

2 LOCATION MAP N.T.S

LIST OF DRAWINGS		
SHEET NUMBER	TITLE	
T-000	COVER SHEET	
LANDSCAPE		
L- 100	SITE PLAN	
L- 101	OVERHEAD PLAN	
L- 200	MATERIALS PLAN	
L-300	FURNISHING PLAN	
L-400	PLANTING PLAN	
L-500	NORTH ELEVATION AND RENDERING	
L-501	SOUTH ELEVATION	
L-600	SITE DETAILS	
L-601	SITE DETAILS	
C - 2.0	DEMOLITION PLAN	
C - 3.0	DIMENSION & PAVING PLAN	
E-2.1	LIGHTING PLAN	
E-3.1	POWER PLAN	

PARADISE VALLEY ALLEY IMPROVEMENTS

HDC SUBMISSION 11-26-2025

HamiltonAnderson architecture landscape architecture urban design

Hamilton Anderson Associates, Inc 1435 Randolph Suite 200 Detroit, Michigan 48226 p 313 964 0270 f 313 964 0170 www.hamilton-anderson.com

Landscape Architecture

JIMA Studio 1401 Vermont St., Suite 220 Detroit, MI 48216 313.262.6880

Civil Engineering

PEA 45 W Grand River Ave., Suite 501 Detroit, MI 48226 313.769.5770

Illuminart 5145 Livernois Rd, Suite 100 Troy, MI 48098 248.897.5666

PBA 5145 Livernois Rd, Suite 100 Electrical Engineering Troy, MI 48098 248.897.5666

The Paradise Valley Cultural and Entertainment District Conservancy

13254 Common Road Warren, MI 48088


HDC SUBMISSION 11-26-2025

DID CE I	07.01.2020
REVISED BID SET	08.12.2025
REVISED BID SET	09.05.2025
ADDENDUM #1	09.17.2025
PERMITS	10.17.2025

Project
Paradise Valley Alley

COVER SHEET

T-000

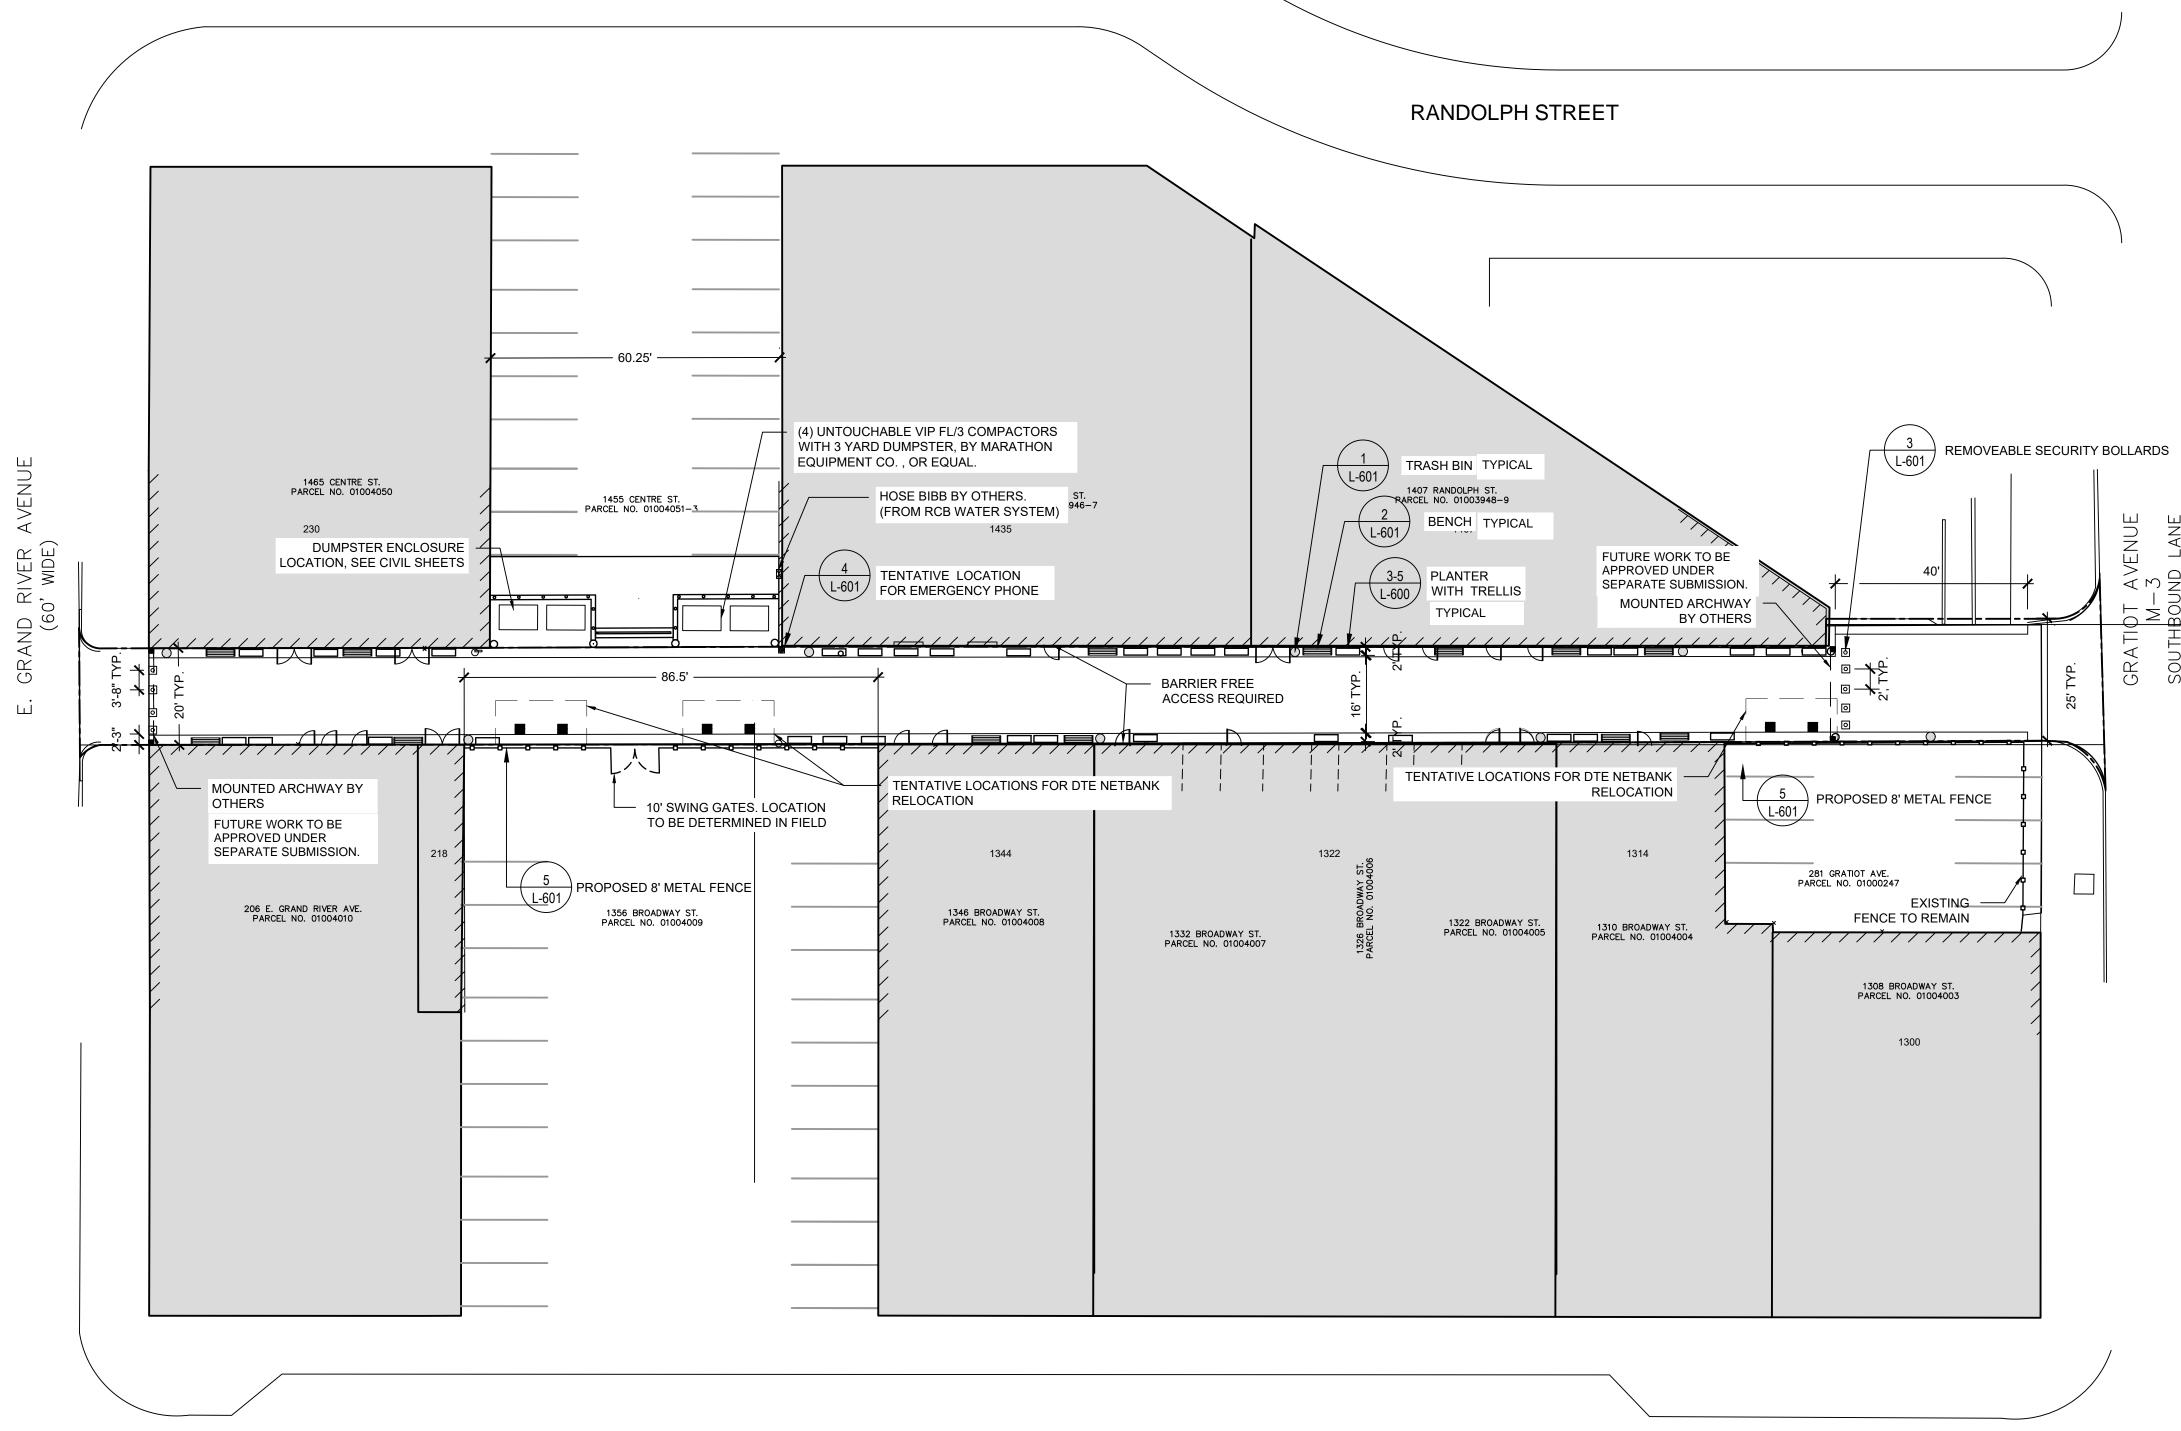

BROADWAY STREET

SITE PLAN SCALE: 1" = 20' SHEET NOTES

PRIOR TO START OF PROJECT WORK, VERIFY ALL SITE CONDITIONS AND SUBMIT A PROJECT WORK PLAN TO THE LANDSCAPE ARCHITECT FOR REVIEW AND COMMENT. AT THE OWNER'S PRE-CONSTRUCTION MEETING. DO NOT BEGIN PRIOR TO THE 'PRE-CONSTRUCTION MEETING', AND UNTIL WRITTEN AUTHORIZATION TO PROCEED IS ISSUED BY THE OWNER.

NOTIFY THE LANDSCAPE ARCHITECT IN WRITING OF ANY IDENTIFIED DISCREPANCIES WITHIN THE CONTRACT DOCUMENTS PRIOR TO THE START OF WORK. DURING PERFORMANCE OF WORK, VERIFY ALL DIMENSIONS AND CONDITIONS AT THE JOB SITE AND CROSS-CHECK DETAILS AND DIMENSIONS SHOWN ON THE DRAWINGS. CONTRACTOR SHALL VERIFY ALL SITE CONDITIONS PRIOR TO STARTING WORK. IN ALL CASES WHERE A CONFLICT MAY OCCUR. THE LANDSCAPE ARCHITECT SHALL BE NOTIFIED AND WILL INTERPRET THE INTENT OF THE CONTRACT DOCUMENTS.

PRIOR TO THE COMMENCEMENT OF WORK, VERIFY LOCATIONS AND DEPTHS OF ALL UNDERGROUND UTILITIES THAT MAY BE AFFECTED BY CONSTRUCTION AND TAKE RESPONSIBILITY FOR DAMAGES TO SUCH UTILITIES CAUSED AS A RESULT OF CONSTRUCTION. CALL MISS DIG (800) 482-7171 A MINIMUM OF 72 HOURS PRIOR TO THE START OF CONSTRUCTION.

TAKE ALL NECESSARY PRECAUTIONARY MEASURES TO PROTECT THE PUBLIC AND ADJACENT PROPERTIES FROM DAMAGE THROUGHOUT CONSTRUCTION, INCLUDING DAMAGES TO UTILITIES, WALKS, WALLS, DRIVES, CURBS, ETC.

SECURE ALL NECESSARY PERMITS AND NOTIFY ALL UTILITY COMPANIES WITH UTILITIES ON THE SITE PRIOR TO THE START OF CONSTRUCTION. ANY PERMITS REQUIRED ARE THE RESPONSIBILITY OF THE CONTRACTOR.

ESTABLISH AND MAINTAIN SITE SECURITY UNTIL PROJECT ACCEPTANCE. AVOID LEAVING UNINSURED MATERIALS AND EQUIPMENT ON THE SITE OVERNIGHT. THE OWNER IS NOT RESPONSIBLE FOR STOLEN OR DAMAGED ITEMS LEFT ON

USE DIMENSIONS SHOWN ON DRAWINGS FOR LAYOUT OF THE WORK. DO NOT USE SCALE DIMENSIONS FROM PLANS, SECTIONS OR DETAILS ON THE DRAWINGS. DIMENSIONS ARE FROM CENTERLINE, BACK OF CURB, CENTER OF POST, OR EDGE OF PAVEMENT, UNLESS OTHERWISE NOTED. VERIFY LOCATIONS IN FIELD WITH LANDSCAPE ARCHITECT. ALL DIMENSIONS MUST BE FIELD VERIFIED AND ANY DISCREPANCIES REPORTED TO THE LANDSCAPE ARCHITECT IMMEDIATELY.

REFER TO THE SPECIFICATIONS FOR ADDITIONAL REQUIREMENTS NOT SHOWN ON DRAWINGS.

DETAILS NOTED AS TYPICAL SHALL APPLY IN ALL CASES UNLESS SPECIFICALLY SHOWN OR NOTED OTHERWISE. WHERE NO SPECIFIC DETAIL IS SHOWN, THE CONSTRUCTION SHALL BE IDENTICAL OR SIMILAR TO THAT INDICATED FOR LIKE CASES OF CONSTRUCTION ON THIS PROJECT.

TAKE NOTE OF ALL GRADING AND DRAINAGE WAYS AND MAINTAIN THESE DRAIN WAYS/FLOWS FREE OF OBSTRUCTIONS. NOTIFY OWNER'S REPRESENTATIVE OF ANY DISCREPANCIES BETWEEN PROPOSED GRADES AND EXISTING SITE ELEVATIONS. ANY AREAS OF POOR DRAINAGE OR INADEQUATE DRAINAGE FROM PROPOSED IMPROVEMENTS SHALL BE BROUGHT TO THE ATTENTION OF THE LANDSCAPE ARCHITECT AND SHALL BE MODIFIED AS REQUIRED AND APPROVED AT NO ADDITIONAL COST TO THE OWNER.

COORDINATE WORK OF SUBCONTRACTORS TO ENSURE ORDERLY AND EFFICIENT COMPLETIONS OF ALL WORK.

MINIMIZE INTERFERENCE WITH ADJOINING ROADS, STREETS, WALKS AND OTHER ADJACENT OCCUPIED OR USED FACILITIES DURING SITE-CLEARING OPERATIONS. DO NOT CLOSE OR OBSTRUCT STREETS, WALKS, OR OTHER ADJACENT OCCUPIED OR USED FACILITIES WITHOUT PERMISSION FROM OWNER AND AUTHORITIES HAVING JURISDICTION.

PROVIDE TEMPORARY EROSION AND SEDIMENT CONTROL MEASURES TO PREVENT SOIL EROSION AND DISCHARGE OF SOIL BEARING WATER RUN-OFF OR AIRBORNE DUST TO ADJACENT PROPERTIES AND WALKWAYS, ACCORDING TO LOCAL CITY ORDINANCE AND EROSION CONTROL REQUIREMENTS OF AUTHORITIES HAVING JURISDICTION. ALL UTILITIES ON OR ADJACENT TO THE SITE WILL REMAIN IN PLACE. PROTECT ALL PUBLIC AND PRIVATE UTILITIES FROM DAMAGE DURING SITE REMOVALS.

REMOVE AND LEGALLY DISPOSE OF OBSTRUCTIONS, DEBRIS AND VEGETATION TO PERMIT INSTALLATION OF NEW CONSTRUCTION. REMOVE SURPLUS SOIL MATERIALS, UNSUITABLE TOPSOIL, OBSTRUCTIONS, DEMOLISHED MATERIALS AND WASTE MATERIALS INCLUDING TRASH AND DEBRIS. PROVIDE RECEIPTS AND LETTERS FROM DISPOSAL SITES TO OWNER AS REQUIRED BY THE OWNER.

ADHERE TO ALL APPLICABLE LOCAL, STATE AND FEDERAL LAWS, CODES ORDINANCES OR REGULATIONS PERTAINING TO THIS PROJECT.

SEE SURVEY AND CIVIL SHEETS FOR UTILITIES AND GRADING.

SEE MEP SHEETS FOR ELECTRICAL SUPPLY AND TELECOM.

LEGEND

SEE LIGHTING SHEETS FOR LIGHTING LAYOUT, COUNT AND SPECIFICATIONS.

ALLEY PAVEMENT MATERIAL TO BE SELECTIVELY DEMOLISHED TO SALVAGE HISTORIC BRICK PAVERS UNDERNEATH EXISTING CONCRETE AND ASPHALT. TO BE ASSORTED AND PALLETED FOR REUSE. COST OF THIS SELECTIVE DEMOLITION TO BE COSTED AS AN ADD ALTERNATE. SEE DEMOLITION PLAN AND MATERIALS PLAN FOR MORE INFORMATION.

architecture landscape architecture urban design

Hamilton Anderson Associates, Inc 1435 Randolph Suite 200 Detroit, Michigan 48226 p 313 964 0270 f 313 964 0170 www.hamilton-anderson.com

Landscape JIMA Studio 1401 Vermont St., Suite 220 Architecture Detroit, MI 48216 313.262.6880 PEA Civil Engineering 45 W Grand River Ave., Suite 501

> Illuminart 5145 Livernois Rd, Suite 100

Detroit, MI 48226 313.769.5770

Troy, MI 48098 248.897.5666

Electrical 5145 Livernois Rd, Suite 100 Engineering Troy, MI 48098 248.897.5666

Lighting Design

The Paradise Valley Cultural and **Entertainment District Conservancy**

13254 Common Road Warren, MI 48088

HDC SUBMISSION 11-26-2025

BID SET	07.31.2025
REVISED BID SET	08.12.2025
REVISED BID SET	09.05.2025
ADDENDUM #1	09.17.2025
PERMITS	10.17.2025
	<u> </u>
	<u> </u>


Paradise Valley Alley

Drawing Title

SITE PLAN

Project Number: 2023035.00 Drawn By:SBP Approved By:UDW Scale: AS SHOWN

PROJECT LIMITS 5 L-601 8' METAL FENCE 2 L-601 BENCH 3-5 L-600 PLANTER WITH TRELLIS (1 L-601) TRASH BIN REMOVEABLE BOLLARD EMERGENCY PHONE

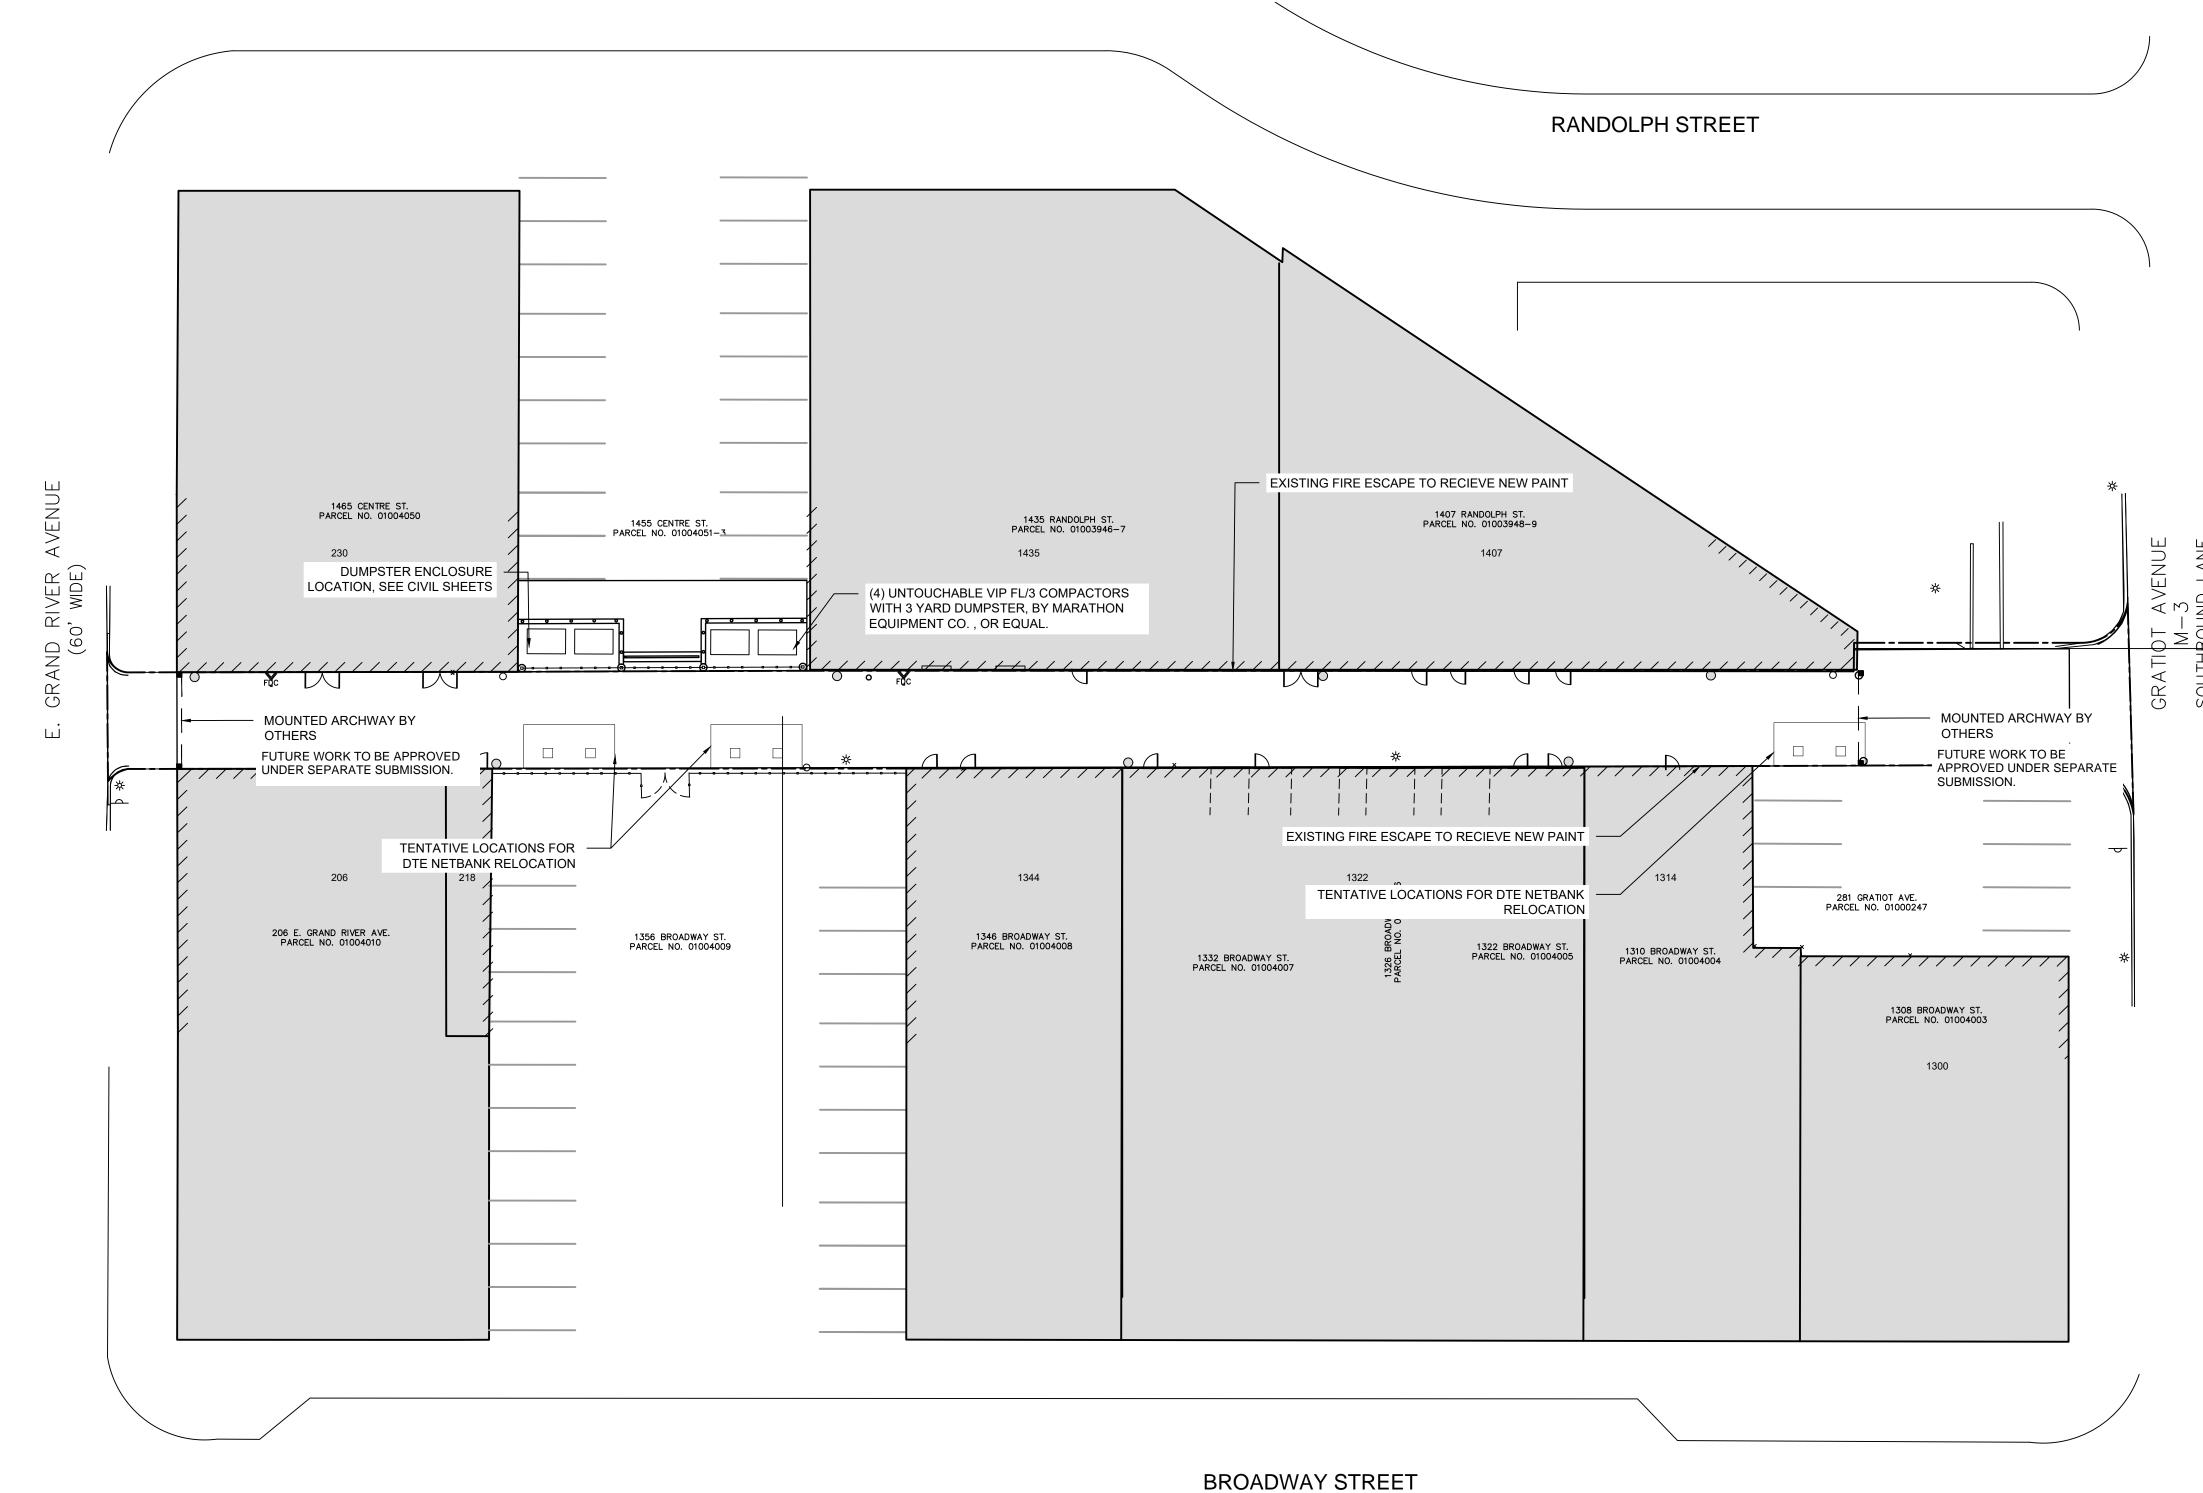

OVERHEAD PLAN
SCALE: 1" = 20'

SHEET NOTES

LEGEND

PROJECT LIMITS

- PRIOR TO THE COMMENCEMENT OF WORK, VERIFY LOCATIONS AND DEPTHS OF ALL UNDERGROUND UTILITIES THAT MAY BE AFFECTED BY CONSTRUCTION AND TAKE RESPONSIBILITY FOR DAMAGES TO SUCH UTILITIES CAUSED AS A RESULT OF CONSTRUCTION. TAKE ALL NECESSARY PRECAUTIONARY MEASURES TO PROTECT THE PUBLIC AND ADJACENT PROPERTIES FROM DAMAGE THROUGHOUT CONSTRUCTION, INCLUDING DAMAGES TO UTILITIES, WALKS, WALLS, DRIVES, CURBS, ETC. CALL MISS DIG (800) 482-7171 A MINIMUM OF 72 HOURS PRIOR TO THE START OF CONSTRUCTION.
 - SEE LANDSCAPE PLAN FOR PLANTING.
 - SEE CIVIL SHEETS FOR UTILITIES AND GRADING.
 - SEE MEP SHEETS FOR ELECTRICAL SUPPLY AND TELECOM.
- SEE LIGHTING SHEETS FOR LIGHTING LAYOUT, COUNT AND SPECIFICATIONS
- CONFIRM WITH OWNER COLOR AND FINISH OF PAINT FOR OVERHEAD FIRE ESCAPES.

JIMA Studio 1401 Vermont St., Suite 220 Detroit, MI 48216 313.262.6880

HamiltonAnderson architecture landscape architecture urban design

Hamilton Anderson Associates, Inc

p 313 964 0270 f 313 964 0170

www.hamilton-anderson.com

1435 Randolph Suite 200

Detroit, Michigan 48226

Landscape Architecture

Lighting Design

PEA 45 W Grand River Ave., Suite 501 Engineering Detroit, MI 48226 313.769.5770

> Illuminart 5145 Livernois Rd, Suite 100 Troy, MI 48098 248.897.5666

PBA 5145 Livernois Rd, Suite 100 **Electrical** Troy, MI 48098 248.897.5666

The Paradise Valley Cultural and Entertainment District Conservan

13254 Common Road Warren, MI 48088

HDC SUBMISSION 11-26-2025

BID SET	07.31.2025	
REVISED BID SET	08.12.2025	
REVISED BID SET	09.05.2025	
ADDENDUM #1	09.17.2025	
PERMITS	10.17.2025	
<u></u>	 	

Paradise Valley Alley


Drawing Title

OVERHEAD PLAN


Project Number: 2023035.00 Approved By:UDW

Scale: AS SHOWN

L-101

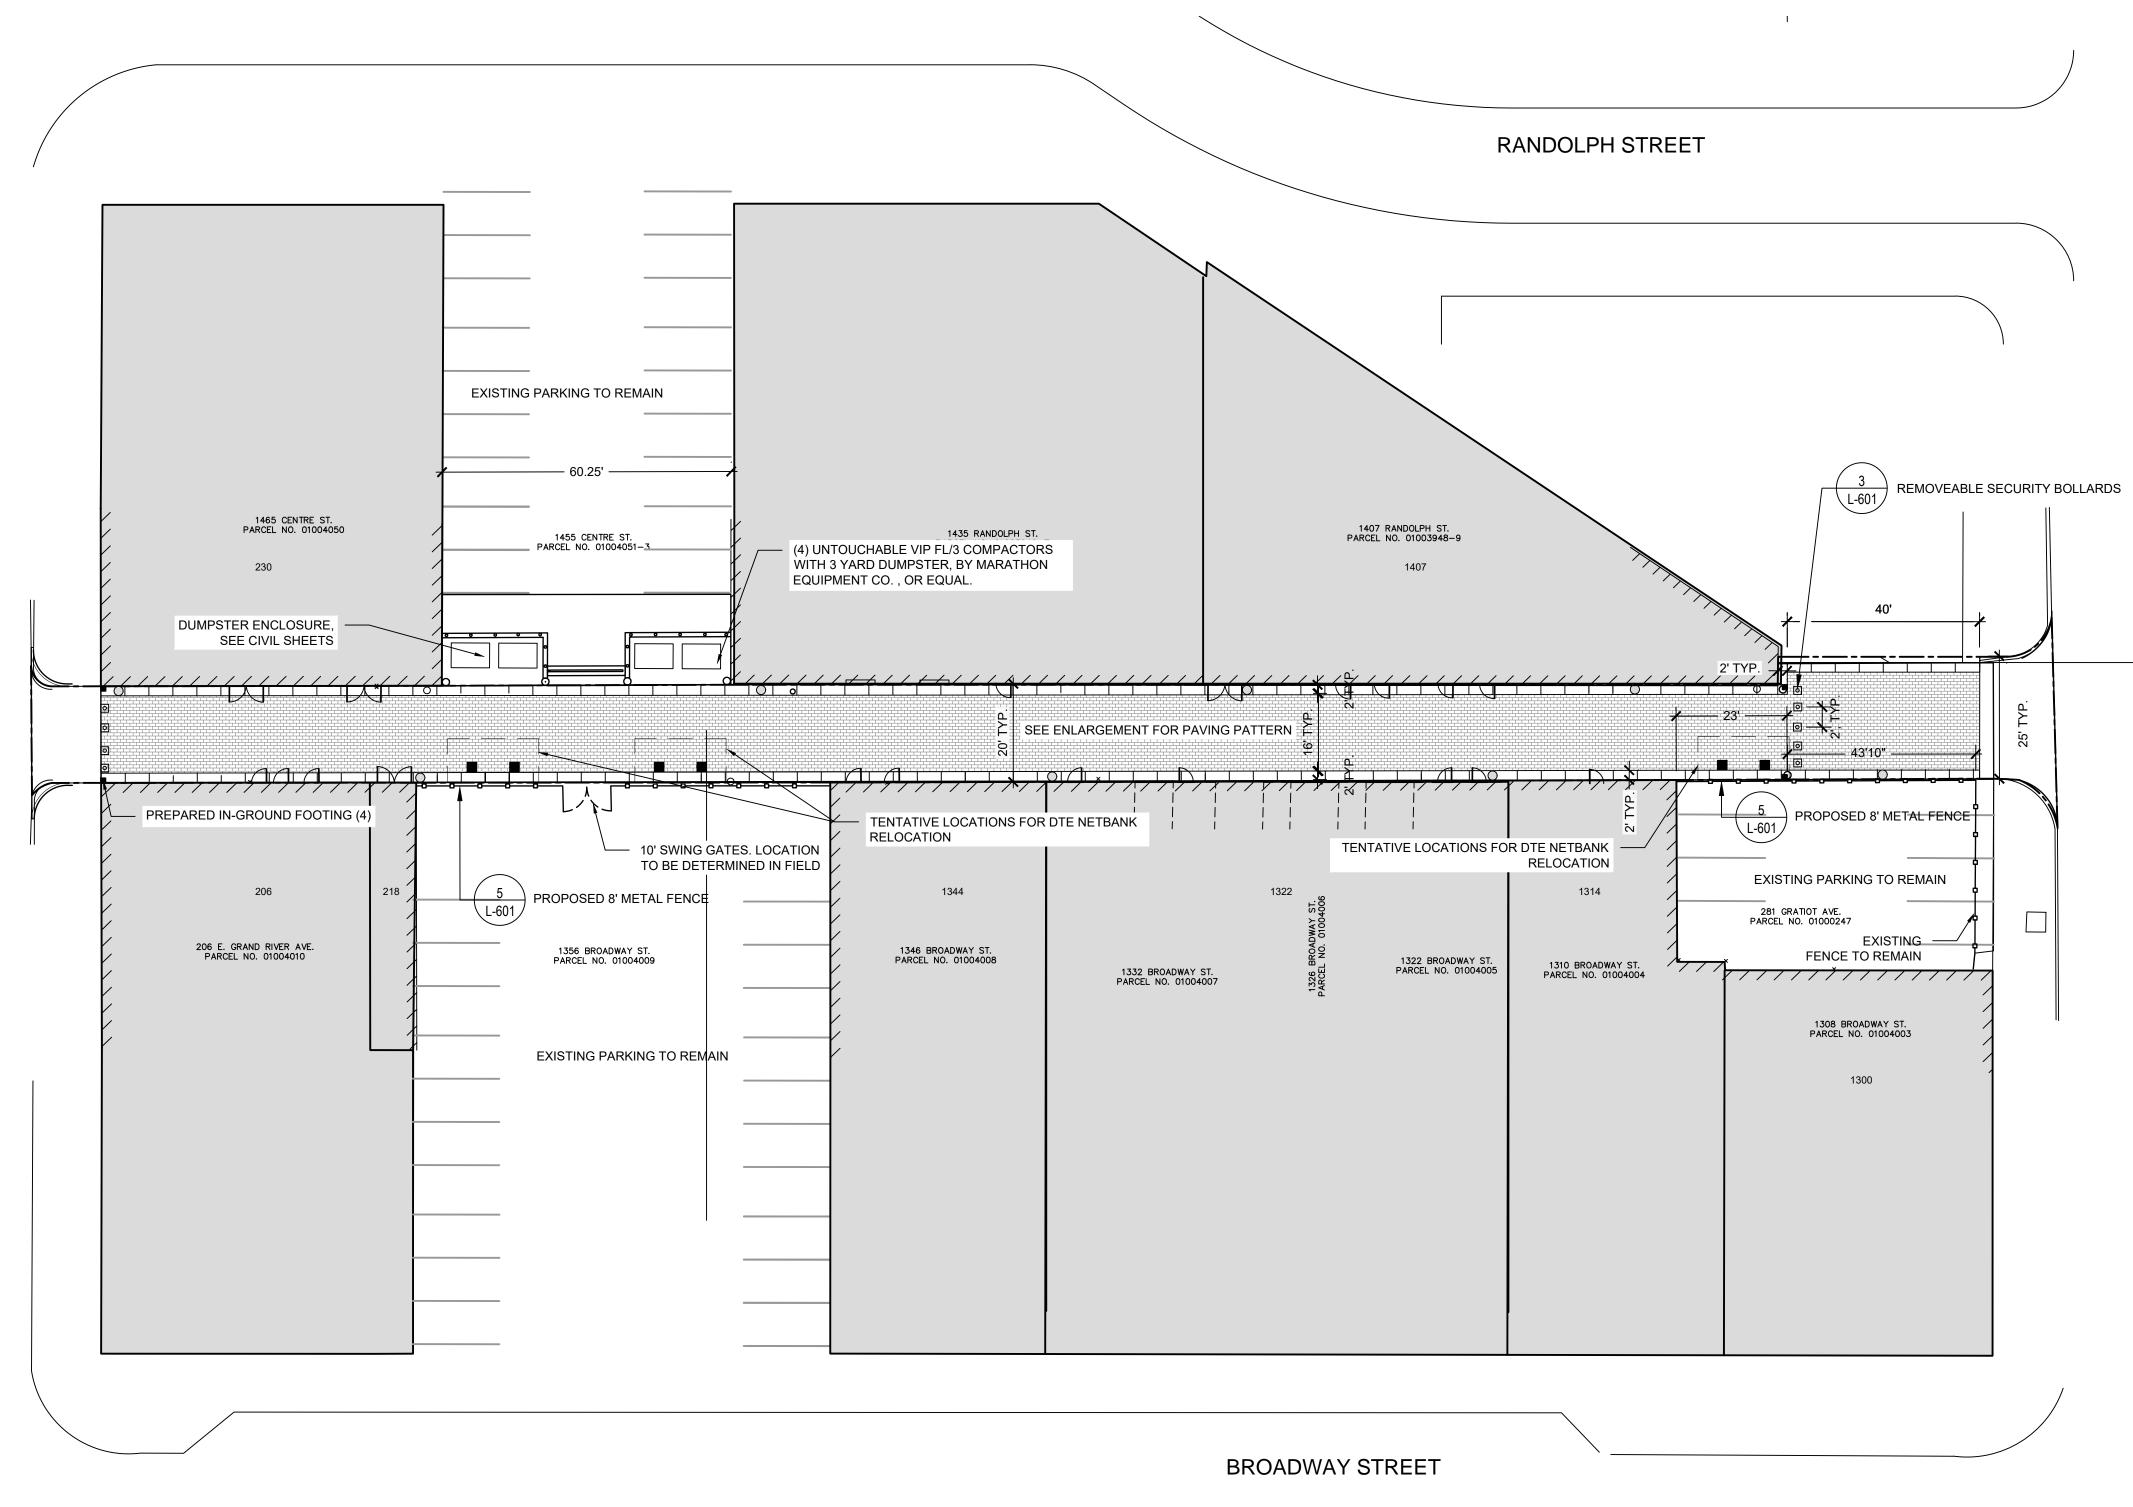

MATERIALS PLAN SCALE: 1" = 20'

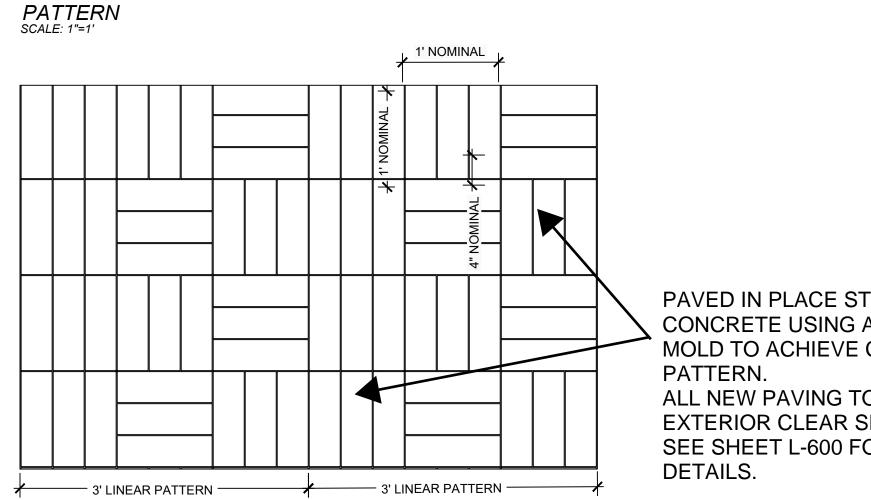

PAVED IN PLACE STAMPED CONCRETE USING A SILICONE MOLD TO ACHIEVE CUSTOM ALL NEW PAVING TO RECEIVE EXTERIOR CLEAR SEALER. SEE SHEET L-600 FOR PAVING

NOTE: CLIENT TO SELECT FINAL COLOR AND FINISH OF PAVEMENT

PAVING PATTERN ENLARGMENT SCALE: AS INDICATED

SHEET NOTES

- PRIOR TO START OF PROJECT WORK, VERIFY ALL SITE CONDITIONS AND SUBMIT A PROJECT WORK PLAN TO THE LANDSCAPE ARCHITECT FOR REVIEW AND COMMENT. AT THE OWNER'S PRE-CONSTRUCTION MEETING. DO NOT BEGIN PRIOR TO THE 'PRE-CONSTRUCTION MEETING', AND UNTIL WRITTEN AUTHORIZATION TO PROCEED IS ISSUED BY THE OWNER.
- NOTIFY THE LANDSCAPE ARCHITECT IN WRITING OF ANY IDENTIFIED DISCREPANCIES WITHIN THE CONTRACT DOCUMENTS PRIOR TO THE START OF WORK. DURING PERFORMANCE OF WORK, VERIFY ALL DIMENSIONS AND CONDITIONS AT THE JOB SITE AND CROSS-CHECK DETAILS AND DIMENSIONS SHOWN ON THE DRAWINGS. CONTRACTOR SHALL VERIFY ALL SITE CONDITIONS PRIOR TO STARTING WORK. IN ALL CASES WHERE A CONFLICT MAY OCCUR, THE LANDSCAPE ARCHITECT SHALL BE NOTIFIED AND WILL INTERPRET THE INTENT OF THE CONTRACT DOCUMENTS.
- PRIOR TO THE COMMENCEMENT OF WORK, VERIFY LOCATIONS AND DEPTHS OF ALL UNDERGROUND UTILITIES THAT MAY BE AFFECTED BY CONSTRUCTION AND TAKE RESPONSIBILITY FOR DAMAGES TO SUCH UTILITIES CAUSED AS A RESULT OF CONSTRUCTION. CALL MISS DIG (800) 482-7171 A MINIMUM OF 72 HOURS PRIOR TO THE START OF CONSTRUCTION.
- TAKE ALL NECESSARY PRECAUTIONARY MEASURES TO PROTECT THE PUBLIC AND ADJACENT PROPERTIES FROM DAMAGE THROUGHOUT CONSTRUCTION, INCLUDING DAMAGES TO UTILITIES, WALKS, WALLS, DRIVES, CURBS, ETC.
- SECURE ALL NECESSARY PERMITS AND NOTIFY ALL UTILITY COMPANIES WITH UTILITIES ON THE SITE PRIOR TO THE START OF CONSTRUCTION. ANY PERMITS REQUIRED ARE THE RESPONSIBILITY OF THE CONTRACTOR.
- ESTABLISH AND MAINTAIN SITE SECURITY UNTIL PROJECT ACCEPTANCE. AVOID LEAVING UNINSURED MATERIALS AND EQUIPMENT ON THE SITE OVERNIGHT. THE OWNER IS NOT RESPONSIBLE FOR STOLEN OR DAMAGED ITEMS LEFT ON SITE.
- USE DIMENSIONS SHOWN ON DRAWINGS FOR LAYOUT OF THE WORK. DO NOT USE SCALE DIMENSIONS FROM PLANS, SECTIONS OR DETAILS ON THE DRAWINGS. DIMENSIONS ARE FROM CENTERLINE, BACK OF CURB, CENTER OF POST, OR EDGE OF PAVEMENT, UNLESS OTHERWISE NOTED. VERIFY LOCATIONS IN FIELD WITH LANDSCAPE ARCHITECT. ALL DIMENSIONS MUST BE FIELD VERIFIED AND ANY DISCREPANCIES REPORTED TO THE LANDSCAPE ARCHITECT IMMEDIATELY.
- REFER TO THE SPECIFICATIONS FOR ADDITIONAL REQUIREMENTS NOT SHOWN ON DRAWINGS.
- DETAILS NOTED AS TYPICAL SHALL APPLY IN ALL CASES UNLESS SPECIFICALLY SHOWN OR NOTED OTHERWISE. WHERE NO SPECIFIC DETAIL IS SHOWN, THE CONSTRUCTION SHALL BE IDENTICAL OR SIMILAR TO THAT INDICATED FOR LIKE CASES OF CONSTRUCTION ON THIS PROJECT.
- TAKE NOTE OF ALL GRADING AND DRAINAGE WAYS AND MAINTAIN THESE DRAIN WAYS/FLOWS FREE OF OBSTRUCTIONS. NOTIFY OWNER'S REPRESENTATIVE OF ANY DISCREPANCIES BETWEEN PROPOSED GRADES AND EXISTING SITE ELEVATIONS. ANY AREAS OF POOR DRAINAGE OR INADEQUATE DRAINAGE FROM PROPOSED IMPROVEMENTS SHALL BE BROUGHT TO THE ATTENTION OF THE LANDSCAPE ARCHITECT AND SHALL BE MODIFIED AS REQUIRED AND APPROVED AT NO ADDITIONAL COST TO THE OWNER.
- COORDINATE WORK OF SUBCONTRACTORS TO ENSURE ORDERLY AND EFFICIENT COMPLETIONS OF ALL WORK.
- EXISTING SITE TO BE GENERALLY CLEARED AND GRUBBED OF WEEDS, OVERGROWTH, TRASH AND OTHER UNSIGHTLY LANDSCAPE COMPONENTS. PRE-CONSTRUCTION MEETING WILL DETERMINE THE EXTENT OF TREE REMOVAL AND PRUNING NEEDED FOR A CLEAN AND SAFE SITE PER THE OWNER'S REQUEST.
- MINIMIZE INTERFERENCE WITH ADJOINING ROADS, STREETS, WALKS AND OTHER ADJACENT OCCUPIED OR USED FACILITIES DURING SITE-CLEARING OPERATIONS. DO NOT CLOSE OR OBSTRUCT STREETS, WALKS, OR OTHER ADJACENT OCCUPIED OR USED FACILITIES WITHOUT PERMISSION FROM OWNER AND AUTHORITIES HAVING JURISDICTION.
- PROVIDE TEMPORARY EROSION AND SEDIMENT CONTROL MEASURES TO PREVENT SOIL EROSION AND DISCHARGE OF SOIL BEARING WATER RUN-OFF OR AIRBORNE DUST TO ADJACENT PROPERTIES AND WALKWAYS, ACCORDING TO LOCAL CITY ORDINANCE AND EROSION CONTROL REQUIREMENTS OF AUTHORITIES HAVING JURISDICTION. ALL UTILITIES ON OR ADJACENT TO THE SITE WILL REMAIN IN PLACE. PROTECT ALL PUBLIC AND PRIVATE UTILITIES FROM DAMAGE DURING SITE REMOVALS.
- REMOVE OBSTRUCTIONS AND LEGALLY DISPOSE OF DEBRIS AND VEGETATION TO PERMIT INSTALLATION OF NEW CONSTRUCTION. REMOVE SURPLUS SOIL MATERIALS, UNSUITABLE TOPSOIL, OBSTRUCTIONS, DEMOLISHED MATERIALS AND WASTE MATERIALS INCLUDING TRASH AND DEBRIS. PROVIDE RECEIPTS AND LETTERS FROM DISPOSAL SITES TO OWNER AS REQUIRED BY THE OWNER.
- ADHERE TO ALL APPLICABLE LOCAL, STATE AND FEDERAL LAWS, CODES, ORDINANCES OR REGULATIONS PERTAINING TO THE PROJECT.
- SEE CIVIL SHEETS FOR UTILITIES AND GRADING.
- SEE MEP SHEETS FOR ELECTRICAL SUPPLY AND TELECOM.
- SEE LIGHTING SHEETS FOR LIGHTING LAYOUT, COUNT AND SPECIFICATIONS.

LEGEND PROJECT LIMITS 2 L-600 POURED IN PLACE CONCRETE 1 L-600 CONCRETE PAVER 5 L-601 8' METAL FENCE -0--0--0--8' METAL FENCE WITH AUTOMATED -0---0----L-XXX GATE L-601 BOLLARD $\begin{pmatrix} X \\ L-XXX \end{pmatrix}$ IN-GROUND FOOTING, FOR FUTURE INSTALLATION

architecture landscape architecture urban design

Hamilton Anderson Associates, Inc 1435 Randolph Suite 200 Detroit, Michigan 48226 p 313 964 0270 f 313 964 0170 www.hamilton-anderson.com

> Landscape JIMA Studio 1401 Vermont St., Suite 220 Detroit, MI 48216 313.262.6880

Engineering 45 W Grand River Ave., Suite 501 Detroit, MI 48226

Illuminart

313.769.5770

Lighting Design 5145 Livernois Rd, Suite 100 Troy, MI 48098

248.897.5666

Electrical 5145 Livernois Rd, Suite 100 Troy, MI 48098 248.897.5666

The Paradise Valley Cultural and **Entertainment District Conservancy**

13254 Common Road Warren, MI 48088

HDC SUBMISSION 11-26-2025


BID SET	07.31.2025
REVISED BID SET	08.12.2025
REVISED BID SET	09.05.2025
ADDENDUM #1	09.17.2025
PERMITS	10.17.2025
	<u> </u>
	

Paradise Valley Alley

Drawing Title

MATERIALS PLAN

Project Number:2023035.00 Drawn By:SBP Approved By:UDW Scale: AS SHOWN

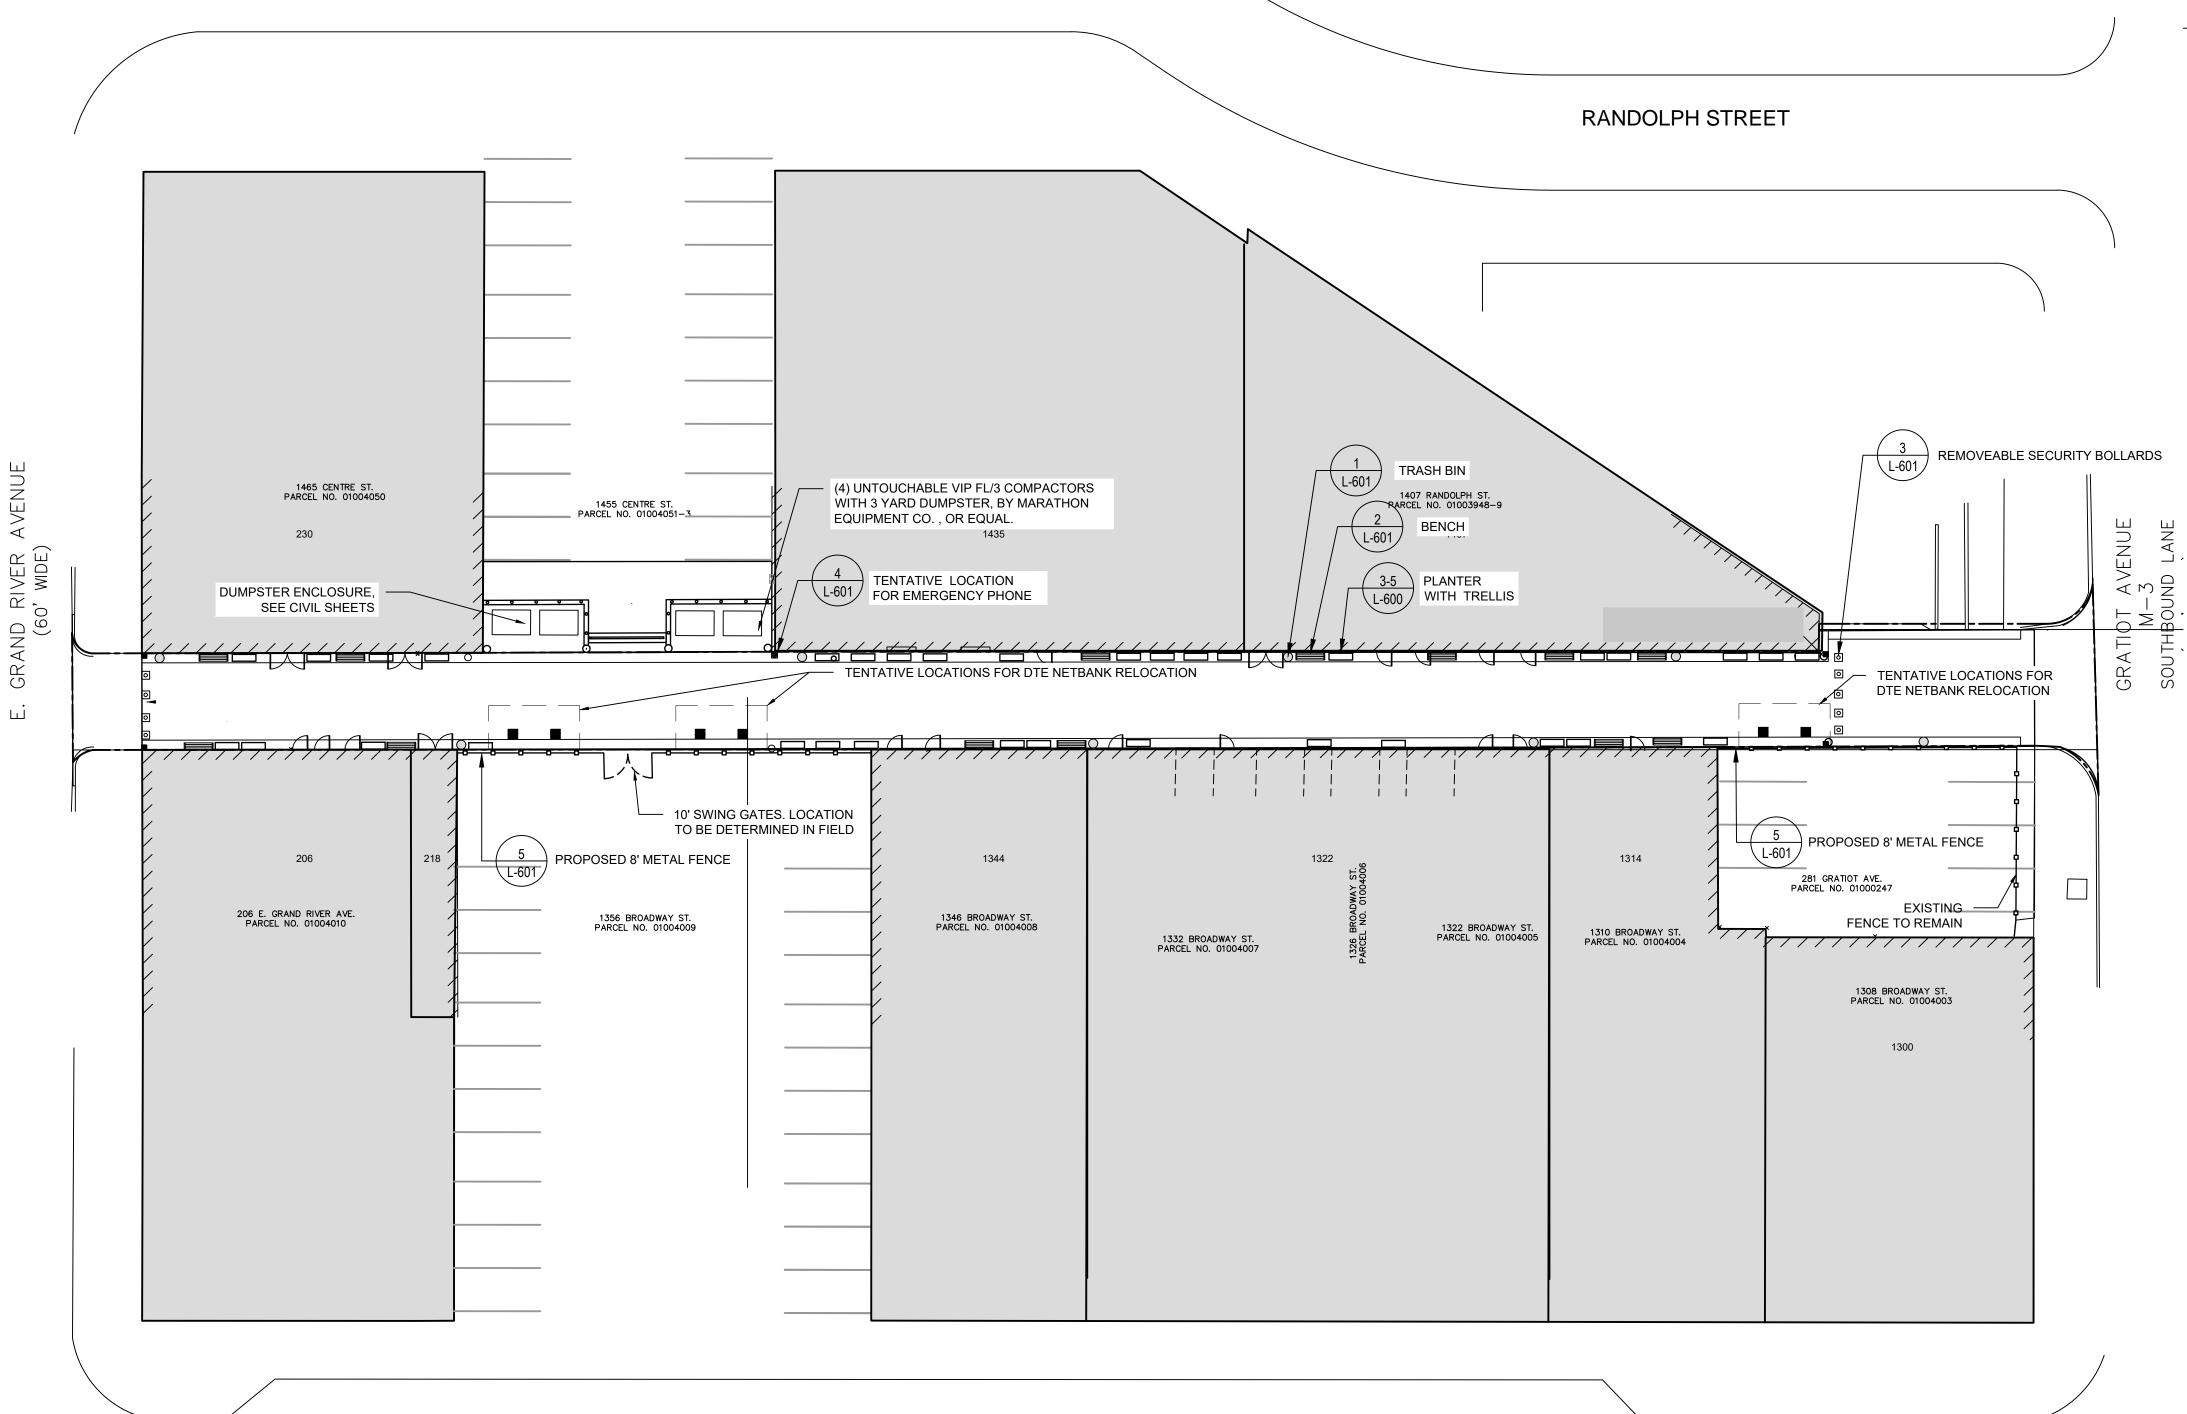

SHEET NOTES

- 1. PRIOR TO THE COMMENCEMENT OF WORK, VERIFY LOCATIONS AND DEPTHS OF ALL UNDERGROUND UTILITIES THAT MAY BE AFFECTED BY CONSTRUCTION AND TAKE RESPONSIBILITY FOR DAMAGES TO SUCH UTILITIES CAUSED AS A RESULT OF CONSTRUCTION. TAKE ALL NECESSARY PRECAUTIONARY MEASURES TO PROTECT THE PUBLIC AND ADJACENT PROPERTIES FROM DAMAGE THROUGHOUT CONSTRUCTION, INCLUDING DAMAGES TO UTILITIES, WALKS, WALLS, DRIVES, CURBS, ETC. CALL MISS DIG (800) 482-7171 A MINIMUM OF 72 HOURS PRIOR TO THE START OF CONSTRUCTION.
 - CONFIRM THE LOCATION OF BENCHES, PLANTERS AND TRELLISES IN FIELD WITH LANDSCAPE ARCHITECT PRIOR TO INSTALLATION.
- 3. CONFIRM BOLLARD LOCATIONS WITH LANDSCAPE ARCHITECT, CIVIL AND MEP PRIOR TO BEGINNING INSTALLATION.
- . SEE PLANTING PLAN FOR PLANT LAYOUT.
- 5. SEE CIVIL SHEETS FOR UTILITIES AND GRADING.
- SEE MEP SHEETS FOR ELECTRICAL SUPPLY AND TELECOM.
- SEE LIGHTING SHEETS FOR LIGHTING LAYOUT, COUNT AND SPECIFICATIONS.

Client The Paradise Valley Cultural and

Entertainment District Conservancy

architecture landscape architecture urban design

JIMA Studio 1401 Vermont St., Suite 220

PEA 45 W Grand River Ave., Suite 501

Illuminart 5145 Livernois Rd, Suite 100

PBA 5145 Livernois Rd, Suite 100

Detroit, MI 48216 313.262.6880

Detroit, MI 48226

313.769.5770

Troy, MI 48098 248.897.5666

Troy, MI 48098 248.897.5666

Hamilton Anderson Associates, Inc

p 313 964 0270 f 313 964 0170

www.hamilton-anderson.com

1435 Randolph Suite 200

Detroit, Michigan 48226

Landscape Architecture

Engineering

Lighting Design

Electrical

Engineering

13254 Common Road Warren, MI 48088

HDC SUBMISSION 11-26-2025

BID SET	07.31.2025
REVISED BID SET	08.12.2025
REVISED BID SET	09.05.2025
ADDENDUM #1	09.17.2025
PERMITS	10.17.2025

Project

Paradise Valley Alley

Drawing Title

FURNISHING PLAN

Project Number:2023035.00	
Drawn By:SBP	Approved By:UDW
Scale: AS SHOWN	


Drawing No:

1 FURNISHING PLAN
SCALE: 1" = 20'

BROADWAY STREET

FURNISHING SCHEDULE	QTY	PRODUCT	MANUFACTURER	NOTES
BENCH: BASIS OF DESIGN	13	STRATA BEAM BACKLESS BENCH	LANDSCAPE FORMS	SELECT BACKLESS BENCH NATURAL WITH GREY MELDSTONE BASE, WOODGRAIN FOR EXTERIOR JARRAH FINISHING, 21 IN WIDTH, 69 IN LENGTH
BENCH: ALTERNATE	-	530 BENCH	DUMOR, INC.	SELECT POWDER COATED BASE IN TEXTURED SILVER, THERMALLY MODIFIED RED OAK SLATS.
PLANTER: BASIS OF DESIGN	32	1500 SERIES PLANTER	MAGLIN	SELECT MPL-1500-00008, 54.38" L x 18.38" W x 18.19 H, MATTE SILVER POWDER COAT FINISH
PLANTER: ALTERNATE	-	HIGH RECTANGLE PLANTER	ORE, REFINED ENVIRONMENTS	SPECIFY SILVER POWDER COAT, DRAINAGE, AND DRIP TRAY. SIZE L, 60"L x 20"W x 24"H
BOLLARD: BASIS OF DESIGN	9	REMOVABLE BOLLARD	SETON	SELECT STAINLESS STEEL WITH SLEEVE
TRASH BIN: BASIS OF DESIGN	8	LAKESIDE LITTER	LANDSCAPE FORMS	SELECT PLAIN PANELS, MATTE BLACK FINISH, BLACK LINER, SIDE OPENING

LEGEND				
		PROJECT LIMITS		
5 L-601	-00	METAL FENCE BY OTHERS		
2 L-601		BENCH		
3-5 L-600		PLANTER WITH TRELLIS		
1 L-601		TRASH BIN		
3 L-601		BOLLARD		
4 L-601		EMERGENCY PHONE		

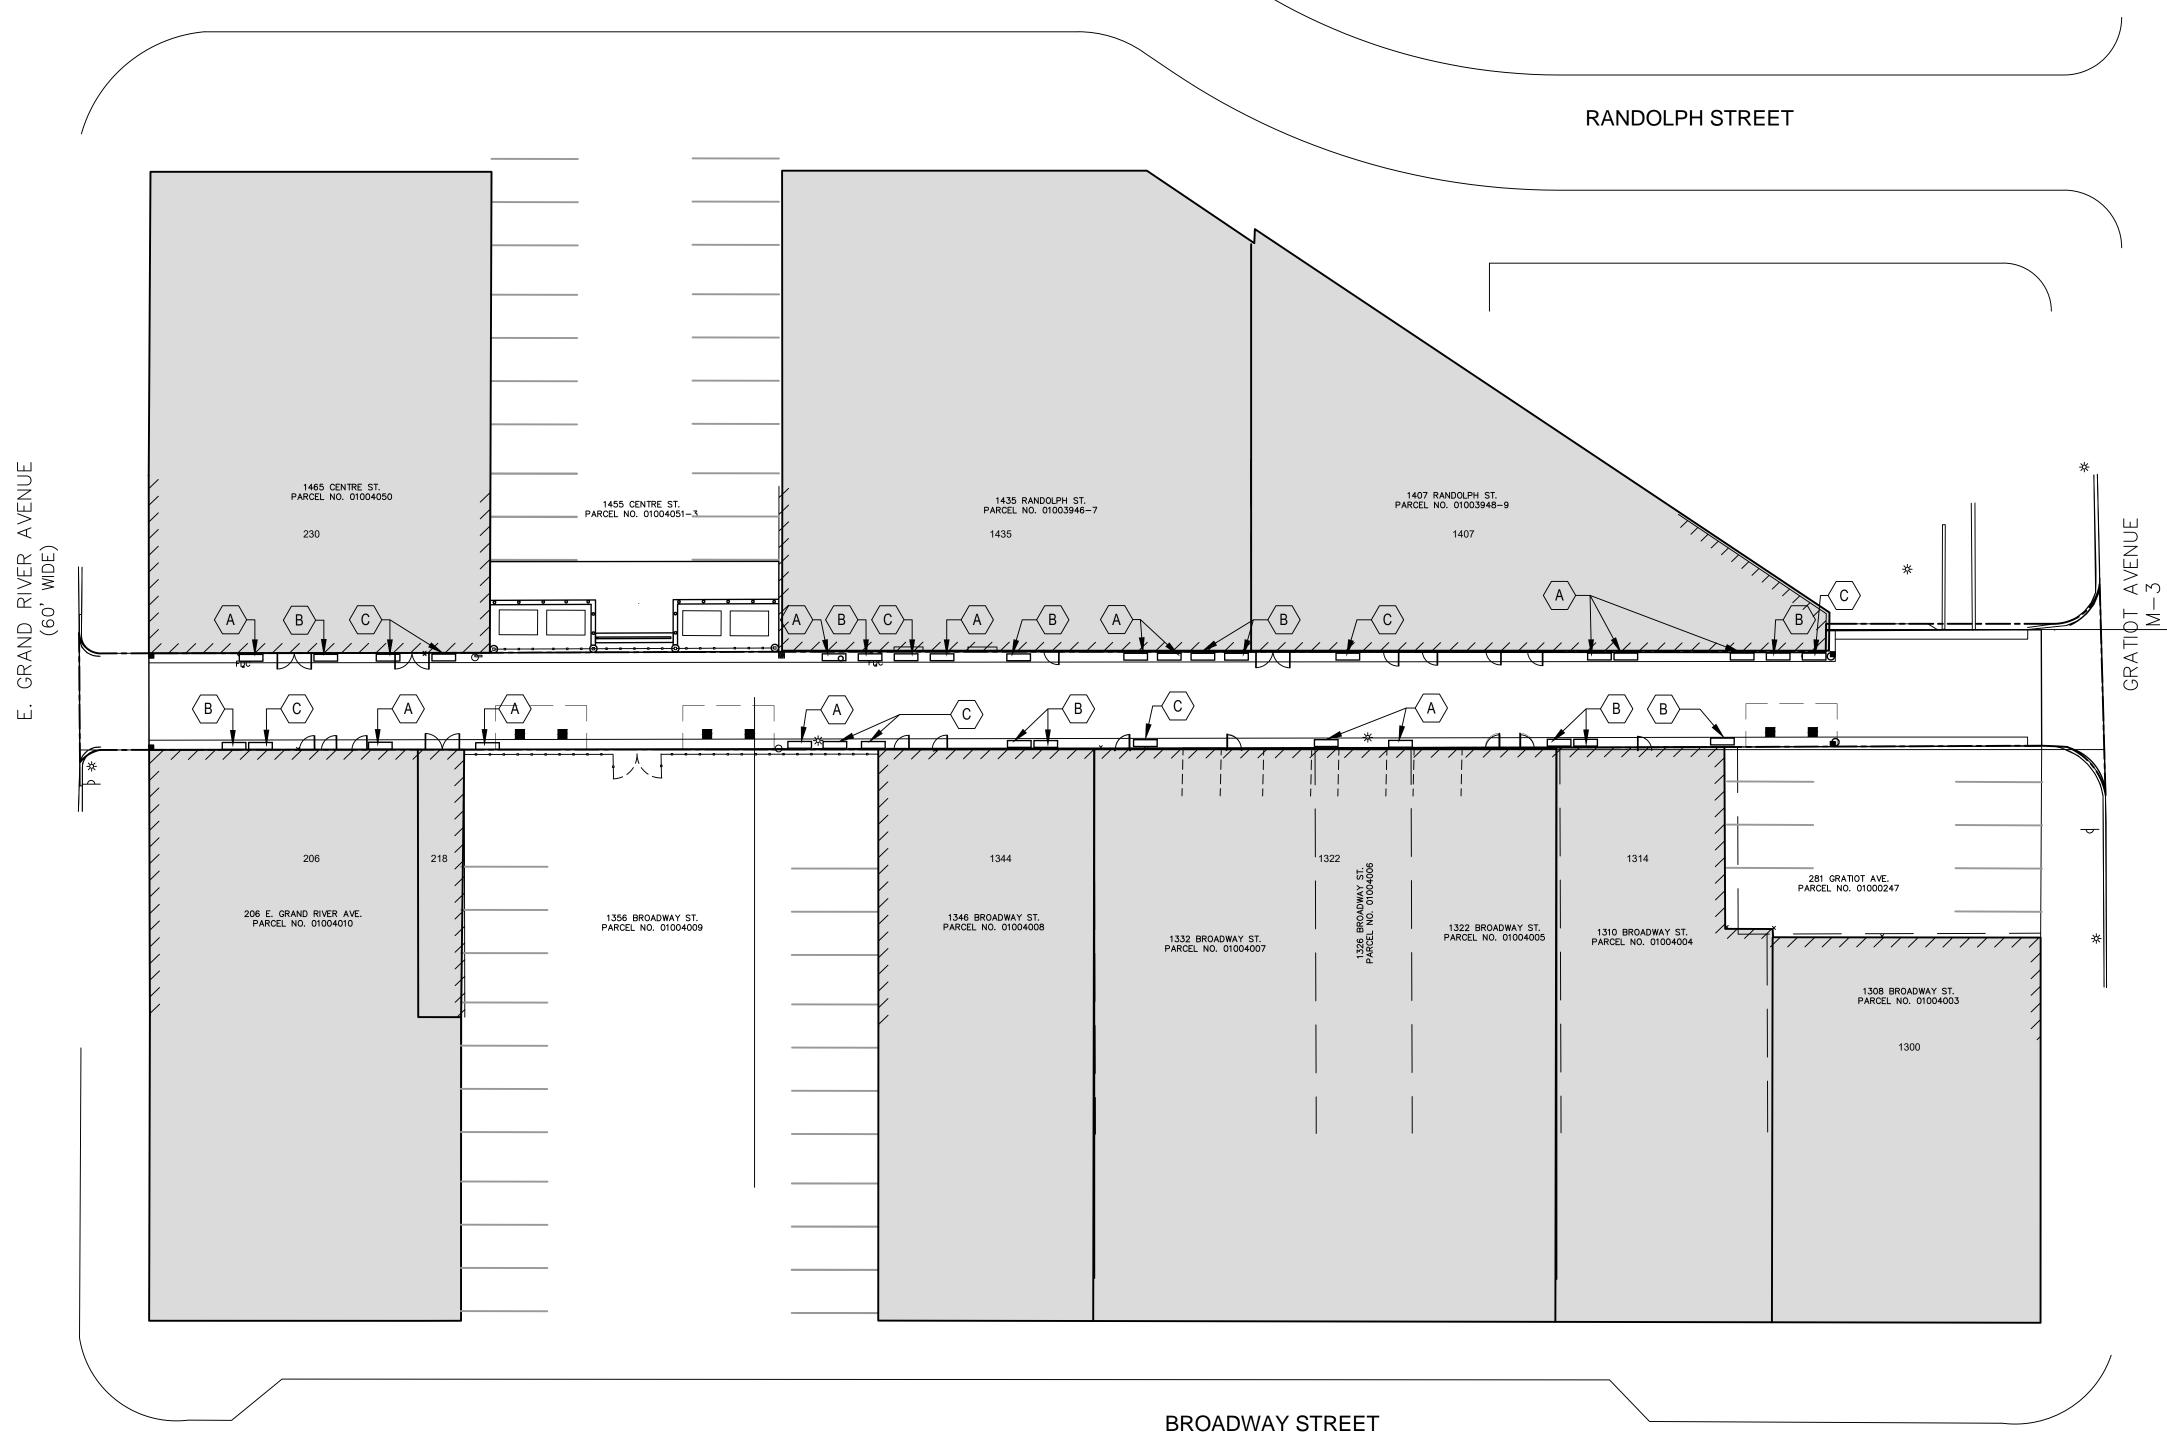

SHEET NOTES

- PRIOR TO THE COMMENCEMENT OF WORK, VERIFY LOCATIONS AND DEPTHS OF ALL UNDERGROUND UTILITIES THAT MAY BE AFFECTED BY CONSTRUCTION AND TAKE RESPONSIBILITY FOR DAMAGES TO SUCH UTILITIES CAUSED AS A RESULT OF CONSTRUCTION. TAKE ALL NECESSARY PRECAUTIONARY MEASURES TO PROTECT THE PUBLIC AND ADJACENT PROPERTIES FROM DAMAGE THROUGHOUT CONSTRUCTION, INCLUDING DAMAGES TO UTILITIES, WALKS, WALLS, DRIVES, CURBS, ETC. CALL MISS DIG (800) 482-7171 A MINIMUM OF 72 HOURS PRIOR TO THE START OF CONSTRUCTION.
- SEE SHEETS L600 FOR DETAILS AND ADDITIONAL NOTES.
- USE DIMENSIONS SHOWN ON DRAWINGS FOR LAYOUT OF THE WORK. DO NOT USE SCALE DIMENSIONS FROM PLANS, SECTIONS OR DETAILS ON THE DRAWINGS. VERIFY LOCATIONS IN FIELD WITH LANDSCAPE ARCHITECT. DETAILS NOTED AS TYPICAL SHALL APPLY IN ALL CASES UNLESS SPECIFICALLY SHOWN OR NOTED OTHERWISE. WHERE NO SPECIFIC DETAIL IS SHOWN, THE CONSTRUCTION SHALL BE IDENTICAL OR SIMILAR TO THAT INDICATED FOR LIKE CASES OF CONSTRUCTION.
- DISPOSE ALL ELEMENTS DESIGNATED FOR REMOVAL IN A LEGAL MANNER. PROVIDE RECEIPTS AND LETTERS FROM DISPOSAL SITES TO OWNER AS REQUIRED BY THE OWNER. COORDINATE WORK OF SUBCONTRACTORS AND ALL OTHER CONTRACTORS TO ENSURE ORDERLY AND EFFICIENT COMPLETIONS OF ALL WORK.
- ALL CONSTRUCTION SHALL CONFORM TO ALL APPLICABLE CODES, REGULATIONS, AND ORDINANCES.
- INDEPENDENT OF NUMERIC QUANTITIES ON DRAWINGS OR IN THE PLANT SCHEDULE, DETERMINE THE PLANT MATERIAL QUANTITIES REQUIRED BY THE PLANS. SPACE PLANT MATERIALS AS SHOWN ON PLANS AND INDICATED IN PLANT SCHEDULE. PLANT MATERIALS SHALL CONFORM TO PLANT SCHEDULES AND SIZES SHALL BE THE MINIMUM INDICATED ON THE PLANT SCHEDULE OR LARGER - AT NO ADDITIONAL COST TO OWNER. ALL MEASUREMENTS SHALL BE IN ACCORDANCE WITH THE LATEST EDITION OF ANLA "STANDARDS FOR NURSERY STOCK".
- PRIOR TO INSTALLATION, DEMARCATE LAYOUT OF ALL PLANTING BEDS, SEED AREAS, AND INDIVIDUAL TREES FOR REVIEW AND APPROVAL BY LANDSCAPE ARCHITECT. INCLUDE PERENNIAL GROUPINGS BY SPECIES FOR INTERNAL LAYOUTS. FLAGGING, OR STAKES MAY BE USED TO DELINEATE LOCATIONS AS SCALED FROM THE PLANS. THE LANDSCAPE ARCHITECT WILL REVIEW THESE LOCATIONS WITH THE CONTRACTOR AND MAY MAKE MINOR ADJUSTMENTS AS NECESSARY. SUCH ADJUSTMENTS WILL BE AT NO ADDITIONAL COST TO THE
- ALL PLANTINGS SHALL BE PLANTED DURING APPROPRIATED PLANTING SEASONS, AS RECOMMENDED BY ANLA. FOR THIS TEMPERATE ZONE, IT IS PREFERRED THAT PLANTING OCCUR DURING EITHER THE SPRING SEASON (APRIL MID-JUNE) OR THE FALL SEASON (SEPTEMBER- MID-NOVEMBER). WHERE TEMPERATURES REMAIN BETWEEN 40-70 DEGREES FAHRENHEIT. THIS WILL ALLOW SUFFICIENT TIME FOR PLANT STABILIZATION AND GERMINATION AND LIMIT SHOCK ASSOCIATED TO TRANSPLANTATION.
- GENERAL CONTRACTOR SELECTED TO PERFORM THE LANDSCAPE WORK FOR THIS SITE MUST INSTALL AND GUARANTEE ALL MATERIALS FOR A MINIMUM OF 2 YEARS. THIS INCLUDES A MINIMUM OF A 90 CONSECUTIVE DAY WATERING PERIOD FROM THE TIME OF FULL INSTALLATION TO ENSURE THE ESTABLISHMENT OF ALL PLANTS INSTALLED SAVE DAYS OF ADEQUATE RAIN. WATERING PERIODS MAY OVERLAP DEPENDENT ON PLANTING SEASON SELECTED. NO IRRIGATION PLAN IS PROPOSED AS SELECTED NATIVE PLANTS ARE ACCLIMATED TO THE LOCAL CLIMATE. AFTER ESTABLISHMENT, ADDITIONAL WATERING WILL BE THE RESPONSIBILITY OF THE OWNER. EXISTING DRAINAGE TO REMAIN IN PLACE.
- ALL PLANTINGS SELECTED SHALL BE NORTHERN NURSERY GROWN, NO.1 GRADE. TO SUPPORT LOCAL SUSTAINABILITY GOALS, IT IS PREFERRED THAT ALL PLANT SELECTION COME FROM WITHIN THE STATE OF MICHIGAN.
- CONFIRM PLANTER AND TRELLIS LOCATIONS IN FIELD WITH LANDSCAPE ARCHITECT IN FIELD PRIOR TO INSTALLATION.

LEGEND

5 L-601

3-5 L-600

ALL PLANTERS SHALL BE LINED WITH FILTER FABRIC. ALL PLANTERS SHALL RECEIVE 2" MULCH SET 1" BELOW TOP OF PLANTER

Warren, MI 48088

13254 Common Road

HDC SUBMISSION 11-26-2025

HamiltonAnderson architecture landscape architecture urban design

JIMA Studio 1401 Vermont St., Suite 220

45 W Grand River Ave., Suite 501

5145 Livernois Rd, Suite 100

5145 Livernois Rd, Suite 100

Detroit, MI 48216

Detroit, MI 48226

313.769.5770

Troy, MI 48098

Troy, MI 48098

The Paradise Valley Cultural and

Entertainment District Conservancy

248.897.5666

248.897.5666

Illuminart

313.262.6880

Hamilton Anderson Associates, Inc

p 313 964 0270 f 313 964 0170

www.hamilton-anderson.com

1435 Randolph Suite 200

Detroit, Michigan 48226

Landscape

Architecture

Engineering

Lighting Design

Electrical

BID SET	07.31.2025
REVISED BID SET	08.12.2025
REVISED BID SET	09.05.2025
ADDENDUM #1	09.17.2025
PERMITS	10.17.2025
	-
	=

Paradise Valley Alley

Drawing Title

PLANTING PLAN

Project Number:2023035.00		
Drawn By:SBP	Approved By:UDW	

PROJECT LIMITS

METAL FENCE


PLANTER WITH TRELLIS


Project Number:2023035.00			
Drawn By:SBP	Approved By:UDW		
Scale: AS SHOWN			


Drawing No:

PLANTING PLAN
SCALE: 1" = 20'

PLANTER LAYOUTS
SCALE: 1" = 1'

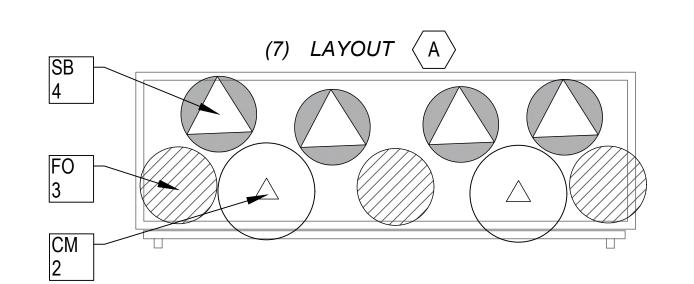


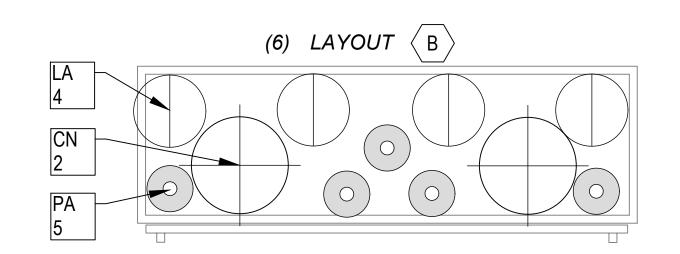

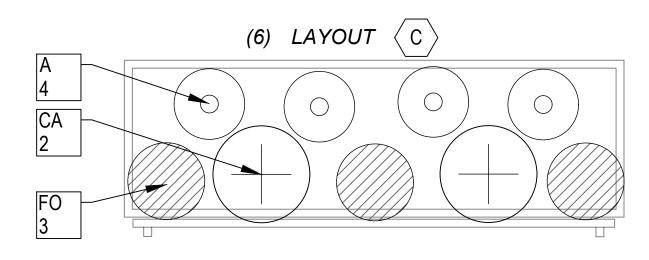

PLANT LIST	SYM	QTY	ID	BOTANIC NAME	COMMON NAME	SIZE	SPACING	NOTES
CLIMBING VINES	$ \oplus $	24	CN	CLEMATIS 'NELLY MOSER'	'NELLY MOSER' CLEMATIS	#1 CONT.	SEE PLANTER LAYOUT	FULL, WELL ROOTED
	\oplus	18	CA	CLEMATIS ALPINA 'PAMELA JACKMAN'	'PAMELA JACKMAN' ALPINE CLEMATIS	#1 CONT.	SEE PLANTER LAYOUT	FULL, WELL ROOTED
	Δ	26	СМ	CLEMATIS MONTANA 'MAYLEEN'	'MAYLEEN' MONTANA CLEMATIS	#1 CONT.	SEE PLANTER LAYOUT	FULL, WELL ROOTED
PERENNIALS AND GRASSES		48	LA	LAVANDULA ANGUSTIFOLIA 'HIDCOTE'	'HIDCOTE' ENGLISH LAVENDER	#1 CONT.	SEE PLANTER LAYOUT	FULL, WELL ROOTED
	0	60	PA	PEROVSKIA ATRIPLICIFOLIA 'LITTLE SPIRE'	LITTLE SPIRE RUSSIAN SAGE (DWARF)	#1 CONT.	SEE PLANTER LAYOUT	FULL, WELL ROOTED
	0	36	Α	AGASTACHE 'BLACK ADDER'	GIANT HYSSOP	#1 CONT.	SEE PLANTER LAYOUT	FULL, WELL ROOTED
		30	FO	FESTUCA OVINA 'EILERS BEAUTY'	EILERS BEAUTY FESCUE GRASS	#1 CONT.	SEE PLANTER LAYOUT	FULL, WELL ROOTED
		52	SB	STACHS BYZANTINA 'SILVER CARPET'	SILVER CARPET LAMB'S EAR	#1 CONT.	SEE PLANTER LAYOUT	FULL, WELL ROOTED

L-400

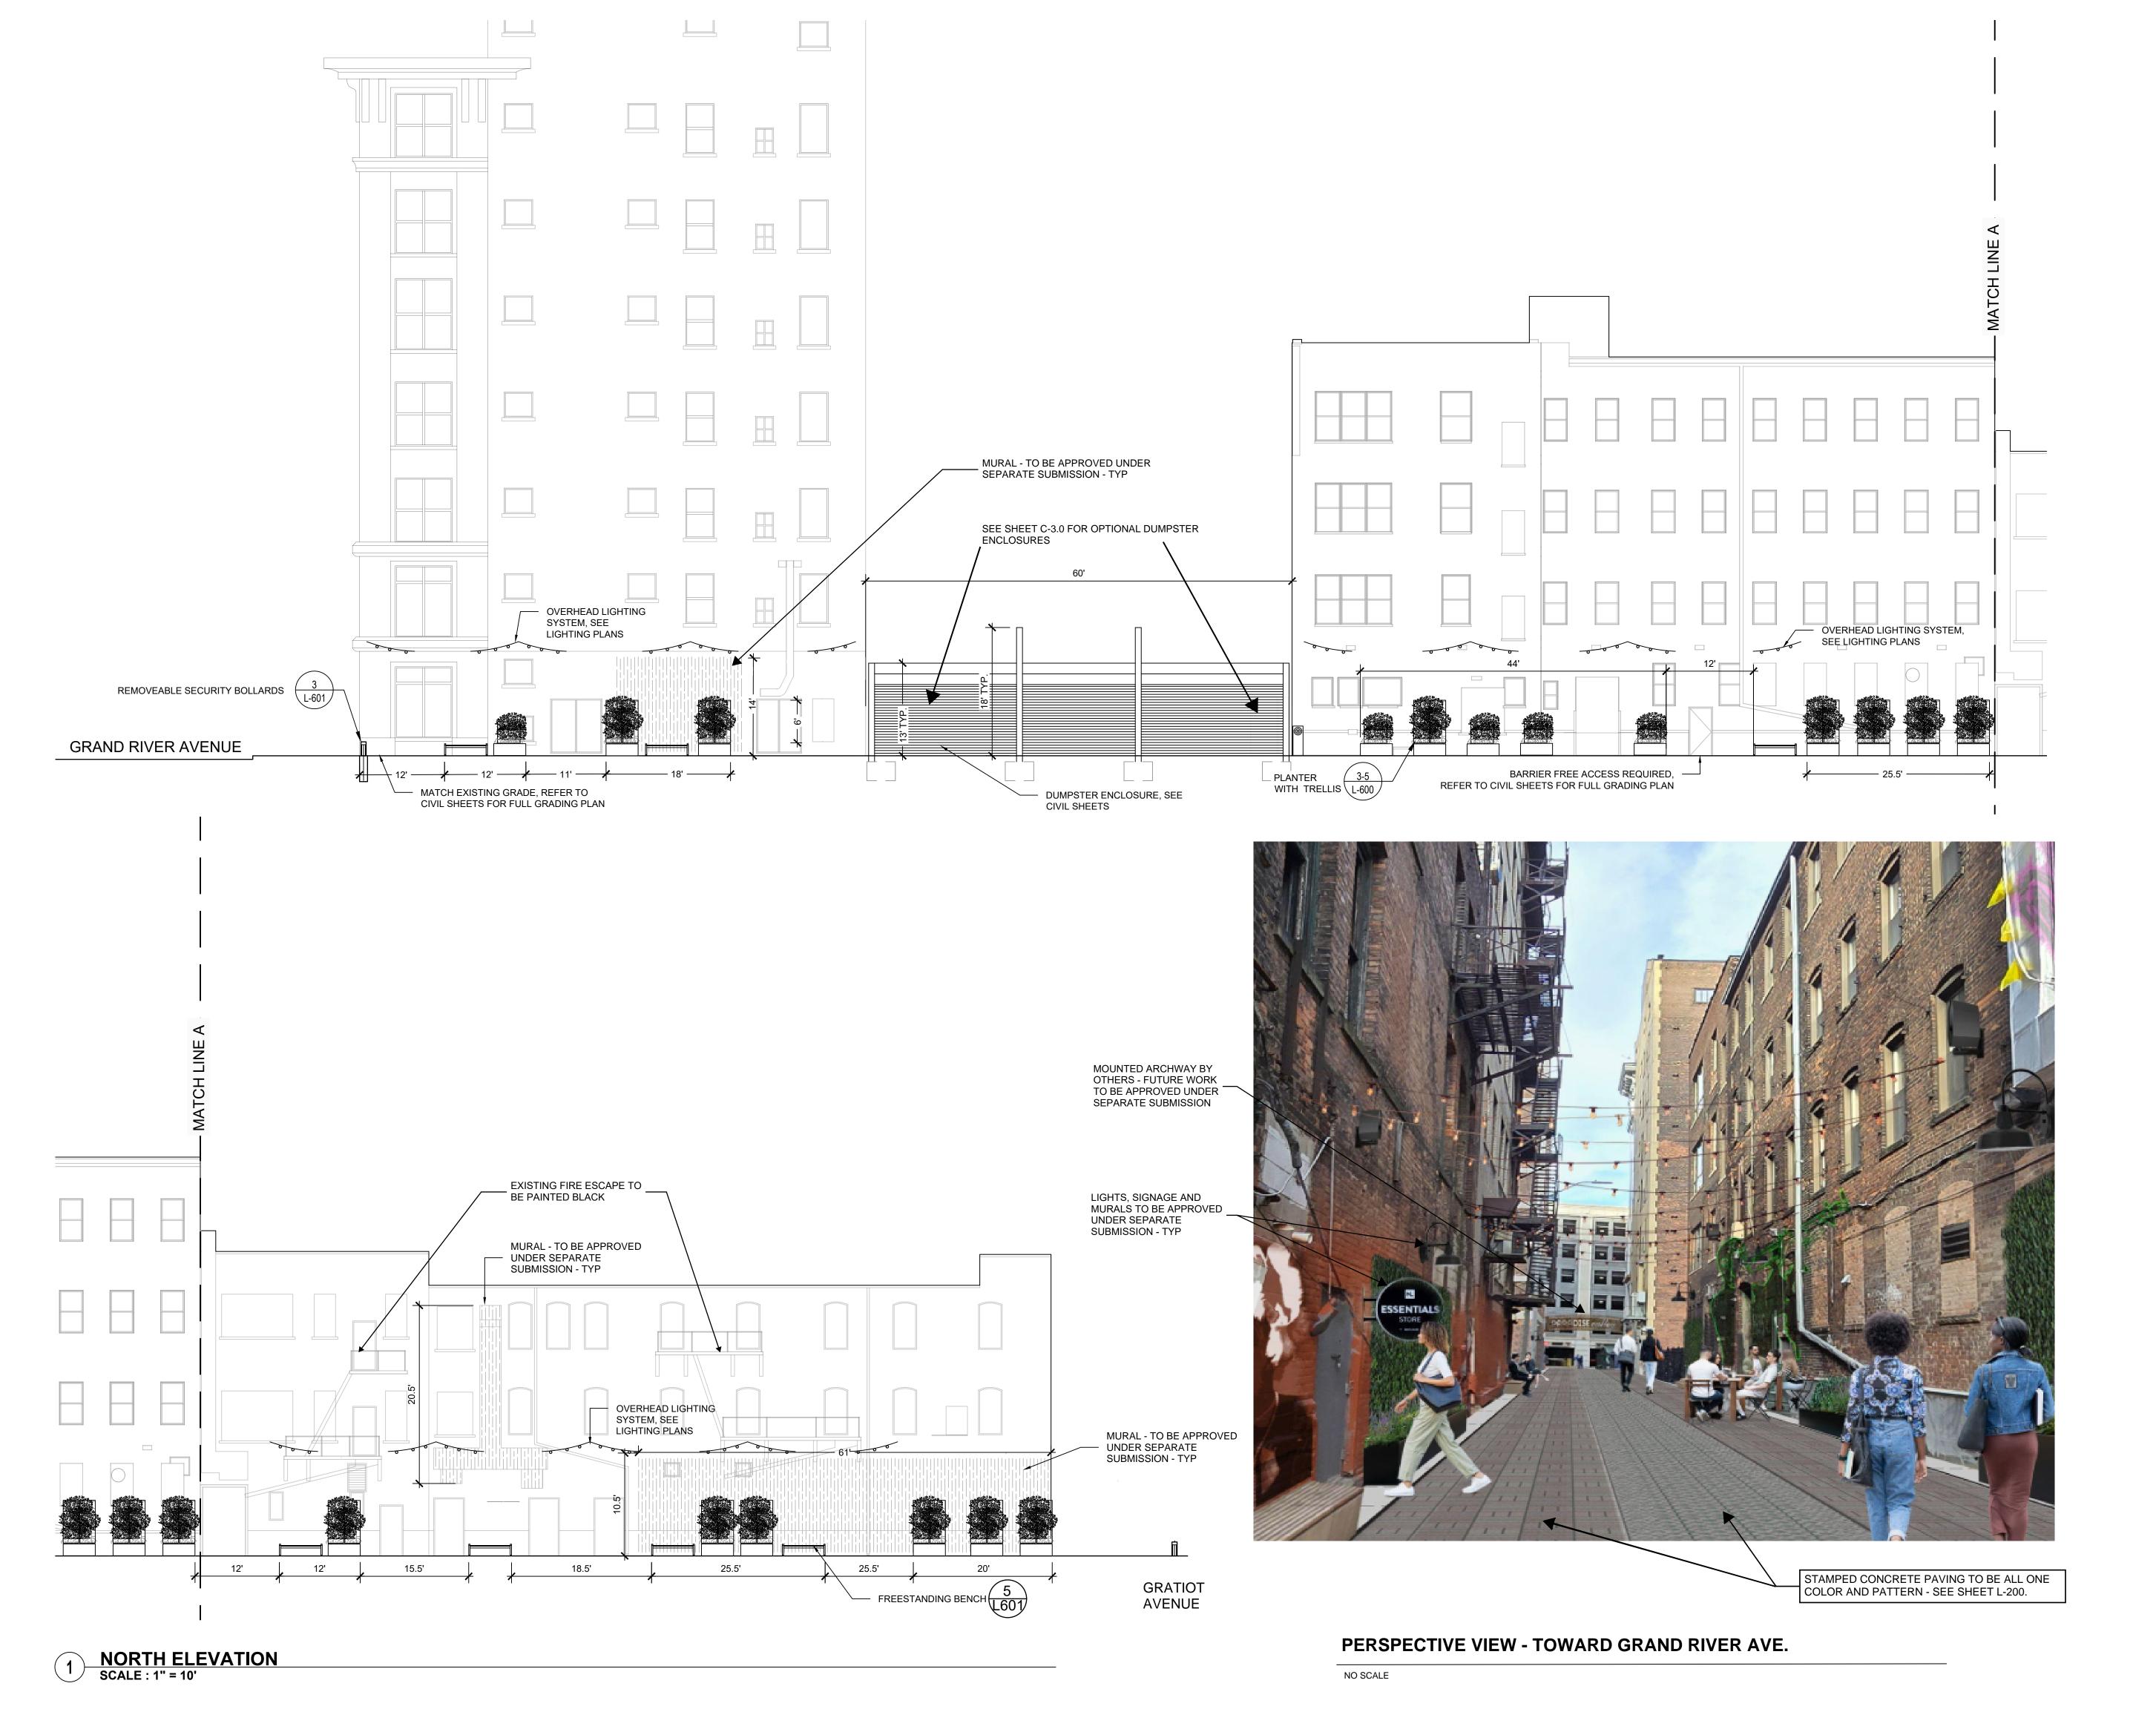

HamiltonAnderson architecture landscape architecture urban design

Hamilton Anderson Associates, Inc 1435 Randolph Suite 200 Detroit, Michigan 48226 p 313 964 0270 f 313 964 0170 www.hamilton-anderson.com

JIMA Studio 1401 Vermont St., Suite 220 Detroit, MI 48216 313.262.6880 Landscape Architecture

Civil Engineering PEA 45 W Grand River Ave., Suite 501

Detroit, MI 48226 313.769.5770

Lighting Design Illuminart 5145 Livernois Rd, Suite 100

Troy, MI 48098 248.897.5666

Electrical 5145 Livernois Rd, Suite 100 Engineering

Troy, MI 48098 248.897.5666

The Paradise Valley Cultural and Entertainment District Conservancy

13254 Common Road Warren, MI 48088

HDC SUBMISSION 11-26-2025

BID SET	07.31.2025
REVISED BID SET	08.12.2025
REVISED BID SET	09.05.2025
ADDENDUM #1	09.17.2025
PERMITS	10.17.2025

Paradise Valley Alley

Drawing Title


NORTH ELEVATION AND RENDERING


Project Number:2023035.00


Scale: AS SHOWN

Drawing No:

L-500

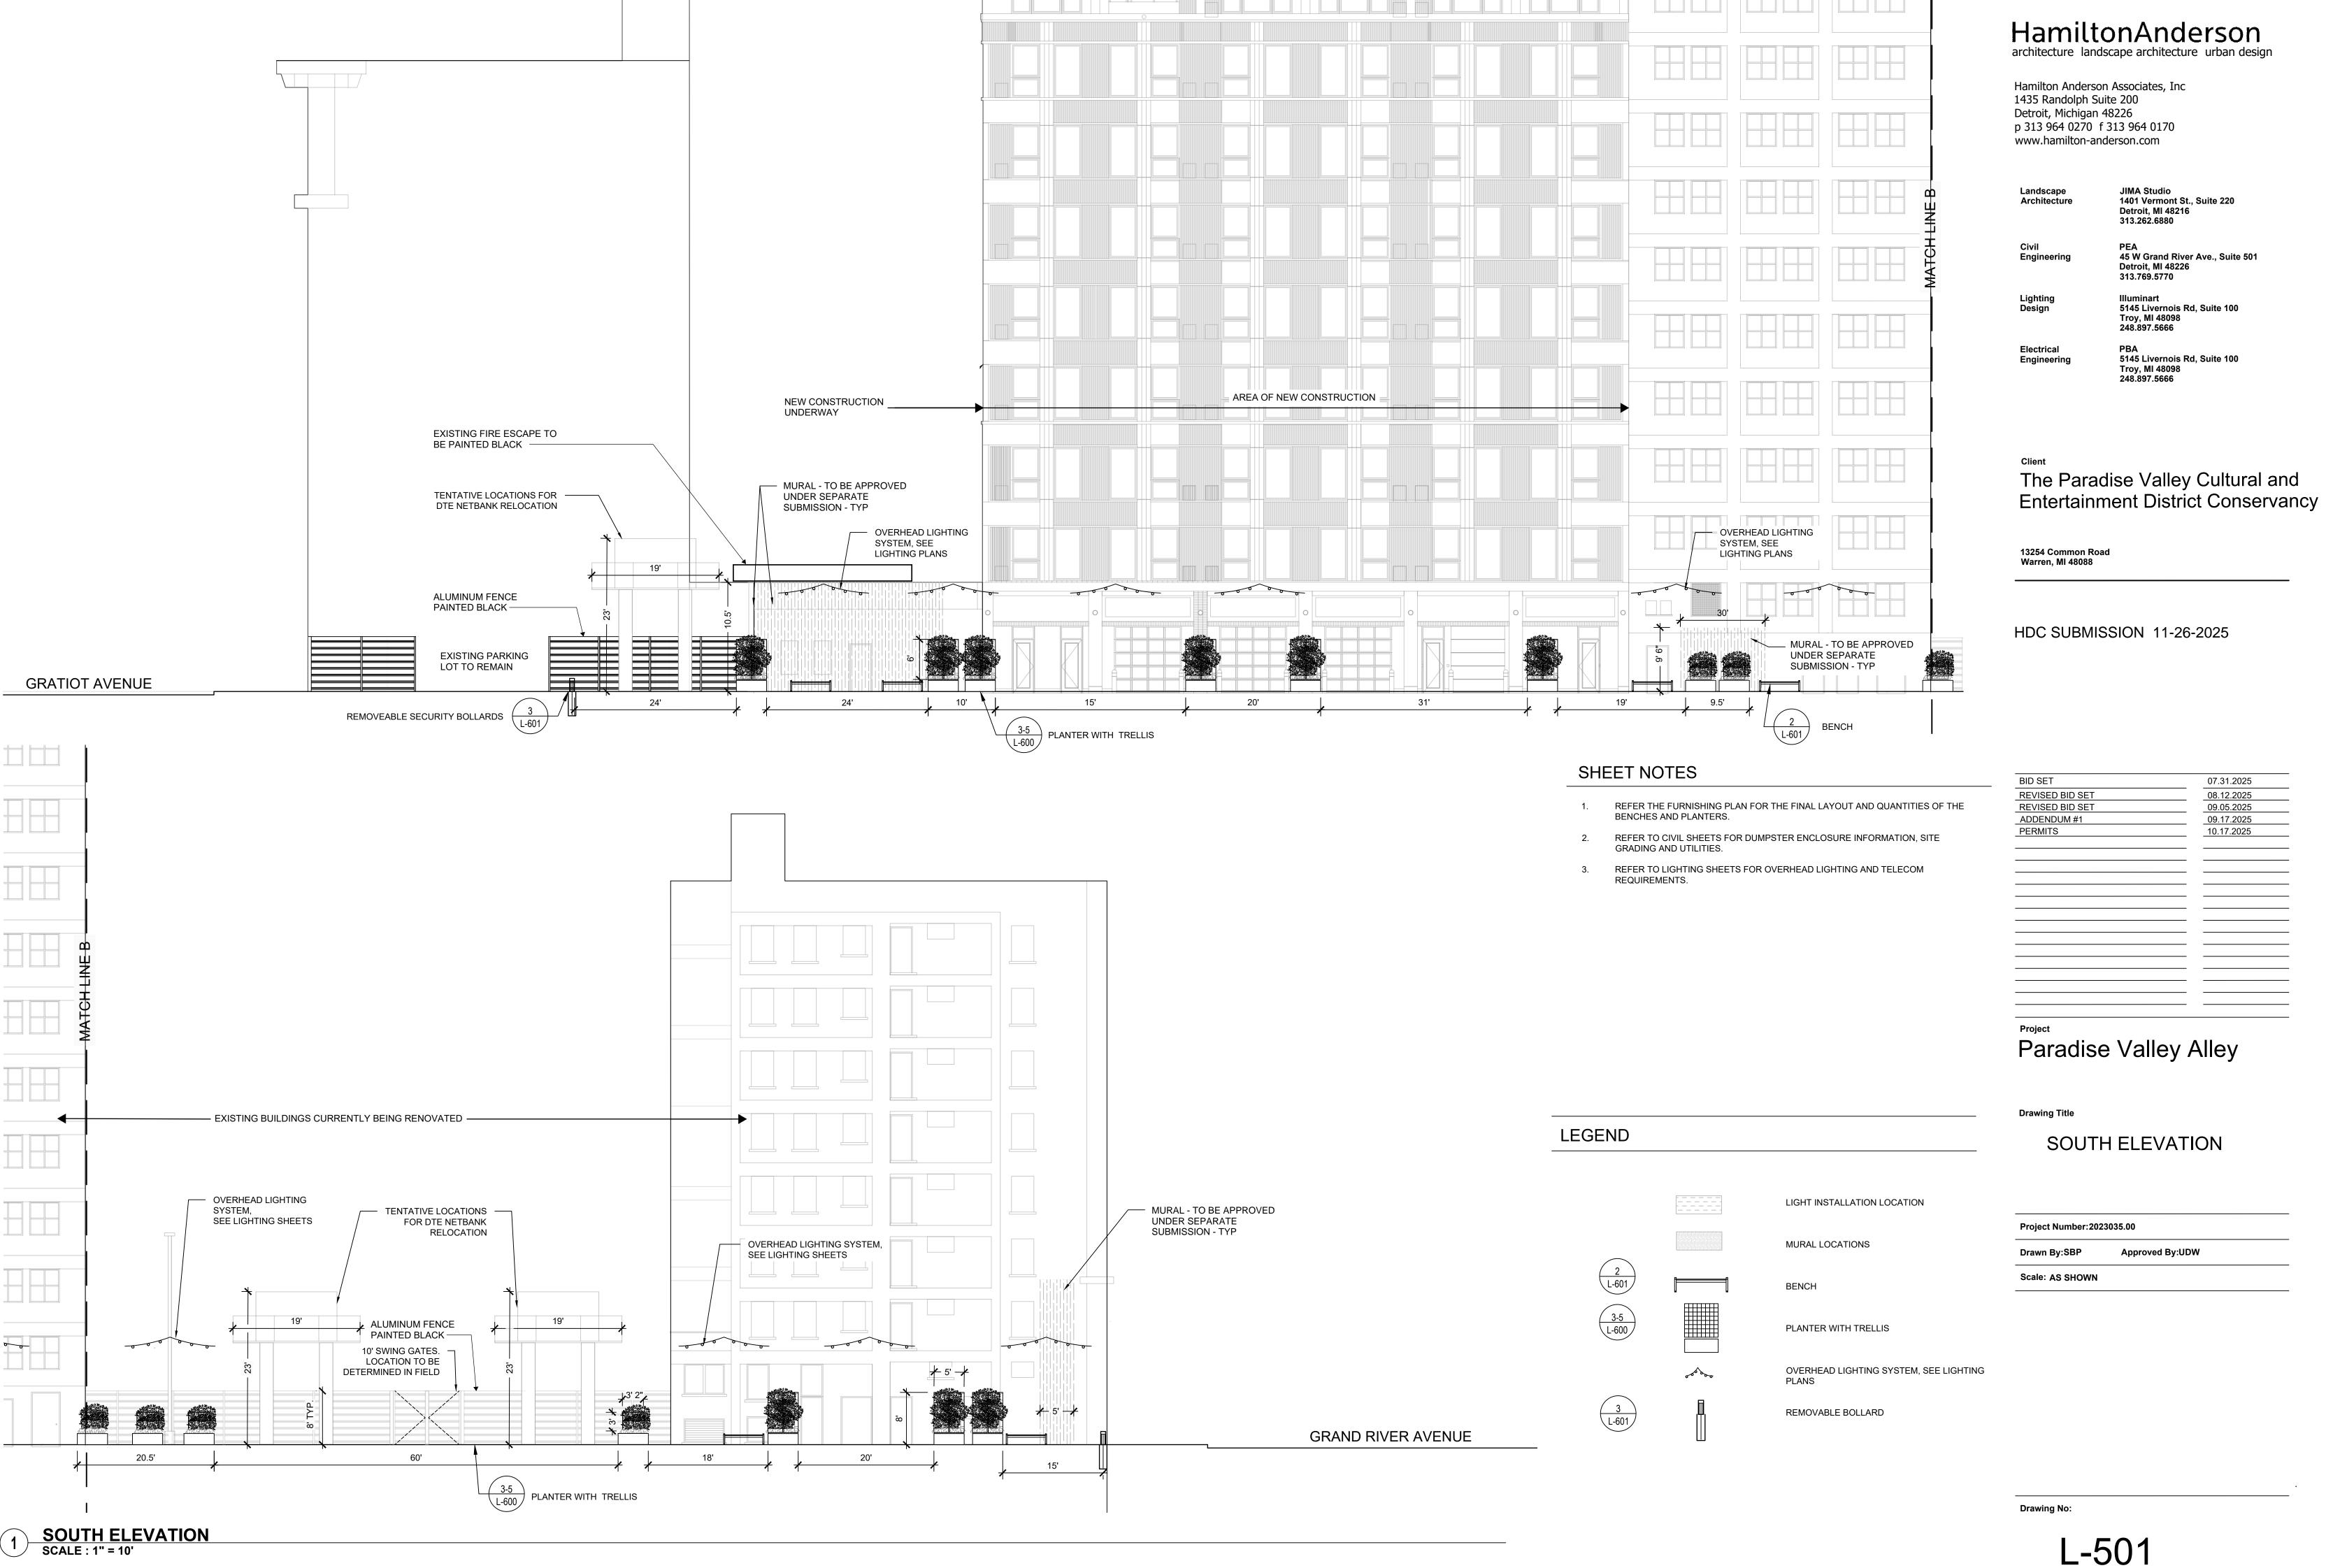

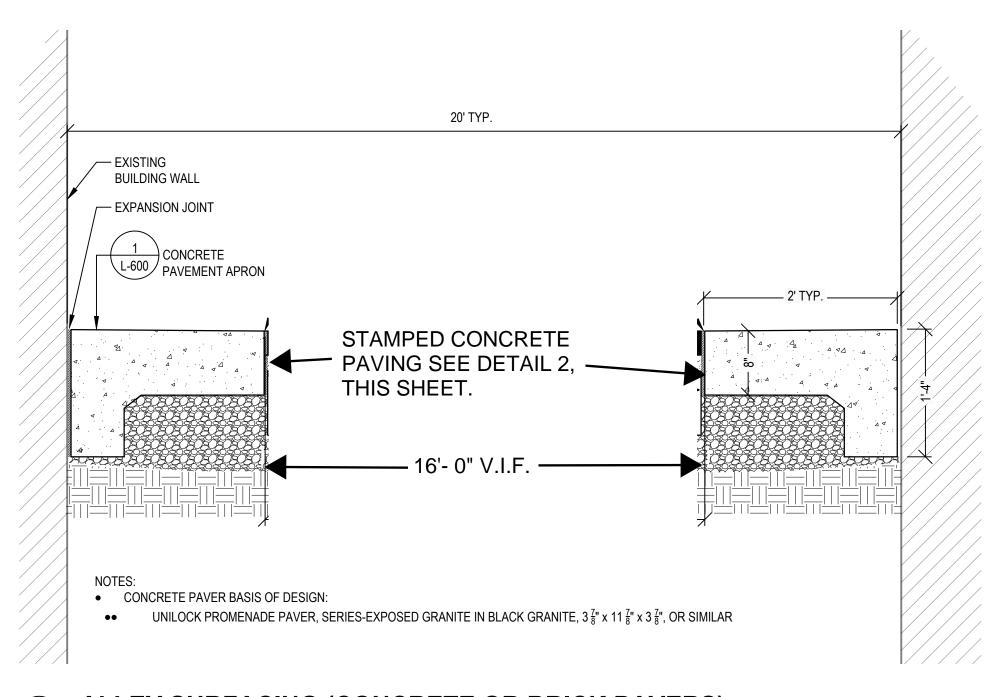


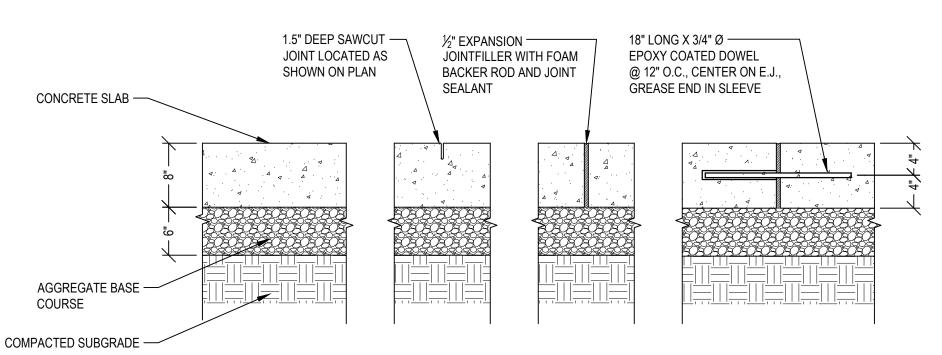

- ½" SEALED EXPANSION JOINTS SHALL BE PLACED AT ALL LOCATIONS WHERE SIDEWALK ABUTS CONCRETE
- CURB, EXISTING SIDEWALK, LIGHT POLE BASES, AND/OR RETAINING WALLS. • SAWCUTS SHOULD BE INDUSTRY STANDARD WIDTH, NO MORE THAN 1/4.
- SEE PLAN ENLARGEMENT TO FULL CONCRETE SCORING JOINT PATTERN AND JOINT TYPE LOCATIONS. CONTROL JOINT NO FURTHER THAN 10' FEET IN BOTH NS AND EW DIRECTIONS; SCORE JOINT NO FURTHER
- THAN 10' IN BOTH NS AND EW DIRECTIONS.
- SEE SPECIFICATION FOR DECORATIVE CONCRETE FINISH AND APPLICATION METHODS

ALLEY SURFACING (CONCRETE OR BRICK PAVERS)


CONCRETE PAVEMENT DETAIL (FOR STAMPED OR BROOM FINISH) SCALE: 1"=1"

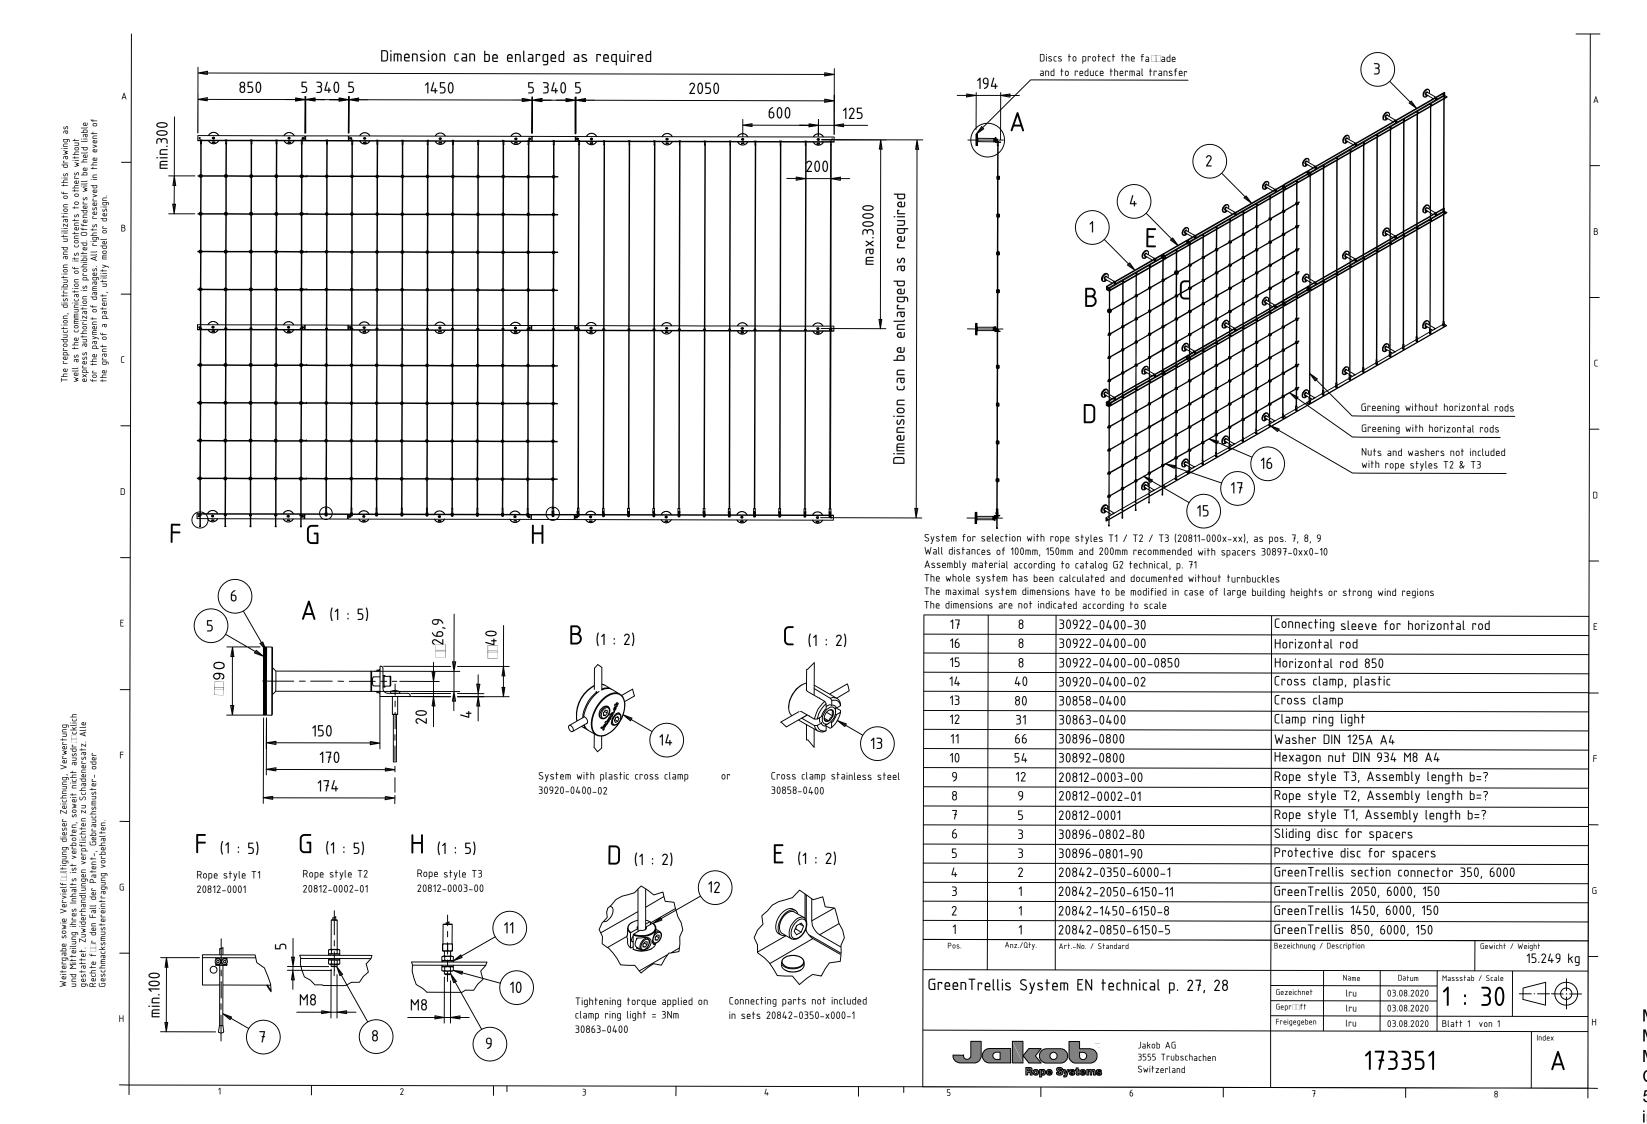

MFR: JAKOB ROBES MODEL:GREEN TRELLIS METAL:STAINLESS STEEL CONTACT: 561-330-6502 info@jakob-usa.com

TRELLIS: BASIS OF DESIGN
SCALE: NTS


• SELECT RECTANGLE 18.19"H x 54.38" L x 18.38" D. MATTE BLACK FINISH, FREE STANDING

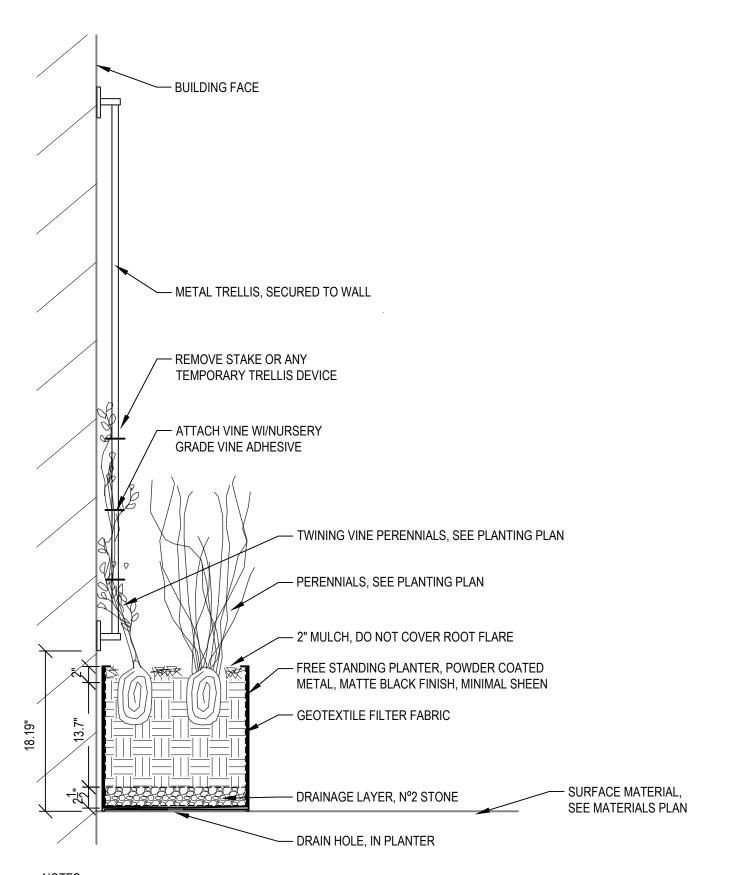

PLANTER BASIS OF DESIGN: MAGLIN 1500 SERIES PLANTER AND CONTAINER

- TRELLIS BASIS OF DESIGN: JAKOB ROPE SYSTEMS GREENKIT 26" W x 80" H AND 38" W x 80" H STAINLESS STEEL TRELLIS. SECURE TO WALL OR FENCE FOLLOWING MANUFACTURER INSTRUCTIONS.
- FIELD VERIFY PLANT LOCATIONS WITH LANDSCAPE ARCHITECT, FOLLOW PLANTING INSTRUCTIONS AS INDICATED IN PLANTING DETAILS AND NOTES.
- PLANTS: REMOVE POTS AND SEPARATE POT BOUND ROOTS AS SPECIFIED. SET ROOT FLARE (COLLAR) AT FINISH GRADE.

PERENNIALS IN PLANTER WITH TRELLIS

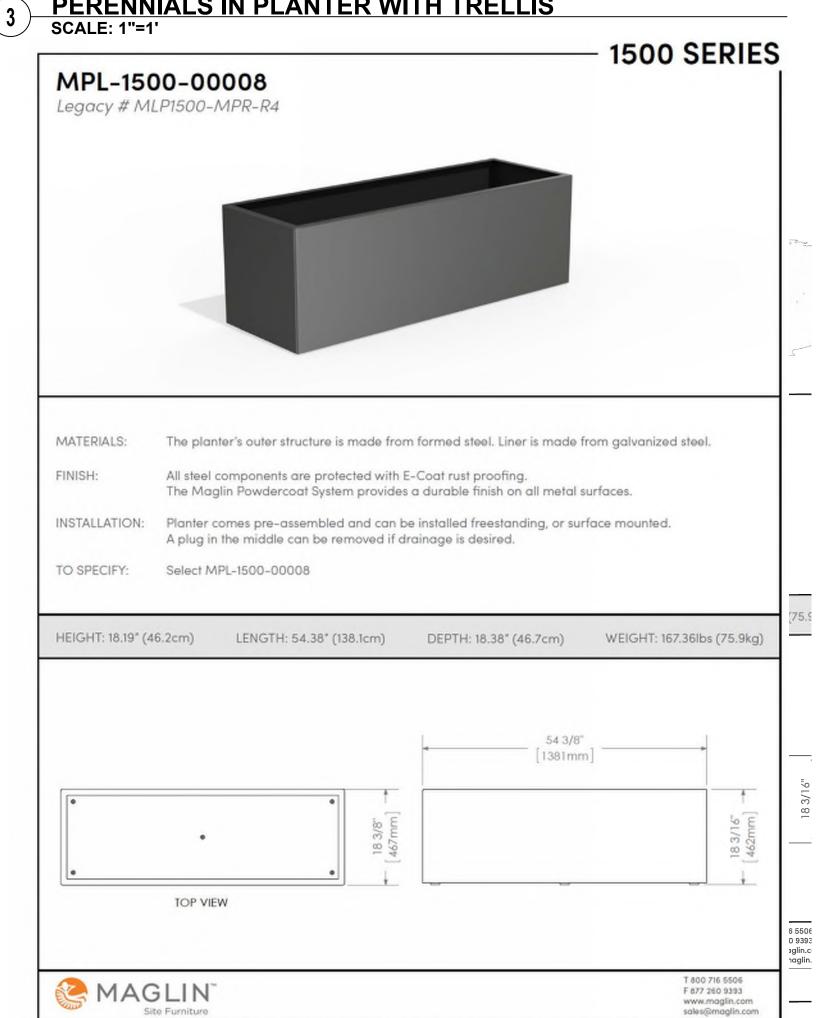

All drawings, specifications, design and details on this page remain the property of Maglin Site Furniture Inc. and may not be used without Maglin authorization.
 Details and specifications may vary due to continuing improvements of our products.

HamiltonAnderson architecture landscape architecture urban design Hamilton Anderson Associates, Inc

1435 Randolph Suite 200 Detroit, Michigan 48226 p 313 964 0270 f 313 964 0170 www.hamilton-anderson.com

Landscape 1401 Vermont St., Suite 220 Detroit, MI 48216

45 W Grand River Ave., Suite 501 Detroit, MI 48226

313.769.5770

313.262.6880

Illuminart 5145 Livernois Rd, Suite 100 Lighting

Troy, MI 48098 248.897.5666

Electrical 5145 Livernois Rd, Suite 100 Troy, MI 48098 248.897.5666

The Paradise Valley Cultural and **Entertainment District Conservancy**

13254 Common Road Warren, MI 48088

HDC SUBMISSION 11-26-2025

BID SET	07.31.2025
REVISED BID SET	08.12.2025
REVISED BID SET	09.05.2025
ADDENDUM #1	09.17.2025
PERMITS	10.17.2025

Paradise Valley Alley

Drawing Title

SITE DETAILS

Project Number:2023035.00			
Drawn By:SBP	Approved By:UDW		
Scale: AS SHOWN			

Drawing No:

L-600

PLANTER: BASIS OF DESIGN
SCALE: 1"=1'

DETAIL A SCALE 1 : 6

PAVEMENT

• SELECT SIDE OPENING, PLAIN PANEL, MATTE BLACK FINISH, BLACK LINER, FREE STANDING.

STANDING OR SURFACE MOUNT OPTONS 7/16"[11] DIA. MOUNTING HOLES HARDWARE SUPPLIED BY OTHERS





MFR: LANDSCAPE FORMS MODEL: STRATA BEAM, TABLE-LENGH BACKLESS, 21IN WIDTH, 69IN LENGTH, FREE STANDING WOOD: JARRAH (P) FOR EXTERIOR BASE: MELDSTONÉ NATURAL GRAY

The Paradise Valley Cultural and **Entertainment District Conservancy**

HamiltonAnderson

Hamilton Anderson Associates, Inc

p 313 964 0270 f 313 964 0170 www.hamilton-anderson.com

1435 Randolph Suite 200 Detroit, Michigan 48226

Landscape

Lighting Design

Electrical

architecture landscape architecture urban design

JIMA Studio 1401 Vermont St., Suite 220

45 W Grand River Ave., Suite 501

Illuminart 5145 Livernois Rd, Suite 100

5145 Livernois Rd, Suite 100 Troy, MI 48098 248.897.5666

Detroit, MI 48216 313.262.6880

Detroit, MI 48226 313.769.5770

Troy, MI 48098 248.897.5666

13254 Common Road Warren, MI 48088

HDC SUBMISSION 11-26-2025

BID SET	07.31.2025
REVISED BID SET	08.12.2025
REVISED BID SET	09.05.2025
ADDENDUM #1	09.17.2025
PERMITS	10.17.2025

Paradise Valley Alley

Drawing Title

SITE DETAILS


Project Number:2023035.00		
Drawn By:SBP	Approved By:UDW	


84 20.55% 20.55% 20.54% 20.55% 96 20.32% 20.31% 20.31% 20.32%

Aluminum

Never Needs

BENCH: BASIS OF DESIGN
SCALE: NTS

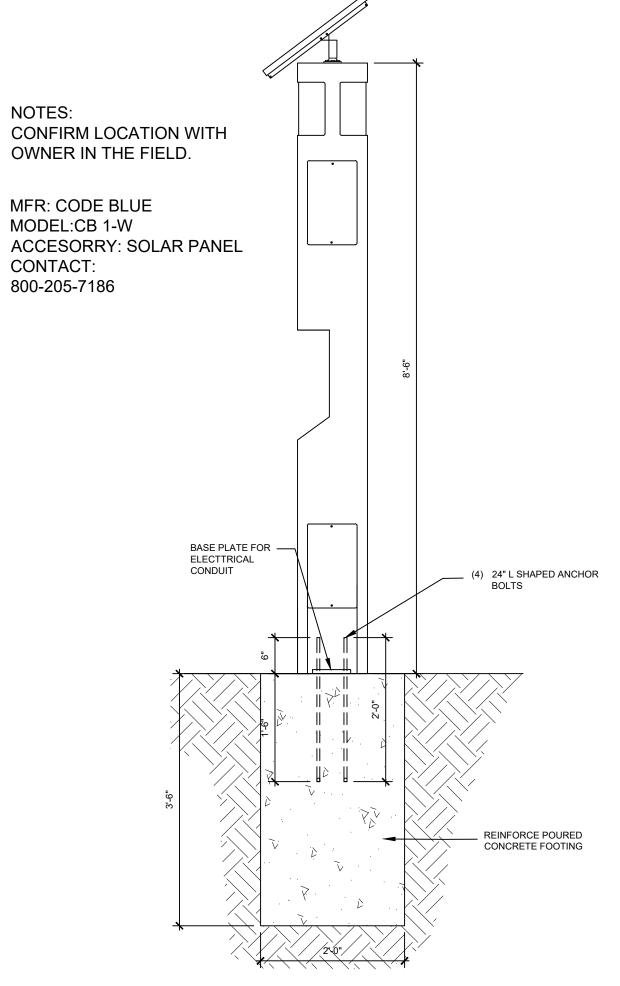


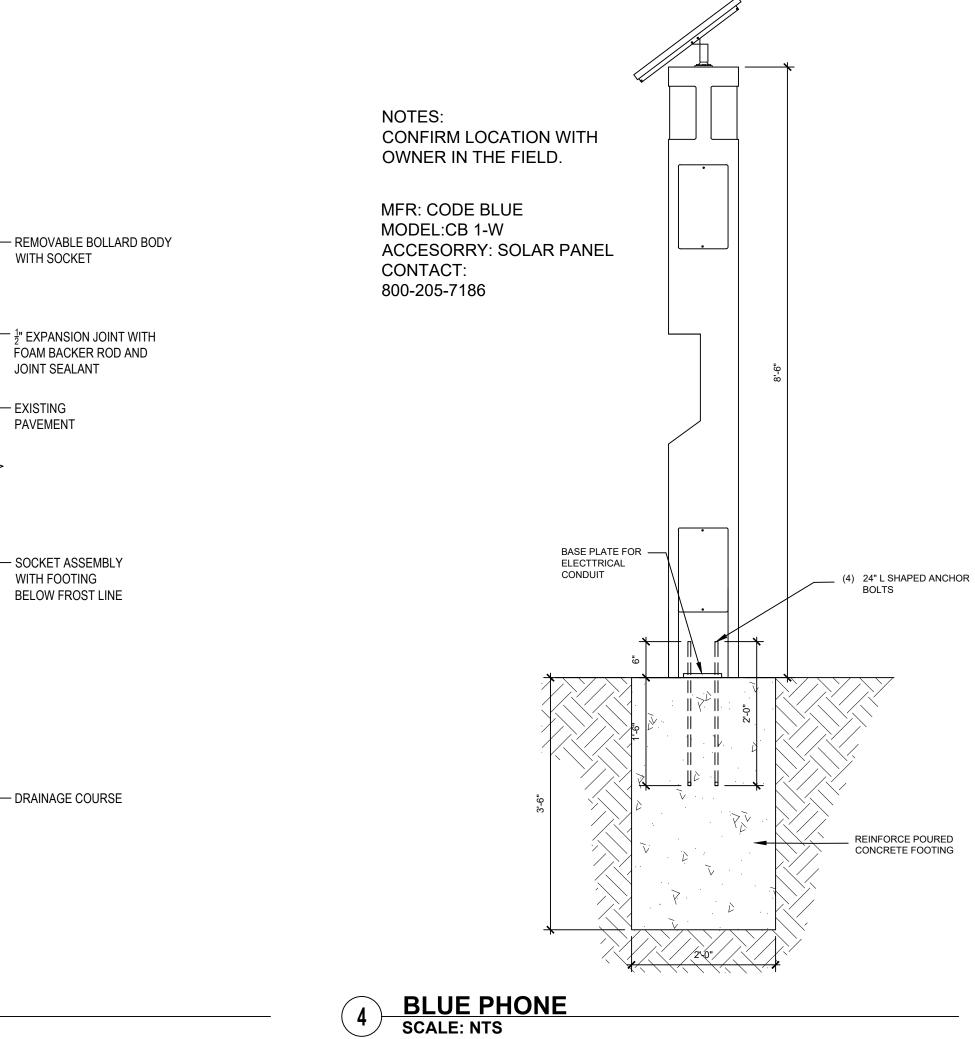

SECURITY BOLLARD
SCALE: 1"=1"

Drawing: LS602-01 Dimensions are in inches [mm]

TRASH BIN: BASIS OF DESIGN
SCALE: NTS

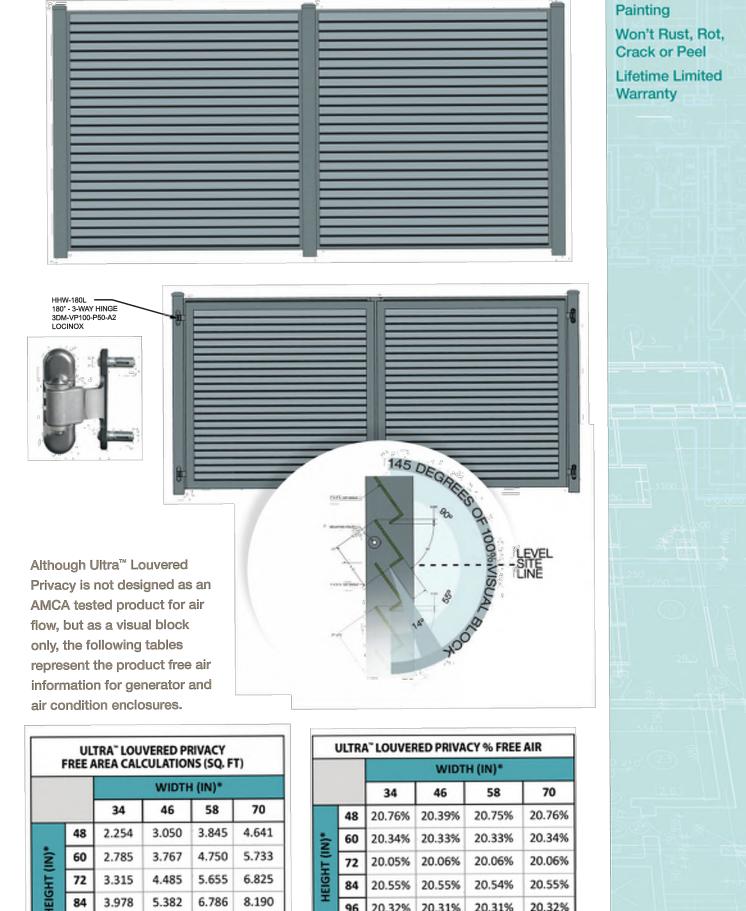

**INCLUDES PERIMETER FRAME DEDUCT

Ultra™ Louvered Privacy Panels

SELECT MATTE BLACK FINISH, MATCH THE DOORS FOR DUMPSTER ENCLOSURE

LOUVERED FENCE: BASIS OF DESIGN SCALE: N.T.S.

96 4.508 6.100 7.691 9.282

L-601

TILITY CONTACTS	
ONTRACTOR TO COORDINATE WORK	WITH UTILITY PROVIDERS:
AT&T 313-221-2121	COMCAST CABLE COMPANY 313-934-1608
DETROIT EDISON COMPANY 313-237-9000	DETROIT PUBLIC LIGHTING DEPT. 313-224-0500
DETROIT WATER AND SEWERAGE 313-833-8649	MICHIGAN CONSOLIDATED GAS COMPANY 313-965-0435

DEMOLITION LEGEND:	
ITEM TO BE PROTECTED	
ITEM TO BE REMOVED	
CURB/FENCE REMOVAL	·/·/·/·/·/·/·/·/·/·/·
PAVEMENT REMOVAL/MIXED MATERIALS	
AREA OR ITEMS TO BE REMOVED	
DE NEMOVES	
	·····
UTILITY REMOVAL	***************************************
ABANDON UTILITY	••••••
ASPHALT REMOVAL	
TREE REMOVAL	
CAWOUT LINE	
SAWCUT LINE	

GENERAL DEMOLITION NOTES:

THESE NOTES APPLY TO ALL CONSTRUCTION ACTIVITIES ON THIS PROJECT:

. ALL MATERIAL TO BE REMOVED, WHETHER SPECIFICALLY NOTED IN THE PLANS OR NOT, SHALL BE REMOVED FROM THE SITE BY THE CONTRACTOR AND DISPOSED OF OFF-SITE IN A LEGAL MANNER. NO ON-SITE BURY OR BURN PITS SHALL

2. ALL DEMOLITION WORK SHALL CONFORM TO ALL LOCAL CODES AND ORDINANCES.

3. STAGING/PHASING OF DEMOLITION AND CONSTRUCTION IS TO BE COORDINATED WITH THE OWNER AND THE CONTRACTOR PRIOR TO CONSTRUCTION.

SPECIFIC DEMOLITION ITEMS HAVE BEEN INDICATED ON THE PLANS AS A GUIDE TO THE GENERAL SCOPE OF THE WORK. IT IS THE INTENT THAT THESE ITEMS SHALL BE COMPLETELY REMOVED BY THE CONTRACTOR ABOVE AND BELOW GROUND, UNLESS SPECIFICALLY NOTED OTHERWISE, AND THAT DEMOLITION WILL INCLUDE BUT WILL NOT NECESSARILY BE LIMITED TO THESE ITEMS. CONTRACTOR SHALL VISIT SITE TO VERIFY EXISTING CONDITIONS AND EXTENTS OF THE DEMOLITION THAT WILL BE REQUIRED PRIOR TO SUBMITTING A BID.


5. REMOVE ALL STRUCTURES DESIGNATED FOR REMOVAL ACCORDING TO THE DEMOLITION PLAN. THIS INCLUDES FOUNDATIONS, FOOTINGS, FOUNDATION WALLS, FLOOR SLABS, UNDERGROUND UTILITIES, CONCRETE, ASPHALT, TREES,

THE CONTRACTOR SHALL, AS A MINIMUM, PROVIDE TREE PROTECTION FENCING AROUND EXISTING TREES TO BE SAVED THAT ARE WITHIN 15 FEET OF CONSTRUCTION ACTIVITIES AND AS INDICATED IN THE PLANS OR PER LOCAL AGENCY


. THE CONTRACTOR SHALL BE RESPONSIBLE FOR CLEAN UP, NOISE, DUST CONTROL, STREET SWEEPING AND HOURS OF OPERATION IN ACCORDANCE WITH THE LOCAL CODES.

THE CONTRACTOR SHALL PROVIDE ALL NECESSARY BARRICADES, SIGNAGE, MARKINGS, LIGHTS AND OTHER TRAFFIC CONTROL DEVICES TO PROTECT THE WORK ZONE AND SAFELY MAINTAIN TRAFFIC PER AGENCY REQUIREMENTS AND IN ACCORDANCE WITH THE LATEST EDITION OF THE STATE MANUAL OF UNIFORM TRAFFIC CONTROL DEVICES.

THE CONTRACTOR SHALL CONTACT THE APPROPRIATE UTILITY COMPANIES TO CONFIRM THAT UTILITY LEADS HAVE BEEN TAKEN OUT OF SERVICE PRIOR TO DEMOLITION.

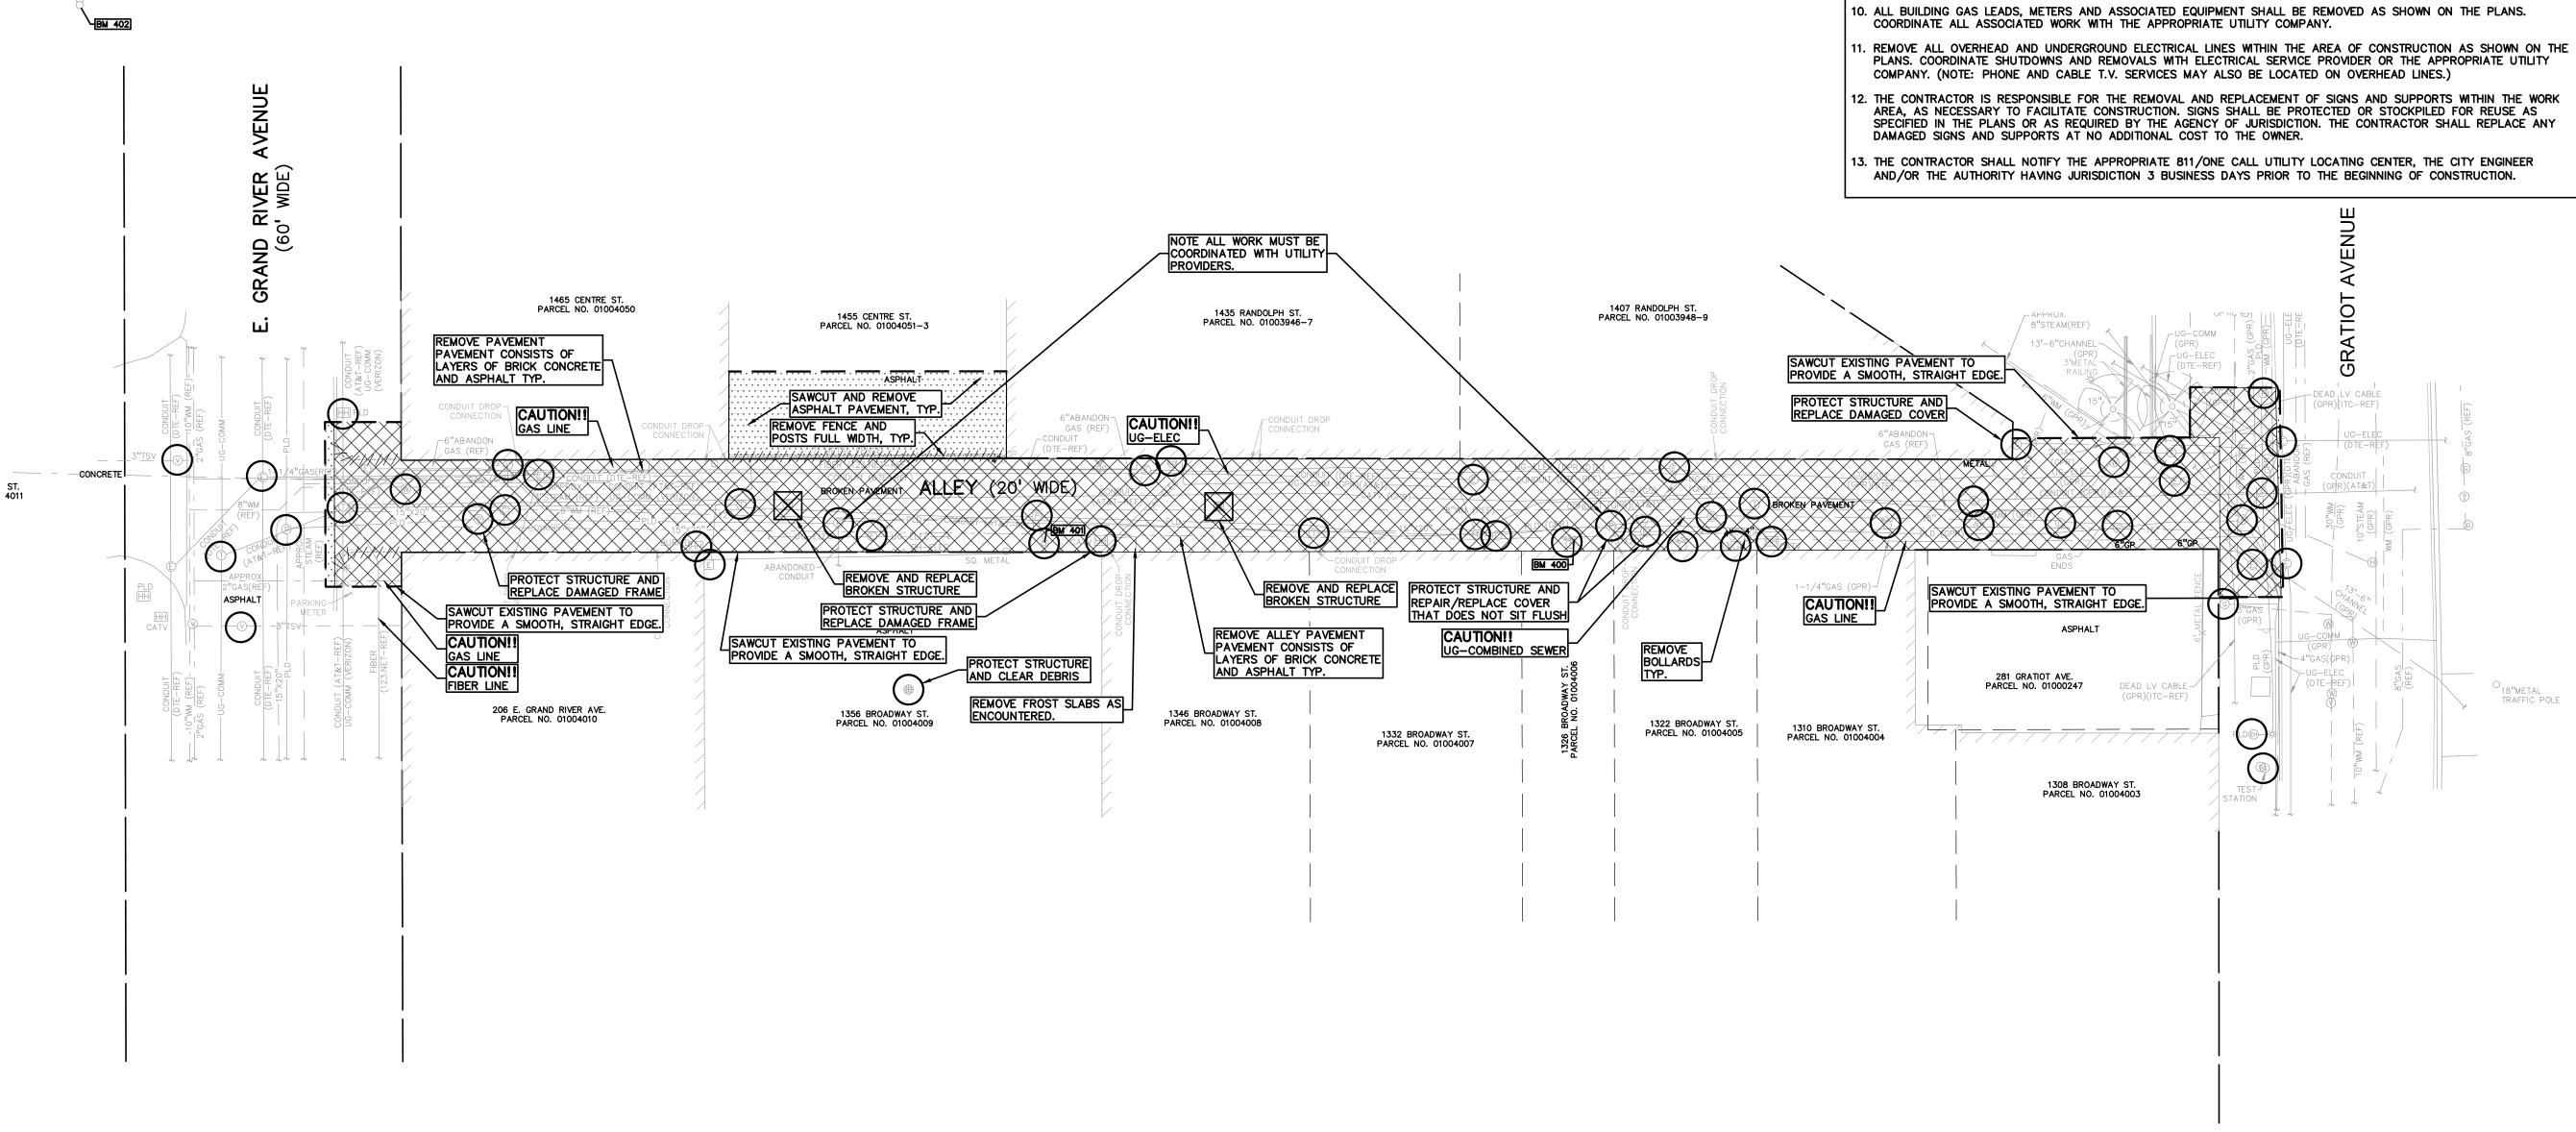



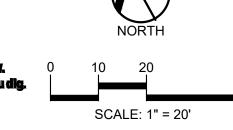

HamiltonAnderson

Hamilton Anderson Associates, Inc 1435 Randolph Suite 200 Detroit, Michigan 48226 p 313 964 0270 f 313 964 0170 www.hamilton-anderson.com

PEA Group 45 W Grand River Ave., Suite 501 Detroit, MI 48226 313.769.5770

> Illuminart 5145 Livernois Rd, Suite 100 Troy, MI 48098 248.897.5666

Electrical 5145 Livernois Rd, Suite 100 Troy, MI 48098 248.897.5666

The Paradise Valley Cultural and **Entertainment District Conservancy**

13254 Common Road Warren, MI 48088


HDC SUBMISSION 11-26-2025


100% DESIGN DEVELOPMENT	08.23.2024
BID SET	07.31.2025
REVISED BID SET	08.12.2025
REVISED BID SET	09.05.2025
ADDENDUM #1	09.17.2025
PERMITS	10.17.2025
	_
	-
	_
	-
	_
	_
	_
	—
	_
	_
	_
	_

Paradise Valley Alley

Drawing Title **DEMOLITION PLAN**

Project Number: 2023035.00 Drawn By: CNR/RDW Approved By: ESB Scale: 1"=20'

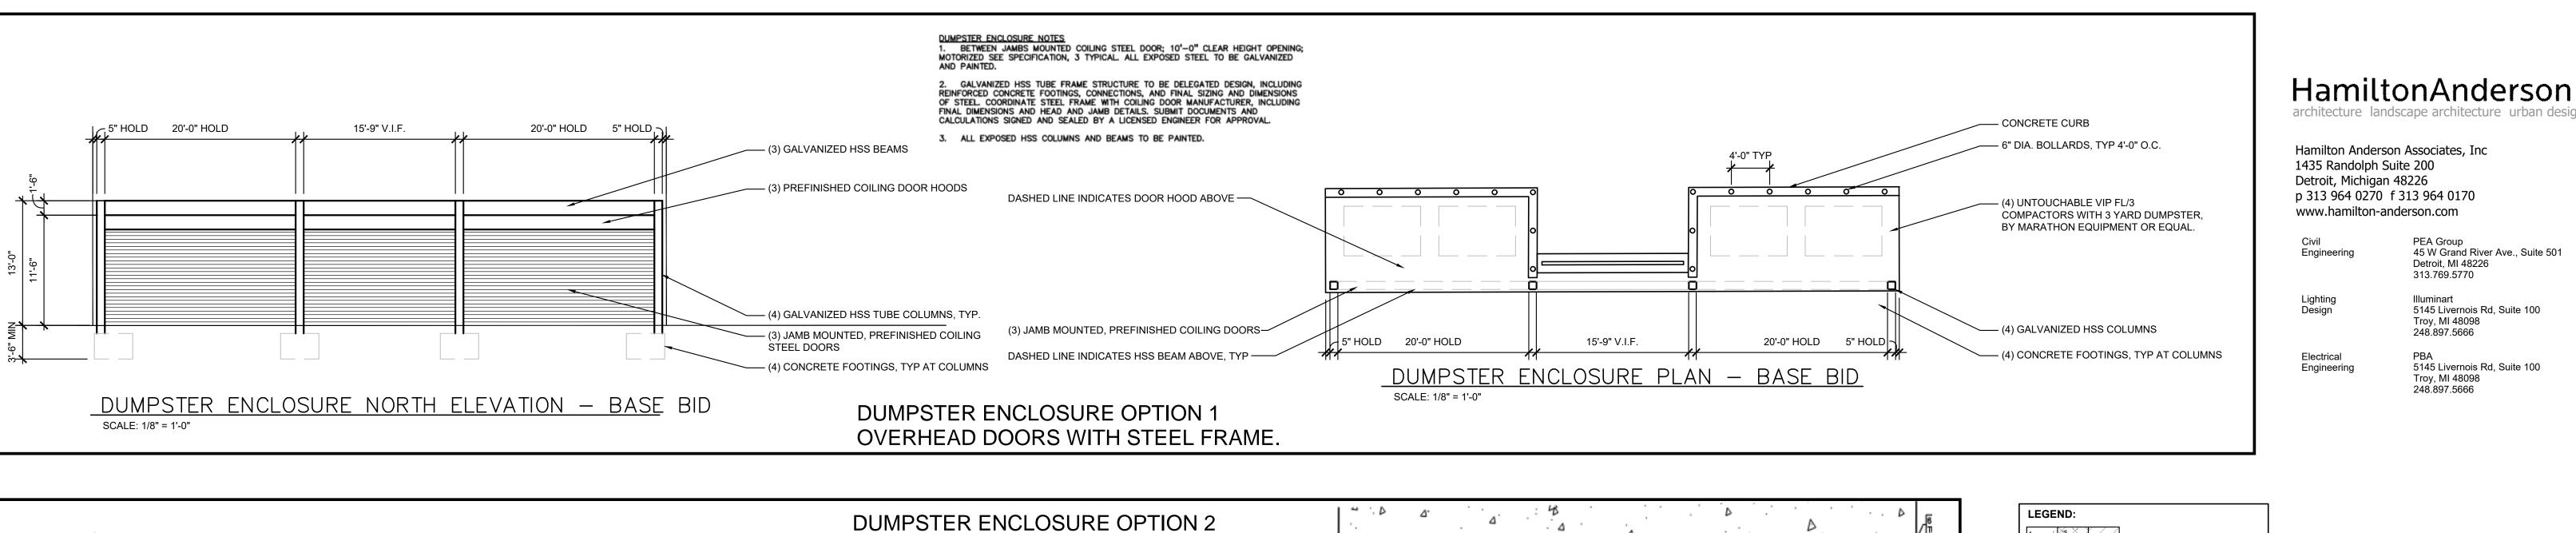

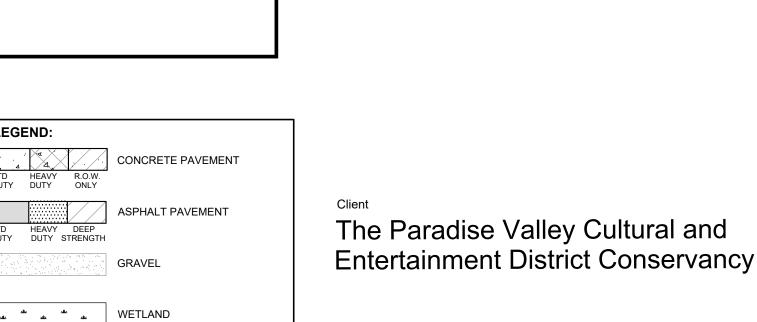

REVERSE GUTTER PAN

LIGHTPOLE

— — · · · — SETBACK LINE

—————— FENCE GUARD RAIL

60,21

ALTERNATE DOUBLE DUMPSTER ENCLOSURE DETAIL

13254 Common Road Warren, MI 48088

HDC SUBMISSION 11-26-2025

PEA Group

Illuminart

Detroit, MI 48226 313.769.5770

Troy, MI 48098


248.897.5666

Troy, MI 48098 248.897.5666

45 W Grand River Ave., Suite 501

5145 Livernois Rd, Suite 100

5145 Livernois Rd, Suite 100

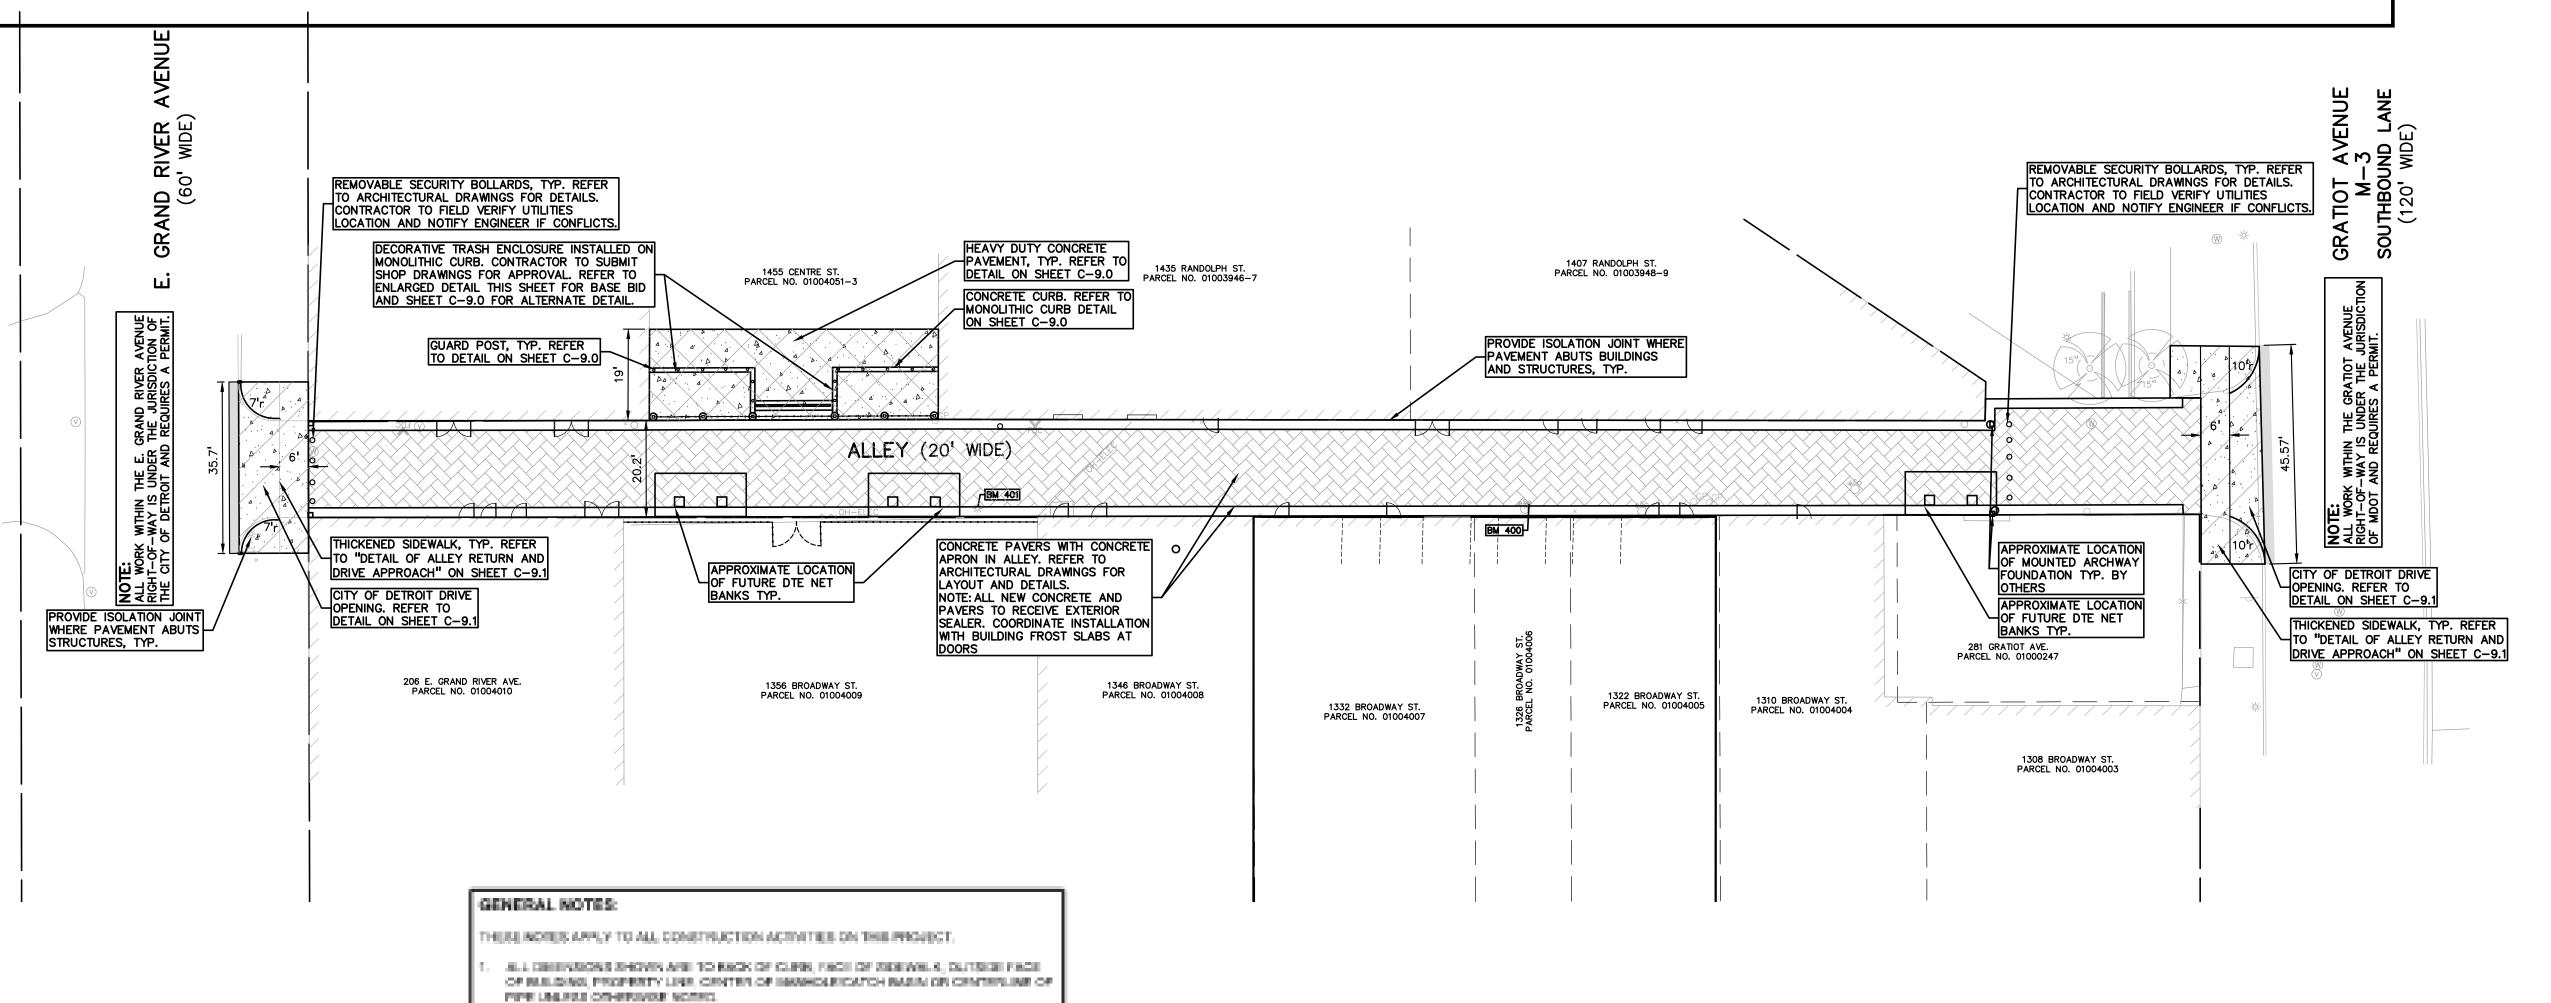

SWING GATES WITH LOUVER

SCREENING TO MATCH NEW FENCING

EXISTING BUILDING

- ALUMINUM FENCE

AND SWING GATES

THE PARKING FIRE LAND SHOWS SHALL BE POSTED ALDRESTALL FIRE LANDS AT 150 FORM

INTERNALS OR AS DIRECTED BY THE PIPE OFFICIAL.

PREFER TO NOTES & DETAILS SHEET FOR ONSITE PAYING DETAILS.

REFER TO NOTES A DETAILS SHEET FOR OWSITE SIDOWALK RAMP DETAILS.


PAINTED BLACK

8'Hx6" STL. TUBE COLUMN (TYP. AT GATES.)

INSTALL 1" DROP LATCH, TYP.

GATES TO MATCH NEW SITE FENCING. REFER TO LANDSCAPE PLANS


FRONT ELEVATION

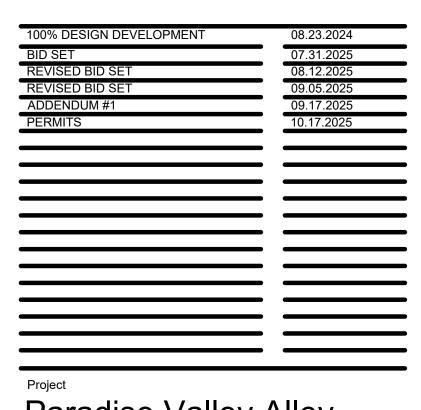


Paradise Valley Alley

Drawing Title **DIMENSION AND** PAVING PLAN

Project Number: 2023035.00 Drawn By: CNR/RDW Approved By: ESB Scale: 1"=20'

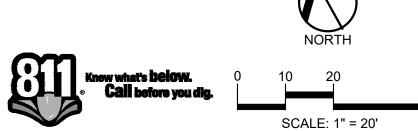

THE FOLLOWING DIMENSION EQUALS
ONE INCH WHEN PRINTED TO SCALE.

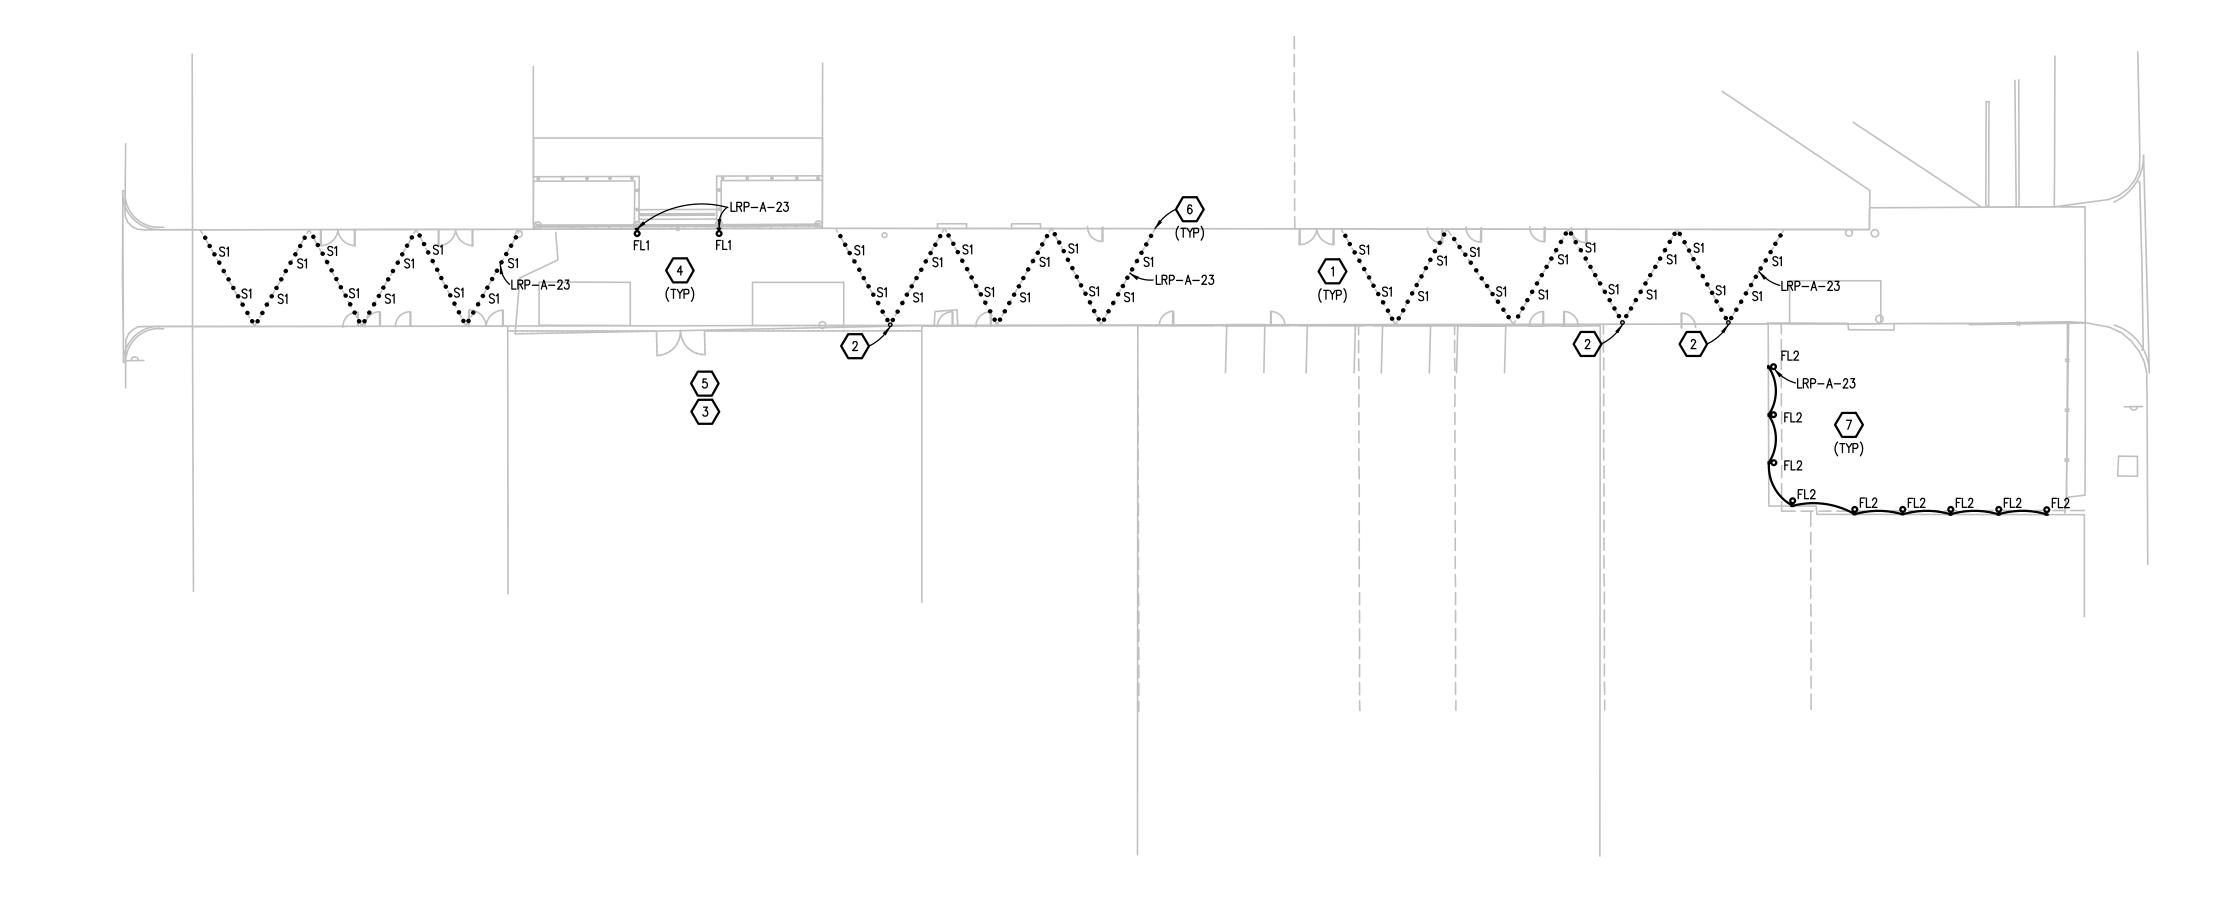





Know what's below.

Call before you dig.



Polycarbonate Globe with flammability rating UL 94V-2

Light Sources include LEDs and Xenon lamps

Flexible Conductors #12 AWG stranded and plated wire

Two O-Rings on each globe for weatherproof seal

Sockets permanently fastened to cable with sealant

Insulation is flexible PVC with flammability rating UL 94 HB

STRING LIGHT DETAIL

NO SCALE

SITE PLAN GENERAL NOTES:

- 1. THESE NOTES ARE GENERIC GUIDELINES ONLY. ELECTRICAL CONTRACTOR'S PERSONNEL ON SITE SHALL BE THOROUGHLY FAMILIAR WITH THE PUBLISHED SPECIFICATIONS FOR EXACT DESCRIPTIONS OF SCOPE, METHODS, AND MATERIAL.
- 2. THESE DRAWINGS REPRESENT THE GENERAL EXTENT AND ARRANGEMENT OF SYSTEMS. COORDINATE EXACT EQUIPMENT LOCATIONS, ELEVATIONS, AND FINAL CONNECTION REQUIREMENTS. PROVIDE EACH SYSTEM COMPLETE, INCLUDING ALL NECESSARY COMPONENTS, FITTINGS AND OFFSETS.
- 3. CONDUCT A SURVEY TO IDENTIFY ALL UNDERGROUND UTILITIES. CALL 811 PRIOR TO EXCAVATION.
- 4. UTILITIES SHOWN ON THESE DRAWINGS ARE FOR REFERENCE ONLY. COORDINATE EXACT LOCATION OF ALL EXISTING UTILITIES, AND ROUTING OF ALL NEW UNDERGROUND UTILITIES PRIOR TO EXCAVATION.
- 5. DEWATER TRENCHES PRIOR TO INSTALLATION OF CONDUITS. PROVIDE WATER TIGHT FITTINGS ON ALL UNDERGROUND CONDUITS.
- 6. COORDINATE DEMOLITION WORK, AND ELECTRICAL AND TELEPHONE SERVICES TO THE SITE, WITH THE RESPECTIVE LOCAL UTILITY COMPANY REPRESENTATIVES PRIOR TO COMMENCEMENT OF WORK. INCLUDE ALL ASSOCIATED COST/FEES BY THE UTILITY COMPANIES IN THE BID PRICE.
- 7. INSTALL UNDERGROUND CONDUITS 42" BELOW FINISHED GRADE, MINIMUM, UNLESS NOTED OTHERWISE.
- 8. COORDINATE SERVICE SHUT-DOWNS WITH ALL TRADES INVOLVED ON SITE AND OBTAIN WRITTEN AUTHORIZATION FROM OWNER 72 HOURS PRIOR TO ANY ELECTRICAL AND/OR TELEPHONE SHUT-DOWN.
- 9. REMOVE ALL DE—ENERGIZED CONDUCTORS FROM SITE AT COMPLETION OF THE PROJECT.
- 10. OUTDOOR LIGHTING BRANCH CIRCUIT WIRING SHALL BE MINIMUM #8 AWG CONDUCTORS (XHHW-2), IN MINIMUM 1" DIA. CONDUIT, UNLESS NOTED OTHERWISE.
- 11. SPARE CONDUITS SHALL INCLUDE PULL STRING AND SHALL BE TERMINATED WITH A
- 12. EXCAVATE THE ENTIRE LENGTH OF TRENCH TO PROPERLY SET DUCT ELEVATIONS.

***** CONSTRUCTION KEY NOTES:

- 1. TYPE S1 STRING LIGHTING. MOUNTING AND POWER ACCESSORIES TO BE COORDINATED BY CONTRACTOR.
- 2. STRING LIGHTING IS POLE MOUNTED IN LOCATIONS WHERE BUILDING WALL MOUNTING IS NOT FEASIBLE. EXACT LOCATION TO BE DETERMINED. CONTRACTOR TO COORDINATE POLE REQUIREMENTS AND FINAL LOCATIONS, AND COORDINATE STRUCTURAL INTEGRITY
- 3. COORDINATE ADDITIONAL POWER AND CONTROL CAPACITY AND MOUNTING LOCATIONS FOR PRODUCTION EQUIPMENT ANTICIPATED FOR SPECIAL EVENTS INCLUDING
- 4. FLOOD DOWNLIGHTS MOUNTED TO POSTS 16'-0" A.F.G. AND AIMED STRAIGHT DOWN. FIXTURE TYPE FL1 IS THE BASIS OF DESIGN.
- 5. OUTDOOR RATED AUDIO-VISUAL PROJECTOR BY OTHERS..

REVIEW. ASSUME 18" BASE FOR PRICING.

- 6. STRING LIGHTING CABLING AND HARDWARE TO BE COORDINATED WITH LIGHTING MANUFACTURER. MOUNT AT APPROXIMATELY 18'-0" A.F.G. FOR MINIMUM CLEARANCE HEIGHT OF 16'-0" A.G. CONTRACTOR TO COORDINATE FULL SERVICE DELEGATED DESIGN, INCLUDING FINAL BUILDING MOUNTING LOCATIONS TO AVOID CONFLICTS IN FIELD, AND VERIFICATION OF STRUCTURAL INTEGRITY TO BE PROVIDED WITH STRING LIGHTING SYSTEM.
- 7. TYPE FL2: ADJUSTABLE WALL MOUNTED FLOOD LIGHTS 10'-0" A.F.G. SPACED EVENLY ALONG WALL AND AIMED STRAIGHT DOWN. COORDINATE MOUNTING LOCATIONS WITH BUILDING ELEMENTS.

HamiltonAnderson
architecture landscape architecture urban design

Hamilton Anderson Associates, Inc 1435 Randolph Suite 200 Detroit, Michigan 48226 p 313 964 0270 f 313 964 0170 www.hamilton-anderson.com

Engineerir

PEA 45 W Grand River Ave., Suite 501 Detroit, MI 48226 313.769.5770

Lighting Design Illuminart 5145 Livernois Rd, Suite 100 Troy, MI 48098 248.897.5666

Electrical Engineerir

5145 Livernois Rd, Suite 100 Troy, MI 48098 248.897.5666



PBA Project No.: 2024.0248

The Paradise Valley Cultural and Entertainment District Conservancy

13254 Common Road Warren, MI 48088

HDC SUBMISSION 11-26-2025

 Permits
 10/17/2025

 Addendum #1
 09/17/2025

 Bid Set
 09/05/2025

 Progress Set
 08/27/2025

 Progress Set
 07/09/2025

08/23/2024

Paradise Valley Alley

100% Design Development

Drawing Title
LIGHTING PLAN

Project Number: 2023035.00


Drawn By: ANS Approved By: RMW

Scale: 1/20"=1'-0"

Drawing No:

E2.1

THE FOLLOWING DIMENSION EQUALS ONE INCH WHEN PRINTED TO SCALE.

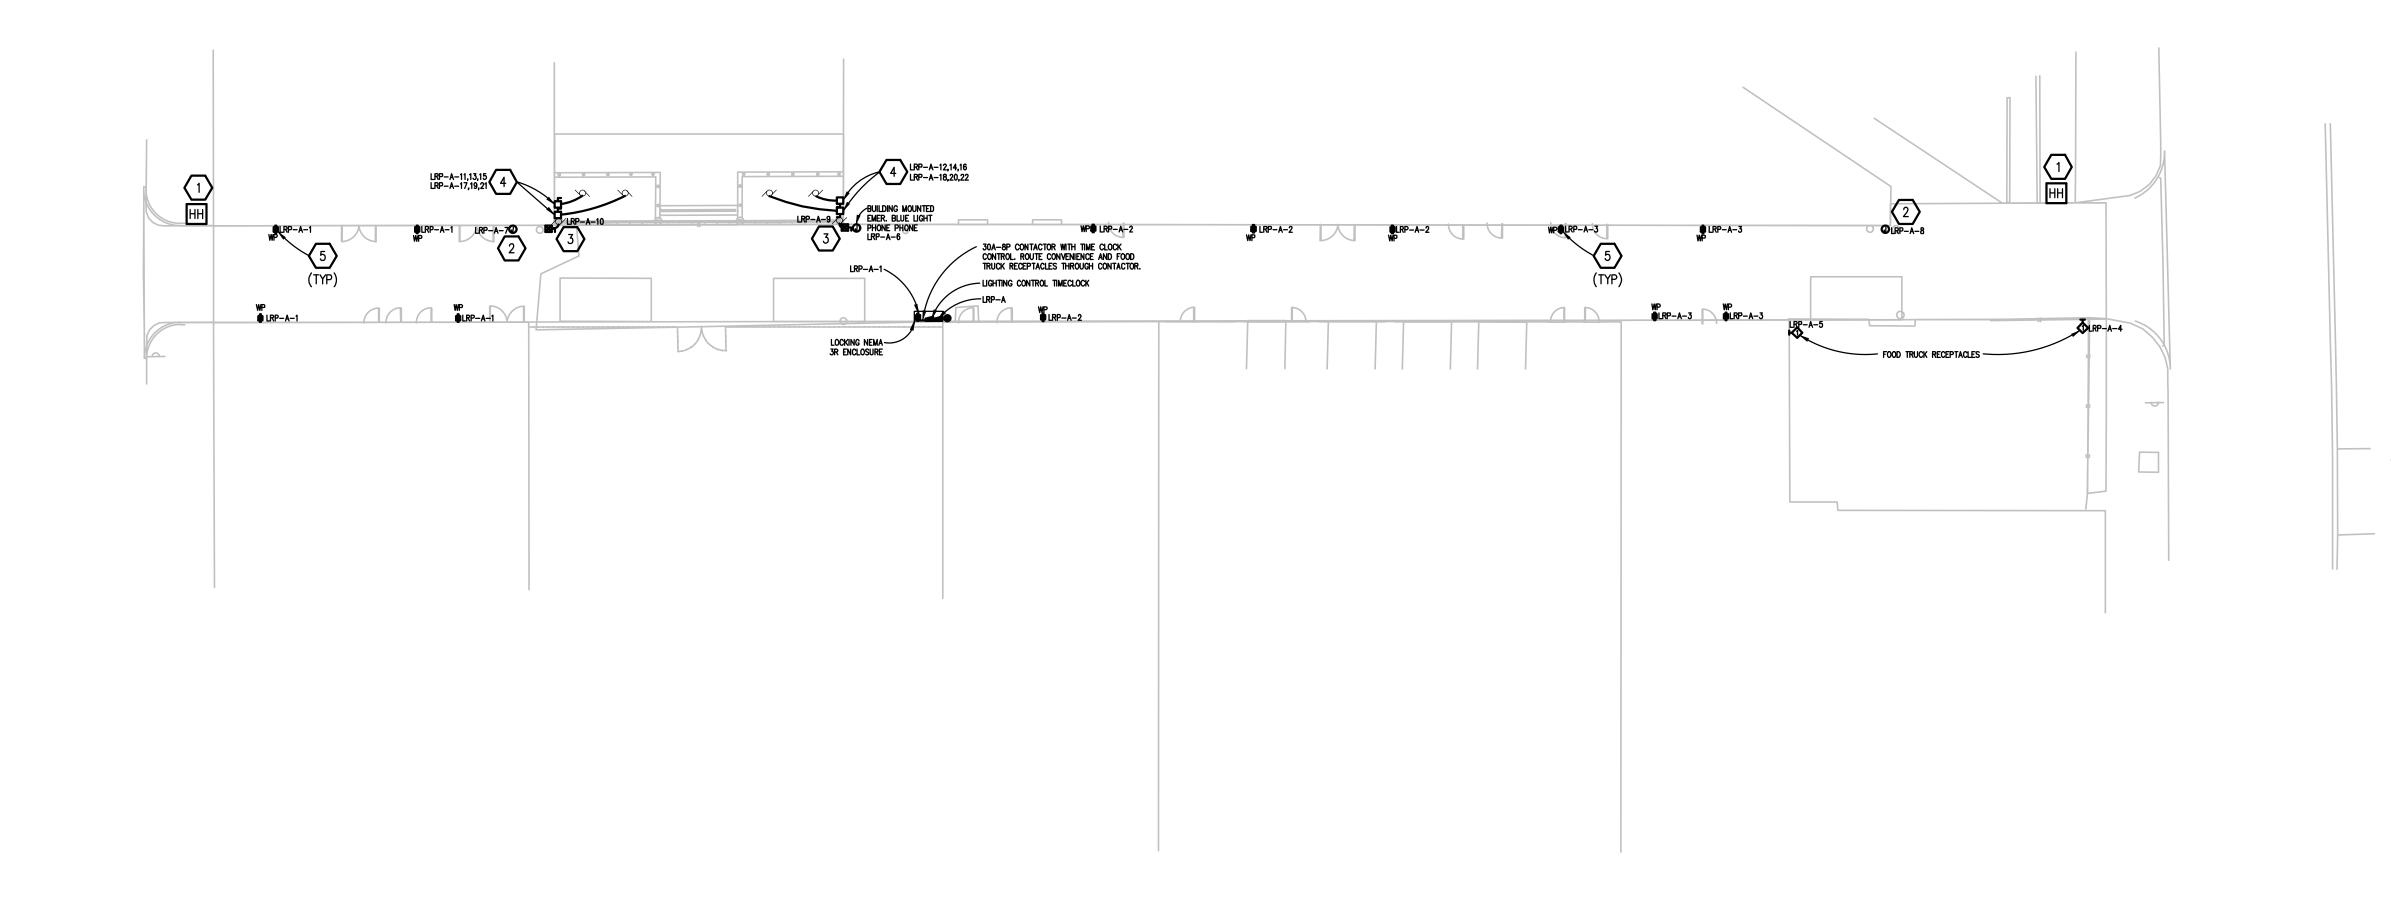





SITE PLAN GENERAL NOTES:

- 1. THESE NOTES ARE GENERIC GUIDELINES ONLY. ELECTRICAL CONTRACTOR'S PERSONNEL ON SITE SHALL BE THOROUGHLY FAMILIAR WITH THE PUBLISHED SPECIFICATIONS FOR EXACT DESCRIPTIONS OF SCOPE, METHODS, AND MATERIAL.
- 2. THESE DRAWINGS REPRESENT THE GENERAL EXTENT AND ARRANGEMENT OF SYSTEMS. COORDINATE EXACT EQUIPMENT LOCATIONS, ELEVATIONS, AND FINAL CONNECTION REQUIREMENTS. PROVIDE EACH SYSTEM COMPLETE, INCLUDING ALL NECESSARY COMPONENTS, FITTINGS AND OFFSETS.
- 3. CONDUCT A SURVEY TO IDENTIFY ALL UNDERGROUND UTILITIES. CALL 811 PRIOR TO EXCAVATION.
- 4. UTILITIES SHOWN ON THESE DRAWINGS ARE FOR REFERENCE ONLY. COORDINATE EXACT LOCATION OF ALL EXISTING UTILITIES, AND ROUTING OF ALL NEW UNDERGROUND UTILITIES PRIOR TO EXCAVATION.
- 5. DEWATER TRENCHES PRIOR TO INSTALLATION OF CONDUITS. PROVIDE WATER TIGHT FITTINGS ON ALL UNDERGROUND CONDUITS.
- 6. COORDINATE DEMOLITION WORK, AND ELECTRICAL AND TELEPHONE SERVICES TO THE SITE, WITH THE RESPECTIVE LOCAL UTILITY COMPANY REPRESENTATIVES PRIOR TO COMMENCEMENT OF WORK. INCLUDE ALL ASSOCIATED COST/FEES BY THE UTILITY COMPANIES IN THE BID PRICE.
- 7. INSTALL UNDERGROUND CONDUITS 42" BELOW FINISHED GRADE, MINIMUM, UNLESS NOTED OTHERWISE.
- 8. COORDINATE SERVICE SHUT-DOWNS WITH ALL TRADES INVOLVED ON SITE AND OBTAIN WRITTEN AUTHORIZATION FROM OWNER 72 HOURS PRIOR TO ANY ELECTRICAL AND/OR TELEPHONE SHUT-DOWN.
- 9. REMOVE ALL DE-ENERGIZED CONDUCTORS FROM SITE AT COMPLETION OF THE
- 10. OUTDOOR LIGHTING BRANCH CIRCUIT WIRING SHALL BE MINIMUM #8 AWG CONDUCTORS (XHHW-2), IN MINIMUM 1" DIA. CONDUIT, UNLESS NOTED OTHERWISE.
- 11. SPARE CONDUITS SHALL INCLUDE PULL STRING AND SHALL BE TERMINATED WITH A
- 12. EXCAVATE THE ENTIRE LENGTH OF TRENCH TO PROPERLY SET DUCT ELEVATIONS.

EXAMPLE 2 CONSTRUCTION KEY NOTES:

- PROVIDE HANDHOLE FOR FUTURE SIGNAGE WITH (2) 1-1/4" SPARE CONDUIT BACK TO ELECTRICAL ENCLOSURE. COORDINATE FINAL LOCATION WITH OWNER.
- 2. PROVIDE JUNCTION BOX FOR FUTURE PROJECTOR. COORDINATE LOCATION WITH OWNER. PROVIDE ALLOWANCE FOR 600' OF CONDUIT, 2/0 WIRE, AND DATA CONNECTION FROM ELECTRICAL ENCLOSURE TO EQUIPMENT LOCATION. INCLUDE ALLOWANCE FOR EQUIPMENT REQUIRED TO MOUNT OVER 20' AFF, HANGERS AND SUPPORT, TRENCHING TO LOCATION, AND TO CHANGE THE CB SIZE FOR THE CIRCUIT SHOWN.
- 3. MOTORIZED COILING DOOR FOR TRASH ENCLOSURE.
- 4. PROVIDE POWER AND DISCONNECT FOR UNTOUCHABLE VIP 3 TRASH COMPACTOR.
- 5. LOCATE ADJACENT TO BENCH. REFERENCE LANDSCAPING ARCHITECTURAL DRAWINGS FOR BENCH LOCATIONS.

HamiltonAnderson architecture landscape architecture urban design

Hamilton Anderson Associates, Inc 1435 Randolph Suite 200 Detroit, Michigan 48226 p 313 964 0270 f 313 964 0170 www.hamilton-anderson.com

Engineering

PEA 45 W Grand River Ave., Suite 501 Detroit, MI 48226 313.769.5770

5145 Livernois Rd, Suite 100

5145 Livernois Rd, Suite 100 Troy, MI 48098 248.897.5666

Illuminart

Engineering



Troy, MI 48098 248.897.5666

Tel: 248-879-5666 www.PeterBassoAssociates.com PBA Project No.: 2024.0248

The Paradise Valley Cultural and **Entertainment District Conservancy**

13254 Common Road Warren, MI 48088

HDC SUBMISSION 11-26-2025

Permits	10/17/2025
Addendum #1	09/17/2025
Bid Set	09/05/2025
Progress Set	08/27/2025
Progress Set	07/09/2025

08/23/2024

Paradise Valley Alley

POWER PLAN

100% Design Development

Project Number: 2023035.00 Drawn By: KWA Approved By: EMG Scale: 1/20"=1'-0"

REMOVABLE BOLLARDS



Removable Bollards - 4" Steel with

Convert removable bollards to easily permit or restrict access to certain areas

- Convenient removable bollard system temporarily blocks access to hazardous or restricted areas in your parking lot.
- The included stainless steel embedment sleeve seamlessly installs in the ground and provides a strong foundational locking point for the safety bollard.
- Secure the bollard post to the hinged lid on the emedment sleeve with a padlock (sold separately).

> View full product description

Dimensions *

36 in H x 4.5 in W x 4.5 in Dia

> View all options (2)

Details	Details Available options Specifications
Removable Bollards - Steel with Sleeve Stainless steel bollards are designed to withstand long-term exposure to the elements. Choose from 4" x 36" or 6" x 36" sizes.	

Available options	Details Available	options	Specifications	↑
Dimensions	36 in H x 6.63 in W x 6.63 in Dia, 36 in H x 4.5 in W x 4.5 in Dia.			

Specifications			Details Available options Specifications
Base Length	48"	Base Width	8.75"
California Prop 65	No warning label required	Color	Silver
Country of Origin	Viet Nam	Diameter	4.5"
Dimensions	36" H x 4.5" W x 4.5" Dia	ECCN (Export Commodity Control Number)	EAR99
HTS Code (Harmonized Tariff Schedule)	7326.90.8688	Height	36"
Includes	Steel Bollard & Embedment Sleeve	Item Type	Bollard Sleeve
Material	Carbon Steel,Steel	Mounting Type	Ground Mounting
Reflective Type	Non-reflective	RoHS Compliance Status	Please contact our CS department for more information
Special Properties	Collapsible?: No	Trade Name	Removable Bollard
Weight	54 lb	Width	4.5"

TRASH ENCLOSURE BOLLARDS



Steel Bolt Down Bollard

Bolt down bollards provide safety barriers against unauthorized vehicles

- Steel bolt down bollards feature study design and thick base plates
- Effectively prevent forklifts and other vehicles from hitting facilities, machines and other structures
- No core drilling required for installation

> View full product description

Dimensions *

42 in H x 12 in W x 6.5 in Dia

> View all options (3)


* Required Fields



Available options	S	Details Available options Specifications
Dimensions	42 in H \times 12 in W \times 6.5 in Dia, 36 in H \times 8 in W \times 4.5 in Dia, 42 in H \times 8 in W \times 4.5 in Dia.	

Specifications			Details Available options Specifications ↑
Base Length	12"	Base Thickness	0.5"
Base Width	8"	California Prop 65	No warning label required
Coating Material	Powder Coated	Color	Yellow
Country of Origin	United States of America	Diameter	6.5"
Dimensions	42" H x 12" W x 6.5" Dia	ECCN (Export Commodity Control Number)	EAR99
HTS Code (Harmonized Tariff Schedule)	7326.90.8688	Height	42"
Item Type	Bollard	Manufacturer Name	Post Guard
Manufacturer Part Number	BDB6.5R-12	Material	Steel
Mounting Type	Concrete	Packaging	Each
Reflective Type	Non-reflective	RoHS Compliance Status	Not applicable to this product
Special Properties	Collapsible?: No	Trade Name	Bolt Down Bollard
Туре	Bollard	UNSPSC	46161533
VM Master Number	L8945	Weight	85 lb
Width	12"		




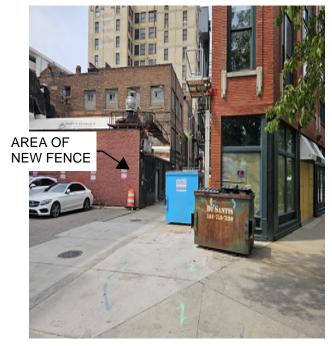


2.



3.

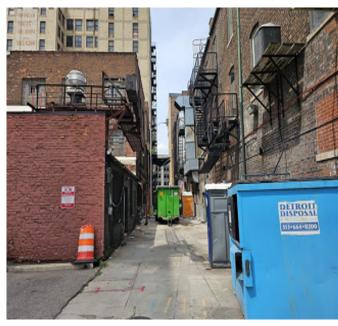

4.

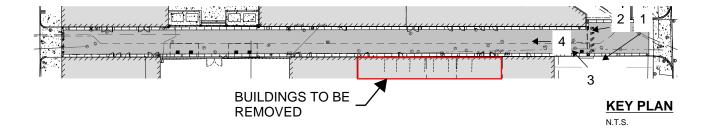






6.





8.

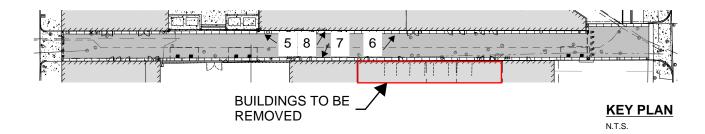




EXISTING PARKING LOT TO REMAIN **NEW FENCE AND GATE INSTALLED** AT PARKING LOT


10.





11. 12.

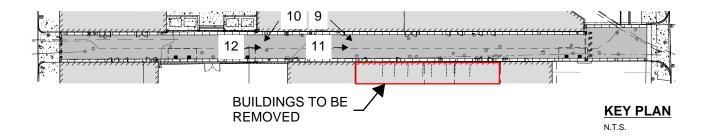

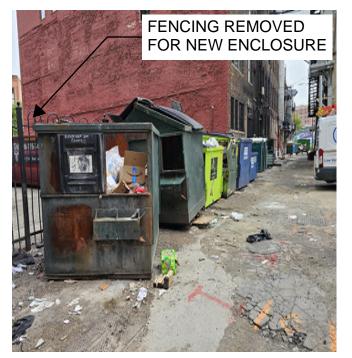




13 14.





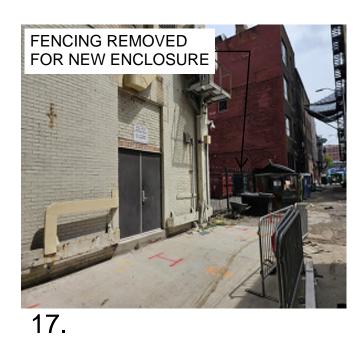

15. 16.

