


GARAGE FLOOR PLAN SCALE 1/4" = 1'-0"

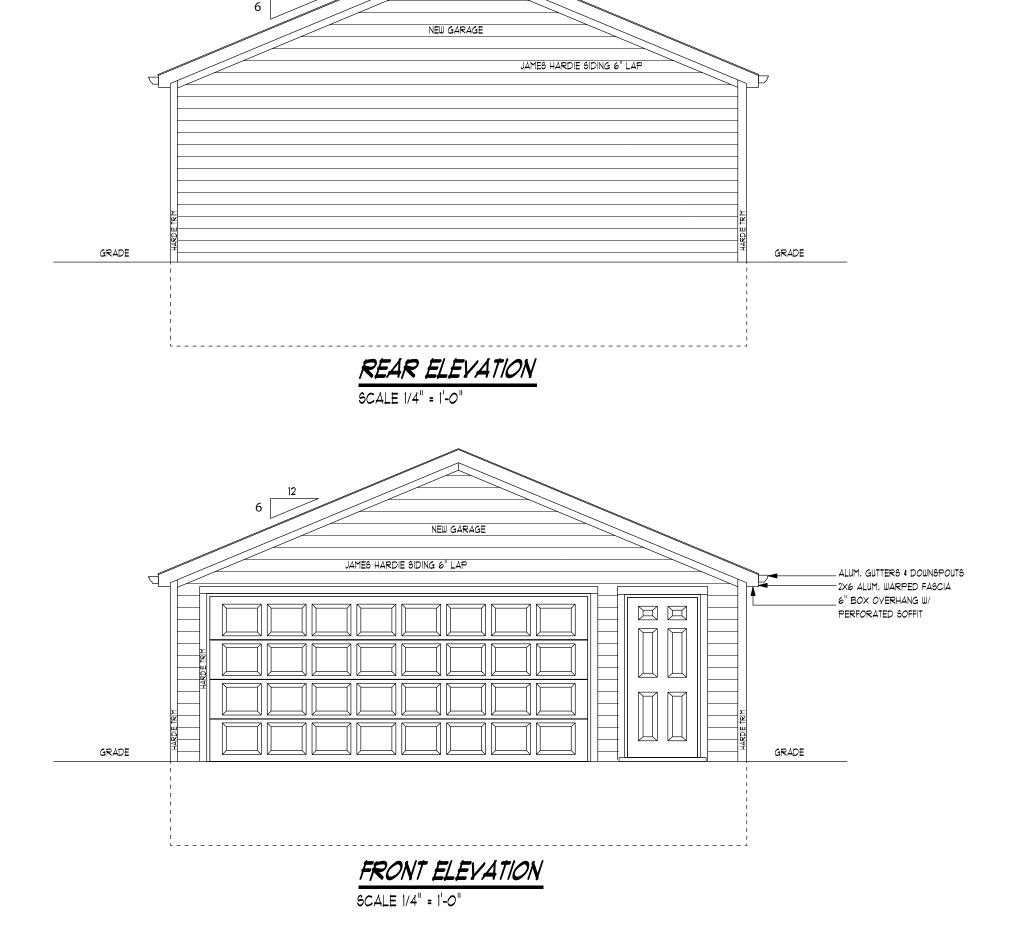

STRUCTURAL SHEATHING NOTES:


- I. DESIGNED FOR SEISMIC ZONE A-C AND WIND SPEEDS OF 115 M.P.H. OR
- 2. WALLS SHALL BE BRACED IN ACCORDANCE WITH SECTION R602.10 OF THE 2015 MRC CODE
- 3. BRACING REQUIREMENTS SHALL BE PER TABLE R602.10.1.3
- 4. EXTERIOR BRACED WALL PANELS (BWP) SHALL BE CONSTRUCTED IN ACCORDANCE WITH CS-WSP METHOD AS PRESCRIBED IN SECTION R602,10.4 (U.N.O.)
- 5. ALL SHEATHABLE SURFACES OF EXTERIOR WALLS (INCLUDING AREAS ABOYE AND BELOW OPENINGS AND GABLE END WALLS) SHALL BE CONTINUOUSLY SHEATHED WITH WOOD STRUCTURAL PANEL (WSP) SHEATHING WITH A MINIMUM THICKNESS OF 3/8", SHEATHING SHALL BE SECURED WITH MINIMUM 6d COMMON NAILS SPACED AT 6" O.C. AT PANEL EDGES AND SPACED AT 12" O.C. AT INTERMEDIATE SUPPORTS
- 6. LENGTH REQUIREMENTS FOR BRACED WALL PANELS WITH CS-WSP METHOD SHALL BE IN ACCORDANCE WITH TABLE R602.10.5
- (IA) PROVIDE 6D COMMON NAILS AT 6" O.C. SPACING AT PANEL EDGES AND 12" O.C. AT INTERMEDIATE SUPPORTS
- (2A) R403.1.6, WALLS 24" TOTAL LENGTH OR SHORTER CONNECTING OFFSET BRACED WALL PANELS SHALL BE ANCHORED TO THE FOUNDATION WITH A MINIMUM OF ONE ANCHOR BOLT LOCATED IN THE CENTER THIRD OF THE PLATE SECTION AND SHALL BE ATTACHED TO ADJACENT BRACED WALL PANELS AT CORNERS AS SHOWN IN ITEM 3 OF TABLE R602.3(1)
- (3A) SEE CONTINUOUS PORTAL FRAME PANEL CONSTRUCTION DETAIL (CS-PF) SHEET GN-2 FOR HEADER / CORNER FRAMING INFORMATION, HEADER PROVIDED MUST BE MINIMUM 3" X II 1/4" SOLID SAWN OR LAMINATED VENEER LUMBER (L,Y,L)


INFORMATION DEEMED RELIABLE BUT NOT GUARANTEED.
ALL DIMENSIONS ARE APPROXIMATE.
TRUSS MANUFACTURER AND GENERAL CONTRACTOR TO VERIFY ALL
FIELD CONDITIONS INCLUDING BUT NOT LIMITED TO:

EXTERIOR WALL THICKNESS

EXISTING ROOF PITCH
EXISTING HEEL HEIGHT
OVERHANG DIMENSIONS
OVERALL DIMENSIONS ACROSS TOP PLATES
EXISTING FLOOR JOIST AND ROOF FRAMING DIRECTION

PRIOR TO BIDDING / TRUSS FABRICATION / MATERIAL TAKEOFF

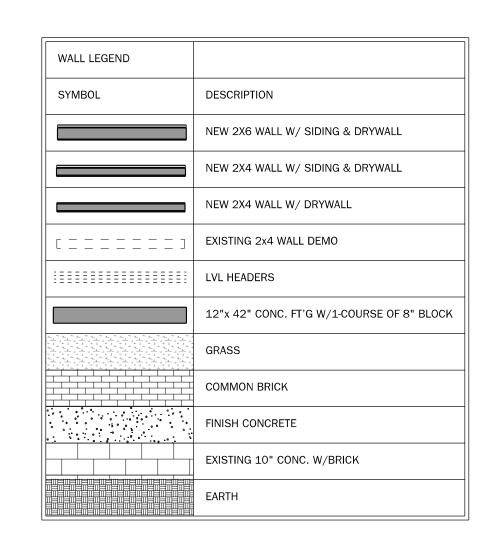

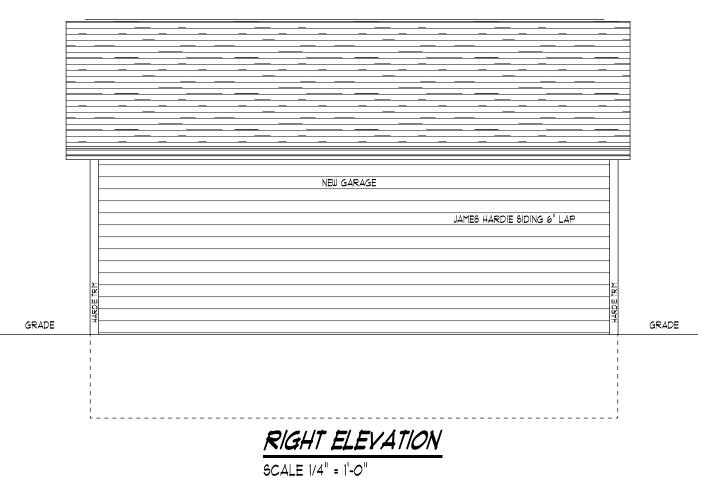

	SCALE 1/4 = 1-0	
	NEW GARAGE JAMES HARDIE SIDING 6" LAP	
GRADE	1 H	GRADE
	SCALE 1/4" = 1'-0"	

NOTE: THIS PLAN IS FOR ELEVATION VIEW ONLY

ITALY AMERICAN CONSTRUCTION

FAMILY OWNED SINCE 1954

PHONE* 313-278-7500

8401 N. TELEGRAPH RD. DEARBORN HEIGHTS MI. 4812T

Date:

On Site

Job Notes:			
-			

CARMEN & KEYIN DAHLBG

4372 STURTEYANT ST DETROIT MI. 48204

Froject

"NEW GARAGE"


4372 STURTEVANT ST DETROIT MI. 48204

Issued For	8/24/2025
Owner Review	
REVISED	
Drawing Title	

"FRONT ELEVATION"
"REAR ELEVATION"
"RIGHT ELEVATION"
"LEFT ELEVATION"

Date: 8/24/2025
Drawn By: MARK KREUTZKAMP
8140-531-1649
Revisions:

PAGE I OF I

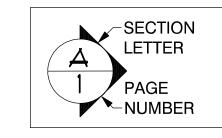

Drawing # 8242025