

# HISTORIC DISTRICT COMMISSION APPLICATION FOR WORK APPROVAL

City of Detroit - Planning & Development Department 2 Woodward Avenue, Suite 808 Detroit, Michigan 48226

APPLICATION ID

HDC2025-00539

Dello	it, iviicingan 40	220						11002025-0	0000	
PR	OPERTY	INFORM <i>A</i>	ATION							
ADDRESS(ES): 1724 Seyburn St										
HIST	HISTORIC DISTRICT: West Village									
scc	SCOPE OF WORK: (Check ALL that apply)									
x	Windows/ Doors	Walls/ Siding		Painting	X	Roof/Gutters/ Chimney	X	Porch/Deck/Balcony	, <b></b>	Other
	Demolition	Signa	де 🔲	New Building		Addition	$\mathbf{x}$	Site Improvements (landscape, trees, fence patios, etc.)	es,	
REH EXT NEV ELE BAY	BRIEF PROJECT DESCRIPTION: REHABILITATION OF AN EXISTING HISTORIC RESIDENCE IN THE WEST VILLAGE NEIGHBORHOOD OF DETROIT. EXTERIOR SCOPE: NEW WOOD WINDOWS IN MODIFIED EXISTING OPENINGS; REMOVAL OF (1) WINDOW & INFILL W/ NEW BRICK; NEW DOORS THROUGHOUT; NEW FRONT PORCH ROOF COVER; NEW REAR DECK & RAILINGS AT FORMER ELEVATED COVERED PATIO AREA; NEW EXTERIOR LIGHTING; REPLACE LOW-SLOPE ROOF AREAS AT REAR AND SIDE BAY WINDOW. SITE SCOPE: REPAIR EXISTING SITEWORK AS NEEDED; NEW SITE-BUILT WOOD FENCE W/ GATES, NEW LANDSCAPING PER OWNER.									
ΛD	DLICANT	IDENTIE	CATION							
APPLICANT IDENTIFICATION										
TYP	E OF APPLI	CANT: Archi			1	COMPANY NAM	F: Infuz	Architacts		
TYP	E OF APPLI	CANT: Archi	tect/Enginee			COMPANY NAM	<b>E:</b> Infuz <i>i</i>		71P: 49	2216
TYP NAM ADE	E OF APPLI ME: Joe Hude DRESS: 1451	CANT: Archi	tect/Enginee		(	CITY: Detroit		STATE: MI	<b>ZIP:</b> 48	3216
NAM ADE	PE OF APPLI ME: Joe Hude DRESS: 1451 DNE: +1 (412)	CANT: Archi	tect/Enginee	er/Consultant	(	CITY: Detroit		STATE: MI	<b>ZIP:</b> 48	3216
TYP NAM ADE	DE OF APPLI ME: Joe Hude DRESS: 1451 DNE: +1 (412)	CANT: Archi	tect/Engined	er/Consultant	WIN	CITY: Detroit  EMAIL: joehudec	@infuzaro	STATE: MI		
NAM ADE	PE OF APPLI ME: Joe Hude DRESS: 1451 DNE: +1 (412) GREE TO	CANT: Archi	tect/Enginee ite 7  FIRM TH	E FOLLO pad all require	WIN	CITY: Detroit  EMAIL: joehudec	@infuzaro	STATE: MI		
TYP NAM ADE	DRESS: 1451 DNE: +1 (412) GREETO I understan project and I understan responsibili	Bagley St, Su 779-9046  AND AFF d that the fai /or a denied d that the ret ty to comply	ite 7  FIRM TH  lure to uplo application view of this with any of	E FOLLO pad all require application bether applicable	WIN ed do	EMAIL: joehudece	@infuzaro / result ir	STATE: MI	v times fo	or my
TYP NAM ADE PHO	PE OF APPLI ME: Joe Hude DRESS: 1451 DNE: +1 (412) GREETO I understand project and I understand responsibilisign, etc.) of I hereby cer	Bagley St, Su 779-9046  AND AFF d that the fai /or a denied d that the ret ty to comply or other depa	ite 7  FIRM TH  lure to uplo application view of this with any or ormation on	E FOLLO pad all require application bether applicable provals prior to	by the old or beginn is true	EMAIL: joehudece  IG: cumentation may Historic District linances including inning the work.  ue and correct. I ce	@infuzaro / result in Commis g obtaini	STATE: MI chitects.com n extended review sion does not wa	v times for ive my ermits (but is authorized)	or my uilding,
TYP NAM ADD PHO	PE OF APPLI ME: Joe Hude DRESS: 1451 DNE: +1 (412) GREETO I understand project and I understand responsibilisign, etc.) of I hereby cer	Bagley St, Su 779-9046  AND AFF d that the fai /or a denied d that the ret ty to comply or other depa	ite 7  FIRM TH  lure to uplo application view of this with any or ormation on	E FOLLO pad all require application bether applicable provals prior to	by the ord to beg	EMAIL: joehudece  IG: cumentation may e Historic District linances including inning the work. ue and correct. I ce application as the p	@infuzaro / result in Commis g obtaini	state: MI chitects.com  n extended review sion does not waing appropriate per the proposed work wner(s) authorized	v times for ive my ermits (but is authorized)	or my uilding,
TYP NAM ADD PHO	DRESS: 1451 DNE: +1 (412) GREETO I understant project and I understant responsibility sign, etc.) of the owner of recommendation.	Bagley St, Su 779-9046  AND AFF d that the fai /or a denied d that the re- ty to comply or other depa	ite 7  FIRM TH  lure to uplo application view of this with any or ormation on	E FOLLO pad all require application bether applicable provals prior to	by the ord to beg	EMAIL: joehudece  IG: cumentation may e Historic District linances including inning the work. ue and correct. I ce application as the p	@infuzaro / result in Commis g obtaini ertify that roperty of	state: MI chitects.com  n extended review sion does not waing appropriate per the proposed work wner(s) authorized	v times for ive my ermits (but is authorized)	or my uilding,
TYP NAM ADE PHO	PE OF APPLI  ME: Joe Hude  DRESS: 1451  DNE: +1 (412)  GREE TO  I understant project and I understant responsibilities ign, etc.) of the company of recommendation of the company of the c	Bagley St, Su 779-9046  AND AFF d that the fai /or a denied d that the re- ty to comply or other depa	ite 7  FIRM TH  lure to uplo application view of this with any or intment app	E FOLLO pad all require application bether applicable provals prior to	by the ord to beg	EMAIL: joehudece  IG: cumentation may e Historic District linances including inning the work. ue and correct. I ce application as the p	@infuzaro / result in Commis g obtaini ertify that roperty of	state: MI chitects.com  n extended review sion does not waing appropriate per the proposed work wner(s) authorized	v times for ive my ermits (but is authorized)	or my uilding,

Questions? Contact us at <a href="https://documents.com/hdc@detroitmi.gov">hdc@detroitmi.gov</a> or (313)224-1762

NOTE: Based on the scope of work, additional documentation may be required. See www/detroitmi.gov/hdc

for scope-specific requirements.

#### PROJECT DETAILS - TELL US ABOUT YOUR PROJECT

Instructions: Add project details using the text box in each section. If your details exceed the space provided, attach the details via the attachment icon for that section.

#### **ePLANS PERMIT NUMBER:**

(only applicable if you've already applied for permits through ePLANS)

N/A

#### **GENERAL**

#### 1. DESCRIPTION OF EXISTING CONDITION

Please tell us about the current appearance and conditions of the areas you want to change. You may use a few sentences or attach a separate prepared document on the right. (For example, "existing roof on my garage is covered in gray asphalt shingles in poor condition.")

Existing Historic residence is a Colonial Revival w/ Neo-Georgian features.

The house remains in good shape from the exterior and still maintains many original wood windows.

\* Repair/Restoration of original wood windows, Masonry restoration, & Gutter replacement has been submitted under HDC2025-00443

The front masonry porch is in poor shape and needs repaired/rebuilt. The rear masonry porch has failed at its concrete slab, and will be replaced with a new deck. The masonry chimney has fallen and will be rebuilt.

The interior is to the studs and will undergo a renovation.

#### 2. PHOTOGRAPHS

Help us understand your project. Please attach photographs of all areas where work is proposed.



#### 3. DESCRIPTION OF PROJECT

In this box, tell us about what you want to do at the areas described above in box #1. (For example, Install new asphalt shingle roofing at garage.)

Exterior scope: New wood windows in modified existing openings; Removal of (1) window & infill w/ new brick; New doors throughout; New front porch roof cover; new rear deck & railings at former elevated covered patio area; New exterior lighting; Replace low-slope roof areas at rear and side bay window.

Site Scope: Repair existing sitework as needed; New site-built wood fence w/ gates, New landscaping per owner.

#### 4. DETAILED SCOPE OF WORK

In this box, please describe all steps necessary to complete the work described in box #3. (For example, "remove existing shingles, replace wood deck as necessary, replace wood eaves, install roof vents, replace rotted fascia boards, paint, clean worksite.")

See attached detailed scope of work + Drawing package



#### 5. BROCHURES/CUT SHEETS

Please provide information on the products or materials you are proposing to install. For example, a brochure on the brand and color of the shingles proposed.



### ADDITIONAL DETAILS

6. WINDOWS/DOORS  Detailed photographs of window(s) and/or door(s) proposed for replacement showing the condition of the interior and exterior of the window(s) and/or door(s)	
8. SITE IMPROVEMENTS If site improvements are proposed, please provide any relevant site improvement plans pertaining to your project.	











# HISTORIC RENOVATION RYAN & LACEY ZAMPARDO

1724 SEYBURN ST **DETROIT, MI 48214** 



## **PROJECT INFORMATION**

RYAN & LACEY ZAMPARDO 1724 SEYBURN ST. Location: DETROIT, MI 48214

### **PROJECT DESCRIPTION:**

REHABILITATION OF AN EXISTING HISTORIC RESIDENCE IN THE WEST VILLAGE NEIGHBORHOOD OF DETROIT, MICHIGAN

SCOPE OF WORK TO INCLUDE:

WINDOW RESTORATION / REPLACEMENT; NEW DOORS THROUGHOUT; NEW FRONT PORCH ROOF COVER; NEW REAR DECK & RAILINGS AT FORMER ELEVATED COVERED PATIO AREA: NEW EXTERIOR LIGHTING; REPLACE LOW-SLOPE ROOF AREAS AT REAR AND SIDE BAY WINDOW.

NEW INTERIOR FINISHES THROUGHOUT; REBUILD & REFRAME THE EXISTING MAIN STAIR; PROVIDE STRUCTURAL BEAM UPGRADES; ALL NEW HVAC, ELECTRICAL, & PLUMBING; NEW

REPAIR EXISTING SITEWORK AS NEEDED; NEW SITE-BUILT WOOD FENCE W/ GATES, NEW

### **BUILDIING SUMMARY:**

EXISTING AND PROPOSED GROSS BUILDING AREAS:

1,039 SFG (EXISTING - NO CHANGE) FIRST FLOOR: SECOND FLOOR: 1,031 SFG (EXISTING - NO CHANGE) THIRD FLOOR: 403 SFG (EXISTING - NO CHANGE) 1,031 SFG (EXISTING - NO CHANGE) TOTAL GROSS BUILDING AREA: 3,504 SFG (EXISTING - NO CHANGE)

### **GOVERNING CODES:**

2015 MICHIGAN RESIDENTIAL CODE (MRC) 2021 MICHIGAN MECHANICAL CODE (MMC) 2021 MICHIGAN PLUMBING CODE (MPC) 2023 NATIONAL ELECTRICAL CODE (NEC) 2015 MICHIGAN UNIFORM ENERGY CODE (MUEC)

2015 INTERNATIONAL FIRE CODE NFPA 1, UNIFORM FIRE CODE


**CONSTRUCTION TYPE:** 


TYPE VB / NS (NO SPRINKLER SYSTEM)

DISCLAIMER: ALL CONDITIONS DEPICTED ARE BASED ON KNOWLEDGE DISCOVERED UPON FIELD MEASURE (OR CONVEYED BY OWNER). IT IS THE RESPONSIBILITY OF THE CONTRACTOR TO NOTIFY THE ARCHITECT AND OWNER OF ANY DISCOVERIES EXPOSED UPON DEMOLITION / NEW CONSTRUCTION THAT DIFFER FROM CONDITIONS DEPICTED HEREIN.

SHEET LIST						
SHEET NUMBER	SHEET NAME					
1CS	COVER SHEET					
2CSP	ARCHITECTURAL SITE PLAN					
A-1.0	DEMOLITION PLANS					
A-1.1	DEMOLITION ELEVATIONS					
A-2.1	PROPOSED FLOOR PLANS					
A-2.2	PROPOSED FLOOR PLANS					
A-2.3	PROPOSED ROOF PLAN					
A-3.1	PROPOSED EXTERIOR ELEVATIONS					
A-3.2	PROPOSED EXTERIOR ELEVATIONS					
A-3.3	ELEVATION DETAILS					
A-5.0	REFLECTED CEILING PLANS					
A-5.1	REFLECTED CEILING PLANS					
A-6.0	TYPICAL UNIT PLANS AND INTERIOR ELEVATIONS					

SHEET LIST					
SHEET NUMBER SHEET NAME					
M-100	MECHANICAL NOTES				
M-201	HVAC PLANS				
M-202	HVAC PLANS				
E-100	ELECTRICAL NOTES				
E-201	ELECTRICAL POWER PLANS				
E-202	ELECTRICAL POWER PLANS				
E-203	ELECTRICAL LIGHTING PLANS				
E-204	ELECTRICAL LIGHTING PLANS				
P-100	PLUMBING NOTES				
P-201	PLUMBING PLANS				
P-202	PLUMBING PLANS				
S-1.0	STRUCTURAL PLANS				

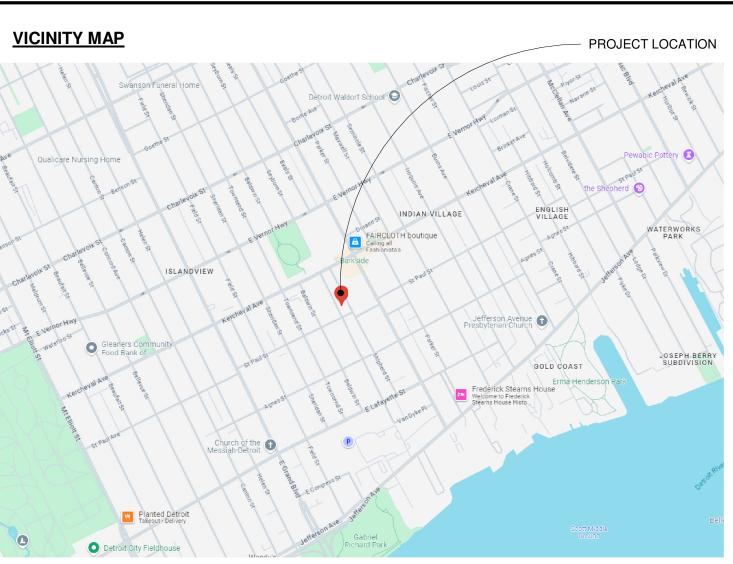

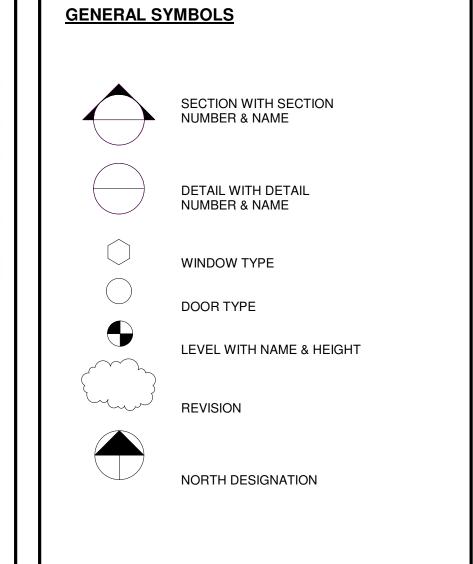

### **ABBREVIATIONS**

**FLOOR** 

FOOTING

GALVANIZED GYPSUM **HARDWARE HOLLOW METAL** 

HORIZONTAL

INSULATION

LAVATORY

MAXIMUM

**MECHANICAL** 

**MEZZANINE** 

MISCELLANEOUS MASONRY OPENING

NOT IN CONTRACT NO SCALE

NOT TO SCALE ON CENTER OUTSIDE DIAMETER

OPENING

**OPPOSITE** PLATE GLASS

PLASTER

PLATE STEEL

PAINT/POINT

RETURN AIR

REQUIRED

**ROOF SUMP** 

RUBBER TILE

SANITARY

SCHEDULE SHEET

STANDARD

STORAGE

STRUCTURAL

SUSPENDED

SYMMETRICAL

TELEPHONE TERRAZZO

THRESHOLD

TOP AND BOTTOM

THICK/THICKNESS

TOP OF FOOTING

VINYL COBE BASE VINYL COMPOSITE TILE

VERIFY IN FIELD

WATER CLOSET

WOVEN WIRE MESH

VINYL STRAIGHT BASE

TOP OF STEEL

TYPICAL

UNDERCUT

UNDERSIDE

VINYL BASE

VERTICAL

WAINSCOT

WD. WIN. WOOD WINDOW

WOOD

WEIGHT

W.W.F. WELDED WIRE FABRIC

TONGUE AND GROOVE

UNLESS NOTED OHTERWISE

SPECIFICATION

ROOFING

ROOM

RUBBER BASE

ROOF CONDUCTOR

RUBBER FLOORING

PLASTIC LAMINATE

PREFABRICATED PROJECT

POUNDS PER SQUARE FOOT

REINFORCED/REINFORCING

SERVICE SINK/STAINLESS STEEL

MINIMUM

MISC.

O.D.

OPP.

PL.S.

R.C.

RM.

R.S.

R.T.

SAN.

SCHED.

SPEC.

S.S. STL.

STD.

STOR.

SUSP.

SW.

T&B

TEL.

THRES.

T.O.

T.O.F.

T.O.S.

TYP.

U.N.O.

V.C.B.

V.I.F.

V.S.B.

VERT.

WD.

WD.

WAINS.

U/S

V.B.

STRUCT.

REINF.

REQ'D.

P-LAM.

**INSIDE DIAMETER** 

LONG LEG OUTSTANDING LONG LEG VERTICAL

MISCELLANEOUS IRON

GAUGE

FACE OF STUD

ACOUST. ACOUSTICAL ACOUSTICAL CEILING TILE ADJACENT ABOVE FINISHED FLOOR **ALUMINUM** ANOD. **ANNODIZED** BOARD BLDG. BUILDING BLOCK BLKG. **BLOCKING BOTTOM OF** BOTTOM OF FOOTING **Web:** infuzarchitects.com CUBIC FEET PER MINUTE CENTERLINE COLUMN **CORNER GUARD** COL.G. CONST. CONSTRUCTION CONT. CONTINOUS CARPET **CERAMIC TILE** DIAMETER **DIMENSION** DOWN DOOR OPENING DWG. DRAWING **ELEVATION EACH WAY EXISTING** EXPANSION/EXPOSED EXTERIOR FLOOR DRAIN **FOUNDATION** FIBER REINFORCED PANELS

Unauthorized use of this drawing set without written permission from VIRTUOSO DESIGN + BUILD and Infuz Ltd is in violation of U.S. COPYRIGHT LAWS and will be subject to civil damages and prosecution.


DESCRIPTION 01/20/2025 HDC SET 08/15/2025

DATE SEALED

8/18/2025 12:15:55 PM

SHEET NUMBER

# **PUBLIC ALLEY**

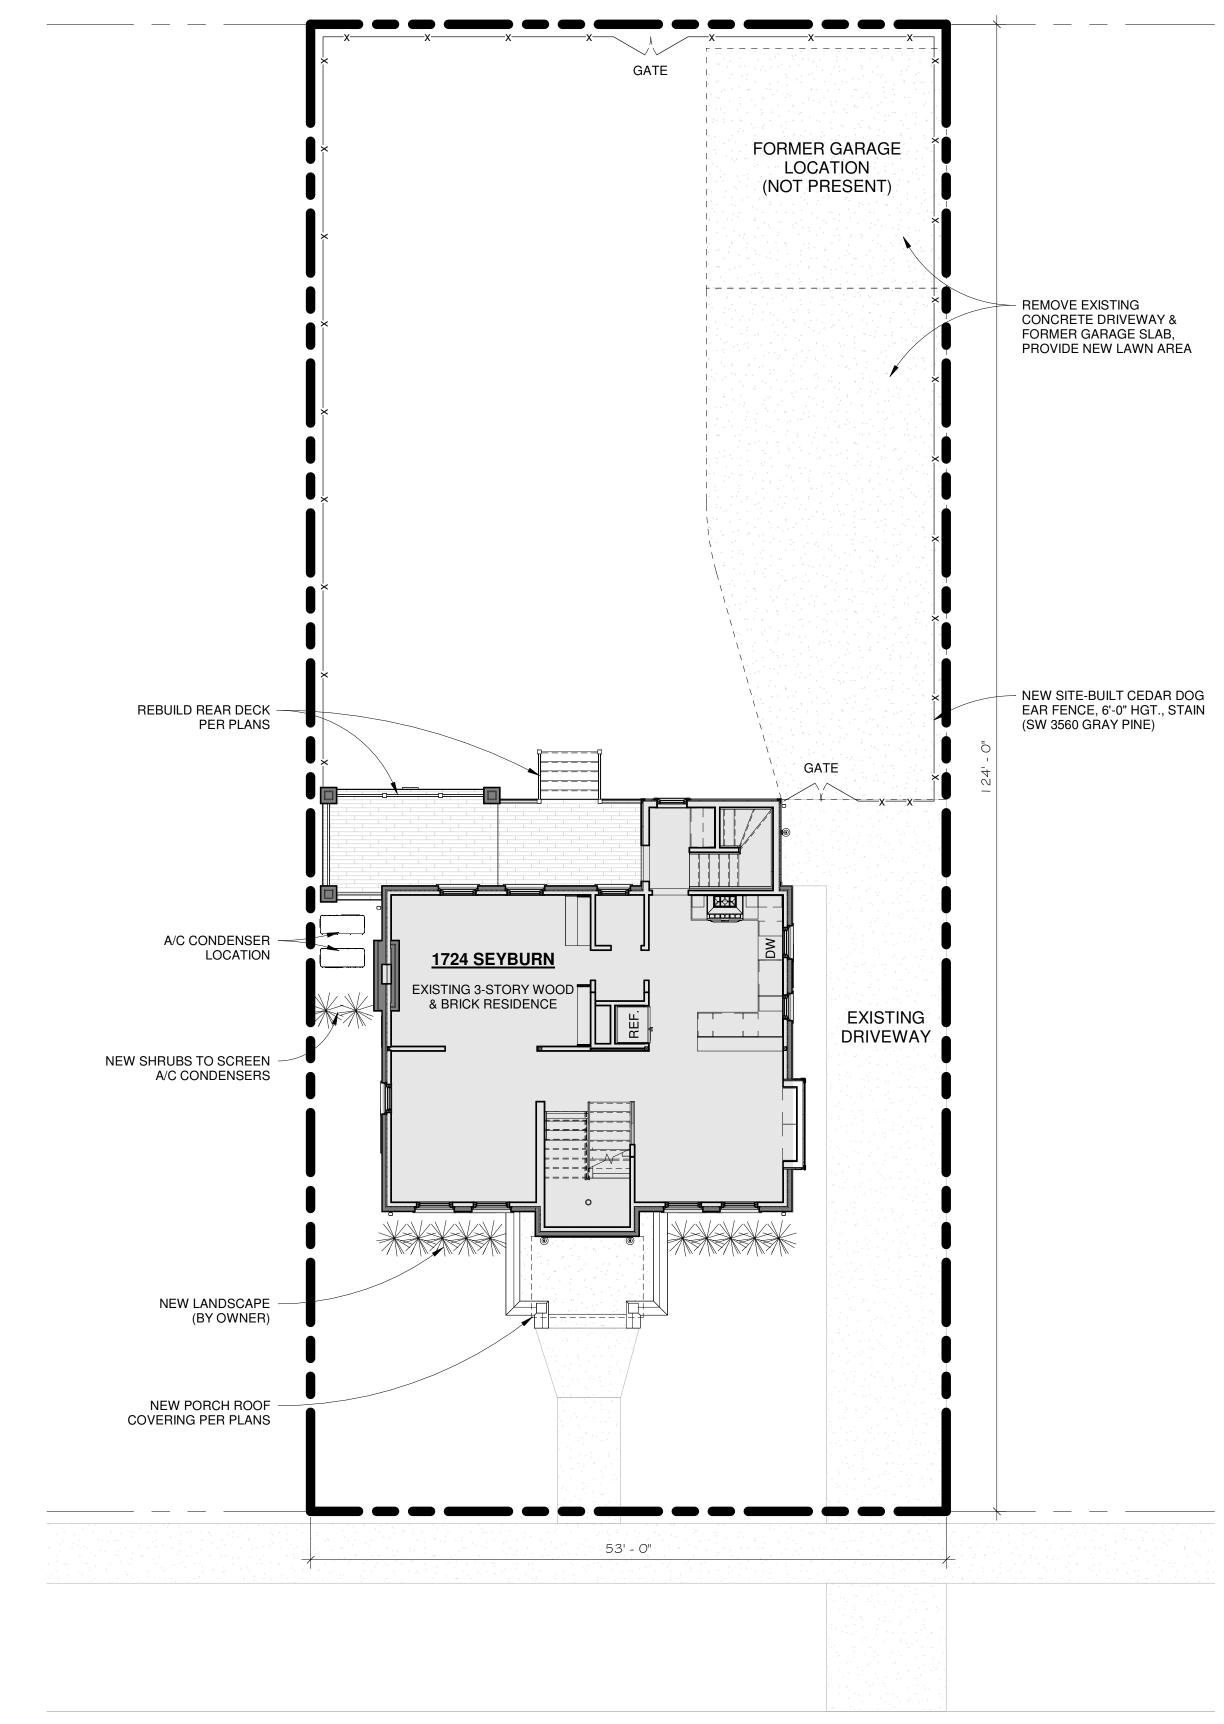

ALL INFO PROVIDED BY OWNER AND PUBLICLY PROVIDED INFO.

# **SEYBURN ST**

ARCHITECTURAL SITE PLAN FOR REFERENCE ONLY. ALL LANDSCAPE SELECTIONS BY OWNER/CONTRACTOR.





TORIC

SHEET NUMBER

8/18/2025 12:15:57 PM

ZAMPARDO SIT ARCHITECTU LAC PROJECT NUMBER: 2240
1724 SEYBUR
DETROIT, MI 4
RYAN & L

Email: infuzltd@comcast.net Web: infuzarchitects.com

Unauthorized use of this drawing set without written permission

of U.S. COPYRIGHT LAWS and

will be subject to civil damages

Revision Schedule

01/20/2025

08/15/2025

DATE

SEALED

Description

and prosecution.

2 HDC SET

from VIRTUOSO DESIGN + BUILD and Infuz Ltd is in violation

**GENERAL SITE NOTES:** THE DRAWINGS HEREIN ARE FOR INFORMATIONAL PURPOSES AND CONVEYANCE OF DESIGN INTENT. INFORMATION DEPICTED IS NOT INTENDED TO BE CONSTRUED AS LEGAL SURVEY OR ENGINEERED CIVIL. REFER TO SUBMITTALS BY PROFESSIONAL CONSULTANTS FOR WORK BEYOND THE SCOPE DEPICTED HEREIN. GENERAL CONTRACTOR TO VERIFY ALL EXISTING ELEVATIONS AND BUILDING CONDITIONS IN FIELD PRIOR TO START OF CONSTRUCTION. THE CONTRACTOR SHALL

HAVE A REGISTERED LAND SURVEYOR TIE OUT AND RESET ANY PROPERTY CORNERS OR SECTION CORNERS PLANNED TO BE DISTURBED BY CONSTRUCTION OF THIS PROJECT, AND SHALL HAVE A REGISTERED LAND SURVEYOR RE-ESTABLISH ANY PROPERTY CORNERS OR SECTION CORNERS INADVERTENTLY DISTURBED DURING CONSTRUCTION OF THIS PROJECT. ALL STREET, SANITARY SEWER, STORM SEWER AND WATERLINE CONSTRUCTION SHALL CONFORM TO THE LOCAL MUNICIPALITY STANDARDS AND SPECIFICATIONS CURRENT AT THE DATE OF EXECUTION OF THE CONSTRUCTION. THE CONTRACTOR SHALL BE RESPONSIBLE FOR CONTACTING MISSDIG. CALL TWO BUSINESS DAYS PRIOR (NOT INCLUDING THE DAY OF THE CALL) TO DIGGING, GRADING OR EXCAVATING FOR THE MARKING OF UNDERGROUND MEMBER UTILITIES. MAINTENANCE OF ONSITE DRAINAGE TO MINIMIZE ANY RUNOFF / EROSION DURING CONSTRUCTION SHALL BE THE RESPONSIBILITY OF THE CONTRACTOR. PRIOR TO COMMENCEMENT OF ANY CONSTRUCTION, THE CONTRACTOR SHALL

CONTACT ALL UTILITIES TO COORDINATE SERVICE AND SCHEDULES. THE CONTRACTOR SHALL RESTORE ANY DISTURBED AREAS TO EQUAL OR BETTER CONDITION THAN EXISTED BEFORE CONSTRUCTION. THE CONTRACTOR SHALL IMMEDIATELY REMOVE ANY CONSTRUCTION DEBRIS AND MUD TRACKED ONTO EXISTING ROADWAYS. THE CONTRACTOR SHALL REPAIR ANY EXCAVATION OR PAVEMENT FAILURES CAUSED BY THE CONSTRUCTION.

ALL DAMAGED EXISTING CURB, GUTTER, AND SIDEWALK SHALL BE REPAIRED PRIOR TO ACCEPTANCE OF COMPLETED IMPROVEMENTS. THE TYPE, SIZE, LOCATION AND NUMBER OF ALL KNOWN UNDERGROUND UTILITIES ARE APPROXIMATE WHEN SHOWN ON THESE CONSTRUCTION DRAWINGS. IT SHALL BE THE RESPONSIBILITY OF THE CONTRACTOR TO VERIFY THE EXISTENCE AND LOCATION OF ALL UNDERGROUND UTILITIES ALONG THE ROUTE OF THE WORK PRIOR TO COMMENCING ANY NEW CONSTRUCTION. THE CONTRACTOR SHALL BE RESPONSIBLE

OF ANY UNKNOWN UNDERGROUND UTILITIES. THE CONTRACTOR SHALL NOTIFY THE PUBLIC WORKS DEPARTMENT AT LEAST 48 HOURS PRIOR TO INSTALLING A NEW SEWER, WATER SERVICE OR ABANDONING AN EXISTING WATER SERVICE.

THE CONTRACTOR SHALL PERFORM ALL WORK ACCORDING TO ALL LOCAL, COUNTY, STATE AND FEDERAL SAFETY AND HEALTH REGULATIONS. IN PARTICULAR, THE TRENCHING AND OPEN EXCAVATION OPERATIONS SHALL COMPLY WITH ALL CURRENT

O.S.H.A. REGULATORY REQUIREMENTS. REFER TO ELECTRICAL DRAWINGS FOR SITE RELATED ELECTRICAL SCOPE.

### **ZONING REQUIREMENTS**

CITY OF DETROIT LOCAL AUTHORITY:

LOCAL ORDINANCE: DETROIT ZONING ORDINANCE (REVISION 31 JULY 2018)

**ZONING CLASSIFICATION:** R-2 RESIDENTIAL

**USE CLASSIFICATION:** SINGLE FAMILY DWELLING (SEC. 50-11-236 - SEC. 50-11-239)

REQUIRED SETBACKS: (SECT. 50-11-245) EXISTING TO REMAIN (NO CHANGE)

MINIMUM LOT SIZE: (SECT. 50-13-45)

EXISTING TO REMAIN (NO CHANGE)

MAXIMUM HEIGHT: EXISTING TO REMAIN (NO CHANGE)

(SECTS. 50-13-236 & 50-13-237) LOT COVERAGE:

EXISTING TO REMAIN (NO CHANGE)

1 SPACE PER DWELLING REQUIRED PARKING: TOTAL PARKING PROVIDED: 1 SPACES PROVIDED ON SITE

#### **DEMOLITION NOTES:**

COMPLY WITH GOVERNING EPA NOTIFICATION REGULATIONS BEFORE STARTING DEMOLITION. COMPLY WITH HAULING AND DISPOSAL REGULATIONS OF AUTHORITIES HAVING JURISDICTION. OBTAIN AND PAY FOR ALL PERMITS REQUIRED. WHERE TOXIC SUBSTANCES ARE SUSPECTED TO BE PRESENT, PARTICULARLY LEAD PAINT AND ASBESTOS, A CERTIFIED REMOVAL ENTITY SHALL BE RETAINED AND FOLLOW GOVERNING AGENCY GUIDELINES FOR REMOVAL AND DISPOSAL. CONTRACTOR SHALL PROVIDE ALL NECESSARY TEMPORARY PROTECTION REQUIRED BY FEDERAL,

STATE, AND LOCAL LAW TO INSURE PUBLIC AND WORKER SAFETY. COMPLY WITH OSHA AND EPA REQUIREMENTS.

AS PART OF THE PROJECT SCOPE, THE CONTRACTOR SHALL PREPARE ALL DRAWINGS, DOCUMENTS, AND APPLICATIONS AND SHALL OBTAIN ALL GOVERNMENT AGENCY APPROVALS AND PERMITS REQUIRED FOR DEMOLITION ACTIVITIES.

CONDUCT DEMOLITION OPERATIONS AND REMOVE MATERIALS TO ENSURE MINIMUM INTERFERENCE WITH ROADS, STREETS, WALKS, AND OTHER ADJACENT OCCUPIED AND UTILIZED

DO NOT CLOSE OR OBSTRUCT STREETS, WALKS, OR OTHER ADJACENT OCCUPIED OR UTILIZED FACILITIES WITHOUT PERMISSION FROM AUTHORITIES HAVING JURISDICTION. PROVIDE ALTERNATE ROUTES AROUND CLOSED OR OBSTRUCTED TRAFFIC WAYS IF REQUIRED BY GOVERNING

CONDUCT DEMOLITION OPERATIONS TO PREVENT INJURY TO PEOPLE AND DAMAGE TO ADJACENT BUILDINGS AND FACILITIES TO REMAIN. ENSURE SAFE PASSAGE OF PEOPLE AROUND DEMOLITION

ERECT TEMPORARY PROTECTION, SUCH AS WALKS, FENCES, RAILINGS, CANOPIES, AND COVERED PASSAGEWAYS, WHERE REQUIRED BY AUTHORITIES HAVING JURISDICTION. MAINTAIN TEMPORARY PROTECTION TO PEOPLE AT EXTERIOR AREAS OF THE EXISTING BUILDING

WHERE DECORATIVE MEDALLION REMOVAL WORK IS BEING DONE. PROTECT EXISTING SITE IMPROVEMENTS, APPURTENANCES, AND LANDSCAPING THAT ARE

DESIGNATED TO REMAIN IN PLACE. PROVIDE AND MAINTAIN INTERIOR AND EXTERIOR SHORING, BRACING, OR STRUCTURAL SUPPORT

TO PRESERVE STABILITY AND PREVENT MOVEMENT, SETTLEMENT, OR COLLAPSE OF BUILDINGS TO BE DEMOLISHED AND ADJACENT BUILDINGS TO REMAIN. STRENGTHEN OR ADD NEW SUPPORTS WHEN REQUIRED DURING PROGRESS OF DEMOLITION. VERIFY THAT UTILITIES HAVE BEEN DISCONNECTED AND CAPPED.

SURVEY EXISTING CONDITIONS AND CORRELATE WITH REQUIREMENTS INDICATED TO DETERMINE EXTENT OF DEMOLITION AND RECYCLING REQUIRED. SURVEY CONDITION OF THE BUILDING TO DETERMINE WHETHER REMOVING ANY ELEMENT MIGHT

RESULT IN A STRUCTURAL DEFICIENCY OR UNPLANNED COLLAPSE OF ANY PORTION OF THE STRUCTURE OR ADJACENT STRUCTURES DURING DEMOLITION. RETAIN A LICENSED AND QUALIFIED STRUCTURAL ENGINEER TO PROVIDE ANALYSIS, INCLUDING CALCULATIONS, NECESSARY TO ENSURE THE SAFE EXECUTION OF THE DEMOLITION WORK.

BEARING WALLS, STRUCTURAL STEEL, CONCRETE FOUNDATIONS AND SUPPORTED SLABS WITH STRUCTURAL FRAMING SHALL NOT BE ALTERED WITHOUT A FIELD INVESTIGATION BY THE ARCHITECT OR A STRUCTURAL ENGINEER.

DEMOLITION DRAWINGS INDICATE GENERAL AREAS OF DEMOLITION ONLY. EXTENT OF REMOVAL OF EXISTING CONSTRUCTION MATERIALS TO BE DETERMINED BY FIELD INVESTIGATION AND COORDINATION WITH ARCHITECTURAL, MECHANICAL, ELECTRICAL, AND PLUMBING DOCUMENTS AS REQUIRED TO ACCOMMODATE THE NEW CONSTRUCTION. EXISTING MECHANICAL, PLUMBING, AND ELECTRICAL TO BE RELOCATED PER DRAWINGS, COORDINATE WITH CONTRACTORS AS REQUIRED.

COORDINATE REMOVAL OF EXISTING ITEMS WITH PROPOSED FRAMING DETAILS, INTERIOR ELEVATIONS, AND DETAILS. PROVIDE TEMPORARY STRUCTURAL SUPPORT AS REQUIRED PRIOR TO STRUCTURAL DEMOLITION.

PATCH AND REPAIR EXISTING MATERIALS TO REMAIN AS REQUIRED WHERE REMOVAL OF EXISTING CONSTRUCTION OR WHERE REQUIREMENTS OF NEW CONSTRUCTION NECESSITATES CUTTING OR ALTERING EXISTING MATERIALS. EXISTING WALLS, FLOORS, AND CEILING TO REMAIN INTACT AS IS INDICATED ON DRAWINGS. COORDINATE WITH ARCHITECTURAL, MECHANICAL, PLUMBING, AND ELECTRICAL DOCUMENTS. CONTRACTOR IS RESPONSIBLE FOR THE PATCH AND REPAIR OF ALL DAMAGE ARISING FROM DEMOLITION OPERATIONS AS REQUIRED TO MATCH EXISTING.

ALL DEMOLITION WORK SHALL ATTEMPT TO SALVAGE ADJACENT AREAS AND RE-USABLE MATERIALS TO THE EXTENTS POSSIBLE. VERIFY OWNER'S INTENT TO REUSE OR STORE ANY BUILDING COMPONENTS PRIOR TO DISPOSAL. EXCEPT FOR ITEMS OR MATERIALS INDICATED TO BE REUSED, SALVAGED, REINSTALLED, OR OTHERWISE INDICATED TO REMAIN PROPERTY OF OWNER, DEMOLISHED MATERIALS SHALL BECOME THE CONTRACTOR'S PROPERTY AND SHALL BE REMOVED, RECYCLED, OR DISPOSED FROM PROJECT SITE IN AN APPROPRIATE AND LEGAL MANNER.

EVERY ATTEMPT SHALL BE MADE BY THE DEMOLITION CONTRACTOR TO SEPARATE BUILDING MATERIALS INTO RECYCLABLE CONTENT. LOCATE DEMOLITION EQUIPMENT THROUGHOUT THE BUILDING AND REMOVE DEBRIS AND

MATERIALS SO AS NOT TO IMPOSE EXCESSIVE LOADS ON SUPPORTING WALLS, FLOORS, OR REMOVE STRUCTURAL FRAMING MEMBERS AND LOWER TO GROUND BY METHOD SUITABLE TO

AVOID FREE FALL AND TO PREVENT GROUND IMPACT OR DUST GENERATION. PROVIDE TEMPORARY AND SECURE WATERPROOF ENCLOSURE DURING CONSTRUCTION.

PREPARE ALL SURFACES AS REQUIRED TO RECEIVE NEW WORK AND NEW FINISHES AS INDICATED ON THE DRAWINGS AND SPECIFICATIONS. ALL SALVAGED ITEMS TO BE CLEANED, REPAIRS, OR PATCHED AS NECESSARY PRIOR TO NEW

REMOVE ANY DAMAGED MASONRY AT REMAINING WALLS. PROVIDE NEW INFILL TO MATCH EXISTING.

REMOVE EXISTING MECHANICAL AND PLUMBING SYSTEMS, VENTS, FIXTURES, DRAINS, AND DUCTWORK NOT INDICATED FOR REUSE. DO NOT ABANDON ITEMS IN PLACE UNLESS NOTED OTHERWISE. REFER TO MECHANICAL AND PLUMBING FOR ADDITIONAL INFORMATION.

### DISPOSAL PRACTICES AND HAULING:

LEGALLY TRANSPORT AND DISPOSE OF MATERIALS THAT CANNOT BE DELIVERED TO A SOURCE-SEPARATED OR MIXED RECYCLING FACILITY TO A TRANSFER STATION OR DISPOSAL FACILITY THAT CAN LEGALLY ACCEPT THE MATERIALS FOR THE PURPOSE OF DISPOSAL USE A PERMITTED WASTE HAULER OR CONTRACTOR'S TRUCKING SERVICES AND PERSONNEL. TO

CONFIRM VALID PERMITTED STATUS OF WASTE HAULERS, CONTACT THE APPROPRIATE WASTE

BECOME FAMILIAR WITH THE CONDITIONS FOR ACCEPTANCE OF NEW CONSTRUCTION, EXCAVATION AND DEMOLITION MATERIALS AT RECYCLING FACILITIES, PRIOR TO DELIVERING

DELIVER TO FACILITIES THAT CAN LEGALLY ACCEPT NEW CONSTRUCTION, EXCAVATION AND DEMOLITION MATERIALS FOR PURPOSE OF RE-USE, RECYCLING, COMPOSTING, OR DISPOSAL. DO NOT BURN, BURY OR OTHERWISE DISPOSE OF RUBBISH AND WASTE MATERIALS ON PROJECT

DEMOLISH CONCRETE AND MASONRY IN SIZES THAT WILL BE SUITABLE FOR ACCEPTANCE AT RECYCLING OR DISPOSAL FACILITIES.

SAFETY-RELATED WORK PRACTICES SHALL BE EMPLOYED TO PREVENT ELECTRIC SHOCK OR ELECTRICAL CONTACTS, WHEN WORK IS PERFORMED NEAR OR ON EQUIPMENT OR CIRCUITS WHICH ARE OR MAY BE ENERGIZED. LIVE PARTS SHALL BE DE-ENERGIZED BEFORE WORK COMMENCES ON THEM. ONLY QUALIFIED ELECTRICIAN MAY WORK ON ENERGIZED CIRCUITS OR

THE CIRCUITS AND EQUIPMENT TO BE WORKED ON SHALL BE DISCONNECTED FROM ALL ELECTRIC ENERGY SOURCES. ELECTRIC EQUIPMENT OR CIRCUITS WHICH HAVE BEEN DE-ENERGIZED SHALL BE LOCKED OUT OR TAGGED OR BOTH

A QUALIFIED ELECTRICIAN SHALL USE TEST EQUIPMENT (VOLT-OHM METER, ETC.) AND SHALL VERIFY THAT THE CIRCUIT AND EQUIPMENT ARE DE-ENERGIZED. IF THE CIRCUIT IS OVER 600 VOLTS THE TEST EQUIPMENT SHALL BE CHECKED FOR PROPER OPERATION IMMEDIATELY BEFORE AND IMMEDIATELY AFTER THIS TEST.

STORED ELECTRIC ENERGY WHICH MIGHT ENDANGER PERSONNEL SHALL BE RELEASED. CAPACITORS SHALL BE DISCHARGED AND HIGH CAPACITANCE ELEMENTS SHALL BE SHORT-CIRCUITED AND GROUNDED, IF THE STORED ELECTRIC ENERGY MIGHT ENDANGER PERSONNEL


A QUALIFIED ELECTRICIAN SHALL CONDUCT TESTS AND VISUAL INSPECTIONS TO VERIFY THAT ALL TOOLS, ELECTRICAL JUMPERS, SHORTS, GROUNDS, AND OTHER SUCH DEVICES HAVE BEEN


REMOVED, SO THAT THE CIRCUITS AND EQUIPMENT CAN BE SAFETY ENERGIZED. CAP, TERMINATE, OR REMOVE ALL MISCELLANEOUS POWER WIRES, OUTLETS, AND SWITCHES AS REQUIRED DURING CONSTRUCTION AND DEMOLITION

DISCONNECT AND REMOVE ALL EXISTING ELECTRICAL LIGHTING FIXTURES, LOW VOLTAGES TRANSFORMERS, WIRING DEVICES IN ENTIRETY. ALL CONDUIT, WIRING, CABLING, ETC. SHALL BE REMOVED BACK TO THE SOURCE.


ALL GAS TO BE SHUT OFF TO AREAS OF DEMOLITION BY A QUALIFIED CONTRACTOR. TEST FOR LEAKS PRIOR TO COMMENCING WORK.

WHERE APPLICABLE, PROVIDE NEW SHUT OFF VALVES WHERE PIPING REACHES AREA OF

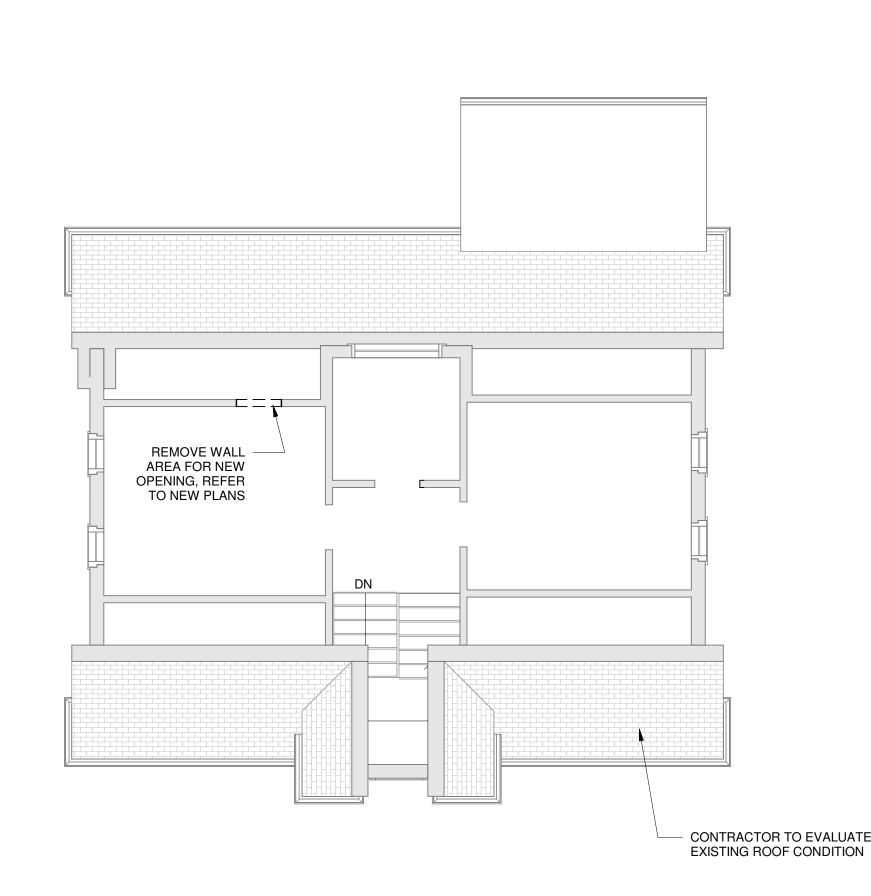

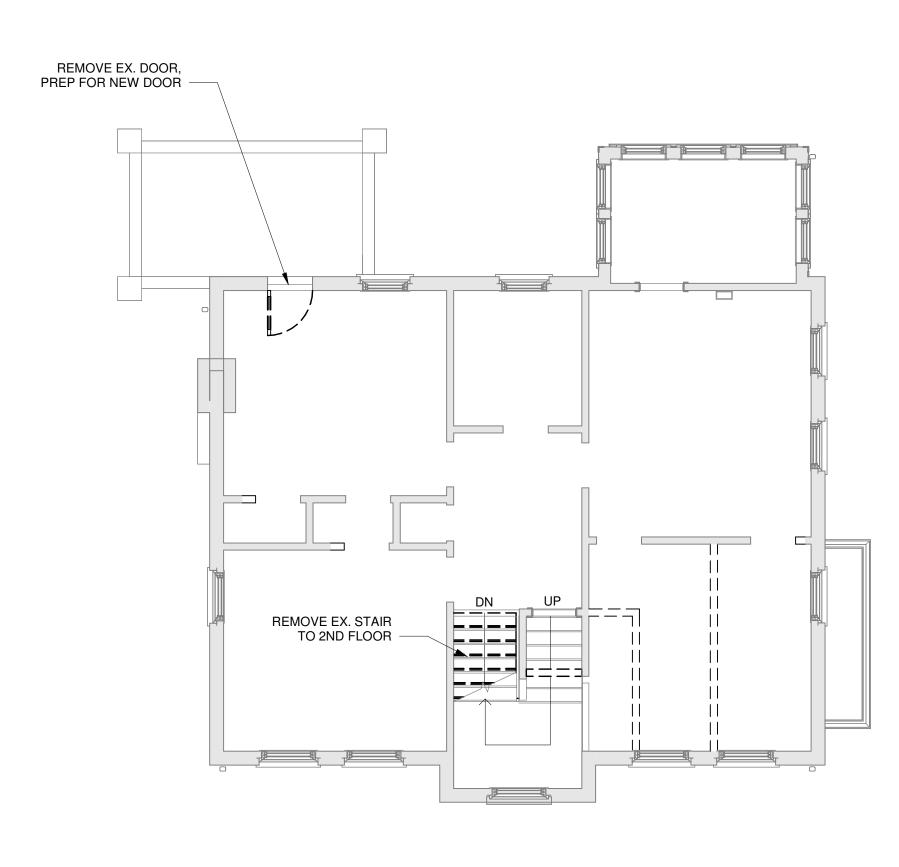


# ATTIC PLAN - DEMO 3/16" = 1'-0"

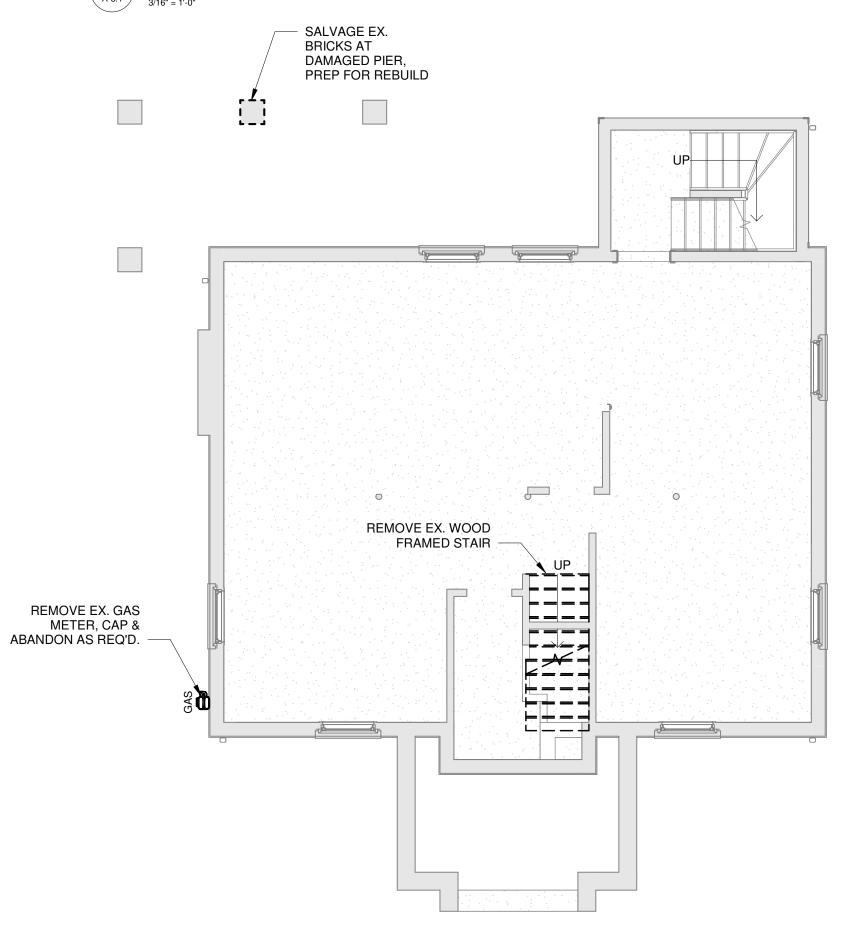




### SECOND FLOOR - DEMO

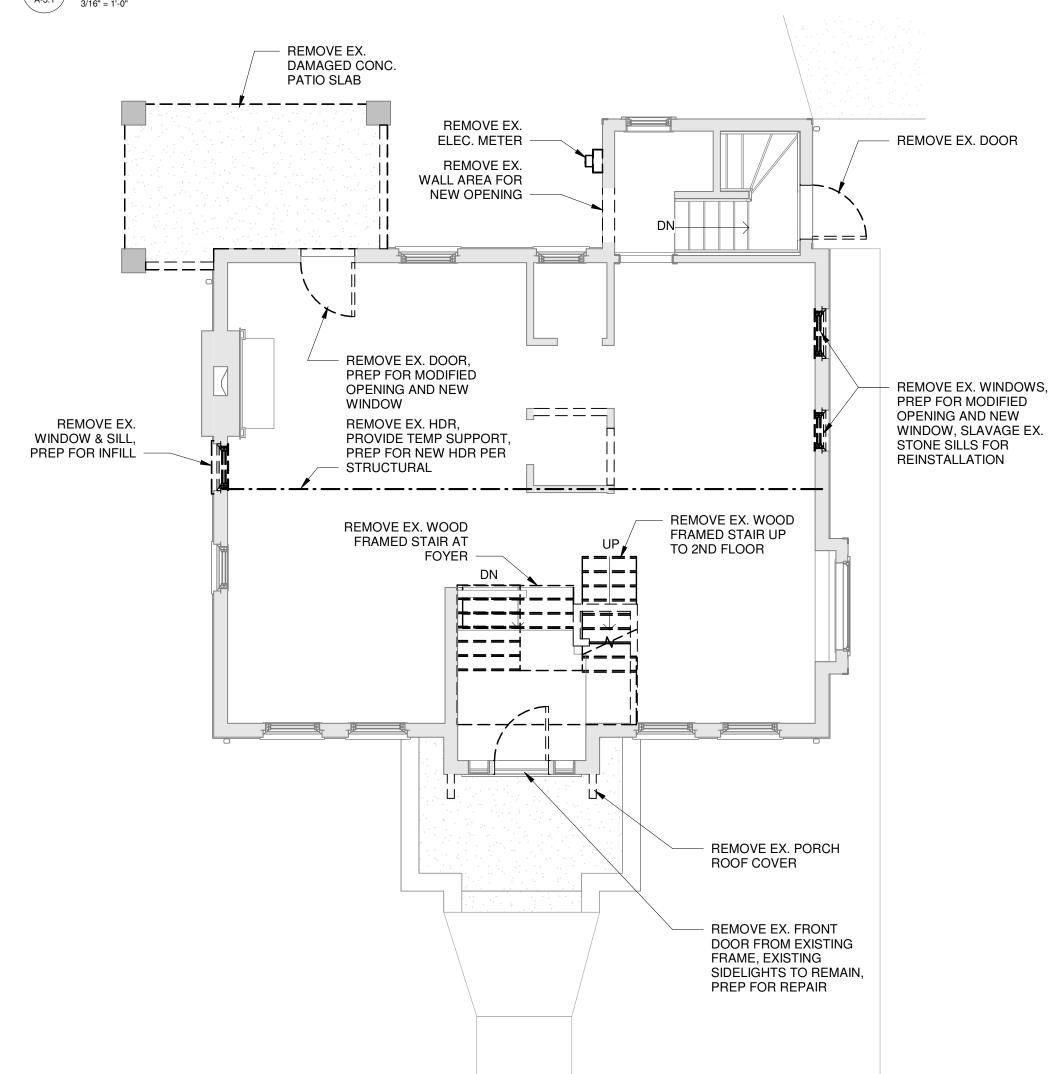

FIRST FLOOR - DEMO

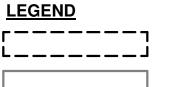

**DEMOLISHED EXISTING** 



**Email:** infuzltd@comcast.net Web: infuzarchitects.com

Unauthorized use of this drawing set without written permission from VIRTUOSO DESIGN + BUILD and Infuz Ltd is in violation of U.S. COPYRIGHT LAWS and will be subject to civil damages and prosecution.

Revision Schedule Description

01/20/2025 2 HDC SET 08/15/2025

DATE SEALED

ZAMP, DEMOLITION LAC ∞ 1724 SEY DETROIT, RYAN

SHEET NUMBER

8/18/2025 12:27:26 PM


TORIC













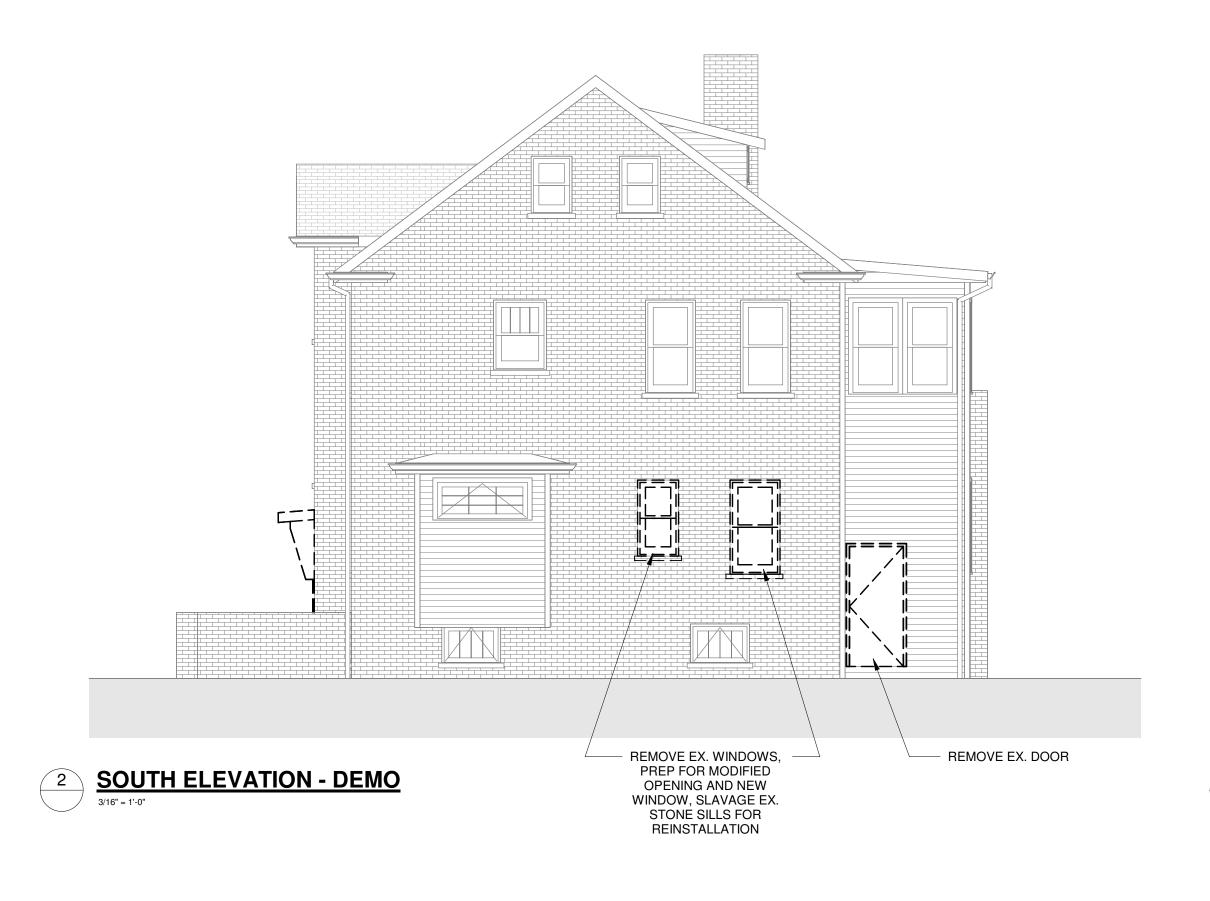

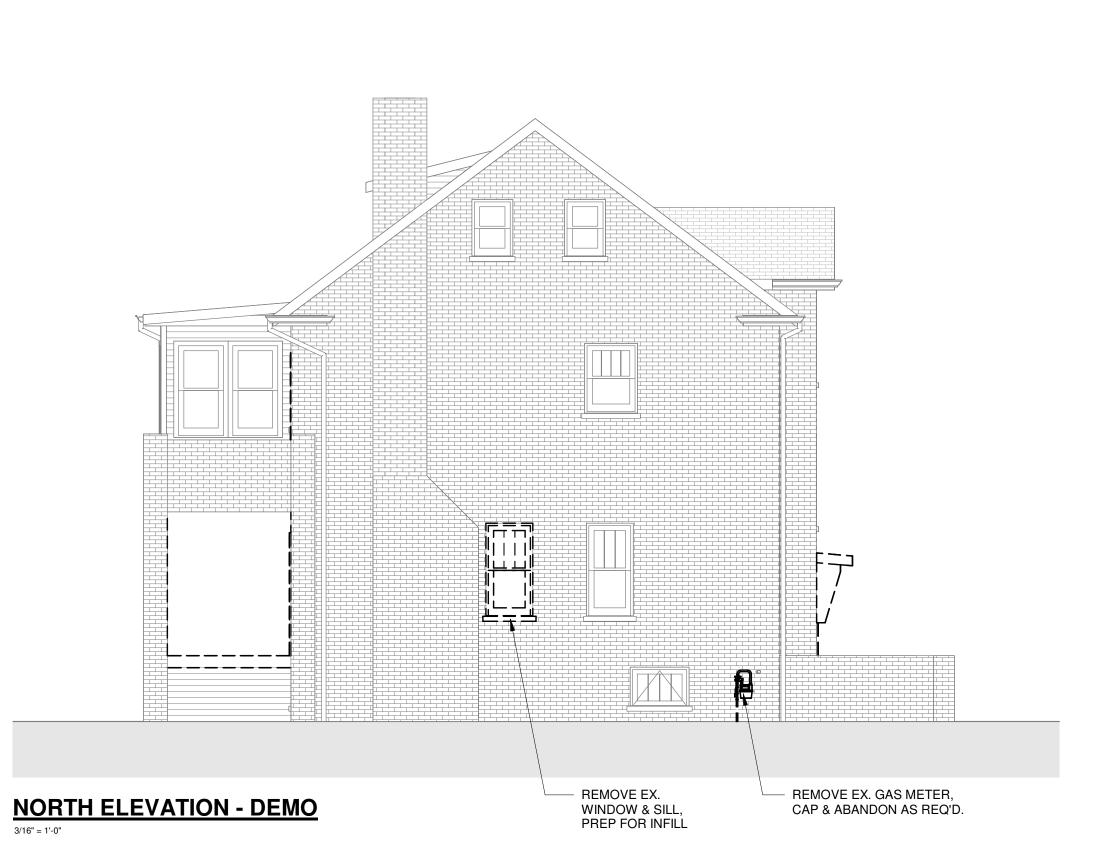

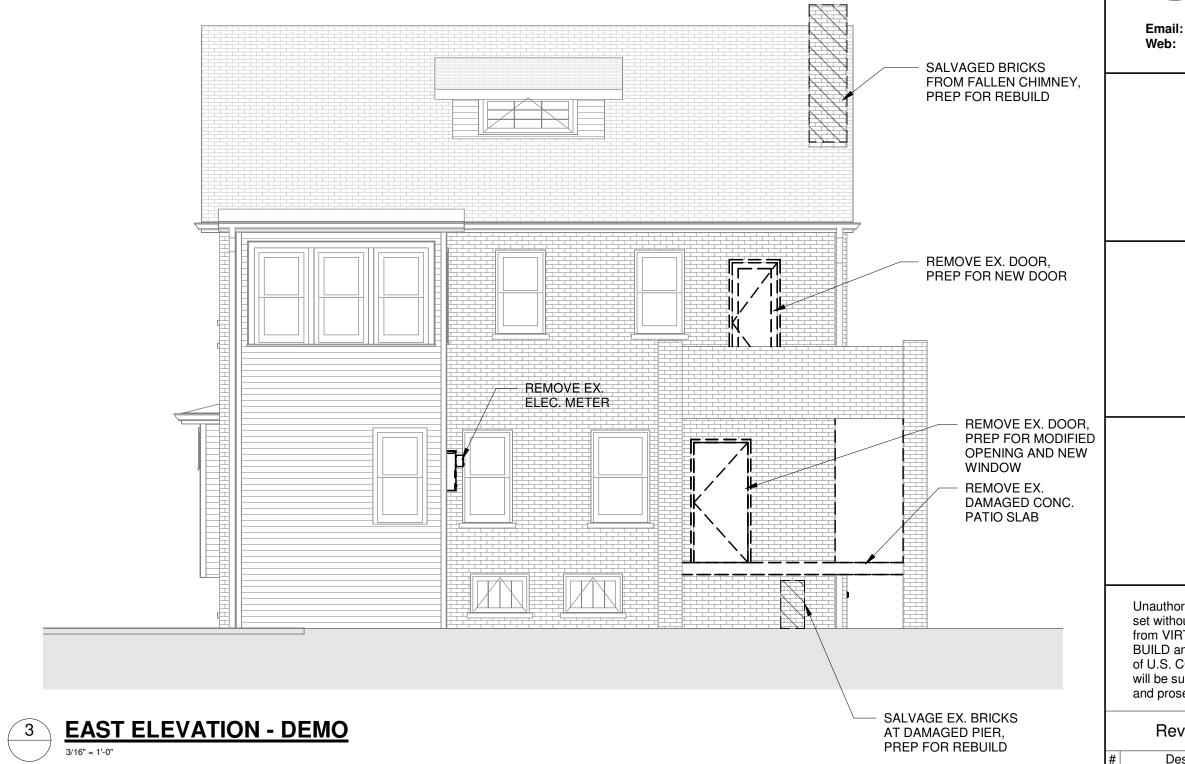

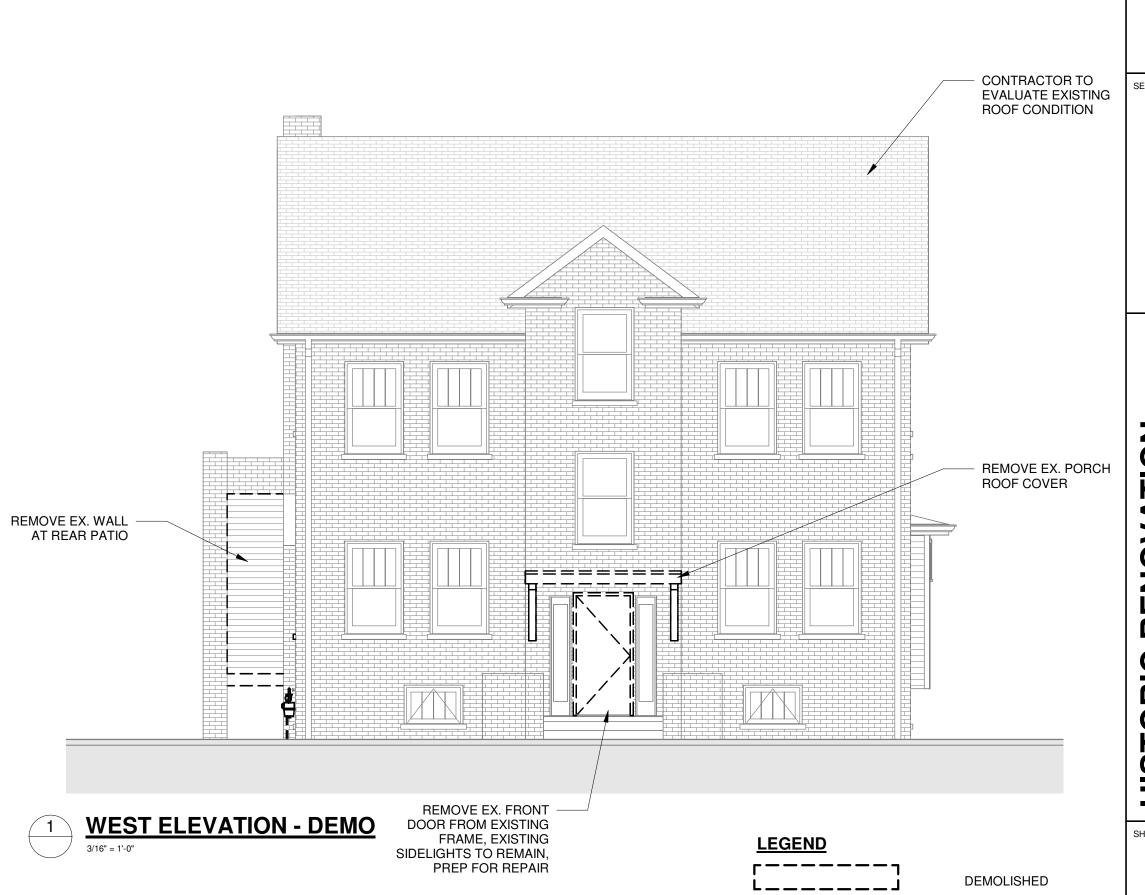

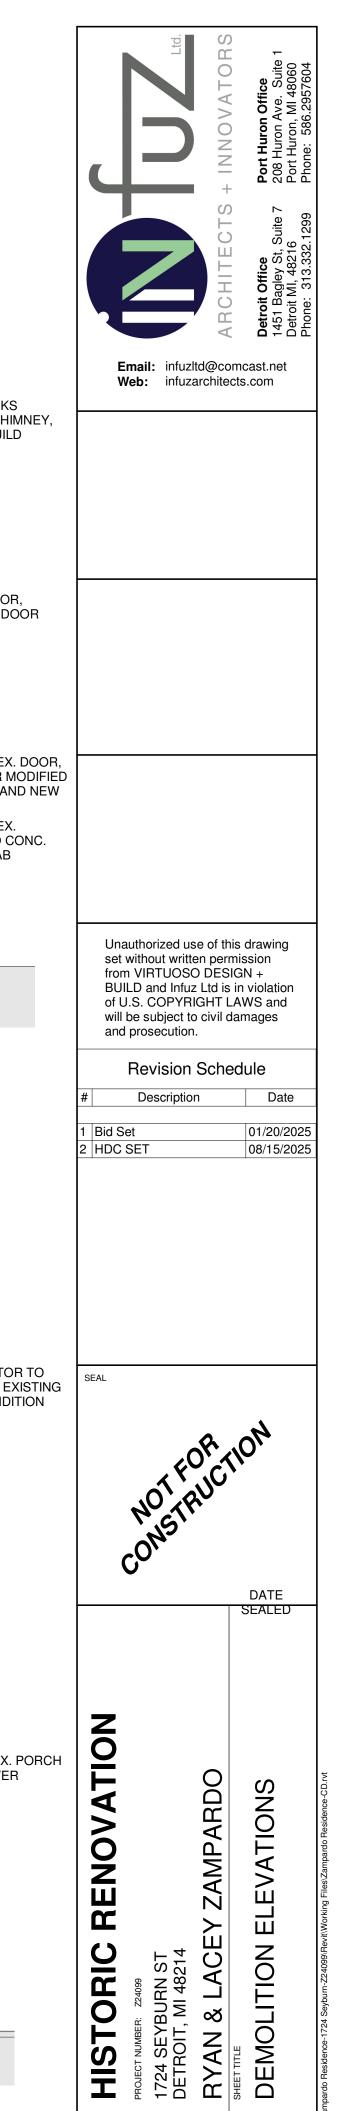


DEMOLITION

SHEET NUMBER A-1.1

8/18/2025 12:16:01 PM

**EXISTING** 

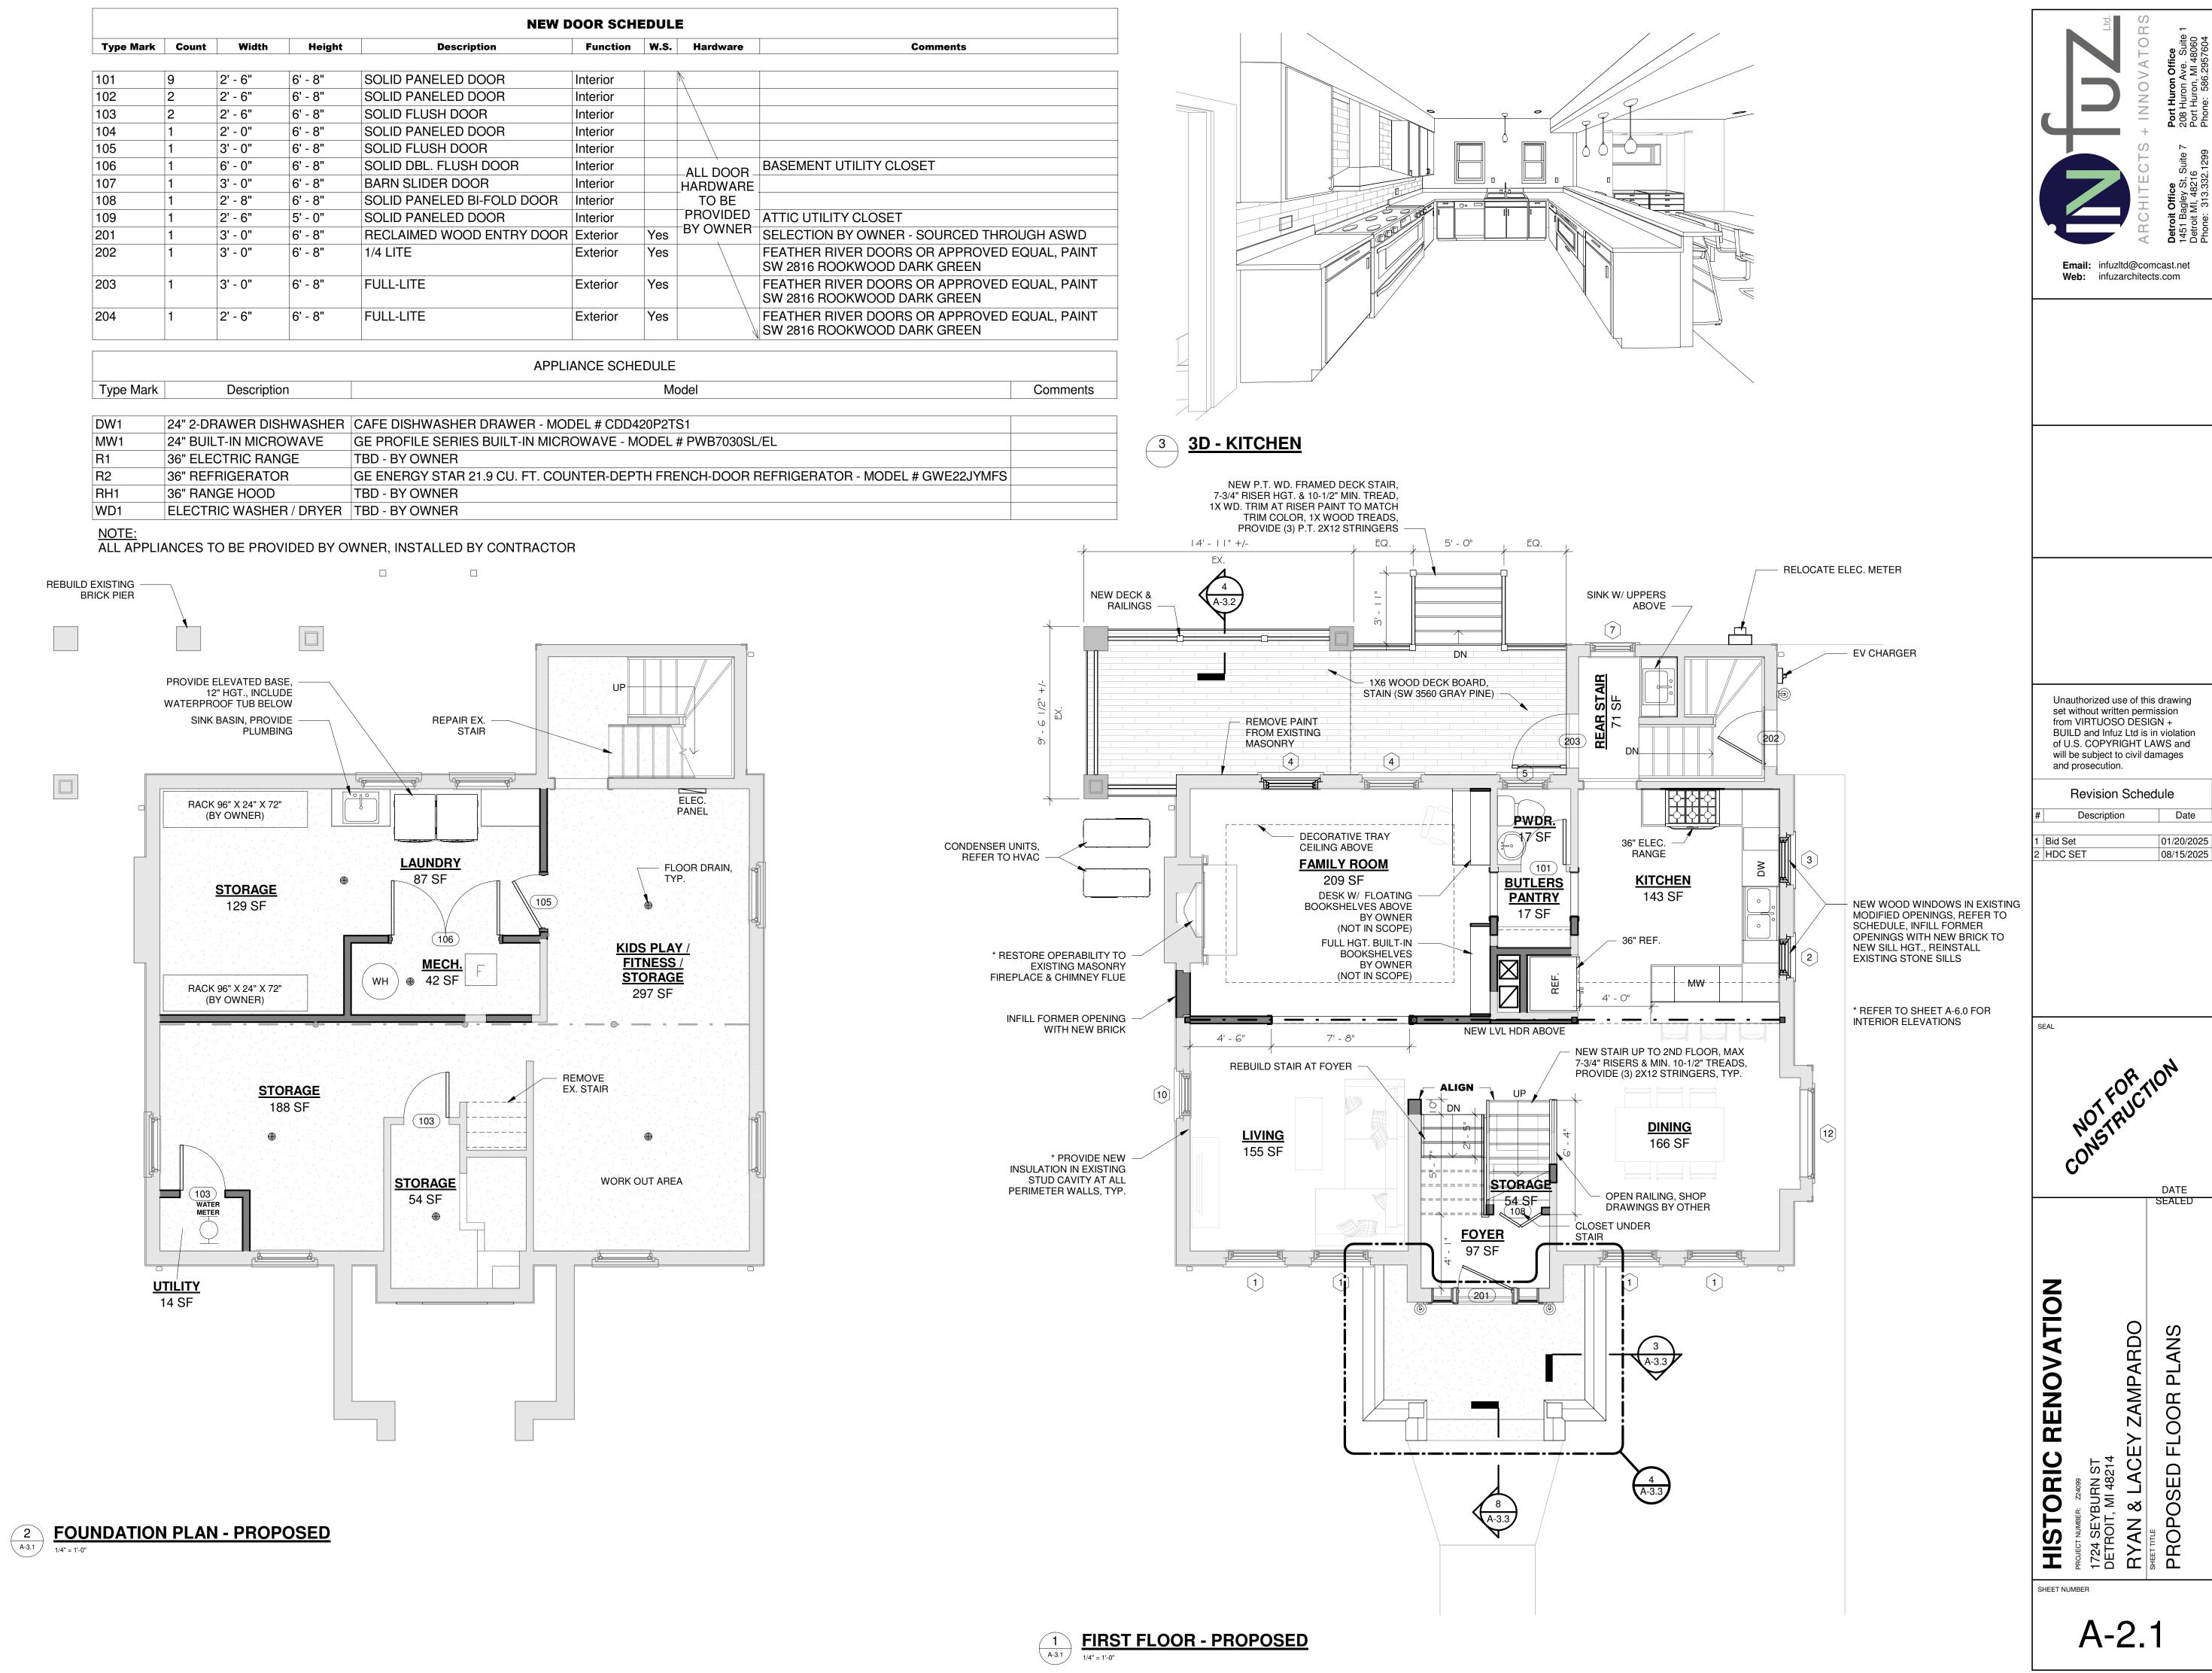


8/18/2025 12:29:26 PM

ROOM FINISH SCHEDULE						
Name	Area	Wall Finish	Floor Finish	Base Finish	Ceiling Finish	Comments
EX. 2ND FLOOR						
PRIMARY BEDROOM	169 SF	GWB, PAINT	HARDWOOD	WD BASE BD	GWB, PAINT	
WALK-IN-CLOSET	43 SF	GWB, PAINT	HARDWOOD	WD BASE BD	GWB, PAINT	
PRIMARY BATH	39 SF	GWB, PAINT	TILE	WD BASE BD	GWB, PAINT	
HALL	70 SF	GWB, PAINT	HARDWOOD	WD BASE BD	GWB, PAINT	
BEDROOM 2 (GUEST OPT.)	139 SF	GWB, PAINT	HARDWOOD	WD BASE BD	GWB, PAINT	
BEDROOM 1	139 SF	GWB, PAINT	HARDWOOD	WD BASE BD	GWB, PAINT	
BATH	47 SF	GWB, PAINT	TILE	WD BASE BD	GWB, PAINT	
CLO.	6 SF	GWB, PAINT	HARDWOOD	WD BASE BD	GWB, PAINT	
CLO.	10 SF	GWB, PAINT	HARDWOOD	WD BASE BD	GWB, PAINT	
CLO.	10 SF	GWB, PAINT	HARDWOOD	WD BASE BD	GWB, PAINT	
SUN PORCH	71 SF	GWB, PAINT	HARDWOOD	WD BASE BD	GWB, PAINT	
VANITY	52 SF	GWB, PAINT	HARDWOOD	WD BASE BD	GWB, PAINT	
	796 SF	1	1	1	'	ı

EX. ATTIC						
PLAY / CRAFT / KIDS ROOM (BEDROOM OPT.)	130 SF	GWB, PAINT	HARDWOOD			
BEDROOM 3	130 SF	GWB, PAINT	HARDWOOD			
BONUS / FUTURE BATHROOM	48 SF	GWB, PAINT	TILE OR HW			VERIFY W/ OWNER
STAIR	100 SF	GWB, PAINT	HARDWOOD			
UTILITY	41 SF	GWB, PAINT	VINYL	VINYL COVE WALL BASE	GWB, PAINT	


449 SF 2938 SF Grand total: 33

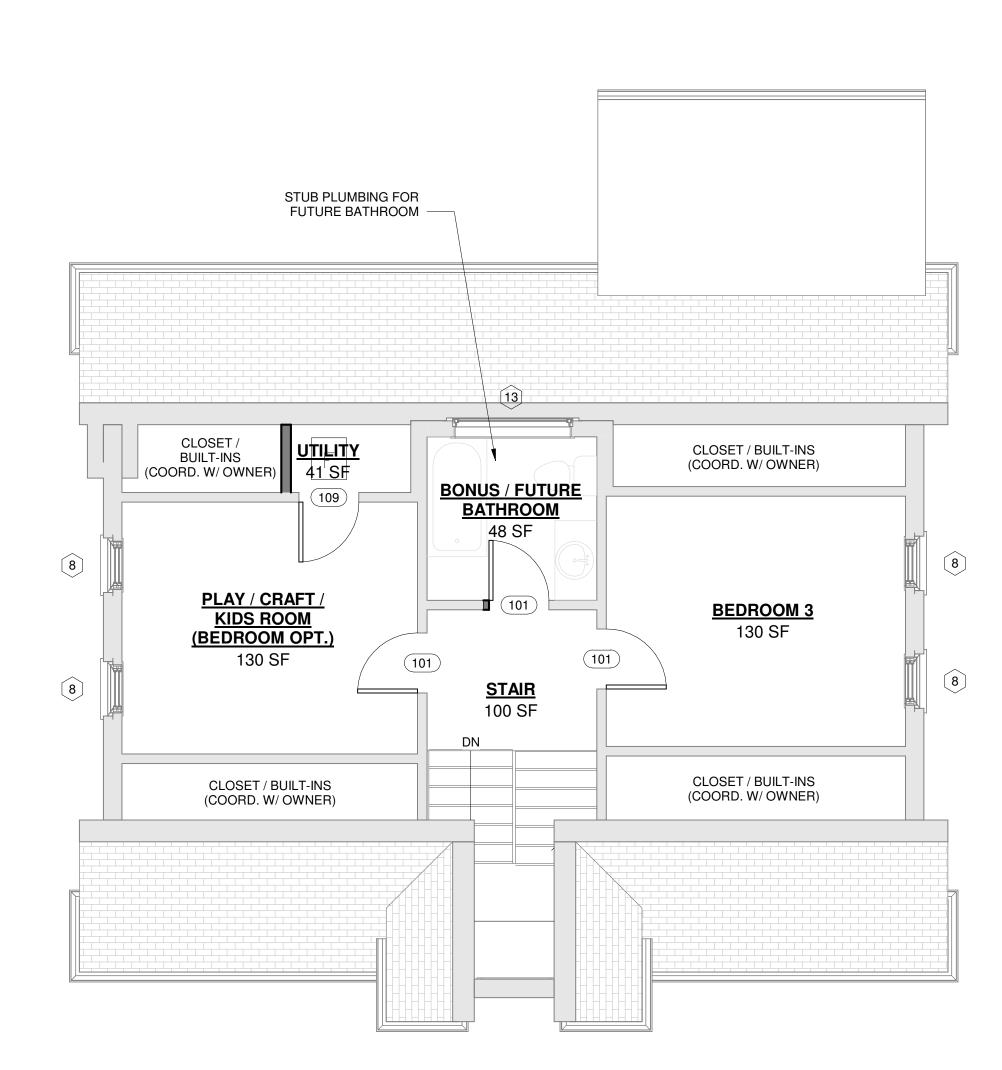


1
A-3.1
A-7.1
A-7.1
A-7.1

	ROOM FINISH SCHEDULE					
Name	Area	Wall Finish	Floor Finish	Base Finish	Ceiling Finish	Comments
EX. BASEMENT						
STORAGE	129 SF	GWB, PAINT	CONC.	VINYL COVE WALL BASE	E EXPOSED JOISTS, PAINT	
LAUNDRY	87 SF	GWB, PAINT	CONC.		EXPOSED JOISTS, PAINT	
KIDS PLAY / FITNESS / STORAGE		GWB, PAINT	CONC.		EXPOSED JOISTS, PAINT	
STORAGE	54 SF	GWB, PAINT	CONC.		EXPOSED JOISTS, PAINT	
STORAGE	188 SF	GWB, PAINT	CONC.		EXPOSED JOISTS, PAINT	
UTILITY	14 SF	GWB, PAINT	CONC.		EXPOSED JOISTS, PAINT	
MECH.	42 SF	GWB, PAINT	CONC.	VINYL COVE WALL BASE	EXPOSED JOISTS, PAINT	
	812 SF	-				
EX. 1ST FLOOR						
PWDR.	17 SF	GWB, PAINT	TILE	WD BASE BD	GWB, PAINT	
REAR STAIR	71 SF	GWB, PAINT	HARDWOOD	WD BASE BD	GWB, PAINT	
LIVING	155 SF	GWB, PAINT	HARDWOOD	WD BASE BD	GWB, PAINT	
DINING	166 SF	GWB, PAINT	HARDWOOD	WD BASE BD	GWB, PAINT	
KITCHEN	143 SF	GWB, PAINT	TILE OR HW	WD BASE BD	GWB, PAINT	
BUTLERS PANTRY	17 SF	GWB, PAINT	HARDWOOD	WD BASE BD	GWB, PAINT	
FAMILY ROOM	209 SF	GWB, PAINT OR WALL PAPER	HARDWOOD	WD BASE BD	GWB, PAINT	DECORATIVE TRAY DETAIL
FOYER	97 SF	GWB, PAINT	HARDWOOD	WD BASE BD	GWB, PAINT	
CLO.	6 SF	GWB, PAINT		WD BASE BD	GWB, PAINT	
	882 SF	<u> </u>	1	1		1

NOTE:
ALL FINAL FINISH SELECTIONS BY OWNER

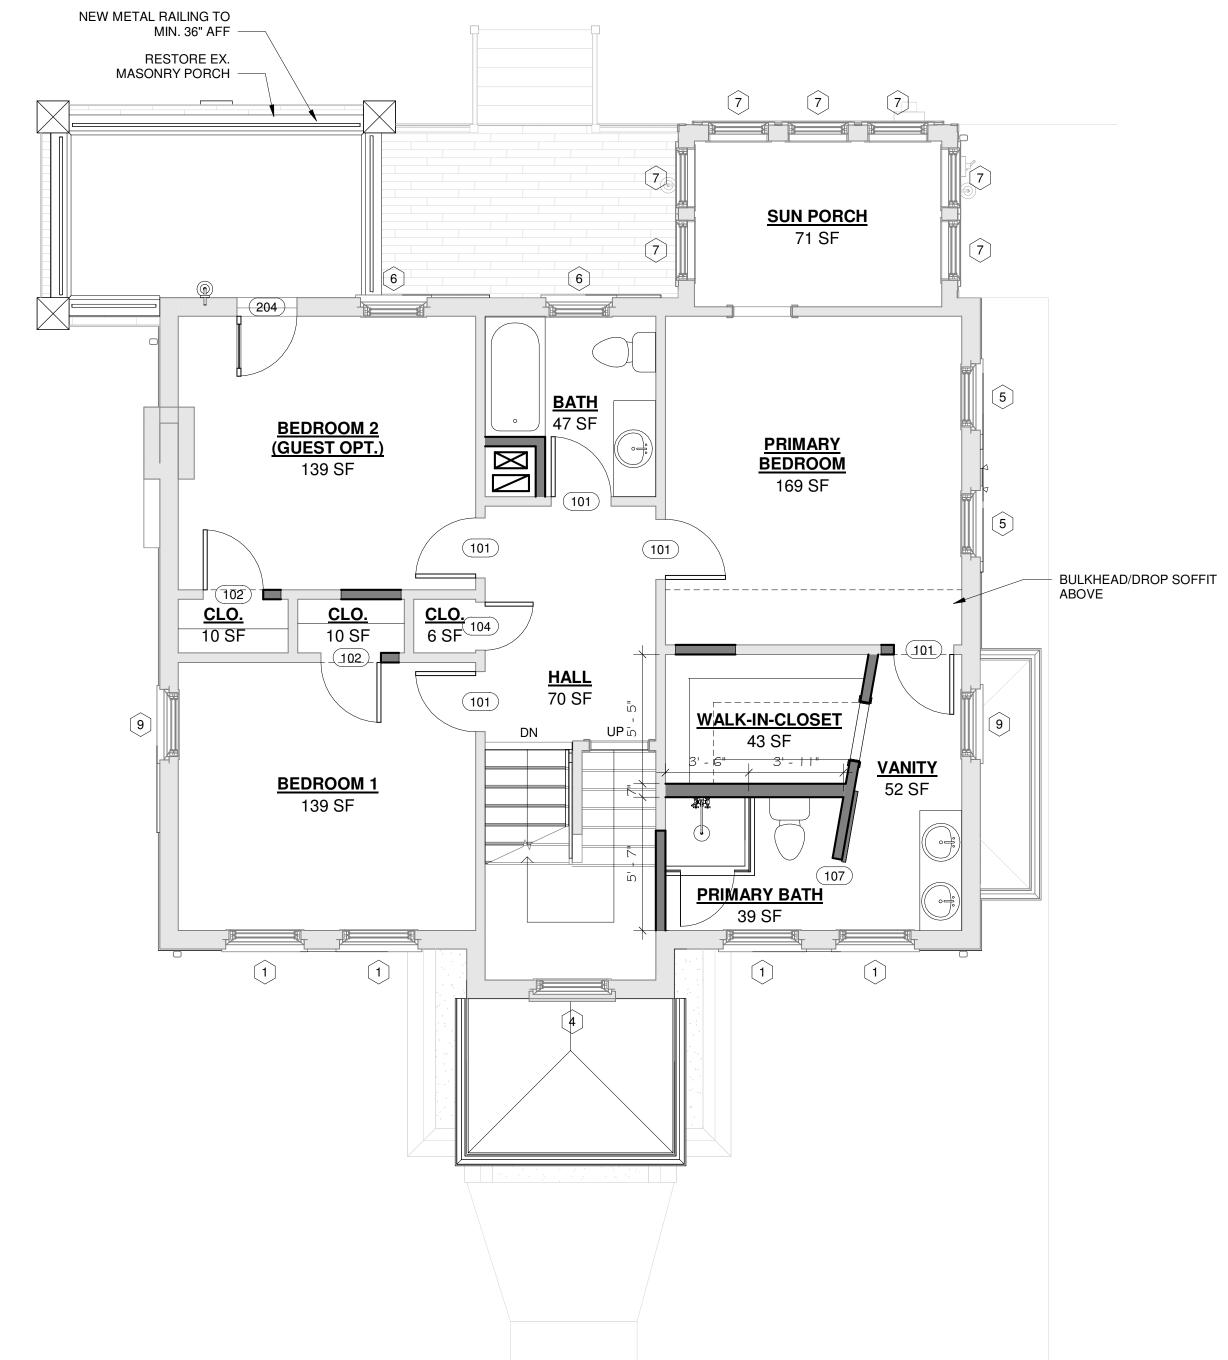

3
A-3.1
SECOND FLOOR - PROPOSED
1/4" = 1'-0"

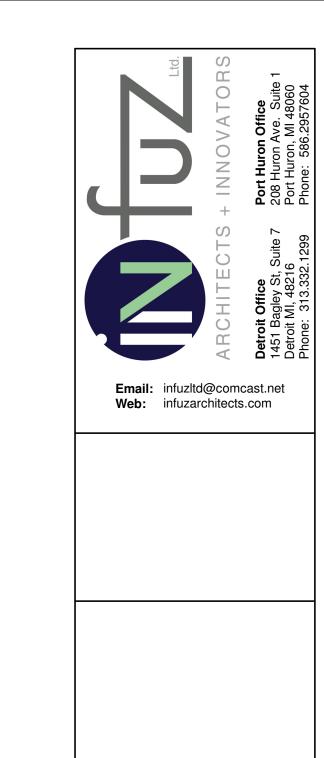

Unauthorized use of this drawing set without written permission from VIRTUOSO DESIGN + BUILD and Infuz Ltd is in violation of U.S. COPYRIGHT LAWS and will be subject to civil damages and prosecution.

Revision Schedule Description

01/20/2025 2 HDC SET 08/15/2025

DATE SEALED

HISTORIC RENOVATION
PROJECT NUMBER: 24099
1724 SEYBURN ST
DETROIT, MI 48214
RYAN & LACEY ZAMPARDO
SHETTITLE
PROPOSED FLOOR PLANS

8/18/2025 12:16:04 PM

A-2.2

Docusign Envelope ID: D5393107-C48D-4E4E-A9F5-CFD7923BCABC

### ROOFING NOTES:

#### PITCHED ROOFS WITH SHINGLES:

- 1. PROVIDE W&I SHIELD @ ALL EAVES MIN. 24" BEYOND INSIDE FACE OF EXTERIOR WALLS.
- 2. PROVIDE W&I SHIELD @ SADDLES AND AREAS WHERE CONVERGING PITCHES MAY RETAIN SNOW BUILD-UP.
- PROVIDE 'VALLEY GUARD' AT ALL VALLEY LOCATIONS.
   PROVIDE MIN 30 YR. WARRANTY SHINGLES WITH MIN 15# FELT
- UNDERLAYMENT.
  5. ENSURE THAT ALL DORMERS (FALSE & TRUE) ARE VENTED.
- 6. WHERE FLAT ROOF MEMBRANES MEET SLOPED ROOFS, RUN MEMBRANE MIN. 48" UP SLOPE.
- REFER TO MANUFACTURER DETAILS AND RECOMMENDED PRACTICES FOR ALL ROOFING MATERIALS.

#### FLAT ROOFS:

- WHERE EXISTING FLAT ROOFS EXIST, ROOFING CONTRACTOR SHALL PROVIDE INSPECTION FOR LEAKS, AND PITCH ISSUES TO ROOF SUMPS.
   WHERE NEW MEMBRANE ROOFS ARE SPECIFIED, RUN MEMBRANE A MIN. OF 8" UP VERTICAL PARAPET WALLS WITH COUNTER FLASHING DETAIL AS
- RECOMENDED BY MFR.... OR UP UNDER COPING.

  METAL COPING TO BE MIN .024 MM PRE FINISHED ALUM OR APPROVED
- 4. PROVIDE MIN RIGID INSULATION AS REQUIRED BY CODE, TAPER WHERE NECESSARY TO ASSURE POSITIVE FLOW OF WATER.

#### INSULATION/VENTING & ACCESS:

- 1. PROVIDE MIN. R-26 INSULATION AT ALL BOND AND CONCEALED/SHAFT CONDITIONS.
- ALL BATT INSULATION SHALL PROVIDE VAPOR BARRIER AT WARM SIDE.
   RIGID INSULATIONS SHALL CONTAIN/EMIT NO HCFC'S.
   CONFIRM OWNER REQUIREMENTS FOR BATT SOUND INSULATION IN
- WALLS, FLOORS AND CEILINGS.
  5. PROVIDE INSULATION BEHIND ANY FIXTURE OR CHASE IN EXTERIOR
- WALLS.6. CONFIRM THAT ANY FIXTURE BEING COVERED BY INSULATION IS APPROVED AND/OR IC RATED.
- 7. A READILY ACCESSIBLE OPENING NOT LESS THAN 22" X 30" SHALL BE PROVIDED TO ANY ATTIC AREA HAVING A CLEAR HEIGHT OF OVER 30". PROVIDE ACCESS TO ALL PLUMBING CONTROL VALVES AND MOTORS.
- 8. PROVIDE FREE AIRFLOW FROM ALL SOFFITS TO THE ROOF SPACE
  MAINTAINING VENTILATION TO ANY CONCEALED ROOF AREAS; PROVIDE
  BAFFLES WHERE REQUIRED FOR UNOBSTRUCTED AIR FLOW.

### DRAINAGE NOTES:


- 1. IF REQUIRED, ALL DRAIN TILES TO BE MIN. 4" DIA., RIGID PVC IN PEA STONE COVER, PROVIDE FILTER FABRIC PROTECTION.
- 2. CONNECT ALL DOWNSPOUTS INTO EXISTING DRAIN TILE WHERE APPLICABLE.
- 3. VERIFY W/ OWNER FOR ANY DISCONNECTED DOWNSPOUTS AT LANDSCAPE LOCATIONS.


#### MOISURE PROTECTION

### PROVIDE FLASHING AT ALL WALL ASSEMBLIES AT MATERIAL TRANSITIONS. WHERE ANY MOISTURE INTRUSION MAY OCCUR IN BUILDING ASSEMBLIES,

- PROVIDE RELIEF OUTLET WITH DIRECTED, POSITIVE FLOW.

  3. ALL INTERIOR CONCRETE SLABS SHALL HAVE MIN. 6 MIL VAPOR BARRIER BELOW; WHERE EXTREME WET SOILS EXIST, PROVIDE MIN 12 MIL VAPOR BARRIER OVER MIN. 6" OF 3/4" SHARP STONE (NO FINES) BASE WITH PITCHED SUBGRADE TO DRAIN TILES.
- 4. USE PRESSURE TREATED WOOD WITHIN 8" OF GRADE AND PROTECT WITH WATERPROOF MEMBRANE.
- 5. USE SOLAR SEAL CAULK FOR ALL EXTERIOR APPLICATIONS, COLOR TO MATCH TRIM.

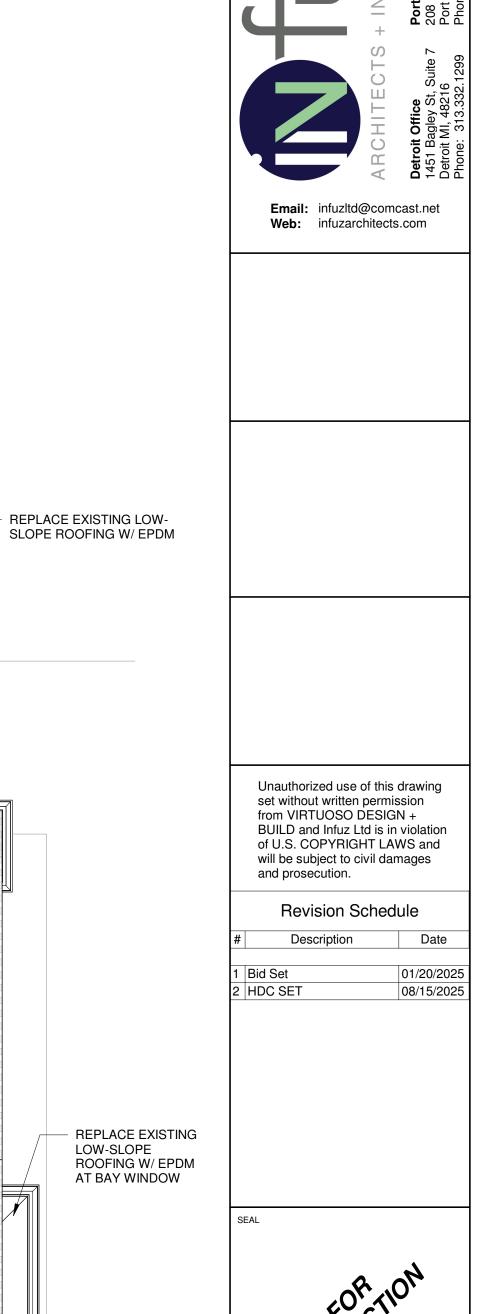

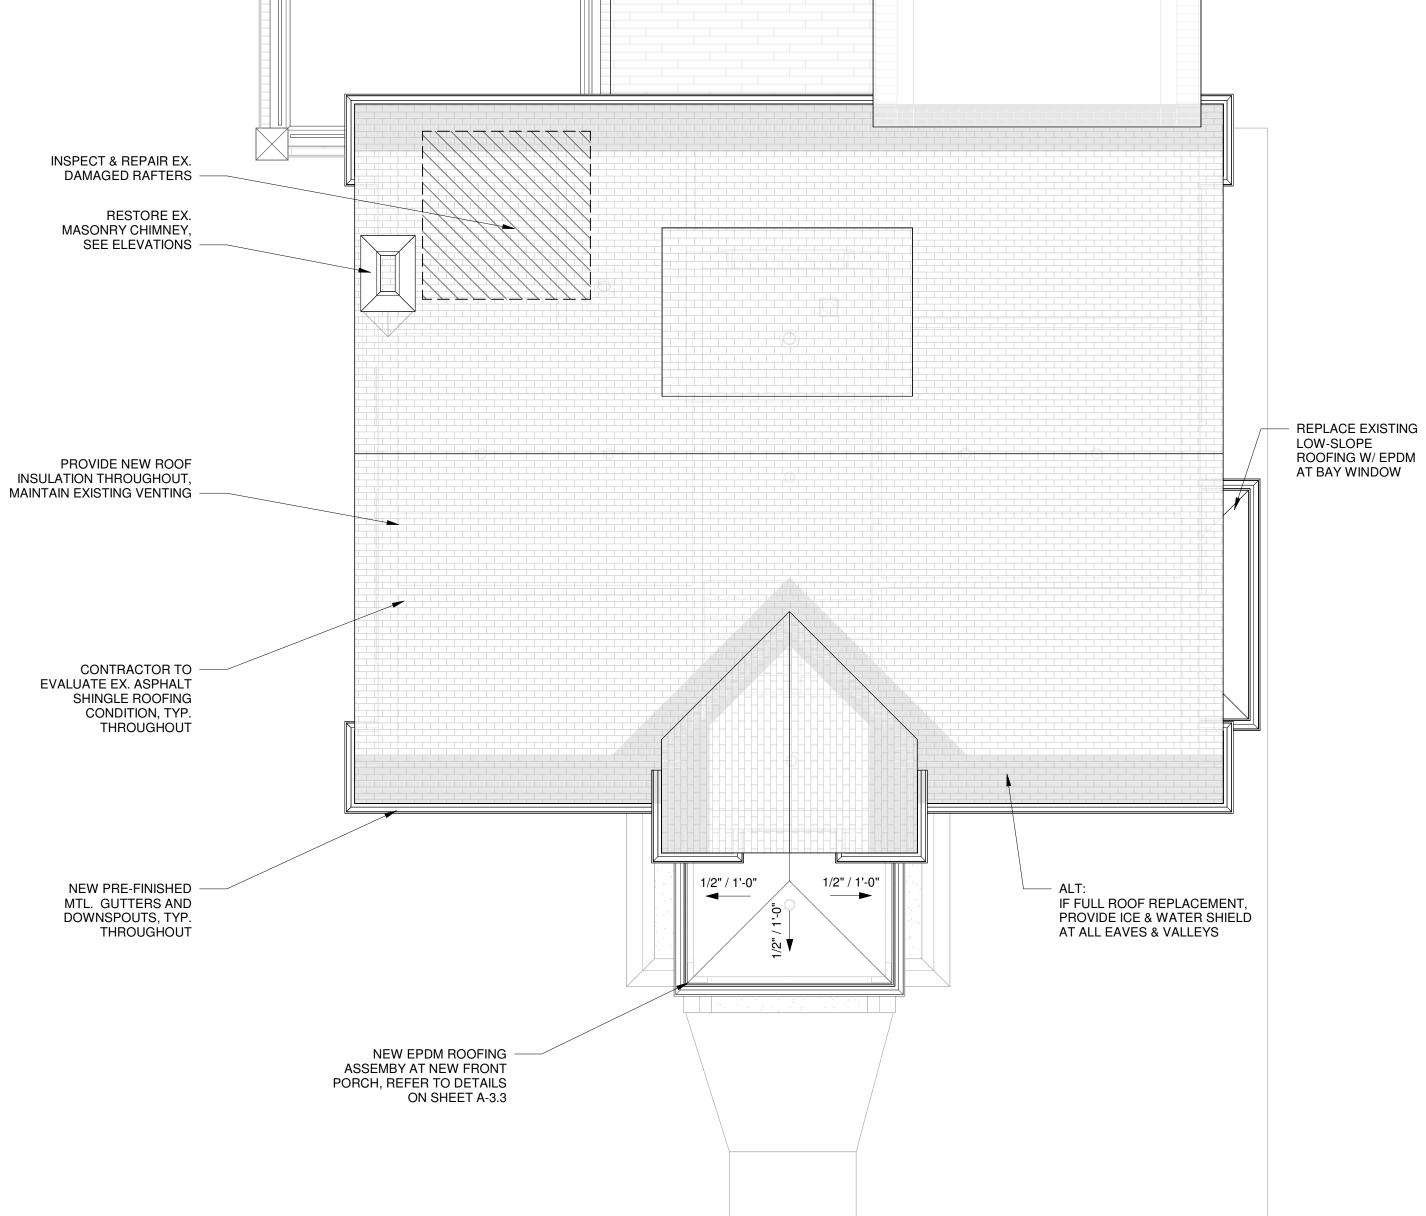



INSPECT EX. CONC. BALCONY

SURFACE, REPAIR AS REQ'D.

PROJECT NUMBER: 224099
1724 SEYBURN ST
DETROIT, MI 48214

RYAN & LACEY ZAMPARDO

SHETTITLE

PROPOSED ROOF PLAN

HISTORIC RENOVATION

8/18/2025 12:16:05 PM

DATE










SURRONDING RESIDENCES W/ CENTER PORCHES (IN REGARDS TO HISTORIC SUBMISSION)

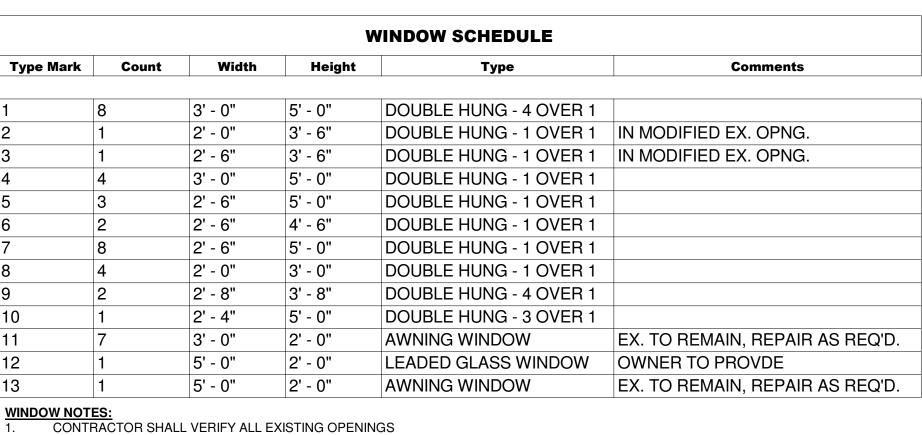

INTERSTATE BRICK - BRONZESTONE













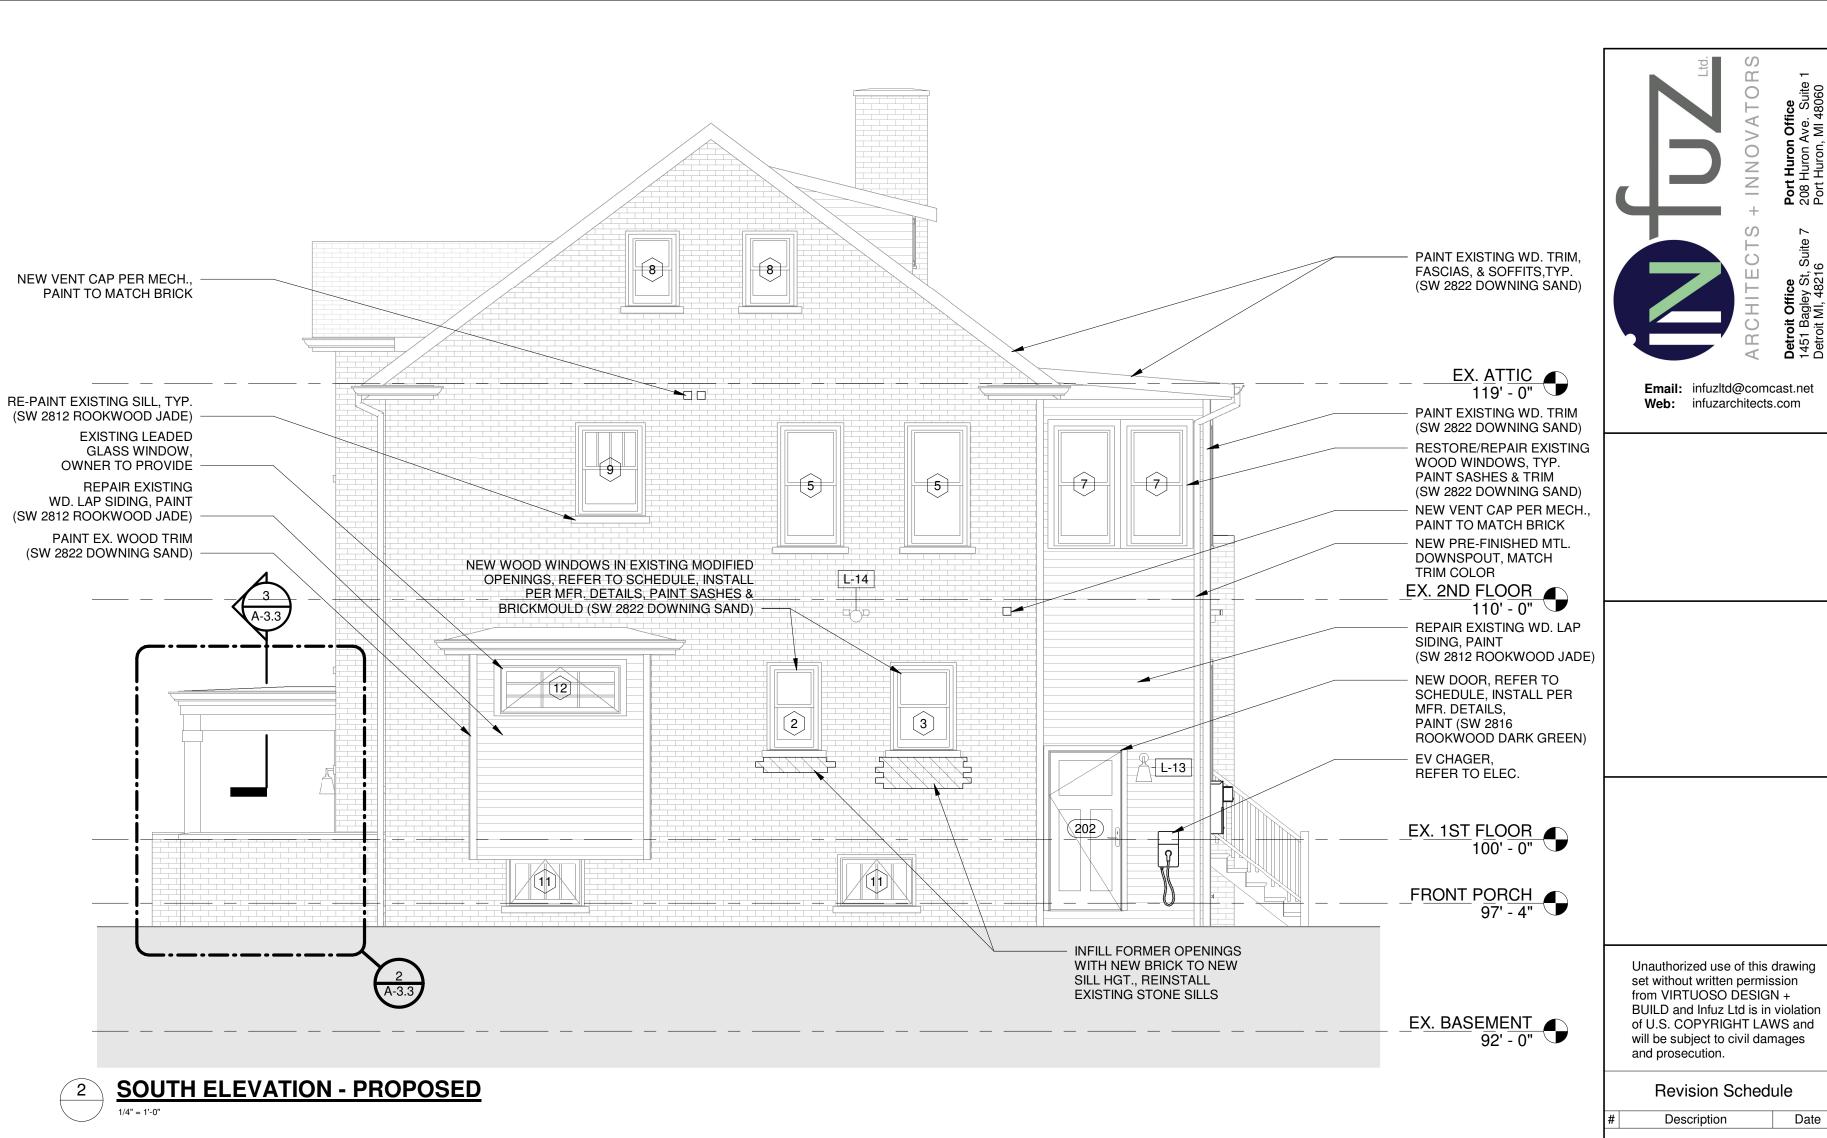

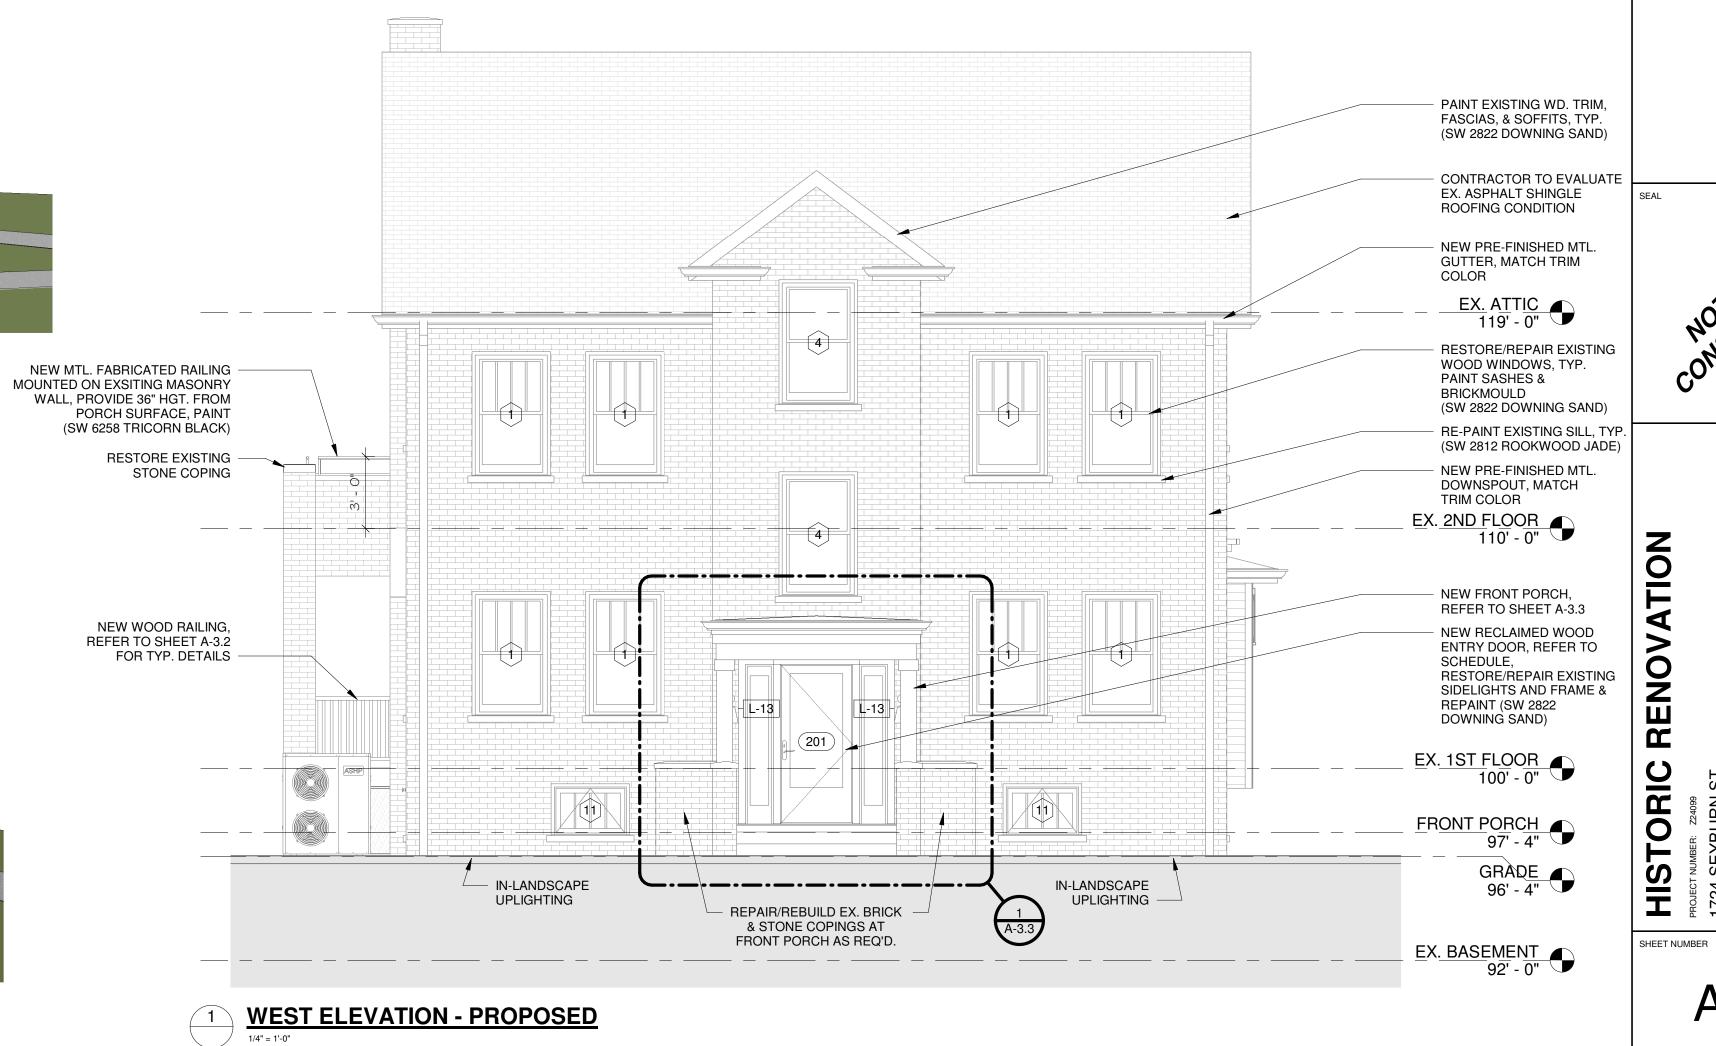

DATE SEALED

Description

2 HDC SET

01/20/2025


08/15/2025


ELEVATIONS

ZAMPARDO EXTERIOR & LACEY PROPOSED

RYAN SHEET THE A-3.

8/18/2025 12:16:13 PM

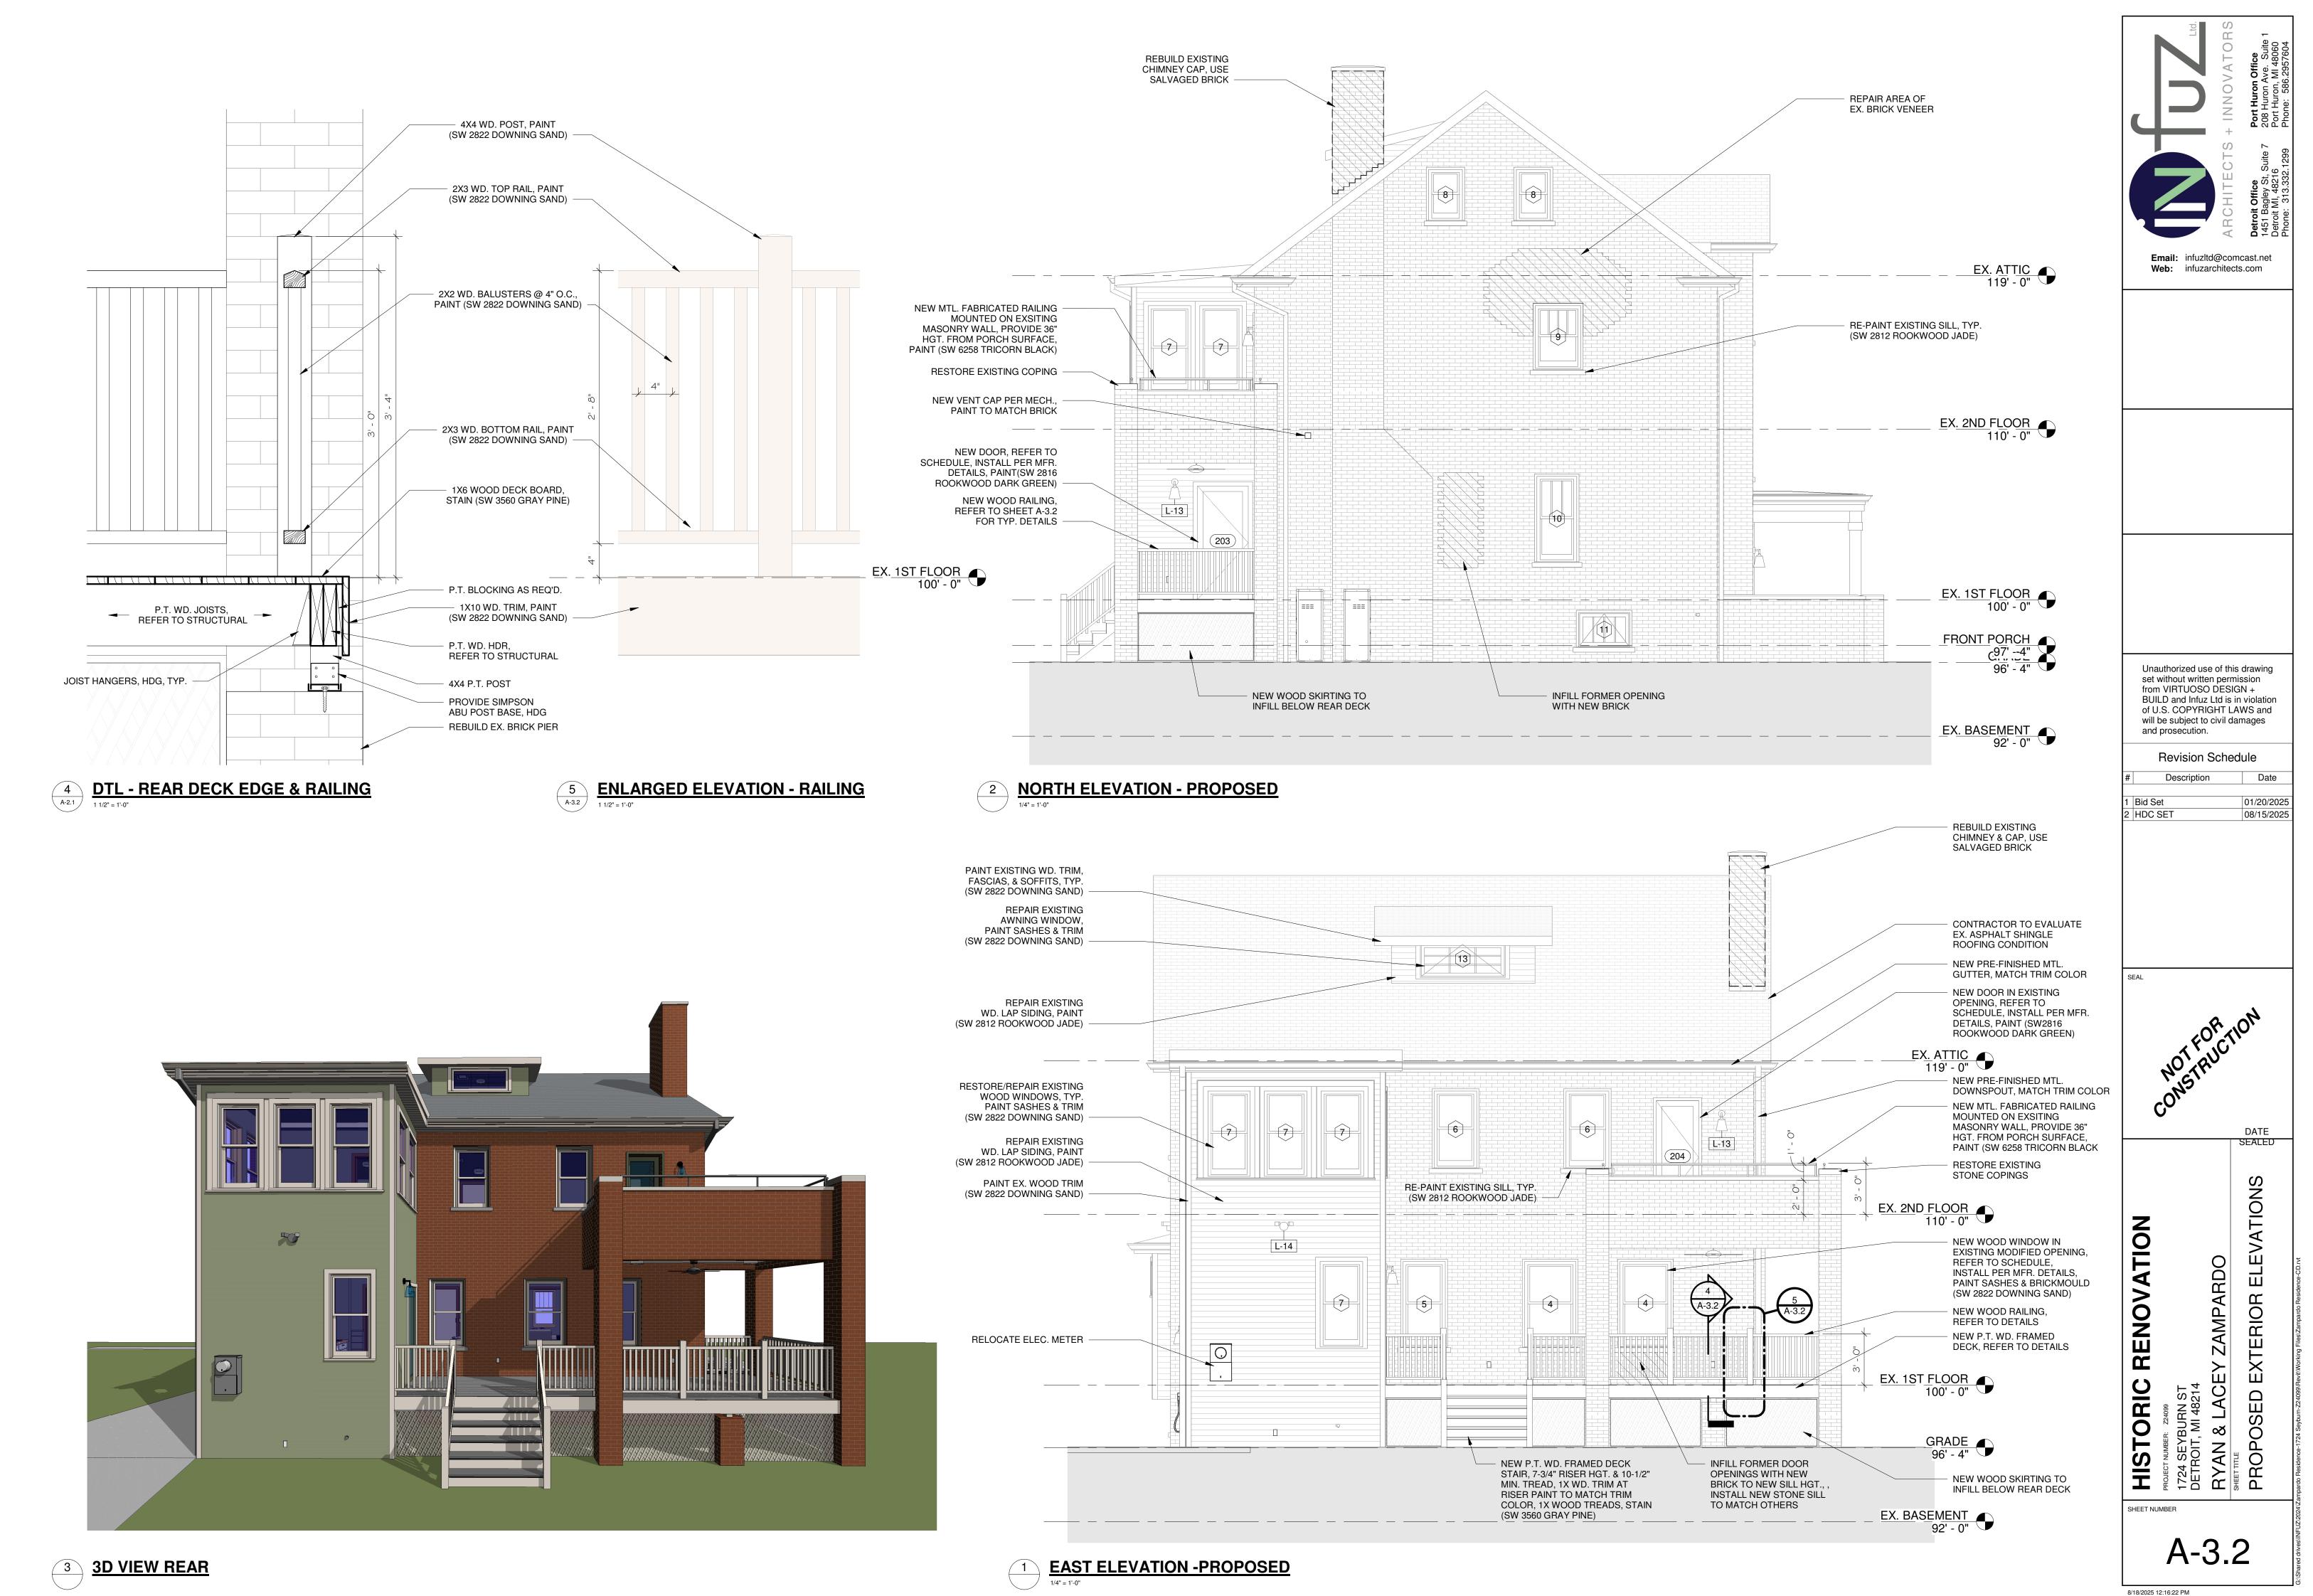

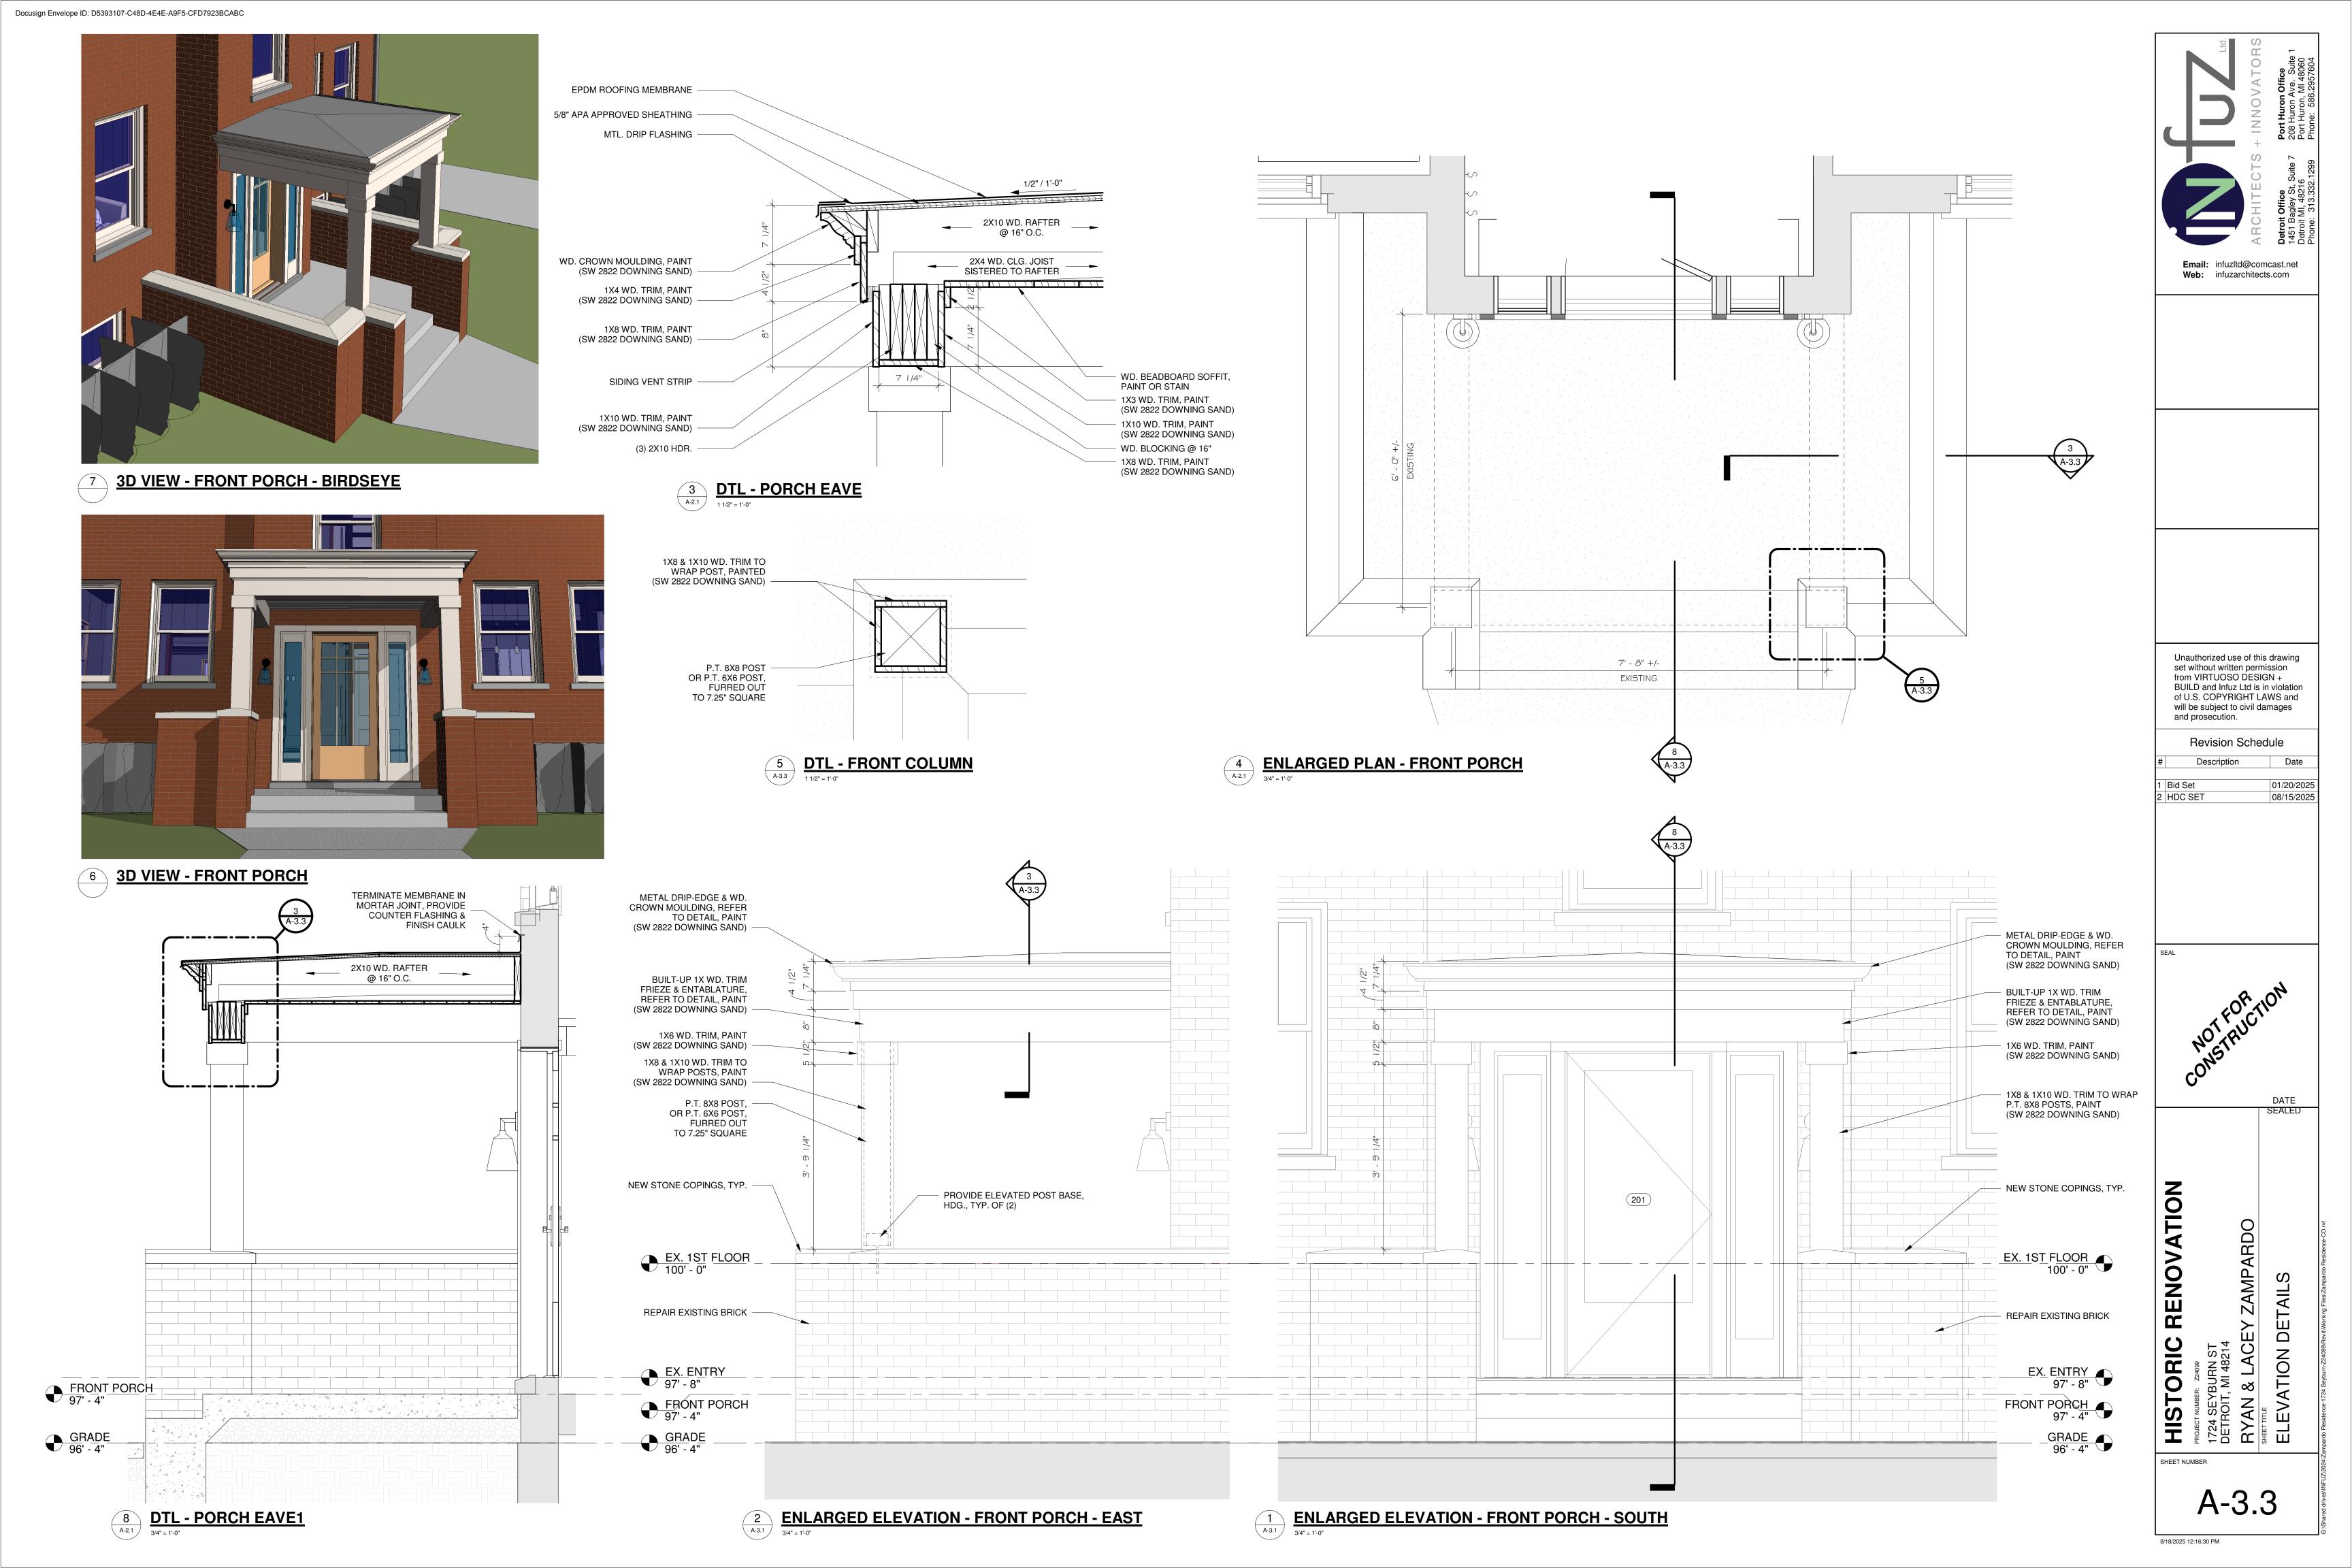

Type Mark Area Description Comments

C-1 2214 SF 1/2" GYP. BOARD ON EXISTING WOOD JOISTS

C-2 479 SF 1/2" GYP. BOARD ON NEW 2X4 CEILING FRAMING / BUILKHEAD


Grand total 2693 SF

		LIGHTING FIXTURE SCHE	EDULE
Type Mark	Count	Туре	Comments
L-1	35	4" LED CAN LIGHT	IVO 4" OR EQ. WATERPROOF FIXTURE AT EXT./WET LOCATIONS
L-2	12	VINTAGE CEILING LIGHT	OWNER PROVIDED
L-3	1	DECORATIVE CEILING LIGHT	OWNER PROVIDED
L-4	3	SMALL DROP PENDANT	OWNER PROVIDED
L-5	1	DROP PENDANT - SINK	OWNER PROVIDED
L-6	1	PENDANT - REAR STAIR	OWNER PROVIDED
L-7	3	24" STRIP LIGHT	LITHONIA MNSL L24 OR EQ.
L-8	2	48" STRIP LIGHT	LITHONIA MNSL L48 OR EQ.
L-9	5	BATHROOM SCONCE	OWNER PROVIDED
L-10	2	4" DIRECTIONAL CAN LIGHT	IVO 4" WALL WASH OR EQ.
L-11	11	UTILITY CEILING LIGHT	JUNO SLIMFORM JSF OR EQ.
L-12	2	VINTAGE CEILING LIGHT - EXT	OWNER PROVIDED
L-13	5	EXTERIOR WALL SCONCE	BROMLEY SMALL OUTDOOR WALL-MOUNT LANTERN OR EQ., MUSEUM BLACK, ON TIMER / SENSOR
L-14	2	SECURITY LIGHT	LITHONIA HGX OR EQ., DARK BRONZE, ON TIMER / SENSOR


Grand total 85


### **LIGHTING NOTE:**


- ALL FINAL FIXTURE SELECTIONS BY OWNER.
   PROVIDE DIMMER SWITCHES FOR ALL INTERIOR LIGHT FIXTURES,
- EXCEPT IN BATHROOMS.
- PROVIDE POWER TO LANDSCAPE LIGHTING.

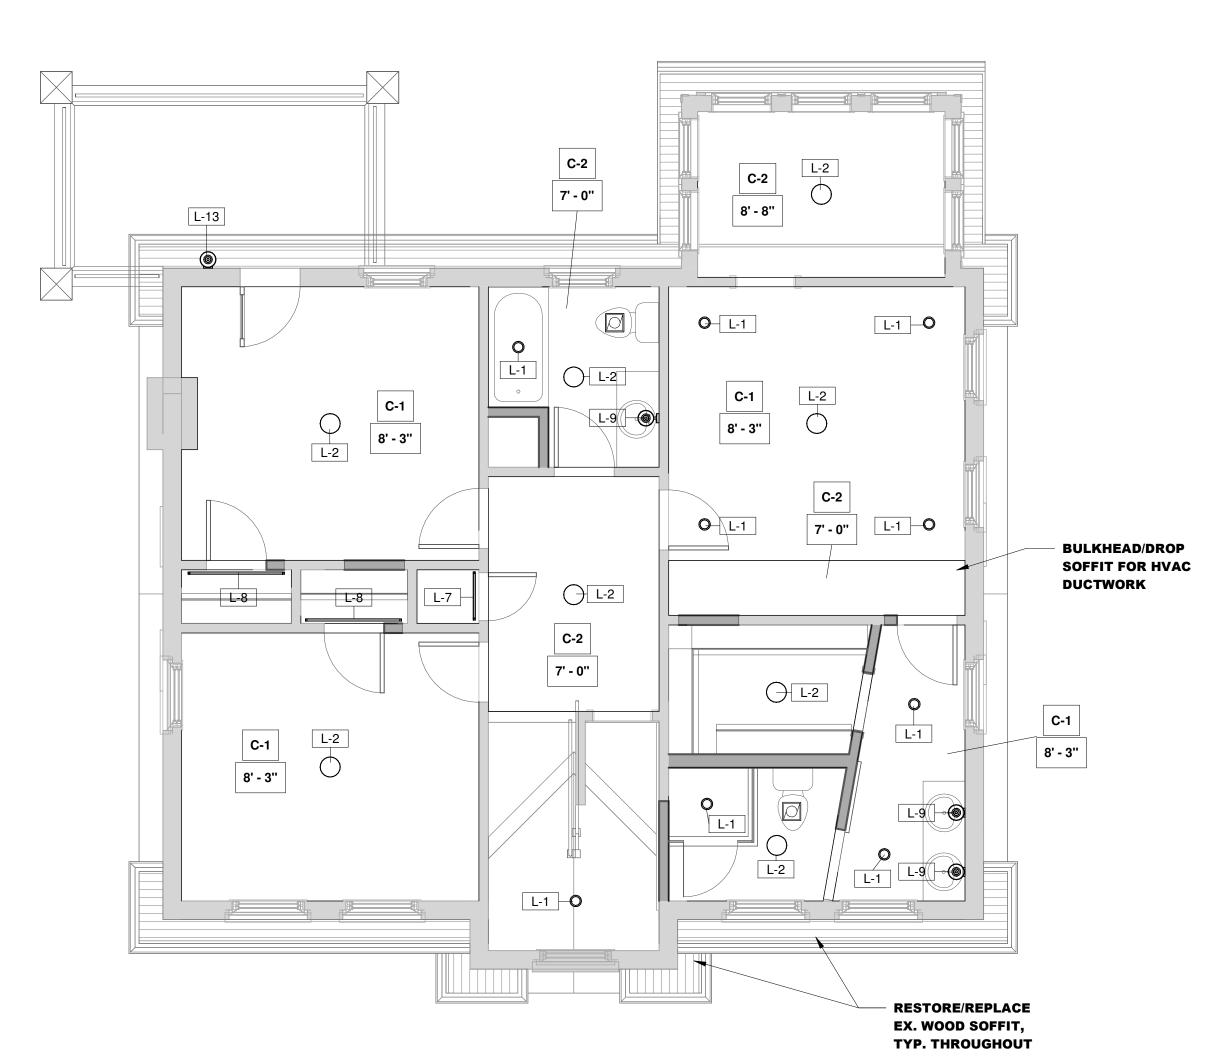


2
A-3.1
SECOND FLOOR REFLECTED CEILING PLAN
1/4" = 1'-0"

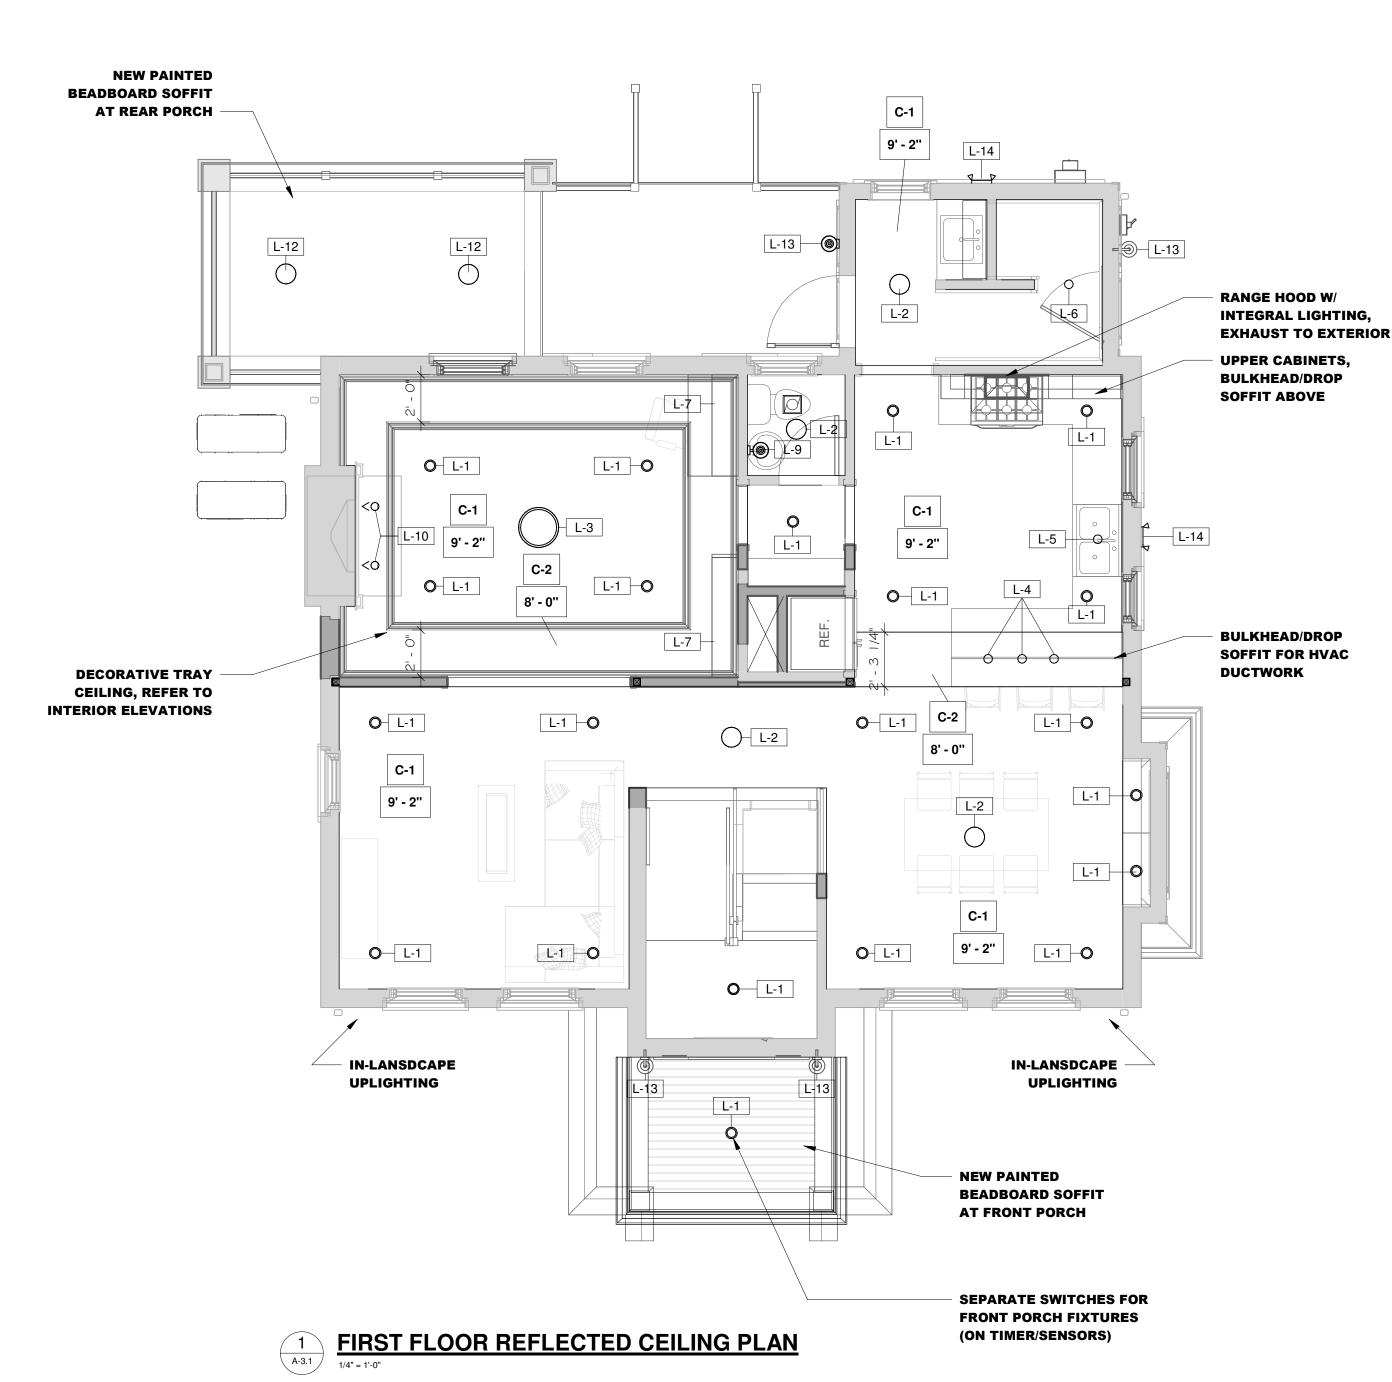

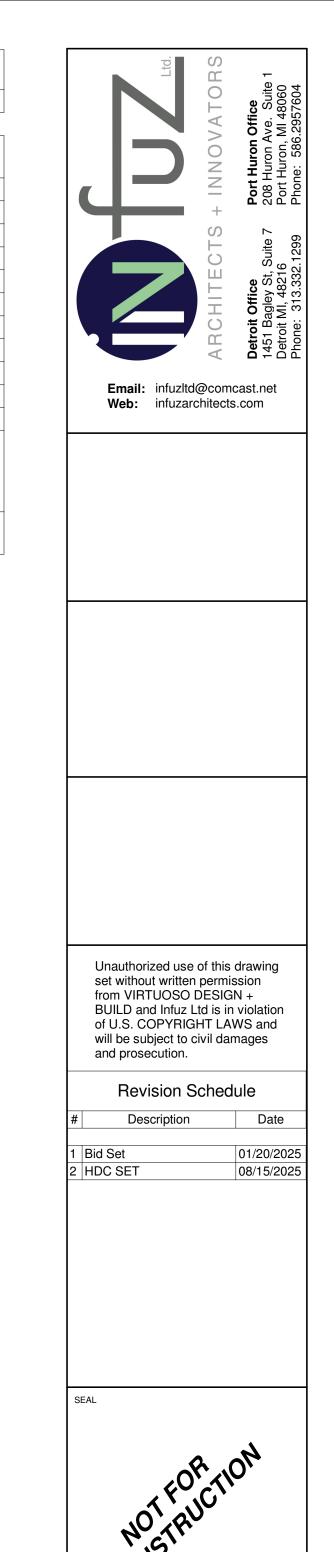

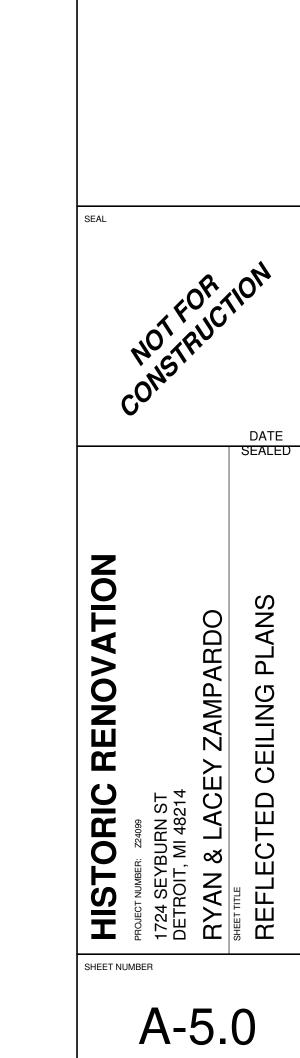


8/18/2025 12:16:32 PM

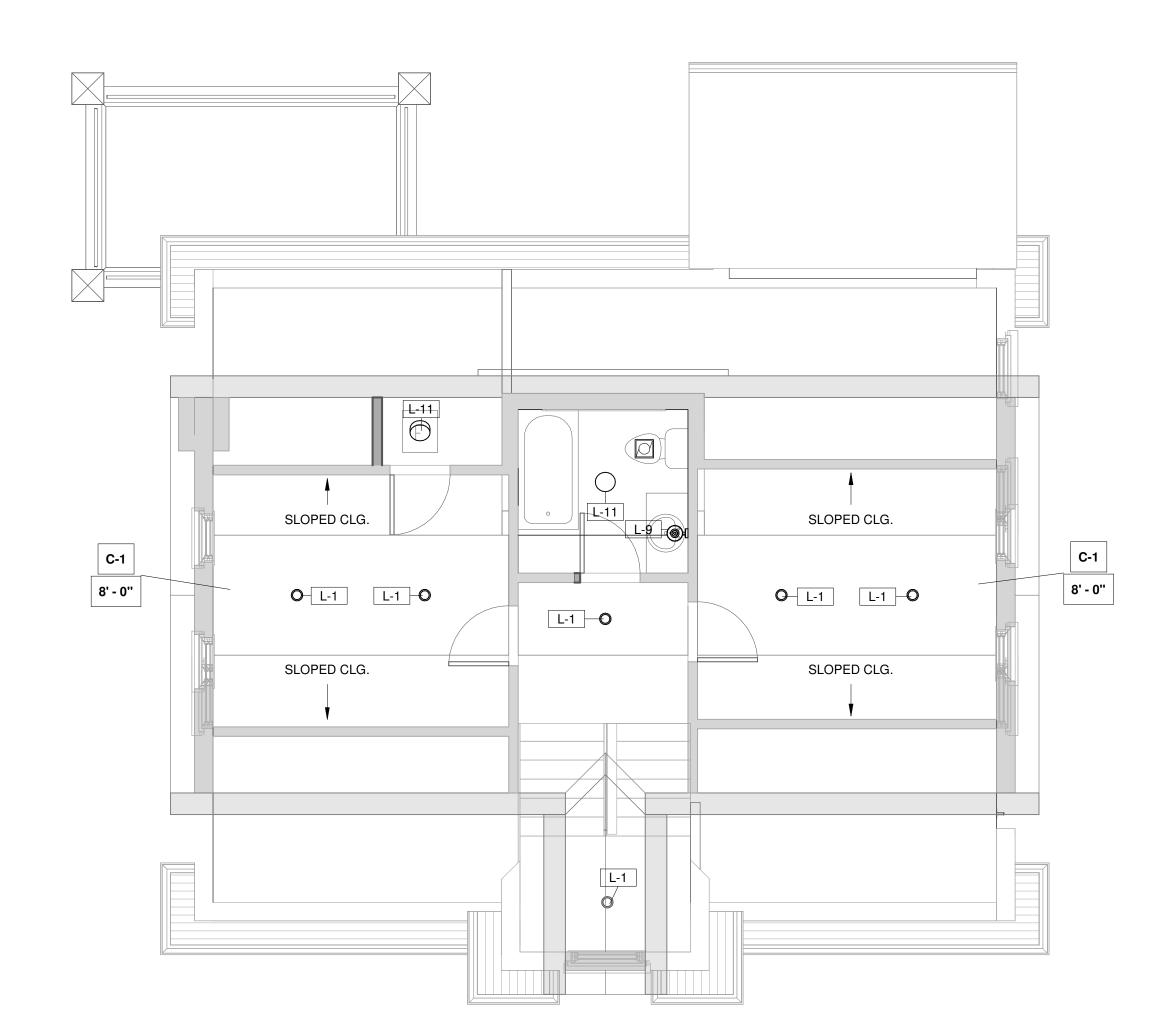

ATTIC - RCP - PROPOSED

1/4" = 1'-0"

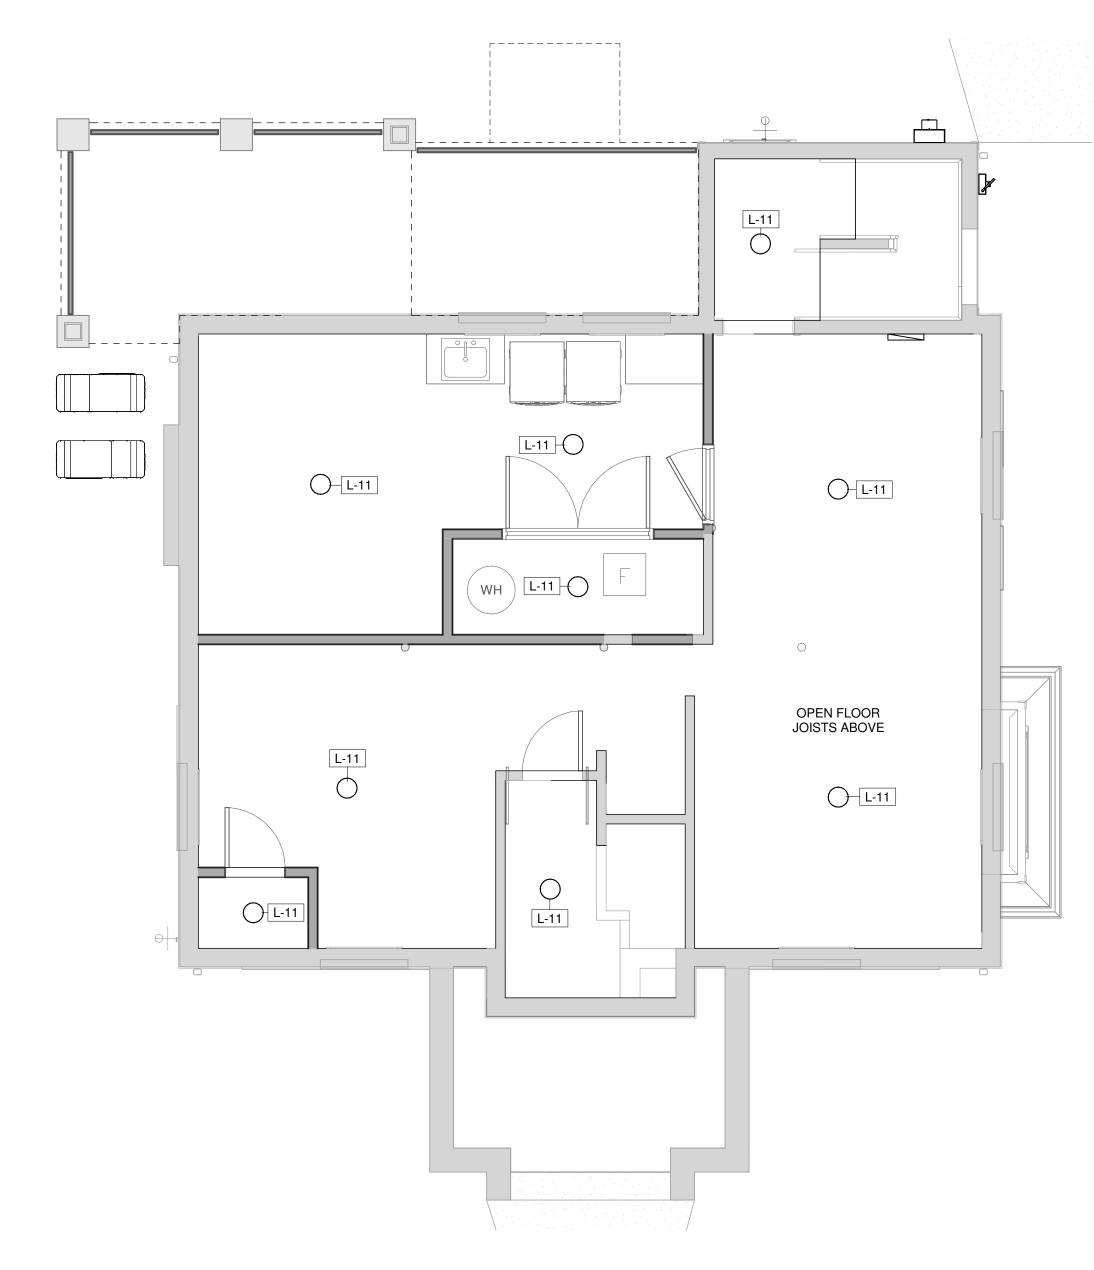



HISTORIC RENOVATION
PROJECT NUMBER: 224099
1724 SEYBURN ST
DETROIT, MI 48214
SHEFTECTED CEILING PLANS
REFLECTED CEILING PLANS

Email: infuzltd@comcast.net
Web: infuzarchitects.com

Unauthorized use of this drawing set without written permission from VIRTUOSO DESIGN +

BUILD and Infuz Ltd is in violation of U.S. COPYRIGHT LAWS and will be subject to civil damages

Revision Schedule

01/20/2025

08/15/2025

DATE SEALED

Description

and prosecution.

2 HDC SET



#### **HDC - Scope of Work**

The following describes the proposed exterior work planned for the building and site, which includes: <a href="Exterior scope:"><u>Exterior scope:</u></a> New wood windows in modified existing openings; Removal of (1) window & infill w/ new brick; New doors throughout; New front porch roof cover; new rear deck & railings at former elevated covered patio area; New exterior lighting; Replace low-slope roof areas at rear and side bay window. <a href="Site Scope:">Site Scope:</a> Repair existing sitework as needed; New site-built wood fence w/ gates, New landscaping per owner.

#### Windows

New wood windows to be installed in modified existing openings, New brick infill up to new sill height where indicated. New wood windows will be built by the General Contractor.

\* Repair/Restoration of original wood windows has been submitted under HDC2025-00443

#### **Masonry Brick**

One window on the side, first level, will be removed to allow for a beam replacement bearing in its location. This will be infilled w/ brick veneer to match the existing brick. New brick to be a blend of Interstate Bronzestone & Walnut.

\* Masonry restoration, with this selection, has been submitted under HDC2025-00443

#### Sills

There are existing stone sills at windows and masonry copings. These have been painted over time to match the siding color. These will be restored and repainted.

#### **Doors**

There are (4) exterior doors, (3) are to remain, (1) former door location becomes a window and a new door location is proposed at the rear deck. The Front door is to be a reclaimed wood door with a lite, as selected by the Owner, sourced from ASWD. This door will be restored and stained. The other doors at the side and rear are to be fiberglass doors w/ lites as indicated. These doors are to be smooth and primed for paint. The door on the side is to be ½ lite and the doors at the rear are to be full-lite

#### **Front Porch**

The existing small roof cover is to be replaced with a new larger roof cover as indicated in the drawings. This will have two posts (utilizing the extents of the existing masonry porch walls) supporting a wood framed low-slope roof. This will be trimmed out with wood trim boards and mouldings as indicated on Sheet A-3.3. There will be a beadboard soffit/ceiling with a can light.

#### **Rear Deck**

The first floor concrete slab of the rear masonry deck has failed and is to be removed. This will be replaced & enlarged with a new wood framed deck with railings and new stair as indicated on the drawings. The deck boards are to be 1x6 stained wood. The railings are wood and are to be painted. The area under the deck will have wood skirting w/ wood trim and infill. There will be a beadboard soffit/ceiling with a ceiling fan at the covered portion.



#### **Exterior Painting**

Siding/Sills: SW 2812 Rookwood Jade
Doors: SW 2816 Rookwood Dark Green

Window Sashes/Trim/Railings SW 2822 Downing Sand Metal Fabrications SW 6258 Tricorn Black Stain (Deck + Fence) SW 3560 Gray Pine

#### **Exterior Lighting**

There are exterior wall sconces proposed at exterior doors. Additionally, there are two security lights on motion sensors at the side along the driveway and rear yard. See elevations and cut-sheets

#### Roofing

The existing asphalt shingle roof is relatively new and being evaluated by the General Contractor. If it is to be replaced, it will be replaced to match the existing asphalt shingles currently installed. The roof at the rear bump out and the roof at the small bay window on the side are to receive a roof replacement. These low-slope roofs are to be replaced with EPDM, in black. \*Gutter replacement has been submitted under HDC2025-00443

#### **Site Improvements**

Repair existing sitework as indicated. Proposing a new 6 ft tall site-built cedar dog-ear wood fence w/gates. There will be additional new landscaping per owner.



### Modular Solid 4 x 21/4 x 8

Home / Face Brick / Sizes



Choose Your **Color**: **Bronzestone** 

Choose Your **Texture**: Antique





Clear

#### Choose Your Shape


Click here to talk to one of our consultants to find exactly what you're looking for.

Request a Sample	Add to Project
------------------	----------------

NOTE: Keep track of your selections by adding this Product to your Project Wishlist

Disclaimer: Images are for general color representation only – not size.


Clay brick is comprised of natural materials from the ground. As such,
each production run may vary from another and may have color
variance within itself.

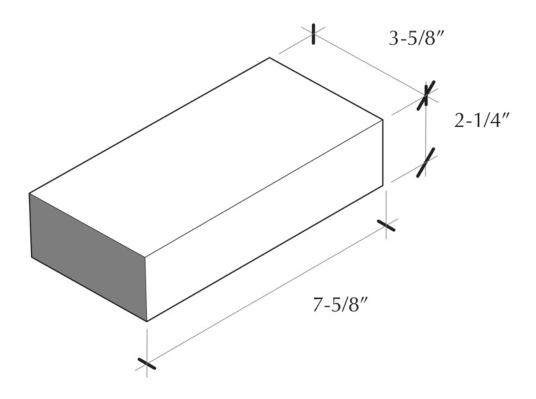

### **Synopsis**


This brick size is the industry standard. It was designed to fit to a mason's hand grip. The unit is designed to turn corners and start a wall in running bond. 3 brick courses equals one brick laid in a soldier course (stacked vertically). This brick is the easiest to use when creating patterns in the wall. There are 6.85 brick per square foot.

Specs	
Safety Data Sheet	
Other Documents	
Face Brick Dimensions, Weights, Coverage and Packaging >	

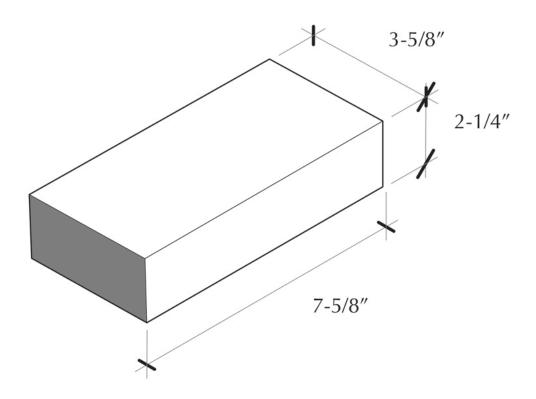

### **Face Brick Inspiration**

View More Inspiration

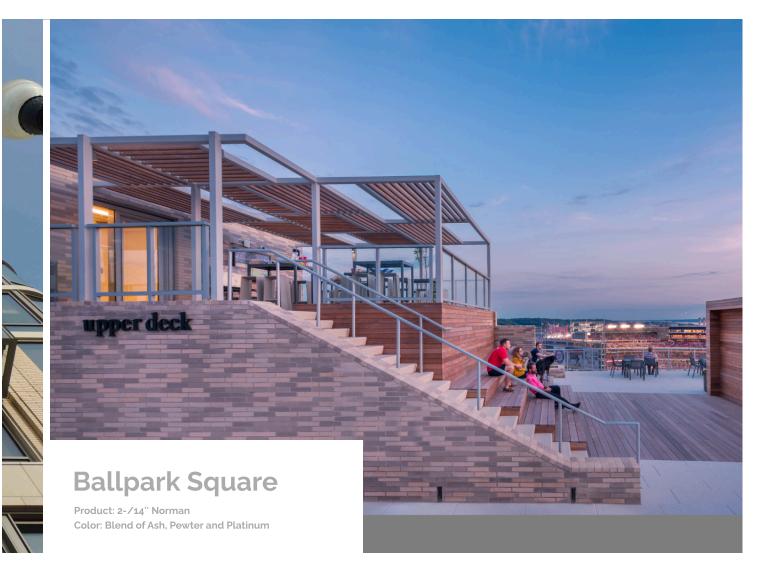

### **Additional Sizes**





Norman 4 x 2½ x 12

Utility 4 x 4 x 12



Emperor 4 x 2½ x 16

**Browse More Face Brick Sizes** 



#### **Corporate Headquarters**

(888) 614-8586 9780 South 5200 West West Jordan, UT 84081 View Map >>

© 2025 Interstate Brick | Privacy Policy | Trademarks | Terms of Use | Login Website Built by Elevate Advertising

f in





BROMLEY 2368MB
MUSEUM BLACK

WIDTH:	8.0"
HEIGHT:	11.8"
WEIGHT:	3.0 LBS
MATERIAL:	ALUMINUM
GLASS:	CLEAR
BACKPLATE WIDTH:	4.8"
BACKPLATE HEIGHT:	8.3"
SOCKET:	1-100W MED
EXTENSION:	9.3"
TTO:	7.5"
CERTIFICATION:	C-US WET RATED
VOLTAGE:	120V
UPC:	640665236811


AT HINKLEY, WE EMBRACE THE DESIGN PHILOSOPHY THAT YOU CAN MERGE TOGETHER THE LIGHTING, FURNITURE, ART, COLORS AND ACCESSORIES YOU LOVE INTO A BEAUTIFUL ENVIRONMENT THAT DEFINES YOUR OWN PERSONAL STYLE. WE HOPE YOU WILL BE INSPIRED BY OUR COMMITMENT TO KEEP YOUR 'LIFE AGLOW.'

life AGLOW®

# **Fiberglass Exterior Doors**

Full Program Offering



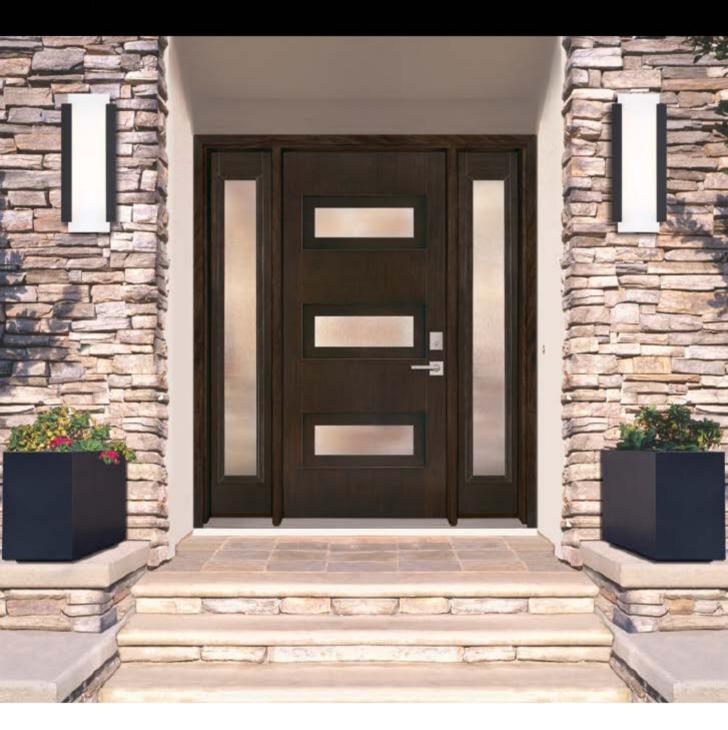

MAHOGANY WOODGRAIN TEAK WOODGRAIN OAK WOODGRAIN SMOOTH



Docusian Envelope ID: D5393107-C48D-4E4E-A9F5-CFD7923BCABC

# FIBERGLASS DOOR FINISHES

#### **TEAK WOODGRAIN**











#### **MAHOGANY WOODGRAIN**







PAINTED WHITE

Craftsman style panel profile



#### **COTTAGE MAHOGANY WOODGRAIN**












PAINTED WHITE

#### OAK WOODGRAIN

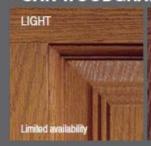









#### SMOOTH











Our finishes are hand stained or painted to enhance the details of the grain, resulting in a unique and distinctive finish.

# Docusign Envelope ID: D5393107-C48D-4E4E-A9F5-CFD7923BCABC CUSTOM PAINT OPTIONS



Add dramatic curb appeal without the mess and the hassle of having to paint yourself. It's easy with Feather River pre-painted doors. All you have to do is choose the color(s) you want

It's eas	y with Feather River pre-p	ainted doors. All you hav	e to do is choose the co	olor(s) you want.
Bright White Light 7757	Pure White 7005	Antique White 6119	Sun Fire 1141	Durable paint finish     Two-color (interior and exterioption available
Gray Grey 7075	Stormwind 7072	Sage Mist 6178	Spring Coral 6606	Touch up paint included with all special orders  PVC jamb width options, see page 6-7
Elder Tree 2809	Burnt Cranberry 2801	Wine Red	Rich Cinnamon 7591	S YEAR FINISH WALBANTY Feather River
Timeless Black 6258	Black Coffee 6006	Rich Soil 7510	Space Blue 6244	Vast Ocean 6783
		AVAILABLE STYLE	s	
TEAK	MAHOGANY	COTTAGE MAHOGANY		OAK
		SMOOTH		
e.s.			80"	
Metro* Collection			ALSO AVAII • Flush-glazed	LABLE: 1 / Impact – pages 54-58


Note: Colors shown are an approximate representation of the actual color. Actual finished color may vary in tone/shade (darker or lighter) from what is shown in brochure.

8'0" - More options page 63

6'8" - More options page 42

. Simulated Divided Lites (SDL) - pages 46-49

• PVC Transoms - page 6

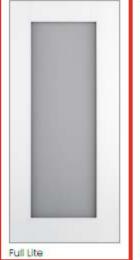







Your privacy. Your control. Instantly.

#### **Specifications**

- · 36" width / 6'8" height / Inswing only
- Smooth unfinished ready to paint
- Zinc threshold & hinges

#### **Additional Options**

- . Clear Low-E transoms
- Visit featherriverdoors.com/switch for additional information on Rough Opening, Energy Efficiency, and Warranty details.


 Simulated Divided Lite (SDL) Examples

Half Lite





Colonial

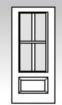

4-Lite

2-1/4"

Colonial



4-Lite

1-1/8"

Colonial



6-Lite

1-1/8"

Colonial

· Pair your door with **Full Lite** Sidelite(s)

Sidelite widths: 14, 12, 10



private glass only

works

Select additional widths: 34", 32", 30"

Horizontal

5-5/8

Brass or Patina threshold & hinges



Control using Bluetooth if Wi-Fi is unavailable. The Wi-Fi CERTIFIED™ Logo is a registered trademark of Wi-Fi Alliance®. The Bluetooth word mark and logos are registered trademarks owned by Bluetooth SIG, Inc. and any use of such marks by The Home Depot is under license. Other trademarks and trade names are those of their respective own

Amazon, Alexa and all related logos are trademarks of Amazon.com or its affiliates Google and Google Home are trademarks of Google LLC.



This device complies with Part 15 of the FCC Rules. Operation is subject to the following two conditions: (1) this device may not cause harmful interference, and (2) this device must accept any interference received, including interference that may cause undesired operation.







alexa

#### CLEAR GLASS LOW-E



Full Lite

3/4 Litte

More Clear Glass options are available in our Metro" Collection -See pages 42-43

36-10

36-12

36-14

10-36

12-36

14-36

64 🗪

'Glass is not Low-E


6-Lite External Grille\*

#### INTERNAL GRILLE (GBG) LOW-E

Half Lite

3/4 Oval



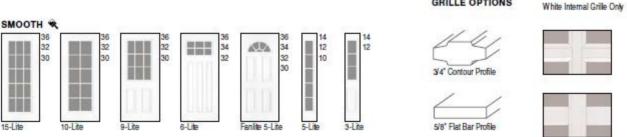



☐ Dearborn 9PM

\$ 48126 What can we help you find today?









s DIY




Cart

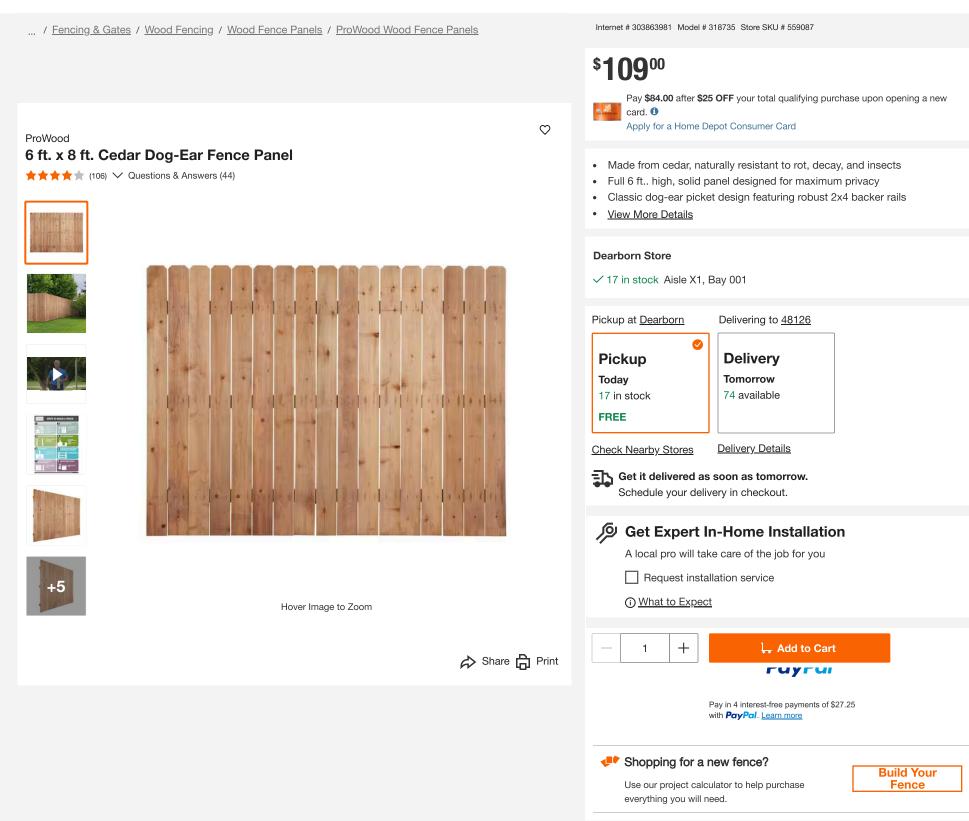



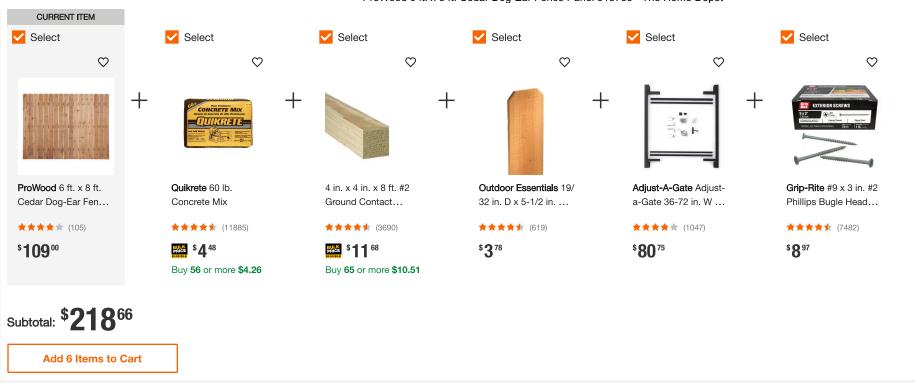

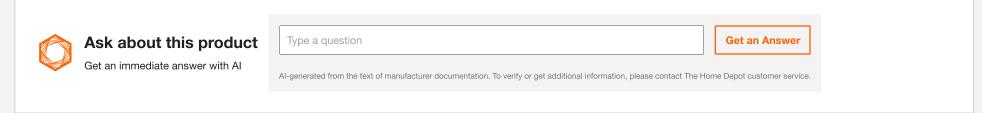

Product Details ^

#### **About This Product**

Achieve lasting privacy and a classic look with this 6 ft. x 8 ft. Cedar Dog-Ear Fence Panel. Designed with traditional dog-ear pickets, this panel offers a timeless aesthetic while providing full-height coverage for your yard. The natural cedar construction resists rot and insects, making it a durable choice for long-term outdoor use. Preassembled for convenience, it's ideal for enclosing backyards, gardens, or property lines with ease.

#### **Highlights**

- 8 ft. width covers large areas efficiently
- Strong rail construction adds stability and support
- Cedar wood weathers beautifully or can be stained
- Preassembled panel simplifies installation and saves time
- Ideal for residential fencing, pet areas, or garden enclosures
- Dog-ear pickets offer a clean, traditional look

#### **Additional Resources**

Shop All ProWood

#### From the Manufacturer

- Installation Guide
- Specification
- Instructions / Assembly
- Return Policy

- Made from the most renewable resource in the world wood! for environmentallypreferred projects
- Find everything you need to complete your fencing project here



- Return Policy
- California residents see Prop 65 WARNINGS

### **Product Information**

Internet # 303863981 Model # 318735 Store SKU # 559087

Specifications							
Dimensions							
Actual backer rail length (in.)	96 in	Actual backer rail thickness (in.)	1.5 in				
Actual backer rail width (in.)	3.5 in	Actual panel height (in.)	72 in				
Actual panel thickness (in.)	2.25 in	Actual panel width (in.)	96 in				
Actual Picket Length (in.)	72 in	Actual picket thickness (in.)	0.625 in				
Actual picket width (in.)	5.5 in	Nominal backer rail length (in.)	96.0 in				

Nominal backer rail thickness (in.)	2 in	Nominal backer rail width (in.)	4 in
Nominal panel height (ft.)	6 ft	Nominal panel width (ft.)	8 ft
Nominal picket length (ft.)	6 ft	Nominal picket thickness (in.)	1 in
Nominal picket width (in.)	6 in		

### **Details**

Color Family	Brown	Color/Finish	Cedar	
Contact Type Allowed	Above Ground	Features	Paintable, Stainable	
Fencing Installation Type	No Dig	Fencing Product Type	Wood Fence Panels	
Includes	No Additional Items Included	Material	Wood	
Nominal panel thickness (in.)	3 in	Number of pickets for panels	17	
Number of rails for panels	3	Panel Assembly	Assembled Panel	
Panel Design	Privacy	Panel Top Shape	Flat	
Picket Top Style	Dog-Eared	Product Weight (lb.)	120 lb	
Recommended Fastener	Nails	Structure Type	Ornamental, Permanent, Temporary	

## **Warranty / Certifications**

Manufacturer Warranty	See store for details
-----------------------	-----------------------

How can we improve our product information? Provide feedback.

#### **Questions & Answers**

44 Questions

**Customer Reviews** 

3.9 out of 5 **\* \* \* \* \* \*** (106)

## **Customers Also Viewed**

Best Seller



ProWood 6ft. x 8ft. Pine Pressure Treated Privacy Dog-Ear Flat Wood Fence Panel

**★★★★** (4.1 / 1269)

\$**74**98



ProWood 3-1/2 ft. x 8 ft. Western Red Cedar Privacy Flat Top Fence Panel Kit

**★★★★** (3.7 / 146)

\$**64**<sup>32</sup> /package Was \$80.40



Outdoor Essentials 6 ft. H x 8 ft. W Spruce Pine Fir Stockade Fence Panel

**★★★★** (3.8 / 462)

\$64<sup>98</sup>



Concord 5 ft. H x 3.2 ft. W Cedar Wood Slatted Panel Flat Top Privacy Fence Screen 1-Panel

**★★★★** (4.5 / 125)

\$109<sup>99</sup>



Zippity Outdoor Products Newberry Dig Free Wood Fence Kit, 48 in. by 32 in. (2-panels)

**★★★★** (4.5 / 23)

\$121<sup>67</sup>



Vigoro 37.1 in. H x 45.35 in. W Cedar Garden Fence Panel

**★★★★** (4.3 / 110)

\$**57**<sup>98</sup>

Wo \*1

Sur

Kit

Flat

**\$1** 

SW 2812 ROOKWOOD JADE

SIDING / SILLS

# SW 2816 ROOKWOOD DARK GREEN

**DOORS** 

SW 2822 **DOWNING SAND** 

WINDOW SASHES / TRIM / DECK RAILINGS

# SW 6258 TRICORN BLACK

**METAL FABRICATION** 

SW 3560 GRAY PINE

DECK SURFACE / FENCE



HGX LED 2RH ALO SWW2 120 PE DDB M2

# A complete security floodlighting solution

HGX












HGX LED 2RH ALO SWW2 120 PIR DDB M2 \*Wall mount only



HGX LED 3RH ALO SWW2 120 PE WH M2

Luminaire	Length (L)	Width (W)	Height (H)	Lamp head dia (A)	Back plate dia (B)	Back plate thickness (C)	Weight
HGX 2RH	4.41"	7.56"	4.25"	2.4"	4.25"	1.38"	1.15 lbs
	(11.2cm)	(19.2cm)	(10.8cm)	(6.1cm)	(10.8cm)	(3.5cm)	(0.52 kg)
HGX 3RH	5.12"	7.72"	4.53"	2.4"	4.53"	2.13"	1.77 lbs
	(13cm)	(19.6cm)	(11.5cm)	(6.1cm)	(11.51cm)	(5.4cm)	(0.8kg)
HGX 2SH	4.53"	7.56"	4.33"	2.40"	4.33"	1.54"	1.31 lbs
	(11.5cm)	(19.2cm)	(11cm)	(6.1cm)	(11cm)	(3.9cm)	(0.6kg)
HGX 2RH PIR	4.96"	7.52"	4.53"	2.40"	4.53"	1.89"	1.37lbs
	(12.6cm)	(19.1cm)	(11.5cm)	(6.1cm)	(11.5cm)	(4.8cm)	(0.62 kg)
HGX 2RH ALO	4.53"	7.56"	4.33"	2.40"	4.33"	1.54"	1.31lbs
	(11.51cm)	(19.2cm)	(11cm)	(6.1cm)	(11cm)	(3.9cm)	(0.6kg)

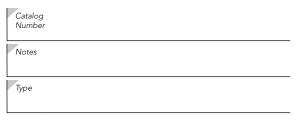



#### Introduction


The HomeGuard LED family of security flood lights, built with rugged die cast aluminum construction, are long lasting, energy efficient solutions for replacing incandescent PAR lamp fixtures. Mounted under an eave or on a wall, these luminaires provide reliable security lighting in residential and commercial applications (PIR unit is wall mount only).


The HGX family has six configurations both in bronze and white. Featuring a low cost version for switched circuits and fully featured products that include the following options: an integral photocell for that automatic dusk-to-dawn operation, adjustable lumen output, color temperature switchability, and a PIR motion sensor in a wall sconce SKU. With tool-less easy-to-aim lamps, HGX installs quickly, and delivers a lumen range from 1700 to 4100. The HGX family provide great flexibility and versatility.

HGX 2SH

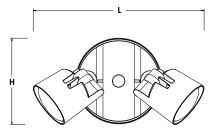

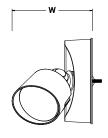


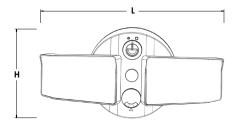


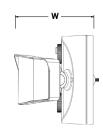



HGX 2RH & HGX 2RH ALO

COMMERCIAL OUTDOOR

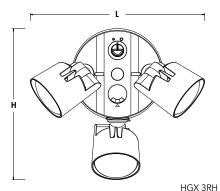

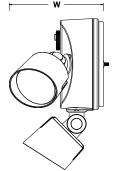

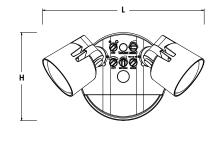

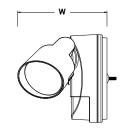

HGX 2RH PIR

**Contractor Select Spec Sheet** 

### **Ordering Information**

#### **EXAMPLE:** HGX LED 3RH ALO SWW2 120 PE DDB

Homeguard ordering nomenclature and stocked configurations								
Nomenclature	UPC	CI Code	Features					
HGX LED 2RH 40K 120 DDB	00194995254156	*271FE9						
HGX LED 2RH 40K 120 WH	00194995254170	*271FEE						
HGX LED 2RH ALO 40K 120 PE DDB	00194995254200	*271FEF						
HGX LED 2RH ALO 40K 120 PE WH	00194995254194	*271FEH						
HGX LED 2RH ALO SWW2 120 PE DDB	00194995254255	*271FEP	<b>1 1 1 1 1 1 1 1 1 1</b>					
HGX LED 2RH ALO SWW2 120 PE WH	00194995254316	*271FEV	3 OCT SWITCHASLE					
HGX LED 2SH ALO SWW2 120 PE DDB	00194995255214	*271FJ3	- Sartowale					
HGX LED 2SH ALO SWW2 120 PE WH	00194995255207	*271FJ4	SWITCHASLE					
HGX LED 3RH ALO SWW2 120 PE DDB	00194995255160	*271FHW						
HGX LED 3RH ALO SWW2 120 PE WH	00194995255139	*271FJ0	3 OCT SWITCHASLE					
HGX LED 2RH ALO SWW2 120 PIR DDB*	00194995254330	*271FEX						
HGX LED 2RH ALO SWW2 120 PIR WH*	00194995255092	*271FHR	SWITCHABLE					







Switchable CCT SWW2 (3000K/4000K/5000K)





Motion Sensor Capable


## **Photometric Diagrams**

Full photometric data report available within 2 weeks from request. Contact Acuity tech support.



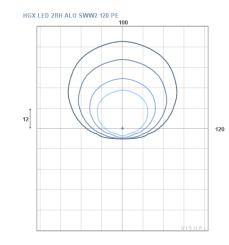

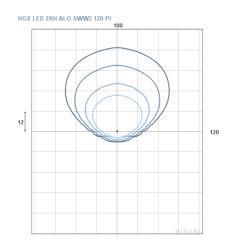

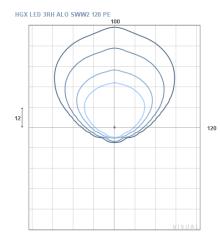

<sup>\*</sup>PIR unit is wet location rated and is to be used for wall mount applications

HomeGuard LED Stocked Configurations																		
		Low Medium		High														
Nomenclature	Lumens	Wattage	CRI	Lumens	Wattage	CRI	Lumens	Wattage	CRI	Options								
HGX LED 2RH 40K 120 DDB							2750	25	80									
HGX LED 2RH 40K 120 WH							2/50	25	80									
HGX LED 2RH ALO 40K 120 PE DDB	1750	15	80				2750	25	80	<b>*</b>								
HGX LED 2RH ALO 40K 120 PE WH	1/50	15	80	80			2/50	25	80									
HGX LED 2RH ALO SWW2 120 PE DDB	1800	15	80				2750	25	80	30cT SWITCHARLE								
HGX LED 2RH ALO SWW2 120 PE WH	1800	15	80				2/50	25	80	SWITCHABLE								
HGX LED 2SH ALO SWW2 120 PE DDB	1700	15	80				2700	25	00	30cT SWITCHARLE								
HGX LED 2SH ALO SWW2 120 PE WH	1700	15	15	15	15	15	15	15	15	15	80				2700	25	80	SWITCHABLE
HGX LED 3RH ALO SWW2 120 PE DDB	1750	15	80	2750	25	80	4100	36	80	33 cr SWITCHABLE								
HGX LED 3RH ALO SWW2 120 PE WH	1/50	50 15	15   80	80	2/50	25	00	4100	30	00	SWITCHABLE							
HGX LED 2RH ALO SWW2 120 PIR DDB	2150	21	90				2600	26	90	SATTCHARE SATTCHARE								
HGX LED 2RH ALO SWW2 120 PIR WH	2150	21	80				2000	20	80	SHITCHABLE								



Adjustable Lumen Output



Dusk-to-Dawn Operation



Switchable CCT



Motion Sensor Capable



Easy, tool-less aiming.



Integrated visors allow for visually pleasing illumination with minimal glare.



Modern design with user-friendly controls. Non-obtrusive motion sensor with elegant accent light.



Adjustable Light Output (ALO) and CCT color switching from warm, cool or daylight settings.

#### **FEATURES & SPECIFICATIONS**

#### INTENDED USE

HGX security floods are ideal for an energy efficient replacement for two lamp 200W incandescent security lights. The HGX LED provides over 50K hours of maintenance-free general illumination for outdoor applications. HGX with its 2RH/3RH/2SH head with PE options prevents daylight operation and saves on energy costs. Further with adjustable light output and color tuning technology built into HGX, it provides great flexibility for mounting and color selection. Ideal for entrances, walkways, corridors, yards, driveways and patios.

#### CONSTRUCTION

Cast-aluminum housing with dark bronze or white polyester powder paint for lasting durability. Photocell sensitivity is adjustable. LED lamp heads are thermally isolated from the driver that is located in the rear housing, promoting a long service life. Lenses are sealed to prolong service life. LEDs maintain 70% of light output at 50,000 hours of service life.

#### ELECTRICAL

HGX family comes in six configurations from low cost version which is on switched circuit to a fully featured product which has adjustable lumens, photocell, color and motion. The HGX is rated for outdoor installations. The 2 RH versions consume 25W and 3RH version consumes 36W power, 120V input 60 HZ driver. LED's with min. 80 CRI provide great quality of light and rendering. HGX with PIR option (motion sensor) has up to 180 degree motion detection angle, range of up to 40' at 18C/65 F and has three modes - test, 1 or five minutes on time after motion is detected. Motion sensitivity and daylight sensing is adjustable. Wall Sconce PIR unit is recommended for wall mount only.

#### ADJUSTABLE FEATURES

Adjustable light output - select HGX products include adjustable lumen output -2 settings on 2 head versions & 3 settings on 3 RH version. The lumens can be adjusted by rotation of dial. Use the same product to mount on various mounting heights by increasing or decreasing the light output. Color Tuning - Color temperature of the lamp heads can be switched with rotation of dial from warm to cool to daylight. Adjustable photocell - the sensitivity of the PE can be adjusted. The dial can be turned off to make the light turn on during day time, or have it only as dusk-to-dawn operation.

#### INSTALLATION

Mounts to a recessed junction box on wall or ceiling. Crossbar and hardware provided. Wet location listed for mounting 4 feet above ground. Tool-less adjustable heads allow for precise aiming.

#### LISTINGS

UL/cUL listed Listed to U.S. and Canadian safety standards for wet locations. Tested in accordance with IESNA LM-79 and LM-80 standards. All units are IP65 except HGX PIR which is wet location. HGX is rated for use in ambient conditions ranging from -40° C to 40° C.

#### WARRANTY

Five-year limited warranty. This is the only warranty provided and no other statements in this specification sheet create any warranty of any kind. All other express and implied warranties are disclaimed. Complete warranty terms located at:

www.acuitybrands.com/support/warranty/terms-and-conditions

**Note:** Actual performance may differ as a result of end-user environment and application. All values are design or typical values, measured under laboratory conditions at 25 °C. Specifications subject to change without notice.



Docusign Envelope ID: D5393107-C48D-4E4E-A9F5-CFD7923BCABC

## 36x84 Solid Door With Beveled Glass









RH Swing, includes letter slot, one pane is cracked

Price: \$100.00

Amount on hand: 1.00

Buy now (pickup)


If you'd like a quote to ship the item to you, please call us at 313-300-0046

Barcode: 505532784907





# **PUBLIC ALLEY**

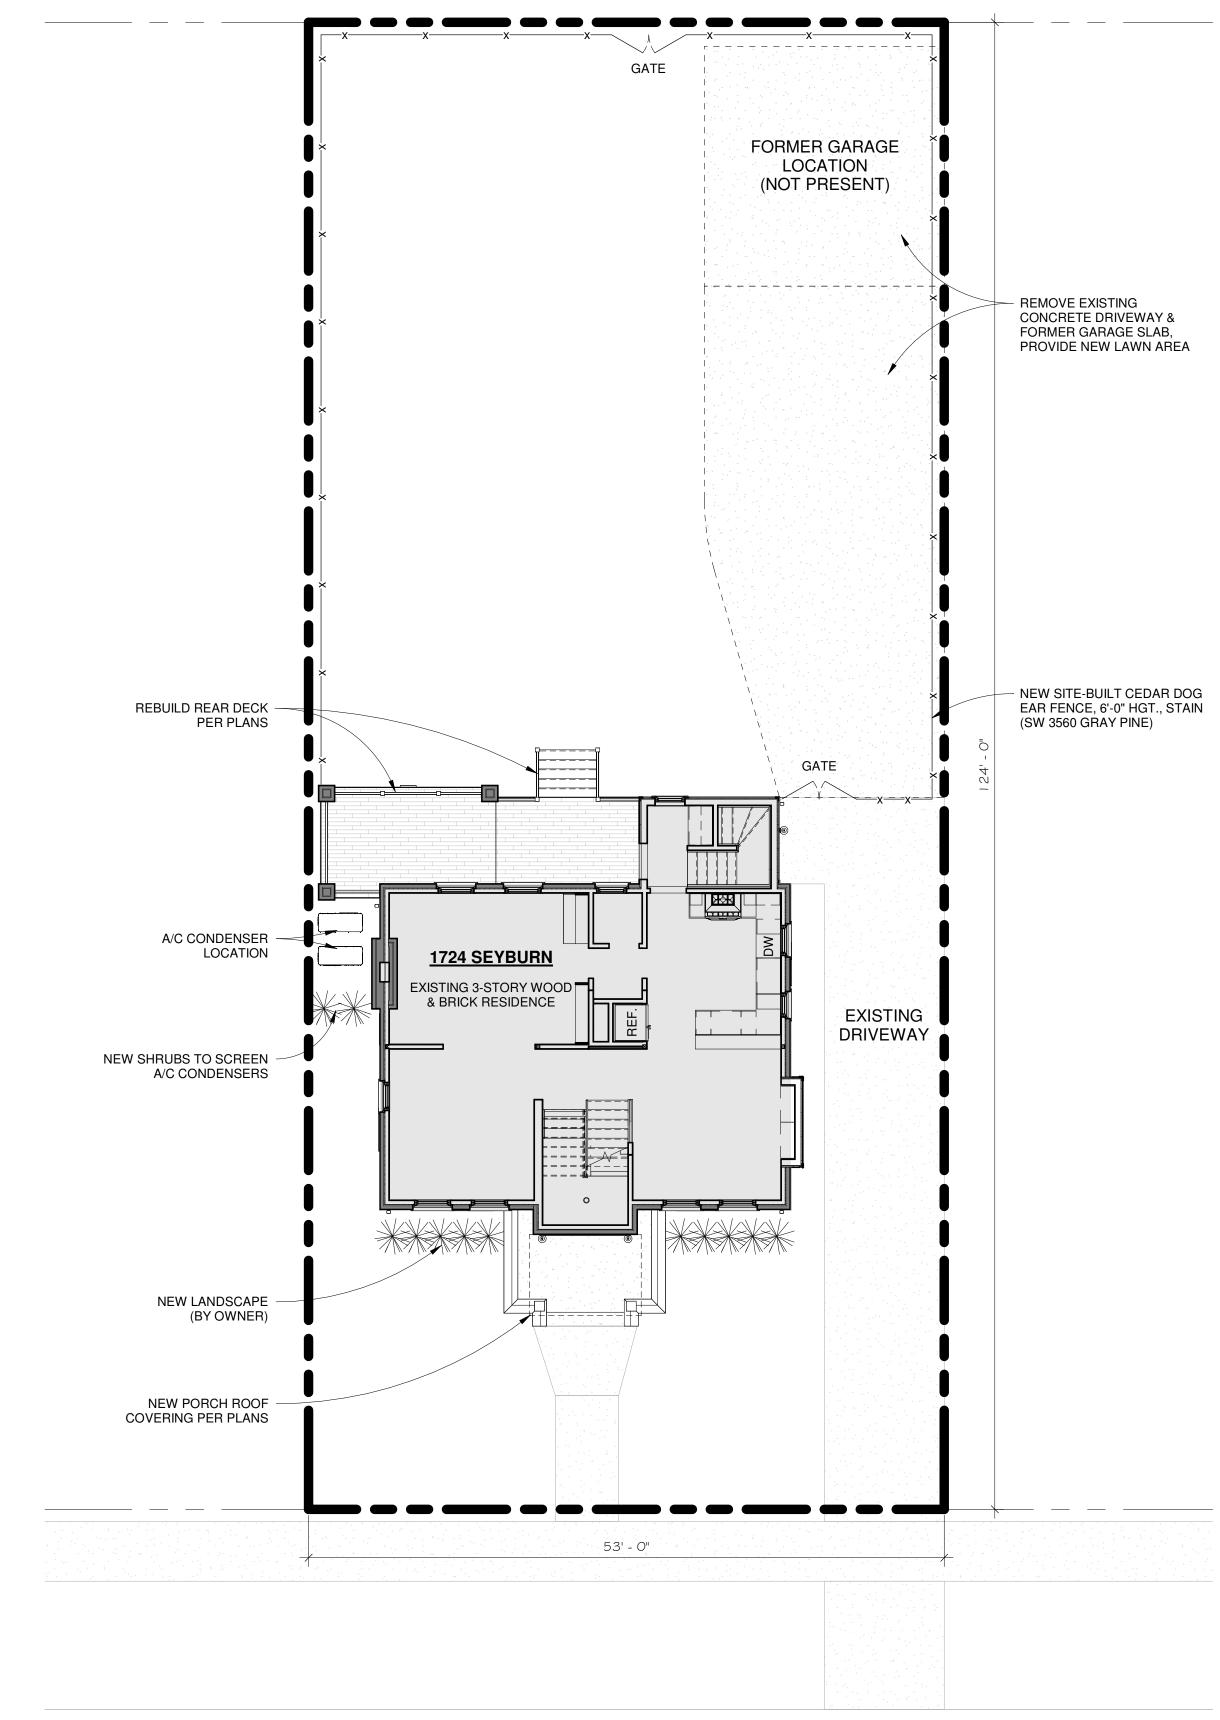

## **SEYBURN ST**

ARCHITECTURAL SITE PLAN FOR REFERENCE ONLY. ALL INFO PROVIDED BY OWNER AND PUBLICLY PROVIDED INFO. ALL LANDSCAPE SELECTIONS BY OWNER/CONTRACTOR.







ZAMPARDO

TORIC

SHEET NUMBER

8/18/2025 12:48:59 PM

SIT

Email: infuzltd@comcast.net Web: infuzarchitects.com

Unauthorized use of this drawing set without written permission

of U.S. COPYRIGHT LAWS and

will be subject to civil damages

Revision Schedule

01/20/2025

08/15/2025

DATE

SEALED

Description

and prosecution.

2 HDC SET

from VIRTUOSO DESIGN + BUILD and Infuz Ltd is in violation

**GENERAL SITE NOTES:** THE DRAWINGS HEREIN ARE FOR INFORMATIONAL PURPOSES AND CONVEYANCE OF DESIGN INTENT. INFORMATION DEPICTED IS NOT INTENDED TO BE CONSTRUED AS LEGAL SURVEY OR ENGINEERED CIVIL. REFER TO SUBMITTALS BY PROFESSIONAL CONSULTANTS FOR WORK BEYOND THE SCOPE DEPICTED HEREIN. GENERAL CONTRACTOR TO VERIFY ALL EXISTING ELEVATIONS AND BUILDING

CONDITIONS IN FIELD PRIOR TO START OF CONSTRUCTION. THE CONTRACTOR SHALL HAVE A REGISTERED LAND SURVEYOR TIE OUT AND RESET ANY PROPERTY CORNERS OR SECTION CORNERS PLANNED TO BE DISTURBED BY CONSTRUCTION OF THIS PROJECT, AND SHALL HAVE A REGISTERED LAND SURVEYOR RE-ESTABLISH ANY PROPERTY CORNERS OR SECTION CORNERS INADVERTENTLY DISTURBED DURING CONSTRUCTION OF THIS PROJECT.

ALL STREET, SANITARY SEWER, STORM SEWER AND WATERLINE CONSTRUCTION SHALL CONFORM TO THE LOCAL MUNICIPALITY STANDARDS AND SPECIFICATIONS CURRENT AT THE DATE OF EXECUTION OF THE CONSTRUCTION. THE CONTRACTOR SHALL BE RESPONSIBLE FOR CONTACTING MISSDIG. CALL TWO

BUSINESS DAYS PRIOR (NOT INCLUDING THE DAY OF THE CALL) TO DIGGING, GRADING OR EXCAVATING FOR THE MARKING OF UNDERGROUND MEMBER UTILITIES. MAINTENANCE OF ONSITE DRAINAGE TO MINIMIZE ANY RUNOFF / EROSION DURING CONSTRUCTION SHALL BE THE RESPONSIBILITY OF THE CONTRACTOR. PRIOR TO COMMENCEMENT OF ANY CONSTRUCTION, THE CONTRACTOR SHALL

CONTACT ALL UTILITIES TO COORDINATE SERVICE AND SCHEDULES. THE CONTRACTOR SHALL RESTORE ANY DISTURBED AREAS TO EQUAL OR BETTER CONDITION THAN EXISTED BEFORE CONSTRUCTION. THE CONTRACTOR SHALL IMMEDIATELY REMOVE ANY CONSTRUCTION DEBRIS AND

MUD TRACKED ONTO EXISTING ROADWAYS. THE CONTRACTOR SHALL REPAIR ANY EXCAVATION OR PAVEMENT FAILURES CAUSED BY THE CONSTRUCTION. ALL DAMAGED EXISTING CURB, GUTTER, AND SIDEWALK SHALL BE REPAIRED PRIOR TO

ACCEPTANCE OF COMPLETED IMPROVEMENTS. THE TYPE, SIZE, LOCATION AND NUMBER OF ALL KNOWN UNDERGROUND UTILITIES ARE APPROXIMATE WHEN SHOWN ON THESE CONSTRUCTION DRAWINGS. IT SHALL BE THE RESPONSIBILITY OF THE CONTRACTOR TO VERIFY THE EXISTENCE AND LOCATION OF ALL UNDERGROUND UTILITIES ALONG THE ROUTE OF THE WORK PRIOR TO COMMENCING ANY NEW CONSTRUCTION. THE CONTRACTOR SHALL BE RESPONSIBLE OF ANY UNKNOWN UNDERGROUND UTILITIES.

THE CONTRACTOR SHALL NOTIFY THE PUBLIC WORKS DEPARTMENT AT LEAST 48 HOURS PRIOR TO INSTALLING A NEW SEWER, WATER SERVICE OR ABANDONING AN EXISTING WATER SERVICE.

THE CONTRACTOR SHALL PERFORM ALL WORK ACCORDING TO ALL LOCAL, COUNTY, STATE AND FEDERAL SAFETY AND HEALTH REGULATIONS. IN PARTICULAR, THE TRENCHING AND OPEN EXCAVATION OPERATIONS SHALL COMPLY WITH ALL CURRENT

O.S.H.A. REGULATORY REQUIREMENTS. REFER TO ELECTRICAL DRAWINGS FOR SITE RELATED ELECTRICAL SCOPE.

## **ZONING REQUIREMENTS**

CITY OF DETROIT LOCAL AUTHORITY:

LOCAL ORDINANCE: DETROIT ZONING ORDINANCE (REVISION 31 JULY 2018)

**ZONING CLASSIFICATION:** R-2 RESIDENTIAL

**USE CLASSIFICATION:** SINGLE FAMILY DWELLING (SEC. 50-11-236 - SEC. 50-11-239)

REQUIRED SETBACKS: (SECT. 50-11-245) EXISTING TO REMAIN (NO CHANGE)

MINIMUM LOT SIZE: (SECT. 50-13-45) EXISTING TO REMAIN (NO CHANGE)

MAXIMUM HEIGHT:

EXISTING TO REMAIN (NO CHANGE)

(SECTS. 50-13-236 & 50-13-237) LOT COVERAGE:

EXISTING TO REMAIN (NO CHANGE)

1 SPACE PER DWELLING REQUIRED PARKING:

TOTAL PARKING PROVIDED: 1 SPACES PROVIDED ON SITE