
# 3261 SHERBOURNE RD., DETROIT, MI

SHERBOURNE ROAD

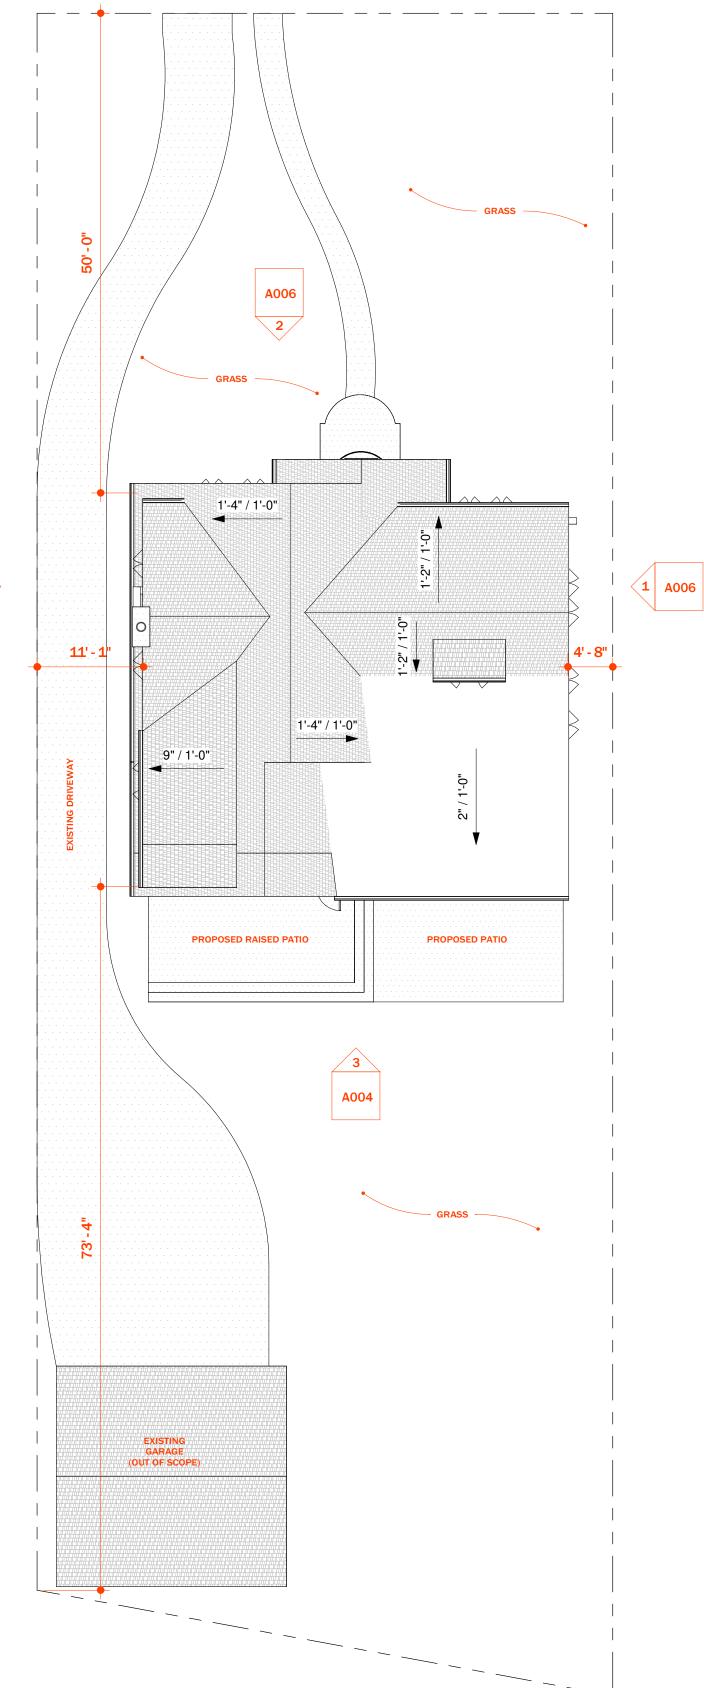

	ABE	BREVIATIONS
4		
4	ALT	ALTERNATE
1	ALUM	ALUMINUM
١	APPROX	APPROXIMATE
\	AVG	AVERAGE
3		
3	B.O.	BOTTOM OF
3	BDRM	BEDROOM
3	BLKG	BLOCKING BOTTOM
) }	BOT BRDG	BRIDGE, BRIDGING
) }	BRG	BEARING
) }	BRKT	BRACKET
3	BSMT	BASEMENT
3	BTW	BETWEEN
, )	DIW	BLIWELK
· }	CEM	CEMENT
- )	CL	CENTER LINE
)	CLG	CEILING
;	CMU	CONCRETE MASONRY UNIT
	CNTR	CENTER
	COL	COLUMN
)	CONC	CONCRETE
	CONT	CONTINUOUS
	CRPT	CARPET
	CSMT	CASEMENT
	СТ	CERAMIC TILE
)		
)	DBL	DOUBLE
)	DEMO	DEMOLISH, DEMOLITION
)	DH	DOUBLE HUNG
)	DN	DOWN
)	DWL	DOWEL
	EIFS	EXTERIOR INSULATION & FINISH SYSTEM
	EJ	EXPANSION JOINT
	ELEC	ELECTRICAL
<u> </u>	EQ	EQUAL
	EQUIP	EQUIPMENT
:	EXIST	EXISTING
•	FDTN	FOUNDATION
:	FF	FINISHED FLOOR
- -	FIXT	FIXTURE
	FLEX	FLEXIBLE
•	FLG	FLOORING
•	FTG	FOOTING
•	FURN	FURNISH, FURNITURE
- 3	FURIN	I GRIVIOR, FURINITORE
я Э	GFCI	GROUND FAULT CIRCUIT INTERRUPTED
я Э	GLAZ	GLAZING
а Э	GYP	GYPSUM BOARD

	AB	BREVIATIONS
Н		
Н	HDR	HEADER
Н	HDWD	HARDWOOD
Н	HGT	HEIGHT
Н	HVAC	HEATING, VENTILATING & AIR CONDITIONIN
I		
I	INSUL	INSULATION
J		
J	JST	JOIST
L		
L	LAM	LAMINATE, LAMINATED
M		
M	MECH	MECHANICAL
M	MEMB	MEMBRANE
M	MFG	MANUFACTURER
M	MIN	MINIMUM
M	MISC	MISCELLANEOUS
N		
N	NAT	NATURAL
N	NOM	NOMINAL
0		
0	O.C.	ON CENTER
P		
P	PERF	PERFORATED
P -	PERP	PERPENDICULAR
P	PLYWD	PLYWOOD
P	PREFAB	PREFABRICATED
P	PREFIN	PREFINISHED
P	PVMT	PAVEMENT
P	PWR	POWER
R R		DICED
•	R	RISER
R S	REQD	REQUIRED
s S	SF	SOUADE FOOT/EEET
s S	SPEC	SQUARE FOOT/FEET SPECIFICATION(S)
<u>з</u> Т	SFEC	or contonion(o)
<u>'</u> T	T.O.	TOP OF
<u>'</u> Т	THRU	THROUGH
<u>'</u> T	TRD	TREAD
<u>'</u> T	TYP	TYPICAL
U		· · · · · · · · · · · · · · · · · · ·
U	UNEXC	UNEXCAVATED
U	UNFIN	UNFINISHED
U	UNO	UNLESS NOTED OTHERWISE
V		,
V	VCT	VINYL COMPOSITION TILE
V	VIF	VERIFY IN FIELD
W		ı
W	W/	WITH
W	W/O	WITHOUT

# **PROJECT INFO:**

#### PROSPECTIVE OWNER:

**ROBIN GLASCO PROJECT ADDRESS:** 

3261 SHERBOURNE RD.

#### DETROIT, MI 48221 **DESIGNER:**

**VANGUARD DESIGN GROUP 25120 CULVER ST.** 

ST. CLAIR SHORES, MI 48081

**SCOPE OF WORK:** 

RESTORATION OF HISTORIC EXTERIOR AND CONSTRUCTION OF AN APPROX. 842 SQ. FT. REAR 2 STORY ADDITION. ADDITION TO INCLUDE EXPANDED KITCHEN AND LIVING

#### LEGAL DESCRIPTION:

PLATS, W C R 2/148 60x171.10A **BUILDING SUMMARY:** 

FIRST FLOOR:	1,553 SQ. F
SECOND FLOOR:	1,428 SQ. I
THIRD FLOOR:	493 SQ. F
BASEMENT:	1,338 SQ. F
TOTAL EXISTING GROSS BUILDING AREA	4,812 SQ. I

NOI GOLD GROSS DOILDING ARLAS	
FIRST FLOOR:	1,836 SQ. FT.
SECOND FLOOR:	1,826 SQ. FT.
THIRD FLOOR:	493 SQ. FT.
BASEMENT:	1,338 SQ. FT.
TOTAL PROPOSED GROSS BUILDING	AREA 5.493 SO. FT.

## **ZONING REQUIREMENTS:**

#### LOCAL AUTHORITY:

#### LOCAL ORDINANCE:

DETROIT ZONING ORDINANCE

#### **ZONING CLASSIFICATION:**

R-1 RESIDENTIAL

#### **USE CLASSIFICATION:**

SINGLE FAMILY DWELLING / BY RIGHT (§ 50-8-14)

## REQUIRED SETBACKS:

	REQUIRED SETBACK	ACTUAL EXISTING SETBACK	ACTUAL PROPOSED SETBA
FRONT:	20 FT.	50 FT.	NO CHANGE
SIDES:	4 FT. MIN.	4.7 FT.	NO CHANGE
	14 FT. COMBINED	17.8 FT.	NO CHANGE
REAR:	30 FT.	73 FT.	NO CHANGE

### MINIMUM LOT SIZE:

AREA:	5000 SQ. FT.	ACTUAL AREA:	10520 SQ. FT.
WIDTH:	50 FT.	<b>ACTUAL WIDTH:</b>	62 FT.

### **MAXIMUM HEIGHT:**

HEIGHT:	35 FT.	ACTUAL HEIGHT:	33.6 FT.

LOT COVERAGE: MAX PERCENTAGE ALLOWED: 35%

ACTUAL PERCENTAGE: 24.1%

# **REQUIREMENTS:**

#### **GOVERNING CODE:**

**USE AND OCCUPANCY:** 


## **VICINITY MAP:**

BUILDING ELEVATION 🚡 4 A101 2

STAIRS 20 R @ ±7 1/2"

SCALE: 1/4" = 1'-0"

**ANNOTATIONS LEGEND** 

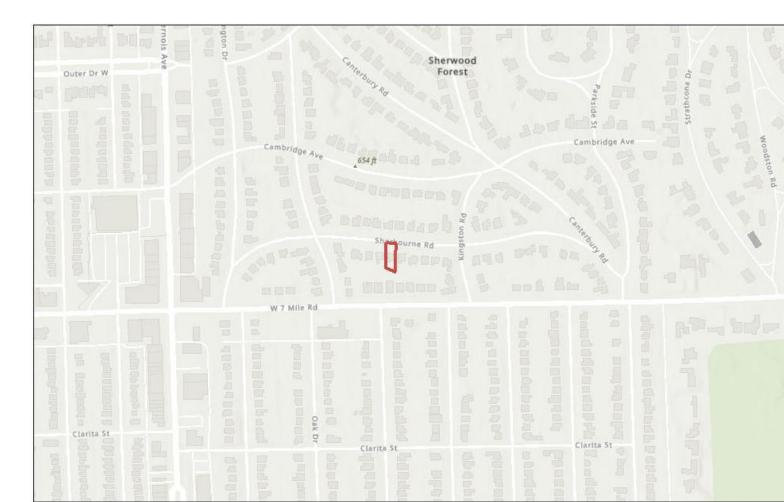




**GLASCO RESIDENCE** 


04/17/25

DRAWING INDEX SHEET NAME			
A001	EXISTING PLANS		
A002	EXISTING PLANS		
A003	PROPOSED PLANS AND KITCHEN ELEVATIONS		
A004	PROPOSED PLANS AND SOUTH ELEVATION		
A005	CEILING PLANS & WEST ELEVATION		

**EAST AND NORTH ELEVATIONS** 

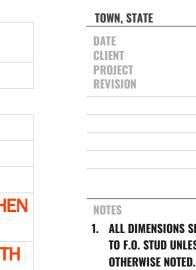

1. ALL DIMENSIONS SHOWN ARE TO F.O. STUD UNLESS OTHERWISE NOTED. 2 THIS IS NOT A SEALED ARCHITECTURAL DRAWING

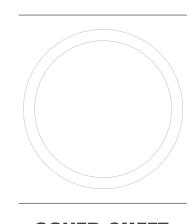


**COVER SHEET** 




SITE PLAN

1/4" = 1'-0"

**PLANS** 

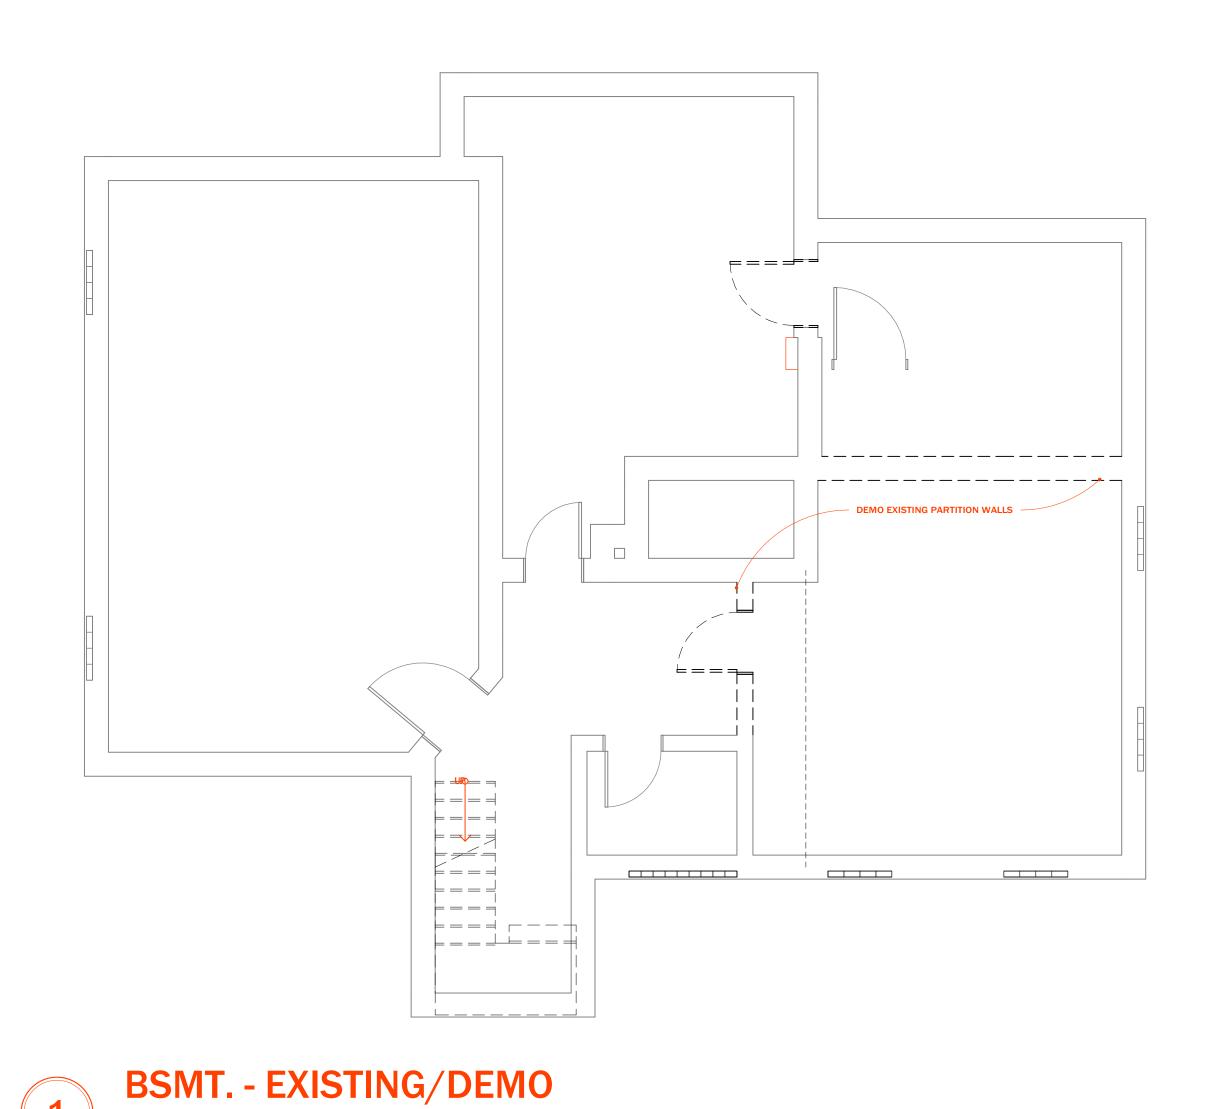

SCALE: 1/4" = 1'-0"

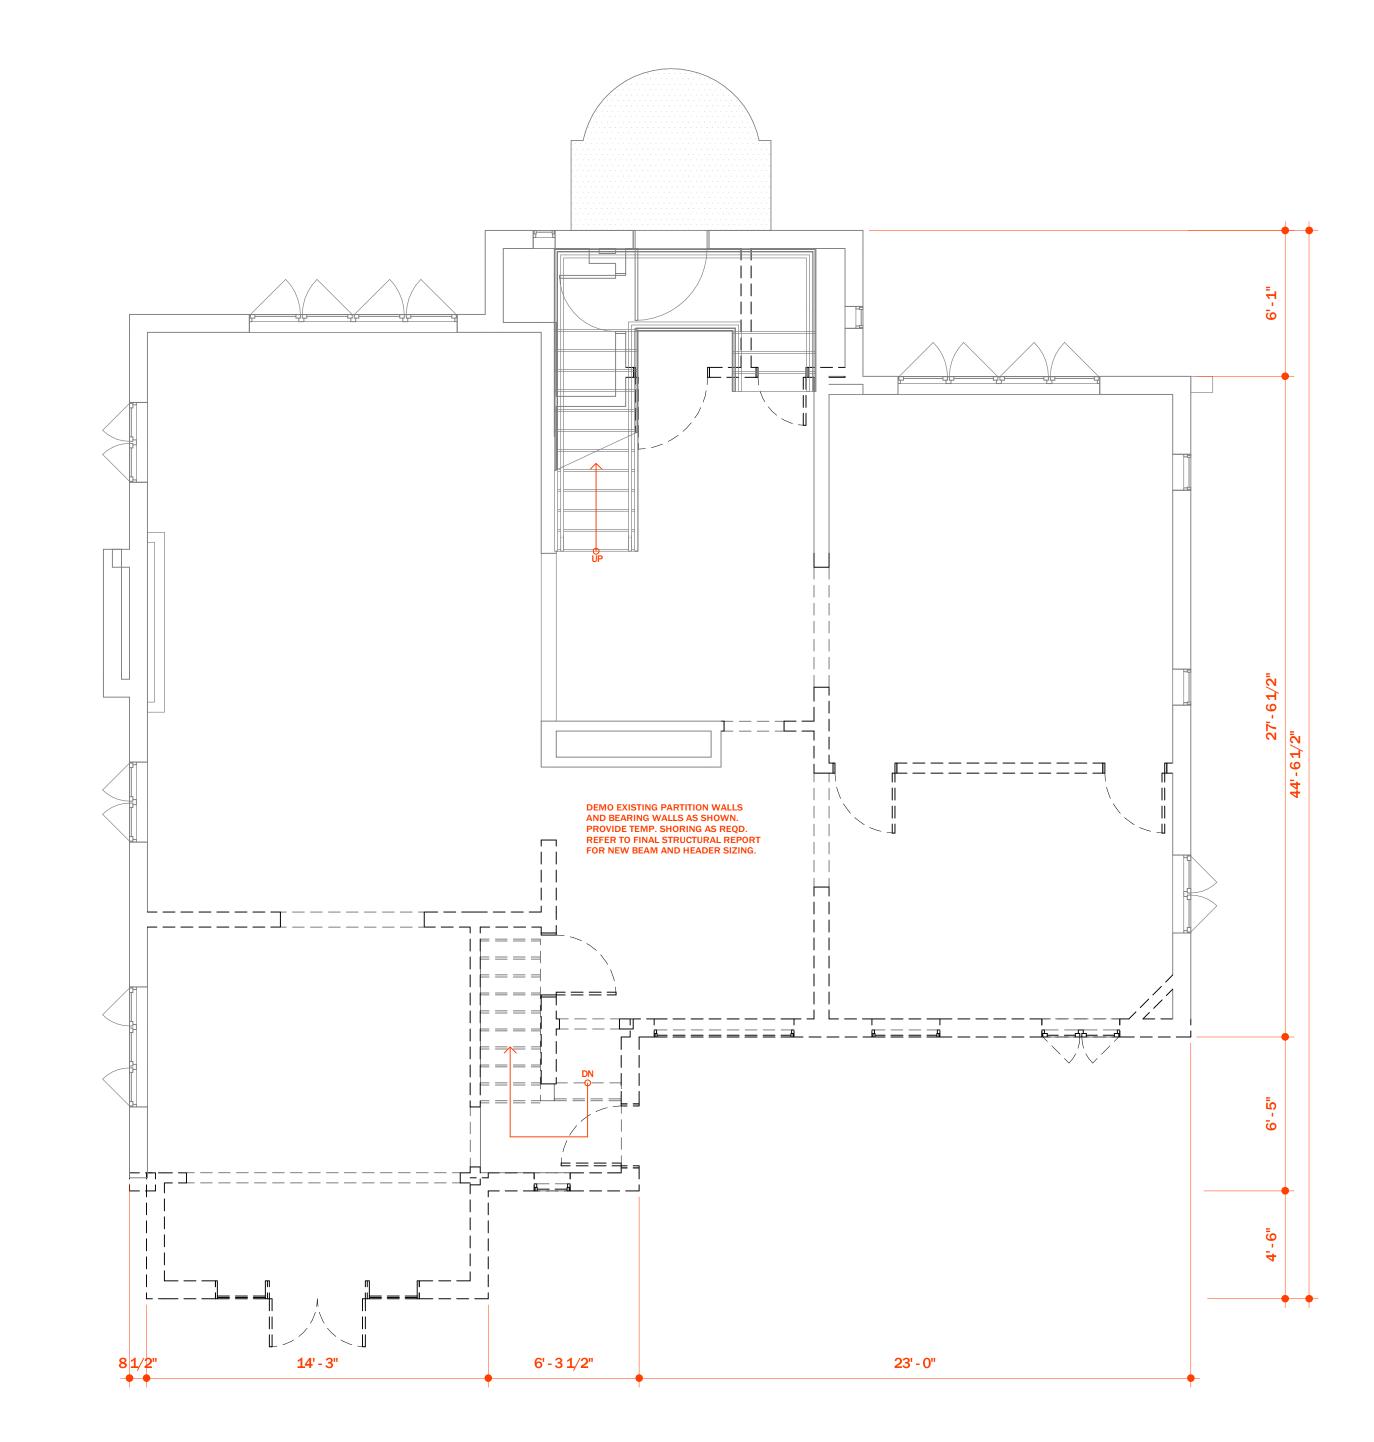



LEVEL 1 FF - EXISTING/DEMO

SCALE: 1/4" = 1'-0"

**EXISTING** 

**PLANS** 

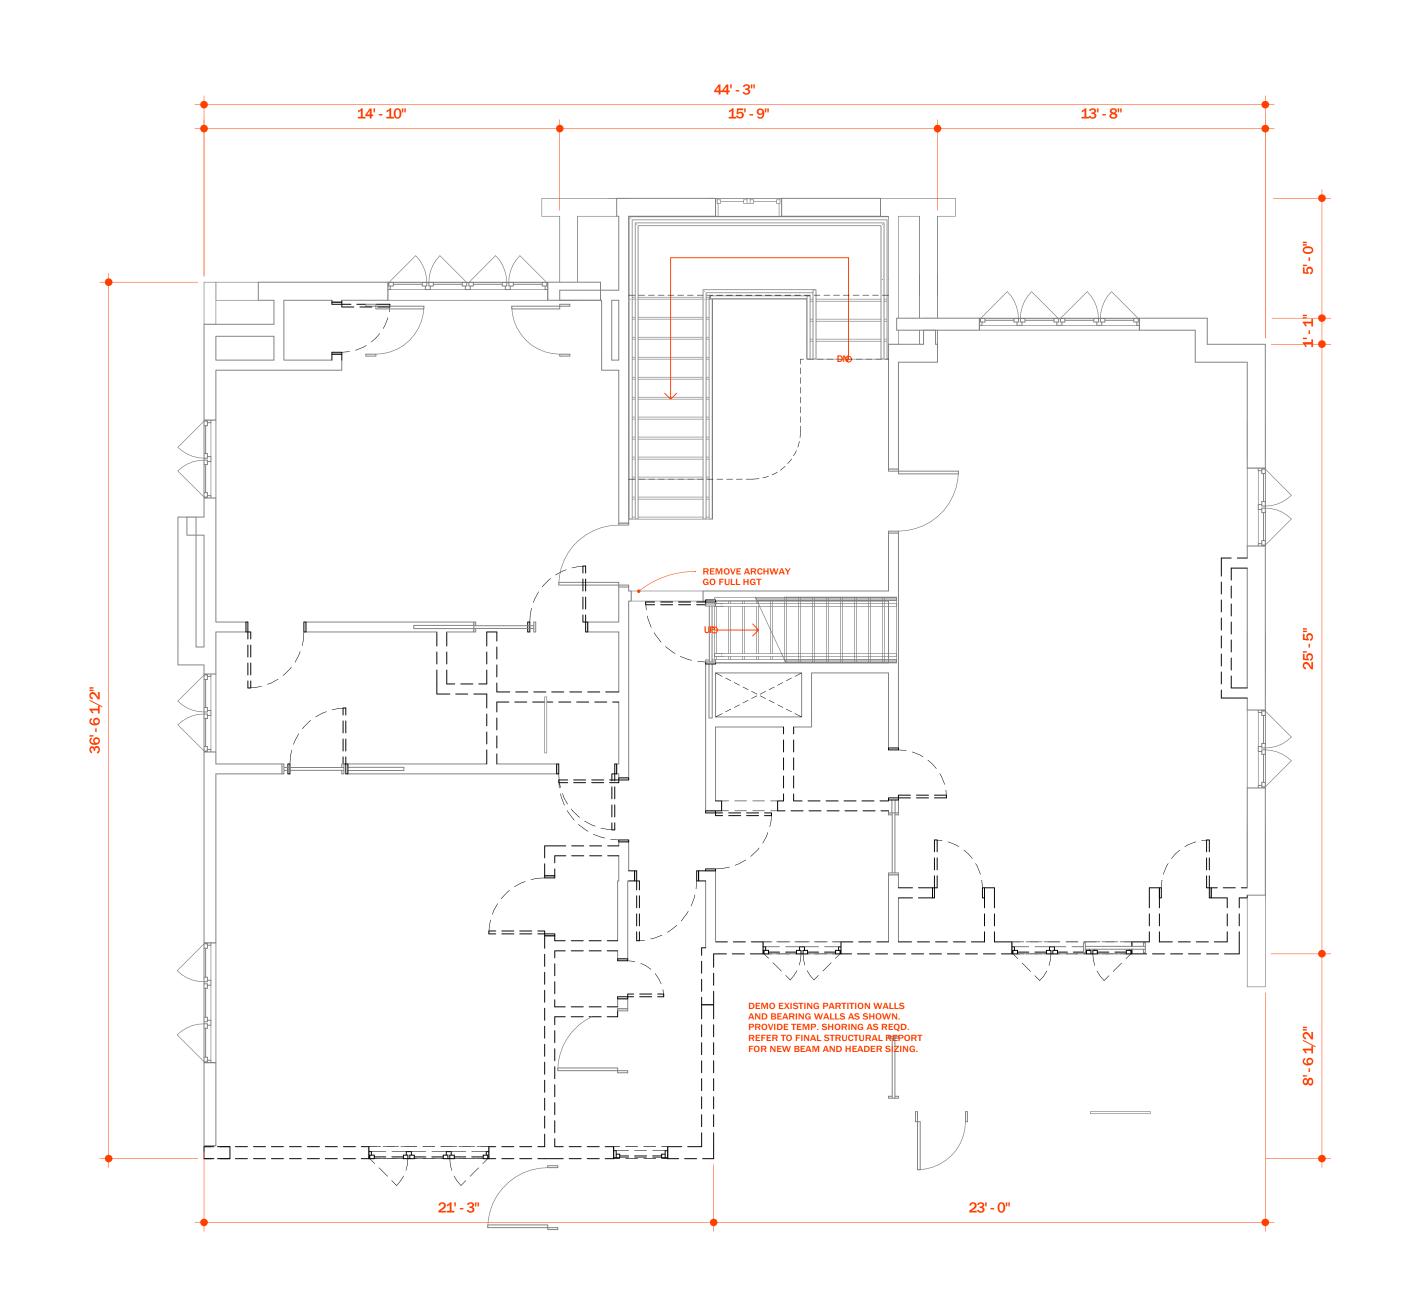


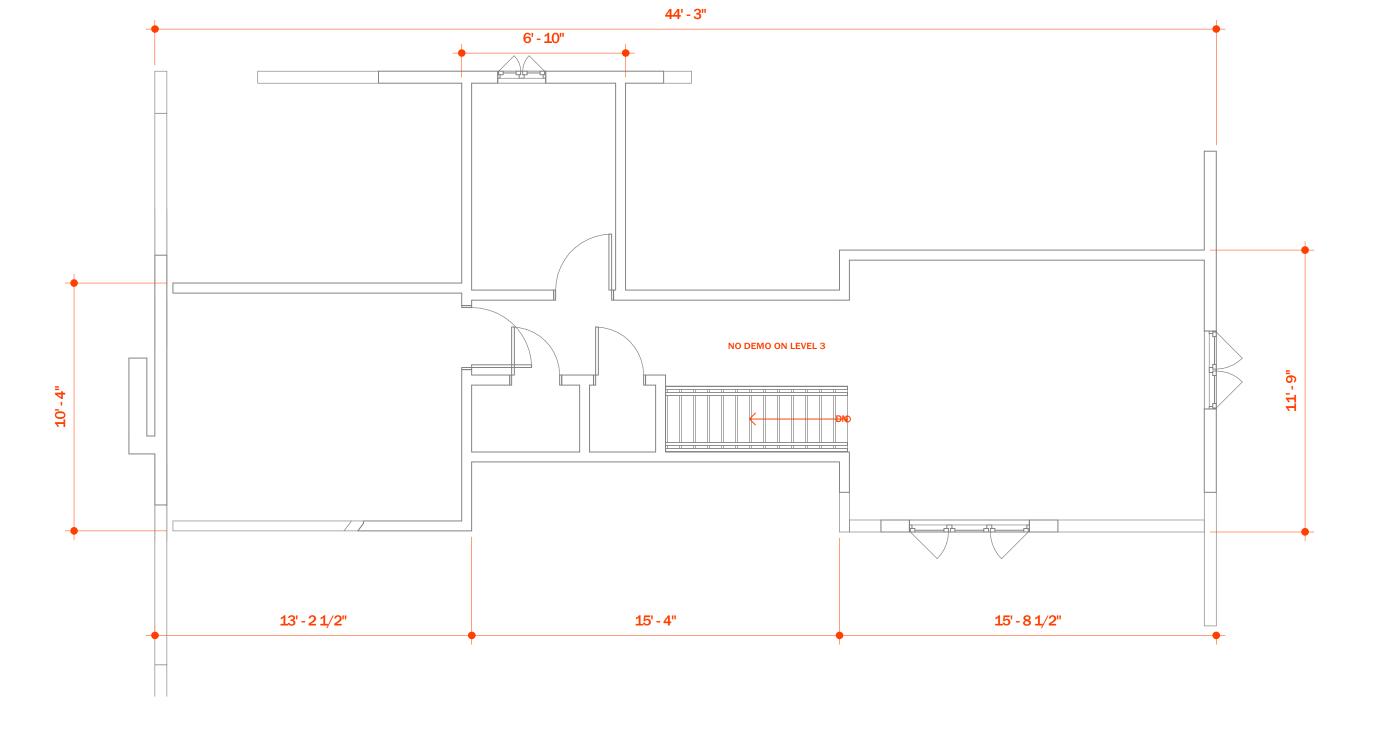

LEVEL 3 FF - EXISTING/DEMO SCALE: 1/4" = 1'-0"

LEVEL 2 FF - EXISTING/DEMO

SCALE: 1/4" = 1'-0"

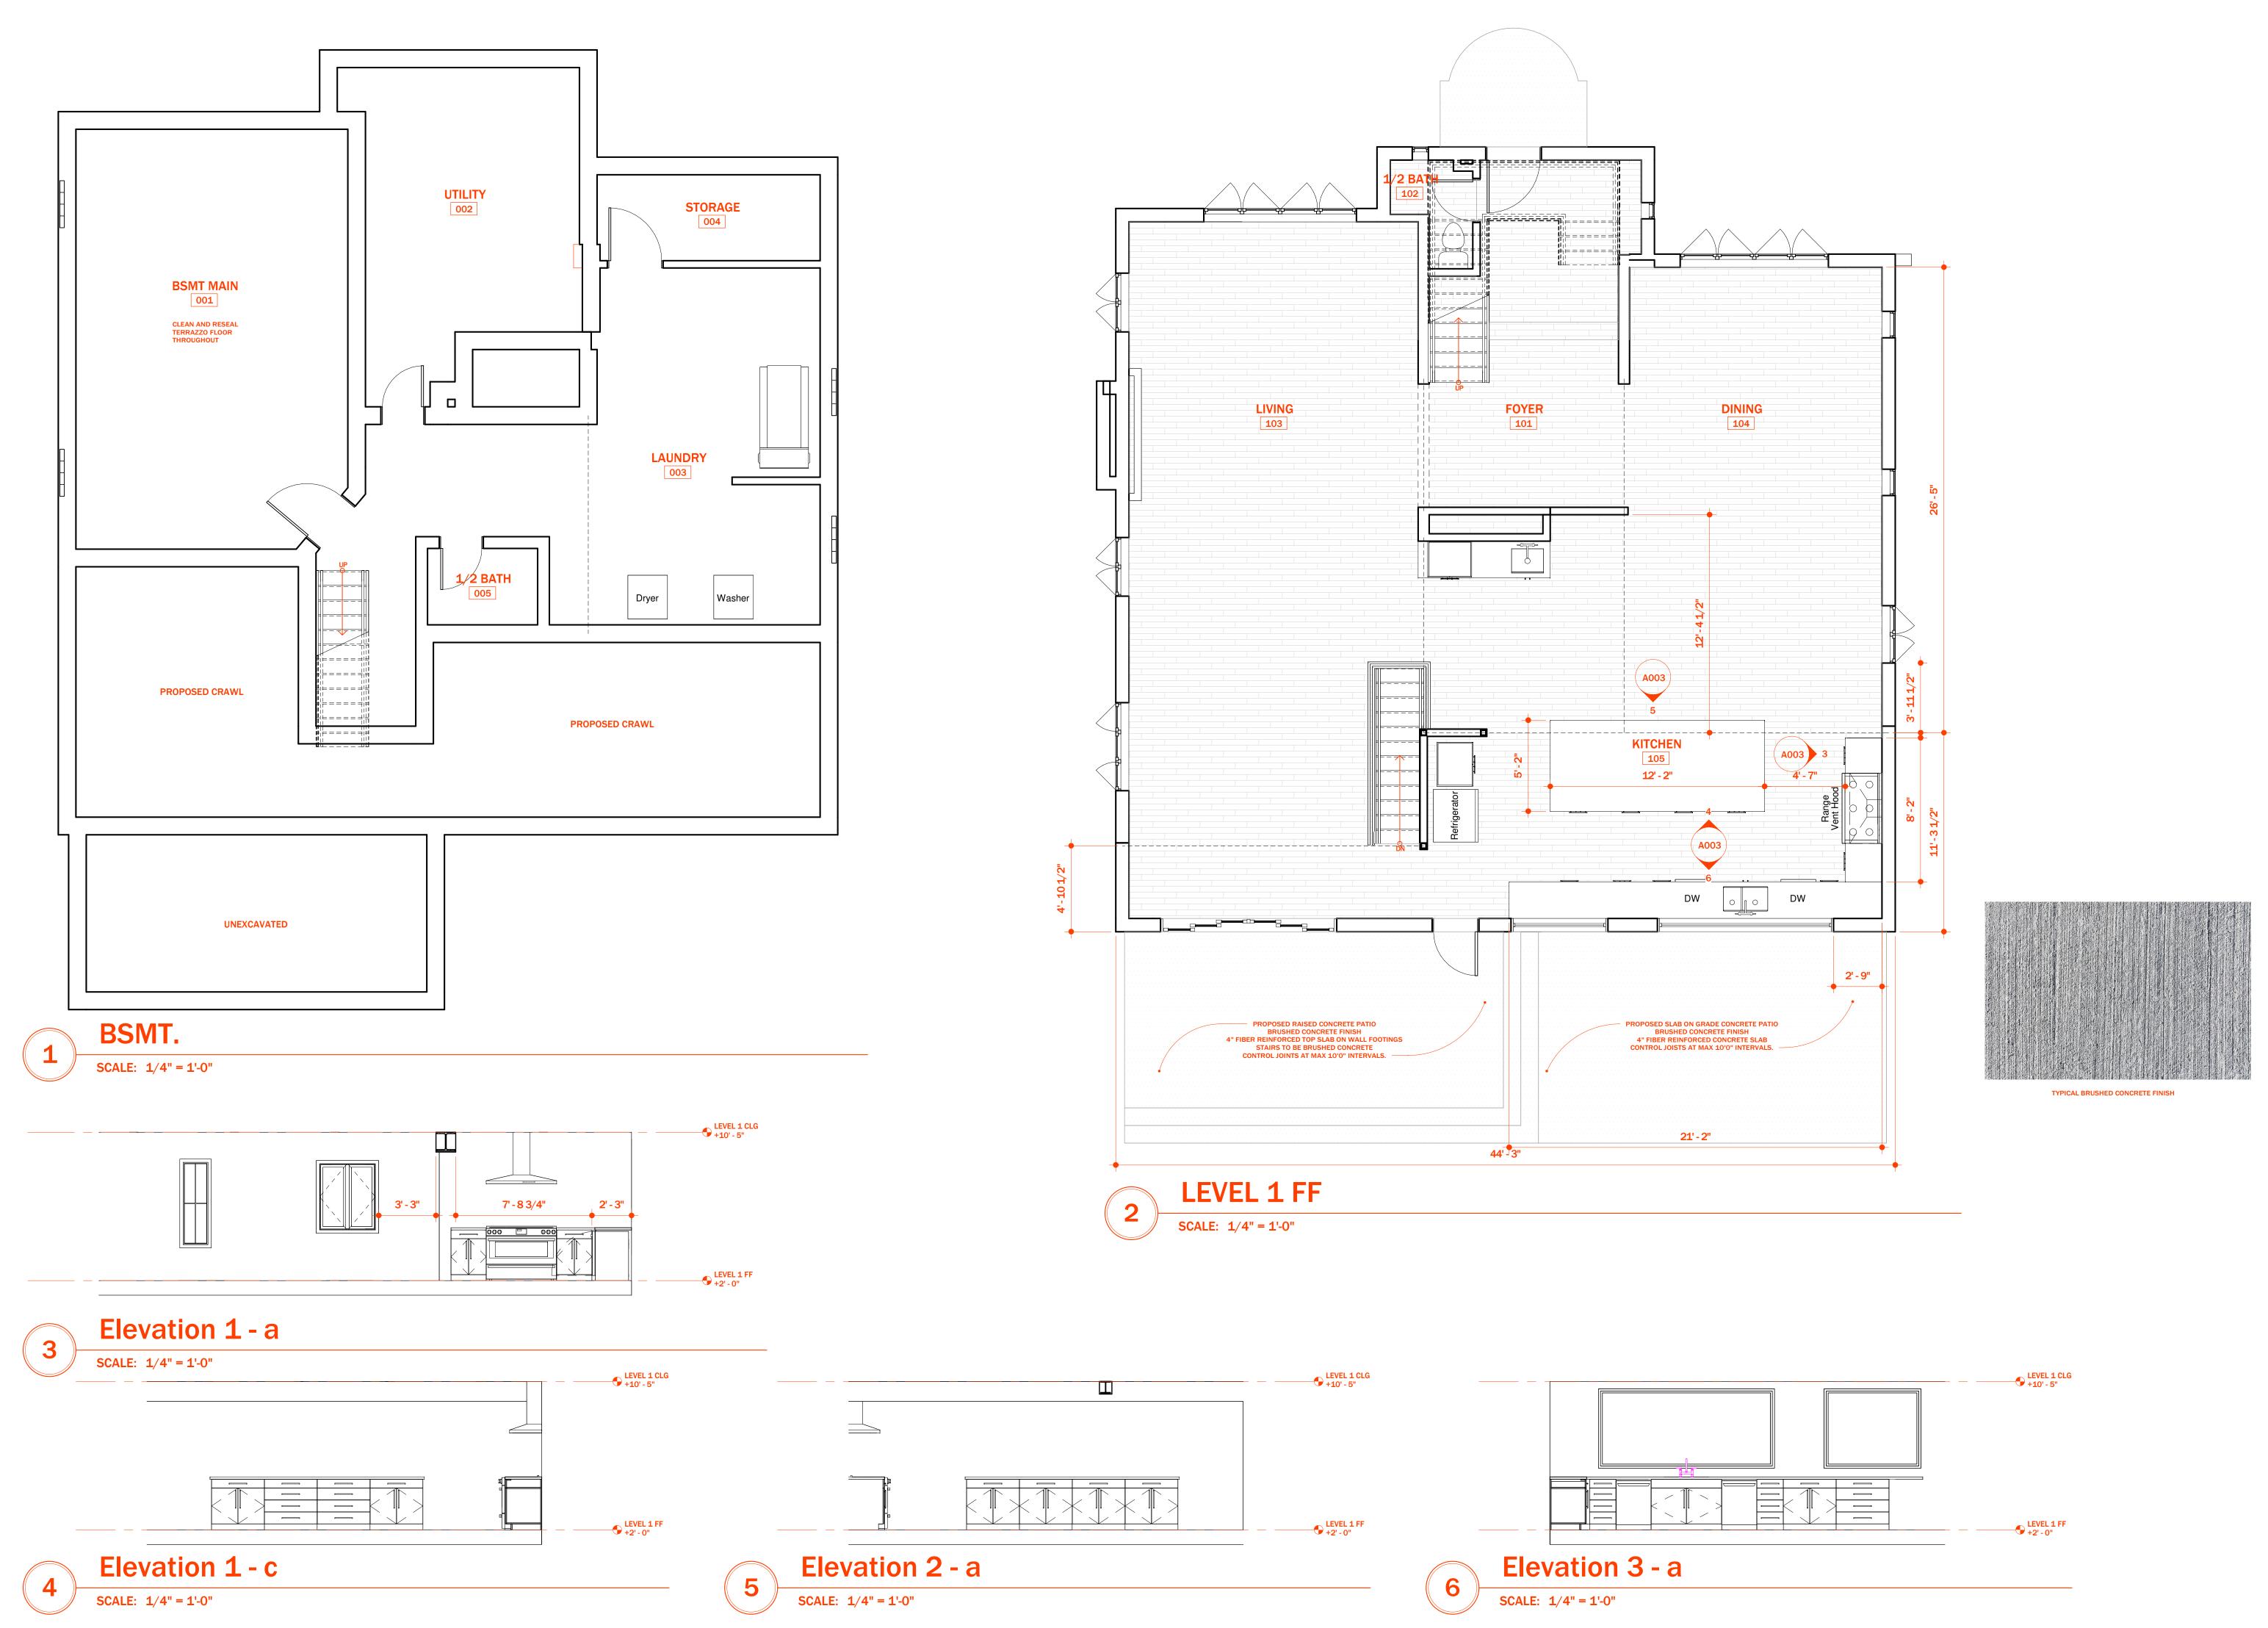

25120 Culver, St. Clair Shores, MI 48081 EST. 2014

GLASCO RESIDENCE

 TOWN, STATE

 DATE
 04/01/25


 CLIENT
 0260

 PROJECT
 0260

 REVISION
 REV 1

NOTES

NOT FOR CONSTRUCTION

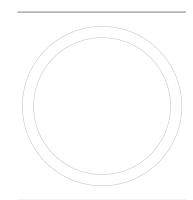

PROPOSED
PLANS AND
KITCHEN
ELEVATIONS

SCALE 1/4" = 1'-0"

AOO3


DRAWN B, SHISHAKLY

SOUTH ELEVATION

SCALE 1/4" = 1'-0"

AOO4


DRAWN B. SHISHAKLY

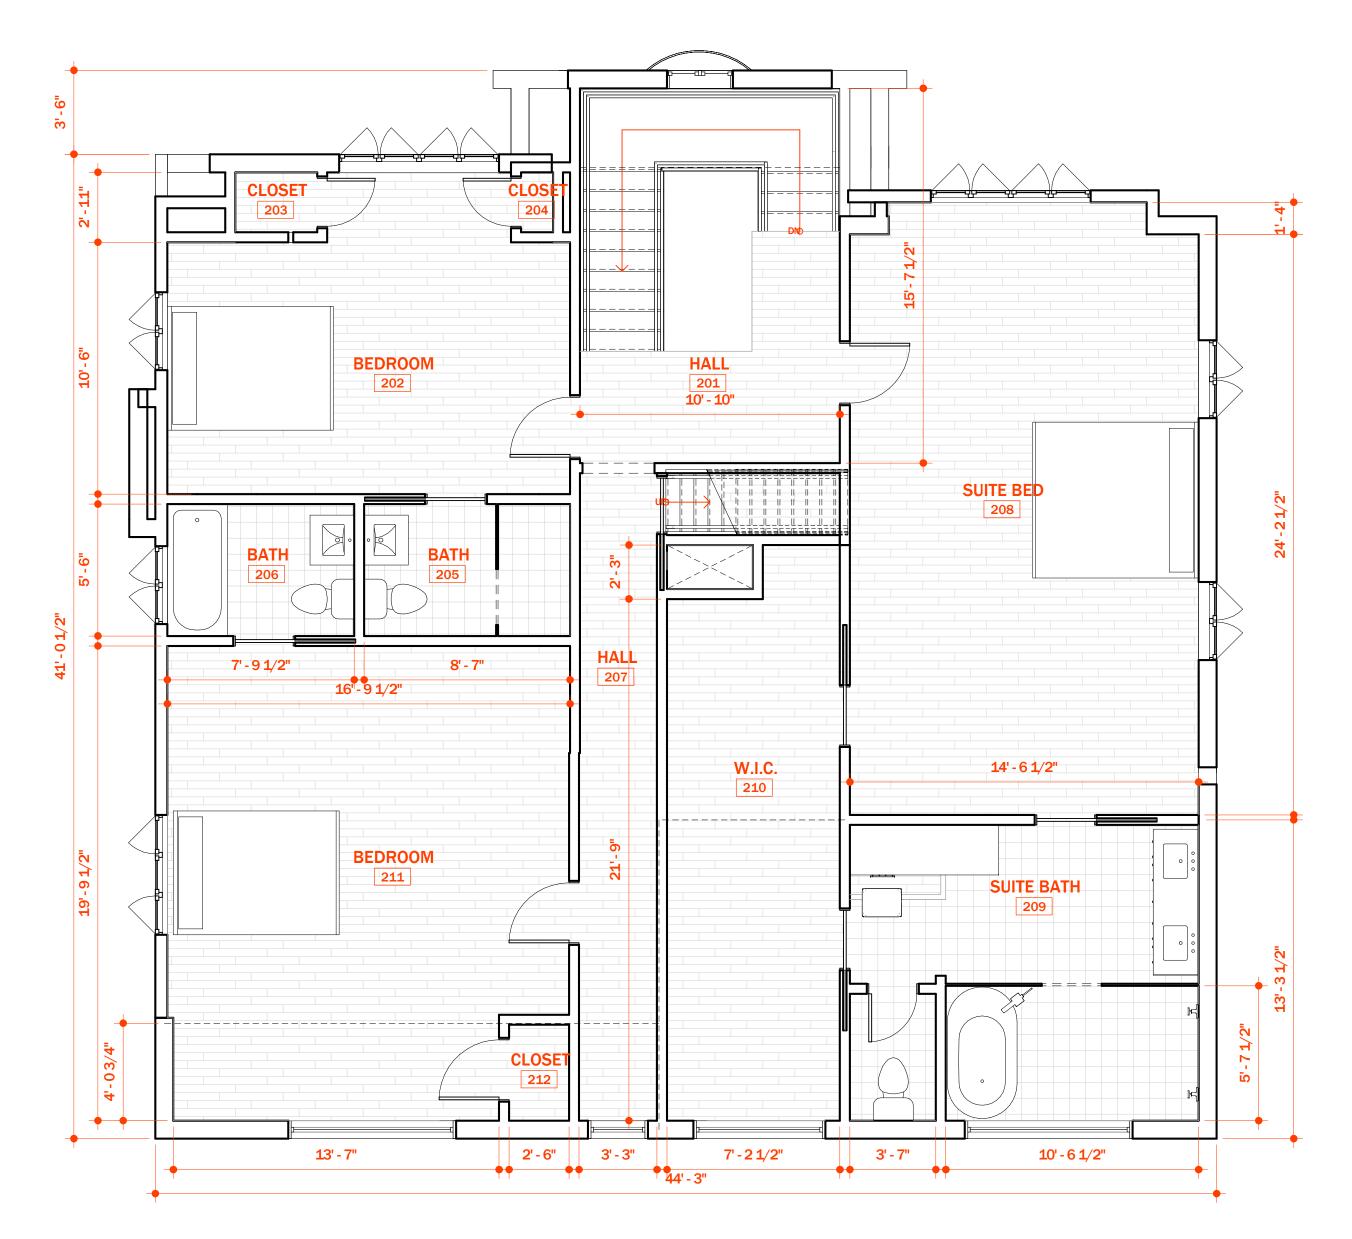

# LEVEL 2 FF

SCALE: 1/4" = 1'-0"

					\	WINDOW SCHEDULE	
WINDOW NO	WIDTH	HEIGHT	SILL HEIGHT	TYF	PE COUNT		REMARKS
A	2'-6"	4' - 6"	2' - 2"	30" x 54"	1	ANDERSON E-SERIES ARC	CH. COLLECTION - CASEMENT - RIGHT SWING - BLACK TRIM/GRILLES
В	5' - 6"	4' - 6"	<varies></varies>	66" x 54"	2	ANDERSON E-SERIES ARC	CH. COLLECTION - DOUBLE CASEMENT - BLACK TRIM/GRILLES
C	7' - 0"	6' - 0"	0' - 8"	84" x 72"	2	ANDERSON E-SERIES ARC	CH. COLLECTION - TRIPLE CASEMENT - BLACK TRIM/GRILLES
D	10' - 0"	4' - 6"	3' - 6"	120" x 54	." 1	ANDERSON E-SERIES ARC	CH. COLLECTION - QUAD CASEMENT - BLACK TRIM/GRILLES
						DOOR SCHEDULE	
DOOR NO	COUNT	WIDTH	HEIGHT	THICKNESS		TYPE	REMARKS
1	1	10' - 0"	7' - 0"	0' - 8 11/16"	Door-Multi-Slide-Pel -Bi_Parting: Reserve	-	Pella Reserve Traditional - Bi-Parting 6 Panel Sliding Door -Black Trim and Grilles. Individual Panel Thickness - 2"
2	1	2' - 6"	6' - 8"	0'-13/4"	Door-Exterior-Single	-Entry-Historic: 30" x 80"	Custom built wood door to match existing front entry door style ,color, and glass lite.

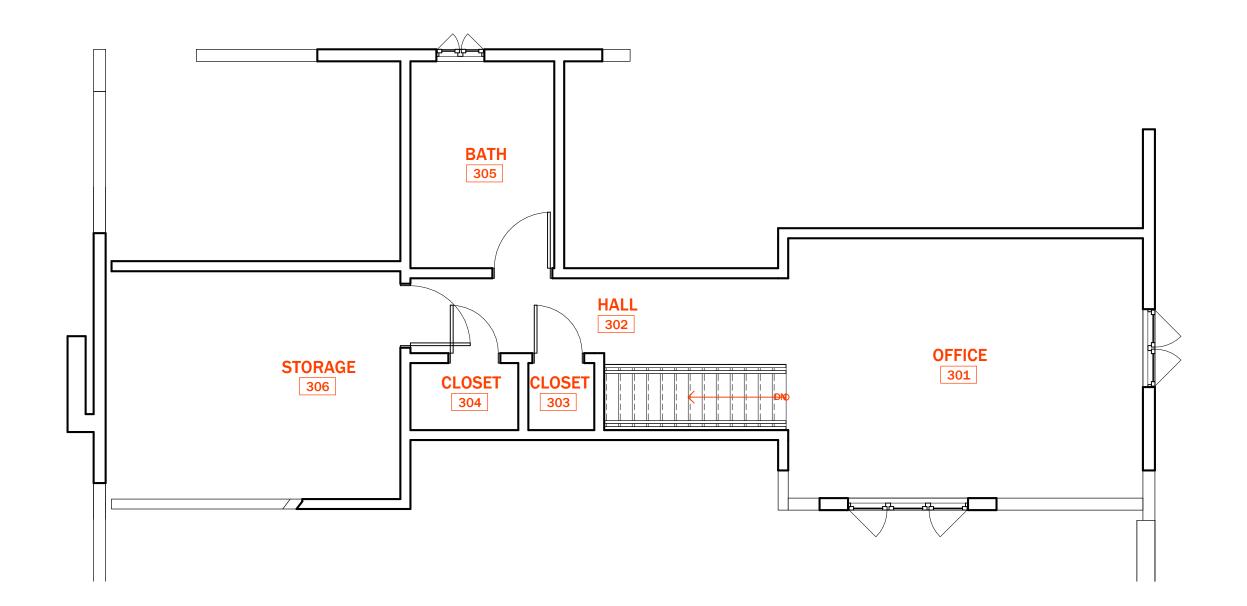







25120 Culver, St. Clair Shores, MI 48081 EST. 2014

PROJECT GLASCO **RESIDENCE** 

04/10/25 0260 0260 REV 1

4" FIBER REINFORCED CONCRETE SLAB
BRUSHED CONCRETE FINISH.
SLAB ON VAPOR BARRIER, PLACE


VAPOR BARRIER ON 6" MIN. COMPACTED GRANULAR FILL.

- CHAMFERED EDGE MIN. 1/2"

PROVIDE #4 BARS CONTINUOUS TOP
AND BOTTOM OF SLAB EDGE AND
3' FROM SLAB EDGE. TIE TO #4
BARS 12" O.C.

PATIO SLAB ON GRADE


CONTROL JOINTS @10-0" O.C. MAX

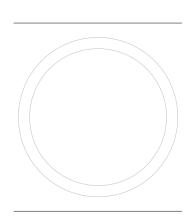

**CEILING PLANS & WEST ELEVATION** 

SCALE



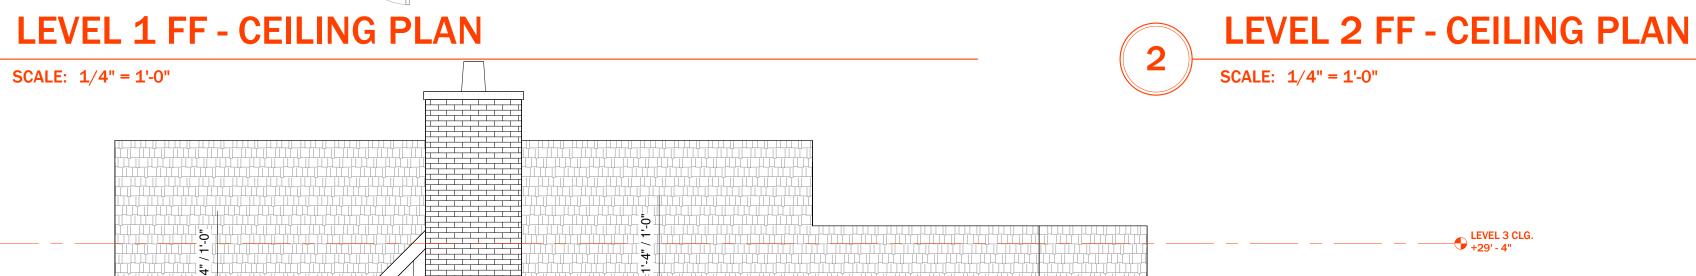

 $\circ$ 


 $\circ$ 

 $\circ$ 

A003 3

PENDANTS ON EITHER SIDE OF BED, CENTERED ON WINDOWS

 $\circ$ 

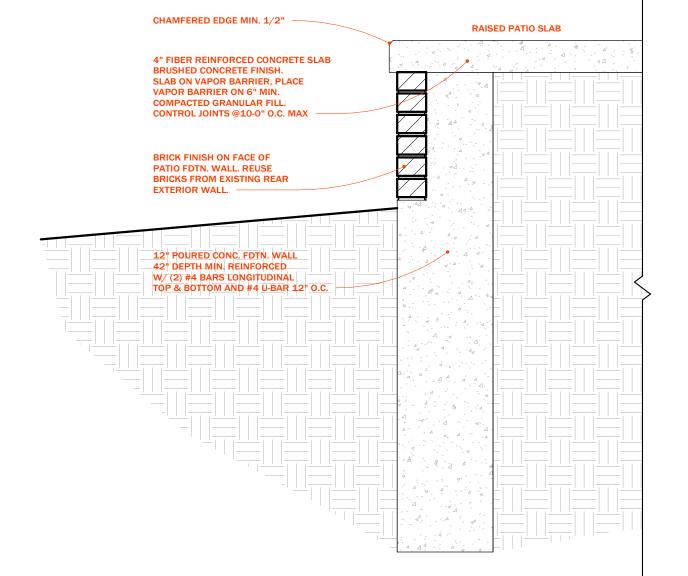

PATIO EDGE SECTION DETAIL

SCALE: 1" = 1'-0"

**WEST** SCALE: 1/4" = 1'-0"  $\circ$ 

 $\circ$ 

 $\circ$ 

 $\circ$ 

CHANDELIER

 $\circ$ 

LEVEL 1 FF +2' - 0" LEVEL 1 FOYER +1' - 0" GRADE

LEVEL 2 FF +11' - 6"

LEVEL 1 CLG +10' - 5"

FOYER SOFFIT +11' - 0"

FOR NEW ADDITION.

ALL EXISTING WINDOWS TO BE REPAIRED AS NEEDED BY A HISTORIC WINDOW CONTRACTOR (TYP.)

ALL WINDOWS ON WEST **ELEVATION ARE EXISTING.** 

ALL NEW STUCCO AND EXTERIOR WOOD
 TRIM TO BE PRIMED AND PAINTED

WITH SHERWIN WILLIAMS LOXON XP COATING TO MATCH EXISTING COLORS. SAMPLES TO BE TAKEN TO PAINT SUPPLIER FOR COLOR MATCHING. (TYP.)

- ALL EXISTING STUCCO AND EXTERIOR WOOD TRIM TO BE PRIMED AND PAINTED WITH

SHERWIN WILLIAMS LOXON XP COATING.
STUCCO TO BE PAINTED C:4 YELLOWISH
WHITE FROM THE HDC COLOR PACKAGE SYSTEM D.
HALF-TIMBERING AND TRIM/SASH TO BE PAINTED

B:19 BLACK FROM THE HDC COLOR PACKAGE

ASPHALT SHINGLE ROOF TO
BE REPAIRED AS A FULL TEAR OFF
INSPECTION OF SUBSTRATE
REQUIRED. IF DAMAGED, REPLACE
WITH MIN. 5/8" PLYWOOD.
CERTAINTEED SHINGLES.
MAY DEE CORRI ESTONE CRAY

MAX DEF COBBLESTONE GRAY PROVIDE FULL COVER BUILDING PAPER & ICE AND WATER SHIELD

OVER MIN. 6' OF ROOF SLOPE. (TYP.)

\_\_\_\_\_

EXISTING BRICK TO REMAIN.

CONTRACTOR TO CLEAN USING 300 PSI OR LESS POWERWASHER

LOCATE AND REPAIR ANY FAILING MORTAR JOINTS AND TUCKPOINT AS NEEDED MATCHING EXISTING MORTAR COLOR. (TYP.)


TOWN, STATE DATE 04/11/25 CLIENT PROJECT REVISION

0260

0260

REV 1

NOTES

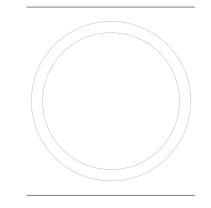

**EAST AND** NORTH **ELEVATIONS** 

1/4" = 1'-0" SCALE

DRAWN B. SHISHAKLY



