Docusign Envelope ID: DADDD111-BA4E-4874-8BDD-C841EB94EE18



## HISTORIC DISTRICT COMMISSION APPLICATION FOR WORK APPROVAL

	f Detroit - Plann			nt Depa	artment				APPLI	CATIC	ON ID
	odward Avenue, it, Michigan 482		808						HDC2025-00	199	
PR	OPERTY II	ERTY INFORMATION SS(ES): 2044 Chicago Blvd IC DISTRICT: Boston-Edison OF WORK: (Check ALL that apply) ndows/ ors Walls/ Siding Painting Painting New Other Site Improvements									
ADD	<b>DRESS(ES):</b> 2	044 C	hicago Blvo	ł							
HIS	TORIC DISTR	ICT:	Boston-Ed	ison							
sco	OPE OF WORI	<b>Հ։ (C</b> Ի	eck ALL that	at apply)							
x	Windows/ Doors	x			Painting	X			Porch/Deck/Balcony	x	Other
	Demolition		Signage						(landscape, trees, fence	s,	
BRI	EF PROJECT	DES	CRIPTION	l:							
Ren	ovation of unap	orove	d roof, insta	llation o	of new windo	ows and	installation siding				
AP	PLICANT I	DEN	NTIFICA	TION							
TYP	PE OF APPLIC	ANT	Architect/	Enginee	er/Consulta	nt					
NAN	<b>IE:</b> Timothy FI	intoff	Jr.				COMPANY NAME	<b>E:</b> 4545 A	rchitecture		
ADE	DRESS: 2761 F	Jeff	erson Ave	Ste 302			CITY: Detroit		STATE: MI	<b>ZIP:</b> 48	207

PHONE: +1 (313) 450-4545

## I AGREE TO AND AFFIRM THE FOLLOWING:

I understand that the failure to upload all required documentation may result in extended review times for my project and/or a denied application.

X	

X

х

I understand that the review of this application by the Historic District Commission does not waive my responsibility to comply with any other applicable ordinances including obtaining appropriate permits (building, sign, etc.) or other department approvals prior to beginning the work.

I hereby certify that the information on this application is true and correct. I certify that the proposed work is authorized by the owner of record and I have been authorized to make this application as the property owner(s) authorized agent.

DocuSigned by:	Timothy Flintoff Jr.
$ \sim 7 $	D
2 th	<i>{</i> ] <i>D</i>

SIGNATURE

2761 E. Jefferson Ave, Ste 302

4545 Architecture

EMAIL: tim.flintoff@4545architecture.com

04/21/2025

DATE

Detroit

48207

MI

+1 (313) 450-4545

tim.flintoff@4545architecture.com

Questions? Contact us at hdc@detroitmi.gov or (313)224-1762

NOTE: Based on the scope of work, additional documentation may be required. See <a href="http://www.detroitmi.gov/hdc">www/detroitmi.gov/hdc</a> for scope-specific requirements.

### **PROJECT DETAILS – TELL US ABOUT YOUR PROJECT**

Instructions: Add project details using the text box in each section. If your details exceed the space provided, attach the details via the attachment icon for that section.

### **ePLANS PERMIT NUMBER:**

brand and color of the shingles proposed.

(only applicable if you've already applied for permits through ePLANS)

NA

### GENERAL

1.	<b>DESCRIPTION OF EXISTING CONDITION</b> Please tell us about the current appearance and conditions of the areas you want to change. You may use a few senter attach a separate prepared document on the right. (For example, "existing roof on my garage is covered in gray aspha in poor condition.")	ences or It shingles
2.	<b>PHOTOGRAPHS</b> Help us understand your project. Please attach photographs of all areas where work is proposed.	Ø
3.	<b>DESCRIPTION OF PROJECT</b> In this box, tell us about what you want to do at the areas described above in box #1. (For example, Install new asphal roofing at garage.)	lt shingle
		Ø
4.	<b>DETAILED SCOPE OF WORK</b> In this box, please describe all steps necessary to complete the work described in box #3. (For example, "remove exis shingles, replace wood deck as necessary, replace wood eaves, install roof vents, replace rotted fascia boards, paint, worksite.")	
5.	<b>BROCHURES/CUT SHEETS</b> Please provide information on the products or materials you are proposing to install. For example, a brochure on the	

### ADDITIONAL DETAILS

### 6. WINDOWS/DOORS

Detailed photographs of window(s) and/or door(s) proposed for replacement showing the condition of the interior and exterior of the window(s) and/or door(s)

#### 9. OTHER

Please provide any additional details. HDC Staff may ask you to submit additional information at a later time depending on your project.



April 16, 2025

2044 Chicago Blvd., Detroit, MI 48206


RE: 2044 Chicago Blvd. Historic District Commission Submission

### Existing Photos



South Elevation



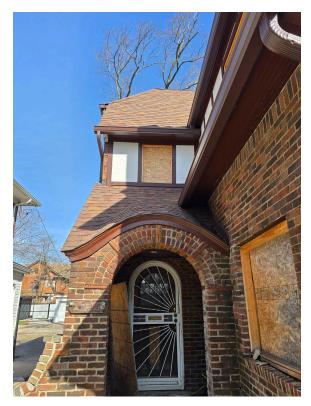

South Elevation, West Entry



West Front Porch Stair Condition






West Front Porch Typical Slab Condition





West Front Porch Typical Condition

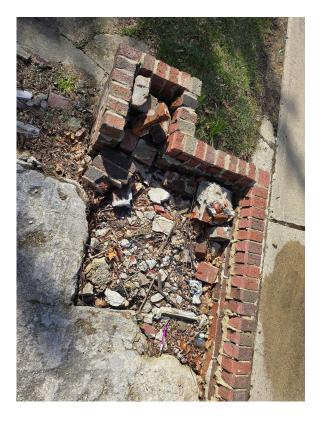





West Entry Existing Front Door and Tiles



South Elevation, East Entry



East Front Porch Condition



East Front Porch Condition



East Front Porch Existing Tile






South Elevation Detail



South Elevation Window Well

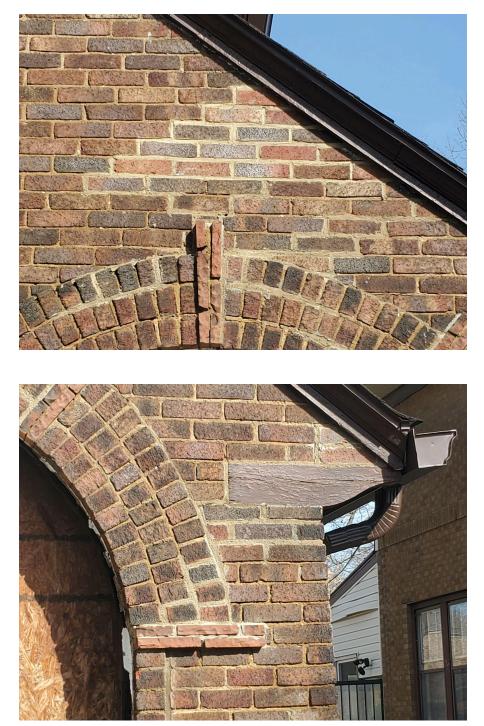

South Elevation, Brick Tuckpointing/Repair Required (typical detail)



South Elevation, Brick Tuckpointing/Repair Required (typical detail) (cont'd)





West Elevation





North Elevation



North Elevation Rear Porch/Door





East Elevation








East Elevation Existing Window



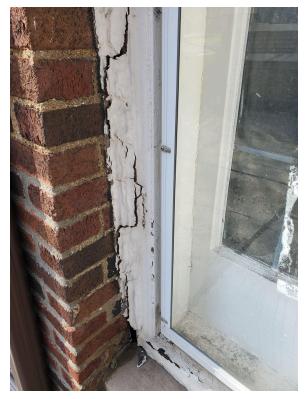

East Elevation Existing WIndow Typical Details






East Elevation Entry



East Elevation Detail

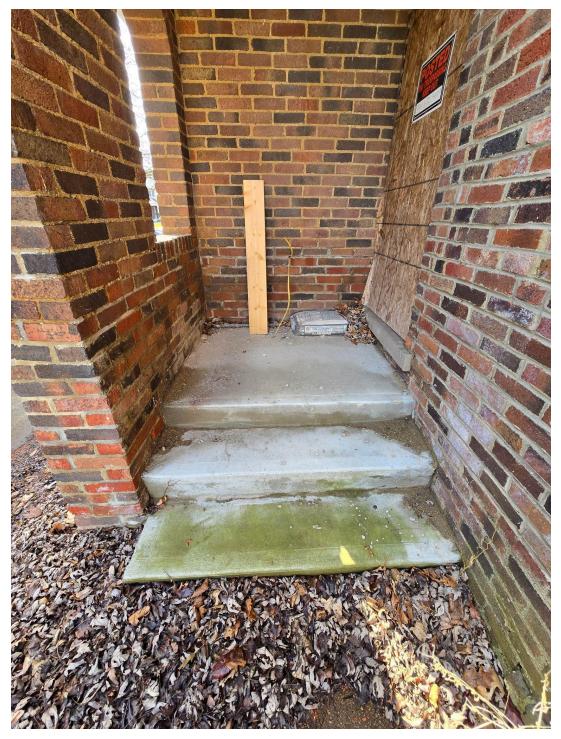

East Elevation Porch



East Dormer Detail



April 21, 2025

2044 Chicago Blvd., Detroit, MI 48206

RE: 2044 Chicago Blvd. Historic District Commission Submission

### Project Narrative

2044 Chicago Blvd. is located in the Boston Edison Historic District of Detroit, near the intersection of Chicago Blvd. and 14th Street. It is a 2.5-story single-family residence in the Tudor-Revival style, built in the early 1900s. The majority of the structure is clad in brick, with some of the second stucco clad in stucco with timber detailing. The central roof is hipped, featuring a front-facing gable which projects toward the street. There is also a 2-story hipped-roof rear wing. A brick chimney sits offset from the center at the front, flanked by an entry door and associated porch at each end of the front facade. The front porches are in a state of disrepair. A 3-sided private entry is present at the east side of the building. A fire in 2018 caused much damage to the 2nd and 3rd stories, predominantly near the southwest portion of the building. A portion of the roof and several walls have since been rebuilt. Several original leaded glass windows were also lost. Since then, almost all original windows have been removed, except for (5) leaded glass casement windows.

The intention of this project is to complete a general exterior repair of the existing building elements, replace the missing windows, and alter some non-original building elements in order to better align the building's appearance with how it looked at the time of designation.

All south (front) facing windows will be replaced with custom wood leaded glass windows, with the glass pattern to match previously existing original windows. The windows are a combination of casements and double-hung style. The westernmost 2nd story window at the front features an arch top, which will be present; all other windows are typical rectilinear windows. The original east front entry featured half-lite front door with divided lites, with sidelites on either side. The entry itself is a large arch. This look will be re-created with a custom front door and sidelites. At the west front entry, the original front door is still present, and will be repaired as necessary. All other missing windows will be replaced with aluminum-clad wood windows (Anderson E-Series). They will have simulated divided lites whose pattern will match that of the original leaded glass windows. The remaining existing leaded glass windows and their associated storm windows will be repaired as required using in-kind materials.

The two front porches will be repaired. The remaining concrete slabs will be removed and repoured.

They will be topped with tiles to match those that previously existed there, based on some tiles still found to remain. The brick side walls will be rebuilt/tuckpointed/repaired as necessary. The missing steps will be replaced with precast concrete steps. The east side entry door will be replaced with a half-lite wood door (Anderson Straightline Glass Panel Wood Door: Panel style 179) and stained to match the existing front door. The missing rear door at the 2-story wing will be replaced with an aluminum-clad wood french door with sidelites (Anderson E-Series) with simulated divided lites.

The stucco cladding at the 3rd story east dormer will be replaced with a wood cedar shake siding, to match with the material present before the 2018 fire. The stucco at the north (rear) dormer at all (3) sides, as well as the (3) sides of the rear 2nd-story hipped-roof wing, will also be replaced with wood cedar shake siding, as was present in photos from before the fire.

All brickwork will be tuckpointed and repaired as necessary.



April 16, 2025

2044 Chicago Blvd., Detroit, MI 48206

RE: 2044 Chicago Blvd. Historic District Commission Submission

### Scope of Work

- 1. Replace all missing windows
  - a. South (street-facing) elevation missing windows to be custom wood windows with leaded glass to match previously existing windows; paint to match existing
    - i. East entry on south facade to have custom half-lite wood door with simulated divided lites; side lites with leaded glass to match previously existing
  - b. All other missing windows are to be replaced with Anderson E-Series aluminum-clad wood windows
- 2. Repair remaining leaded glass window and associated storm window at east facade as required
- 3. Repair existing wood entry door at west entry of south facade as required
- 4. Replace missing entry door at east elevation with Anderson Straightline Glass Panel Wood Door: Panel style 179; stain to match existing front entry door
- 5. Replace missing patio door at north (rear) 1st floor with Anderson E-Series aluminum-clad wood french doors with side lites; frame color to match windows
- 6. Replace stucco at 3rd floor east dormer facade with wood cedar shake siding; paint to match existing
  - a. Replace stucco at 3rd floor north (rear) dormer (3 sides) with wood cedar shake siding; paint to match existing
  - b. Replace stucco at rear 2nd floor extension (3 sides: east/south/west) with wood cedar shake siding; paint to match existing
- 7. Remove remaining front porch concrete slabs
  - a. Replace with new poured concrete slab topped with ceramic tiles to match previously existing
  - b. Replace missing steps with precast concrete steps
  - c. Tuckpointe and repair existing brick porch side walls as required
- 8. Tuckpointe and repair existing brick as required
- 9. Existing asphalt shingle roof to remain (Certainteed Landmark Pro, color "Max Def Resawn Shake")

2761 E. Jefferson, Suite 302, Detroit, MI 48207

## Landmark<sup>®</sup> PRO

## The Expert's Choice

Forbes HOME BEST OF 2024





Landmark PRO, shown in Max Def Driftwood

# Introducing More Value

Landmark® PRO is designed specifically for the professional roofing contractor that takes pride in providing more to their customer.

## Landmark PRO improves upon the reliable CertainTeed Landmark shingle.

We started by adding more weathering asphalt to the industry's toughest fiberglass mat to provide more protection. Then we incorporated our Maximum Definition color blend technology to give the product more vibrancy on the roof. Included is the proven performance of our **Nail***Trak*<sup>®</sup> feature, enabling faster installation.

Landmark PRO offers the industry's strongest warranty. Protecting your reputation and safeguarding homeowners from manufacturing and aesthetic defects.

### LANDMARK PRO STANDARD WARRANTY

- Lifetime Limited Warranty
- 10-years of SureStart™ protection
- 15-year 110 MPH wind warranty (Upgrade to 130 MPH available. CertainTeed starter and CertainTeed hip and ridge required.)
- 30-year Streak Fighter® algae resistance warranty

Add it all up and what you get is the opportunity to offer a lot of additional value for the money... and today that means more than ever.

## Landmark<sup>®</sup> PRO



### Landmark PRO specifications:

- Premium Max Def color palette
- **Nail***Trak*<sup>®</sup> for faster installation
- Lifetime limited warranty
- 30-year Streak Fighter® algae resistance
- 10-year SureStart protection includes:
- Materials, labor, tear off and disposal cost
- 15-year 110 MPH wind warranty with upgrade to 130 MPH available
- UL 2218 Class 3 Impact Rated



## Landmark®



### Landmark specifications:

- Traditional color palette
- NailTrak® for faster installation
- Lifetime limited warranty
- 25-year Streak Fighter® algae resistance
- 10-year SureStart protection includes:
  - Materials and labor costs
- 15-year 110 MPH wind warranty with upgrade to 130 MPH available

## LANDMARK® PRO COLOR PALETTE





Max Def Cobblestone Gray



Max Def Driftwood




Max Def Espresso



Max Def Resawn Shake

**Max Def Colors** 

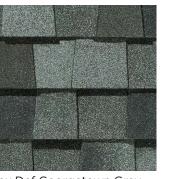

Max Def Georgetown Gray



Max Def Prairie Wood



Max Def Heather Blend



Max Def Coastal Blue



Max Def Colonial Slate



Max Def Pewter



Max Def Shenandoah



Max Def Red Oak



Max Def Weathered Wood



Max Def Moiré Black



Max Def Burnt Sienna



Max Def Evergreen



Scan code for more information

appearance and depth of color. And the natural beauty of your roof shines through.

NOTE: Due to limitations of printing reproduction, CertainTeed can not guarantee the identical match of the actual product color to the graphic representations throughout this publication.

Look deeper. With Max Def, a new dimension is added to shingles with a richer mixture of surface granules. You get a brighter, more vibrant, more dramatic

## StreakFighter<sup>®</sup>

**Algae Resistance** 

The ultimate in stain protection.

Those streaks you see on other roofs in your neighborhood? That's algae, and it's a common eyesore on roofing throughout North America. CertainTeed's **Streak***Fighter* technology uses the power of science to repel algae before it can take hold and spread.

**Streak***Fighter*'s granular blend includes naturally algae-resistant copper, helping your roof maintain its curb appeal and look beautiful for years to come.





## NailTrak®

Fast, Accurate, Visible

The new and improved Nail*Trak* nailing line, a feature on CertainTeed designer shingles.

Now NailTrak is brighter than ever before, with high-visibility lines that stand out whether it's daybreak or dusk.

Nail*Trak* removes the guesswork with three separately defined lines, creating a large area to guide your nailing and a smaller area for extreme steep-slope applications.

Diagram for illustrative purposes only.

## **Quadra**Bond®

**Advanced Layering** 

CertainTeed's specially formulated adhesive adheres shingle layers at four points, more than any other manufacturer. This superior bond provides greater protection against shingle delamination to maximize performance over the life of the shingle in any climate.

> Underside of Top Shingle Layer

## CertaSea/®

**Uplift Protection** 

**Certa***Seal*\* is a fast-activating modified asphalt sealant with a 20-year record of proven performance. Designed to seal shingles together upon installation, it protects roofs from wind uplift and shingle blow-off so that homes stay safe and dry. It's also engineered to remain flexible after installation, unlike harder sealants that can dry out and crack over time.



## Integrity Roof System™

Insist upon the Integrity Roof System<sup>™</sup> and get the ultimate in roof performance.





Read our blog

Landmark<sup>®</sup> PRO available in areas shown





### CertainTeed

Ceilings • Gypsum • Insulation • Roofing • Siding • Trim 20 Moores Road, Malvern, PA 19355 | 800-233-8990 | certainteed.com ©06/24 CertainTeed, Printed in the USA, Code No. 00-00-191-NA-EN

## Docusign Envelope ID: DADDD111-BA4E-4874-8BDD-C841EB94EE18 DOUBLE-HUNG WINDOW

## **FEATURES**

## **DOUBLE-HUNG** WINDOWS

## **FRAME & SASH**


A Select wood components are kiln dried and treated with water/insect repellent and preservative. Interior wood surfaces are available in pine, mixed grain Douglas fir, cherry, hickory, mahogany, maple, oak, walnut, alder or vertical grain Douglas fir. Interior surfaces are available unfinished or factory primed. Optional factoryapplied finishes are available in a variety of stains and paints.

**B** Wood components are fitted with aluminum extrusions on the exterior. 50 exterior colors that meet AAMA 2604 and 2605 specifications are available, as well as custom colors. Also available is a selection of seven exterior anodized options.

Optional vinyl installation flanges are pre-applied into a kerf on the frame exterior to facilitate installation. Optional aluminum flanges or metal installation clips are available.

Compression bulb weatherstrip is applied on the bottom sash, head jamb, at the meeting rail and on side jambs for a maximum weather seal.

Jamb liners encase balancer assemblies that allow each sash to be tilted 90° inward from a bottom pivot and stay securely in place for washing.

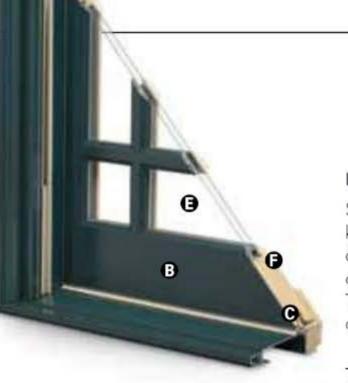

Double-hung jamb liners incorporate synthetic interior and exterior inserts or optional painted aluminum exterior and wood-veneered interior inserts.



## GLASS

G High-Performance Low-E4® glass with a low-conductivity spacer. Triple-pane glass, tinted, clear dualpane, high-altitude glass and other special glazing options are available.

Glass is fixed in place from the interior with wood stops that can be removed for easy reglazing if necessary. Glass stops available in ovolo (colonial) and contemporary profiles.

**GLASS SPACERS** available in black, white and stainless steel.

## HARDWARE

Sash lock/tilt mechanisms and keepers give a slim, more traditional design and allow opening and tilting of the window in one operation. Tilting the sash from the inside for cleaning is effortless.

Optional surface mount sash lifts allow for easy operation. Units less than 3' wide use one lift. Units 3' wide and greater use two lifts.

## HARDWARE OPTIONS



Windows with VeriLock® sensors use a different sash lock. See the next page for details. Bold name denotes finish shown.

## HARDWARE FINISHES



## **EXTERIOR & INTERIOR OPTIONS**



\*Actual wood species is either Sapele or Sipo, both non-endangered species grown in Africa, with color and characteristics similar to Central American mahoganies. Printing limitations prevent exact replication of colors and finishes. Please see your Andersen supplier for actual color and finish samples.



## ACCESSORIES Sold Separately

## DOUBLE-HUNG WINDOWS

## HARDWARE

## Window Opening Control Device Kit

An optional Window Opening Control Device Kit is available, which limits opening the sash to less than 4" when the window is first opened. Available in stone and white.

## VeriLock & Open/Closed Sensors DISCONTINUED



VeriLock sensors are unique as they

## Open/Closed Sensors

Wireless open/closed sensors

## **INSECT SCREENS**

## TruScene® Insect Screens


Andersen® TruScene insect screens let in over 25% more fresh air and provide 50% greater clarity than conventional Andersen insect screens, all while keeping out unwanted small insects. Frames are available in painted aluminum or wood-veneered options.

## **Conventional Insect Screens**

## GRILLES

## **Full Divided Light**

Permanent interior and exterior grilles with grille spacer bars between two panes of glass. Available in 5/8," 7/8", 1 1/8", 1 1/2", or 2 1/4" widths and ovolo or contemporary profile. Ovolo profile shown below, not all widths are pictured.

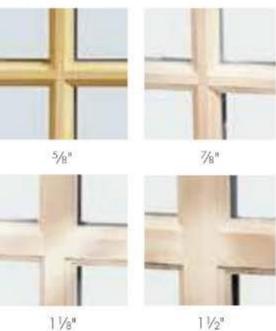

Simulated Divided Light

Permanent exterior and interior grilles without grille spacer bars. Available in 5/8", 7/8", 1 1/8", 1 1/2", or 2 1/4" widths and ovolo or contemporary profile. Ovolo profile shown below, not all widths are pictured.



## Finelight<sup>™</sup> Grilles-Between-the-Glass

Available in 5/8" flat or 1" contoured aluminum profiles. Two-tone colors of pebble tan/colony white, sierra bronze/colony white or forest green/colony white are available on the 1" profile.



## **Removable Interior Wood Grilles**

Removable interior wood grilles are available in a 7/8" width and ovolo or contemporary profiles. Optional surround for removable grille and permanent exterior grilles also available. Ovolo profile shown below.



See page 22 for more information on grilles.

E-Series Double-Hung Windows




Charcoal fiberglass screen mesh fits into an aluminum frame in all 50 exterior colors and seven anodized finishes. Available in half or full insect screens. Aluminum screen mesh is available as an option.

See page 24 for more information on our insect screens.


\*When properly configured and maintained with a professionally installed security system and/or self monitoring system compatible with Honeywell<sup>®</sup> 5800 controls. See your Andersen supplier for more information.

## Docusign Envelope ID: DADDD111-BA4E-4874-8BDD-C841EB94EE18 DOUBLE-HUNG WINDOWS

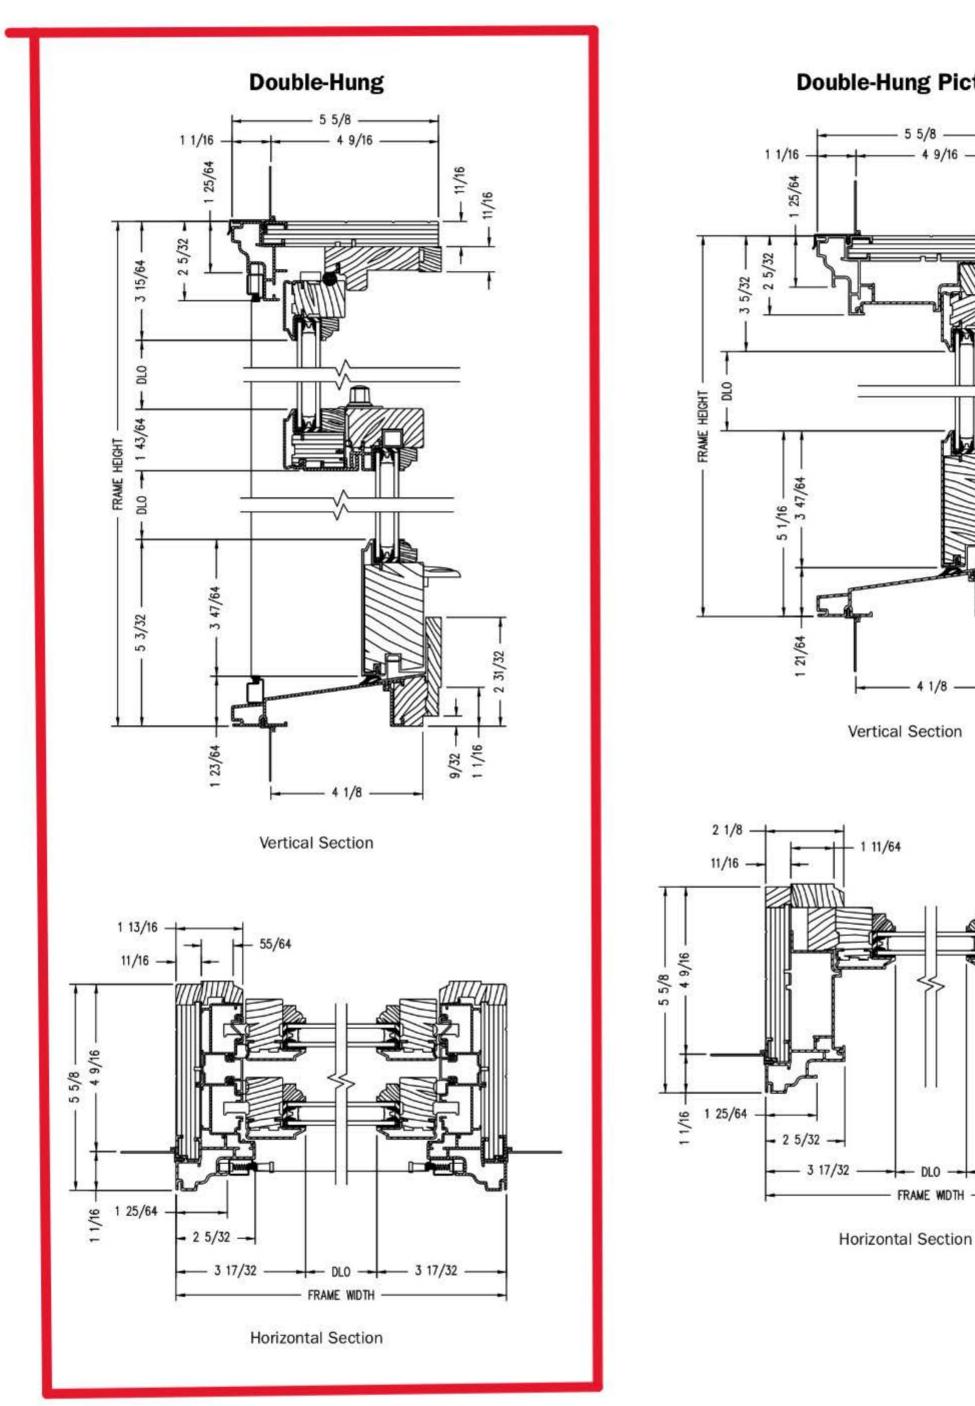

## **Double-Hung Windows**

**Double-Hung Picture** 

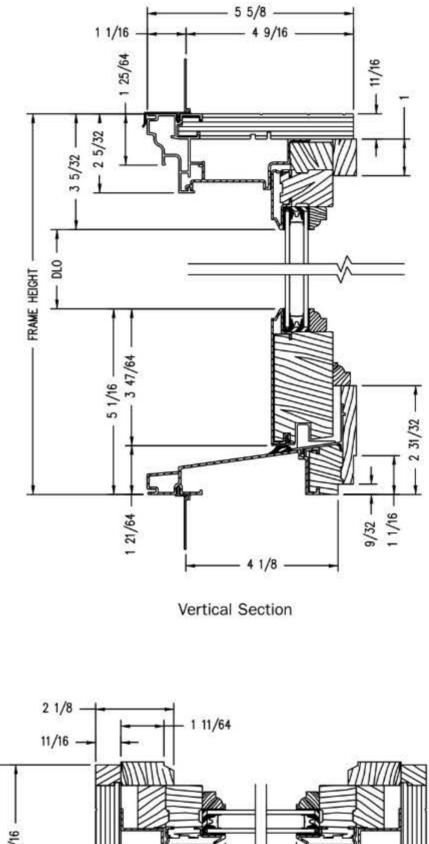


3 17/32

- DLO -

Shown with ovolo (colonial) glass stops.

PROPER INSTALLATION AND MAINTENANCE OF E-SERIES PRODUCTS IS ESSENTIAL TO ATTAIN OPTIMUM PERFORMANCE AND OPERATION. WRITTEN INSTALLATION INSTRUCTIONS THAT PROVIDE GUIDELINES FOR PROPER INSTALLATION ARE AVAILABLE BY VISITING <u>ANDERSENWINDOWS.COM</u>. CUSTOM SIZES ARE AVAILABLE. CONTACT YOUR LOCAL SUPPLIER FOR MORE INFORMATION. DRAWINGS ARE NOT TO SCALE.

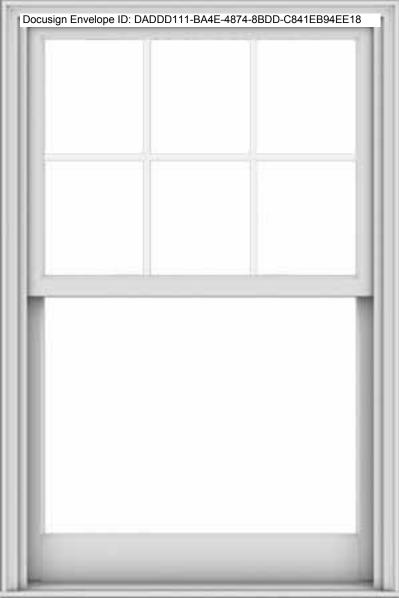

A

### FEATURES

#### **CASEMENT WINDOWS**

#### FRAME & SASH


Select wood components are kiln dried and treated with water/insect repellent and preservative. Interior wood surfaces are available in pine, mixed grain Douglas fir, cherry, hickory, mahogany,' maple, oak, walnut, alder or vertical grain Douglas fir. Interior surfaces are available unfinished or factory primed. Optional factoryapplied finishes are available in a variety of stains and paints.

Wood components are fitted with aluminum extrusions on the exterior. 50 exterior colors that meet AAMA 2604 and 2605 specifications are available, as well as custom colors. Also available is a selection of seven exterior anodized options. Integral, butyl-backed corner keys provide a positive, tight seal.

Vinyl installation flanges are pre-applied into a kerf on the frame exterior to facilitate installation. Optional aluminum flanges or metal installation clips are available.

● A Fibrex<sup>®</sup> material thermal barrier encompasses the interior perimeter of the frame and is a neutral beige color.



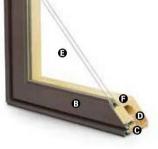

• A continuous perimeter bulb weatherstrip around the frame is positioned on the Fibrex material thermal barrier and provides solid surface contact with the sash.

A secondary bulb weatherstrip is applied on three sides of the sash into a stand-alone kerf on the aluminum extrusion. Available in white or optional black.

#### GLASS

High-Performance Low-E4® glass with a low-conductivity spacer. Triple-pane glass, tinted, clear dualpane, high-altitude glass and other special glazing options are available.

Glass is fixed in place from the interior with wood stops that can be removed for easy reglazing if necessary. Glass stops available in ovolo (colonial) and contemporary profiles.

GLASS SPACERS available in black, white and stainless steel.

#### HARDWARE

Equipped with a stainless steel gear operator, concealed hinges and hinge track. Arch casement units use stainless steel piano hinges. Sash Locks

Sash Lock

Concealed sash locks

(multi-point on units taller than 2'-8") provide a

positive lock by operating

resist corrosion." Available

one convenient lever.

in hardware finishes

shown helow

Antique Brass | Black

Gold | Oil Rubbed Bronze

Pewter | Bright Brass

Bold name denotes finish shown.

Polished Chrome | Bronze

Brushed Chrome | White

Stainless steel keepers

Locks, handles and operator covers are available in 10 finishes and can be shipped separately closer to job completion.

#### HARDWARE OPTIONS



Operator Handle & Cover

#### HARDWARE FINISHES



Oil rubbed bronze is a "living" finish that will change with time and use.

### **EXTERIOR & INTERIOR OPTIONS**

EXTERIOR COLORS 50 exterior colors, 7 anodized finishes and custom colors. See exterior colors on page 11.

#### INTERIOR WOOD SPECIES

[	1ixed Grain Douglas Fir <b>FINISHEI</b>	Oak	Maple	Hickory	Mahogany	Cherry	Walnut	Vertical Grain Douglas Fir	Alder	White Oak	color ma Naturally grain, ca make ea All factor are show Painted a Dark bra	custom stains atching avail y occurring vo olor and textur ch window or ry-finished opt yn on pine. options availa nze and blac available on p	able. priations in e of wood ne of a kind. tions ble on pine.
Clear Coat		Autumn Oak	Golden Hickory	Honey	Cinnamon	Russet	Mocha	Espresso		_	Anodize	d silver painte e on maple or	ed option
White	Birch Bark	Primed (for paint)	Canvas	Sandtone	Terratone or Sipo, both no	Forest Green	Dark Bronze	Dove Gray	Prairie Grass	Red Rock	Cocoa Bean	Black	Anodized Silver

Printing limitations prevent exact replication of colors and finishes. Please see your Andersen supplier for actual color and finish samples.

#### ACCESSORIES Sold Separately

#### **CASEMENT WINDOWS**

#### HARDWARE

#### **Power Operator**



Power operators are available in bronze, white, black or gold.

#### Window Opening Control Device Kit

An optional Window Opening Control Device Kit is available, which limits opening the sash to less than 4" when the window is first opened. Available in stone and white.

#### **Construction Hardware**



Construction locks and operator handles keep your permanent window hardware away from the construction process and possible damage yet allow operation of windows during construction.

#### SENSORS

#### VeriLock & Open/Closed Sensors DISCONTINUED

detect whether the windows are locked or unlocked" — a feature no other sensors can provide.

#### Open/Closed Sensors

Wireless open/closed sensors are available in four colors.

See <u>page 27</u> for Smart Home options.

#### PRIVACY OPTIONS

#### System 3 Blinds



A 5%" aluminum slat blind is mounted to an extruded aluminum blind panel and applied to the window, creating a triple-glazed window boasting privacy and energy efficiency. Available in three colors. Blind panels are offered in white, tan, gold or an optional wood veneer to match your interior.

#### System 3 Shades

Pleated fabric shades are available in four colors to effortlessly and beautifully filter the light.

See <u>page 25</u> for more information on our blinds and shades.

#### INSECT SCREENS

#### TruScene<sup>®</sup> Insect Screens



Andersen® TruScene insect screens let in over 25% more fresh air and provide 50% greater clarity than conventional Andersen insect screens, all while keeping out unwanted small insects. Frames are available in painted aluminum or wood-veneered options.

#### **Retractable Insect Screens**

Retractable insect screen available in wood-veneered frame options.

#### **Conventional Insect Screens**




Charcoal fiberglass screen mesh fits into an aluminum frame in colors of bronze, white or gold as well as optional black. Aluminum screen mesh and wood-veneered insect screen also available.

See <u>page 24</u> for more information on our insect screens.

#### GRILLES

#### Full Divided Light

Permanent interior and exterior grilles with grille spacer bars between two panes of glass. Available in  $\frac{5}{40}$ ,  $\frac{7}{40}$ ,  $1\frac{1}{20}$ ,  $1\frac{1}{20}$ , or  $2\frac{1}{40}$  widths and ovolo or contemporary profile. Ovolo profile shown below, not all widths are pictured.

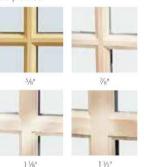

#### Simulated Divided Light

Permanent exterior and interior grilles without grille spacer bars. Available in  $\frac{5}{74}$ ,  $\frac{1}{74}$ ,  $\frac{1}{14}$ ,  $\frac{1}{74}$ ,  $\frac{1}{74$ 



#### Finelight<sup>™</sup> Grilles-Between-the-Glass

Available in 5/s" flat or 1" contoured aluminum profiles. Two-tone colors of pebble tan/colony white, sierra bronze/colony white or forest green/colony white are available on the 1" profile.



**Removable Interior Wood Grilles** 


Removable interior wood grilles are available in a 7%" width and ovolo or contemporary profiles. Optional surround for removable grille and permanent exterior grilles also available. Ovolo profile shown below.




See page 22 for more information on grilles.

#### **Casement Windows**



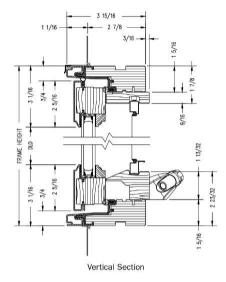


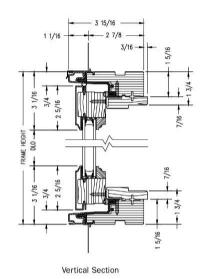

Sash-Set (2-Piece) Casement


90/57 90

Horizontal Section

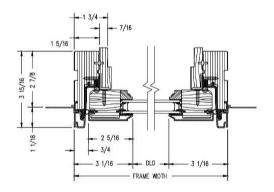

Horizontal Section

Shown with ovolo (colonial) glass stops.

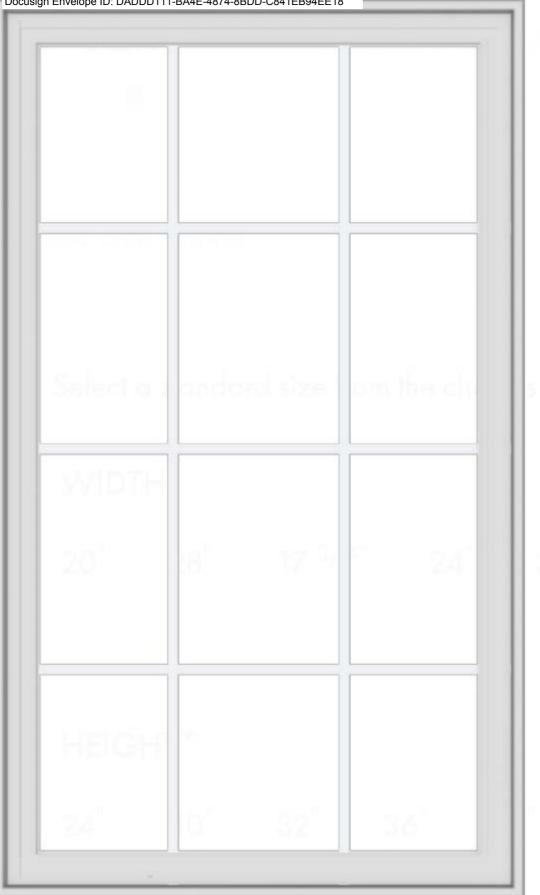



# **ENTRY DOORS**









# One of a kind. Like your home.

With Andersen, create an entry door with character and handcrafted origins, built in solid fine-grain wood. Styled to suit you perfectly. One of a kind. Like your home. And like you.







# **EXPAND YOUR VIEW**

# ENTRY DOOR STYLES

All styles available with wood or clad exteriors, as single or double doors, and with inswing or outswing operation. Doors are offered in standard and custom sizes.



Gothic, Elliptical, Arch and Springline<sup>™</sup> door styles are also available. Visit andersenwindows.com/entrydoors or contact your Andersen supplier for more information.

# SIDELIGHTS & TRANSOMS

To provide seamless alignment with Straightline or Arts & Crafts style entry doors, sidelights and transoms are available. For more information, visit **andersenwindows.com/entrydoors**.



# **REALIZE YOUR VISION**

# INTERIOR AND EXTERIOR WOOD SPECIES


Select from an expansive array of the finest grades of wood species to add warmth and beauty to your home's entranceway. Available on both the interior and exterior of your door.



\*Actual wood species is either Sapele or Sipo, both non-endangered species grown in Africa, with color and characteristics similar to Central American mahoganies.


Naturally occurring variations in grain, color and texture of wood makes each window or door one of a kind.

Printing limitations prevent exact replication of finishes. Please see your Andersen supplier for actual finish samples.

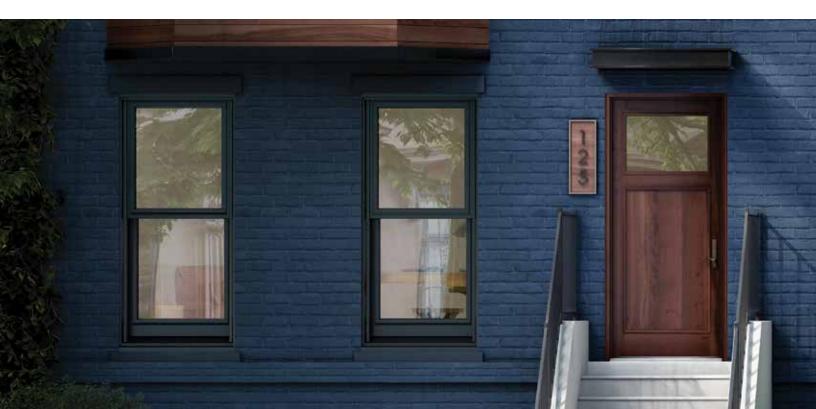

# **COLOR OPTIONS**

Make a bold first impression with color – choose from 50 commercial-grade, aluminum exterior color options. On the interior of the door, choose from our painted options or enjoy the look of unfinished wood.

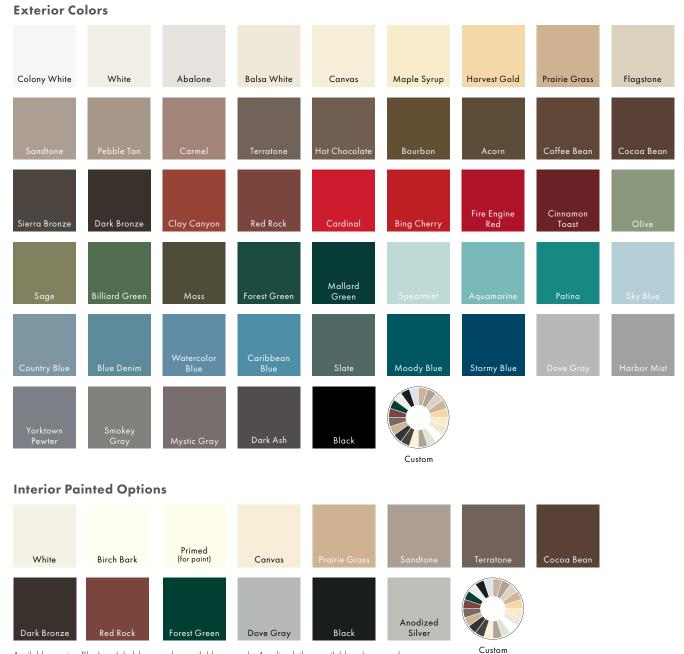

Available on pine. Black and dark bronze also available on maple. Anodized silver available only on maple.

# ADD A VISUAL ACCENT

Add a carefully considered detail to your home's overall look with Andersen® hardware or have your door prepped for hardware manufactured by others.

# HARDWARE OPTIONS\*



# FSB® HARDWARE\*

Durable FSB hinged door hardware features clean lines and a sleek finish for a thoroughly modern look.



Black Anodized Aluminum Satin Stainless Steel

Satin Stainless Steel

\*Hardware sold separately. \*\*FSB style 1102 is not available in black anodized aluminum. FSB hardware is stainless steel or aluminum.

Printing limitations prevent exact finish replication. See your Andersen supplier for actual finish samples.

"FSB" is a registered trademark of Franz Schneider Brakel GmbH & Co.





Tribeca and Albany hardware are zinc die cast with power-coat durable finish. Yuma, Encino, Newbury and Anvers are solid forged brass. Distressed bronze and oil rubbed bronze are "living" finishes that will change with time and use. Bright brass and satin nickel finishes on patio door hardware feature a 10-year limited warranty.

# YALE<sup>®</sup> ASSURE LOCK<sup>®\*</sup>

Monitor, lock and unlock from anywhere with the Yale Assure Lock. This slim, sleek keyless lock is designed exclusively for Andersen® hinged doors<sup>\*\*</sup> and integrates with a wide range of smart home platforms.







Satin Nickel

\*Hardware sold separately.

\*\*Available on select hinged doors, see your Andersen supplier for details. Printing limitations prevent exact finish replication. See your Andersen supplier for actual finish samples. Yale manufactures and supports the limited warranty for Yale Assure Lock for Andersen doors.

# **BRIGHTEN YOUR VIEW**


Glass can affect energy efficiency more than any other part of a door. Choose from these High-Performance glass options for your climate and home.

			ENERGY							LIGHT											
GLASS			U-Factor How well a product prevents heat from escaping.				Solar Heat Gain Coefficient How well a product blocks heat caused by sunlight.			Visible Light Transmittance How much visible light comes through a product.				Ho	UV Protection How well a product blocks ultraviolet rays.						
SmartSun™	Thermal control similar to tinted glass, with visible light transmittance similar to Low-E4 glass.	•			• (	С	•				•				D	0					•
SmartSun with HeatLock® Coating	Applied to the room-side surface, it reflects heat back into the home and improves U-Factor values.	•			•	D	•			•	•				С	0	•			•	•
Low-E4®	Outstanding overall performance for climates where both heating and cooling costs are a concern.	•			• (	С	•				0	(				0	•			•	0
Low-E4 with HeatLock Coating	Applied to the room-side surface, it reflects heat back into the home and improves U-Factor values.	•				D	•				0				D	0	•				0
Sun	Outstanding thermal control in southern climates where less solar heat gain is desired.	•				С	•				•			) (	С	0	•			•	0
PassiveSun®	Ideal for northern, passive solar construction applications where solar heat gain is desired.	•			<b>D</b> (	С	•		)	0	0					0	•			O	0
Triple-Pane with Low-E coatings on two surfaces	Three panes of glass combine with either argon gas blend air or Low-E coatings to provide enhanced energy performance.					•	•			•	0				D	0	•				•

Center of glass performance only. Ratings based on glass options as of January 2022. Visit and ersenwindows.com/energystar for ENERGY STAR® map and NFRC total unit performance data.

### **Patterned Glass**

Patterned glass lets in light while obscuring vision and adds a unique, decorative touch to your home. Cascade and Reed patterns can be ordered with either a vertical or horizontal orientation.

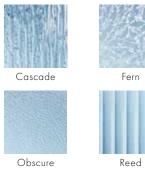





### Art Glass

With art glass from Andersen, you can add interest, create a focal point and make your doors stand out. These finely crafted inserts are available to complement any home's architecture. For more information, visit andersenwindows.com/artglass.

Arts & Crafts (403) Shown in oak with Arts & Crafts art glass pattern.

Satin Etch



# **GRILLE OPTIONS**

### **Grille Patterns**

Choose from Colonial, Prairie or Specified Equal Light grille patterns.







Colonial

Specified Equal Light

# Grille Types Available

# Full Divided Light

Permanent exterior Permanent interior with spacer

**Simulated Divided** 






**Light** Permanent exterior Permanent interior

# **Profiles & Widths**

Grilles are available in four standard widths:  $\frac{3}{4}$ ",  $\frac{7}{8}$ ",  $1\frac{1}{8}$ " and  $1\frac{1}{2}$ ".

Removable Interior Removable interior

Simulated Divided Light with Removable Interior Grilles Permanent exterior Removable interior

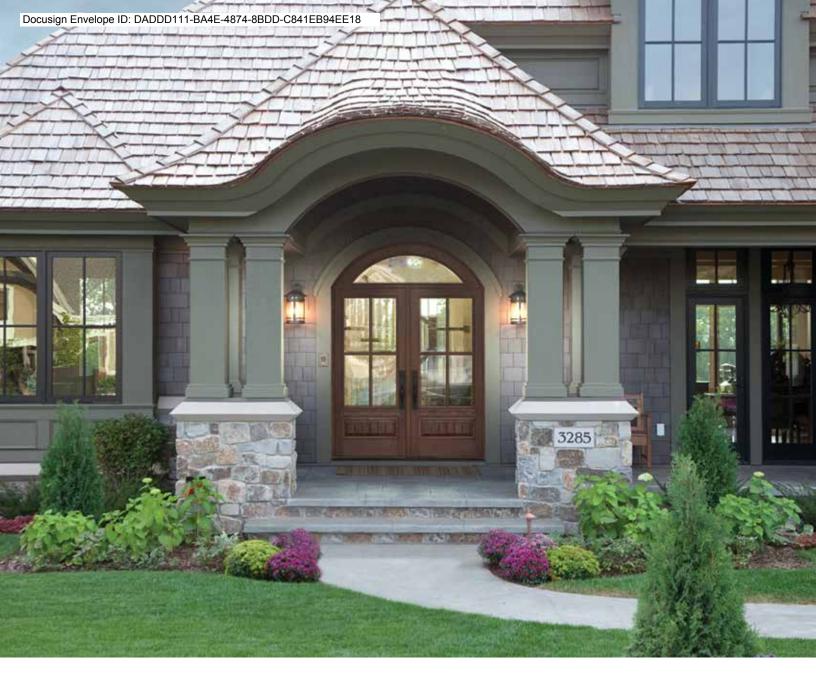



# andersenwindows.com/entrydoors

"Andersen" and all other marks where denoted are trademarks of Andersen Corporation. ©2022 Andersen Corporation. All rights reserved. 04/22 Part #2000652

# Docusign Envelope ID: DADDD111-BA4E-4874-8BDD-C841EB94EE18 HINGED PATIO DOORS

# FEATURES

# HINGED PATIO DOORS

# FRAME & PANEL

Select wood components are kiln dried and treated with water/insect repellent and preservative. Interior wood surfaces are available in pine, mixed grain Douglas fir, cherry, hickory, mahogany, maple, oak, walnut, alder or vertical grain Douglas fir, Interior surfaces are available unfinished or factory primed. Optional factoryapplied finishes are available in a variety of stains and paints.

Wood components are fitted with aluminum extrusions on the exterior. 50 exterior colors that meet AAMA 2604 and 2605 specifications are available, as well as custom colors. Also available is a selection of seven exterior anodized options.


• The frame perimeter consists of a high-quality foam-filled weatherstrip.

Inswing and outswing doors receive a factory-applied vinyl installation flange with drip cap. Some inswing patio doors require an adjustable metal installation flange. Optional aluminum flanges and metal installation clips are available.

# SILL

# **Drainage Sill for Inswing Patio Doors**

Premium grade aluminum inswing sill with an oak threshold. Sills have a built-in drainage channel that allows water to drain away from the interior of the door. A top plate is removable for easy channel cleaning. A polyurethane thermal barrier helps reduce heat loss. Available in clear anodized or dark bronze anodized finish, shown below.

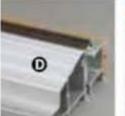






# **On-Floor Sill for Outswing Patio Doors**


Premium grade aluminum outswing sill with oak threshold. Outswing door sill is backed with a compression foam weatherstrip. Available in clear anodized or dark bronze anodized finish, shown below.

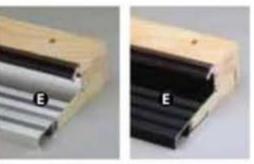


On-floor sills for outswing

# Low-Threshold Sill

Aluminum low threshold sill available for outswing doors and inswing doors. Available for inswing doors with jamb depths of 4 %6° and 6 %16°. Low threshold design provides a smooth transition fram interior to exterior and is wheelchair-accessible. A polyurethane thermal barrier helps reduce heat loss. Available in dark bronze anodized finish, shown below.

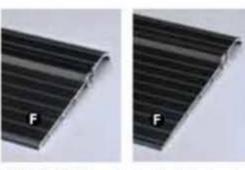

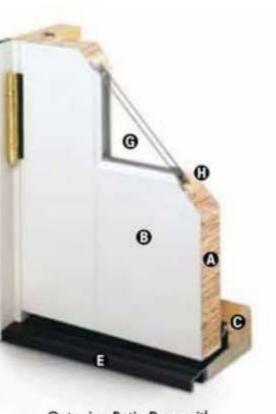

Outswing Patio Door with French Panel

# GLASS

G High-Performance Low-E4<sup>III</sup> glass with a low-conductivity spacer. Triple-pane glass, tinted, clear dualpane, high-altitude glass and other special glazing options are available.

Glass is fixed in place from the interior with wood stops that can be removed for easy reglazing if necessary. Glass stops available in ovolo (colonial) and contemporary profiles.

GLASS SPACERS available in black, white and stainless steel.

# HARDWARE

# Multi-Point Locking System

Autolatch® stainless steel multi-point lacking system lacks the panel in three locations to provide a secure, weather-resistant entry system. Some door heights lock the panel in four locations.

Hinges



Heavy-duty commercial grade hinges are available in finishes of antique brass, black, bright brass, commenced pewter, gold down oil rubbed branze, bright chrome stainless steel, and white to go with your handle set. Hinges are complete with matching screws. An innovative hinge shimming system allows for minor adjustments.

Satin Chrome, Gold Dust and Bright Chrome DISCONTINUED



Drainage sills for inswing

4 %16" & 6 %16" Low-threshold sills for inswing



4%16" Low-threshold sill for outswing

\*Actual wood species is either Sapele or Sipo, both non-endangered species grown in Africa, with color and characteristics similar to Central American mahaganies.

NDOWS & DOORS

# ACCESSORIES Sold Separately

# HINGED PATIO DOORS

### HARDWARE

# **Construction Handle**



Temporary construction handle is sent with all hinged patio doors. This handle allows operation during the construction phase, protecting finished hardware from damage or jobsite theft.

# **Hardware Options**

Additional hardware options such as exterior keyed locks and more are also available. Contact your Andersen supplier.

# SENSORS

# Yale® Assure Lock®

Monitor, lock and unlock from anywhere with the Yale Assure Lock. The sleek keyless lock includes Bluetooth® technology for key-free unlocking and is compatible with Z-Wave® for integration with a wide range of smart home platforms. Available on select hinged doors, see your Andersen supplier for details.

# VeriLock & Open/Closed Sensors DISCONTINUED

detect whether the doors are locked or unlocked" — a teature no other sensors can pravide. Available in all hardware linteles.

# Open/Closed Sensors

Winless open/clased sensors are available in faur colors.

See page 27 for Smart Home options.

### INSECT SCREENS

Retractable Insect Screens



Concealed, retractable insect screen has charcoal fiberglass screen mesh. Available for inswing single or double door units. Insect screen rolls out when needed and retracts into concealed housing when not in use. Available in 50 exterior colors.

Retractable insect screens for outswing doors are field applied to the interior of the door. Available in five colors including white, almond, desert sand, bronze and black.

### Hinged Insect Screens for Inswing Patio Doors

Charcoal fiberglass screen mesh fits into an aluminum frame in 50 exterior colors. Provided with a black lockable latch and automatic closer for smooth operation. Available in single or multiple door units. Aluminum screen mesh is also available.

# Top-Hung Gliding Insect Screens for Inswing Center Post Patio Doors

Charcoal fiberglass screen mesh fits into an aluminum frame available in 50 exterior colors. Aluminum screen mesh is also available.

# PRIVACY OPTIONS

### Blinds-Between-the-Glass




A %\* aluminum slat blind mounted between two panes of insulated glass in a dust-free environment. Available in white, tan and almond. Blinds are magnetically controlled and can be tilted or raised and lowered with one cord." Not available on arch patio doors.

# GRILLES

# Full Divided Light

11%

Permanent interior and exterior grilles with grille spacer bars between two panes of glass. Available in %\*, %\*, 1 %\*, 1 ½\*, or 2 ¼\* widths and avala or contemporary profile. Ovala profile shown below, not all widths are pictured.

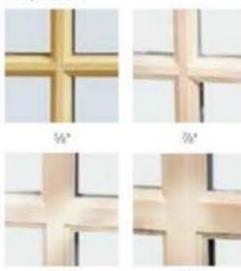

### 11/2\*

# Simulated Divided Light

Permanent exterior and interior grilles without grille spacer bars. Available in %s, %s, 1 %s, 1 %s, and ovelo or contemporary profile. Ovelo profile shown below, not all widths are pictured.



# Finelight" Grilles-Between-the-Glass

Available in <sup>5</sup>/<sub>6</sub>" flat or 1" contoured aluminum profiles. Two-tone colors of pebble tan/colony white, sierra bronze/colony white or forest green/colony white are available on the 1" profile.



Shi" Flat

# 1° Contoured

# **Removable Interior Wood Grilles**

Removable interior wood grilles are available in a 7%" width and avalo or contemporary profiles. Optional surround for removable grille and permanent exterior grilles also available. Ovalo profile shown below.



See page 22 for more information

E-Series Hinged Patio Doors

on grilles.

\*When properly configured and maintained with a professionally installed security system and/or self-monitoring system compatible with Honeywell® 5800 controls. See your Andersen supplier for more information.


\*\*Not all sizes are retractable. See your local Andersen supplier for details.

WINDOWS & DOORS




# **Hinged Outswing Patio Doors**


# **Hinged Outswing Patio Door**

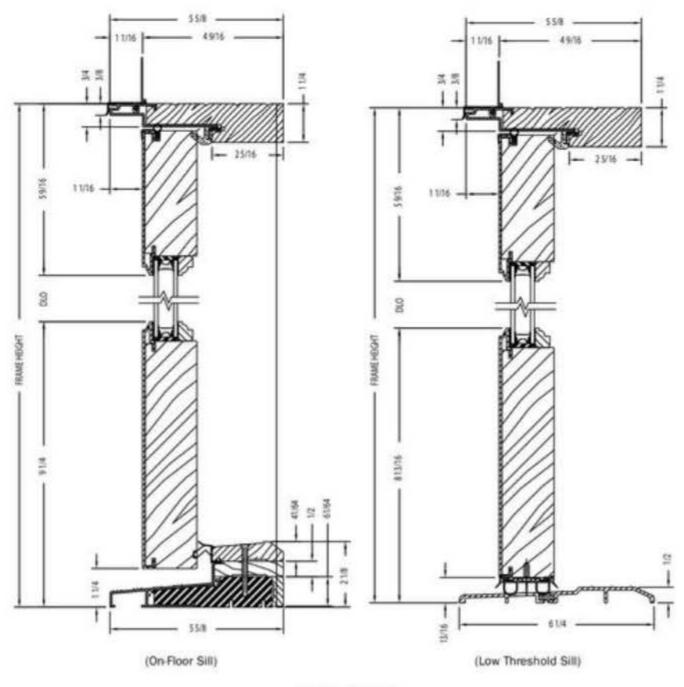


Vertical Section

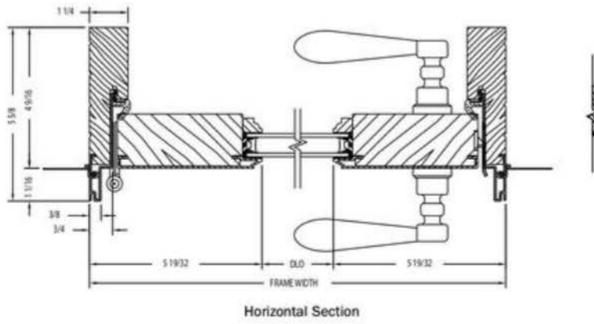




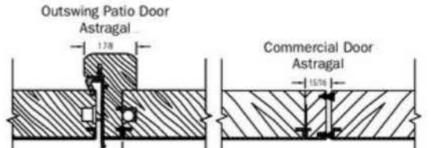

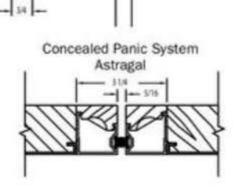

Shown with ovolo (colonial) glass stops. French panel shown, also available with a contemporary panel.

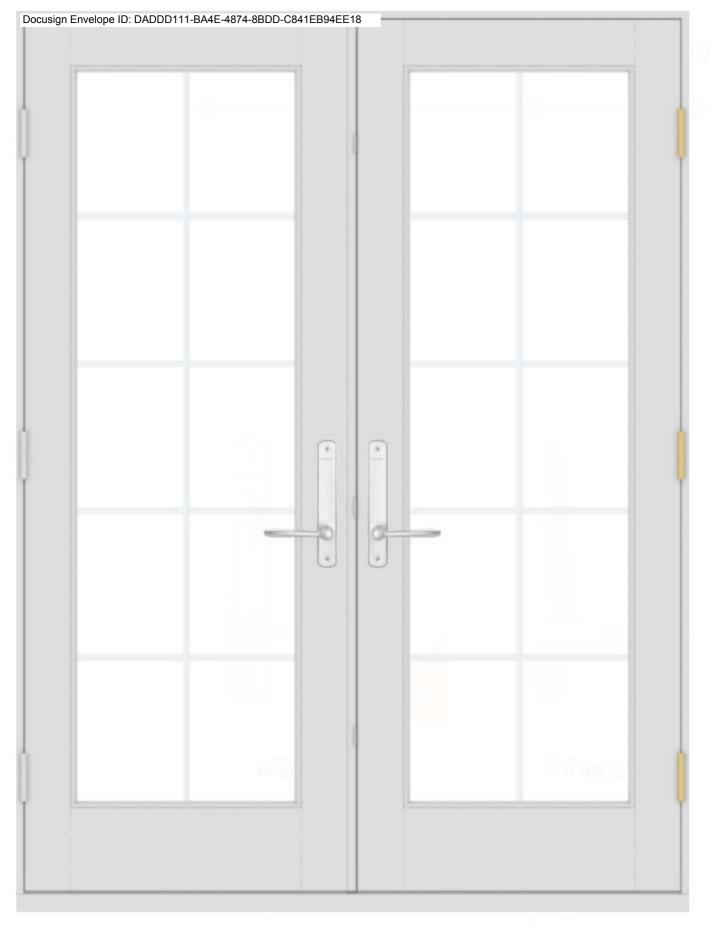

# 2044 CHICAGO BLVD. EXTERIOR RENOVATION

2044 CHICAGO BLVD., DETROIT, MI. 48206

ARCHITECT 4545 ARCHITECTURE | DESIGN, PLLC TIMOTHY FLINTOFF, AIA, NCARB 2761. E JEFFERSON, SUITE 302 DETROIT, MI 48207 248-320-6098

PROJECT DATA

**BUILDING CODE AUTHORITY:** CITY OF DETROIT, MICHIGAN

OWNER: VIVEK CIAL 1624 EDISON ST., DETROIT, MI 48202

APPLICABLE CODES: BUILDING CODE ALSO KNOWN AS THE "MICHIGAN BUILDING CODE" 2021 MICHIGAN BUILDING CODE (MBC) AS AMENDED

MECHANICAL CODE ALSO KNOWN AS THE "MICHIGAN MECHANICAL CODE" 2021 MICHIGAN MECHANICAL CODE AS AMENDED

PLUMBING CODE ALSO KNOWN AS THE "MICHIGAN PLUMBING CODE" 2021 MICHIGAN PLUMBING CODE AS AMENDED

ELECTRICAL CODE ALSO KNOWN AS THE "MICHIGAN ELECTRICAL CODE" 2023 MICHIGAN ELECTRICAL CODE AS AMENDED


ENERGY CODE 2015 UNIFORM ENERGY CODE

BARRIER FREE REQUIREMENTS AMERICANS WITH DISABILITIES ACT (ADA) MBC-2015, CHAPTER 11 ICC / ANSI 117.1 - 2010, EXCEPT SECTION 611 & 707



TS1.1	TITLE SHEET AND SHEE
A1.1	WEST PORCH PLAN
A1.2	EAST PORCH PLAN
A3.1	EXTERIOR ELEVATION
A3.2	EXTERIOR ELEVATION
A3.3	EXTERIOR ELEVATION
A3.4	EXTERIOR ELEVATION
A3.5	EXTERIOR ELEVATIONS
A3.6	EXTERIOR ELEVATIONS
A5.1	WINDOW SCHEDULE

2044 CHICAGO BLVD., DETROIT, MI 48206

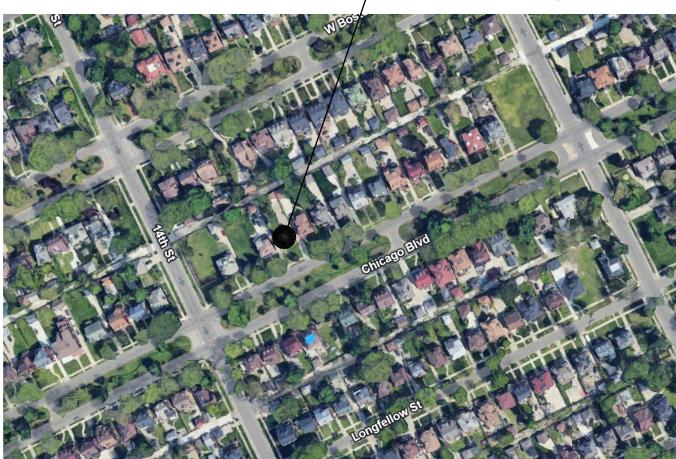



PROJECT SITE MAP: NOT TO SCALE



ET INDEX


- NEW WINDOWS - NEW WINDOWS

A-8 -DETA 12 A-8 / 1" = 1'-0" EL. 8'-0" A.F.F. B./CEILING -**----** 8'-0" **----ROOM NAME** 0000000 В MATCH LINE ✓ REF: A3 —— · · · · · · · · 

> + + + + +

YN	MBOL LEGEND	AB	BREVIATION
	- DARKENED ARROW INDICATES ELEVATED SECTION	@ ACOUST.	AT ACOUSTICAL
	- ELEVATION NUMBER	A.C.T. ADJ.	ACOUSTIC CEILING TILE ADJACENT
	- SHEET NUMBER WHERE ELEVATION IS LOCATED	A.F.F.	ABOVE FINISH FLOOR
		ALUM. ANOD.	ALUMINUM ANODIZED
	- ELEVATION NUMBER	BD. BLDG.	BOARD BUILDING
		BLK. BLKG.	BLOCK BLOCKING
	- SHEET NUMBER WHERE ELEVATION IS LOCATED	CEM.	CEMENT
		C.J. CLG.	CONTROL JOINT CEILING
	- DETAIL REFERENCE NUMBER	ଜ	CENTER LINE
	- SHEET NUMBER WHERE DETAIL IS LOCATED	C.O. COL.	CLEAN OUT COLUMN
		CONC. C.G.	CONCRETE CORNER GUARD
	- DETAIL NUMBER	CONST.	CONSTRUCTION
	- DETAIL NAME	CONT. CORR.	CONTINUOUS CORRUGATED
	- DRAWING SCALE	CPT.	CARPET
	- SHEET NUMBER WHERE DETAIL IS REFERENCED	C.T. DET.	CERAMIC TILE DETAIL
		DIA. DM.	DIAMETER DIMENSION
		DN.	DOWN
		D.O. DR.	DOOR OPENING DOOR
	<ul> <li>REFERENCE POINT OF ELEVATION</li> </ul>	DWG.	DRAWING
		EA.	EACH ELEVATION
	- HEIGHT ABOVE FINISHED FLOOR	E.W.	EACH WAY
	NOTE: DATUM SYMBOL INDICATES A SPECIFIC	EXG. EXIST.	EXISTING EXISTING
	REFERENCE HEIGHT OF MATERIAL INDICATED	EXP.	EXPANSION, EXPOSED
	- ROOM NAME	EXT. F.D.	EXTERIOR FLOOR DRAIN
		FDN.	FOUNDATION
	- ROOM NUMBER	F.R.P. FIN.	FIBER REINFORCED PANE FINISH
		FLR. F.O.	FLOOR FACE OF
		F.O.S.	FACE OF STUD
2		FR. FTG.	FRAME FOOTING
$\geq$	- NUMBERS DESIGNATE VERTICAL COLUMN LINES	FV.	FIELD VERIFY
	LETTERS DESIGNATE HORIZONTAL COLUMN LINES	GA. GALV.	GAUGE GALVANIZED
		GYP.	GYPSUM
	<ul> <li>CIRCLES REPRESENT NEW COLUMN LINES</li> </ul>	HDW. H.M.	HARDWARE HOLLOW METAL
	- DASHED CIRCLES REPRESENT EXISTING COLUMNS	HORIZ. HT.	HORIZONTAL HEIGHT
		I.D.	INSIDE DIAMETER
		INSUL.	INSULATION INTERIOR
		JT.	JOINT
	- EXISTING DOOR SYMBOL	LAV.	LAVATORY LONG
		L.L.O.	LONG LEG OUTSTANDING
		L.L.V. MAX.	LONG LEG VERTICAL MAXIMUM
	- NEW DOOR SYMBOL	MECH.	MECHANICAL
		MET. MEZZ.	METAL MEZZANINE
	- DOOR DESIGNATION	M.I.	MISCELLANEOUS IRON
		MIN. MISC.	MINIMUM MISCELLANEOUS
		M.O. N.I.C.	MASONRY OPENING
		N.T.S.	NOT IN CONTRACT NOT TO SCALE
	<ul> <li>WALL TYPE DESIGNATION NUMBER - COORDINATE WITH SCHEDULE</li> </ul>	0.C. 0.D.	ON CENTER OUTSIDE DIAMETER
		OPNG.	OPENING
	<ul> <li>EQUIPMENT DESIGNATION NUMBER - COORDINATE WITH PLAN NOTES</li> </ul>	OPP. PL.G.	OPPOSITE PLATE GLASS
		PL.S.	PLATE STEEL
	— KEY NOTE DESIGNATION NUMBER - COORDINATE WITH PLAN NOTES	P.LAM PLAS.	PLASTIC LAMINATE PLASTER
		PREFAB.	PREFABRICATED
	- ADDENDUM DESIGNATION NUMBER	PROJ. P.S.F.	PROJECT, PROJECTION POUNDS PER SQUARE FO
		PT.	PAINT, POINT
	- BULLETIN DESIGNATION NUMBER	R. R.A.	RISER RETURN AIR
		R.B.	RUBBER BASE
		R.C. R.C.P.	ROOF CONDUCTOR REFLECTED CEILING PLAN
	- SHEET REFERENCE FOR DRAWING CONTINUATION	R.D. R.F.	ROOF DRAIN RUBBER FLOORING
		REINF.	REINFORCED, REINFORCI
		REQ'D.	REQUIRED ROOFING
ΛA	ATERIAL LEGEND	RM.	ROOM
		– R.S. R.T.	ROOF SUMP RUBBER TILE
		SAN.	SANITARY
Π	ACOUSTICAL CEILING	SCHED. SHT	SCHEDULE SHEET
		SIM.	SIMILAR
$\square$		SPEC. S.S.	SPECIFICATION SERVICE SINK
Х	BATT/LOOSE INSULATION	STL.	STEEL
7		STD. STOR.	STANDARD STORAGE
	BLOCKING/ROUGH LUMBER	STRUCT.	STRUCTURAL
		SUSP. SW.	SUSPENDED SWITCH
·	CONCRETE	SYM.	SYMMETRICAL
		Т. Т&В	TREAD TOP AND BOTTOM
ト	FINISHED WOOD	TEL. TERR.	TELEPHONE
		TERR. T&G	TERRAZZO TONGUE AND GROOVE
	GLASS	THK.	THICK, THICKNESS
		THRES. T.O.S.	THRESHOLD TOP OF STEEL
ँः	GYPSUM WALLBOARD	TYP. U/C	TYPICAL UNDERCUT
		U.N.O.	UNDERCUT
	MACONDY	V.B.	VINYL BASE
$\overline{\mathbf{X}}$	MASONRY	V.C.T. V.I.F.	VINYL COMPOSITION TILE VERIFY IN FIELD
$\bigotimes$		Ŵ	WIDE
•, )			
* + + + + + + + + + + + + + + + + + + +	PARTICLE BOARD	VERT. WAINS	VERTICAL WAINSCOT
		VERT. WAINS. W.C.	WAINSCOT WATER CLOSET
	PARTICLE BOARD PLYWOOD	VERT. WAINS.	WAINSCOT

1	ARCHITECT:
	4545 architecture
	2761 E. JEFFERSON AVE STE 302 DETROIT, MI 48207 P. 313.454.4545
	CONSULTANT:
	Project :
	2044 CHICAGO BLVD. EXTERIOR RENOVATION
	2044 CHICAGO BLVD., DETROIT, MI 48206
	Issued for : HDC SUBMIT 04/16/2025
Û	
itect, PLLC	
ntoff Arch	Drawn by : <b>ANJ</b> THE <sup>Check by :</sup>
mothy Flir	Sheet Title : TITLE SHEET,
©2025 Ti	SHEET INDEX, AND LOCATOR PLAN
DO NOT SCALE DRAWINGS   ©2025 Timothy Flintoff Archit	Project No. : <b>2025018</b>
SCALE D	Sheet No. : <b>TS11</b>
DO NOT	

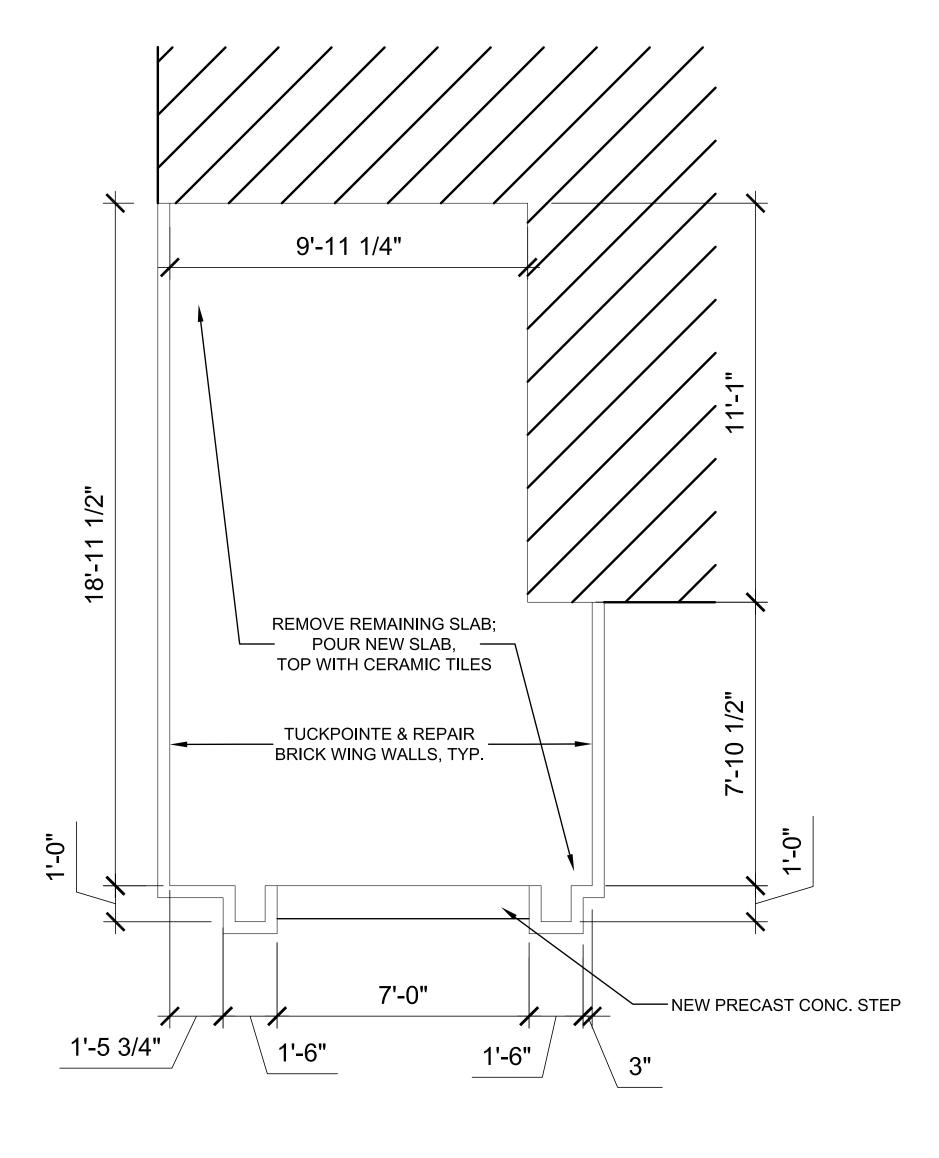

1 WEST FRONT PORCH PLAN SCALE: 3/8"=1'-0"







3 WEST PORCH BRICK WING 1

(4) WEST PORCH BRICK WING 2



# (2) WEST PORCH - EXISTING



5 WEST PORCH STAIR DETAIL

- PREVIOUS TILE PATTERN VISIBLE



6 WEST PORCH SLAB DETAIL






# GENERAL FLOOR PLAN NOTES:

- 1. THIS DRAWING IS DIAGRAMMATIC AND SHOULD BE USED TO DETERMINE THE DESIGN INTENT. THE CONTRACTOR IS RESPONSIBLE FOR THE COMPLETE SET OF WORK AS INDICATED AND SHALL FIELD VERIFY ALL WORK, COORDINATE ALL DRAWINGS / NEW WORK AND SHALL NOTIFY ARCHITECT IMMEDIATELY OF ANY DISCREPANCIES IN THE DOCUMENTS BEFORE PROCEEDING. FAILURE TO DO SO WILL RESULT IN THE CONTRACTOR TAKING FULL RESPONSIBILITY AND LIABILITY FOR SAID DISCREPANCIES.
- ALL DIMENSIONS ARE SHOWN FROM FINISH FACE TO FINISH FACE OF PARTITION UNLESS OTHERWISE NOTED.
- 3. WALL THICKNESS' ARE NOMINAL NOT ACTUAL DIMENSIONS. SEE WALL SCHEDULE FOR ACTUAL DIMENSIONS.
- 4. ALL WORK SHALL BE DONE IN ACCORDANCE WITH ALL LOCAL, STATE, COUNTY CODE REGULATIONS, O.S.H.A., AND THE AMERICAN WITH DISABILITIES ACT (ADA). REFER TO THE CODE PLAN FOR MORE INFORMATION.
- 5. PROVIDE POSITIVE SLOPE TO ALL FLOOR DRAINS WHILE KEEPING FLOOR LEVEL AT WALL BASE CONDITION.




(7) TILE DETAIL FROM INTERIOR PORCH

2761 E. JEFFERSON AVE STE 302 DETROIT, MI 48207 P. 31454.4545 TIM.FLINTOFF@454545ARCHITECTURE.COM CONSULTANT:	AR	CHITECT:
STE 302 DETROIT, MI 48207 P. 313.454.4545 TIM.FLINTOFF #4545ARCHITECTURE.COM CONSULTANT:		<b>4545</b> architecture
Project : Project : 2044 CHICAGO BLVD. EXTERIOR RENOVATION 2044 CHICAGO BLVD. DETROIT, MI 48206 Issued for : HDC SUBMIT 04/16/2025		STE 302
Project : 2044 CHICAGO BLVD. EXTERIOR RENOVATION 2044 CHICAGO BLVD., DETROIT, MI 48206 Issued for : HDC SUBMIT 04/16/2025		P. 313.454.4545 TIM.FLINTOFF@4545ARCHITECTURE.COM
2044 CHICAGO BLVD. EXTERIOR RENOVATION 2044 CHICAGO BLVD., DETROIT, MI 48206		
2044 CHICAGO BLVD. EXTERIOR RENOVATION 2044 CHICAGO BLVD., DETROIT, MI 48206		
2044 CHICAGO BLVD. EXTERIOR RENOVATION 2044 CHICAGO BLVD., DETROIT, MI 48206		Project :
DETROIT, MI 48206		2044 CHICAGO BLVD.
Issued for : HDC SUBMIT 04/16/2025		· · · · · · · · · · · · · · · · · · ·
HDC SUBMIT 04/16/2025		
HDC SUBMIT 04/16/2025		lssued for .
	PLLC	
ANJ Check by : THE Sheet Title : WEST PORCH PLAN Project No. : 2025018 Sheet No. : A J J		Drawn by ·
TRF Title : Sheet Title : WEST PORCH PLAN Project No. : 2025018 Sheet No. :	itoff Arc	ANJ
WEST PORCH PLAN Project No. : 2025018 Sheet No. :		Sheet Title :
Project No. : <b>2025018</b> Sheet No. :		WEST PORCH PLAN
2025018 Sheet No. :	-	Project No. :
Sheet No. :		
		Sheet No. :

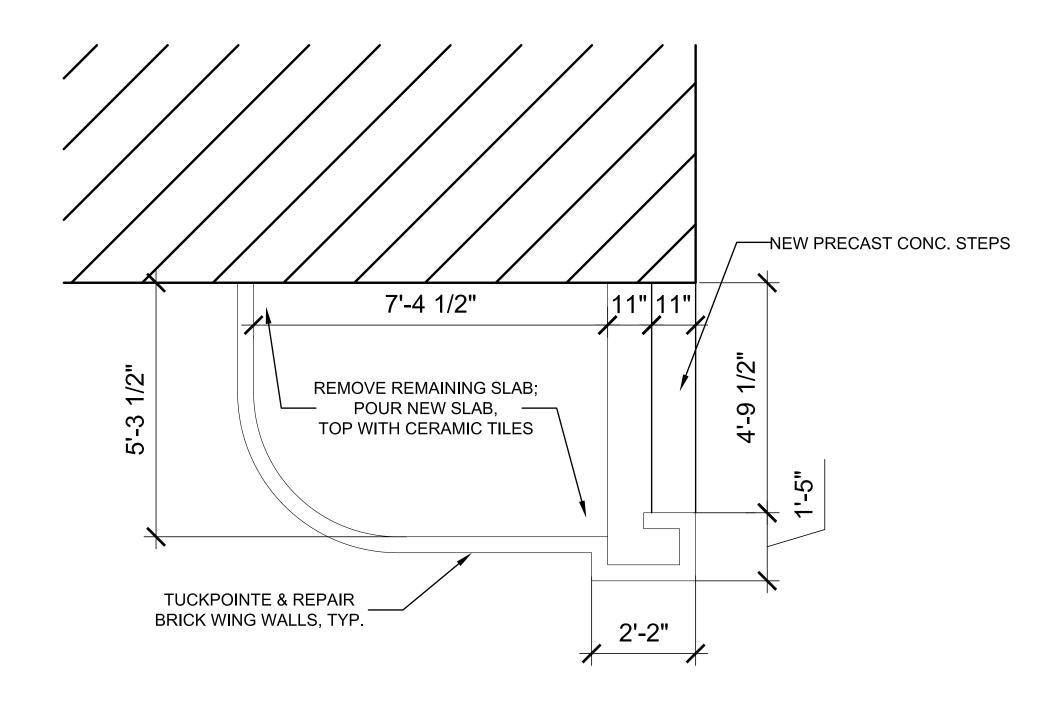



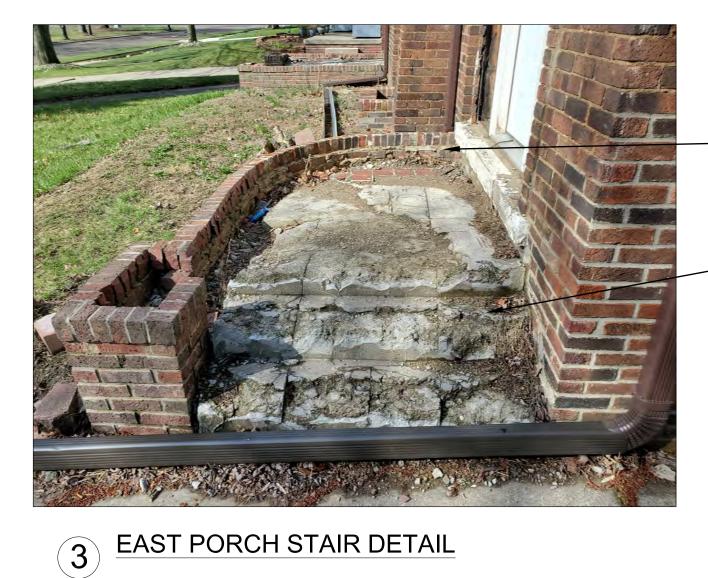



$\bigcirc$	<b>EAST PORCH - EXISTING</b>

- ASSUMED PREVIOUS SLAB TOP LOCATION; POUR NEW SLAB TO MATCH

- REMOVE EXISTING STEPS




4 TILE DETAIL FROM EAST PORCH

# GENERAL FLOOR PLAN NOTES:

- 1. THIS DRAWING IS DIAGRAMMATIC AND SHOULD BE USED TO DETERMINE THE DESIGN INTENT. THE CONTRACTOR IS RESPONSIBLE FOR THE COMPLETE SET OF WORK AS INDICATED AND SHALL FIELD VERIFY ALL WORK, COORDINATE ALL DRAWINGS / NEW WORK AND SHALL NOTIFY ARCHITECT IMMEDIATELY OF ANY DISCREPANCIES IN THE DOCUMENTS BEFORE PROCEEDING. FAILURE TO DO SO WILL RESULT IN THE CONTRACTOR TAKING FULL RESPONSIBILITY AND LIABILITY FOR SAID DISCREPANCIES.
- 2. ALL DIMENSIONS ARE SHOWN FROM FINISH FACE TO FINISH FACE OF PARTITION UNLESS OTHERWISE NOTED.
- WALL THICKNESS' ARE NOMINAL NOT ACTUAL DIMENSIONS. SEE WALL SCHEDULE FOR ACTUAL DIMENSIONS.
- ALL WORK SHALL BE DONE IN ACCORDANCE WITH ALL LOCAL, STATE, COUNTY CODE REGULATIONS, O.S.H.A., AND THE AMERICAN WITH DISABILITIES ACT (ADA). REFER TO THE CODE PLAN FOR MORE INFORMATION.
- 5. PROVIDE POSITIVE SLOPE TO ALL FLOOR DRAINS WHILE KEEPING FLOOR LEVEL AT WALL BASE CONDITION.

- NOTE SLOPING/SAGGING OF PORCH


4545 architecture
STE 302 DETROIT, MI 48207 P. 313.454.4545 TIM.FLINTOFF@4545ARCHITECTURE.CO CONSULTANT: Project : 2044 CHICAGO BLVD. EXTERIOR RENOVATION 2044 CHICAGO BLVD., DETROIT, MI 48206
TIM.FLINTOFF@4545ARCHITECTURE.CO CONSULTANT: Project : 2044 CHICAGO BLVD. EXTERIOR RENOVATION 2044 CHICAGO BLVD., DETROIT, MI 48206
Project : 2044 CHICAGO BLVD. EXTERIOR RENOVATION 2044 CHICAGO BLVD., DETROIT, MI 48206
2044 CHICAGO BLVD. EXTERIOR RENOVATION 2044 CHICAGO BLVD., DETROIT, MI 48206
2044 CHICAGO BLVD. EXTERIOR RENOVATION 2044 CHICAGO BLVD., DETROIT, MI 48206
EXTERIOR RENOVATION 2044 CHICAGO BLVD., DETROIT, MI 48206
DETROIT, MI 48206
Issued for :
Drawn by : <b>ANJ</b>
Check by : TRF
Sheet Title : EAST PORCH PLAN
Project No. : <b>2025018</b>
Sheet No. :
A1.2

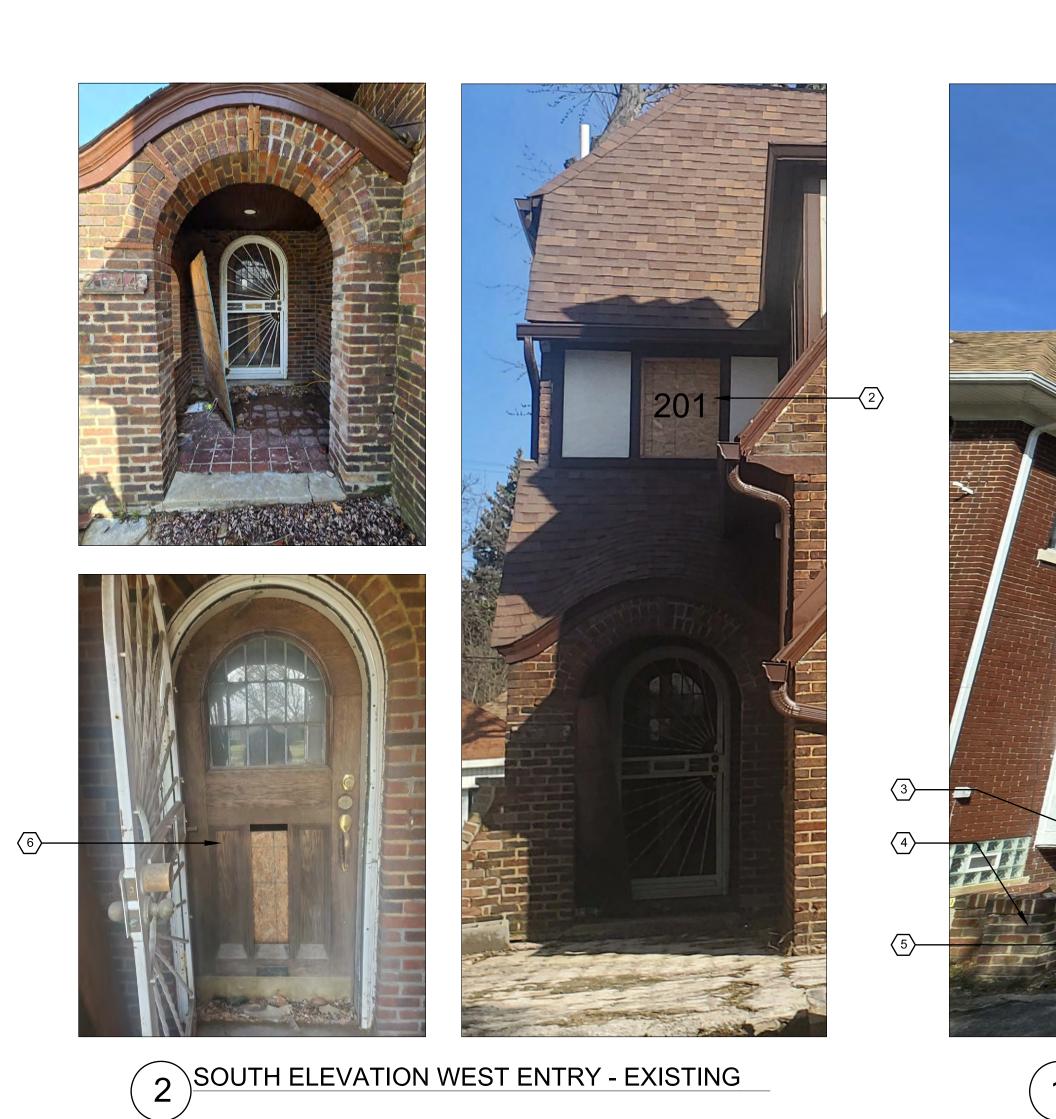







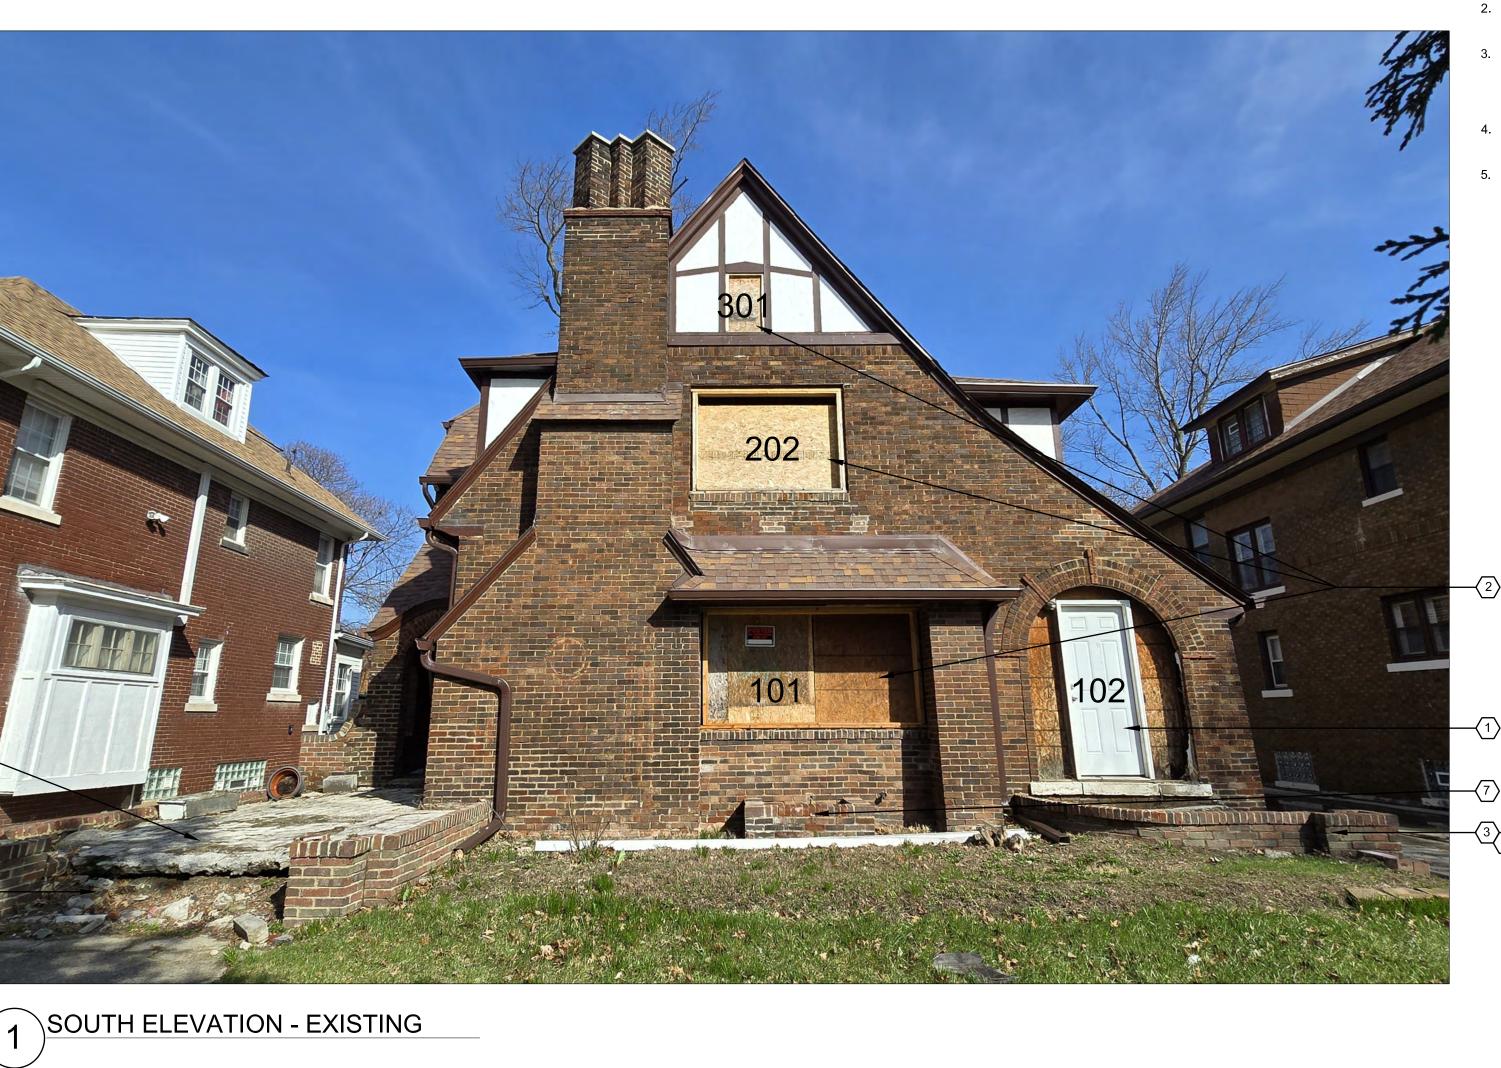

4 HISTORIC DESIGNATION PHOTO, 1974 TAKEN FROM HDC STAFF REPORT





1. THIS DRAWING IS DIAGRAMMATIC AND SHOULD BE USED TO DETERMINE THE DESIGN INTENT. THE CONTRACTOR IS RESPONSIBLE FOR THE COMPLETE SET OF WORK AS INDICATED AND SHALL FIELD VERIFY ALL WORK, COORDINATE ALL DRAWINGS / NEW WORK AND SHALL NOTIFY ARCHITECT IMMEDIATELY OF ANY DISCREPANCIES IN THE DOCUMENTS BEFORE PROCEEDING. FAILURE TO DO SO WILL RESULT IN THE CONTRACTOR TAKING FULL RESPONSIBILITY AND LIABILITY FOR SAID DISCREPANCIES.

ARCHITECT:

CONSULTANT:

4545 architecture

2761 E. JEFFERSON AVE STE 302 DETROIT, MI 48207 P. 313.454.4545 TIM.FLINTOFF@4545ARCHITECTURE.COM

- 2. ALL DIMENSIONS ARE SHOWN FROM FINISH FACE TO FINISH FACE OF PARTITION UNLESS OTHERWISE NOTED.
- ALL WORK SHALL BE DONE IN ACCORDANCE WITH ALL LOCAL, STATE, COUNTY CODE REGULATIONS, O.S.H.A., AND THE AMERICAN WITH DISABILITIES ACT (ADA). REFER TO THE CODE PLAN FOR MORE INFORMATION.
- REFER TO SIDING MANUFACTURER INSTALLATION INSTRUCTIONS AND 4 STANDARD DETAILS
- CONTRACTOR TO VERIFY/COORDINATE CODE REQUIRED WINDOW EGRESS REQUIREMENTS 5.

# ELEVATION KEY NOTES TYPICAL THIS SHEET ONLY

- (1) REPLACE WITH CUSTOM WOOD HALF-LITE DOOR W/ LEADED GLASS SIDE LITES
- 2 REPLACE WITH CUSTOM WOOD WINDOWS W/ LEADED GLASS (SEE WINDOW SCHEDULE)
- 3 REPLACE DAMAGED SLAB, TOP W/ CERAMIC TILES TO MATCH EXISTING
- $\langle 4 \rangle$  TUCKPOINTE & REPAIR BRICK AS REQ'D
- $\left< 5 \right>$  REPLACE MISSING STEPS W/ PRECAST CONC. STEPS
- 6 REPAIR EXISTING DOOR AS REQ'D
- TREPLACE MISSING BASEMENT WINDOW WITH GLASS<br/>BLOCKS, MATCH EXISTING



	Project : 2044 CHICAGO BLVD. EXTERIOR RENOVATION 2044 CHICAGO BLVD., DETROIT, MI 48206
	Issued for : HDC SUBMIT 04/16/2025
DO NOT SCALE DRAWINGS   ©2025 Timothy Flintoff Architect, PLLC	Drawn by : ANJ Check by : Sheet Title : EXTERIOR ELEVATIONS
RAWINGS   ©	Project No. : <b>2025018</b>
DO NOT SCALE D	Sheet No. : A31














-**〈** 4 〉



105

Her.

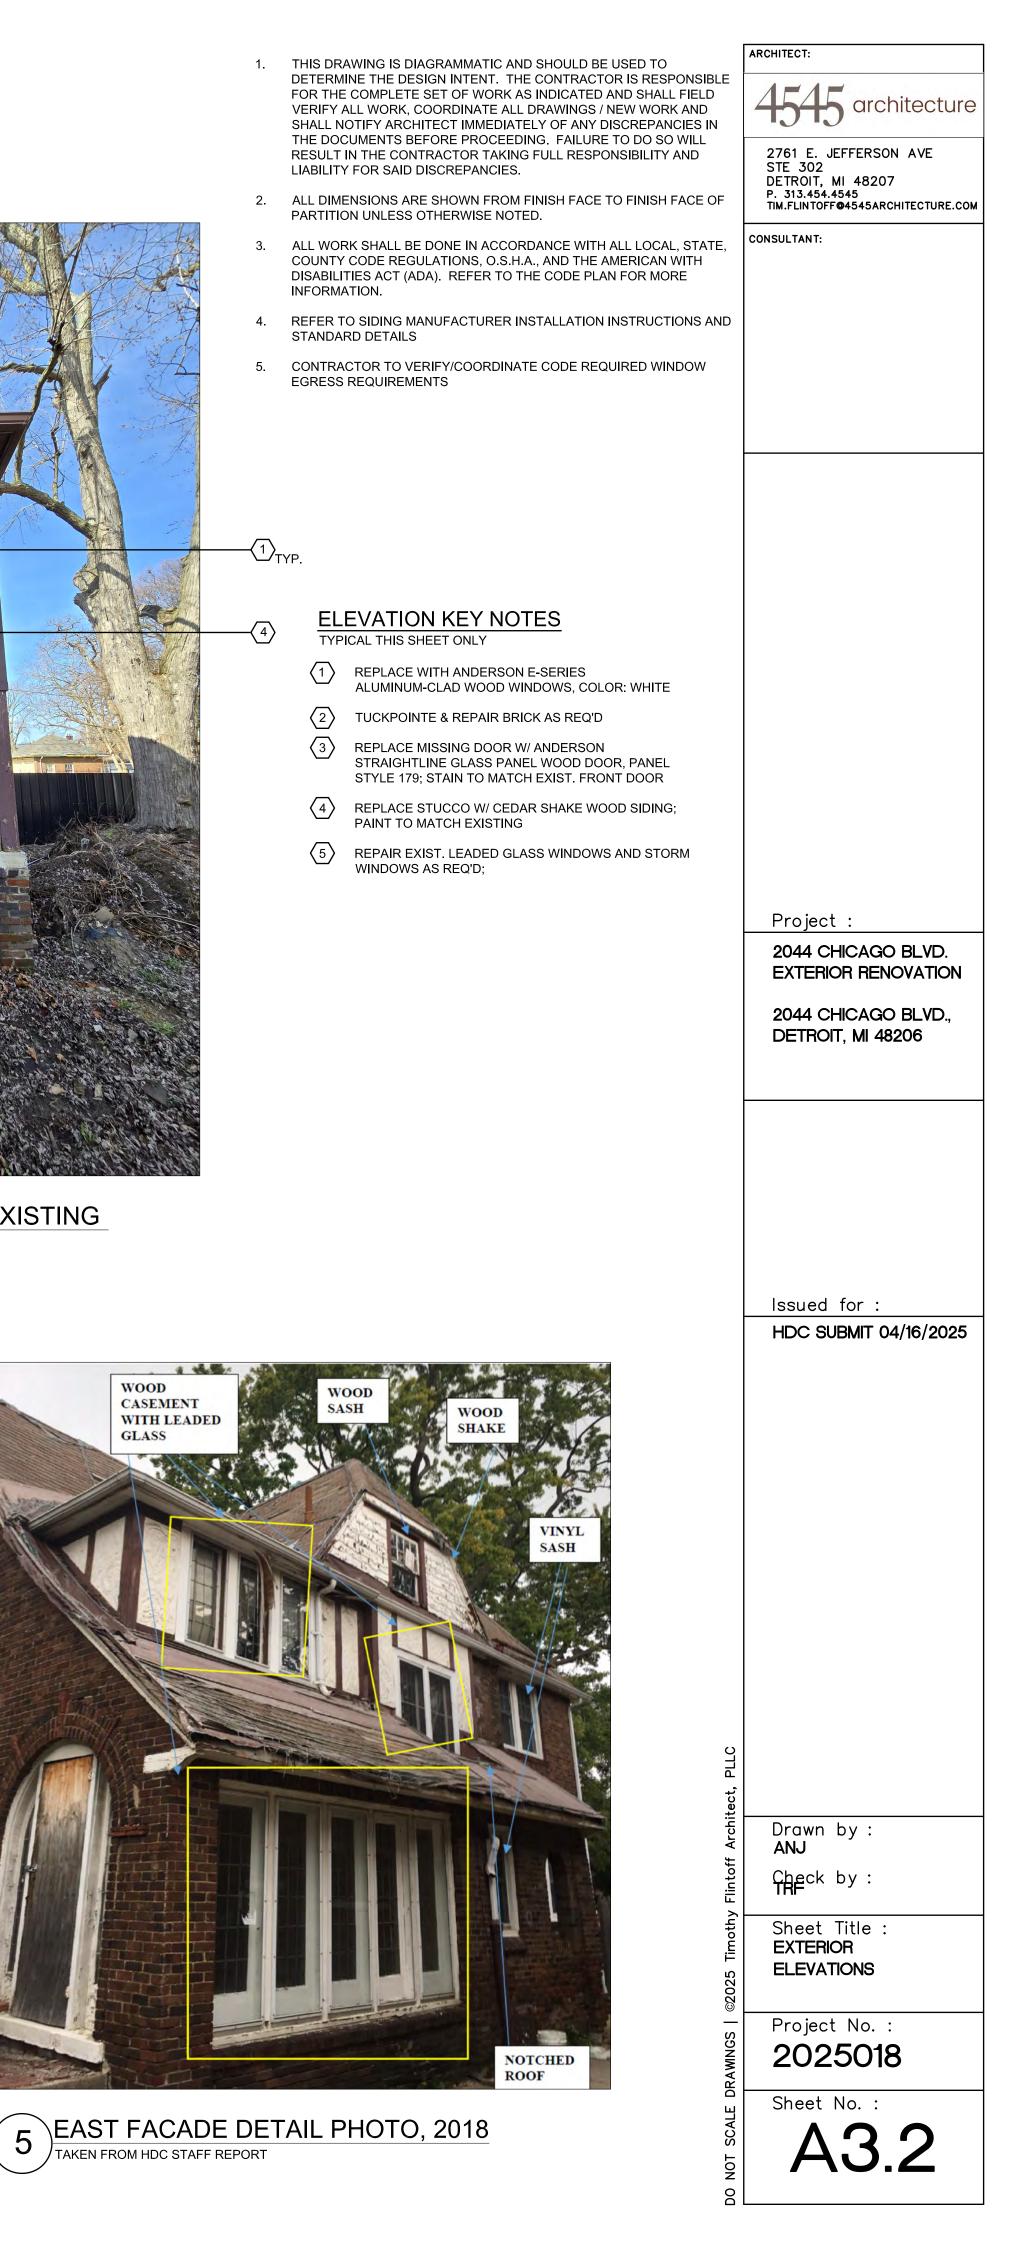


Docusign Envelope ID: DADDD111-BA4E-4874-8BDD-C841EB94EE18







(3)NORTH ELEVATION REAR DOOR - EXISTING

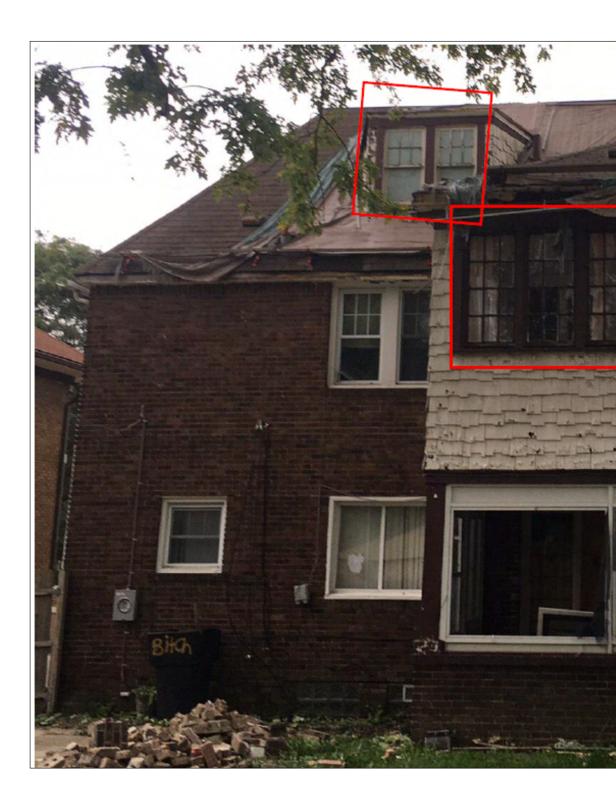



3 NORTH FACADE PHOTO, 2018 TAKEN FROM HDC STAFF REPORT

 $-\langle 2 \rangle$ 

 $\left< \frac{3}{\text{TYP}} \right|$ 

<ol> <li>THIS DRAWING IS DIAGRAMMATIC AND SHOULD BE USED TO DETERMINE THE DESIGN INTENT. THE CONTRACTOR IS RESPONSIBLE FOR THE COMPLETE SET OF WORK AS INDICATED AND SHALL FIELD VERIFY ALL WORK, COORDINATE ALL DRAWINGS / NEW WORK AND SHALL NOTIFY ARCHITECT IMMEDIATELY OF ANY DISCREPANCIES IN THE DOCUMENTS BEFORE PROCEEDING. FAILURE TO DO SO WILL RESULT IN THE CONTRACTOR TAKING FULL RESPONSIBILITY AND LIABILITY FOR SAID DISCREPANCIES.</li> <li>ALL DIMENSIONS ARE SHOWN FROM FINISH FACE TO FINISH FACE OF PARTITION UNLESS OTHERWISE NOTED.</li> <li>ALL WORK SHALL BE DONE IN ACCORDANCE WITH ALL LOCAL, STATE, COUNTY CODE REGULATIONS, O.S.H.A., AND THE AMERICAN WITH DISABILITIES ACT (ADA). REFER TO THE CODE PLAN FOR MORE INFORMATION.</li> <li>REFER TO SIDING MANUFACTURER INSTALLATION INSTRUCTIONS AND STANDARD DETAILS</li> <li>CONTRACTOR TO VERIFY/COORDINATE CODE REQUIRED WINDOW EGRESS REQUIREMENTS</li> </ol>	ARCHITECT: 4545 architecture 2761 E. JEFFERSON AVE STE 302 DETROIT, MI 48207 P. 313.454.4545 TIM.FLINTOFF@4545ARCHITECTURE.COM CONSULTANT:
ELEVATION KEY NOTES         TYPICAL THIS SHEET ONLY         1       REPLACE WITH ANDERSON E-SERIES         ALUMINUM-CLAD WOOD WINDOWS, COLOR: WHITE         (2)       REPLACE WITH ANDERSON E-SERIES         ALUMINUM-CLAD WOOD FRENCH DOOR AND         SIDELITES W/ SIM. DIVIDED LITES         (3)       TUCKPOINTE & REPAIR BRICK AS REQ'D         (4)       REPLACE STUCCO W/ CEDAR SHAKE WOOD SIDING;         PAINT TO MATCH EXISTING	
	Project : 2044 CHICAGO BLVD. EXTERIOR RENOVATION 2044 CHICAGO BLVD., DETROIT, MI 48206
	Issued for : HDC SUBMIT 04/16/2025
<image/>	Drawn by : ANJ Check by : The Sheet Title : EXTERIOR ELEVATIONS Project No. : 2025018 Sheet No. : A333

<sup>1</sup> NORTH ELEVATION - EXISTING
















3 WEST FACADE PHOTO, 2018 TAKEN FROM HDC STAFF REPORT

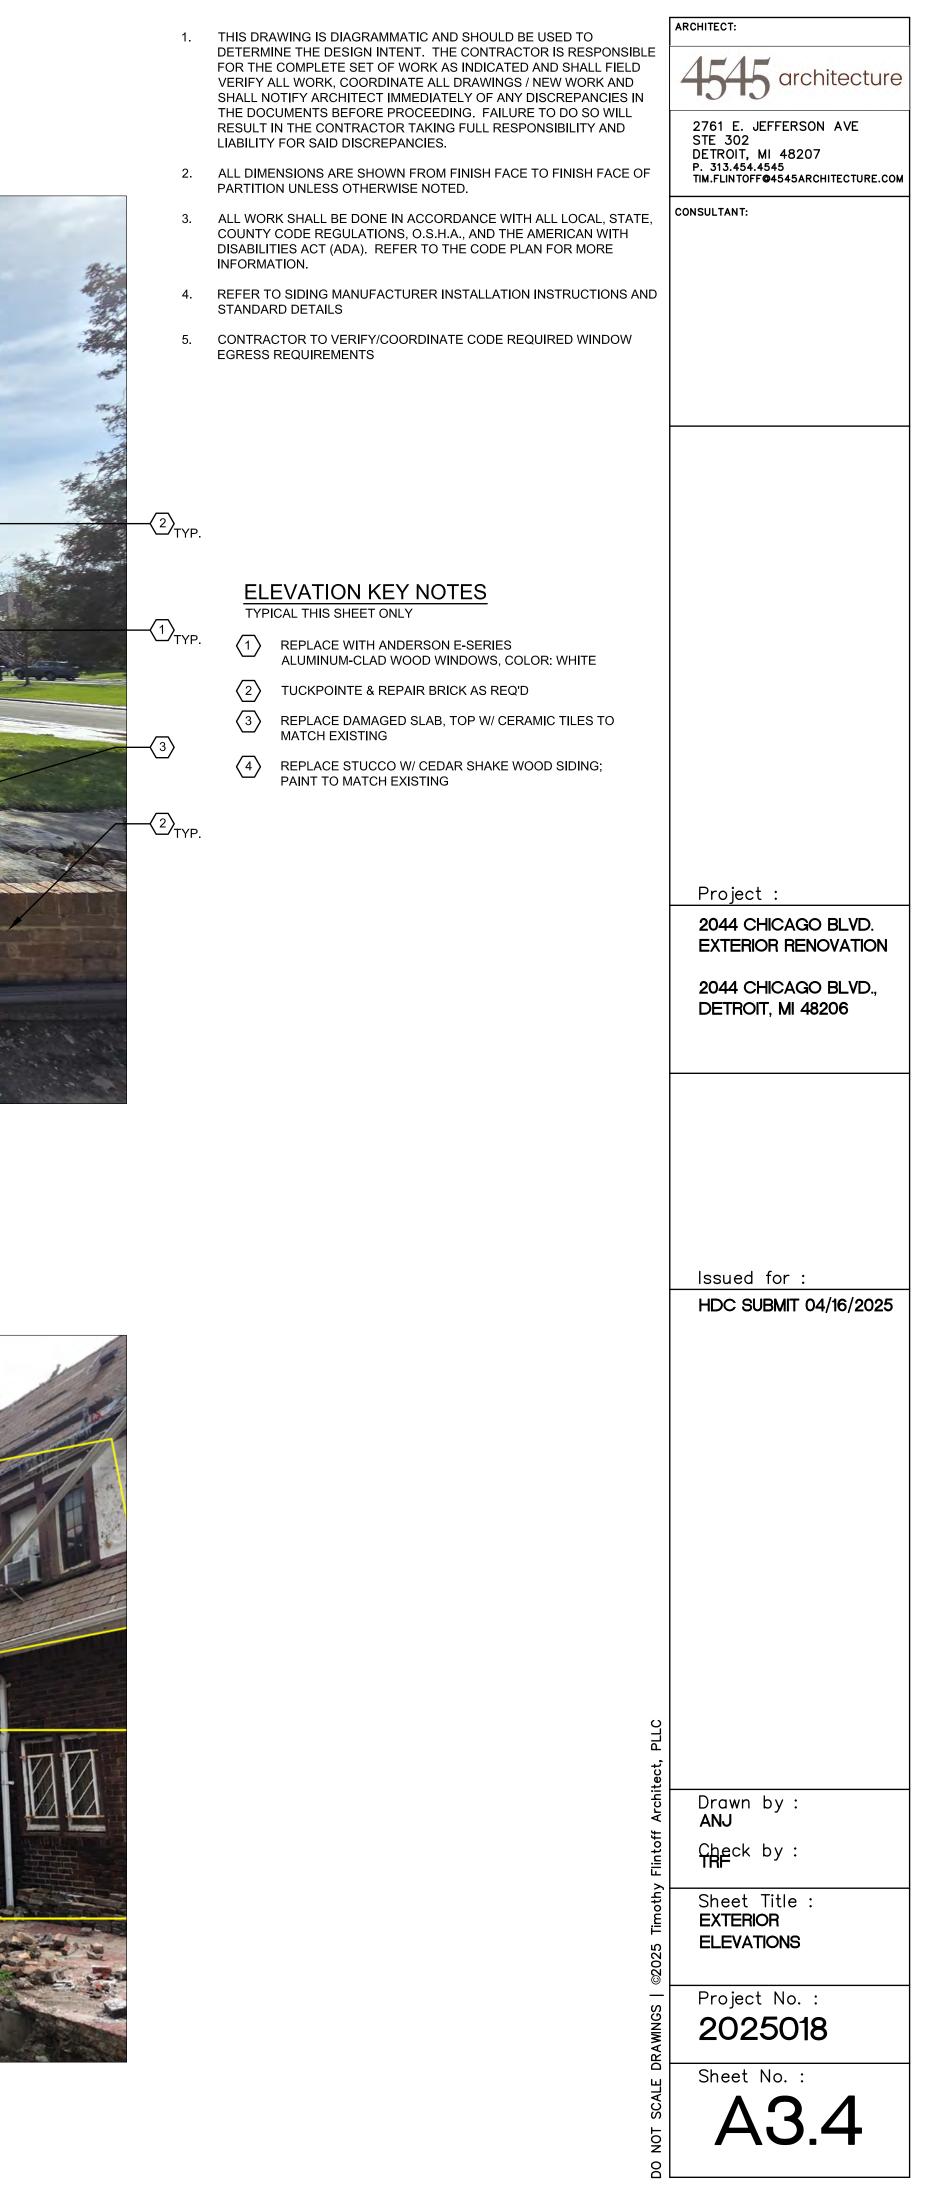





ANDERSON E-SERIES DOUBLE-HUNG WINDOW W/ 6-OVER-1 SIM. DIVIDED — LITES AS SHOWN



2 EAST ELEVATION - NEW WINDOWS




ANDERSON E-SERIES DOUBLE-HUNG — WINDOW W/ 8-OVER-1 SIM. DIVIDED LITES AS SHOWN

ANDERSON E-SERIES DOUBLE-HUNG WINDOW W/ 6-OVER-1 SIM. DIVIDED LITES AS SHOWN

— WOOD 2x, PAINTED TO MATCH EXIST. (TYP.)



1. TH	IS DRAWING IS DIAGRAMMATIC AND SHOULD BE USED TO	ARCHITECT:
DE FO VE SH TH	TERMINE THE DESIGN INTENT. THE CONTRACTOR IS RESPONSIBLE R THE COMPLETE SET OF WORK AS INDICATED AND SHALL FIELD RIFY ALL WORK, COORDINATE ALL DRAWINGS / NEW WORK AND ALL NOTIFY ARCHITECT IMMEDIATELY OF ANY DISCREPANCIES IN E DOCUMENTS BEFORE PROCEEDING. FAILURE TO DO SO WILL	4545 architecture
LIA 2. ALI	SULT IN THE CONTRACTOR TAKING FULL RESPONSIBILITY AND BILITY FOR SAID DISCREPANCIES. L DIMENSIONS ARE SHOWN FROM FINISH FACE TO FINISH FACE OF	2761 E. JEFFERSON AVE STE 302 DETROIT, MI 48207 P. 313.454.4545 TIM.FLINTOFF@4545ARCHITECTURE.COM
3. AL	RTITION UNLESS OTHERWISE NOTED. L WORK SHALL BE DONE IN ACCORDANCE WITH ALL LOCAL, STATE, UNTY CODE REGULATIONS, O.S.H.A., AND THE AMERICAN WITH	CONSULTANT:
DIS INF	SABILITIES ACT (ADA). REFER TO THE CODE PLAN FOR MORE FORMATION.	
ST	FER TO SIDING MANUFACTURER INSTALLATION INSTRUCTIONS AND ANDARD DETAILS NTRACTOR TO VERIFY/COORDINATE CODE REQUIRED WINDOW	
	RESS REQUIREMENTS	
MATCH SHOWN FATTERN		
		Project : 2044 CHICAGO BLVD.
		EXTERIOR RENOVATION
		2044 CHICAGO BLVD., DETROIT, MI 48206
		Issued for :
		HDC SUBMIT 04/16/2025
ANDERSON E-SERIES CASEMENT WINDO W/ SIM. DIVIDED LITES AS SHOWN	9W	
	ن د	
	ect, PLLC	
	f Architect,	Drawn by : <b>ANJ</b>
	y Flintoff Ar	Check by: TRF
	Timothy	Sheet Title : EXTERIOR
	©2025	ELEVATIONS
	SCALE DRAWINGS	Project No. : <b>2025018</b>
	ALE DRA	Sheet No. :
	LON	A3.5
	DO	

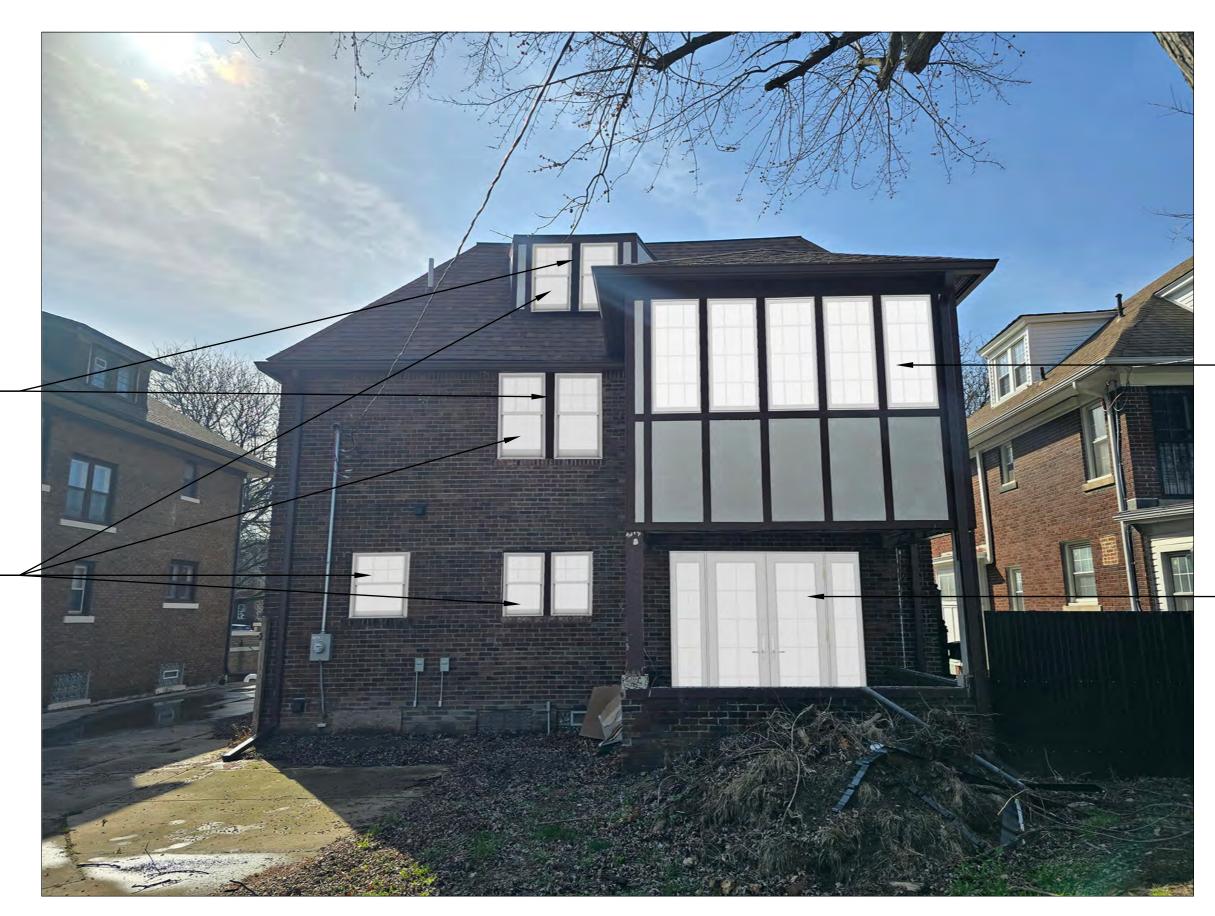

WOOD 2x, PAINTED TO MATCH EXIST. (TYP.)\_\_\_

ANDERSON E-SERIES DOUBLE-HUNG WINDOW W/ 6-OVER-1 SIM. DIVIDED — LITES AS SHOWN

1 NORTH ELEVATION - NEW WINDOWS



ANDERSON E-SERIES DOUBLE-HUNG WINDOW W/ 6-OVER-1 SIM. DIVIDED — LITES AS SHOWN


WOOD 2x, PAINTED TO MATCH EXIST. (TYP.)\_\_\_\_

ANDERSON E-SERIES CASEMENT WINDOW W/ SIM. DIVIDED LITES AS SHOWN -

2 WEST ELEVATION - NEW WINDOWS

\_ ANDERSON E-SERIES CASEMENT WINDOW W/ SIM. DIVIDED LITES AS SHOWN

\_ ANDERSON E-SERIES FRENCH DOOR AND SIDELITES W/ SIM. DIVIDED LITES AS SHOWN

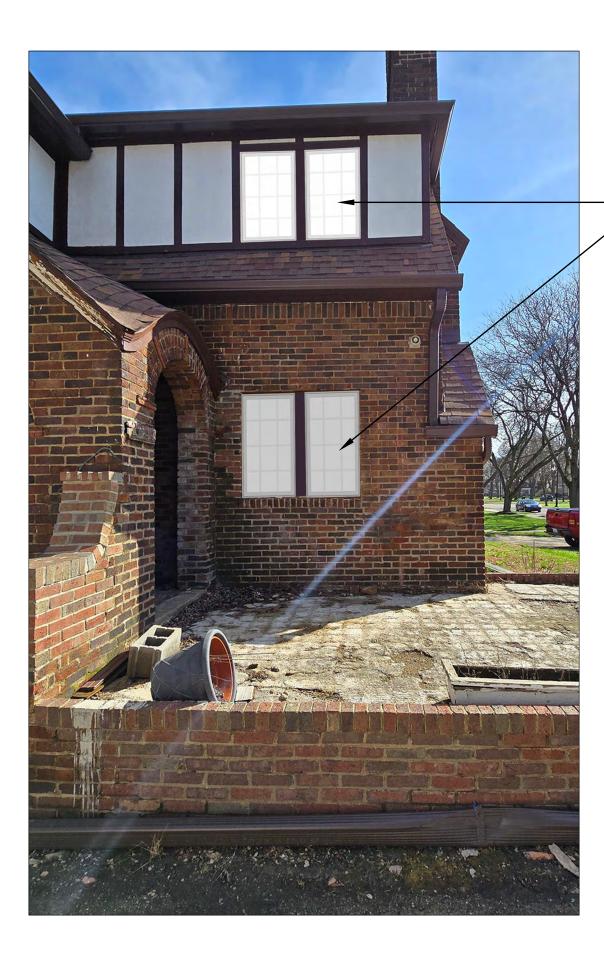

	WING IS DIAGRAMMATIC AND SHOULD BE USED TO	ARCHITECT:
FOR THE VERIFY A SHALL N	NE THE DESIGN INTENT. THE CONTRACTOR IS RESPONSIBLE COMPLETE SET OF WORK AS INDICATED AND SHALL FIELD ALL WORK, COORDINATE ALL DRAWINGS / NEW WORK AND DTIFY ARCHITECT IMMEDIATELY OF ANY DISCREPANCIES IN UMENTS BEFORE PROCEEDING. FAILURE TO DO SO WILL	4545 architecture
	N THE CONTRACTOR TAKING FULL RESPONSIBILITY AND FOR SAID DISCREPANCIES.	2761 E. JEFFERSON AVE STE 302 DETROIT, MI 48207 P. 313.454.4545
PARTITIC 3. ALL WOF	IN UNLESS OTHERWISE NOTED.	TIM.FLINTOFF@4545ARCHITECTURE.COM
DISABILI INFORMA		
STANDAI	O SIDING MANUFACTURER INSTALLATION INSTRUCTIONS AND RD DETAILS CTOR TO VERIFY/COORDINATE CODE REQUIRED WINDOW	
EGRESS	REQUIREMENTS	
		Project :
		2044 CHICAGO BLVD. EXTERIOR RENOVATION
		2044 CHICAGO BLVD., DETROIT, MI 48206
		Issued for :
ANDERSON E-SERIES CASEMENT	WINDOW	HDC SUBMIT 04/16/2025
W/ SIM. DIVIDED LITES AS SHOWN		
	Architect	Drawn by :
	Flintoff Ar	ANJ Check by :
	Tim oth v FI	
	©2025 11	
	© MAMNGS DRAMNAG	
		Sheet No. :
	NOT SCALE	A3.6
		•

	MARK	SIZE	TYPE	COMMENTS
1ST FL.	101	8'-3"x4'-3"	CUSTOM WOOD; DOUBLE HUNG	4 MULLED UNITS; LEADED GLASS
	102	6'-2"x7'-8"	CUSTOM WOOD; ENTRY DOOR	DOOR W/ SIM. DIVIDED LITES; CURVED SIDE LITES W/ LEADED GLASS
	103	12'-3"x6'-7"	EXISTING TO REMAIN	LEADED GLASS W/ STORM WINDOW; REPAIR AS REQ'D
	104	2'-4"x4'-3"	ANDERSON E-SERIES; DOUBLE HUNG	SIM. DIVIDED LITES
	105	5'-3"x3'-2"	ANDERSON E-SERIES; DOUBLE HUNG	2 UNITS; SIM. DIVIDED LITES
	106	3'-0"x3'-3"	ANDERSON E-SERIES; DOUBLE HUNG	SIM. DIVIDED LITES
	107	4'-6"x3'-3"	ANDERSON E-SERIES; DOUBLE HUNG	2 UNITS, SIM. DIVIDED LITES
	108	9'-5"x7'-0"	ANDERSON E-SERIES; FRENCH DOOR	FRENCH DOOR W/ SIM. DIVIDED LITES; SIDE LITES W/ SIM. DIVIDED LITES
	109	6'-7"x3'-9"	ANDERSON E-SERIES; CASEMENT	3 UNITS, SIM. DIVIDED LITES
	110	2'-4"x4'-1"	ANDERSON E-SERIES; CASEMENT	SIM. DIVIDED LITES
	111	4'-6"x4'-1"	ANDERSON E-SERIES; CASEMENT	2 UNITS, SIM. DIVIDED LITES
2ND FL.	201	2'-4"x3'-2"	CUSTOM WOOD; CASEMENT	LEADED GLASS; ARCH TOP
	202	6'-1"x4'-6"	CUSTOM WOOD; DOUBLE HUNG	3 MULLED UNITS' LEADED GLASS
	203	7'-4"x4'-4"	ANDERSON E-SERIES; CASEMENT	3 UNITS, SIM. DIVIDED LITES
	204	5'-0"x3'-0"	ANDERSON E-SERIES; CASEMENT	2 UNITS, SIM. DIVIDED LITES
	205	5'-3"x4'-4"	ANDERSON E-SERIES; DOUBLE HUNG	2 UNITS, SIM. DIVIDED LITES
	206	2'-0"x4'-9"	ANDERSON E-SERIES; CASEMENT	SIM. DIVIDED LITES
	207	2'-0"x4'-9"	ANDERSON E-SERIES; CASEMENT	SIM. DIVIDED LITES
	208	2'-0"x4'-9"	ANDERSON E-SERIES; CASEMENT	SIM. DIVIDED LITES
	209	5'-3"x4'-4"	ANDERSON E-SERIES; DOUBLE HUNG	2 UNITS, SIM. DIVIDED LITES
	210	2'-0"x4'-9"	ANDERSON E-SERIES; CASEMENT	SIM. DIVIDED LITES
	211	2'-0"x4'-9"	ANDERSON E-SERIES; CASEMENT	SIM. DIVIDED LITES
	212	2'-0"x4'-9"	ANDERSON E-SERIES; CASEMENT	SIM. DIVIDED LITES
	213	2'-0"x4'-9"	ANDERSON E-SERIES; CASEMENT	SIM. DIVIDED LITES
	214	2'-0"x4'-9	ANDERSON E-SERIES; CASEMENT	SIM. DIVIDED LITES
	215	2'-0"x4'-9	ANDERSON E-SERIES; CASEMENT	SIM. DIVIDED LITES
	216	2'-0"x4'-9	ANDERSON E-SERIES; CASEMENT	SIM. DIVIDED LITES
	217	2'-0"x4'-9	ANDERSON E-SERIES; CASEMENT	SIM. DIVIDED LITES
	218	5'-7"x4'-4"	ANDERSON E-SERIES; DOUBLE HUNG	2 UNITS, SIM. DIVIDED LITES
	219	4'-8"x3'-8"	ANDERSON E-SERIES; CASEMENT	2 UNITS, SIM. DIVIDED LITES
ATTIC	301	1'-10"x3'-2"	CUSTOM WOOD; CASEMENT	LEADED GLASS
	302	2'-6"x3'-6"	ANDERSON E-SERIES; DOUBLE HUNG	SIM. DIVIDED LITES
	303	5'-0"x4'-0"	ANDERSON E-SERIES; DOUBLE HUNG	2 UNITS, SIM. DIVIDED LITES
	304	7'-0"x3'-0"	ANDERSON E-SERIES; DOUBLE HUNG	3 UNITS, SIM. DIVIDED LITES

4545 architecture         201         202 <t< th=""><th></th><th></th><th>ARCHITECT:</th></t<>			ARCHITECT:
			4545 architecture
			STE 302 DETROIT, MI 48207 P. 313.454.4545
ITES         ITES <t< td=""><td></td><td></td><td></td></t<>			
	6		
Image: State of the state o			
Image: State of the state o			
2044 CHICAGO BLVD. EXTERIOR RENOVATION 2044 CHICAGO BLVD. DETROT, MI 48206 Issued for : HDC SUBMT 04/16/2025 HDC SUBMT 04/16/2025 Crown by : ANU CREck by : Sheet Title : WINDOW SCHEDULE	IIES		
2044 CHICAGO BLVD. EXTERIOR RENOVATION 2044 CHICAGO BLVD. DETROIT, MI 48206 Issued for : HDC SUBMIT 04/16/2025 HDC SUBMIT 04/16/2025 Crown by : ANU Cfigeck by : Sheet Title :: WINDOW SCHEDULE			
2044 CHICAGO BLVD. EXTERIOR RENOVATION 2044 CHICAGO BLVD. DETROT, MI 48206 Issued for : HDC SUBMT 04/16/2025 HDC SUBMT 04/16/2025 Crown by : ANU CREck by : Sheet Title : WINDOW SCHEDULE			
2044 CHICAGO BLVD. EXTERIOR RENOVATION 2044 CHICAGO BLVD. DETROIT, MI 48206 Issued for : HDC SUBMIT 04/16/2025 HDC SUBMIT 04/16/2025 Crown by : ANU Cfigeck by : Sheet Title :: WINDOW SCHEDULE			
2044 CHICAGO BLVD. EXTERIOR RENOVATION 2044 CHICAGO BLVD. DETROT. MI 48208 Issued for : HDC SUBMIT 04/16/2025 HDC SUBMIT 04/16/2025 Crown by : ANU CREAK by : Sheet Title :: WINDOW SCHEDULE			
2044 CHICAGO BLVD. EXTERIOR RENOVATION 2044 CHICAGO BLVD. DETROT, MI 48208 Issued for : HDC SUBMIT 04/16/2025 HDC SUBMIT 04/16/2025 Crown by : ANU CREAK by : Sheet Title :: WINDOW SCHEDULE			
EXTERIOR RENOVATION 2044 CHICAGO ELVD., DETROIT, M 48206  Issued for : HDC SUBMIT 04/16/2025  HDC SUBMIT 04/16/2025  Trown by : ANU Chieck by : Sheet Title : WINDOW SCHEDULE			
DETROIT, MI 48206			EXTERIOR RENOVATION
HDC SUBMIT 04/16/2025			
HDC SUBMIT 04/16/2025			laguad fam.
The second se			
The second se			
The second state       The second state         The second state       Drawn by :         ANJ       Check by :         The second state       Sheet Title :         WINDOW SCHEDULE       Sheet Title :			
The second state       The second state         The second state       Drawn by :         ANJ       Check by :         The second state       Sheet Title :         WINDOW SCHEDULE       Sheet Title :			
The second secon			
The second secon			
The second secon			
The second secon			
The second state       The second state         The second state       Drawn by :         ANJ       Check by :         The second state       Sheet Title :         WINDOW SCHEDULE       Sheet Title :		Q	
©2025		ict, PLL	
©2025		Archite	Drawn by : <b>ANJ</b>
©2025		Flintoff	
		mothy	Sheet Title : WINDOW SCHEDULE
Sheet No. : A5.1			Project No. :
To o o di solutione di solution		DRAWN	
		SCALE	
		O NOT	