Docusign Envelope ID: 121C250E-EAB6-43C1-88CA-B78C23A4CB55



### HISTORIC DISTRICT COMMISSION **APPLICATION FOR WORK APPROVAL**

City of Detroit - Planning & Development Department	APPLICATION ID
2 Woodward Avenue, Suite 808 Detroit, Michigan 48226	HDC2025-00198
PROPERTY INFORMATION	
ADDRESS(ES): 708 Pallister	
HISTORIC DISTRICT: New Center Area	
SCOPE OF WORK: (Check ALL that apply)	
Windows/ Walls/ Painting Roof/Gutters/ P	orch/Deck/Balcony
Demolition Signage Ruilding Addition	ite Improvements andscape, trees, fences, atios, etc.)
BRIEF PROJECT DESCRIPTION: Renovation of unapproved dormer addition and installation of new windows	
APPLICANT IDENTIFICATION	
TYPE OF APPLICANT: Architect/Engineer/Consultant	

A torneou Engineer, conouncant			
NAME: Timothy Flintoff Jr.	COMPANY NAME: 4545 Architecture		
ADDRESS: 2761 E. Jefferson Ave, Ste 302	CITY: Detroit	STATE: MI	<b>ZIP:</b> 48207
<b>PHONE:</b> +1 (313) 450-4545	EMAIL: tim.flintoff@4545architecture.com		

### I AGREE TO AND AFFIRM THE FOLLOWING:

I understand that the failure to upload all required documentation may result in extended review times for my project and/or a denied application.

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Х

X

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I understand that the review of this application by the Historic District Commission does not waive my responsibility to comply with any other applicable ordinances including obtaining appropriate permits (building, sign, etc.) or other department approvals prior to beginning the work.

I hereby certify that the information on this application is true and correct. I certify that the proposed work is authorized by the owner of record and I have been authorized to make this application as the property owner(s) authorized agent.

DocuSigned by:	Timothy Flintoff Jr.
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2 Th	<i>{</i> ] <i>D</i>

SIGNATURE

2761 E. Jefferson Ave, Ste 302

4545 Architecture

04/21/2025

DATE

MI 48207

+1 (313) 450-4545

Detroit

tim.flintoff@4545architecture.com

Questions? Contact us at hdc@detroitmi.gov or (313)224-1762

NOTE: Based on the scope of work, additional documentation may be required. See <a href="http://www.detroitmi.gov/hdc">www.detroitmi.gov/hdc</a> for scope-specific requirements.

### **PROJECT DETAILS – TELL US ABOUT YOUR PROJECT**

Instructions: Add project details using the text box in each section. If your details exceed the space provided, attach the details via the attachment icon for that section.

### **ePLANS PERMIT NUMBER:**

(only applicable if you've already applied for permits through ePLANS)

N/A

### GENERAL

1.	DESCRIPTION OF EXISTING CONDITION	
	Please tell us about the current appearance and conditions of the areas you want to change. You may use a few sentences or attach a separate prepared document on the right. (For example, "existing roof on my garage is covered in gray asphalt shingle is near sentitive.")	es
	in poor condition.")	
2.	PHOTOGRAPHS	
	Help us understand your project. Please attach photographs of all areas where work is proposed.	
3.	DESCRIPTION OF PROJECT	
0.	In this box, tell us about what you want to do at the areas described above in box #1. (For example, Install new asphalt shingle roofing at garage.)	9
		Γ
		1
4.	DETAILED SCOPE OF WORK	
	In this box, please describe all steps necessary to complete the work described in box #3. (For example, "remove existing shingles, replace wood deck as necessary, replace wood eaves, install roof vents, replace rotted fascia boards, paint, clean	
	worksite.")	
		Γ
_		
5.	BROCHURES/CUT SHEETS	

Please provide information on the products or materials you are proposing to install. For example, a brochure on the brand and color of the shingles proposed.

|--|

### ADDITIONAL DETAILS

### 6. WINDOWS/DOORS

Detailed photographs of window(s) and/or door(s) proposed for replacement showing the condition of the interior and exterior of the window(s) and/or door(s)

### 9. OTHER

Please provide any additional details. HDC Staff may ask you to submit additional information at a later time depending on your project.



April 21, 2024

708 Pallister St., Detroit, MI 48202

RE: 708 Pallister Exterior Renovations, Historic District Commission Submission

Photos taken November 2024




Front (South) Elevation



Rear (North) Elevation



Side (East) Elevation

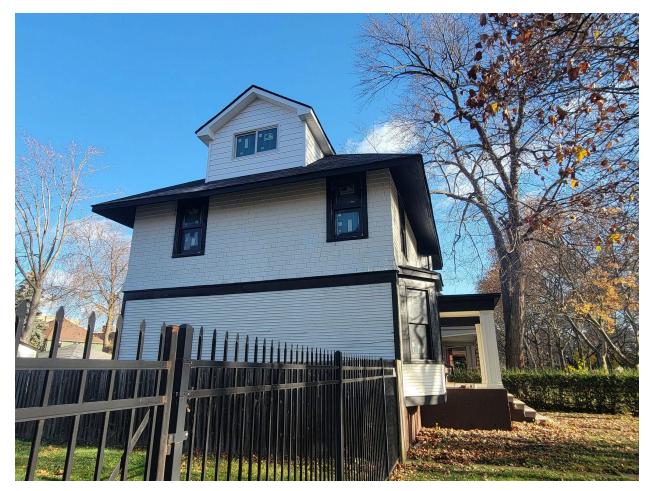

Side (West) Elevation



East elevation window with incorrect trim



Typical correct window trim



Garage Front (South) Elevation





Garage Side (West) Elevation





Garage Alley (North) Elevation



April 21, 2024

708 Pallister St., Detroit, MI 48202

RE: 708 Pallister Exterior Renovations, Historic District Commission Submission

Photos taken January 2024



Front (South) Elevation





Rear (North) Elevation



Side (East) Elevation



Side (West) Elevation



Front Bay Window Detail



Front Window Detail



Typical Window Detail



Front Porch Soffit Detail



Typ. Damage to Front Porch





Front Porch Stair Detail



Front Dormer Detail





Rear Soffit Detail



Basement Door Detail



Rear Deck Details





Garage Front (South) Elevation





Garage Side (West) Elevation





Garage Alley (North) Elevation







House and Garage Roof



April 21, 2025

708 Pallister St., Detroit, MI 48202

RE: 708 Pallister Exterior Renovations

### Project Narrative

708 Pallister is a single family home in the New Center Area historic district. It is located in the middle of the pedestrian-only block of Pallister St., between 3rd Ave. and Bethune Ct. The structure is two stories, with a traditional hip roof and covered porch entry, and an existing street-facing dormer; three new construction dormers have been added in the last year. It features painted horizontal wood siding on the first floor exterior, with painted wood shake above, on traditional wood framing. The street-facing south elevation also features a bay window on the first floor, adjacent to the existing covered porch. The structure is approximately 1557 GSF, plus an attic and basement. The property also has a detached, single-story 2 car garage that is approximately 500 GSF.

The existing front porch has had a painted brick veneer installed to match the existing foundation wall of the house, as well as a new street-facing masonry stair; the existing east-facing stair has been replaced. Two wrapped and painted wood posts have been installed, with plans to install a matching third post, in order to support the existing porch roof. Hip roofs previously built on two of the three new dormers will be removed and replaced with gable roofs to better align with the design of the existing street-facing dormer; they are to be rebuilt to have 6" overhangs and a less steep slope on all sides in order to create individual dormers, rather than the current appearance of a second connected roof. Fascia and eave elements are to be painted wood, matching the existing color choices. The installed sliding windows on the new dormers are to be removed and replaced with vinyl-clad wood casement style windows (Anderson 400 series) with simulated divided lites. A new casement window of the same style will be installed at the east dormer, which currently has no windows present. All dormers, including the original street-facing dormer, have had composite siding installed; this is to be removed and replaced with a wood shake siding, and painted to match the rest of the house (HDC approved C:4 "Yellowish White" with black wood trim).

A new window has been installed at the east elevation first floor. The installed inset composite trim is to

be removed and replaced with a wood trim which sits atop the siding, similar to the trim of the original windows, with trim member sizing also to match. Further, this new window's inset trim has extended into an existing horizontal 'belt band' which visually separates the first and second stories. The 'belt band' is to be removed and replaced with a painted wood member in the same style that was previously present, extending the width of the elevation and the top of the new window.

At the east elevation second floor and the north elevation first floor, installed sliding windows will be removed and replaced Anderson 400 series casement windows with simulated divided lites in the style of the original windows, and painted black. Two glass block windows at the east elevation will be removed and reset in the same plane as the original basement windows, with appropriate window screens installed in front.

The installed patio door at the rear of the house will be removed and replaced with an aluminum-clad wood french door (Anderson E-series) with a 2-over-1 fractional divided lite configuration. All newly installed windows will have simulated divided lites installed to match the visual style of the previously present windows (see architectural drawings for specific configurations). <u>All newly installed front-facing windows are to be replaced with aluminum-clad wood double-hung cottage style window units, painted black (Anderson E-Series) with simulated divided lites to match original window lite patterns. The rear deck will have Trex composite decking and railing installed in order to be visually/materially distinct from the original house, while the front porch will have wood railing installed.</u>

A heating/cooling unit was installed at the west elevation, along with an electric meter, in the approximately 4'-0" space between the house and existing fence. It is the project's intention to keep this here, as it is less visually present than elsewhere around the house.



April 21, 2025

708 Pallister St., Detroit, MI 48202

RE: 708 Pallister Exterior Renovations

### Scope of Work

- 1. Demolish (2) new construction dormer roofs (east and west dormers)
- 2. <u>Rebuild (2) dormer roofs as hipped roofs with 6 inch overhang</u>
  - a. Lower eave by approximately 6 inches to align with existing dormer eaves
  - b. <u>Eaves to be sloped to create individual dormer appearance (as opposed to one "roof"</u> <u>element) (approximately 6:12 slope)</u>
  - c. Eaves and fascia to be wood, painted (to match existing)
- 3. (2) installed sliding windows in new dormers to be replaced with 8-lite, simulated divided lite vinyl-clad wood casement window units, painted black (Anderson 400 series) (style to match existing dormer)
- 4. <u>Install 8-lite, simulated divided lite vinyl-clad wood casement window unit unit (Anderson 400 series) (style to match existing dormer) in east side dormer; paint window black</u>
  - a. Drywall interior face of window
- 5. Remove composite shake siding from all dormers
- 6. Install wood shake siding and trim at all dormers; paint HDC approved color C:4 "Yellowish White" with Black trim
- 7. At new east elevation forward ground floor window, remove installed inset trim; replace with wood trim atop/pronounced from siding, to match existing window trim; trim size (WxD) to match existing
  - At new east elevation forward ground floor window, remove 'belt band' wood trim above window as required (where window extends into band), replace with continuous trim piece to match previously existing style; paint black
- Replace east elevation second floor sliding window with 6-lite, simulated divided lite vinyl-clad wood awning window unit, painted black (Anderson 400 series); lite style to match previously existing window


- Remaining 1st and 2nd floor windows have been replaced with vinyl-clad wood double hung window units, painted black (Anderson 400 series); simulated divided lites are to be added to replicate original window lite patterns
  - a. <u>Front-facing windows to be replaced with aluminum-clad wood double-hung cottage</u> style window units, painted black (Anderson E-Series) with simulated divided lites to <u>match original window lite patterns</u>
- 10. At east elevation, remove and reset (2) basement glass block windows
  - a. Glass block to be set in same plane as previously existing basement windows
  - b. Install window screen over each window, to match previously existing
- 11. Replace rear elevation ground floor sliding window with 12-lite, simulated divided lite vinyl-clad wood double-hung window unit, painted black (Anderson 400 series) (to match previously existing window)
- 12. Replace installed french door at rear elevation with aluminum-clad wood french door with 2/1 simulated divided lite pattern, painted black (to match previously existing windows at same location) (Anderson E series)
- 13. Install 3rd wood column at front porch, paint to match others already installed
- 14. Install 36" wood railing at front porch
- 15. Install "Trex Transcend Series" composite deck boards and 36" railing at rear deck
- 16. Install simulated divided lites into newly installed windows, lite style to match previously existing windows (see architectural drawings)
- 17. HVAC unit installed at west elevation: intended to remain
- 18. Brick veneer installed at front porch, painted to match existing: intended to remain


# Trex Transcend®



## PREMIUM HIGH-PERFORMANCE DECKING & FASCIA

Trex Transcend<sup>®</sup> decking and Trex<sup>®</sup> Fascia are wood thermoplastic composite lumber (WTCL) boards with an integrated shell that covers the boards on the top surface and sides. The integrated shell consists of a proprietary surface formulation that produces a natural, wood-like grain pattern finish. An alternative to naturally durable hardwood lumber, Transcend Decking and Fascia are ICC-ES SAVE-certified to be a minimum of 95.4% recycled content by weight.

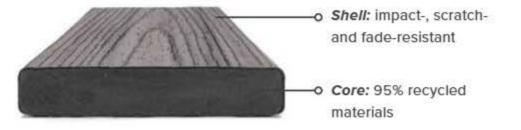

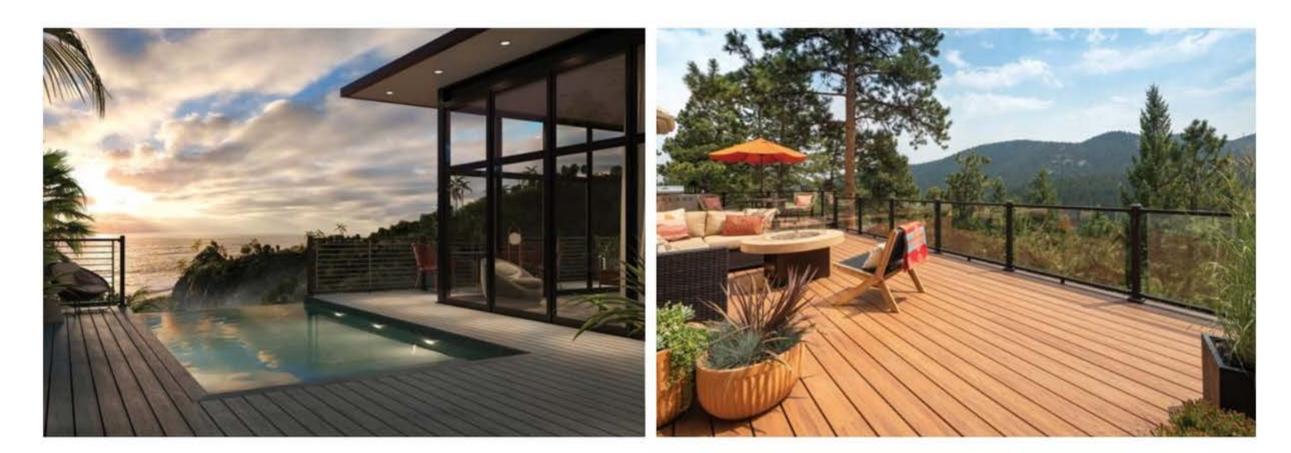



	DECKING BOARDS		FASCIA BOARDS	
FEATURES	1" x 6"	2" x 6"	8"	12"
Actual Dimensions - Standard	.94" x 5.5"	1.3" x 5.5"	.56" x 7.25"	.56" x 11.375"
Actual Dimensions - Metric	24 mm x 140 mm	33 mm x 140 mm	14 mm x 184 mm	14 mm x 288 mm
Available Lengths - Standard	12', 16', 20'	12', 16', 20'	12'	12'
Available Lengths - Metric	365 cm, 487 cm, 609 cm	365 cm, 487 cm, 609 cm	365 cm	365 cm
Grooved Edge	x			
Square Edge	x	X	х	×
Transcend Lineage*	X		х	x
Transcend Tropicals	X	Х	Х	X
Transcend Earth Tones	X		Х	х
Weight per Lineal Foot	2.4 lbs	3.6 lbs	2.0 lbs	3.3 lbs

\*Transcend® Lineage™ square edge profiles are not available in 12' lengths





### **PHYSICAL & MECHANICAL PROPERTIES**

TEST	TEST METHOD	VALUE
Flame Spread	ASTM E 84	Class B
Thermal Expansion	ASTM D 1037	1.9 × 10 <sup>-₅</sup> in/in/°F
Moisture Absorption	ASTM D 1037	< 1%
Screw Head Pull-Through	ASTM D1761	161 lbf/screw*
Fungus Resistance	ASTM D1413	Rating – no decay
Termite Resistance	AWPAE1-72	Rating = 9.6

\*Fastener used in testing: #8 x 2.5" approved Stainless Steel Screw

### COLORS

Lineage (neutral multi-tonal)



Tropicals (vibrant multi-tonal)

Lava Rock



Earth Tones (monochromatic)



### FASTENERS



### Trex Hideaway® Hidden Fastening System

Self-gapping, glass-filled nylon fastener with 304 grade stainless steel, sharp point screw for wood framing.



Other approved fasteners include, color-matched composite deck screw, matching composite plug with composite screw, color-coordinated fascia screw and uncoated stainless steel fascia screw.

For a full list of approved fasteners, download our Installation Guide at trex.com/literature

### Ĺ R D

### **HYDRA**

DESCRIPTION: Paver TEXTURE: Smooth

Pallet Overview	

Specifications pe	r pallet	Imperial	Metric
2	Product dimension $(L \times W \times H)$	11 ${}^{13}\!$	300×200×100
	Cubing	62 ft <sup>2</sup>	5.76 m <sup>2</sup>
96 units / pallet	Approx. Weight	2 811 lbs	1 275 kg
	Number of rows	8	
	Coverage per row	7.75 ft <sup>2</sup>	0.72 m <sup>2</sup>
	Lin. coverage per row	11.80 lin. ft	3.60 lin. m



Laying Patterns Options

### 01 | Linear

┝┰┸┯┘		┯┸┯┸┪
	ЦЦ	

Patterns are for design inspiration only. The installer is responsible to calculate & purchase the correct amount of material.

#### NOTES

See page 6 for icons description.

See page 19 for more information about applications.

See page 20 and 97 for more technical information.

JOINT WIDTH: 1/2" (13 mm) % OF SURFACE OPENING: 8.3 % INFILTRATION RATE: 605 in./hr (15 345 mm/hr)

#### **CHARACTERISTICS**

- Clamp or Mechanical tool available for machine installation. Check with your local Techo-Bloc representative for more information.
- 6000 to 8000 sq. ft can be installed per day with mechanical installation and a team of 5 persons
- · LEED® Projects.
- · Reduces stormwater runoff to municipal sewers.
- Eliminates the need for retention basins and optimizes the use of land.

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Pallet Overview

### VILLAGIO

DESCRIPTION: Paver TEXTURE: Beveled

	Beveled
	Beveled
H	Beveled
	Beveled
T	Beveled
<b>P</b>	Beveled

Merlot

Chocolate Brown

Chestnut Brown

Sandlewood

Champlain Grey

Shale Grey

Beveled Onyx Black

Specifications per pallet		Imperial	Metric
A	Product dimension $(L \times W \times H)$	5 1/8 × 5 1/8 × 2 3/8	130×130×60
	Product dimension (L×W×H)	6 <sup>5</sup> / <sub>16</sub> × 5 <sup>1</sup> / <sub>8</sub> × 2 <sup>3</sup> / <sub>8</sub>	160×130×60
77 units / pallet	Product dimension (L×W×H)	7 <sup>5</sup> ⁄ <sub>16</sub> × 5 <sup>1</sup> ⁄ <sub>8</sub> × 2 <sup>3</sup> ⁄ <sub>8</sub>	185×130×60
B	Product dimension (L×W×H)	8 1⁄16 × 5 1⁄8 × 2 3⁄8	215×130×60
	Cubing	117 ft <sup>2</sup>	10.88 m <sup>2</sup>
77 units / pallet	Approx. Weight	2 960 lbs	1 342 kg
C	Number of rows	11	
	Coverage per row	10.64 ft <sup>2</sup>	0.99 m <sup>2</sup>
154 units / pallet	Lin. coverage per row	24.94 lin. ft	7.61 lin. m
D			


### Laying Patterns Options

154 units / pallet

### 01 | Linear 02 | Herringbone

03 | Herringbone

04 | Herringbone

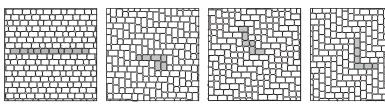

Patterns are for design inspiration only. The installer is responsible to calculate & purchase the correct amount of material.

### NOTES

See page 6 for icons description.

See page 19 for more information about applications.

See page 56 to 58 for more technical information. When used in a permeable pavement application, see page 93 to 97 for more technical information. JOINT WIDTH: %" to %" (9 to 15 mm) % OF SURFACE OPENING: 8.0 % INFILTRATION RATE: 896 in./hr (22 750 mm/hr)

The Villagio paver allows for gentle curves and winding pathways, eliminating the need for cuts.

91

## **Trex**Transcend<sup>®</sup>



RAIL KITS



Rail & Square Composite Baluster Kit



Rail & Round Aluminum Baluster Kit



Cocktail Rail & Round Aluminum Baluster Kit

COMPONENT	RAIL & SQUARE COMPOSITE BALUSTER KIT	RAIL & ROUND ALUMINUM BALUSTER KIT	COCKTAIL RAIL & ROUND ALUMINUM BALUSTER KIT*
Top Rail	Crown	Crown	Universal
Bottom Rail	Universal	Universal	Universal
Heights	36" (914 mm) 42" (106 cm)	36" (914 mm) 42" (106 cm)	36" (914 mm)
Lengths	67.5" (171 cm) 91.5" (232 cm)	67.5" (171 cm) 91.5" (232 cm)	67.5" (171 cm) 91.5" (232 cm)
Applications	Horizontal, Stair	Horizontal, Stair	Horizontal, Stair
Colors	WT, BK, VL	WT, BK, VL (round aluminum balusters come in BK)	WT (round aluminum balusters come in BK)

\*A cocktail rail allows for a Trex Transcend® or Trex Select® deck board to be installed on top of a Universal top/bottom rail. All deck boards sold separately.



### CODE REQUIREMENTS

Trex Transcend Railing meets both IRC and IBC designated requirements in accordance with ICC-ES AC174 and ASTM D7032. Refer to Code Compliance Report CCRR-0132 for specific details.

### HARDWARE

### **Mounting Hardware for Cut Rails**

The perfect solution for any installation that requires making two railing sections from one kit.

Includes 2 Crown top rail gaskets, 4 Universal top/bottom rail gaskets, 4 RSB rail brackets, 8 rail-to-bracket fasteners and 8 rail-to-post fasteners.





### QUESTIONS?

Connect with our pro services team at 1-800-BUY-TREX or customercare@trex.com

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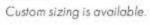
## **DOUBLE-HUNG WINDOWS**

A classic beauty, double-hung windows offer a sleek design with ventilation options from the top, bottom or both. Add a TruScene® insect screen to let the outside in, maximizing your view, not limiting it. E-Series double-hung windows give you the option to select aluminum or wood jamb liner inserts for added visual appeal and include flush-mounted hardware that allows for easy tilt-in operation.

Double-Hung Window Overview	
Double-Hung Insert Window Overview Double-Hung Sash Replacement Kit Overview	
Double-Hung	64
Double-Hung Cottage & Reverse Cottage	66
Double-Hung Picture & Transom	67
Arch Single-Hung	68
Arch Single-Hung Reverse Cottage	70
Direct-Set Double-Hung Transom	71
Monumental Single-Hung	72
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Product Performance	158







# Docusign Envelope ID: 121C250E-EAB6-43C1-88CA-B78C23A4CB55 DOUBLE-HUNG WINDOW

#### FEATURES

#### DOUBLE-HUNG WINDOWS

#### FRAME & SASH


A Select wood components are kiln dried and treated with water/insect repellent and preservative. Interior wood surfaces are available in pine, mixed grain Douglas fir, cherry, hickory mahogany, maple, oak, walnut, alder or vertical grain Douglas fir. Interior surfaces are available unfinished or factory primed. Optional factoryapplied finishes are available in a variety of stains and paints.

<sup>®</sup> Wood components are fitted with aluminum extrusions on the exterior. 50 exterior colors that meet AAMA 2604 and 2605 specifications are available, as well as custom colors. Also available is a selection of seven exterior anodized options.


Optional vinyl installation flanges are pre-applied into a kerf on the frame exterior to facilitate installation. Optional aluminum flanges or metal installation clips are available.

Compression bulb weatherstrip is applied on the bottom sash, head jamb, at the meeting rail and on side jambs for a maximum weather seal.

Jamb liners encase balancer assemblies that allow each sash to be tilted 90° inward from a bottom pivot and stay securely in place for washing.

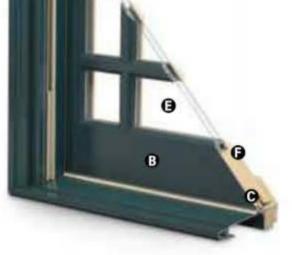

Double-hung jamb liners incorporate synthetic interior and exterior inserts or optional painted aluminum exterior and wood-veneered interior inserts.

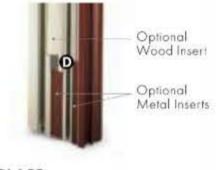

#### GLASS

B High-Performance Low-E4® glass with a low-conductivity spacer. Triple-pane glass, tinted, clear dualpane, high-altitude glass and other special glazing options are available.

Glass is fixed in place from the interior with wood stops that can be removed for easy reglazing if necessary. Glass stops available in ovolo (colonial) and contemporary profiles.

GLASS SPACERS available in black, white and stainless steel.



Sash lock/tilt mechanisms and keepers give a slim, more traditional design and allow opening and tilting of the window in one operation. Tilting the sash from the inside for cleaning is effortless.

Optional surface mount sash lifts allow for easy operation. Units less than 3' wide use one lift. Units 3' wide and greater use two lifts.

Anodized

Silver



Windows with VeriLock® sensors use a different sash lock. See the next page for details. Bold name denotes finish shown.

#### HARDWARE FINISHES



#### **EXTERIOR & INTERIOR OPTIONS**

EXTERIOR COLORS 50 exterior colors, 7 anodized finishes and custom colors. See exterior colors on page 11.

#### INTERIOR WOOD SPECIES Interior custom stains, paints and color matching available. Naturally occurring variations in grain, color and texture of wood Pine Mixed Grain Oak Maple Walnut Vertical Grain Alder White Oak make each window one of a kind. Hickory Mahogany' Cherry Douglas Fir Douglas Fir All factory-finished options are shown on pine. FACTORY-FINISHED INTERIORS Painted options available on pine. Dark bronze and black painted options available on pine or maple. Anodized silver painted option available on maple only. Clear Coat Wheat Autumn Oak Golden Honey Cinnamon Russet Mocha Espresso Hickory INTERIOR PAINTED OPTIONS White Birch Bark Primed Canvas Sandtone Terratone Forest Dark Red Rock Cocoa Black Dove Prairie (for paint Green Bronze Gray Grass Bean \*Actual wood species is either Sapele or Sipo, both non-endangered species grown in Africa, with color and characteristics similar to Central American mahoganies.

Printing limitations prevent exact replication of colors and finishes. Please see your Andersen supplier for actual color and finish samples.



#### ACCESSORIES Sold Separately

#### DOUBLE-HUNG WINDOWS

#### HARDWARE

#### Window Opening Control Device Kit

An optional Window Opening Control Device Kit is available, which limits opening the sash to less than 4" when the window is first opened. Available in stone and white.

# VeriLock & Open/Closed Sensors DISCONTINUED



#### Open/Closed Sensors

#### INSECT SCREENS

#### TruScene® Insect Screens

Andersen® TruScene insect screens let In over 25% more fresh air and provide 50% greater clarity than conventional Andersen insect screens, all while keeping out unwanted small insects. Frames are available in painted aluminum or wood-veneered options.

#### **Conventional Insect Screens**




Charcoal fiberglass screen mesh fits into an aluminum frame in all 50 exterior colors and seven anodized finishes. Available in half or full insect screens. Aluminum screen mes is available as an option.

See page 24 for more information on our insect screens.

#### GRILLES

#### Full Divided Light

Permanent interior and exterior grilles with grille spacer bars between two panes of glass. Available in 5/8", 7/8", 1 1/8", 1 1/2", or 2 1/4" widths and ovolo or contemporary profile. Ovolo profile shown below, not all widths are pictured.

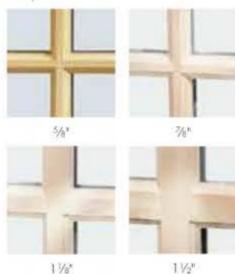

#### Simulated Divided Light

Permanent exterior and interior grilles without grille spacer bars. Available in 5/8," 7/8", 11/8", 11/2", or 21/4" widths and ovolo or contemporary profile. Ovolo profile shown below, not all widths are pictured.



#### Finelight<sup>™</sup> Grilles-Between-the-Glass

Available in 5/8" flat or 1" contoured aluminum profiles. Two-tone colors of pebble tan/colony white, sierra bronze/colony white or forest green/colony white are available on the 1" profile.



#### **Removable Interior Wood Grilles**

Removable interior wood grilles are available in a 7/8" width and ovolo or contemporary profiles. Optional surround for removable grille and permanent exterior grilles also available. Ovolo profile shown below.



See page 22 for more information on grilles.



400 SERIES

WOODWRIGHT® DOUBLE-HUNG FULL-FRAME WINDOWS

Tables of Sizes	50-56
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Joining Details	65
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Product Performance	197



Dimensions in parentheses are in millimeters.



# WOODWRIGHT<sup>®</sup> DOUBLE-HUNG FULL-FRAME WINDOWS

#### FEATURES

#### FRAME

A Perma-Shield® exterior cladding protects the frame - beautifully. Best of all, it's low maintenance and never needs painting."

B For exceptional long-lasting performance, sill members are constructed with a wood core and a Fibrex® material exterior.

• Natural wood stops are available in pine, maple, oak and prefinished white. Wood jamb liners add beauty and authenticity to the window interior.

D A factory-applied rigid vinyl flange on the head, sill and sides of the outer frame helps secure the unit to the structure.


 Multiple weatherstrip systems help provide a barrier against wind, rain and dust. The combination of springtension vinyl, rigid vinyl and flexible bulb weatherstrip is efficient and effective.

For units with white exterior color, the exterior jamb liner is white. For all other units, the exterior jamb liner is gray.

#### SASH

**G** Balancers in the sash enable contractors to screw through the jamb during installation without interfering with the window's operation.


#### Wood Jamb Liner

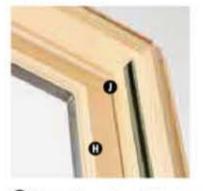

(1) Natural wood sash interior with classic chamfer detailing. Available in pine, maple, oak or prefinished white.

O Low-maintenance sash exterior provides long-lasting protection and performance. Sash exteriors on most units include Fibrex material.

Sash joints simulate the look of traditional mortise-and-tenon construction inside and out.

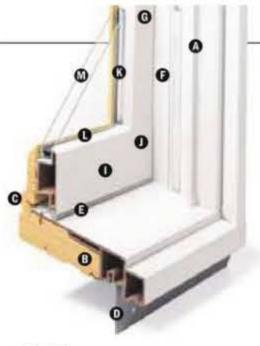

#### GLASS

In addition to stainless steel glass spacers, black or white glass spacers are now available to allow the spacer to blend in with the unit color.

Silicone bed glazing provides superior weathertightness and durability.

High-Performance options include:

- · Low-E4® alass
- Low-E4 HeatLock<sup>®</sup> glass
- Low-E4 SmartSun<sup>™</sup> glass
- Low-E4 SmartSun HeatLock glass Low-E4 Sun glass

Tempered and other glass options are available. Contact your Andersen supplier.

A removable translucent film helps shield the glass from damage during delivery and construction, and simplifies finishing at the job site.

#### **Patterned Glass**

Patterned glass options are available. See page 12 for more details.

#### HARDWARE



Standard lock and keeper design provides an easy tilt-to-clean feature integrated into the lock.

#### **EXTERIOR & INTERIOR OPTIONS**



#### HARDWARE



Antique Bross | Black | Bright Brass Brushed Chrome | Distressed Bronze Distressed Nickel | Gold Dust Oil Rubbed Bronze | Polished Chrome Satin Nickel | Stone | White

Standard Lock & Keeper

#### **OPTIONAL HARDWARE** Sold Separately



#### TRADITIONAL





Antique Brass | Black | Bright Brass | Brushed Chrome Distressed Bronze | Distressed Nickel | Gold Dust | Oil Rubbed Bronze Polished Chrome | Satin Nickel | Stone | White

CLASSIC SERIES"



Bold name denotes finish shown.

#### HARDWARE FINISHES



\*Visit andersenwindows.com/warranty for details.

Dimensions in parentheses are in millimeters

Printing limitations prevent exact replication of colors and finishes.

See your Andersen supplier for actual color and finish samples.

Naturally occurring variations in grain, color and texture of wood make each window one of a kind. All wood interiors are unfinished unless a finish is specified.

Distressed bronze and oil rubbed bronze are "living" finishes that will change with time and use.



# Storn WATCH

Performance Grade (PG) Upgrades

Performance upgrades are available for select sizes of standard, non-impact Woodwright® windows allowing these units to achieve higher performance ratings. Performance Grade (PG) ratings are more comprehensive than Design Pressure (DP) ratings for measuring product performance. For up-to-date performance information of individual products, visit andersenwindows.com. Use of this option will subtract 5/6" (16) from clear opening height. Contact your Andersen supplier for availability.

Visit andersenwindows.com/coastal for more information on Stormwatch<sup>®</sup> Protection.

#### SHAPES

Woodwright windows are available in the following shapes.



Double-Hung



Arch Double-Hung

#### SASH OPTIONS



Cottage

#### ACCESSORIES Sold Separately

#### FRAME

#### **Extension Jambs**



Standard jamb depth is 41/2" (114). Extension jambs are available in unfinished pine or prefinished white Some sizes may be veneered.

Factory-applied and non-applied interior extension jambs are available in 1/16" (1.5) increments between 5 1/4" (133) and 7 1/6" (181). Extension jambs can be factory applied to either three sides (stool and apron application) or four sides (picture frame casing).

#### **Pine Stool**



A clear pine stool is available and ready for finishing. The Woodwright stool is available in 4 1/16" (116) for use in wall depths up to 5 1/4" (133) and 6%16" (167) for use in wall depths up to 7 1/8" (181). Works with 2 1/4" (57) and 2 1/2" (64) casing widths. Shown above on a 400 Series tilt-wash double-hung window.

#### HARDWARE

#### Window Opening Control Device



A window opening control device is available, which limits sash travel to less than 4" (102) when the window is first opened. Available factory applied, or as a field-applied kit in stone or white.

#### STORM/INSECT SCREEN COMBINATION UNIT"



A self-storing storm window combined with an insect screen provides greater energy efficiency, while allowing ventilation when needed.

Constructed with an aluminum frame, single-pane upper and lower glass panels, and charcoal powder-coated aluminum screen mesh. Available in white, Sandtone and Terratone to match product exteriors. Canvas, dark bronze, forest green and black are available by special order.

Combination units can improve Sound Transmission Class (STC) and Outdoor Indoor Transmission Class (OITC) ratings. Ideal for projects near airports, busy roadways or other noisy environments. For example, adding a combination unit to a 400 Series tilt-wash double-hung (3862) unit with Low-E4® alass will improve its STC rating from 26 to 32. Contact your Andersen supplier for additional STC and OITC rating information.

#### INSECT SCREENS

#### Insect Screen Frames



Choose full insect screen or half insect screen. Half insect screen (shown above) allows ventilation without affecting the view through the upper sash. Frames are available in colors to match product exteriors.

#### TruScene® Insect Screens

Andersen TruScene insect screens let in over 25% more fresh air" and provide 50% areater clarity than conventional Andersen insect screens, all while keeping out unwanted small insects.

#### **Conventional Insect Screens**

Conventional insect screens have charcoal powder-coated aluminum screen mesh.

#### GRILLES

Grilles are available in a variety of configurations and widths. For doublehung grille patterns, see page 63.

#### EXTERIOR TRIM

Available with Andersen® exterior trim, See exterior trim section starting on page 175.

#### CAUTION:

- · Painting and staining may cause damage to rigid vinyl.
- · 400 Series windows in Terratone color may be painted any color lighter than Terratone color using quality oil-based or latex paint.
- · Do not point 400 Series windows with white, canvas, Sandtone, dark bronze, forest green or black exterior colors.
- Andersen does not warrant the adhesion or performance of homeowner-applied paint over vinyl or other factory-coated surfaces.
- For vinyl painting instructions and preparation. contact your Andersen supplier.
- Do not paint weatherstrip.
- · Creasate-based stains should not come in contact with Andersen products.
- · Abrasive cleaners or solutions containing corrosive solvents should not be used on Andersen products.

\*Shown on 400 Series tilt-wash double-hung windows.

Reverse Cottage


\*\* Do not add combination units to windows with Low-E4 Sun glass unless window glass is tempered. Combination units may also reduce the overall clear operable area of the window. See your local code official for egress requirements in your area.

†TruScene insect screens let in over 25% more fresh air than standard Andersen fiberglass insect screens. Dimensions in parentheses are in millimeters.


#### WOODWRIGHT® DOUBLE-HUNG FULL-FRAME WINDOWS

#### Woodwright\* Double-Hung Window Details

Scale 11/2" (38) = 1'-0" (305) - 1:8

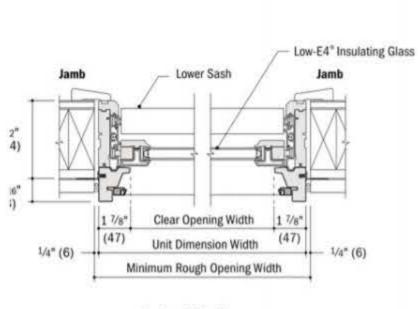


**Horizontal Section** 

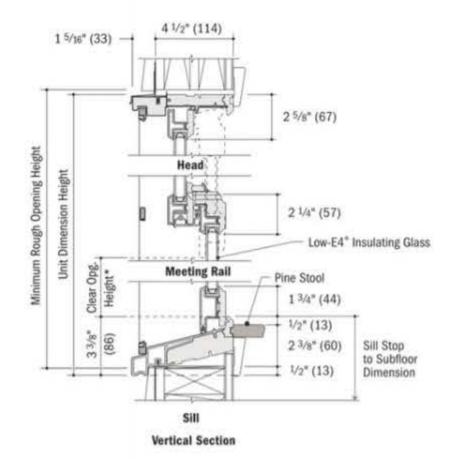


#### Woodwright<sup>®</sup> Picture Window Details

Scale 11/2" (38) = 1'-0" (305) - 1:8

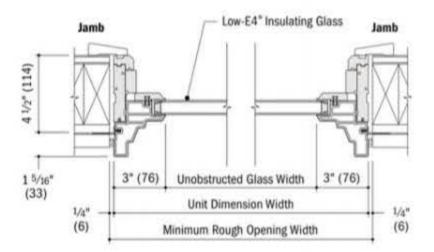

**Horizontal Section** 

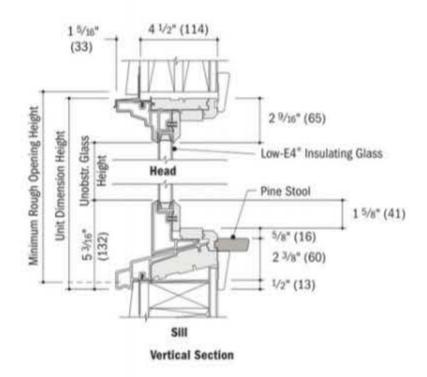

\* Light-colored areas are parts included with window. Dark-colored areas are additional Andersen" parts required to complete window assembly as shown.

• Minimum rough openings may need to be increased to allow for use of building wraps, flashing, sill panning, brackets, fasteners or other items. See installation information on pages 210-211. • Details are for illustration only and are not intended to represent product installation methods or materials. Refer to product installation guides at andersenwindows.com.

Dimensions in parentheses are in millimeters.

\*Clear opening height dimension is less on arch, unequal leg arch and Springline" hung windows.



#### 400 SERIES

#### Horizontal (stack) Joining Detail


Scale 11/2" (38) = 1'-0" (305) - 1:8


#### **Overall Window Dimension Height**

Sum of individual window heights plus 1/16" (1.5) for each join.

#### **Overall Rough Opening Height**

Overall window dimension height.\*

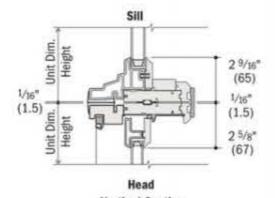

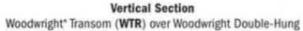

For more joining information, see the combination designs section starting on page 181.

#### Vertical (ribbon) Joining Detail


Scale 11/2" (38) = 1'-0" (305) - 1:8

#### **Overall Window Dimension Width**

Sum of individual window widths plus 1/16" (1.5) for each join.

#### **Overall Rough Opening Width**

Overall window dimension width plus 1/2" (13).

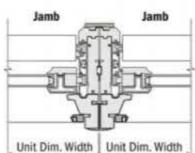

1/16" (1.5)


Horizontal Section

Woodwright\* Double-Hung to Woodwright Double-Hung

#### Separate Rough Openings Detail

Scale 11/2" (38) = 1'-0" (305) - 1:8

To meet structural requirements or to achieve a wider joined appearance, windows may be installed into separate rough openings having vertical support (by others) in combination with Andersen\* exterior filler and exterior vinyl trim.

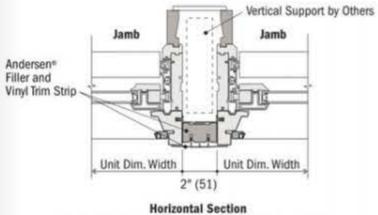

Woodwright\* Double-Hung and Woodwright Double-Hung

\* Light-colored areas are parts included with window. Dark-colored areas are additional Andersen" parts required to complete window assembly as shown.

• Minimum rough openings may need to be increased to allow for use of building wraps, flashing, sill panning, brackets, fasteners or other items. See installation information on pages 210-211.

Details are for illustration only and are not intended to represent product installation methods or materials. Refer to product installation guides at andersenwindows.com.
 Consult with an architect or structural engineer regarding minimum requirements for structural support members between adjacent rough openings.

Dimensions in parentheses are in millimeters.

\*For stacks where bottom unit in combination is a double-hung or picture window with a sloped sill. If bottom window has a flat sill, add 1/2" (13) to the overall window dimension height.

#### FEATURES

#### HINGED PATIO DOORS

#### FRAME & PANEL

Select wood components are kiln dried and treated with water/insect repellent and preservative. Interior wood surfaces are available in pine, mixed grain Douglas fir, cherry, hickory, mahogany, maple, oak, walnut, alder or vertical grain Douglas fir, Interior surfaces are available unfinished or factory primed. Optional factoryapplied finishes are available in a variety of stains and paints.

Wood components are fitted with aluminum extrusions on the exterior. 50 exterior colors that meet AAMA 2604 and 2605 specifications are available, as well as custom colors. Also available is a selection of seven exterior anodized options.

**O** The frame perimeter consists of a high-quality foam-filled weatherstrip.

Inswing and outswing doors receive a factory-applied vinyl installation flange with drip cap. Some inswing patio doors require an adjustable metal installation flange. Optional aluminum flanges and metal installation clips are available.


#### SILL

#### Drainage Sill for Inswing Patio Doors

Premium grade aluminum inswing sill with an oak threshold. Sills have a built-in drainage channel that allows water to drain away from the interior of the door. A top plate is removable for easy channel cleaning. A polyurethane thermal barrier helps reduce heat loss. Available in clear anodized or dark bronze anodized finish, shown below.






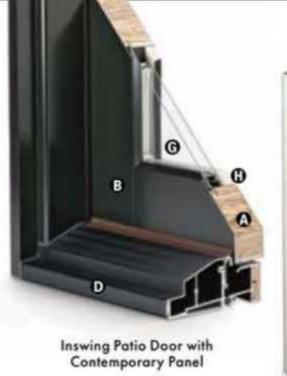

#### **On-Floor Sill for Outswing Patio Doors**


Premium grade aluminum outswing sill with oak threshold. Outswing door sill is backed with a compression foam weatherstrip. Available in clear anodized or dark bronze anodized finish, shown below.

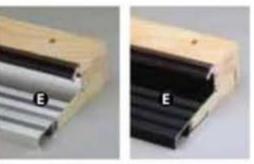


On-floor sills for outswing

#### Low-Threshold Sill

Aluminum low threshold sill available for outswing doors and inswing doors. Available for inswing doors with jamb depths of 4 %6° and 6 %16°. Low threshold design provides a smooth transition fram interior to exterior and is wheelchair-accessible. A polyurethane thermal barrier helps reduce heat loss. Available in dark bronze anodized finish, shown below.

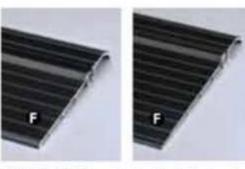

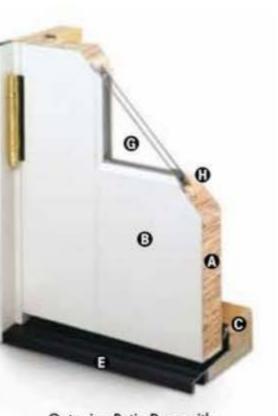

Outswing Patio Door with French Panel

#### GLASS

G High-Performance Low-E4<sup>III</sup> glass with a low-conductivity spacer. Triple-pane glass, tinted, clear dualpane, high-altitude glass and other special glazing options are available.

Glass is fixed in place from the interior with wood stops that can be removed for easy reglazing if necessary. Glass stops available in ovolo (colonial) and contemporary profiles.

GLASS SPACERS available in black, white and stainless steel.

#### HARDWARE

#### Multi-Point Locking System

Autolatch® stainless steel multi-point lacking system lacks the panel in three locations to provide a secure, weather-resistant entry system. Some door heights lock the panel in four locations.

Hinges



Heavy-duty commercial grade hinges are available in finishes of antique brass, black, bright brass, and character pewter, gold dott oil rubbed branze, bright character stainless steel, and white to go with your handle set. Hinges are complete with matching screws. An innovative hinge shimming system allows for minor adjustments.

Satin Chrome, Gold Dust and Bright Chrome DISCONTINUED



Drainage sills for inswing

4 %16" & 6 %16" Low-threshold sills for inswing



4%16" Low-threshold sill for outswing

\*Actual wood species is either Sapele or Sipo, both non-endangered species grown in Africa, with color and characteristics similar to Central American mahaganies.

NDOWS &

#### ACCESSORIES Sold Separately

#### HINGED PATIO DOORS

#### HARDWARE

#### **Construction Handle**



Temporary construction handle is sent with all hinged patio doors. This handle allows operation during the construction phase, protecting finished hardware from damage or jobsite theft.

#### Hardware Options

Additional hardware options such as exterior keyed locks and more are also available. Contact your Andersen supplier.

#### SENSORS

#### Yale® Assure Lock®

Monitor, lock and unlock from anywhere with the Yale Assure Lock. The sleek keyless lock includes Bluetooth® technology for key-free unlocking and is compatible with Z-Wave® for integration with a wide range of smart home platforms. Available on select hinged doors, see your Andersen supplier for details.

#### VeriLock & Open/Closed Sensors DISCONTINUED

#### Open/Closed Sensors

See page 27 for Smart Home options.

#### **INSECT SCREENS**

**Retractable Insect Screens** 



Concealed, retractable insect screen has charcoal fiberglass screen mesh. Available for inswing single or double door units. Insect screen rolls out when needed and retracts into concealed housing when not in use. Available in 50 exterior colors.

Retractable insect screens for outswing doors are field applied to the interior of the door. Available in five colors including white, almond, desert sand, bronze and black.

#### **Hinged Insect Screens for Inswing Patio Doors**

Charcoal fiberglass screen mesh fits into an aluminum frame in 50 exterior colors. Provided with a black lockable latch and automatic closer for smooth operation. Available in single or multiple door units. Aluminum screen mesh is also available.

#### **Top-Hung Gliding Insect Screens for Inswing Center Post Patio Doors**

Charcoal fiberglass screen mesh fits into an aluminum frame available in 50 exterior colors. Aluminum screen mesh is also available.

#### **PRIVACY OPTIONS**

#### Blinds-Between-the-Glass




A 3/8" aluminum slat blind mounted between two panes of insulated glass in a dust-free environment. Available in white, tan and almond. Blinds are magnetically controlled and can be tilted or raised and lowered with one cord," Not available on arch patio doors.

#### GRILLES

#### **Full Divided Light**

11%

Permanent interior and exterior grilles with grille spacer bars between two panes of glass. Available in 3/8, 7/8, 1 1/4", 1 1/2", or 2 1/4" widths and ovolo or contemporary profile. Ovolo profile shown below, not all widths are pictured.

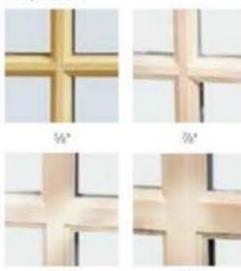

#### 116\*

#### Simulated Divided Light

Permanent exterior and interior grilles without grille spacer bars. Available in %, %, 11%, 11/2", or 21/4" widths and ovolo or contemporary profile. Ovolo profile shown below, not all widths are pictured.



#### Finelight" Grilles-Between-the-Glass

Available in 5/18" flat or 1" contoured aluminum profiles. Two-tone colors of pebble tan/colony white, sierra bronze/colony white or forest green/colony white are available on the 1" profile.



% Flat

1º Contoured

#### **Removable Interior Wood Grilles**

Removable interior wood grilles are available in a 7%" width and ovolo or contemporary profiles. Optional surround for removable grille and permanent exterior grilles also available. Ovalo profile shown below.



See page 22 for more information

E-Series Hinged Patio Doors

on grilles.


\*When properly configured and maintained with a professionally installed security system and/or self-monitoring system compatible with Honeywell\* 5800 controls. See your Andersen supplier for more information.

\*\*Not all sizes are retractable. See your local Andersen supplier for details.


WINDOWS & DOORS

#### **Hinged Outswing Patio Doors**


#### **Hinged Outswing Patio Door**

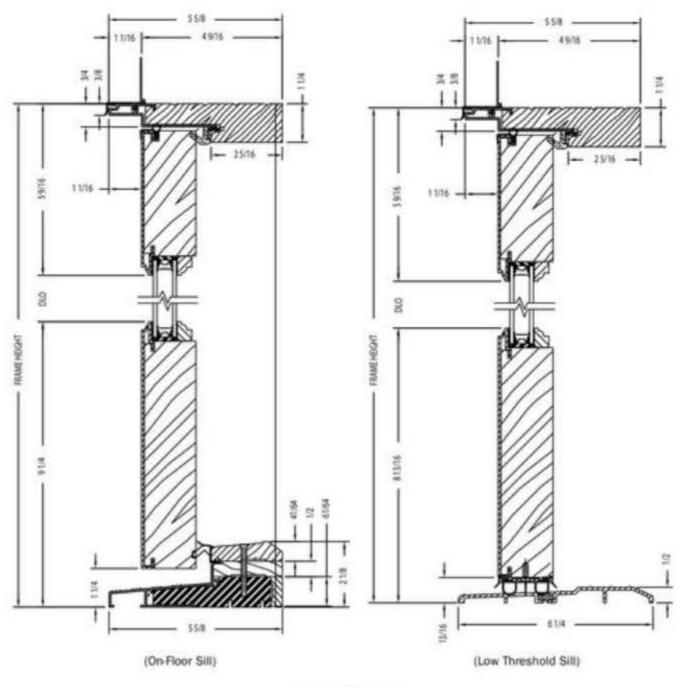


Vertical Section

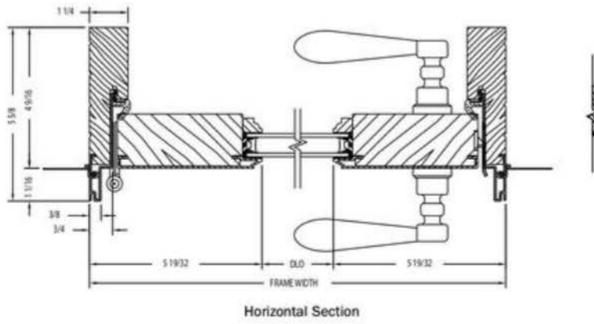


Astragal

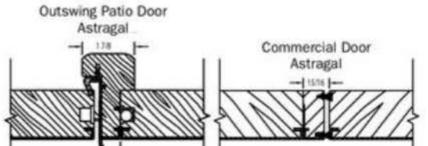

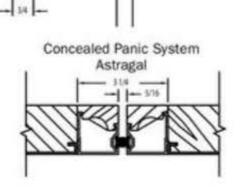

Shown with ovolo (colonial) glass stops. French panel shown, also available with a contemporary panel.

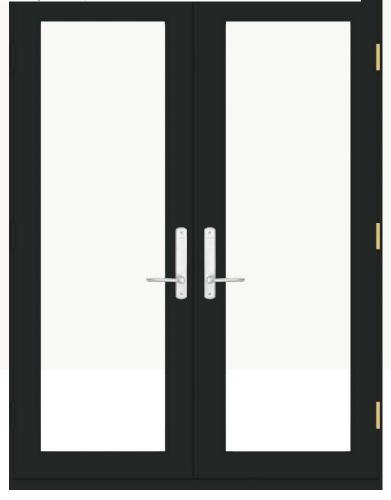

INTERIOR



# CASEMENT & AWNING WINDOWS

Docusign Envelope ID: 121C250E-EAB6-43C1-88CA-B78C23A4CB55

Alignment Grid	24-25
Tables of Sizes	26-30
Specifications	
Custom Sizes	35
Grille Patterns	36
Window Details	
Joining Details	40
Combination Designs	183
Product Performance	

CUSTOM SIZING in 1/4" (3) increments

611

# CASEMENI & AWNING WINDOWS

#### FEATURES

#### FRAME

▲ A seamless one-piece Perma-Shield® rigid vinyl frame cover is secured to the exterior of the wood frame to protect it from moisture and maintain an attractive appearance while minimizing maintenance.

 The seamless rigid vinyl frame cover extends 1 <sup>3</sup>/s" (35) around the perimeter of the unit, creating an installation flange to help seal the unit to the structure.

 Wood frame members are treated with a water-repellent preservative for long-lasting protection and performance.

Traditional or contemporary interior trim stops are unfinished pine. Low-maintenance prefinished white, dark bronze and black<sup>\*\*</sup> interiors are also available. Matching contemporary grilles are available for windows with contemporary stops.

#### SASH

Rigid vinyl encases the entire sash, and a vinyl weld protects each sash corner for superior weathertightness. This maintains an attractive appearance and minimizes maintenance.

• Wood core members provide excellent structural stability and energy efficiency.

• Vinyl closed-cell foam weatherstrip is factory installed on the perimeter of the sash.

#### GLASS

Glass spacers are available in black, stainless steel and white.


• A glazing bead and silicone provide superior weathertightness and durability.

• High-Performance glass options include:

- Low-E4<sup>∞</sup> glass
- Low-E4 HeatLock<sup>®</sup> glass
- Low-E4 SmartSun<sup>™</sup> glass
- Low-E4 SmartSun HeatLock glass
- Low-E4 Sun glass
- Low-E4 PassiveSun<sup>®</sup> HeatLock glass

Tempered and other glass options are available. Contact your Andersen supplier.

A removable translucent film helps shield the glass from damage during delivery and construction, and simplifies finishing at the job site.

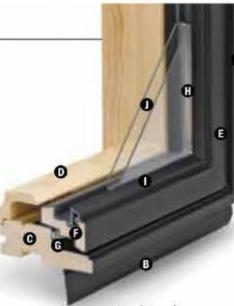

Traditional

#### Patterned Glass

Patterned glass options are available. See page 11 for more details.

#### HARDWARE

Smooth Control Hardware System



The smooth control hardware system employs a worm gear drive for easy operation. Units with wash mode have hinges that move the sash away from the frame to provide easier glass cleaning. CXW15, CXW155, CXW16 and CXW25 sizes are not available with wash mode. Hardware style and finish must be specified. Operator handle and cover are sold separately.

#### Single-Action Casement Lock



On casement windows, a single-action lock easily releases all concealed locking points on the sash, while the reach-out action eliminates binding when closing. The lock handle finish matches the specified hardware finish.

#### \*Visit and ersenwindows.cam/warranty for details.

\*\*Products with dark bronze or black interiors have matching exteriors. †These finishes are " iving finishes" that will change with time and use, see limited warranty for details. Naturally occurring variations in grain, color and texture of wood make each window one of a kind. All wood interiors are unfinished unless a finish is specified. Printing limitations prevent exact replication of colors and finishes. See your Andersen supplier for actual color and finish samples. Dimensions in parentheses are in millimeters.




#### **EXTERIORS & INTERIORS**



#### INTERIOR OPTIONS





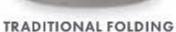

Black | Bright Brass Oil Rubbed Bronze | Satin Nickel Stone | White

**CONTEMPORARY FOLDING** 

HARDWARE Sold Separately

Antique Brass | Black Bright Brass | Distressed Bronze

Distressed Nickel | Oil Rubbed Bronze Satin Nickel | Stone | White

Folding handles avoid interference with window treatments.



ESTATE

Antique Brass | **Bright Brass** Distressed Bronze | Distressed Nickel Oil Rubbed Bronze | Satin Nickel

#### HARDWARE FINISHES

Bold name denotes finish shown

Stone | White



22



#### Awning Sash Locks



Awning sash locks provide an added measure of security and weathertightness. Hardware style and finish options are compatible with Andersen casement windows to ensure consistency in appearance when used in combination designs.

#### PERFORMANCE OPTIONS

#### Performance Grade (PG) Upgrades

PG upgrade is available for select sizes of standard non-impact casement and awning windows, allowing these units to achieve higher performance ratings. PG ratings are more comprehensive than Design Pressure (DP) ratings for measuring product performance. For up-to-date performance information of individual products, visit **andersenwindows.com**. Contact your Andersen supplier for availability.

#### **Coastal Windows**

400 Series casement and awning windows are available with Stormwatch® Protection. Visit andersenwindows.com/coastal or refer to the Andersen 400 Series Coastal Product Guide for more information.



CAUTION. Painting and staining may cause damage to rigid vinyl. Andersen does not worrant the adhesion or performance of homeownerapplied paint over vinyl or other factory-coated surfaces. For vinyl painting instructions and preparation, contact your Andersen supplier. Do not paint weatherstrip. Creasole-based stains should not come in contact with Andersen products. Abrasive cleaners or solutions containing corrosive solvents should not be used on Andersen products. See page 223 for a complete list of coutions.

#### \*Visit andersen windows.com/warranty for details

\*\*TruScene insect screens, et in over 25% more fresh air than standard Andersen fiberglass insect screens. Dimensions in parentheses are in mill meters.

#### ACCESSORIES Sold Separately

#### FRAME

Extension Jambs



The base jamb depth is 27%" (73). Extension jambs are available in unfinished pine, maple and oak, or prefinished white, dark bronze and black. Some sizes may be veneered.

Factory-applied and non-applied extension jambs are available in 7/5" (1.5) increments between 4.%/15" (116) and 7.1%" (181). Extension jambs can be factory applied to either three sides (stool and apron) or four sides (picture frame casing).

For overall jamb depths greater than 7 1/6" (181), interior extension jambs are available in 1/16" (1.5) increments between 7 1/6" (181) and 9" (229) for field application. They are available in 8' (2438) and 12' (3658) lineals.

#### Thick Replacement Extension Jambs

To help preserve original alignment of trim and paint lines in replacement situations, special 1 1/3" (29)-thick replacement extension jambs are available. Factory-applied and non-applied extension jambs are available in 1/16" (1.5) increments between 4 %16" (116) and 7 1/6" (181). Non-applied extension jambs are available in 12' (3658) lineals. Shown on page 43. Detail on page 36.

#### **Drywall Return Bead**



A narrow or wide drywall return bead is available with unfinished pine, or prefinished white, dark bronze and black interiors. Can be ordered factory applied or in non-applied lineals. Detail on page 36.

#### HARDWARE

#### Corrosion-Resistant Components

Corrosion-resistant hinge and operator arm hardware is designed for applications in harsh and corrosive environments such as heavy industrial or coastal areas."

#### Window Opening Control Device



A window opening control device is available, which limits sash travel to less than 4" (102) when the window is first opened. Available factory applied, or as a field-applied kit in black, stone and white.

#### Power Operator for Awning Windows



Awning windows can be ordered with an operator enhanced by PowerAssist" technology that opens and closes the window with the touch of a button, and eliminates the need for sash locks. Easy to install, the 24-volt system features a concealed window power drive, battery backup and a moisture sensor that closes the window when it rains. It is controlled by a wall-mounted console that includes a power box. battery, touch pad and mounting bracket. A remote control is sold separately. Windows can be ordered factory prepped or as a field-applied kit, Power driver requires field installation. Available for windows up to 5' (1524) wide. Not available for windows with Stormwatch Protection or PG upgrade.

#### SPECIAL OPERATOR HANDLES

Available in Classic Series<sup>™</sup> design only.

#### Compact Operator Handle



Specially designed for situations where window treatments

interfere with handle operation. Available in a stone or white finish.

#### **Operator Spline Cover**



An operator spline cover is an attractive cap that covers the roto operator stud when the handle that controls access or operation of the window has been removed. The operator spline cover should not be used on any window designated or intended for emergency escape or rescue. Consult your local building code official for egress code requirements in your area.

#### Metal T-Handle



Our smallest operator handle, the metal T-handle, may make it more difficult for young children aged 5 and under to open the window. For more information on child safety, write:

Andersen Corporation LookOut For Kids® Program 100 Fourth Avenue North Bayport, MN 55003 Call: 800-313-8889 Email: lofk@andersencorp.com Website: andersenwindows.com/ windowsafety

#### Easy-Grip Handle

A larger knob makes it easier to grip and operate. Available in a stone or white finish.



#### **ANDERSEN® ART GLASS**

Andersen art glass panels come in a variety of original patterns. For more information, see the Art Glass section starting on page 175 or visit andersenwindows.com/artglass.

#### **INSECT SCREENS**

#### TruScene<sup>®</sup> Insect Screens



Our TruScene insect screens let in over 25% more fresh air" and provide 50% greater clarity than conventional Andersen insect screens, all while keeping out unwanted small insects. For casement and awning windows, frames are available in white, stone, dark bronze and black, or with pine veneer frame interiors to blend with the wood interior of the window.


#### **Conventional Insect Screens**

Conventional insect screens have charcoal gray powder-coated aluminum screen mesh. Frames are available in white, stone, dark bronze and black.

#### **GRILLES & EXTERIOR TRIM**


Grilles are available in a variety of configurations and widths. See page 18 for details. Available with Andersen exterior trim. See the Exterior Trim section starting on page 177.



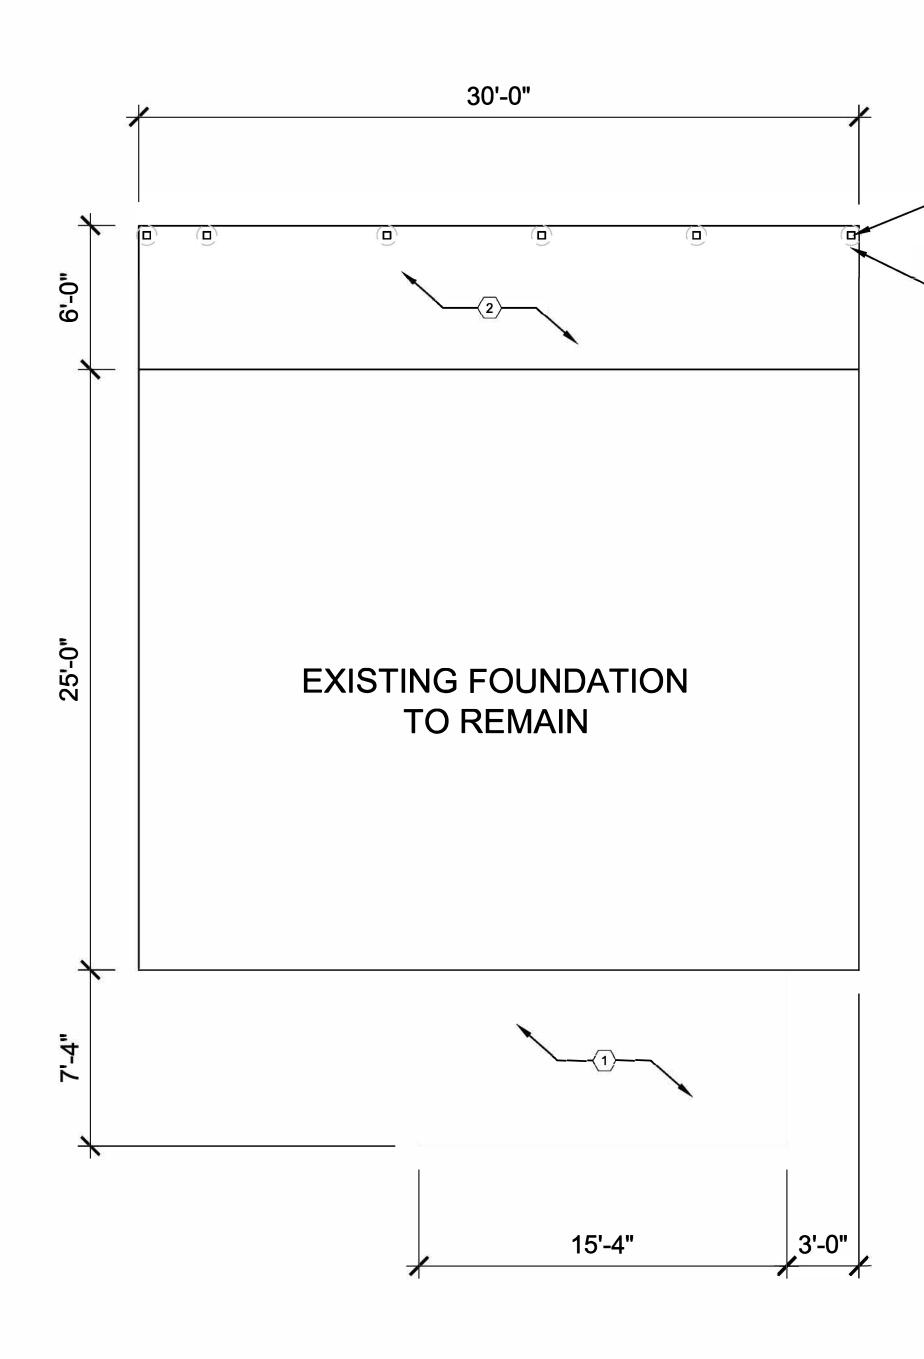


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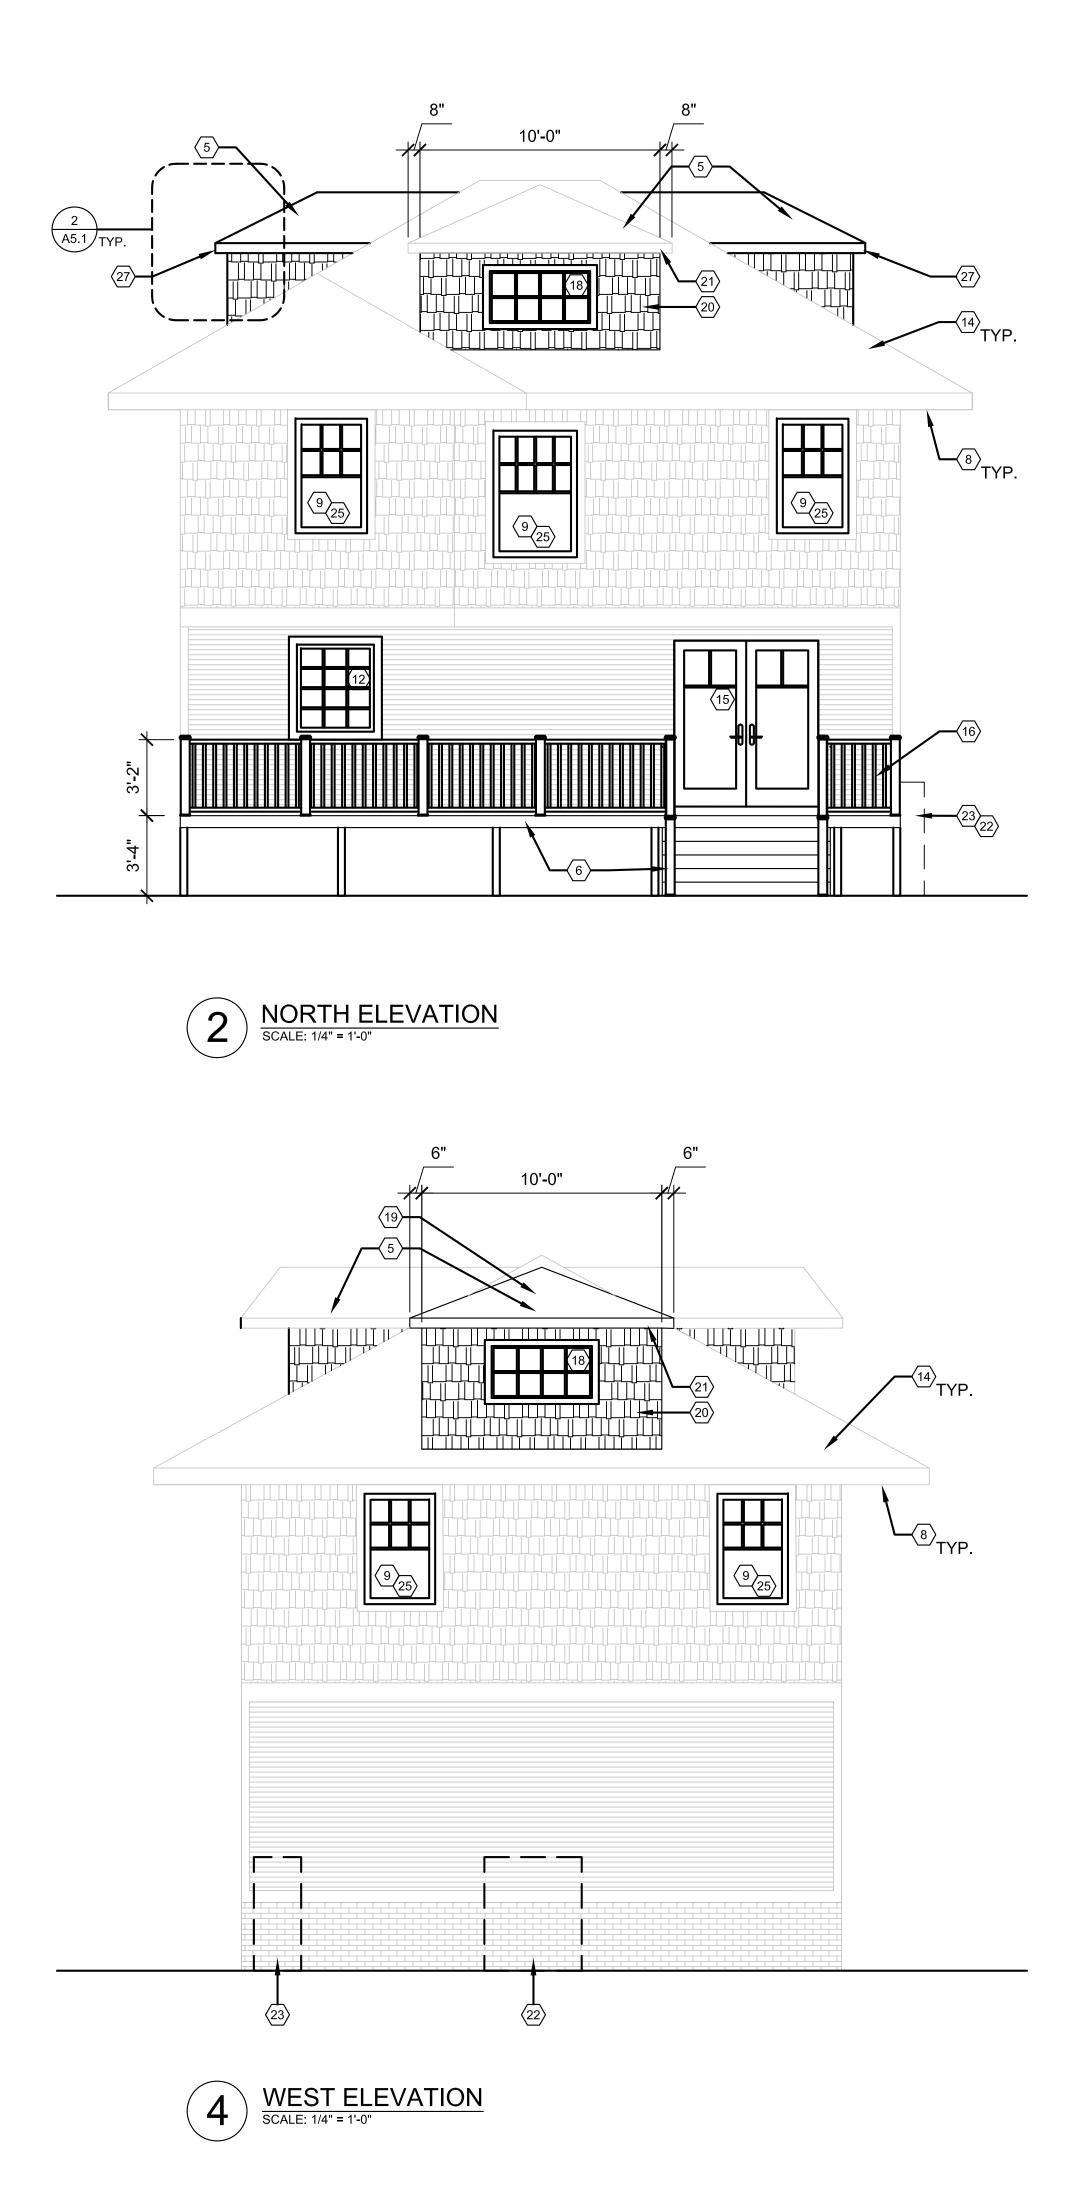


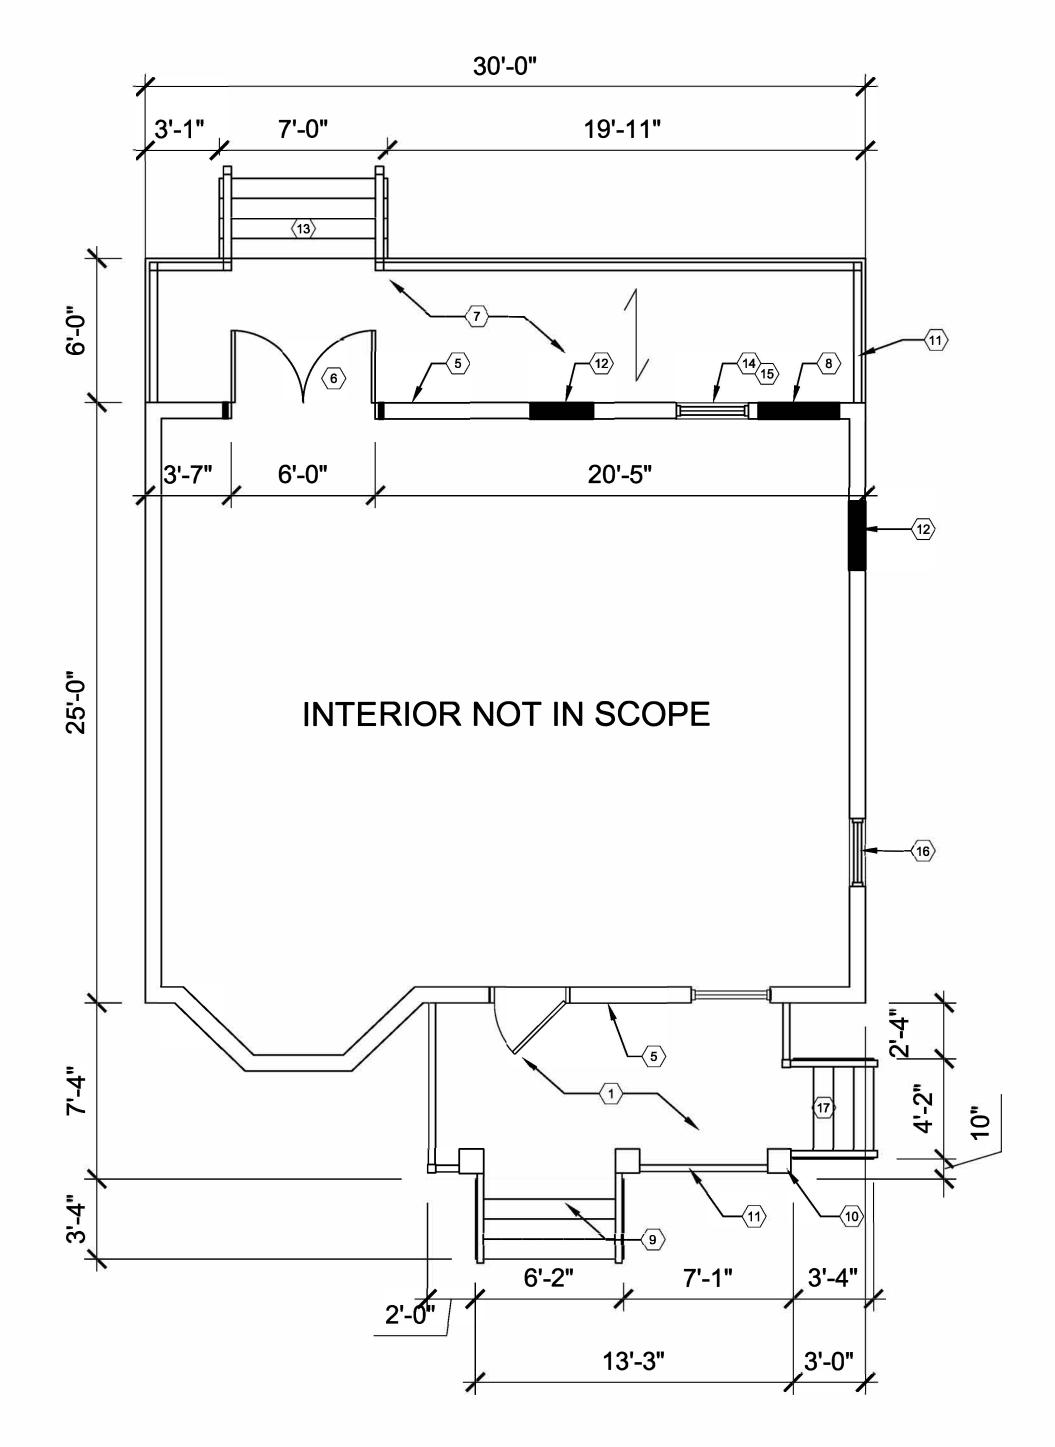

GENERAL FLOOR PLAN NOTES:	
<ol> <li>THIS DRAWING IS DIAGRAMMATIC AND SHOULD BE USED TO DETERMINE THE DESIGN INTENT. THE CONTRACTOR IS RESPONSIBLE FOR THE COMPLETE SET OF WORK AS INDICATED AND SHALL FIELD VERIFY ALL WORK, COORDINATE ALL DRAWINGS / NEW WORK AND SHALL NOTIFY ARCHITECT IMMEDIATELY OF ANY DISCREPANCIES IN THE DOCUMENTS BEFORE PROCEEDING. FAILURE TO DO SO WILL RESULT IN THE CONTRACTOR TAKING FULL RESPONSIBILITY AND</li> </ol>	4545 architecture 2761 E. JEFFERSON AVE STE 302 DETROIT, MI 48207 P. 313.454.4545 TIM.FLINTOFF@4545ARCHITECTURE.COM
LIABILITY FOR SAID DISCREPANCIES. 2. ALL DIMENSIONS ARE SHOWN FROM FINISH FACE TO FINISH FACE OF PARTITION	CONSULTANT:
UNLESS OTHERWISE NOTED. 3. WALL THICKNESS' ARE NOMINAL NOT ACTUAL DIMENSIONS. SEE WALL	
<ul> <li>SCHEDULE FOR ACTUAL DIMENSIONS.</li> <li>ALL WORK SHALL BE DONE IN ACCORDANCE WITH ALL LOCAL, STATE, COUNTY</li> </ul>	
CODE REGULATIONS, O.S.H.A., AND THE AMERICAN WITH DISABILITIES ACT (ADA). REFER TO THE CODE PLAN FOR MORE INFORMATION. 5. PROVIDE POSITIVE SLOPE TO ALL FLOOR DRAINS WHILE KEEPING FLOOR LEVEL	
AT WALL BASE CONDITION.	
PLAN KEY NOTES: (TYPICAL THIS SHEET ONLY)	
(1) EXISTING MASONRY PORCH TO REMAIN	
$\langle 2 \rangle$ NEW DECK FOOTPRINT $\langle 3 \rangle$ 10" SONOTUBE (TYP.), B.O.F. TO BE MIN. 42" BELOW GRADE	
4 4x4 WOOD POST (TYP.)	
(5) LEDGER DECK TO HOUSE, USING STRUCTURAL EPOXY AS REQ'D, STAGGER BOLTS 12" T & B	
(8) INSTALL NEW FRENCH DOOR (WORK COMPLETED), SEE ELEVATIONS. INFILL WALL AS REQ'D.	
$\overline{7}$ TREX COMPOSITE DECKING ON 2x8 WOOD DECK JOISTS, MAX 16" O.C. $\overline{6}$ REMOVE AND INFILL EXISTING DOOR (WORK COMPLETED)	
9 NEW MASONRY STAIR (WORK COMPLETED)	
$\langle 10 \rangle$ wood wrapped 4x4 wood posts, see elevations $\langle 11 \rangle$ new handrail, min. 36" tall. See elevations.	
$\langle 12 \rangle$ EXISTING WINDOW REMOVED/INFILLED (WORK COMPLETED), SEE ELEVATIONS	Project :
	708 PALLISTER HDC RENOVATION
$\langle 14 \rangle$ EXISTING WINDOW REPLACED WITH VINYL-CLAD SLIDING WINDOW (WORK COMPLETED) $\langle 15 \rangle$ SLIDING WINDOW TO BE REMOVED, REPLACED WITH ALUMINUM-CLAD WOOD	
SINGLE-HUNG WINDOW (ANDERSON 400 SERIES) W/ SIMULATED DIVIDED LITES TO MATCH PREVIOUSLY EXISTING WINDOW; PAINTED BLACK	
(16) INSTALL NEW VINYL-CLAD WOOD SINGLE-HUNG WINDOW (ANDERSON 400 SERIES), PAINTED BLACK; SEE ELEVATIONS (WORK COMPLETED)	
(17) REPLACE DAMAGED MASONRY STAIR; NEW STAIR TO MATCH EXISTING (WORK COMPLETED)	
	Issued for : HDC SUBMIT 04/21/2025
	E OF MICHIN
	G TIMOTHY R. FLINTOFF JR.
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	≤   ANJ
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	Project No. : 2024001
	Sheet No. :

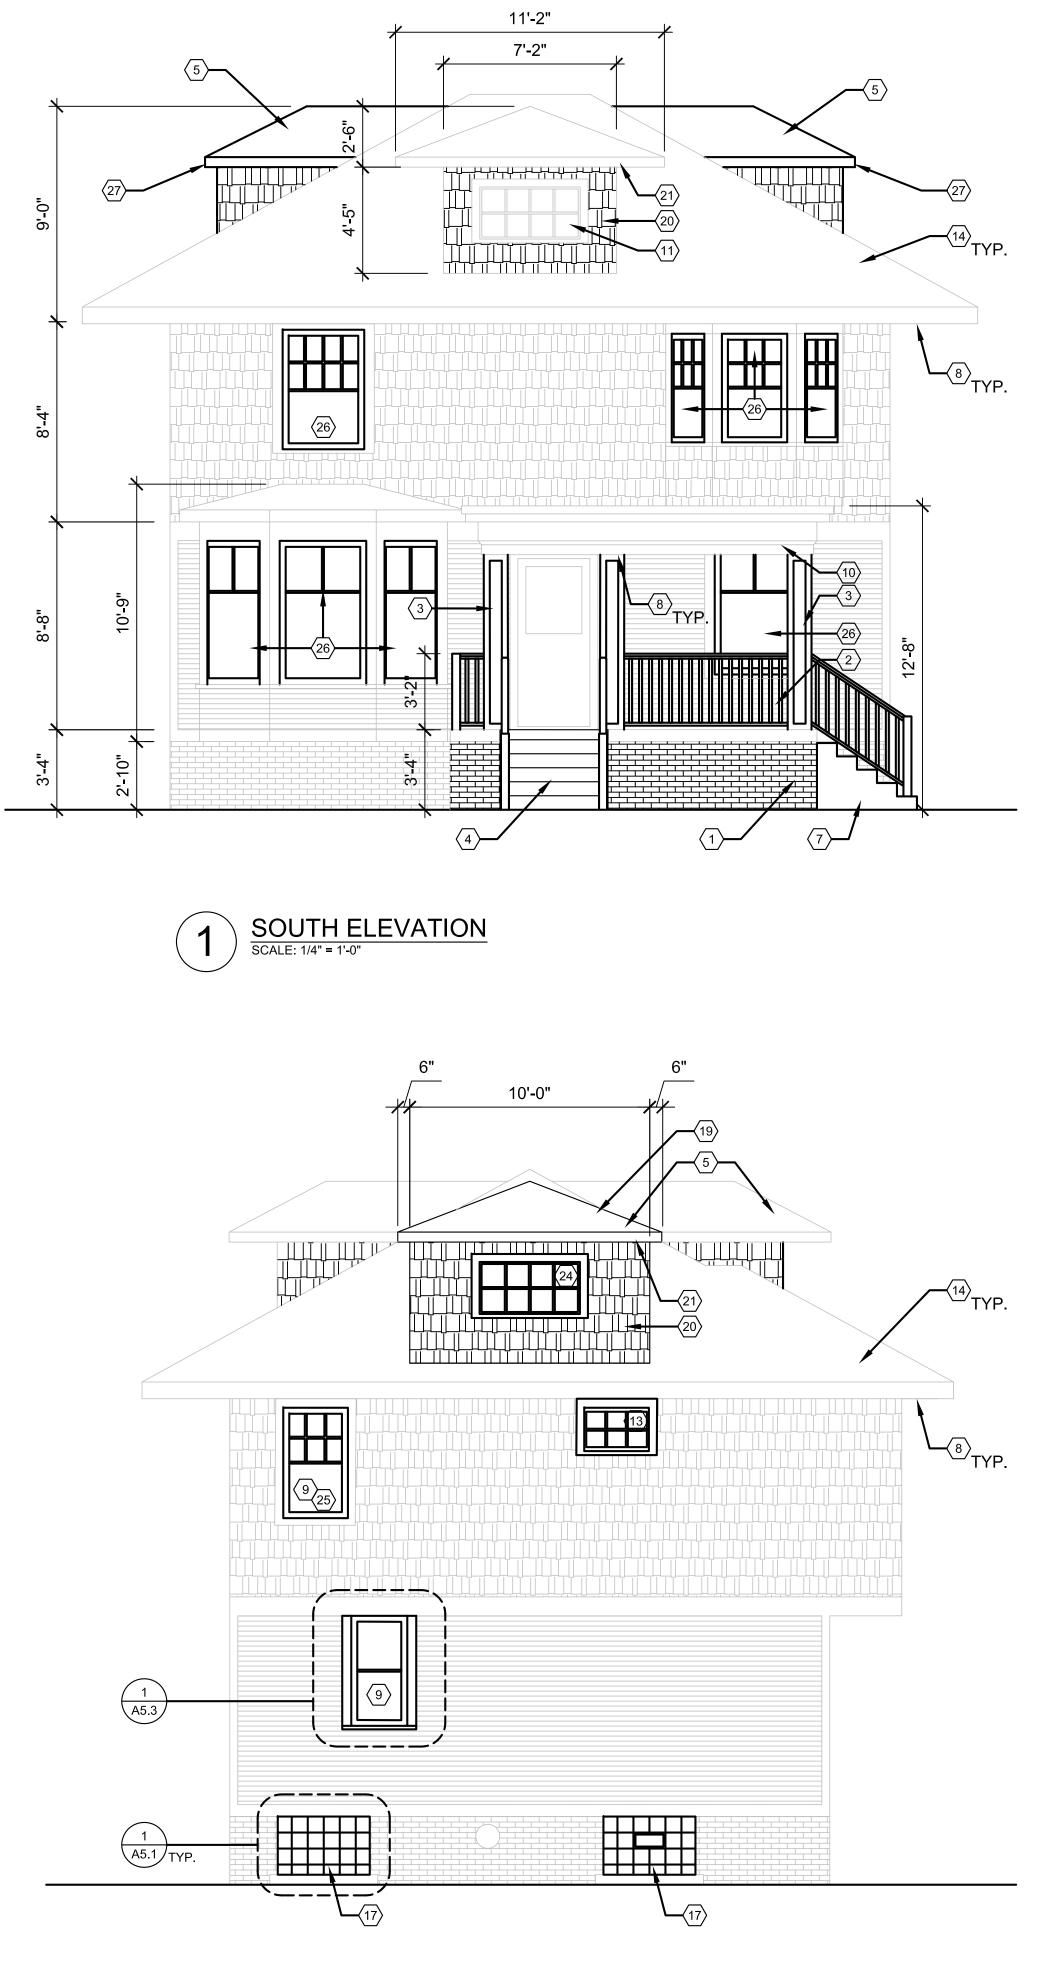



3 EAST ELEVATION SCALE: 1/4" = 1'-0"



		ARCHITECT:
-	EVATION KEY NOTES:	4545 architecture
(TYP	ICAL THIS SHEET ONLY)	2761 E. JEFFERSON AVE STE 302
$\langle 1 \rangle$ $\langle 2 \rangle$	EXISTING MASONRY PORCH; ADDED BRICK VENEER, PAINTED TO MATCH EXISTING; WOOD RAILING, MIN. 36" TALL SEE A5.2 FOR BASIS OF DESIGN	DETROIT, MI 48207 P. 313.454.4545 TIM.FLINTOFF@4545ARCHITECTURE.COM
$\langle 3 \rangle$	PINE WRAPPED 4x4 WOOD POSTS, PAINTED WHITE	CONSULTANT:
$\overline{4}$	NEW MASONRY STAIR	
$\left< \underbrace{5}{} \right>$	NEW DORMER; ROOF SHINGLES TO MATCH EXISTING	
$\langle 6 \rangle$	NEW BACK DECK AND STAIR; BASIS OF DESIGN: TREX TRANSCEND COMPOSITE DECKING, COLOR 'SADDLE'	
$\langle 7 \rangle$	REPLACE DAMAGED MASONRY STAIR WITH NEW	
$\left< \frac{8}{9} \right>$	SOFFITS TO BE PATCHED & REPAIRED WITH IN-KIND MATERIALS EXIST. SINGLE-HUNG WINDOWS REPLACED W/ VINYL-CLAD WOOD SINGLE-HUNG, PAINTED	
(10)	BLACK; (ALREADY INSTALLED); ANDERSON 400 SERIES EXISTING PORCH ROOF TO REMAIN	
$\langle 11 \rangle$ $\langle 12 \rangle$	EXISTING WINDOW TO BE REPAIRED, REPAINTED (BLACK) REPLACE INSTALLED WINDOW WITH: ANDERSON 400 SINGLE HUNG WINDOW IN BLACK, WITH SIMULATED DIVIDED LITES AS SHOWN	
(13)	REPLACE INSTALLED WINDOW WITH: ANDERSON 400 AWING WINDOW IN BLACK, WITH SIMULATED DIVIDED LITES AS SHOWN	
(14)	ROOF TO BE REPAIRED AS REQ'D USING IN-KIND MATERIALS; ROOF TO BE SHINGLED WITH CERTAINTEED LANDMARK PRO ASPHALT ROOF SHINGLES IN CINDER BLACK	
(15)	REPLACE INSTALLED DOUBLE DOOR WITH: FRENCH DOOR, BASIS OF DESIGN: ANDERSON E-SERIES HINGED PATIO DOOR IN BLACK WITH 'SHORT FRACTIONAL' GRILLE STYLE.	
(16)	COMPOSITE RAILING, MIN, 36" TALL; SEE A5.2 FOR BASIS OF DESIGN	
(17)	REPLACE EXIST. BASEMENT WINDOWS WITH GLASS BLOCK (ALREADY INSTALLED); RESET GLASS BLOCK TO ENSURE INSTALLATION IS INSET INTO ORIGINAL WINDOW PLANE	
(18)	REPLACE INSTALLED WINDOW WITH: ANDERSON 400 CASEMENT WINDOW IN BLACK, WITH SIMULATED DIVIDED LITES AS SHOWN	
(19)	GABLE DORMER ROOF TO BE REPLACED WITH HIP ROOF TO MATCH EXISTING	
< <u>20</u> >	INSTALLED COMPOSITE SIDING TO BE REPLACED WITH WOOD SHAKE SIDING, TO MATCH EXISTING, AND PAINTED TO MATCH EXISTING	Project :
$\langle 21 \rangle$	ARTIFICIAL ROOF EAVE COVER(S) TO BE REMOVED; REPLACED WITH WOOD EAVE	708 PALLISTER HDC RENOVATION
(22)		HEO HENOVATION
$\langle 23 \rangle$	LOCATION OF ELECTRIC METER - PLACED BY DTE ENERGY COMPANY INSTALL "FAKE" WINDOW (DRYWALL INTERIOR OF WINDOW, PAINT INSIDE FACE OF	
(24)	DRYWALL WHITE); WINDOW TO BE ANDERSON 100 CASEMENT WINDOW IN BLACK, WITH SIMULATED DIVIDED LITES AS SHOWN	
$\langle 25 \rangle$ $\langle 26 \rangle$	SIMULATED DIVIDED LITES TO BE PLACED IN PREVIOUSLY INSTALLED WINDOWS AS SHOWN REPLACE INSTALLED WINDOW WITH ALUMINUM-CLAD COTTAGE STYLE DOUBLE-HUNG	
~~~~~~~~~~~~~~~~~~~~~~~~~~~~~~~~~~~~~~~	WOOD WINDOW (ANDERSON E-SERIES) IN BLACK, WITH SIM. DIVIDED LITES TO MATCH ORIGINAL AS SHOWN	
<u> </u>	DORMER EAVE TO BE LOWERED 6" TO ALIGN W/ EXISTING FRONT AND REAR DORMERS	
	GENERAL NOTE: ROOF, EXTERIOR CLADDING TO BE PATCHED AND REPAIRED AS REQ'D. ALL REPAIRS TO USE IN-KIND MATERIALS. HOUSE TO BE PAINTED IN ACCORDANCE WITH HDC COLOR SYSTEM E	
	ALL SIDING TO BE C:4 YELLOWISH WHITE ALL TRIM AND SASH TO BE B:19 BLACK	Issued for :
	SEE A6.1 FOR COLOR RENDER	HDC SUBMIT 04/21/2025
	PLLC PLLC	
	chitect	
		Drawn by : ANJ
	Flintoff A	Check by:
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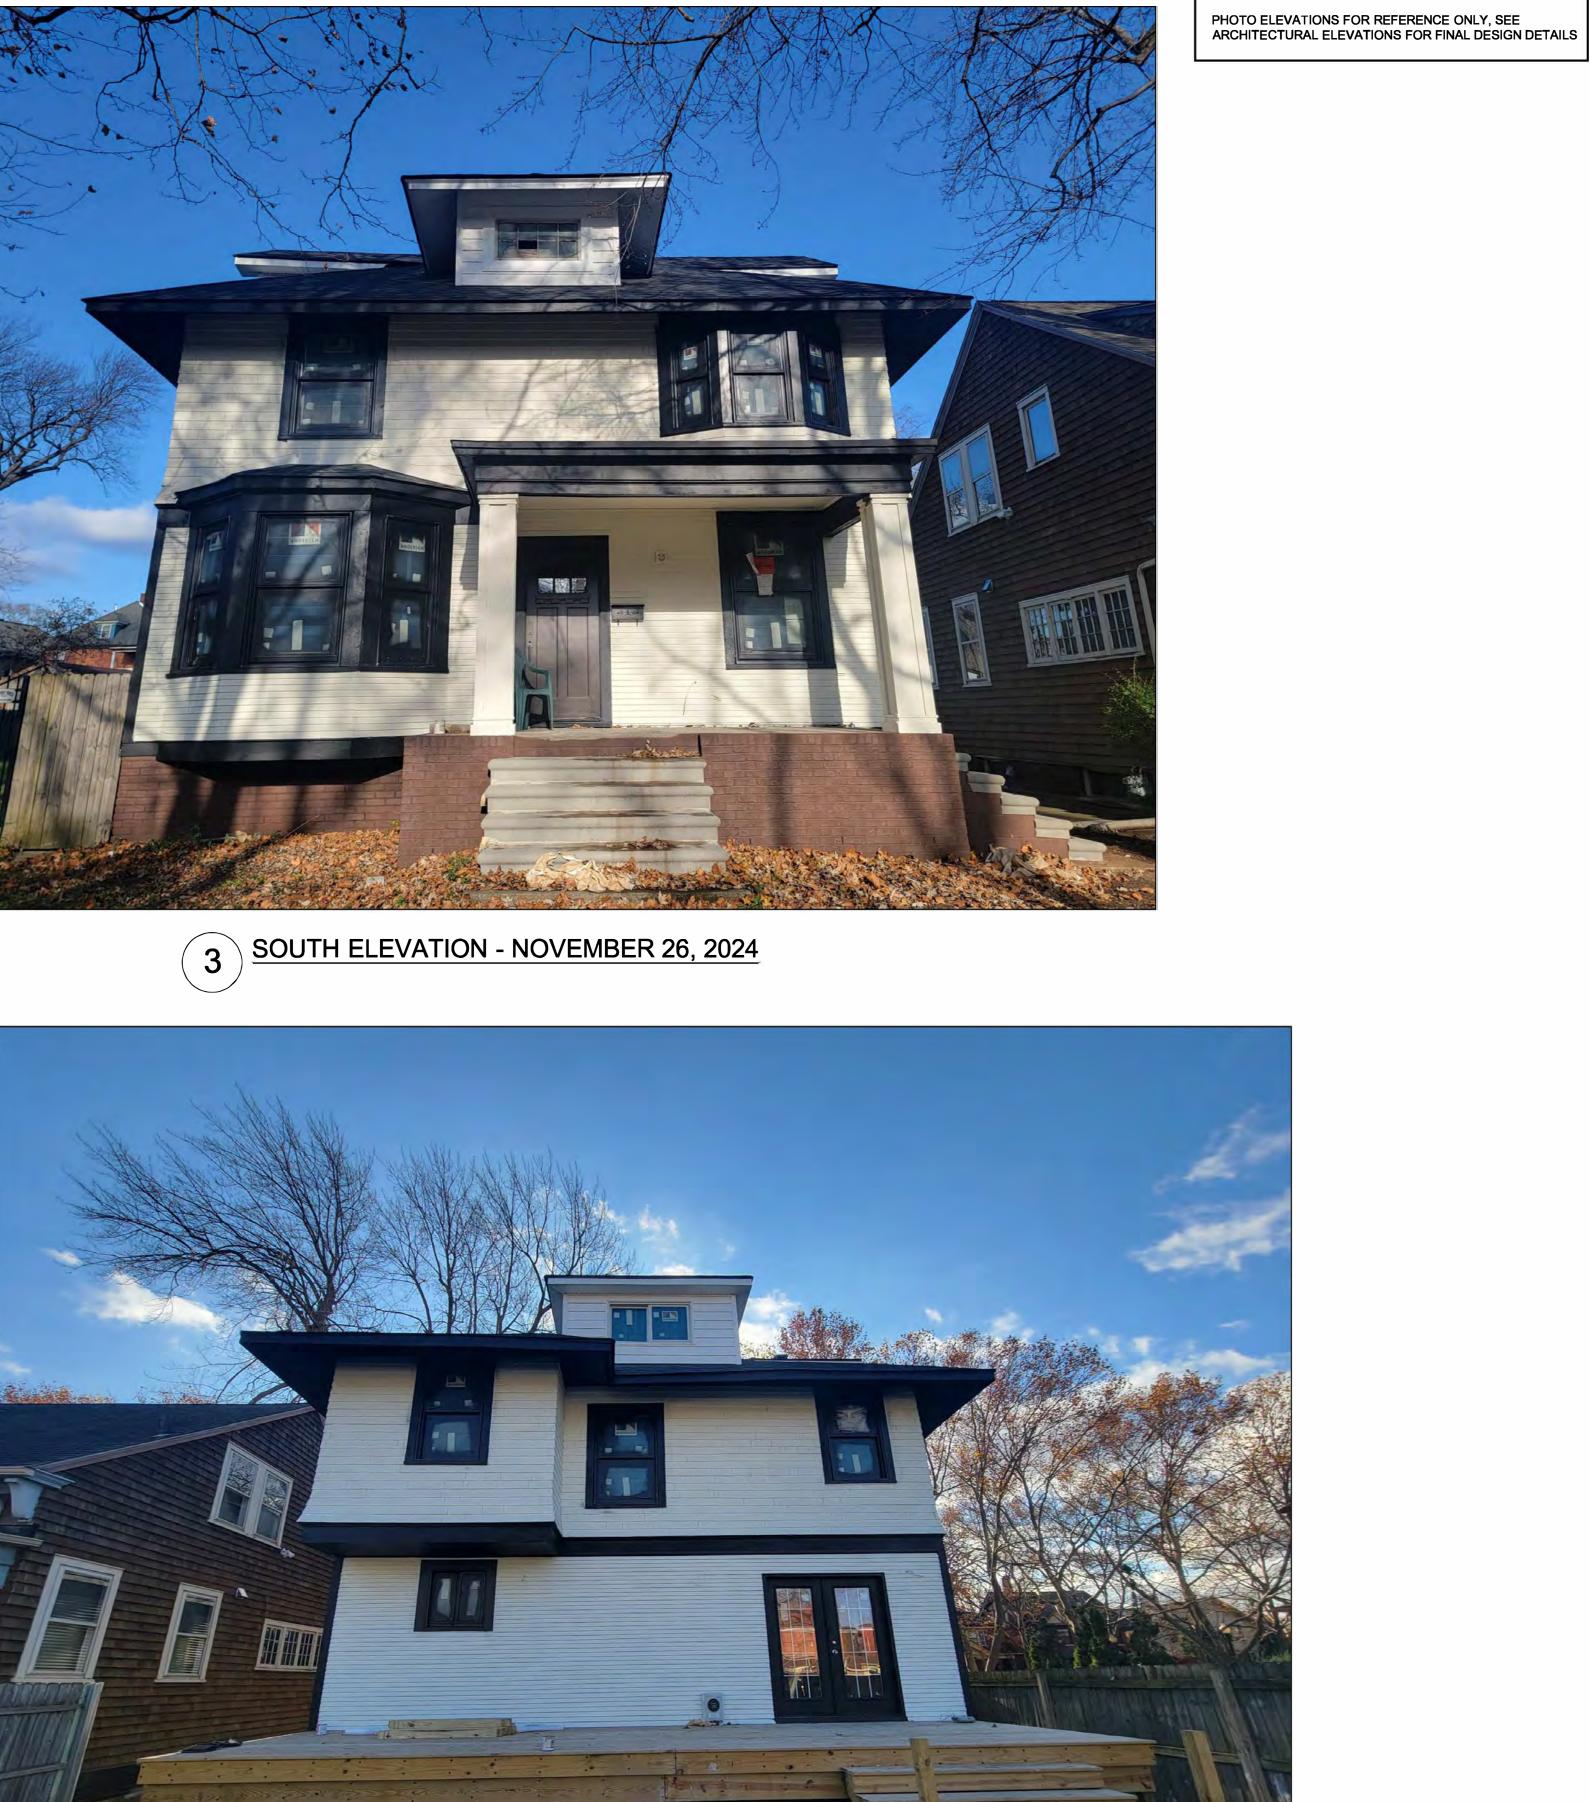
GE	ENERAL FLOOR PLAN NOTES:	
	THIS DRAWING IS DIAGRAMMATIC AND SHOULD BE USED TO DETERMINE THE DESIGN INTENT. THE CONTRACTOR IS RESPONSIBLE FOR THE COMPLETE SET OF WORK AS INDICATED AND SHALL FIELD VERIFY ALL WORK, COORDINATE ALL DRAWINGS / NEW WORK AND SHALL NOTIFY ARCHITECT IMMEDIATELY OF ANY DISCREPANCIES IN THE DOCUMENTS BEFORE PROCEEDING. FAILURE TO DO SO WILL RESULT IN THE CONTRACTOR TAKING FULL RESPONSIBILITY AND LIABILITY FOR SAID DISCREPANCIES.	2761 E. JEFFERSON AVE STE 302 DETROIT, MI 48207 P. 313.454.4545 TIM.FLINTOFF@4545ARCHITECTURE.COM
2.	ALL DIMENSIONS ARE SHOWN FROM FINISH FACE TO FINISH FACE OF PARTITION UNLESS OTHERWISE NOTED.	CONSULTANT:
	WALL THICKNESS' ARE NOMINAL NOT ACTUAL DIMENSIONS. SEE WALL SCHEDULE FOR ACTUAL DIMENSIONS.	
	ALL WORK SHALL BE DONE IN ACCORDANCE WITH ALL LOCAL, STATE, COUNTY CODE REGULATIONS, O.S.H.A., AND THE AMERICAN WITH DISABILITIES ACT	
5.	(ADA). REFER TO THE CODE PLAN FOR MORE INFORMATION. PROVIDE POSITIVE SLOPE TO ALL FLOOR DRAINS WHILE KEEPING FLOOR LEVEL AT WALL BASE CONDITION.	
PI	AN KEY NOTES:	
	PICAL THIS SHEET ONLY)	
$\langle 1 \rangle$	LINE OF WALLS BELOW	
$\left< \frac{2}{3} \right>$	NEW DORMER ROOF TO REMAIN EXISTING ROOF TO BE REPAIRED WITH IN-KIND MATS. AS REQ'D (TYP.)	
<u> </u>	SHINGLES TO BE REPLACED WITH CERTAINTEED LANDMARK PRO ROOF SHINGLES IN CINDER BLACK	
$\langle 4 \rangle$	FINAL LAYOUT OF INTERIOR KNEE WALLS TO BE DETERMINED BY EXISTING CONDITIONS AND OWNER INTERIOR CONFIGURATIONS, COORDINATE WITH OWNER (WORK COMPLETED)	
$\left< 5 \right>$	NEW WINDOW, SEE ELEVATIONS	
6	DORMER ROOF TO BE REMOVED, REPLACED WITH COORDINATING GABLE ROOF, SEE ELEVATIONS	
	GENERAL NOTE: SEE A4.1 FOR ROOF FRAMING PLAN	
		Project :
		708 PALLISTER HDC RENOVATION
		Issued for :
		HDC SUBMIT 04/21/2025
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	•	Drawn by : ANJ
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	Timothy	3RD FLOOR AND ROOF PLAN
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		Project No. :
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1 SOUTH ELEVATION - JANUARY 2024



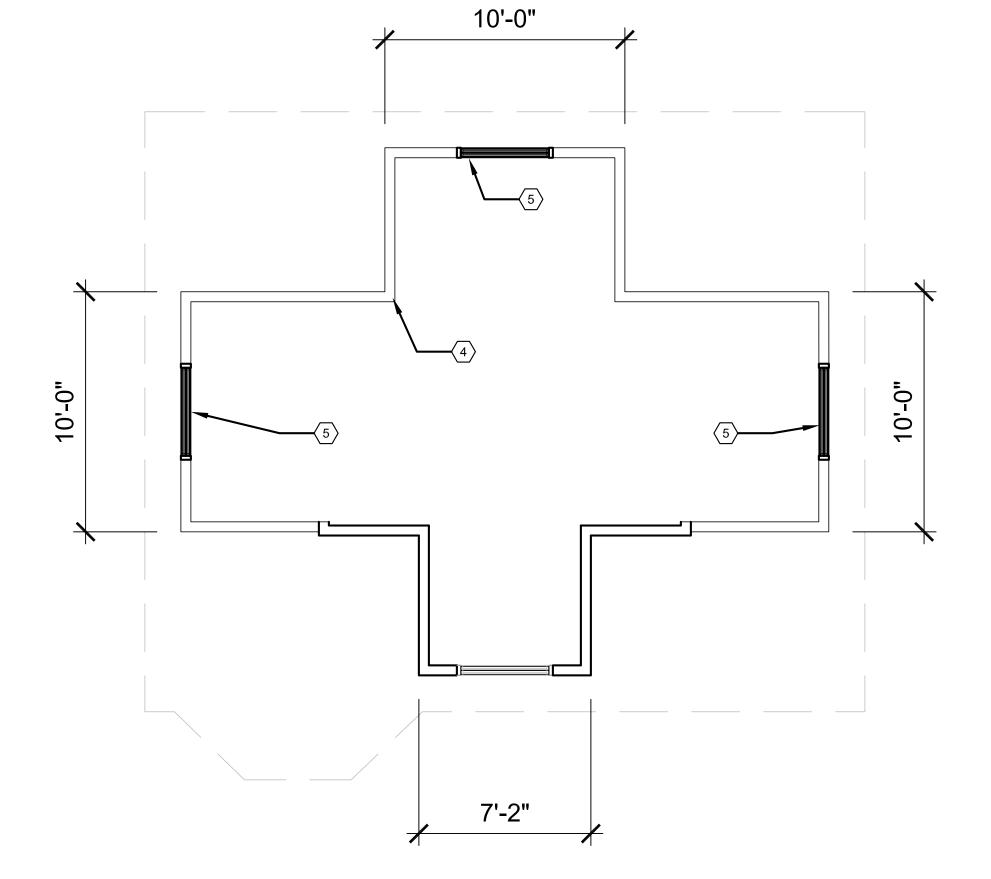

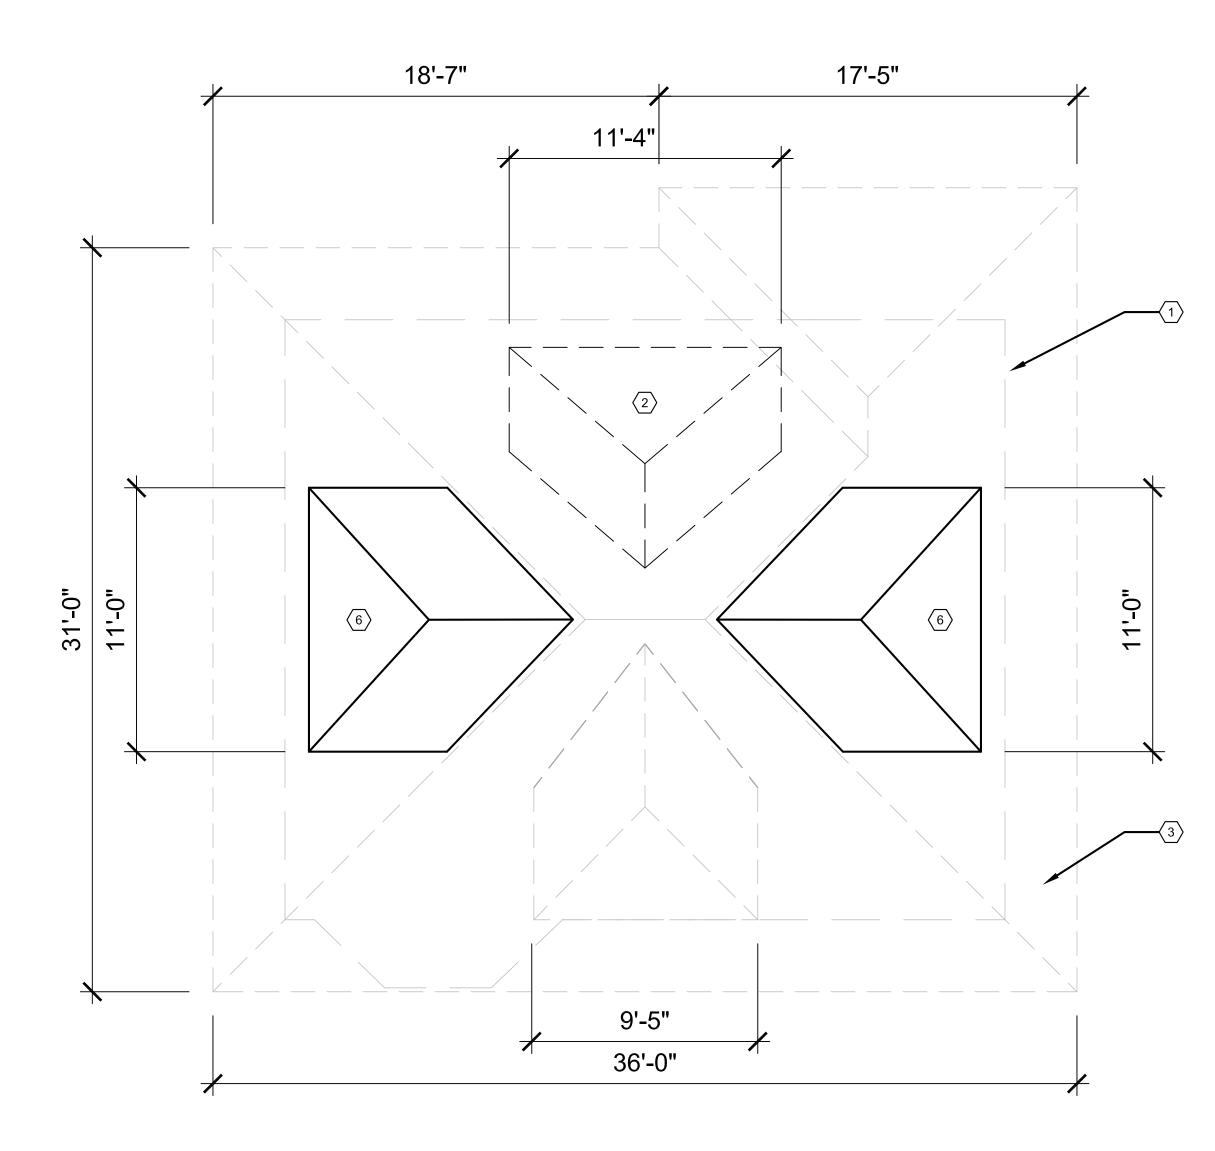






4 NORTH ELEVATION - NOVEMBER 26, 2024

	ARCHITECT:
	4545 architecture
	2761 E. JEFFERSON AVE STE 302 DETROIT, MI 48207 P. 313.454.4545 TIM.FLINTOFF <b>0</b> 4545ARCHITECTURE.COM
	CONSULTANT:
	Project : <b>708 PALLISTER</b>
	HDC RENOVATION
	Issued for : HDC SUBMIT 04/21/2025
	STE OF MICH
	TIMOTHY R.
	ARCHITECT No. 1301064083
chitect, PLLC	STATED ARCHITE
Architec	Drawn by : ANJ
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Timothy	Sheet Title : EXTERIOR
©2024	ELEVATION PHOTOS
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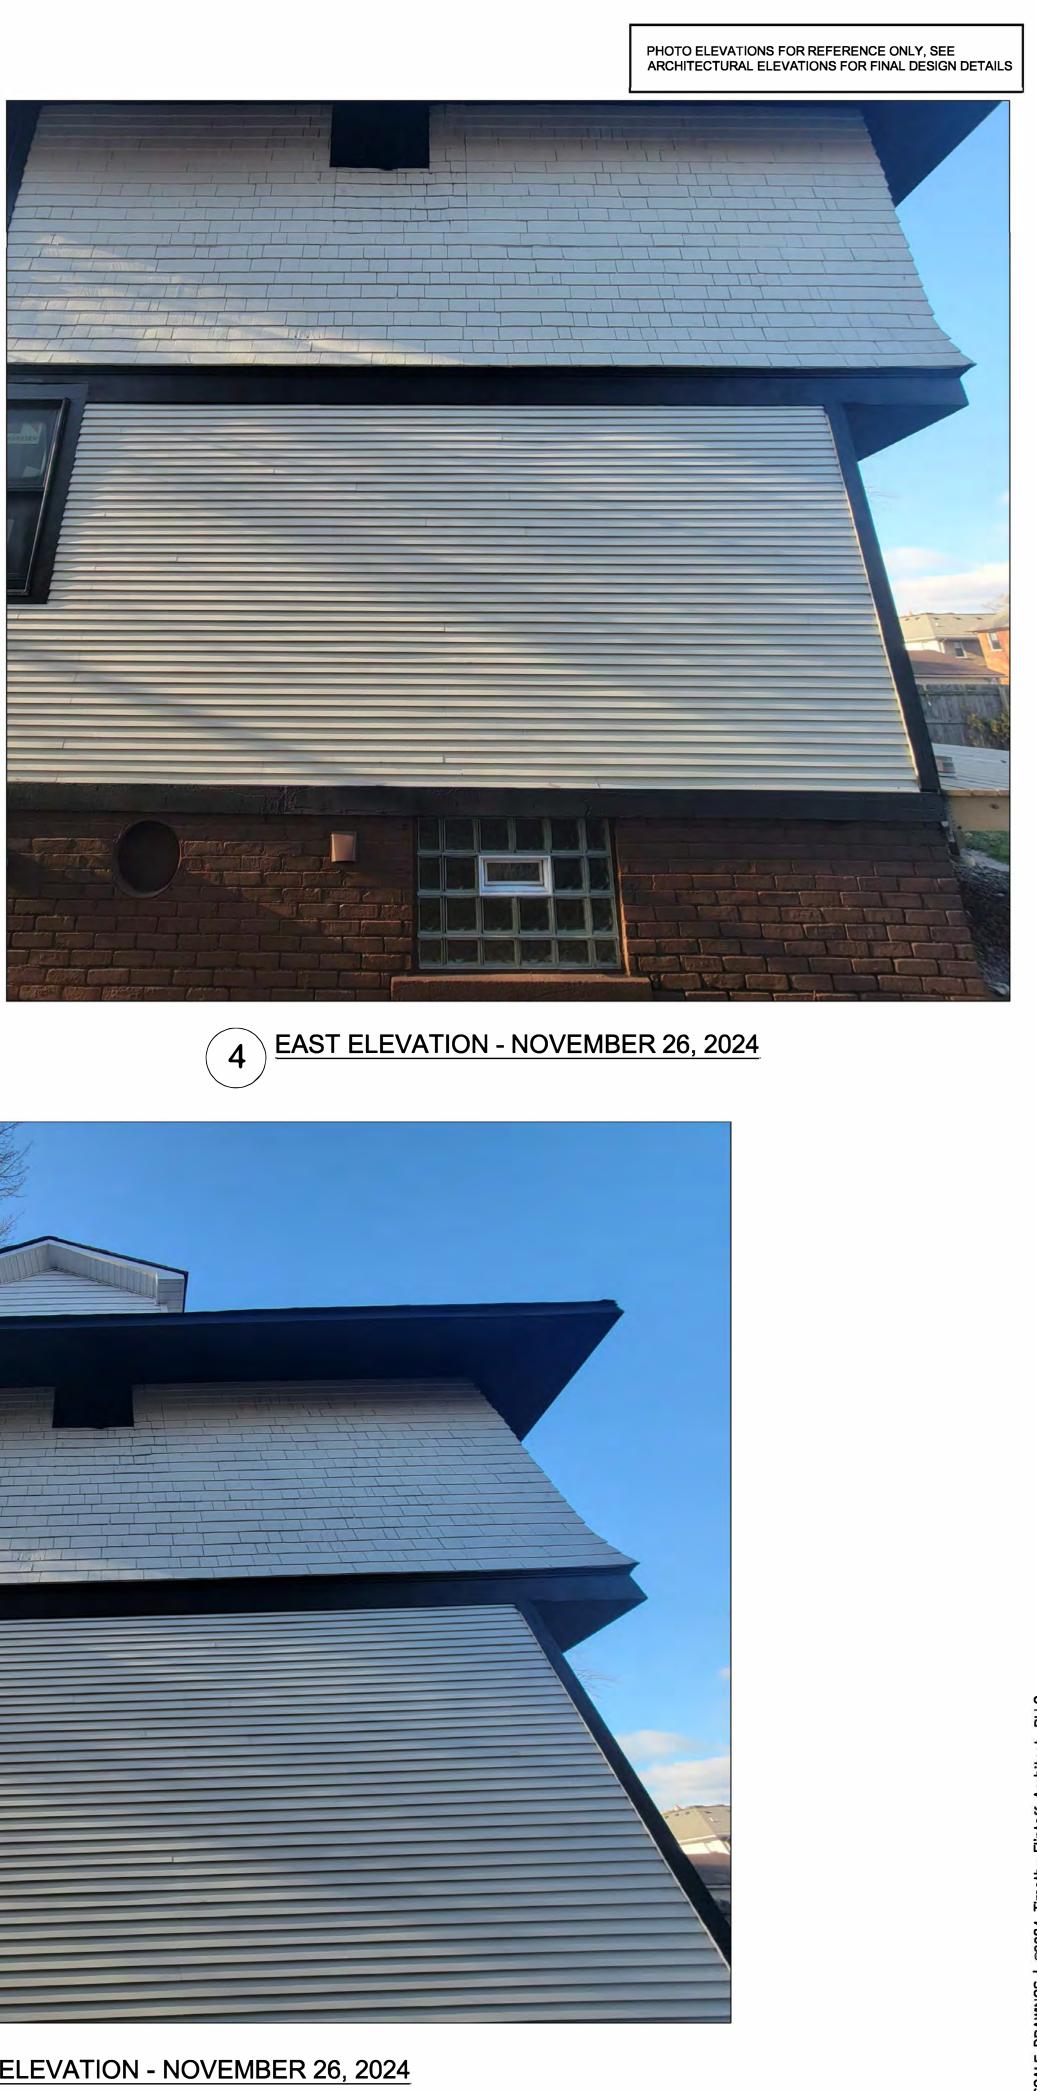


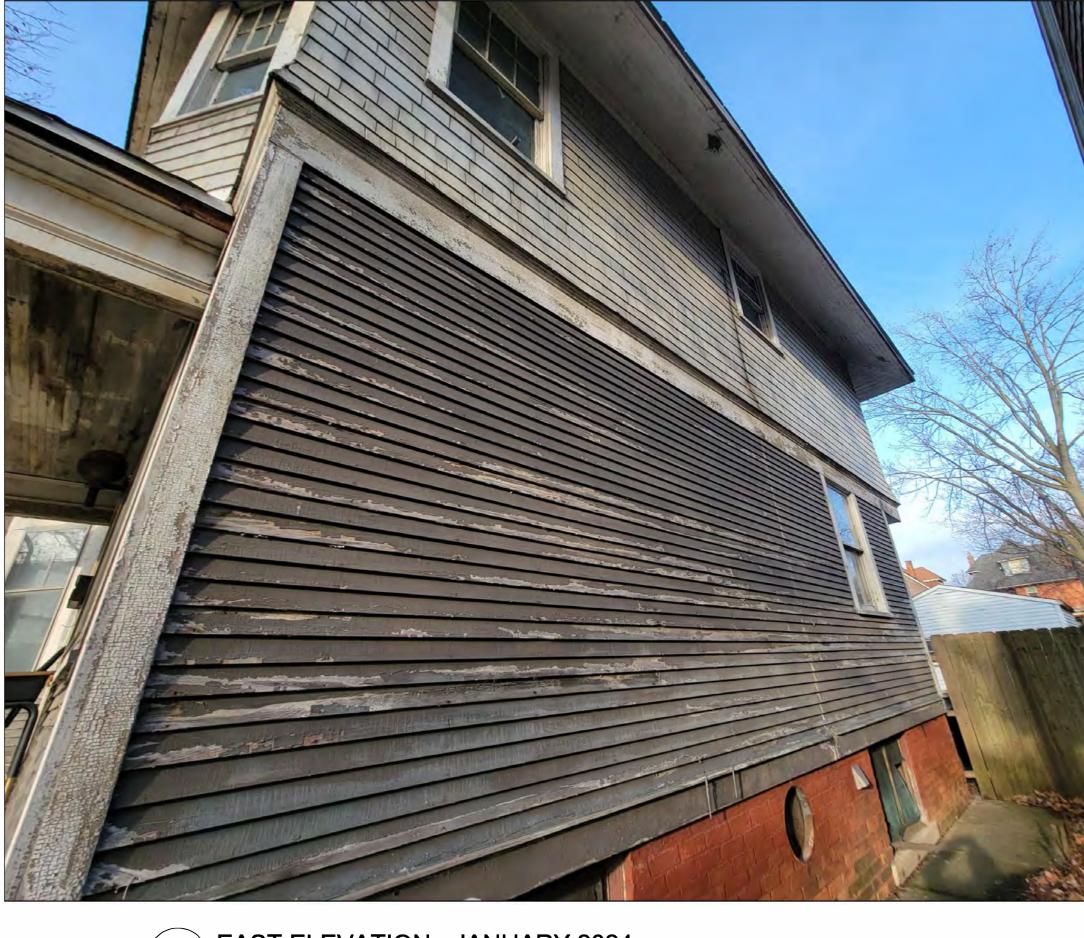














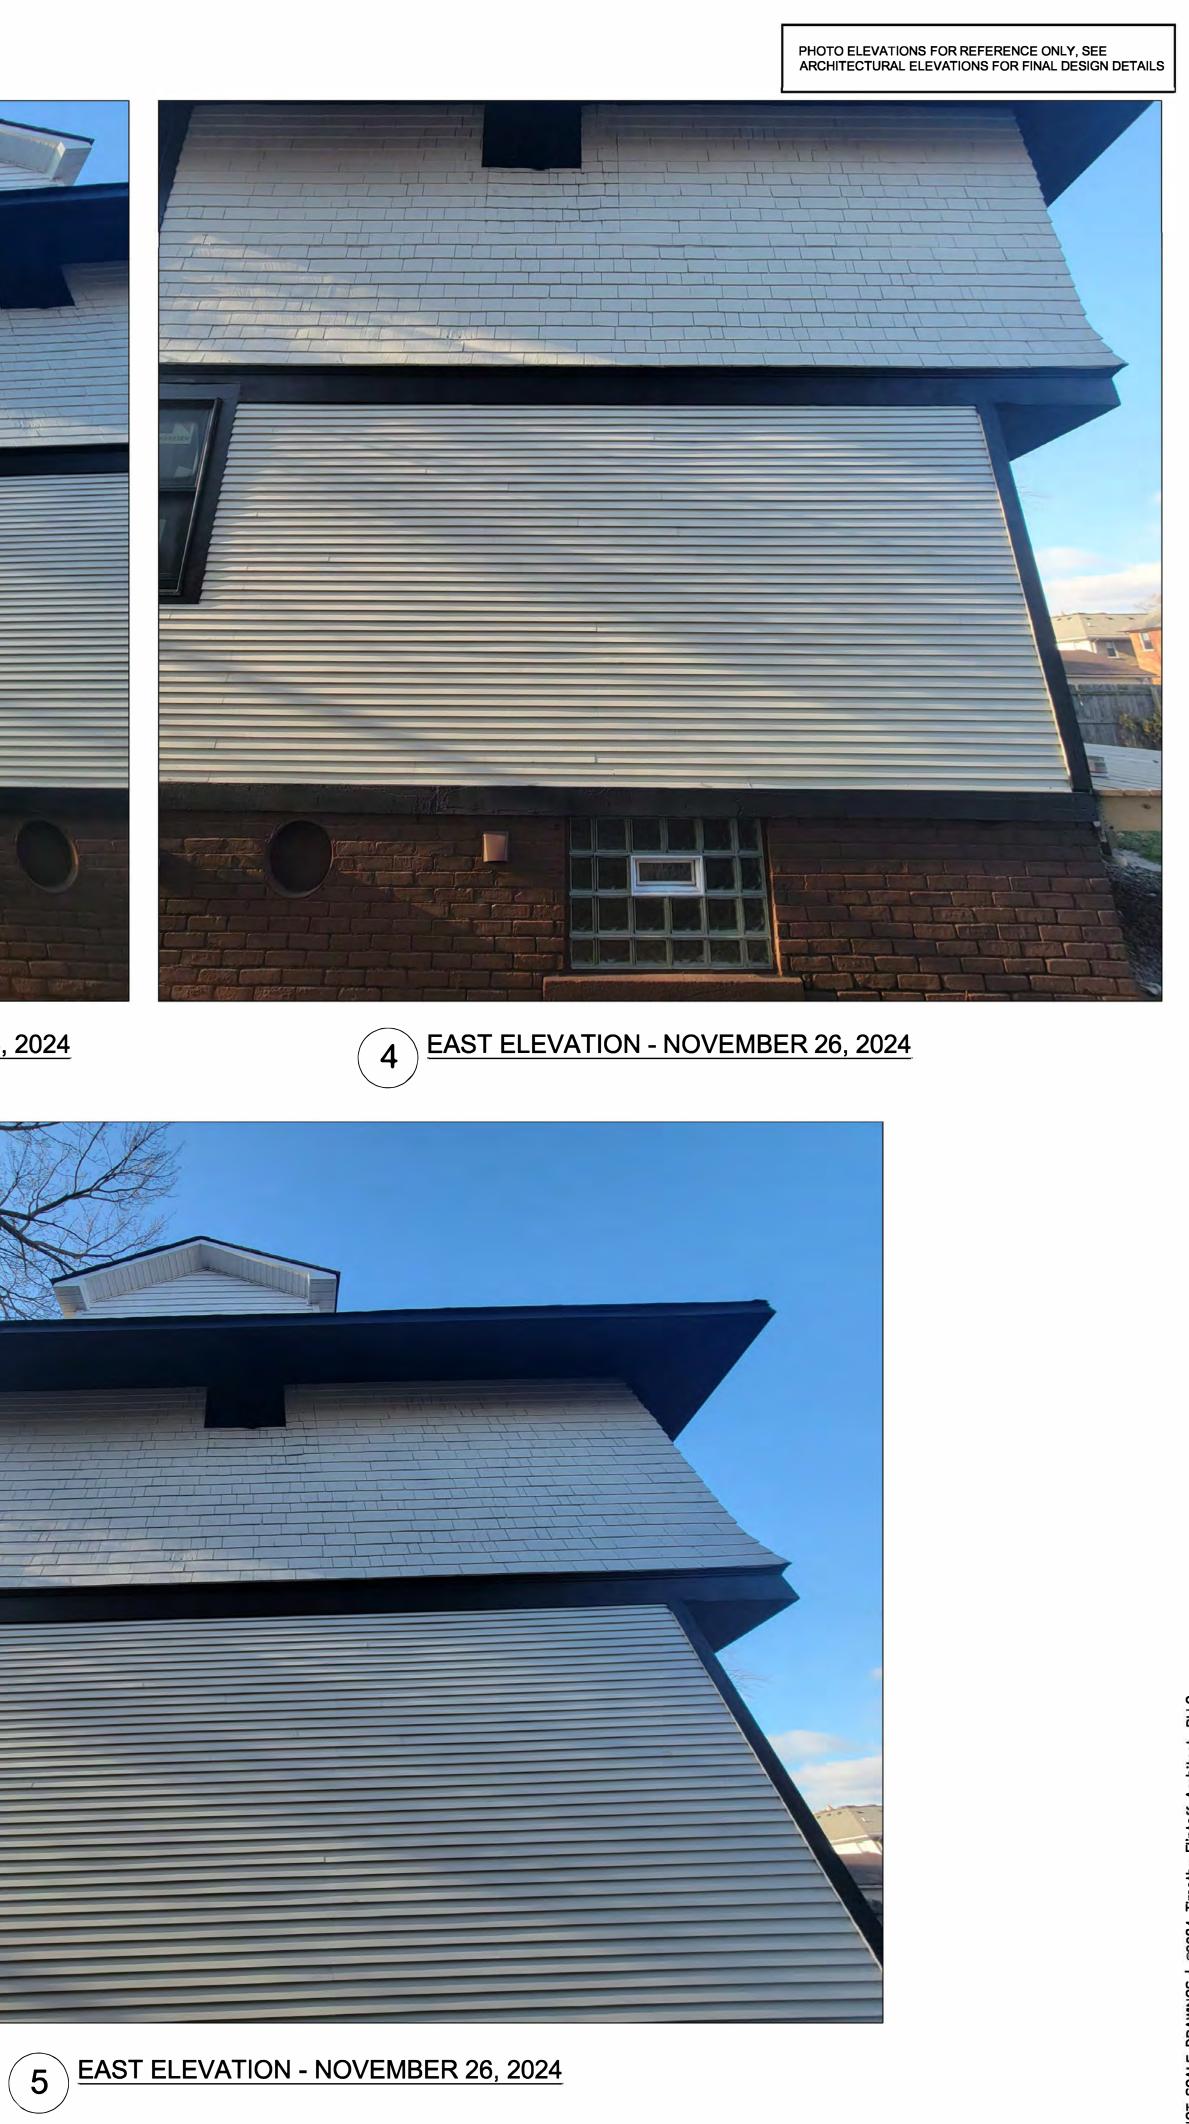


ARCHITECT:	
4545 architectur	е
2761 E. JEFFERSON AVE STE 302 DETROIT, MI 48207 P. 313.454.4545	
TIM.FLINTOFF <b>@4</b> 545ARCHITECTURE.CO	MC
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708 PALLISTER	
HDC RENOVATION	
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STATE OF MICHING	
FLINTOFF JR.	
No. 1301064083	
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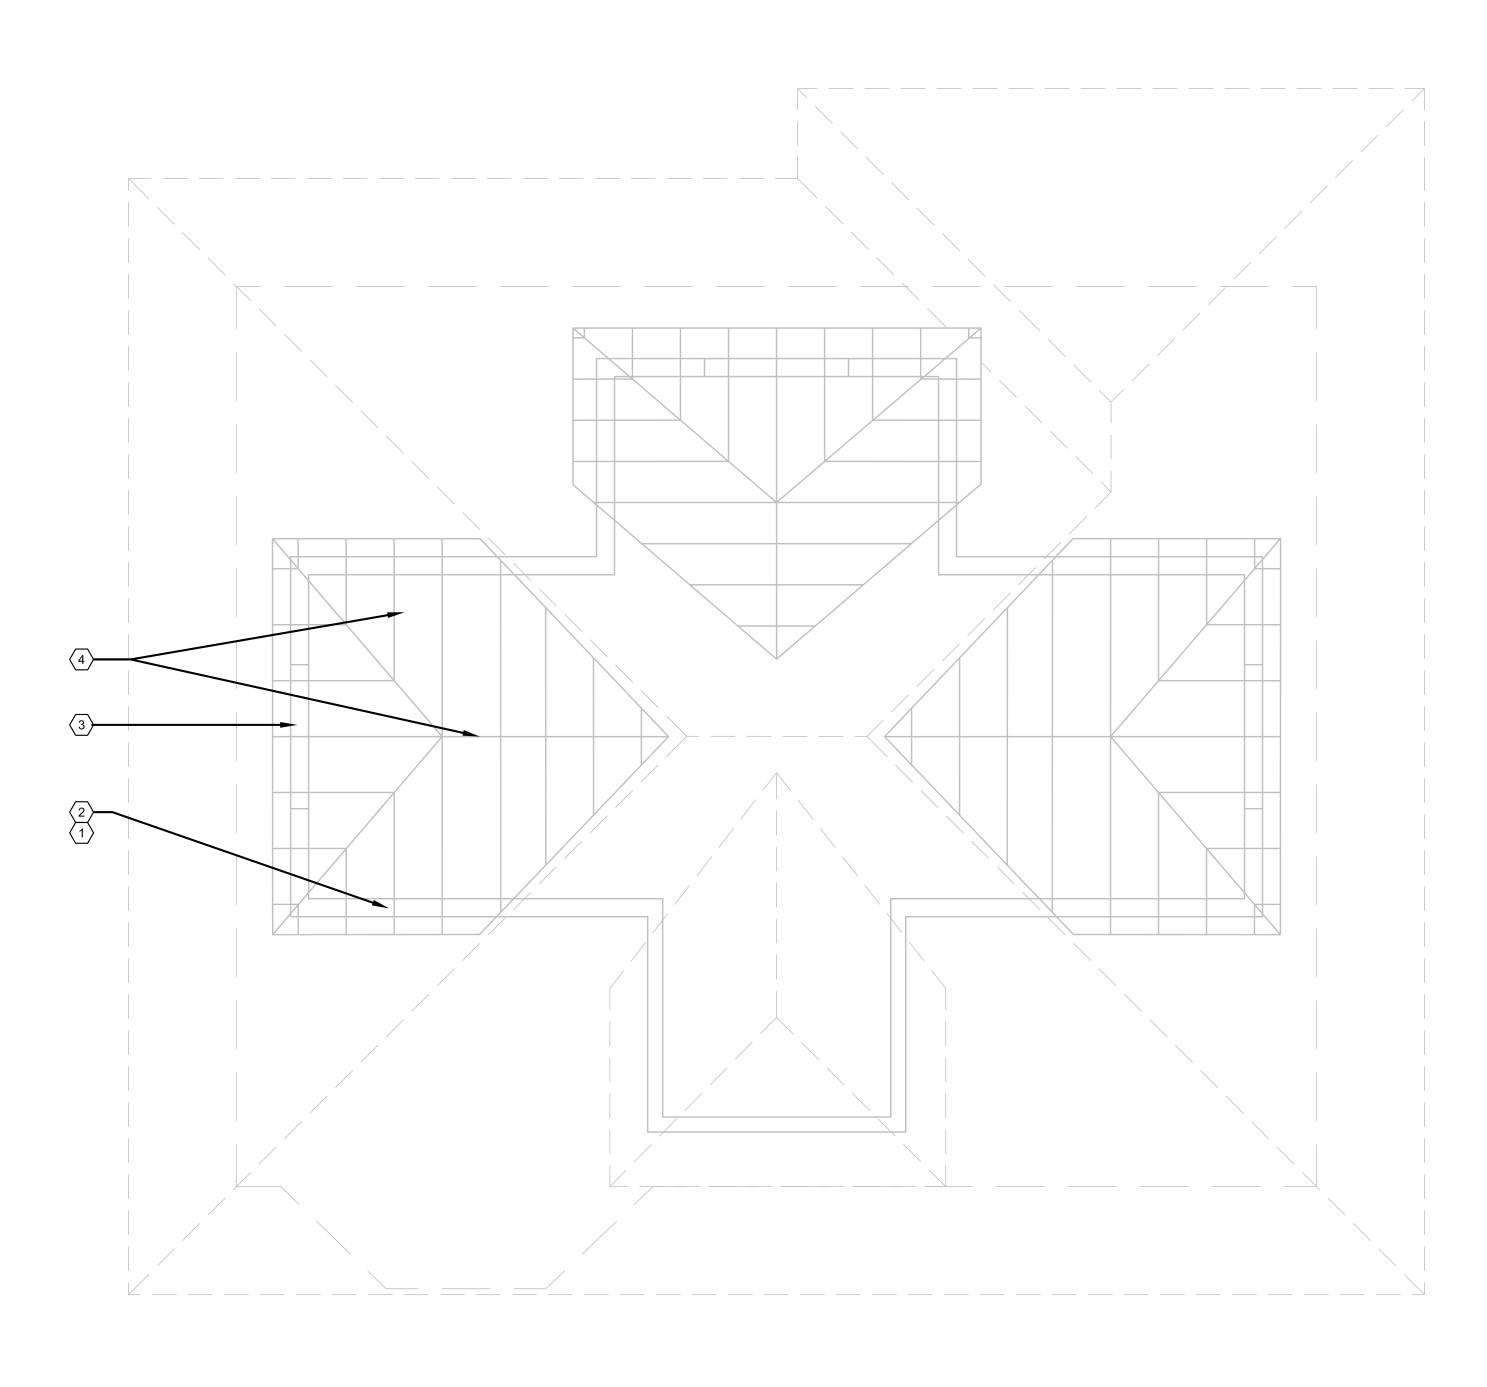



# 1 WEST ELEVATION - JANUARY 2024




2 WEST ELEVATION - NOVEMBER 26, 2024



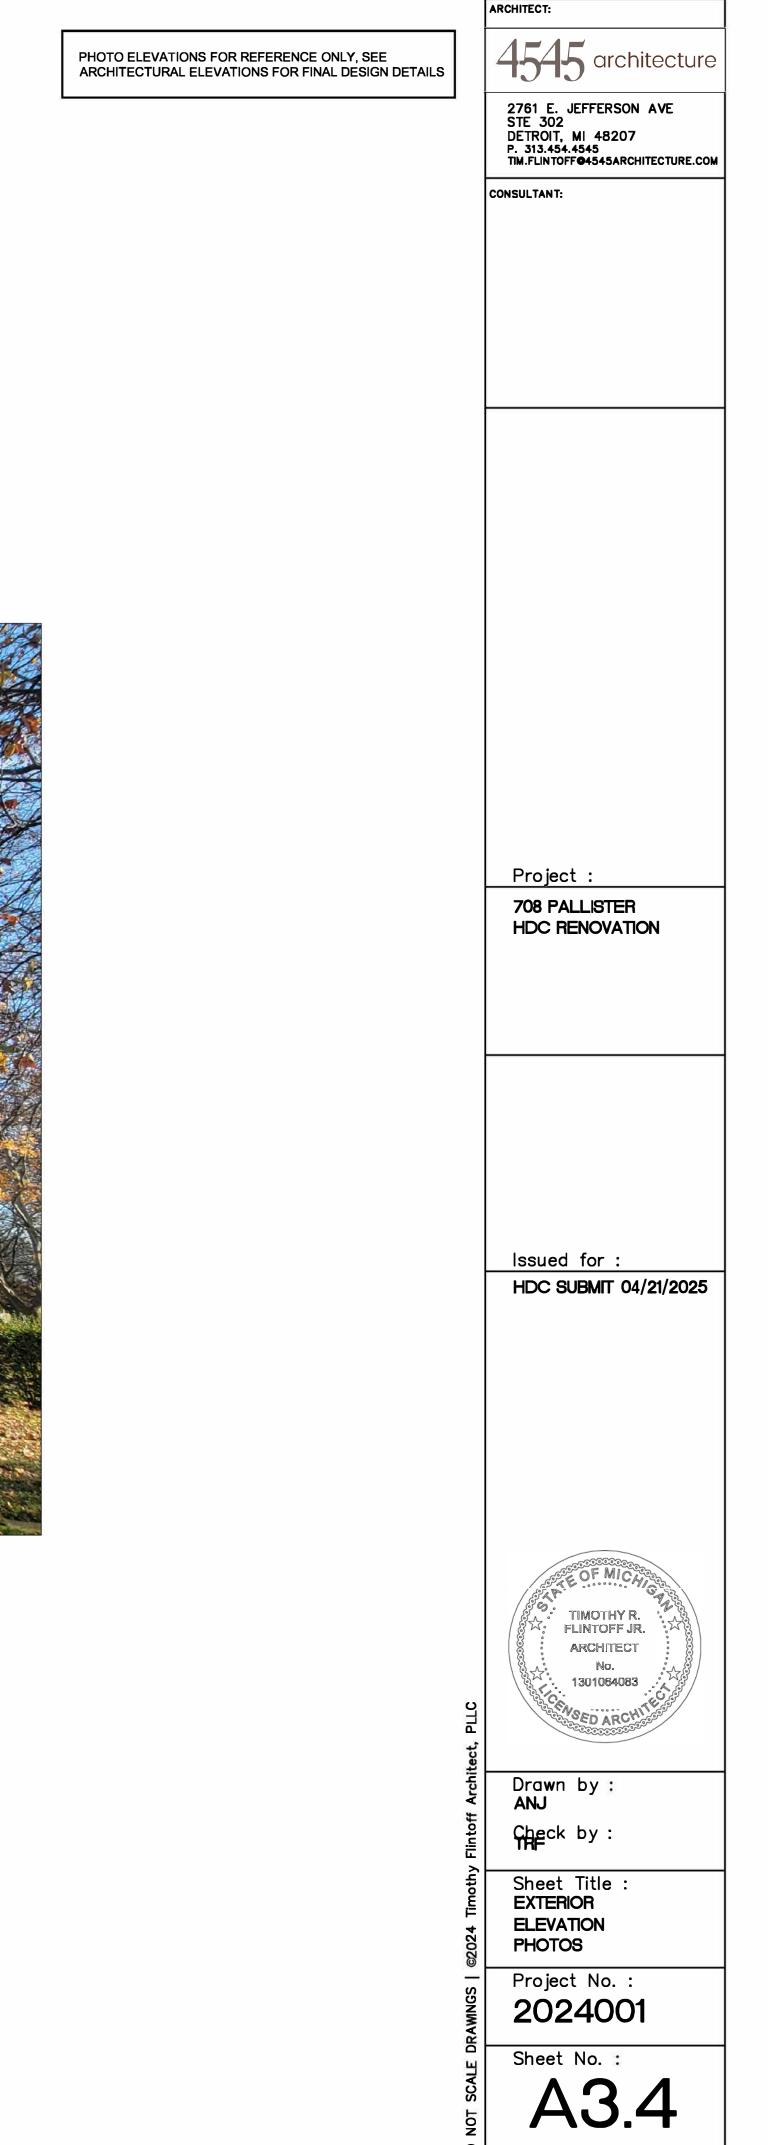

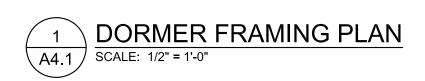

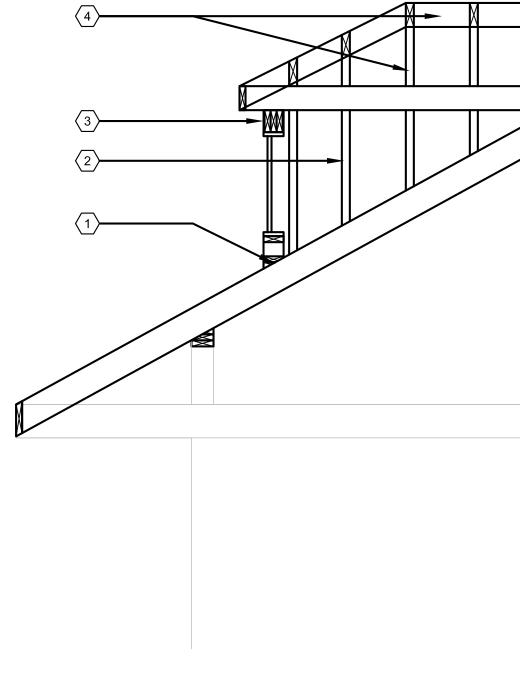

2 A4.1 DORMER FRAMING S SCALE: 1/2" = 1'-0"

	2761 E. JEFFERSON AVE STE 302 DETROIT, MI 48207 P. 313.454.4545 TIM.FLINTOFF@4545ARCHITECTURE.COM
	CONSULTANT:
PLAN KEY NOTES: (TYPICAL THIS SHEET ONLY)	_
<ul> <li>SISTER SIMILAR 2x</li> <li>2x6 WOOD STUD WALL</li> <li>3 2x6 DOUBLE HEADER</li> </ul>	
4 2x6 RIDGE BEAM AND RAFTERS	
	Project : 708 PALLISTER
	HDC RENOVATION
	Issued for : HDC SUBMIT 04/21/2025
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	John John John John John John John John
	Jutoff Architect, PLLC ANJ Check by : THE Sheet Title : DORMER
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	Project No. : 2024001

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708 PALLISTER HDC RENOVATION
lequed for .
Issued for : HDC SUBMIT 04/21/2025
Drawn by : ANJ Check by : TRE
Sheet Title :
DORMER FRAMING DETAILS
Project No. : 2024001
Sheet No. : <b>A4.1</b>

ARCHITECT:

4545 architecture









— PATCH AND REPAIR AS REQ'D WITH IN-KIND MATERIALS; PAINT (COLORS TO MATCH HOUSE, SEE ELEVATIONS) (TYP.)

- REPLACE EXISTING EXTERIOR DOOR AND HARDWARE











PATCH AND REPAIR AS REQ'D WITH IN-KIND MATERIALS; PAINT (COLORS TO MATCH HOUSE, SEE ELEVATIONS) (TYP.)

# Glass Block The Detroit Historic District Commission ("Commission") realizes that safety and energy concerns results in the desire to install glass block in basement window openings. While this treatment is not recommended, it may be acceptable provided certain conditions are met. The installation of glass block in historic districts is work that is regulated by the City of Detroit's Historic District Ordinance No. 161-H. Any proposal for the installation of glass block in a historic district shall meet the following applicable conditions: A. The glass block shall be located at the same plane as the existing historic window, set back from the face of the building wall. B. The glass block shall be covered with the historic screen placed back in the window or with a new screen. C. Glass block will only be permitted in basement window openings.

- D. Openings with glass block that are on the front or visible from a side street shall be screened with foundation plantings that cover the windows.
- E. All glass block installations require a permit and Commission approval
- F. See the drawing below for more information.

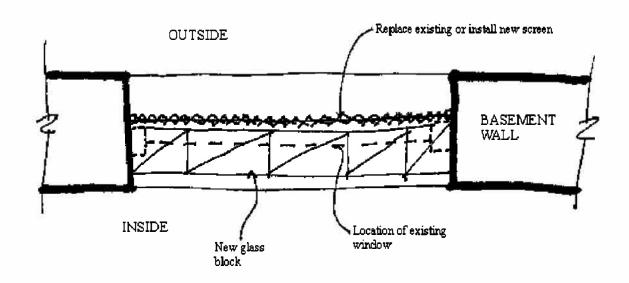



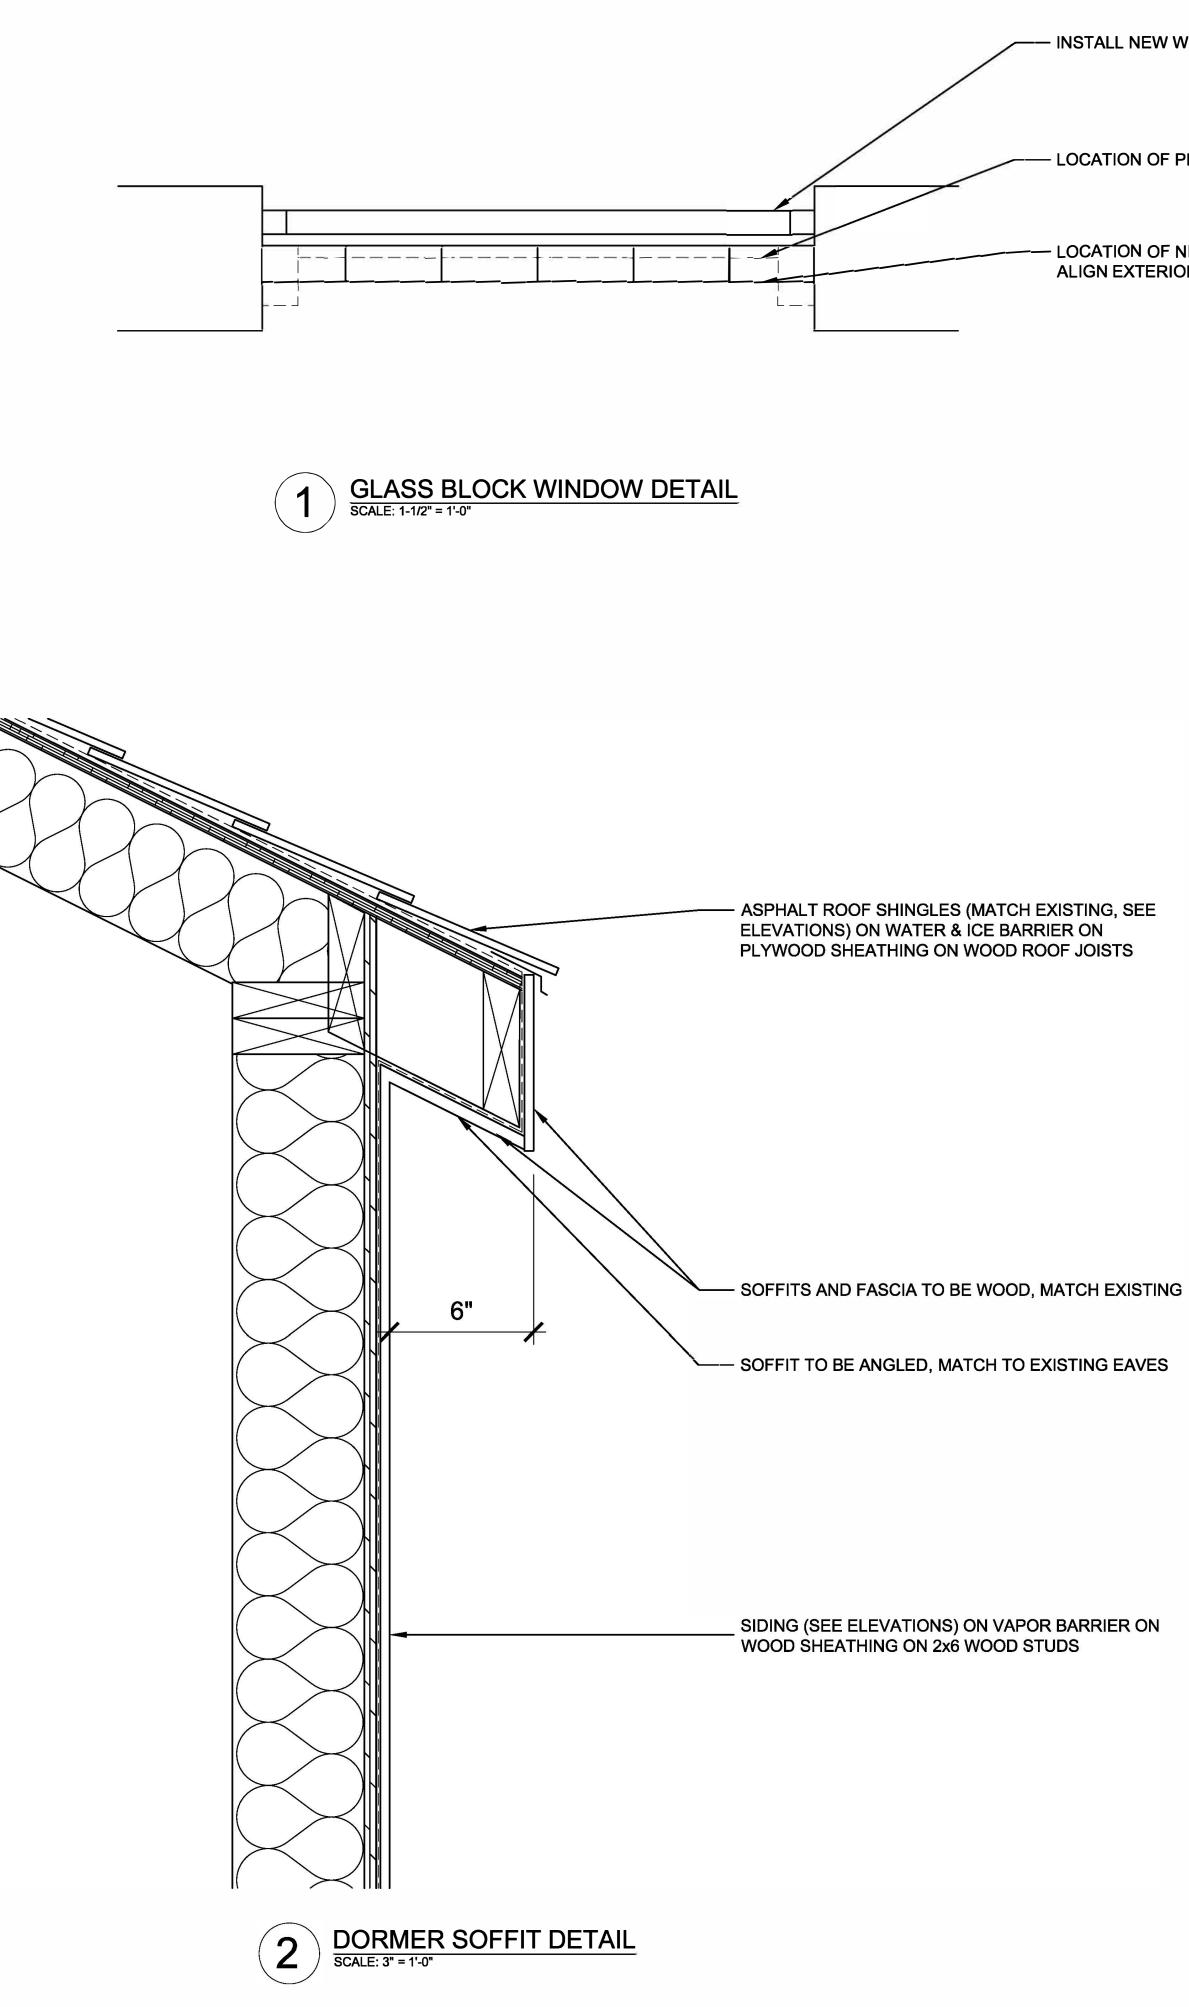

	ARCHITECT:
	4545 architecture
	2761 E. JEFFERSON AVE STE 302
	DETROIT, MI 48207 P. 313.454.4545 TIM.FLINTOFF <b>@4</b> 545ARCHITECTURE.COM
	CONSULTANT:
	Project : 708 PALLISTER
	HDC RENOVATION
	Issued for : HDC SUBMIT 04/21/2025
	COSTONO CONTRACTOR
	FLINTOFF JR.
	No.
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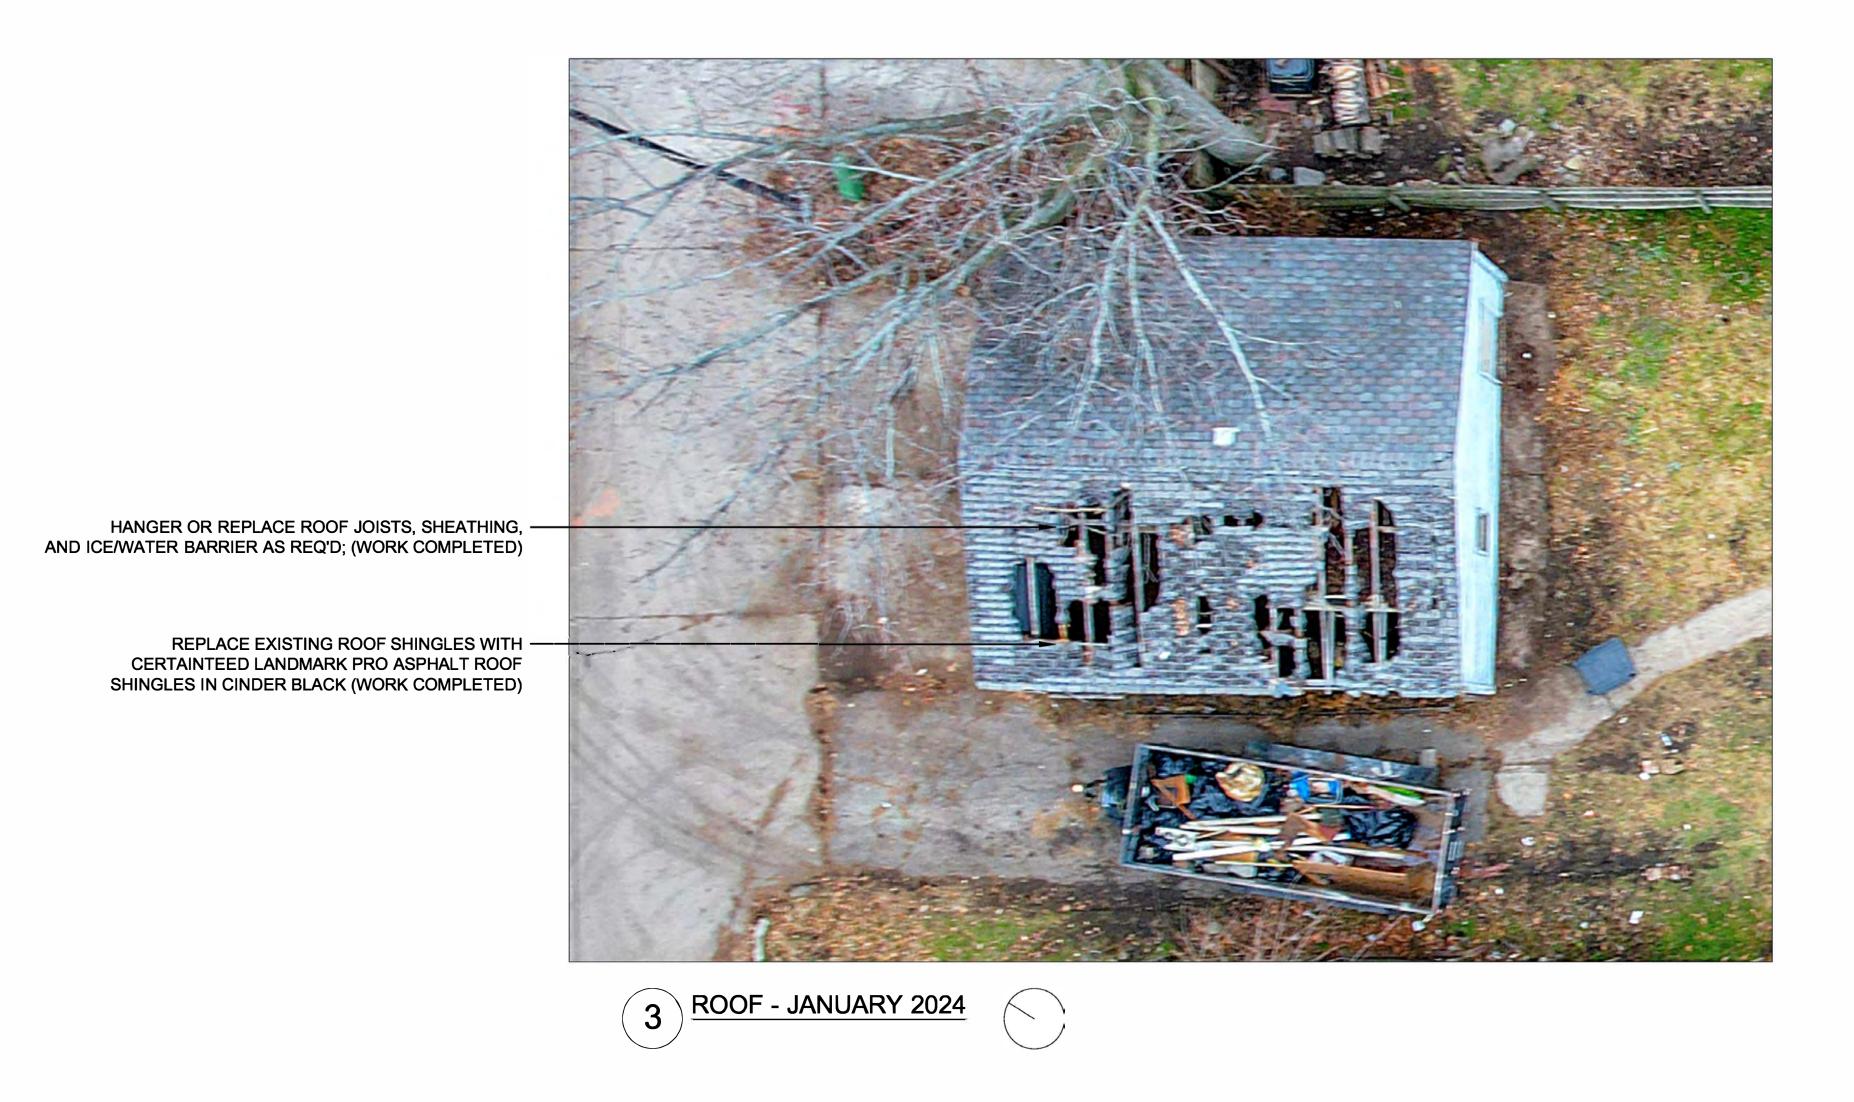
---- INSTALL NEW WINDOW SCREEN; MATCH EXISTING

- LOCATION OF PREVIOUS EXISTING WINDOW

- LOCATION OF NEW GLASS BLOCK; ALIGN EXTERIOR WITH OUTSIDE FACE OF PREVIOUS WINDOW









PATCH AND REPAIR AS REQ'D WITH IN-KIND MATERIALS; PAINT (COLORS TO MATCH HOUSE, SEE ELEVATIONS) (TYP.)



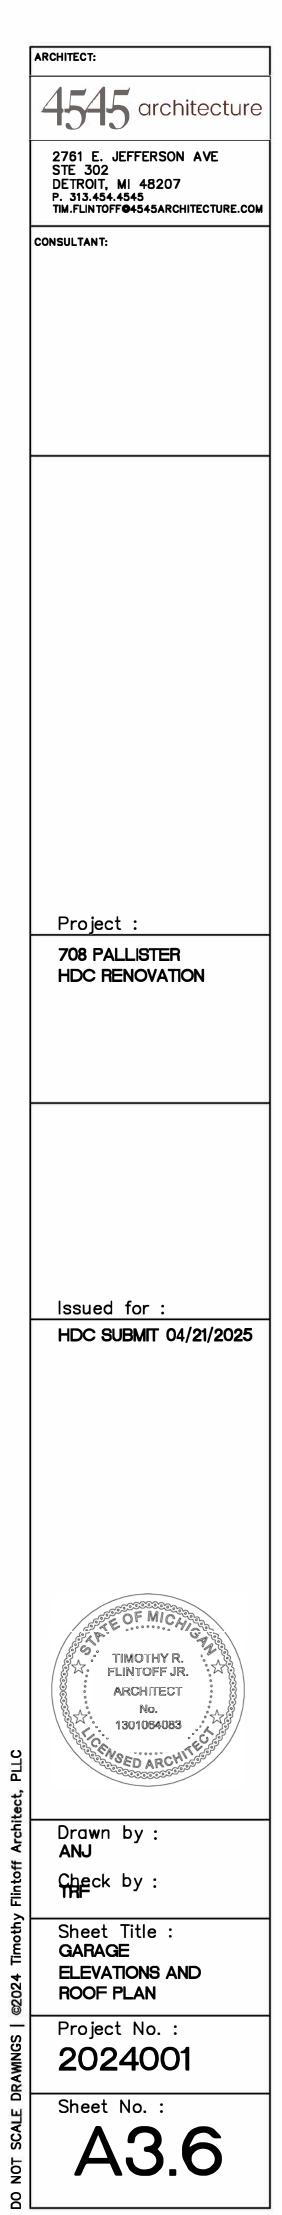

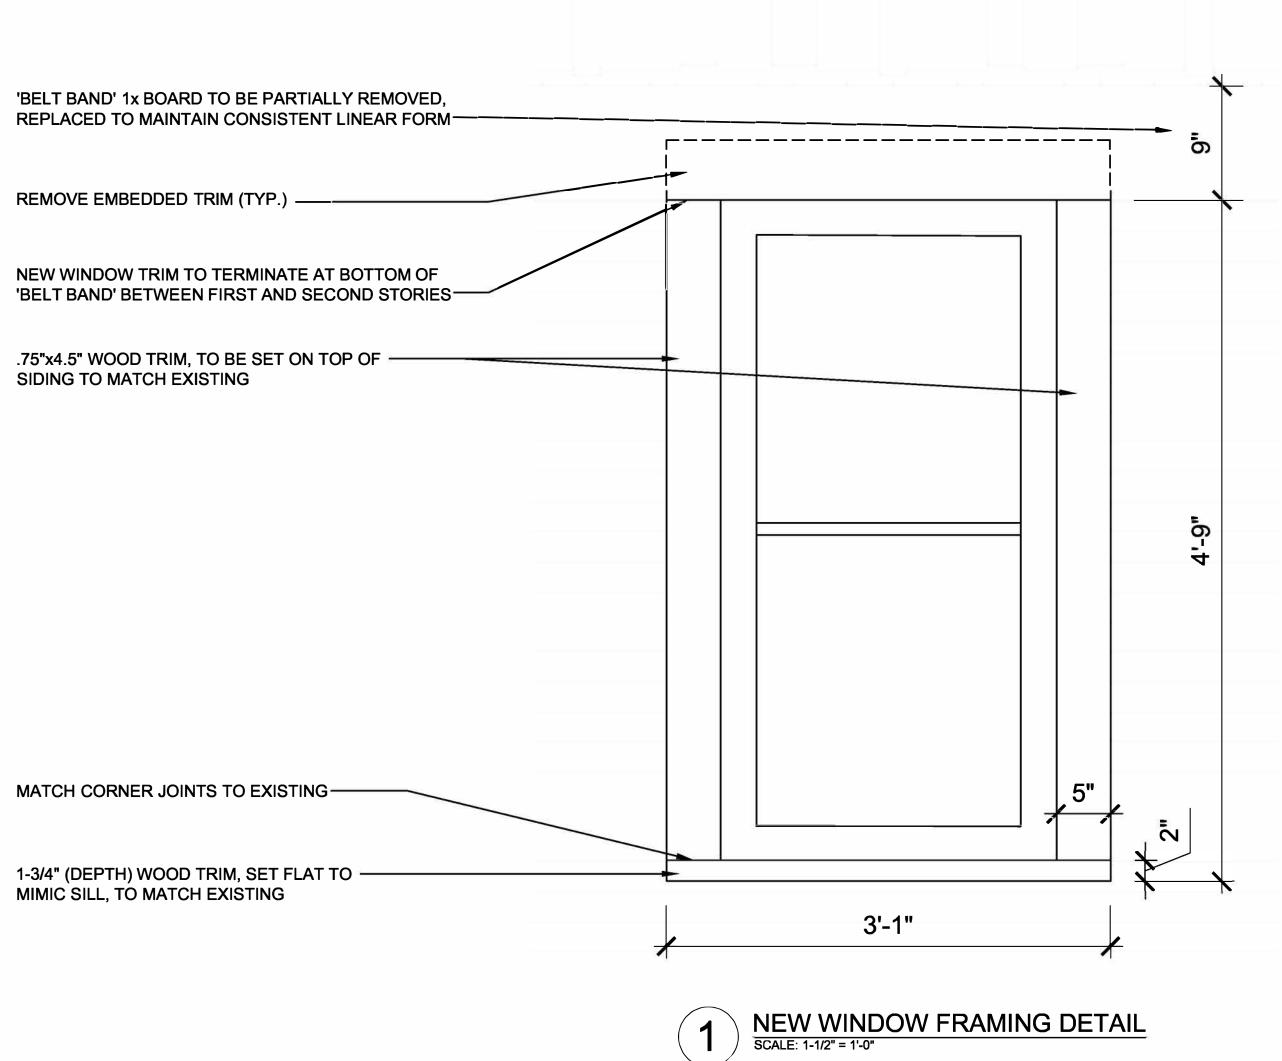








PREVIOUS WINDOW FRAMING DETAIL



NEW WINDOW PHOTO TAKEN NOVEMBER 26, 2024

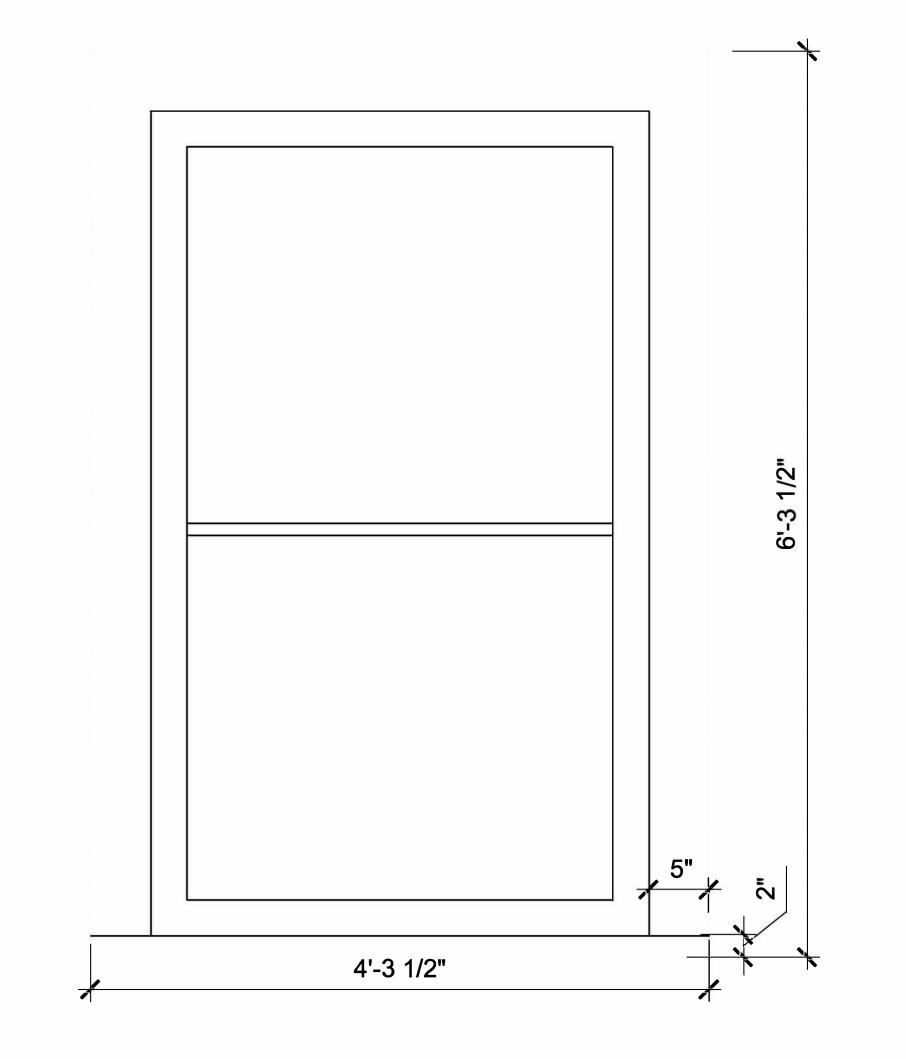



4 FRONT ELEVATION EXISTING WINDOW FRAMING DETAIL SCALE: 1-1/2" = 1'-0"






	ARCHITECT:
	4545 architecture
	2761 E. JEFFERSON AVE STE 302 DETROIT, MI 48207 P. 313.454.4545 TIM.FLINTOFF <b>0</b> 4545ARCHITECTURE.COM
	CONSULTANT:
	Project :
	708 PALLISTER HDC RENOVATION
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2024 Tin	WINDOW TRIM DETAILS
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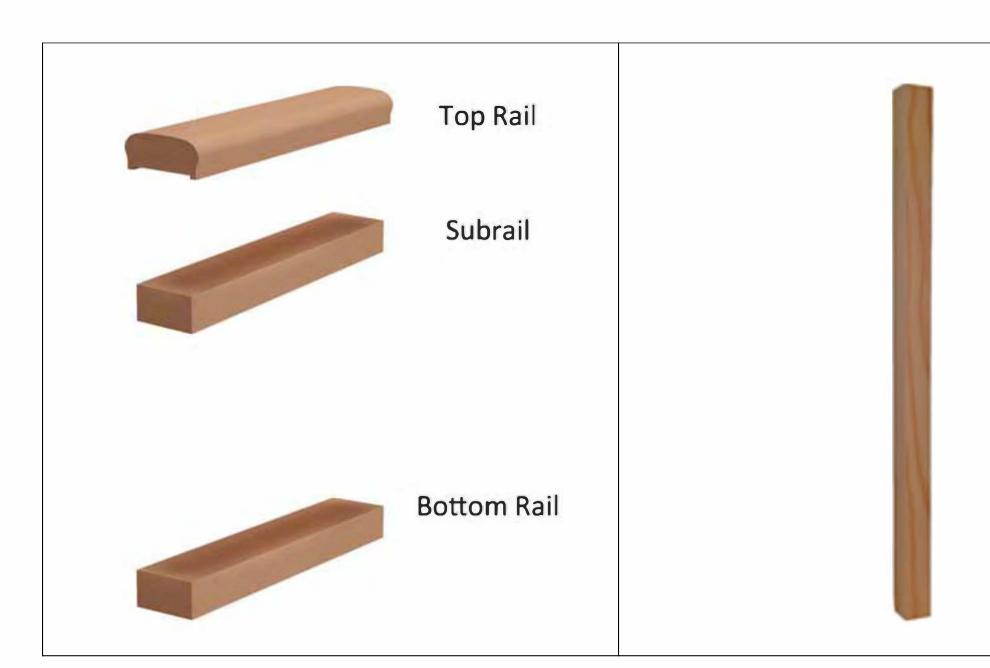



	ARCHITECT:
3D RENDERINGS ARE FOR REFERENCE ONLY, SEE ARCHITECTURAL DRAWINGS FOR FINAL DESIGN DETAILS	2761 E. JEFFERSON SUITE 302 DETROIT, MI 48207 P. 313.450.4545
	TIM.FLINTOFF@4545ARCHITECTURE.COM
	Project : 708 PALLISTER HDC RENOVATION
	Issued for : HDC SUBMIT 04/21/2025
	TIMOTHY R. FLINTOFF JR. ARCHITECT No. SED ARCHITECT
	Drawn by : Author Checked by : Author
i	Sheet Title : 3D RENDERS Project No. :
	2024001 Sheet No. : A6.2


# FRONT PORCH RAILING

# AMERICAN PORCH 4" 3 PC.PORCH RAIL SYSTEM, CEDAR WITH BOTTOM RAIL

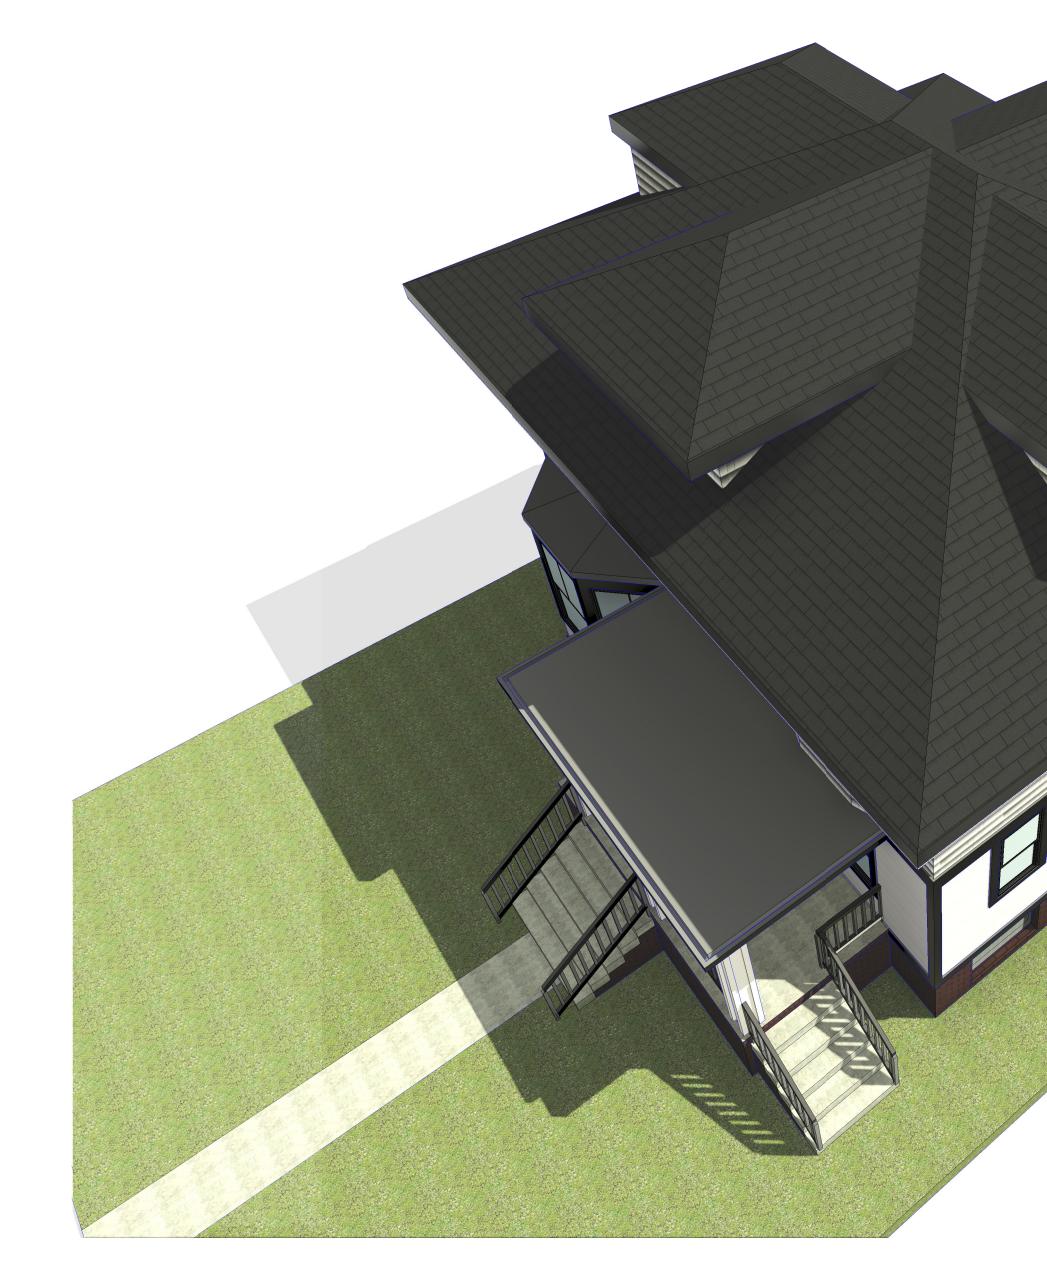
AMERICAN PORCH 1-5/8" SQUARE BALUSTER, CEDAR 32" LENGTH




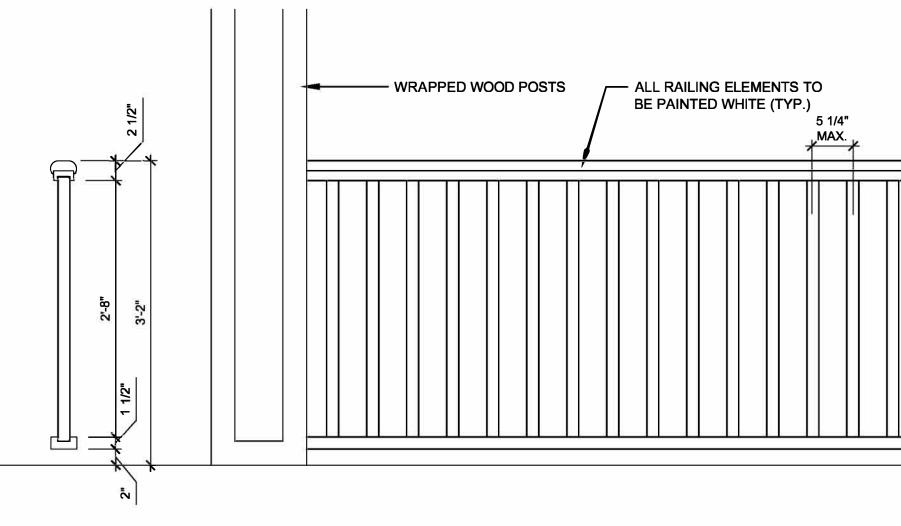


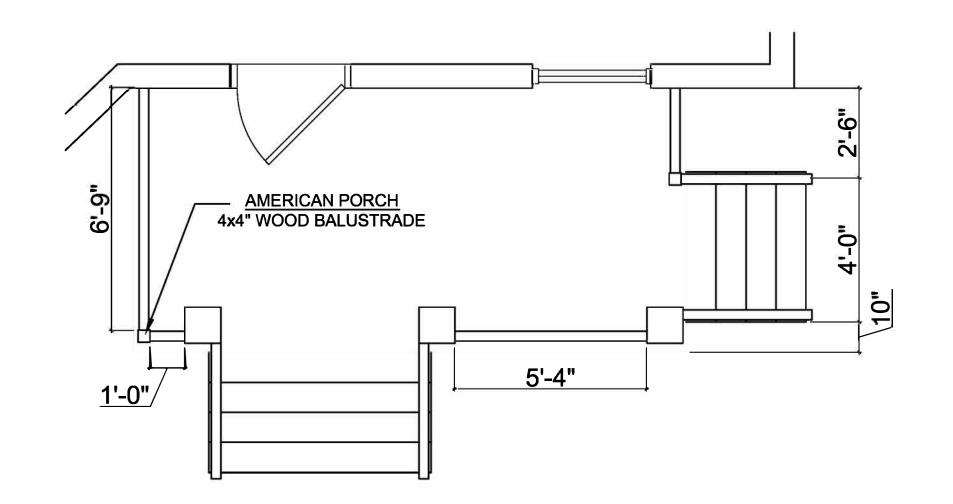

# **REAR DECK RAILING**

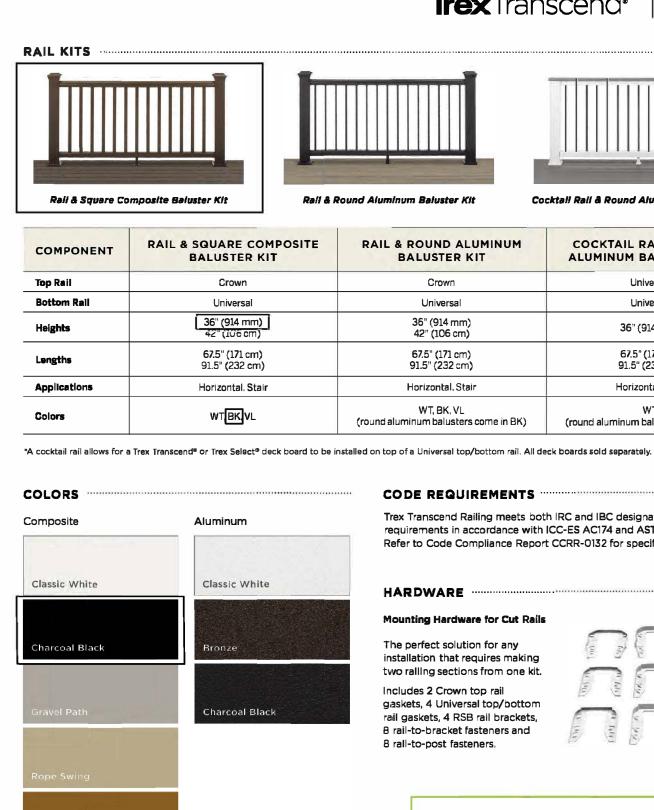

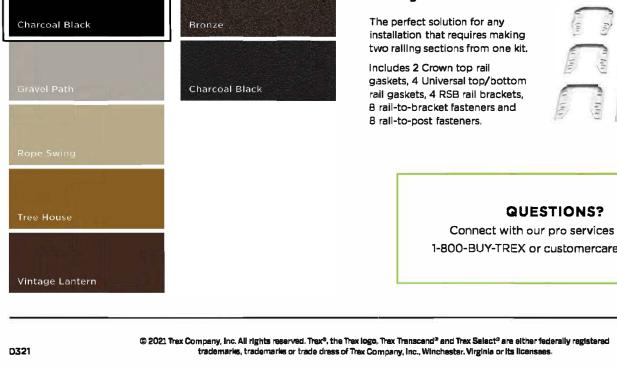

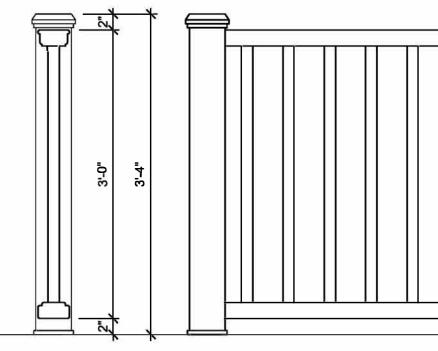

**Trex**Transcend<sup>®</sup>

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Trex

OUND ALUMINUM	COCKTAIL RAIL & ROUND ALUMINUM BALUSTER KIT*			
Crown	Universal			
Universal	Universal			
36" (914 mm) 42" (106 cm)	36" (914 mm)			
67.5" (171 cm) 91.5" (232 cm)	67.5" (171 cm) 91.5" (232 cm)			
orizontal, Stair	Horizontal, Stair			
WT, BK, VL num balusters come in BK)	WT (round aluminum balusters come in BK)			

#### CODE REQUIREMENTS

Trex Transcend Railing meets both IRC and IBC designated requirements in accordance with ICC-ES AC174 and ASTM D7032. Refer to Code Compliance Report CCRR-0132 for specific details.

#### HARDWARE


fect solution for any tion that requires making	
Ing sections from one kit. s 2 Crown top rail s, 4 Universal top/bottom kets, 4 RSB rail brackets, p-bracket fasteners and p-post fasteners.	
	ISTIONS? Ir pro services team at


5 1/4" MAX. 


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ARCHITECT: 4545 architecture 2761 E. JEFFERSON AVE STE 302 DETROIT, MI 48207 P. 313.454.4545 TIM.FLINTOFF**0**4545ARCHITECTURE.COM CONSULTANT: Project : 708 PALLISTER HDC RENOVATION Issued for : HDC SUBMIT 04/21/2025 OFMIC TIMOTHY R. FLINTOFF JR. ARCHITECT 130106408 Drawn by : **ANJ** Check by : Sheet Title : RAILING DETAILS Project No. : 2024001 Sheet No. : A5.2





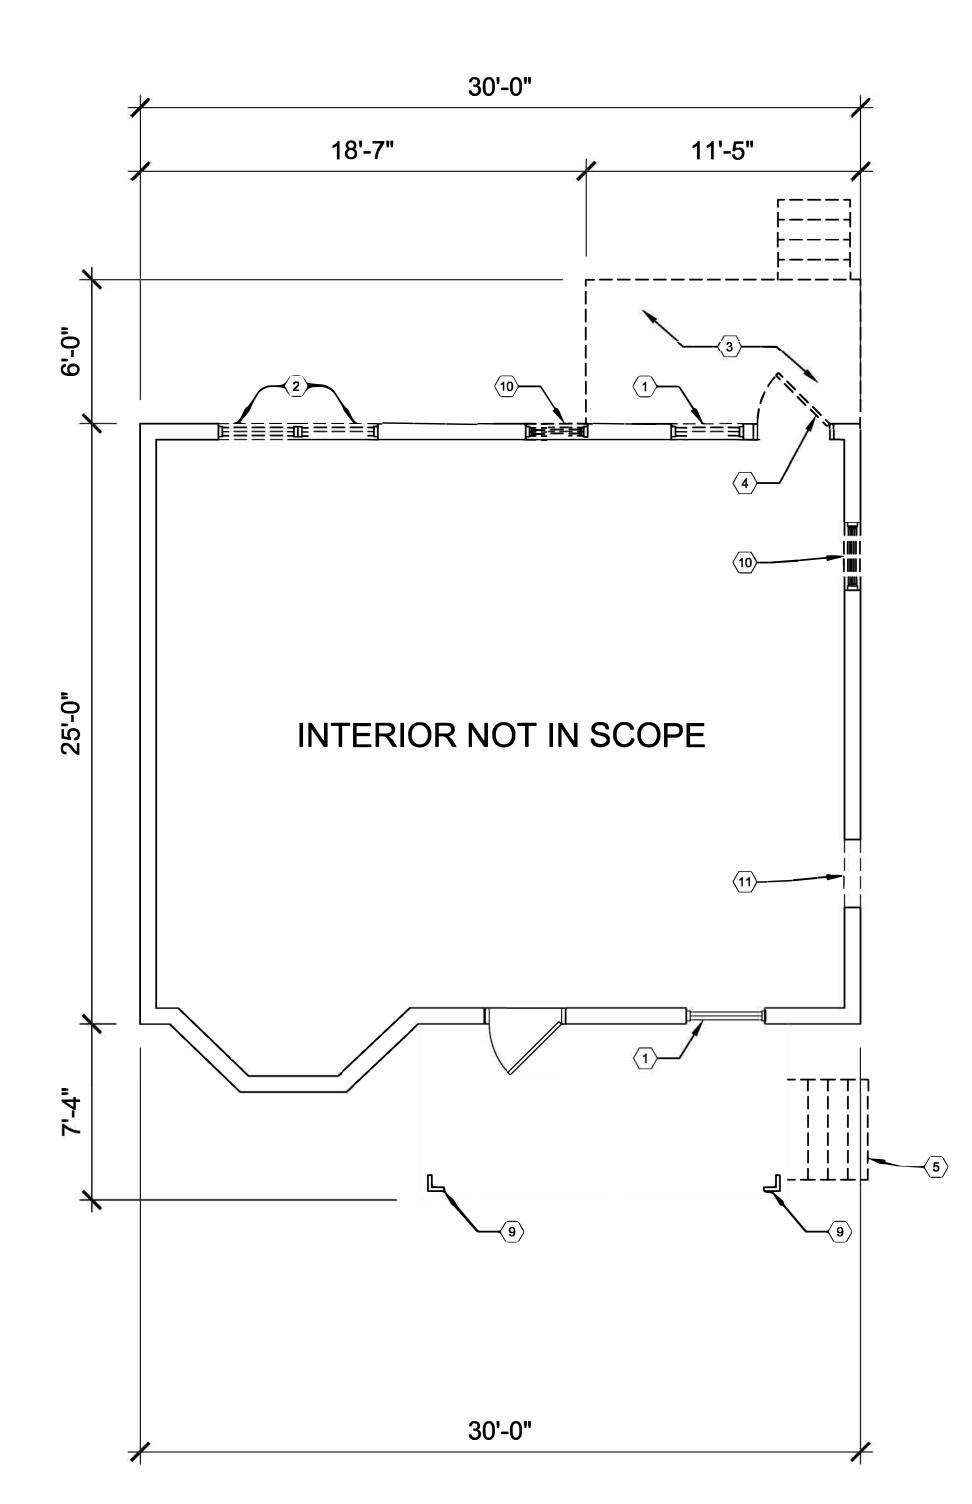

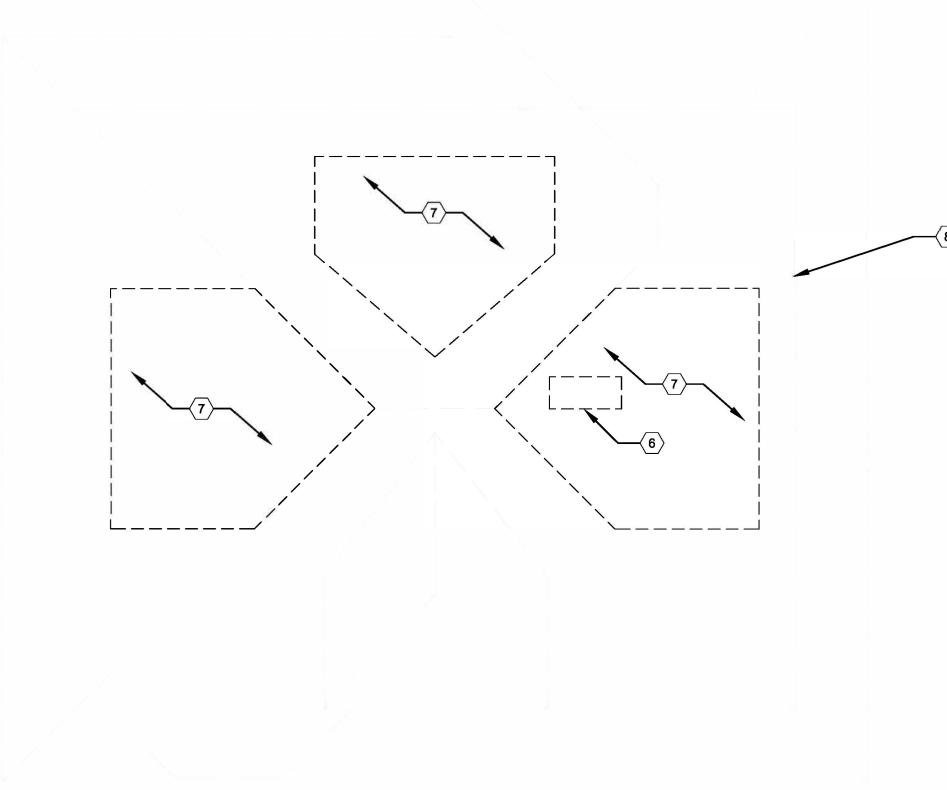
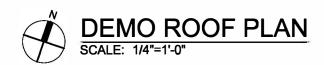
# GENERAL FLOOR PLAN NOTES:


- 1. THIS DRAWING IS DIAGRAMMATIC AND SHOULD BE USED TO DETERMINE THE DESIGN INTENT. THE CONTRACTOR IS RESPONSIBLE FOR THE COMPLETE SET OF WORK AS INDICATED AND SHALL FIELD VERIFY ALL WORK, COORDINATE ALL DRAWINGS / NEW WORK AND SHALL NOTIFY ARCHITECT IMMEDIATELY OF ANY DISCREPANCIES IN THE DOCUMENTS BEFORE PROCEEDING. FAILURE TO DO SO WILL RESULT IN THE CONTRACTOR TAKING FULL RESPONSIBILITY AND LIABILITY FOR SAID DISCREPANCIES.
- 2. ALL DIMENSIONS ARE SHOWN FROM FINISH FACE TO FINISH FACE OF PARTITION UNLESS OTHERWISE NOTED.
- 3. WALL THICKNESS' ARE NOMINAL NOT ACTUAL DIMENSIONS. SEE WALL SCHEDULE FOR ACTUAL DIMENSIONS.
- 4. ALL WORK SHALL BE DONE IN ACCORDANCE WITH ALL LOCAL, STATE, COUNTY CODE REGULATIONS, O.S.H.A., AND THE AMERICAN WITH DISABILITIES ACT (ADA). REFER TO THE CODE PLAN FOR MORE INFORMATION.
- 5. PROVIDE POSITIVE SLOPE TO ALL FLOOR DRAINS WHILE KEEPING FLOOR LEVEL AT WALL BASE CONDITION.


### DEMO PLAN KEY NOTES:

(TYPICAL THIS SHEET ONLY)


- $\langle 1 \rangle$  WINDOW REMOVED AND REPLACED, SEE ELEVATIONS
- $\langle 2 \rangle$  window removed and replaced with door, see elevations
- $\langle 3 
  angle$  demolished existing rear deck and stair
- $\langle 4 \rangle$  REMOVED AND INFILLED REAR DOOR, SEE ELEVATIONS
- $\left< 5 \right>$  DEMOLISHED & REPLACED EXISTING MASONRY STAIR
- $\langle 6 \rangle$  demolished chimney
- $\langle 7 \rangle$  removed roof as req'd for New Dormer
- $\langle 8 
  angle$  line of walls below
- $\langle 9 \rangle$  EXISTING COLUMNS REMOVED, REPLACED (SEE ELEVATIONS)
- $\langle \overline{10} \rangle$  window removed, wall infilled
- $\langle 11 \rangle$  wall demolished as req'd for New Window

3)

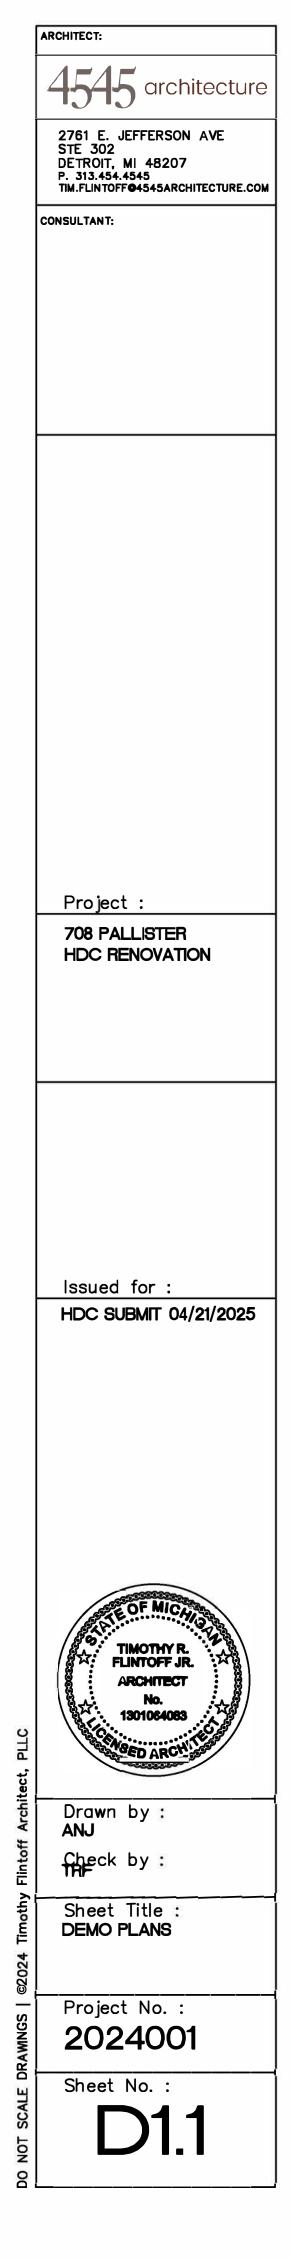

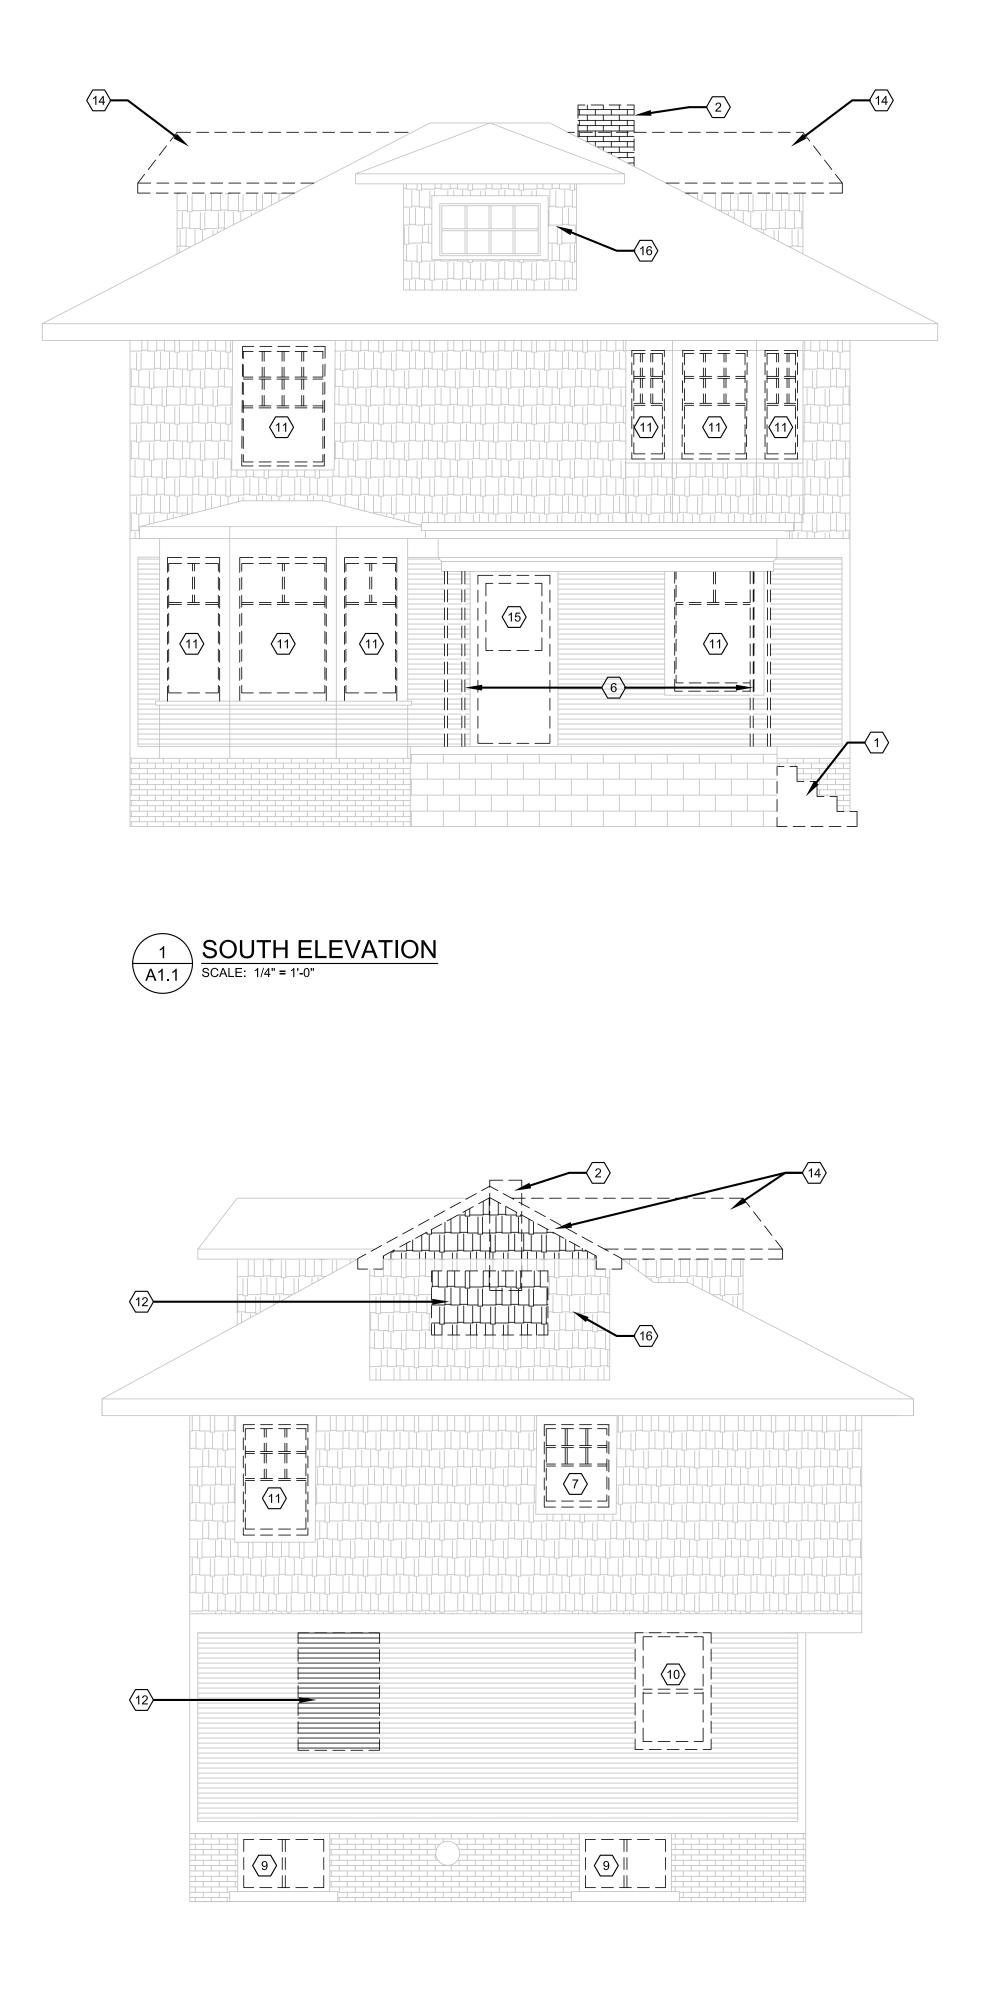



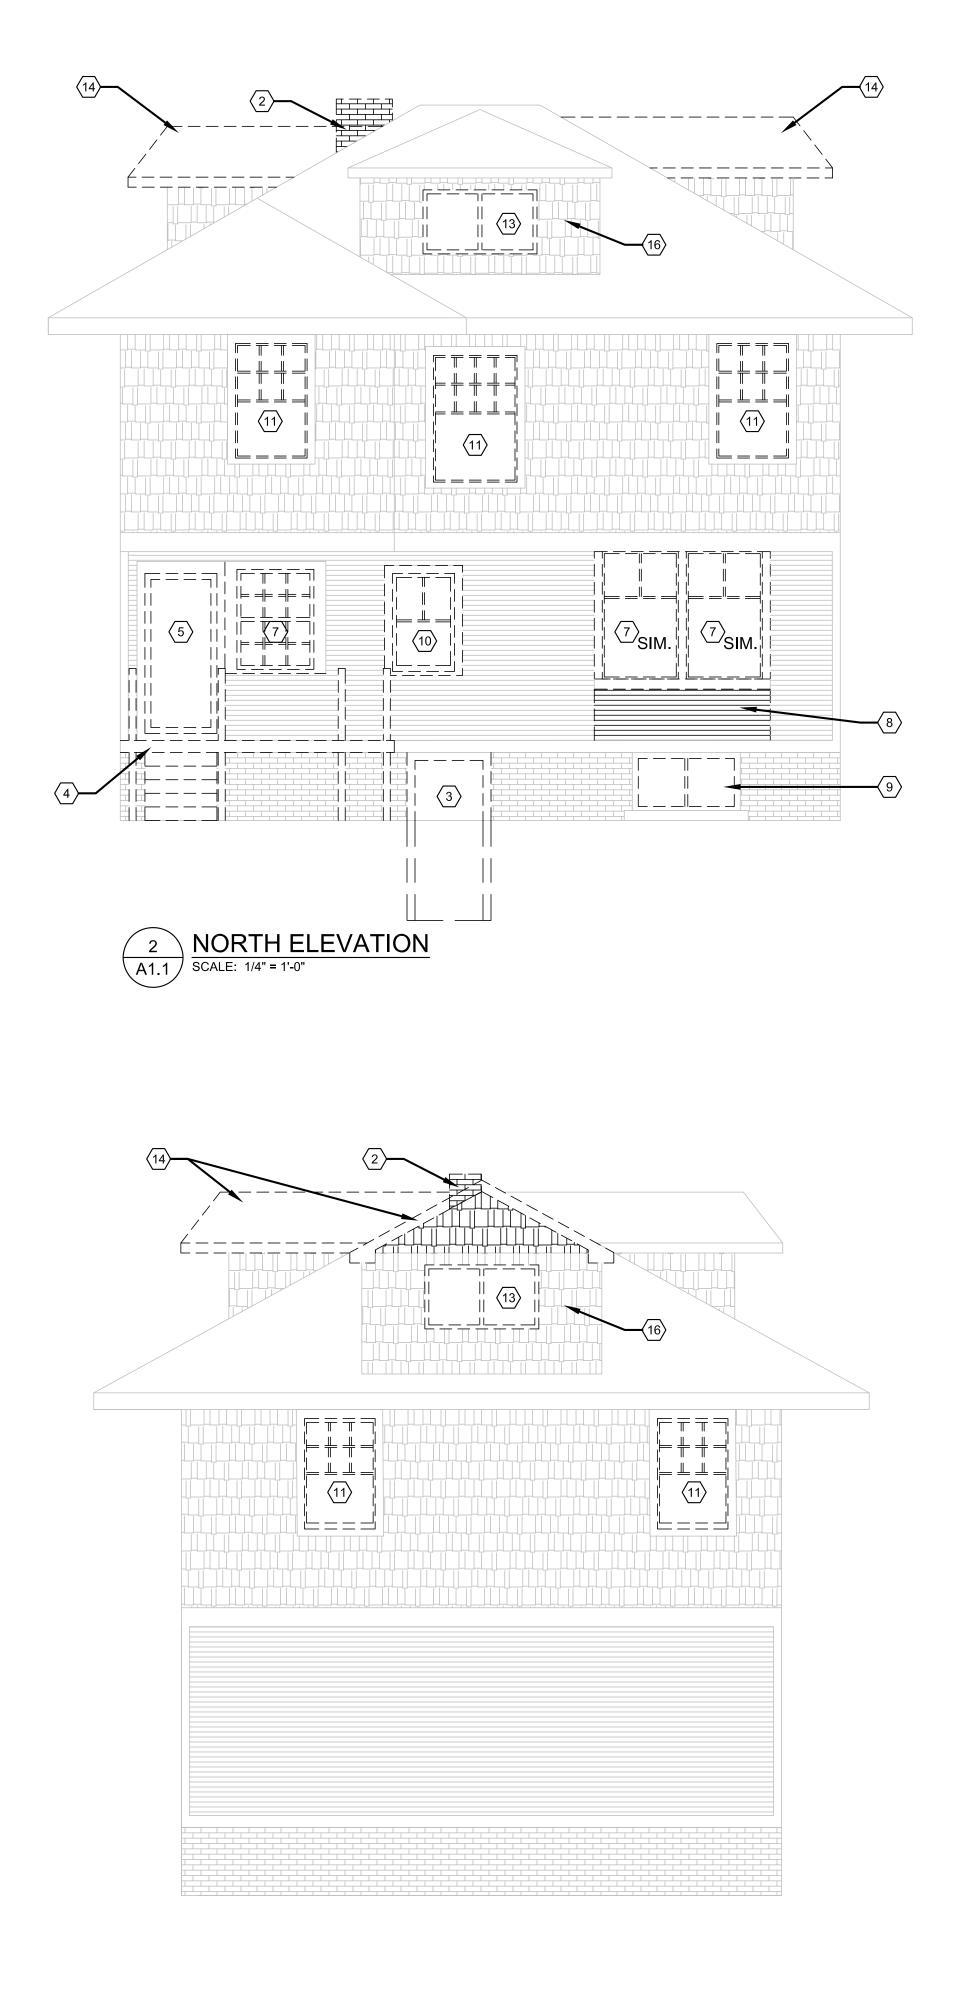



#### ELEVATION KEY NOTES:

(TYPICAL THIS SHEET ONLY)

- (1) MASONRY STAIRS REMOVED, REPLACED
- 2 CHIMNEY DEMOLISHED

3 EXISTING BASEMENT DOOR REMOVED, WALL INFILLED; USE IN-KIND MATERIALS FOR EXTERIOR CLADDING. EARTH TO BE INFILLED

- $\left< 4 \right>$  REAR DECK AND STAIR DEMOLISHED
- $\langle 5 \rangle$  door removed, wall infilled; use in-kind materials for exterior cladding
- $\langle 6 \rangle$  EXISTING COLUMNS TO BE REMOVED AND REPLACED; SHORE ROOF AS REQ'D
- $\langle 7 \rangle$  EXISTING WINDOW REMOVED AND REPLACED, SEE EXTERIOR ELEVATIONS
- $\langle 8 \rangle$  Wall Removed for New Door, see exterior elevations
- $\langle 9 \rangle$  BASEMENT WINDOWS REMOVED, REPLACED WITH GLASS BLOCK; SEE EXTERIOR ELEVATIONS
- (10) WINDOW REMOVED, WALL INFILLED; SEE EXTERIOR ELEVATIONS
- EXISTING SINGLE-HUNG WINDOW REMOVED, REPLACED W/ VINYL-CLAD WOOD SINGLE-HUNG WINDOW (ANDERSON 400 SERIES) (WORK COMPLETED); TO BE PAINTED BLACK
- $\langle 12 \rangle$  Wall demolished as REQ'D for New Window
- $\langle 13 \rangle$  SLIDING WINDOW TO BE REMOVED, REPLACED (SEE EXTERIOR ELEVATIONS)
- $\langle 14 \rangle$  DORMER ROOF TO BE REMOVED, REPLACED (SEE EXTERIOR ELEVATIONS)
- (15) ENTRY DOOR REMOVED, REPLACED
- (16) REMOVE INSTALLED COMPOSITE SIDING

	Project : 708 PALLISTER HDC RENOVATION
	Issued for : HDC SUBMIT 04/21/2025
thy Flintoff Architect, PLLC	Drawn by : TRF Check by : Sheet Title :
DO NOT SCALE DRAWNGS   ©2024 Timothy Flintoff Architect, PLLC	Sheet Title : DEMO EXTERIOR ELEVATIONS Project No. : 2024001 Sheet No. :

**ARCHITECT:** 

CONSULTANT:

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2761 E. JEFFERSON AVE STE 302 DETROIT, MI 48207 P. 313.454.4545 TIM.FLINTOFF**G**4545ARCHITECTURE.COM

# 708 PALLISTER RENOVATION

EXTERIOR RENOVATION 708 PAILSITER STREET,

DETROIT, MI. 48202

#### ARCHITECT

#### 4545 ARCHITECTURE | DESIGN, PLLC TIMOTHY FLINTOFF, AIA, NCARB 2761. E JEFFERSON, SUITE 302 DETROIT, MI 48207 248-320-6098

#### PROJECT DATA

BUILDING CODE AUTHORITY: CITY OF DETROIT, MICHIGAN

OWNER: THOMAS TYPINKSKI 708 PALLISTER ST,. DETROIT, MI 48202

APPLICABLE CODES: BUILDING CODE ALSO KNOWN AS THE "MICHIGAN RESIDENTIAL CODE" 2015 MICHIGAN RESIDENTIAL CODE (MRC) AS AMENDED APPENDIX J: EXISTING BUILDING AND STRUCTURES

MECHANICAL CODE ALSO KNOWN AS THE "MICHIGAN MECHANICAL CODE" 2021 MICHIGAN MECHANICAL CODE AS AMENDED

PLUMBING CODE ALSO KNOWN AS THE "MICHIGAN PLUMBING CODE" 2021 MICHIGAN PLUMBING CODE AS AMENDED

ELECTRICAL CODE ALSO KNOWN AS THE "MICHIGAN ELECTRICAL CODE" 2023 NATIONAL ELECTRIC CODE (NEC) AS AMENDED & MICHIGAN AMMENDMENTS PART 8.

ENERGY CODE 2015 UNIFORM ENERGY CODE

BARRIER FREE REQUIREMENTS AMERICANS WITH DISABILITIES ACT (ADA) MBC-2015, CHAPTER 11 ICC / ANSI 117.1 - 2010, EXCEPT SECTION 611 & 707 BUILDING DATA:

LOT SIZE: 5,800 GSF

EXIST. BUILDING FOOTPRINT: 770 GSF

STORIES: 3 SPRINKLERED: NO

BUILDING CODE INFORMATION: OCCUPANCY/USE

R-2 RESIDENTIAL - SINGLE FAMILY

CONSTRUCTION TYPE: V-B (EXISTING AND PROPOSED)

REQUIRED EXITS: DWELLING UNIT: 1 EXIT + 1 EMERGENCY WINDOW EGRESS PER UNIT

PROVIDED EXITS: DWELLING UNIT: 2 EXTERIOR EXITS + 1 EMERGENCY WINDOW EXIT




PROJECT SITE MAP: NOT TO SCALE




#### SHEET INDEX

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SYN	/BOL LEGEND	AB	BREVIATION
			AT
	- DARKENED ARROW INDICATES ELEVATED SECTION	ACOUST. A.C.T.	ACOUSTICAL ACOUSTIC CEILING TILE
	- ELEVATION NUMBER	ADJ.	ADJACENT
·	- SHEET NUMBER WHERE ELEVATION IS LOCATED	A.F.F. ALUM.	ABOVE FINISH FLOOR ALUMINUM
		ANOD. BD.	ANODIZED BOARD
	- ELEVATION NUMBER	BLDG. BLK.	BUILDING BLOCK
	- SHEET NUMBER WHERE ELEVATION IS LOCATED	BLKG.	BLOCKING
		CEM. C.J.	CEMENT CONTROL JOINT
		CLG. ଜୁ	CEILING CENTER LINE
		<b>C</b> .O.	CLEAN OUT
	- SHEET NUMBER WHERE DETAIL IS LOCATED	COL. CONC.	COLUMN CONCRETE
	- DETAIL NUMBER	C.G. CONST.	CORNER GUARD CONSTRUCTION
AIL—	- DETAIL NAME	CONT. CORR.	CONTINUOUS CORRUGATED
	- DRAWING SCALE	CPT.	CARPET
	- SHEET NUMBER WHERE DETAIL IS REFERENCED	C.T. DET.	CERAMIC TILE DETAIL
		DIA. DM.	DIAMETER DIMENSION
e	- HEIGHT ABOVE FINISHED FLOOR	DN. D.O.	DOWN DOOR OPENING
F	REFERENCE POINT OF ELEVATION	DR.	DOOR
		DWG. EA.	DRAWING EACH
	- HEIGHT ABOVE FINISHED FLOOR	ELEV. E.W.	ELEVATION EACH WAY
	NOTE: DATUM SYMBOL INDICATES A SPECIFIC	EXG.	EXISTING
	REFERENCE HEIGHT OF MATERIAL INDICATED	EXIST. EXP.	EXISTING EXPANSION, EXPOSED
		EXT. F.D.	EXTERIOR FLOOR DRAIN
		FDN. F.R.P.	FOUNDATION FIBER REINFORCED PANELS
	- ROOM NUMBER	FIN.	FINISH
		FLR. F.O.	FLOOR FACE OF
1)		F.O.S. FR.	FACE OF STUD FRAME
.Х		FTG.	FOOTING
<u> </u>	- NUMBERS DESIGNATE VERTICAL COLUMN LINES LETTERS DESIGNATE HORIZONTAL COLUMN LINES	FV. GA.	FIELD VERIFY GAUGE
		GALV. GYP.	GALVANIZED GYPSUM
<u>,</u>	- CIRCLES REPRESENT NEW COLUMN LINES	HDW.	HARDWARE
» 		H.M. HORIZ.	HOLLOW METAL HORIZONTAL
1		HT. I.D.	HEIGHT INSIDE DIAMETER
		INSUL. INT.	INSULATION INTERIOR
		JT.	JOINT
	- EXISTING DOOR SYMBOL	LAV. LG.	LAVATORY LONG
		L.L.O. L.L.V.	LONG LEG OUTSTANDING LONG LEG VERTICAL
		MAX. MECH.	MAXIMUM
	- NEW DOOR SYMBOL	MET.	MECHANICAL METAL
	- DOOR DESIGNATION	MEZZ. M.I.	MEZZANINE MISCELLANEOUS IRON
		MIN. MISC.	MINIMUM MISCELLANEOUS
		М.О.	MASONRY OPENING
		N.I.C. N.T.S.	NOT IN CONTRACT NOT TO SCALE
	- WALL TYPE DESIGNATION NUMBER - COORDINATE WITH SCHEDULE	0.C. 0.D.	ON CENTER OUTSIDE DIAMETER
	- EQUIPMENT DESIGNATION NUMBER -	OPNG. OPP.	OPENING OPPOSITE
	COORDINATE WITH PLAN NOTES	PL.G.	PLATE GLASS
	- KEY NOTE DESIGNATION NUMBER -	PL.S. P.LAM	PLATE STEEL PLASTIC LAMINATE
	COORDINATE WITH PLAN NOTES	PLAS. PREFAB.	PLASTER PREFABRICATED
	- ADDENDUM DESIGNATION NUMBER	PROJ. P.S.F.	PROJECT, PROJECTION POUNDS PER SQUARE FOOT
		PT.	PAINT, POINT
	- BULLETIN DESIGNATION NUMBER	R. R.A.	RISER RETURN AIR
		R.B. R.C.	RUBBER BASE ROOF CONDUCTOR
9	- SHEET REFERENCE FOR DRAWING CONTINUATION	R.C.P. R.D.	REFLECTED CEILING PLAN ROOF DRAIN
		R.F. REINF.	RUBBER FLOORING
		REQ'D.	REINFORCED, REINFORCING REQUIRED
MA	TERIAL LEGEND	RFG. RM.	ROOFING ROOM
		R.S. R.T.	ROOF SUMP RUBBER TILE
		SAN. SCHED.	SANITARY
	ACOUSTICAL CEILING	SHT.	SHEET
		SIM. SPEC.	SIMILAR SPECIFICATION
	BATT/LOOSE INSULATION	S.S. STL.	SERVICE SINK STEEL
		STD. STOR.	STANDARD STORAGE
$\leq$	BLOCKING/ROUGH LUMBER	STRUCT.	STRUCTURAL
		SUSP. SW.	SUSPENDED SWITCH
	CONCRETE	SYM. T.	SYMMETRICAL TREAD
277		T&B TEL.	TOP AND BOTTOM TELEPHONE
ハち	FINISHED WOOD	TERR.	TERRAZZO
		T&G THK.	TONGUE AND GROOVE THICK, THICKNESS
	GLASS	THRES. T.O.S.	THRESHOLD TOP OF STEEL
	GYPSUM WALLBOARD	TYP.	TYPICAL
		U/C U.N.O.	UNDERCUT UNLESS NOTED OTHERWISE
****	MASONRY	V.B. V.C.T.	VINYL BASE VINYL COMPOSITION TILE
******		V.I.F.	VERIFY IN FIELD
	PARTICLE BOARD	W. VER⊺.	WIDE VERTICAL
<u>+ + + +</u> ]		WAINS. W.C.	WAINSCOT WATER CLOSET
<i></i>	PLYWOOD	WD.WIN. WT.	WOOD WINDOW WEIGHT
		W.W.F.	WELDED WIRE FABRIC
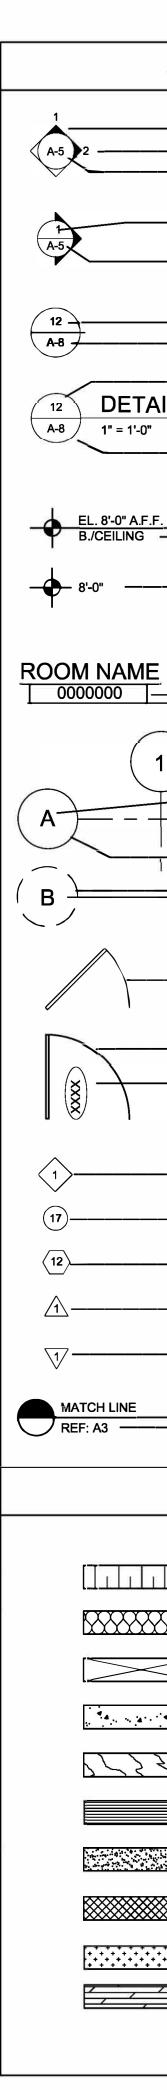
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	Project : <b>708 PALLISTER</b>
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	Issued for : HDC SUBMIT 04/21/2025
	TIMOTHY R.
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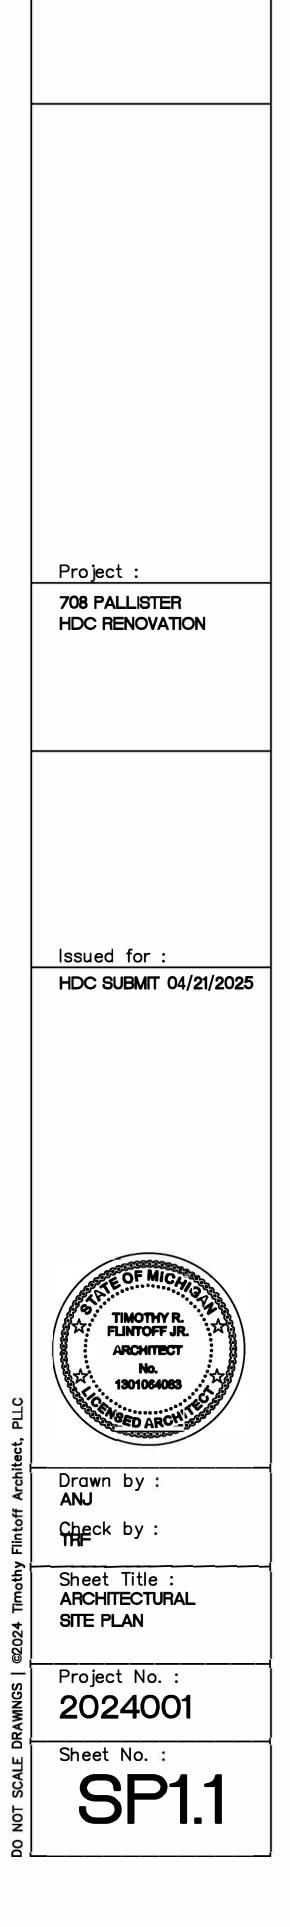
PALLISTER

## GENERAL SITE PLAN NOTES:

- 1. PAVEMENT SHALL BE OF THE TYPE, THICKNESS AND CROSS SECTION AS INDICATED ON THE PLANS AND AS FOLLOWS:
- 2. CONCRETE: PORTLAND CEMENT TYPE IA (AIR-ENTRAINED) WITH A MINIMUM CEMENT CONTENT OF SIX SACKS PER CUBIC YARD, MINIMUM 28 DAY COMPRESSIVE STRENGTH OF 3,500 PSI AND A SLUMP OF 1 1/2 TO 3 INCHES.
- 3. ASPHALT: BASE COURSE MDOT BITUMINOUS MIXTURE NO. 1100L, 20AA; SURFACE COURSE - MDOT BITUMINOUS MIXTURE NO. 1100T, 20AA; ASPHALT CEMENT PENETRATION GRADE 85-100, BOND COAT - MDOT SS-1H EMULSION AT 0.10 GALLON PER SQUARE YARD; MAXIMUM 2 INCH LIFT.
- 4. PAVEMENT BASE SHALL BE COMPACTED TO 95% OF THE MAXIMUM DENSITY (MODIFIED PROCTOR) PRIOR TO PLACEMENT OF PROPOSED PAVEMENT. EXISTING SUB-BASE SHALL BE PROOF-ROLLED IN THE PRESENCE OF THE ENGINEER TO DETERMINE STABILITY.
- 5. ALL CONCRETE PAVEMENT, DRIVEWAYS, CURB & GUTTER, ETC., SHALL BE SPRAY CURED WITH WHITE MEMBRANE CURING COMPOUND IMMEDIATELY FOLLOWING FINISHING OPERATION.
- 6. ALL CONCRETE PAVEMENT JOINTS SHALL BE FILLED WITH HOT POURED RUBBERIZED ASPHALT JOINT SEALING COMPOUND IMMEDIATELY AFTER SAWCUT OPERATION. FEDERAL SPECIFICATION SS-S164.
- 7. ALL WORKMANSHIP AND MATERIALS SHALL BE IN ACCORDANCE WITH THE CURRENT STANDARDS AND SPECIFICATIONS OF THE MUNICIPALITY AND THE MICHIGAN DEPARTMENT OF TRANSPORTATION STANDARD SPECIFICATIONS FOR CONSTRUCTION, CURRENT EDITION.
- 8. ALL TOP OF CURB ELEVATIONS, AS SHOWN ON THE PLANS, ARE CALCULATED FOR A 6" CONCRETE CURB UNLESS OTHERWISE NOTED.
- 9. ALL SIDEWALK RAMPS, CONFORMING TO PUBLIC ACT NO. 8, 1993, SHALL BE INSTALLED AS INDICATED ON THE PLANS.
- 10. CONSTRUCTION OF A NEW OR RECONSTRUCTED DRIVE APPROACH CONNECTING TO AN EXISTING STATE OR COUNTY ROADWAY SHALL BE ALLOWED ONLY AFTER AN APPROVED PERMIT HAS BEEN SECURED FROM THE AGENCY HAVING JURISDICTION OVER SAID ROADWAY.
- 11. FOR ANY WORK WITHIN THE PUBLIC RIGHT-OF-WAY, THE CONTRACTOR SHALL PAY FOR AND SECURE ALL NECESSARY PERMITS AND LIKEWISE ARRANGE FOR ALL INSPECTION.
- 12. EXISTING TOPSOIL, VEGETATION AND ORGANIC MATERIALS SHALL BE STRIPPED AND REMOVED FROM PROPOSED PAVEMENT AREA PRIOR TO PLACEMENT OF BASE MATERIALS.
- 13. EXPANSION JOINTS SHOULD BE INSTALLED AT THE END OF ALL INTERSECTION RADII.
- 14. SIDEWALK RAMPS, CONFORMING TO PUBLIC ACT NO. 8, 1973, SHALL BE INSTALLED AS SHOWN AT ALL STREET INTERSECTIONS AND AT ALL BARRIER FREE PARKING AREAS AS INDICATED ON THE PLANS.
- 15. ALL PAVEMENT AREAS SHALL BE PROOF-ROLLED UNDER THE SUPERVISION OF A GEOTECHNICAL ENGINEER PRIOR TO THE PLACEMENT OF BASE MATERIALS AND PAVING MATERIALS.
- 16. FILL AREAS SHALL BE MACHINE COMPACTED IN UNIFORM LIFTS NOT EXCEEDING 9 INCHES THICK TO 98% OF THE MAXIMUM DENSITY (MODIFIED PROCTOR) PRIOR TO PLACEMENT OF PROPOSED PAVEMENT.
- 17. ALL LANDSCAPED AREAS TO BE PROVIDED W/ SPRINKLER SYSTEMS FOR 100% COVERAGE.
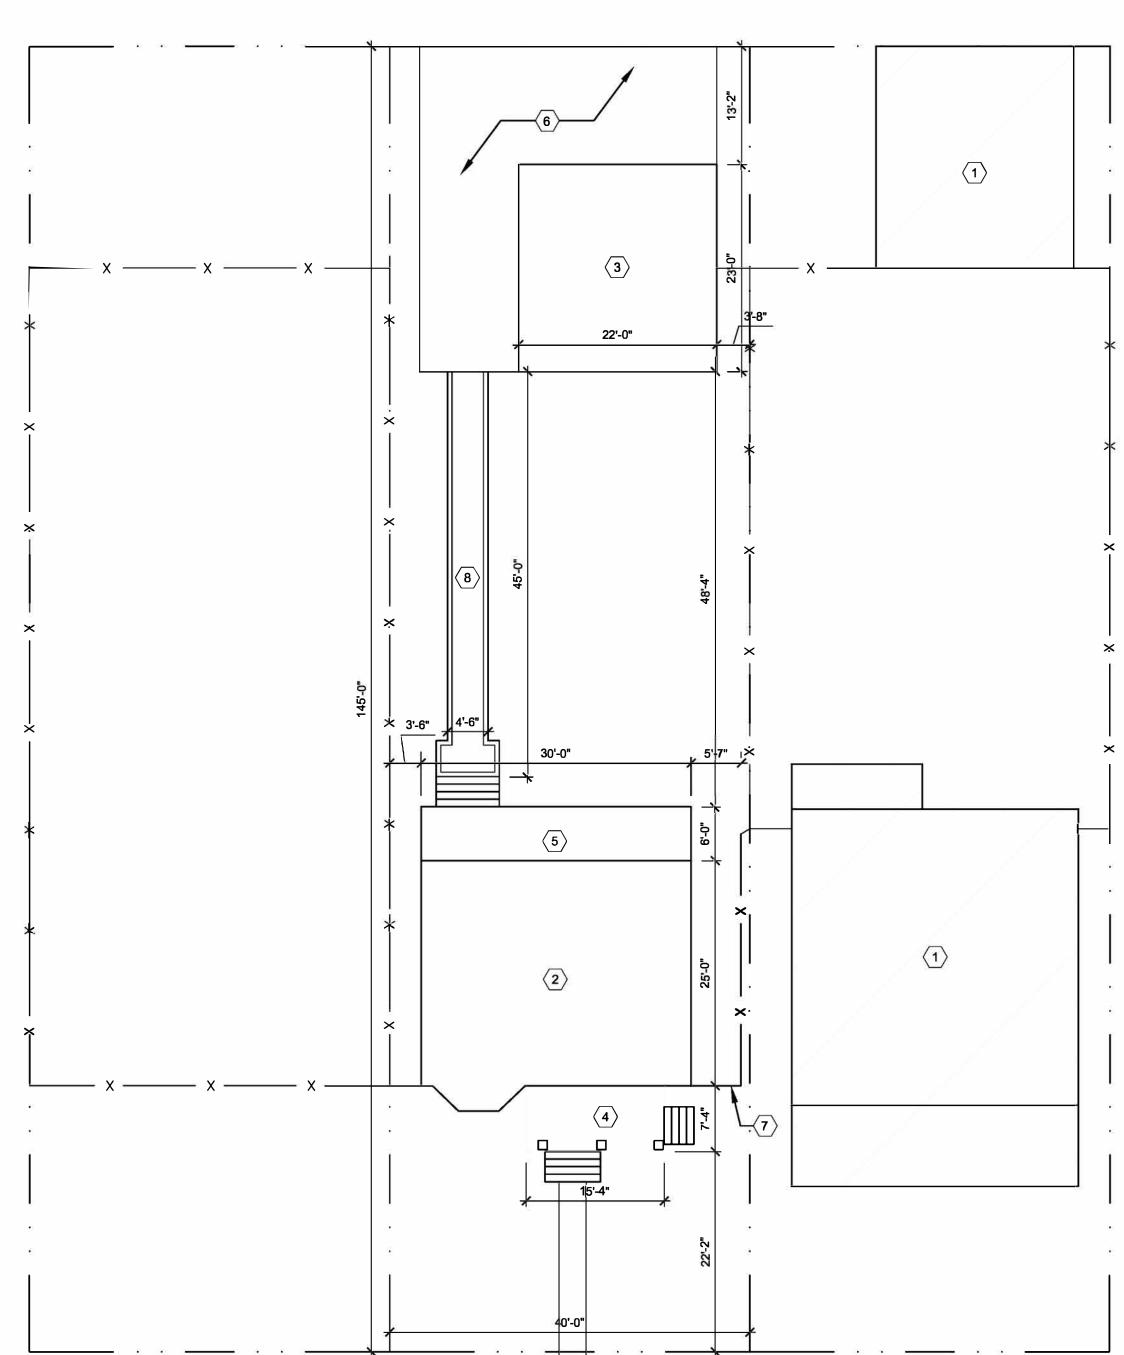
#### SITE PLAN KEY NOTES: (TYPICAL THIS SHEET ONLY)

- (1) EXISTING BUILDING NOT IN SCOPE
- $\langle 2 \rangle$  EXISTING HOUSE
- $\langle 3 \rangle$  EXISTING GARAGE
- $\langle 4 \rangle$  EXISTING FRONT PORCH
- $\overline{5}$  NEW REAR DECK
- $\langle 6 \rangle$  EXISTING CONCRETE PARKING PAD
- $\langle 7 \rangle$  NEW WOOD FENCE WITH GATE
- $\langle 6 \rangle$  NEW PAVED WALKWAY



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