

BERKERY ESTATE

NIALL & MELVIE BERKERY

8325 E JEFFERSON AVE
DETROIT, MI 48214



PROJECT INFORMATION

Owner: Melvie & Niall Berkery

Location: 8325 Jefferson
Detroit, MI 48214

PROJECT DESCRIPTION:

AN EXISTINTING VACANT STRUCTURE WILL BE CONVERTED INTO A LUXURY BED & BREAKFAST. THE BUILDING WAS MOST RECENTLY USED AS AN OFFICE BUILDING BUT WAS ORIGINALLY CONSTRUCTED AS A SINGLE FAMILY HOME. THE UPPER TWO FLOORS OF THE STRUCTURE WILL BE DEDICATED TO THE BED AND BREAKFAST FUNCTIONS. A MAJORITY OF THE HISTORIC DESIGN ELEMENTS WILL BE MAINTAINED AND RESTORED AS NECESSARY. EXISTING BEDROOMS WILL BE UPDATED WITH EN-SUITE RESTROOMS ADDED AS NEEDED. THE BASEMENT WILL BE CONVERTED TO A SMALL SPA SPACE FOR USE BY THE BED & BREAKFASTS PATRONS. THE SPA WILL INCLUDE TWO MASSAGE ROOMS, SAUNA, & HYDROTHERAPY ROOM.

BUILDING SUMMARY:

EXISTING GROSS BUILDING AREAS:		
FIRST FLOOR:	VACANT / FORMER BUSINESS USE	2,414 SFG
SECOND FLOOR:	VACANT / FORMER BUSINESS USE	2,002 SFG
THIRD FLOOR:	VACANT / FORMER BUSINESS USE	1,849 SFG
BASEMENT:	MECHANICAL AND GENERAL STORAGE	1,766 SFG
TOTAL EXISTING GROSS BUILDING AREA		8,031 SFG

NO PROPOSED CHANGES IN OVERALL BUILDING AREAS.

DISCLAIMER: ALL CONDITIONS DEPICTED ARE BASED ON KNOWLEDGE DISCOVERED UPON FIELD MEASURE (OR CONVEYED BY OWNER). IT IS THE RESPONSIBILITY OF THE CONTRACTOR TO NOTIFY THE ARCHITECT AND OWNER OF ANY DISCOVERIES EXPOSED UPON DEMOLITION / NEW CONSTRUCTION THAT DIFFER FROM CONDITIONS DEPICTED HEREIN.

SHEET LIST

SHEET NUMBER	SHEET NAME
--------------	------------


1CS	COVER SHEET
2CS	CODE SHEET
3CSP	EXISTING/DEMO SITE PLAN
4CSP	ARCHITECTURAL SITE PLAN
5CSP	SITE DETAILS
A-1.1	DEMOLITION PLANS
A-2.0	PROPOSED FLOOR PLANS
A-2.1	PROPOSED FLOOR PLANS
A-3.0	PROPOSED EXTERIOR ELEVATIONS
A-3.1	REAR ELEVATION UPDATES
A-5.0	PROPOSED REFLECTED CEILING PLANS
A-5.1	ENLARGED REFLECTED CEILING PLANS
A-8.0	SCHEDULES
E-0	BASEMENT AND FIRST FLOOR POWER PLANS
E-1	SECOND AND THIRD FLOOR POWER PLAN

SHEET LIST

SHEET NUMBER	SHEET NAME
--------------	------------

I-1.0	FIRST FLOOR - ENTRANCE
I-1.1	FIRST FLOOR - PARLOR
I-1.2	FIRST FLOOR - KITCHEN AND DINING
I-1.3	SECOND FLOOR - LOBBY
I-2.0	FIRST FLOOR - GUEST ROOM 1
I-2.1	FIRST FLOOR - GUEST ROOM 2
I-2.2	FIRST FLOOR - ADA GUEST ROOM 3
I-2.3	SECOND FLOOR - GUEST ROOM 4
I-2.4	SECOND FLOOR - GUEST ROOM 5
I-2.5	SECOND FLOOR - GUEST ROOM 6
I-3.0	LOWER LEVEL - LOBBY
I-3.1	LOWER LEVEL - BATHROOMS
I-3.2	LOWER LEVEL - HYDRO ROOM AND SAUNA
I-3.3	LOWER LEVEL - MASSAGE ROOMS
I-3.4	LOWER LEVEL - SALT ROOM
S-100	SPEC SHEET

VICINITY MAP

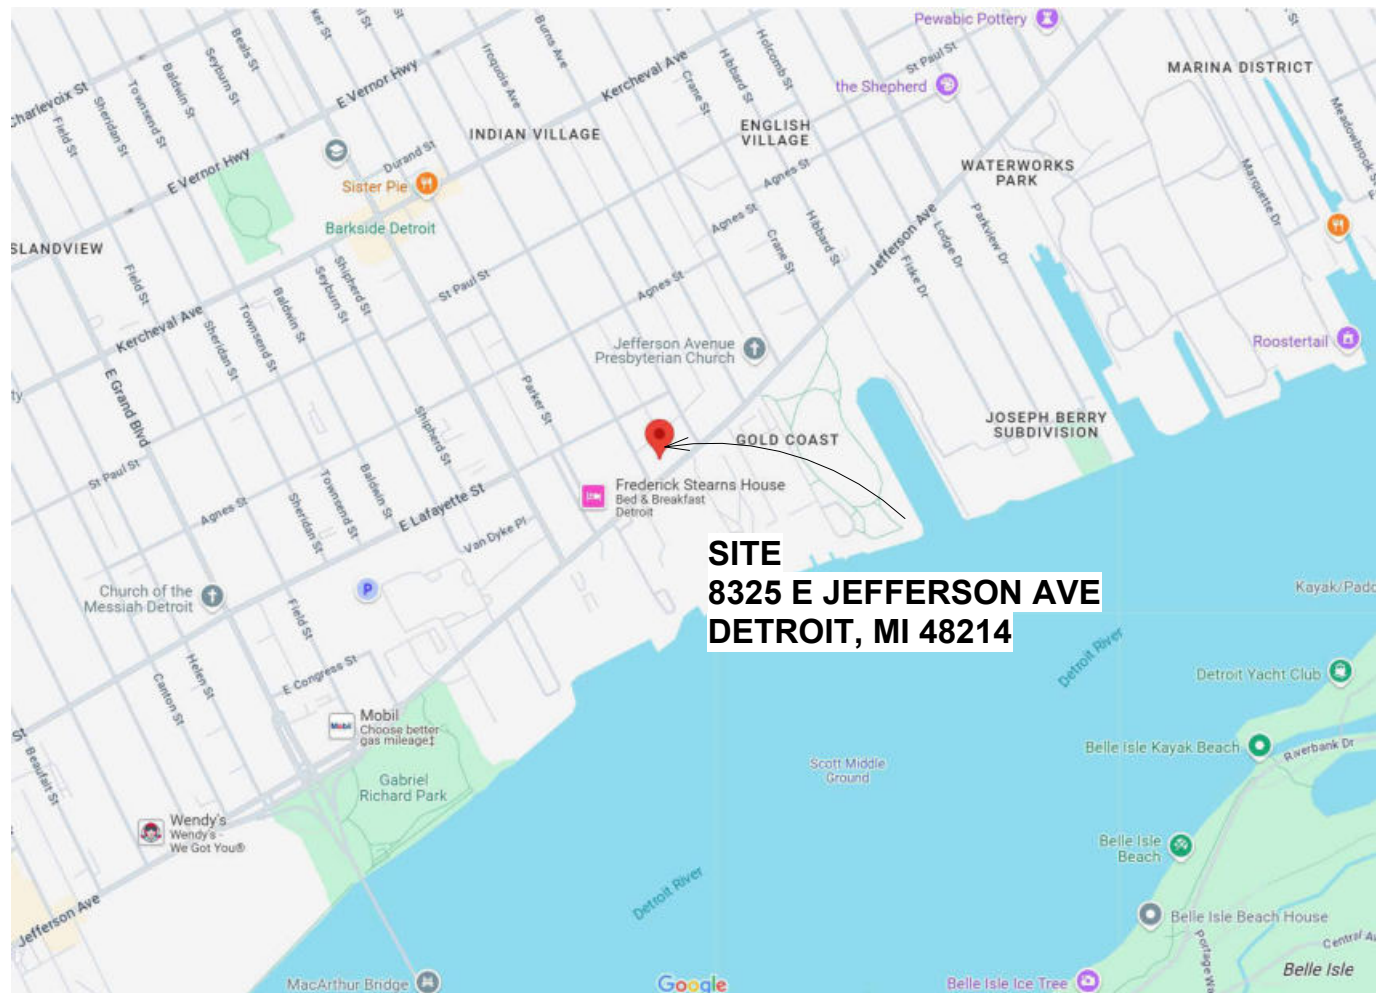

GENERAL SYMBOLS

	SECTION WITH SECTION NUMBER & NAME
	DETAIL WITH DETAIL NUMBER & NAME
	WINDOW TYPE
	DOOR TYPE
	LEVEL WITH NAME & HEIGHT
	REVISION
	NORTH DESIGNATION

ABBREVIATIONS

@	AT
ACOUST.	ACOUSTICAL
A.C.T.	ACOUSTICAL CEILING TILE
ADJ.	ADJACENT
A.F.F.	ABOVE FINISHED FLOOR
ALUM.	ALUMINUM
ANOD.	ANNODIZED
BD.	BOARD
BLDG.	BUILDING
BLK.	BLOCK
BLKG.	BLOCKING
B.O.	BOTTOM OF
B.O.F.	BOTTOM OF FOOTING
CEM.	CEMENT
CFM.	CUBIC FEET PER MINUTE
CL.	CENTERLINE
C.O.	CLEANOUT
COL.	COLUMN
COL.C.	CORNER GUARD
CONST.	CONSTRUCTION
CONT.	CONTINUOUS
CORR.	CORRUGATED
CPT.	CARPET
C.T.	CERAMIC TILE
DET.	DETAIL
DIA.	DIAMETER
DIM.	DIMENSION
DN.	DOWN
D.O.	DOOR OPENING
DR.	DOOR
DWG.	DRAWING
EA.	EACH
ELEV.	ELEVATION
E.W.	EACH WAY
EX.	EXISTING
EXIST.	EXISTING
EXP.	EXPANSION/EXPOSED
EXT.	EXTERIOR
F.D.	FLOOR DRAIN
FDN.	FOUNDATION
FRP.	FIBER REINFORCED PANELS
FIN.	FINISH
FLR.	FLOOR
F.O.	FACE OF
F.O.S.	FACE OF STUD
FR.	FRAME
FTG.	FOOTING

GA.	GAUGE
GALV.	GALVANIZED
GYP.	GYPSUM
HDW.	HARDWARE
H.M.	HOLLOW METAL
HORIZ.	HORIZONTAL
HT.	HEIGHT
I.D.	INSIDE DIAMETER
INSUL.	INSULATION
INT.	INTERIOR
JT.	JOINT
LAV.	LAVATORY
LG.	LONG
LLO.	LONG LEG OUTSTANDING
LLV.	LONG LEG VERTICAL
MAX.	MAXIMUM
MECH.	MECHANICAL
MET.	METAL
MEZZ.	MEZZANINE
M.I.	MISCELLANEOUS IRON
MIN.	MINIMUM
MISC.	MISCELLANEOUS
M.O.	MASONRY OPENING
N.I.C.	NOT IN CONTRACT
N.S.	NO SCALE
N.T.S.	NOT TO SCALE
O.C.	ON CENTER
O.D.	OUTSIDE DIAMETER
OPNG.	OPENING
OPP.	OPPOSITE
PL.G.	PLATE GLASS
PL.S.	PLATE STEEL
PL.	PLATE
P-LAM.	PLASTIC LAMINATE
PLAS.	PLASTER
PREFAB.	PREFABRICATED
PROJ.	PROJECT
P.F.	POUNDS PER SQUARE FOOT
PT.	PAINT/POINT
R.	RISER
R.A.	RETURN AIR
R.B.	RUBBER BASE
R.C.	ROOF CONDUCTOR
R.F.	RUBBER FLOORING
REINF.	REINFORCED/REINFORCING
REQ'D.	REQUIRED
RFG.	ROOFING
RM.	ROOM
R.S.	ROOF SUMP
R.T.	RUBBER TILE
SAN.	SANITARY
SCHED.	SCHEDULE
SHT.	SHEET
SIM.	SIMILAR
SPEC.	SPECIFICATION
S.S.	SERVICE SINK/STAINLESS STEEL
STL.	STEEL
STD.	STANDARD
STOR.	STORAGE
STRUCT.	STRUCTURAL
SUSP.	SUSPENDED
SW.	SWITCH
SYM.	SYMMETRICAL
T.	TREAD
T&B	TOP AND BOTTOM
TEL.	TELEPHONE
TERR.	TERRAZZO
T&G	TONGUE AND GROOVE
THK.	THICK/THICKNESS
THRES.	THRESHOLD
T.O.	TOP OF
T.O.F.	TOP OF FOOTING
T.O.S.	TOP OF STEEL
TYP.	TYPICAL
U/C	UNDERCUT
U.N.O.	UNLESS NOTED OHTERWISE
UIS	UNDERSIDE
V.B.	VINYL BASE
V.C.B.	VINYL COBE BASE
V.C.T.	VINYL COMPOSITE TILE
V.I.F.	VERIFY IN FIELD
V.S.B.	VINYL STRAIGHT BASE
VERT.	VERTICAL
WD.	WIDE
WAINS.	WAINSCOT
W.A.	WATER CLOSET
WD. WIN.	WOOD WINDOW
WOOD.	WOOD
WT.	WEIGHT
W.W.F.	WELDED WIRE FABRIC
W.W.M.	WOVEN WIRE MESH



Email: infuzltd@comcast.net
Web: infuzarchitects.com

GENERAL CONTRACTOR

XXXXXXXXX
XXXXXX

Unauthorized use of this drawing set without written permission from VIRTUOSO DESIGN + BUILD and Infuz Ltd is in violation of U.S. COPYRIGHT LAWS and will be subject to civil damages and prosecution.

NO.	DESCRIPTION	DATE
1	Commercial Set	03/13/2025

SEAL

NOT FOR
CONSTRUCTION

03/13/2025

BERKERY ESTATE

8325 E JEFFERSON AVE
DETROIT, MI 48214

NIALL & MELVIE BERKERY

COVER SHEET

SHEET NUMBER

1CS

BUILDING CODE SUMMARY

PROJECT INFORMATION

Owner: Melvie & Niall Berkery
Location: 8325 Jefferson
Detroit, MI 48214

PROJECT DESCRIPTION:

PROJECT DETAILS: THE BERKERY ESTATE OFFERS LUXURIOUS BED AND BREAKFAST ACCOMMODATIONS NEAR DOWNTOWN DETROIT. COMPLETE WITH A FULL-SERVICE SALON FOR ULTIMATE PAMPERING. ADDITIONALLY, A PENTHOUSE RESIDENCE IS AVAILABLE FOR EXCLUSIVE RESIDENTIAL LIVING. THE CLIENT WANTS TO ADD POSSIBLY 4 BATHROOMS.

GENERAL SCOPE OF WORK: THE ARCHITECT SHALL VISIT THE SITE FOR A FIELD INVESTIGATION/MEASURE AND PHOTO SURVEY. FROM FIELD INFORMATION, A 3D/BIM CAD MODEL OF THE BUILDING WILL BE CONSTRUCTED. THE ARCHITECT WILL PROVIDE CONCEPT/SCHEMATIC DESIGN STUDIES OF THE RENOVATION OF THE EXISTING INTERIOR AND EXTERIOR OF THE SPACE. TEST FIT FLOOR PLAN(S) WILL BE GENERATED DEPICTING THE FUNCTIONALITY OF PROGRAMMED SPACES, CIRCULATION, AND A LAYOUT OF FURNISHINGS WITH INTERIOR DESIGN INTENT INJECTING A CONTEMPORARY DESIGN INTO SPACES, WHERE APPLICABLE. CONSTRUCTION DOCUMENTS WILL BE PROVIDED FOR THE EXISTING BUILDING IMPROVEMENTS. THERE WILL BE MECHANICAL, ELECTRICAL, AND PLUMBING SCHEMATIC DESIGNS PROVIDED, AND WILL BE RESOLVED IN CONJUNCTION WITH THE CLIENT'S MECHANICAL CONTRACTOR. SITE AND LANDSCAPE DESIGN TO INCLUDE ARTWORK, SCULPTURES, HARDSCAPE, SOFTSCAPE, AND LIGHTING CONCEPTS WILL BE PROVIDED BY THE ARCHITECT TO CONVEY A MORE CONTEMPORARY DEVELOPMENT. VISUALIZATIONS/RENDERING OF EXTERIOR INCLUDED

BUILDING SUMMARY:

EXISTING GROSS BUILDING AREAS:			
FIRST FLOOR:	VACANT / FORMER BUSINESS USE	2,414 SFG	
SECOND FLOOR:	VACANT / FORMER BUSINESS USE	2,002 SFG	
THIRD FLOOR:	VACANT / FORMER BUSINESS USE	1,849 SFG	
BASEMENT:	MECHANICAL AND GENERAL STORAGE	1,766 SFG	
TOTAL EXISTING GROSS BUILDING AREA		8,031 SFG	

NO PROPOSED CHANGES IN OVERALL BUILDING AREAS.

ZONING REQUIREMENTS

LOCAL AUTHORITY:	CITY OF DETROIT		
LOCAL ORDINANCE:	DETROIT ZONING ORDINANCE (30 JANUARY 2024)		
ZONING CLASSIFICATION:	B-4: GENERAL BUSINESS DISTRICT		
OVERLAY DISTRICT:	GATEWAY RADIAL THOROUGHFARE OVERLAY: THE GATEWAY RADIAL THOROUGHFARE OVERLAY AREAS CONSIST OF PROPERTY ABUTTING THOSE MAJOR RADIAL STREETS, WITHIN AND LEADING TO THE CENTRAL BUSINESS DISTRICT, UPON WHICH THE MASTER PLAN OF POLICIES HAS GENERALLY PROPOSED A REZONING FROM B4 GENERAL BUSINESS DISTRICT TO A SPECIAL DEVELOPMENT ZONING DISTRICT. (SEC 50-11-361) (5)EAST JEFFERSON AVENUE BETWEEN WATER WORKS PARK (GARLAND AVENUE/MARQUETTE AVENUE) AND THE CHRYSLER FREEWAY (I-375). PROHIBITED USES		
USE CLASSIFICATION:	SEC. 50-9-106. - BY-RIGHT RETAIL, SERVICE, AND COMMERCIAL USES (16)RECREATION, INDOOR, COMMERCIAL AND HEALTH CLUB NOT EXCEEDING 10,000 SQUARE FEET OF GROSS FLOOR AREA		
	SEC. 50-9-112. - CONDITIONAL RETAIL, SERVICE, AND COMMERCIAL USES (6)BED AND BREAKFAST INN		
REQUIRED PARKING:	HIGH FREQUENCY TRANSIT CORRIDOR NO. 9; CONSISTING OF: EAST AND WEST JEFFERSON BETWEEN WASHINGTON AND ALTER. (SEC 50-16-242)		
	SEC. 50-14-49. - RETAIL, SERVICE, AND COMMERCIAL USES WHERE THE USE IS LOCATED WITHIN 0.50 MILES OF A HIGH-FREQUENCY TRANSIT CORRIDOR: 0.75 OF THE MINIMUM REQUIRED OFF-STREET SPACES SPECIFIED IN SECTIONS 50-14-50 THROUGH SECTION 50-14-60.		
	SEC. 50-14-54. - PUBLIC ACCOMMODATION BED AND BREAKFAST INN. 3 PER 4 GUESTROOMS = 2 PER DWELLING UNIT 8 GUESTROOMS = 6 SPACES 1 DWELLING = 2 SPACES 8 SPACES REQUIRED		
	SEC. 50-14-55. - RECREATION AND ENTERTAINMENT, INDOOR HEALTH CLUB. 1 PER 200 GSF 1000 GSF = 5 SPACES		
	TOTAL SPACES REQUIRED = 13 * 0.75 = 10 SPACES REQUIRED		
EXISTING PARKING:	SEC. 50-14-52. - OFFICE OFFICE, BUSINESS OR PROFESSIONAL 5409 GSF / 400 = 13.52 =		
	1 PER 400 GSF 14 SPACES REQUIRED 11 EXISTING SPACES PROVIDED		
OFF STREET LOADING:	(SECT. 50-14-114) SPACES REQUIRED:		
	1 @ 12'X35'		

BUILDING CODE REQUIREMENTS:

GOVERNING CODES:
2015 MICHIGAN REHABILITATION CODE FOR EXISTING BUILDINGS (MRCEB)
2021 MICHIGAN MECHANICAL CODE (MMC)
2021 MICHIGAN PLUMBING CODE (MPC)
2023 NATIONAL ELECTRICAL CODE (NEC)
2015 MICHIGAN UNIFORM ENERGY CODE (MUEC)
2015 INTERNATIONAL FIRE CODE NFPA 1, UNIFORM FIRE CODE

<u>LEVEL OF ALTERATIONS:</u>	CHANGE OF OCCUPANCY
<u>USE AND OCCUPANCY:</u>	NON-SEPARATED MIXED-USE
1ST, 2ND & 3RD FLOOR / PRIMARY USE:	RESIDENTIAL GROUP R-1 / BED & BREAKFAST
BASEMENT:	BUSINESS GROUP B / SPA
<u>ALLOWABLE HEIGHTS AND AREAS:</u> (MBC TABLES 504.3, 504.4 AND 506.2)	
CONSTRUCTION TYPE:	TYPE VB / NS (NOT SPRINKLERED)
ALLOWABLE HEIGHT:	2 STORIES / 40 FEET
ACTUAL HEIGHT:	3 STORIES / 39 FEET
ALLOWABLE AREA:	B - 9,000SF R-1 - 7,000SF
ACTUAL AREA:	2,414 GSF PER FLOOR

FIRE RESISTANCE RATINGS: (MBC TABLES 601 & 602)	
CONSTRUCTION TYPE:	TYPE VB
PRIMARY STRUCTURAL FRAME:	0 HOURS
EXTERIOR BEARING WALLS:	0 HOURS
INTERIOR BEARING WALLS:	0 HOURS
INTERIOR NON-BEARING WALLS:	0 HOURS
FLOOR CONSTRUCTION:	0 HOURS
ROOF CONSTRUCTION:	0 HOURS

FIRE AND SMOKE PROTECTION FEATURES:	
FIRE WALLS (MBC SECT. 706):	NONE REQUIRED
FIRE BARRIERS (MBC SECT. 707):	INTERIOR EXIT STAIRWAYS / 1 HOUR (MBC SECT. 1023.2)
FIRE PARTITIONS (MBC SECT. 708):	1 HR REQUIRED WHERE SEPARATING SLEEPING UNITS ½ HOUR WITH SPRINKLER (708.3.2)
SMOKE BARRIERS (MBC SECT. 709):	NONE REQUIRED
SMOKE PARTITIONS (MBC SECT. 710):	NONE REQUIRED
RATED FLOOR ASSEMBLIES (MBC SECT. 712):	1 HR SEPARATING SLEEPING UNITS ½ HR SEPARATING SLEEPING UNITS IF SPRINKLED (711.2.4.3) 1 HR / B TO R SEPARATION IF SPRINKLED 2 HR / B TO R SEPARATION IF NS (MBC TABLE 508.4)
SHAFT ENCLOSURES (MBC SECT. 713.4):	1 HR / LESS THAN 4 STORIES

INTERIOR FINISHES: (MBC TABLE 803.11)	
INTERIOR EXIT STAIRWAYS/PASSAGEWAYS	CLASS A
CORRIDORS, EXIT ACCESS ENCLOSURES	CLASS B
ROOMS AND ENCLOSED SPACES	CLASS C

FIRE PROTECTION SYSTEMS:	
AUTOMATIC FIRE SUPPRESSION SYSTEM: (MBC SECT. 903.2.8)	
• 903.2.8 GROUP R. AN AUTOMATIC SPRINKLER SYSTEM INSTALLED IN ACCORDANCE WITH SECTION 903.3 SHALL BE PROVIDED THROUGHOUT ALL BUILDINGS WITH A GROUP R FIRE AREA.	
• [F] 903.3.1.2 NFPA 13R SPRINKLER SYSTEMS. AUTOMATIC SPRINKLER SYSTEMS IN GROUP R OCCUPANCIES UP TO AND INCLUDING FOUR STORIES IN HEIGHT	
• NOT REQUIRED FOR GROUP B AREAS	
PORTABLE FIRE EXTINGUISHERS (MBC SECT. 906 / TABLE 906.3(1))	
• PORTABLE FIRE EXTINGUISHERS: LOW HAZARD / TYPE 2-A / MAXIMUM TRAVEL DISTANCE = 75 FT. / MAXIMUM 3000 SF PER UNIT	
• WITHIN 30' OF COMMERCIAL COOKING EQUIPMENT (906.1)	
FIRE ALARM AND DETECTION SYSTEM: (MBC SECT. 907)	
• FIRE ALARM AND DETECTION SYSTEM: NOT REQUIRED IF SUPPRESSION SYSTEM PROVIDED (MBC SECT. 907.2.8.1-2.2.1)	
• AN AUTOMATIC SMOKE DETECTION SYSTEM IS REQUIRED THROUGHOUT ALL CORRIDORS SERVING SLEEPING UNITS (MBC 907.2.8.2)	
• SMOKE ALARMS SHALL BE INSTALLED IN ACCORDANCE WITH 907.2.11	
• IN SLEEPING AREAS	
• IN EVERY ROOM IN THE PATH OF THE MEANS OF EGRESS TO THE DOOR LEADING FROM THE SLEEPING UNIT	
• GROUP B: NOT REQUIRED (<100 OCCUPANTS BELOW GRADE MBC 907.2.2)	

MEANS OF EGRESS

OCCUPANT LOAD: (MBC TABLE 1004.1.2)				
	USE GROUP	AREA/OCCUPANT	USABLE AREA	OCCUPANTS
•	GROUND FLOOR:	R-1/ RESIDENTIAL	200 SF/P GROSS	2,700 SFN 14
•	SECOND FLOOR:	R-1/RESIDENTIAL	200 SF/P GROSS	2,000 SFG 10
•	THIRD FLOOR:	R-1/RESIDENTIAL	200 SF/P GROSS	2,000 SFG 10
•	BASEMENT:	B/OUTPATIENT AREAS	100 SF/P GROSS	2,000 SFG 20
TOTAL OCCUPANT LOAD:				54
EGRESS CAPACITY: (MBC SECT. 1005.3.1 AND 1005.3.2)				
• GROUND FLOOR/MINIMUM WIDTH: 14 OCCUPANTS X 0.2IN. = 2.2 INCHES				
• SECOND FLOOR/MINIMUM WIDTH: 10 OCCUPANTS X 0.3IN. = 1.8 INCHES				
• THIRD FLOOR/MINIMUM WIDTH: 10 OCCUPANTS X 0.3IN. = 1.8 INCHES				
• BASEMENT/MINIMUM WIDTH: 20 OCCUPANTS X 0.3IN. = 1.8 INCHES				
• MINIMUM CLEAR DOOR OPENING: 32 INCHES (MBC SECT. 1010.1.1)				
• MINIMUM CLEAR STAIR WIDTH: 44 INCHES / OCCUPANT LOAD > 50P. (MBC SECT. 1011.2)				
• 36 INCHES / OCCUPANT LOAD < 50P. (MBC SECT. 1011.2.1)				
• MINIMUM CORRIDOR WIDTH: 44 INCHES / OCCUPANT LOAD > 50P. (MBC TABLE 1020.2)				
• 36 INCHES / OCCUPANT LOAD < 50P. (MBC TABLE 1020.2)				
MAXIMUM COMMON PATH OF TRAVEL				
REQUIRED NUMBER OF EXITS: (MBC SECT. 1006 / TABLE 1006.2.1)				
• GROUND FLOOR: 2 EXITS REQUIRED / 2 PROVIDED				
• SECOND FLOOR: 1 EXITS REQUIRED / 1 PROVIDED				
• THIRD FLOOR: 2 EXITS REQUIRED / 1 PROVIDED				
• THE OCCUPANT LOAD, NUMBER OF DWELLING UNITS AND COMMON PATH OF EGRESS TRAVEL DISTANCE DOES NOT EXCEED THE VALUES IN TABLE 1006.3.2(1) OR 1006.3.2(2)				
• MAXIMUM OCCUPANT LOAD PER STORY = 10 & MAX PATH OF TRAVEL = 75'				
• EXEMPTIONS MAY BE ACHIEVABLE FOR HISTORIC BUILDINGS				
• 1 EXIT REQUIRED / 1 PROVIDED				
• ROOMS, AREAS AND SPACES COMPLYING WITH SECTION 1006.2.1 WITH EXITS THAT DISCHARGE DIRECTLY TO THE EXTERIOR AT THE LEVEL OF EXIT DISCHARGE, ARE PERMITTED TO HAVE ONE EXIT OR ACCESS TO A SINGLE EXIT (MBC 1006.3.2).				
• MAXIMUM TRAVEL DISTANCE = 100' (<30 OCCUPANTS) PER TABLE 1006.2.1				
FIRE RATED CONSTRUCTION:				
• INTERIOR EXIT STAIRWAYS ENCLOSURE (MBC SECT. 1023): 1 HOUR				
• EXIT ACCESS CORRIDORS (MBC TABLE 1020.1): 1 HOUR				
• ½ HR WITH SPRINKLER SYSTEM				

ACCESSIBLE MEANS OF EGRESS:	
• ONE ACCESSIBLE MEANS OF EGRESS REQUIRED (MRCEB 1012.8.2)	
• GROUND FLOOR:	1 ACCESSIBLE EXIT PROVIDED.

PLUMBING FIXTURE REQUIREMENTS

USE GROUP:	BUSINESS / B	
OCCUPANT LOAD:	BASEMENT:	20 PERSONS
SEPARATE FACILITIES: NOT REQUIRED / TENANT OCCUPANCY < 15 PERSONS (MPC 403.2)		
REQUIRED FIXTURES:	WATER CLOSETS/URINALS REQUIRED:	1 PER 25 OCCUPANTS
	LAVATORIES REQUIRED:	1 PER 40 OCCUPANTS
	DRINKING FOUNTAINS REQUIRED:	NONE REQUIRED (MPC 410.1)
	SERVICE SINKS REQUIRED:	1 REQUIRED
FIXTURES PROVIDED:	WATER CLOSETS:	1 REQUIRED / 1 PROVIDED
	LAVATORIES:	1 REQUIRED / 1 PROVIDED
	SERVICE SINKS REQUIRED:	1 REQUIRED / 1 PROVIDED



ARCHITECTS + INNOVATORS

Port Huron Office
208 Huron Ave., Suite 1
Port Huron, MI 48130
Phone: 566.2557604

Detroit Office
1111 Bellevue Ste 201
Detroit, MI 48206
Phone: 313.332.1299

Email: infuzltd@comcast.net
Web: infuzarchitects.com

Unauthorized use of this drawing set without written permission from VIRTUOSO DESIGN + BUILD and infuz Ltd is in violation of U.S. COPYRIGHT LAWS and will be subject to civil damages and prosecution.

Revision Schedule

#	Description	Date
1	Commercial Set	03/13/2025

SEAL

NOT FOR CONSTRUCTION

03/13/2025

BERKERY ESTATE

PROJECT NUMBER: Z2405
8325 E. JEFFERSON AVE
DETROIT, MI 48214
NIAL & MELVIE BERKERY

SHEET TITLE
CODE SHEET


SHEET NUMBER
2CS

C:\Shared Drive\NEC 12/2024\The Berkery Estate-8325 Jefferson-83420-Z2405-0007-The Berkery Estate.rvt

3/14/2025 1:36:34 PM



EXISTING SITE CONDITION PHOTOS

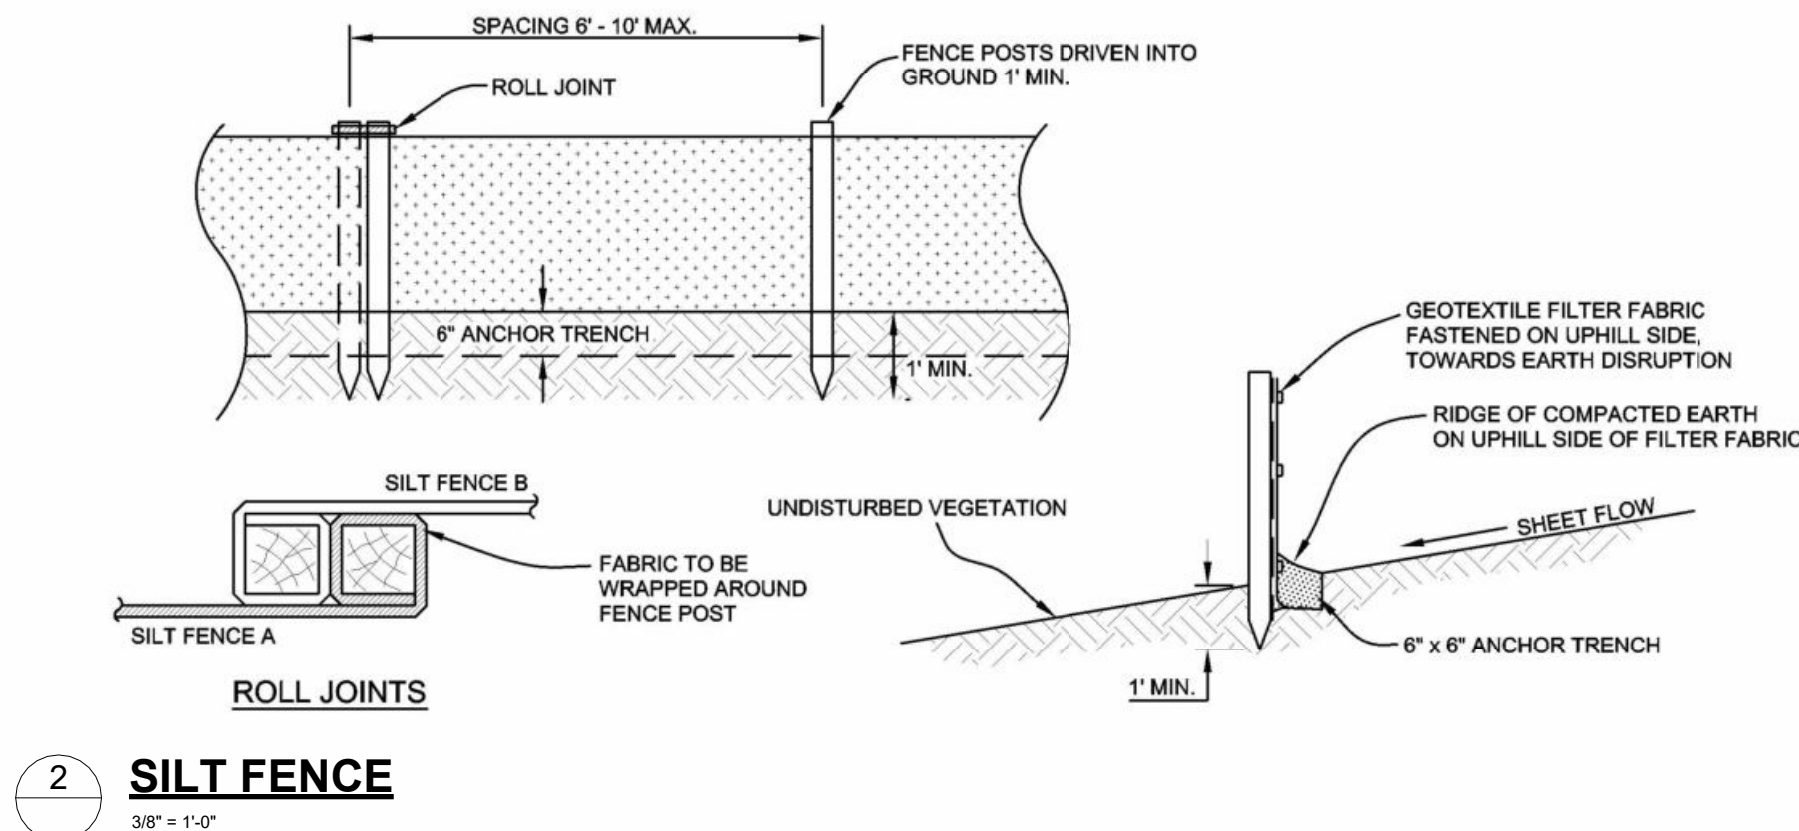

SOIL EROSION/SEDIMENT CONTROL MAINTENANCE NOTES

THIS PROJECT SHALL BE CONSTRUCTED IN COMPLIANCE WITH PART 91 OF ACT 451 OF 1994, AS AMENDED, THE SOIL EROSION AND SEDIMENTATION CONTROL AND THE LOCAL COUNTY SOIL EROSION AND SEDIMENTATION CONTROL ORDINANCE.

ALL EROSION AND SEDIMENTATION CONTROL WORK SHALL CONFORM TO THE STANDARDS AND SPECIFICATIONS OF THE LOCAL COUNTY PUBLIC WORKS OFFICE.

EROSION AND SEDIMENTATION FROM WORK ON THIS SITE SHALL BE CONTAINED ON THE SITE AND NOT ALLOWED TO COLLECT ON ANY OFF SITE AREAS OR IN WATERWAYS. WATERWAYS INCLUDE BOTH NATURAL AND MAN-MADE OPEN DITCHES, STREAMS, STORM DRAINS, LAKES AND PONDS.

STAGING OF THE WORK WILL BE DONE BY THE LANDOWNER'S REPRESENTATIVE AS DIRECTED IN THESE PLANS, AND AS REQUIRED TO ENSURE PROGRESSIVE STABILIZATION OF DISTURBED EARTH CHANGE. THE LANDOWNER OF LANDOWNER'S REPRESENTATIVE SHALL BE RESPONSIBLE FOR INSTALLATION AND MAINTENANCE OF SOIL EROSION AND SEDIMENTATION CONTROL DEVICES.

THE LANDOWNER OR LANDOWNER'S REPRESENTATIVE SHALL IMPLEMENT AND MAINTAIN THE SOIL EROSION CONTROL MEASURES AS SHOWN ON THE PLANS BEFORE, AND AT ALL TIMES DURING CONSTRUCTION ON THIS PROJECT. ANY MODIFICATIONS OR ADDITIONS TO SOIL EROSION CONTROL MEASURES DUE TO CONSTRUCTION OR CHANGED CONDITIONS SHALL BE COMPLIED WITH AS REQUIRED OR DIRECTED BY THE LOCAL PUBLIC WORKS OFFICE.

IF ANY SESC MEASURES ON THE SITE ARE DEEMED INADEQUATE OR INEFFECTIVE, THE LOCAL COUNTY PUBLIC WORKS OFFICE SESC DIVISION HAS THE RIGHT TO REQUIRE ADDITIONAL SESC MEASURES AT THE EXPENSE OF THE LANDOWNER.

INSTALL A CRUSHED CONCRETE ACCESS DRIVE PLACED ON GEOTEXTILE FABRIC AS INDICATED ON THE PLAN. THE ACCESS DRIVE MUST BE A MINIMUM OF 30"x60"x8".

A. NEW LAYERS OF CRUSHED CONCRETE WILL BE ADDED AS OLD LAYERS BECOME COMPACTED.		
INSTALL SILT FENCE AS INDICATED ON THE PLAN AND AT ADDITIONAL AREA AS NECESSARY.		
A. SILT FENCE SHALL BE INSTALLED PER DETAIL.		
B. BUILD SEDIMENT SHALL BE REMOVED WHEN SEDIMENT ACCUMULATES TO 1/3 TO 1/2 OF THE	HEIGHT OF THE SILT FENCE.	
C. IF SILT FENCE DECOMPOSES OR BECOMES INEFFECTIVE PRIOR TO THE END OF ITS EXPECTED	USABLE LIFE AND THE BARRIER IS STILL REQUIRED, THE SILT FENCE SHALL BE REPLACED	PROMPTLY.
D. SILT FENCE SHALL BE INSPECTED WEEKLY UNDER NORMAL CONDITIONS, WITHIN 24 HOURS OF	RAINFALL AND DAILY DURING A PROLONGED RAIN EVENT. REQUIRED MAINTENANCE SHALL BE	PROVIDED

PROMPTLY.

INSTALL DRAIN GUARD ON ALL CATCH BASINS PER DETAIL. SEED OR SOD THE AREA BETWEEN THE SILT FENCE AND THE INLET.

A. DRAIN GUARDS SHALL BE INSPECTED WEEKLY UNDER NORMAL CONDITIONS, WITHIN 24 HOURS		
OF RAINFALL AND DURING A PROLONGED RAIN EVENT.		
B. BUILDUP OF SEDIMENT SHALL BE REMOVED WHEN SEDIMENT ACCUMULATES TO 1/3 TO 1/2 OF	THE HEIGHT OF THE SILT FENCE.	
C. IF FABRIC DECOMPOSES OR BECOMES INEFFECTIVE PRIOR TO THE END OF ITS EXPECTED	USABLE LIFE AND THE BARRIER IS STILL REQUIRED, THE SILT FENCE SHALL BE REPLACED	PROMPTLY.

INLET SEDIMENT TRAPS AND ALL DITCH SEDIMENT TRAPS SHALL BE INSPECTED DAILY. THE SEDIMENT PITS SHALL BE CLEANED OUT WHEN HALF FULL, OR AS DIRECTED BY THE LOCAL COUNTY PUBLIC WORKS OFFICE.

IMMEDIATELY AFTER SEEDING, MULCH ALL SEEDED AREAS WITH UNWEATHERED SMALL GRAIN STRAW, SPREAD UNIFORMLY AT THE RATE OF 1 TO 2 TONS PER ACRE OR 100 POUNDS (2-3 BALES) PER 1,000 SQUARE FEET. THIS MULCH SHOULD BE ANCHORED WITH DISC TYPE MULCH ANCHORING TOOL OF OTHER MEANS AS APPROVED BY THE LOCAL COUNTY PUBLIC WORKS OFFICE. MULCH MATTING MAY BE USED IN LIEU OF LOOSE MULCH.

ALL DIRT TRACKED ONTO ANY ROADWAY SHALL BE REMOVED IMMEDIATELY.


STREETS AND OR PARKING AREAS WILL BE SCRAPPED ON A DAILY BASIS AND SWEEPED AT A MINIMUM OF ONCE PER WEEK BY THE LANDOWNER OR LANDOWNER'S REPRESENTATIVE.


DURING DRY PERIODS, ALL DISTURBED AREAS SHALL BE WATERED FOR DUST CONTROL.

PERMANENT SOIL EROSION CONTROL MEASURES FOR ALL SLOPES, CHANNELS, DITCHES, OR ANY DISTURBED LAND AREA SHALL BE COMPLETED WITHIN 5 CALENDAR DAYS AFTER FINAL GRADING OR THE FINAL EARTH CHANGE HAS BEEN COMPLETED. WHEN IT IS NOT POSSIBLE TO PERMANENTLY STABILIZE A DISTURBED AREA AFTER EARTH CHANGE ACTIVITY CEASES, TEMPORARY SOIL EROSION CONTROL MEASURES SHALL BE IMPLEMENTED IMMEDIATELY. ALL TEMPORARY SOIL EROSION CONTROL SHALL BE MAINTAINED UNTIL PERMANENT SOIL EROSION CONTROL MEASURES ARE IMPLEMENTED. ALL PERMANENT SOIL EROSION CONTROL MEASURES WILL BE IMPLEMENTED AND ESTABLISHED BEFORE A CERTIFICATE OF COMPLIANCE IS ISSUED.

FINAL GRADE, ESTABLISH VEGETATION AND OR LANDSCAPE ALL DISTURBED AREAS NOT BUILT OR PAVED UPON.

REMOVE ALL TEMPORARY SOIL EROSION DEVICES AFTER PERMANENT STABILIZATION IS ESTABLISHED.

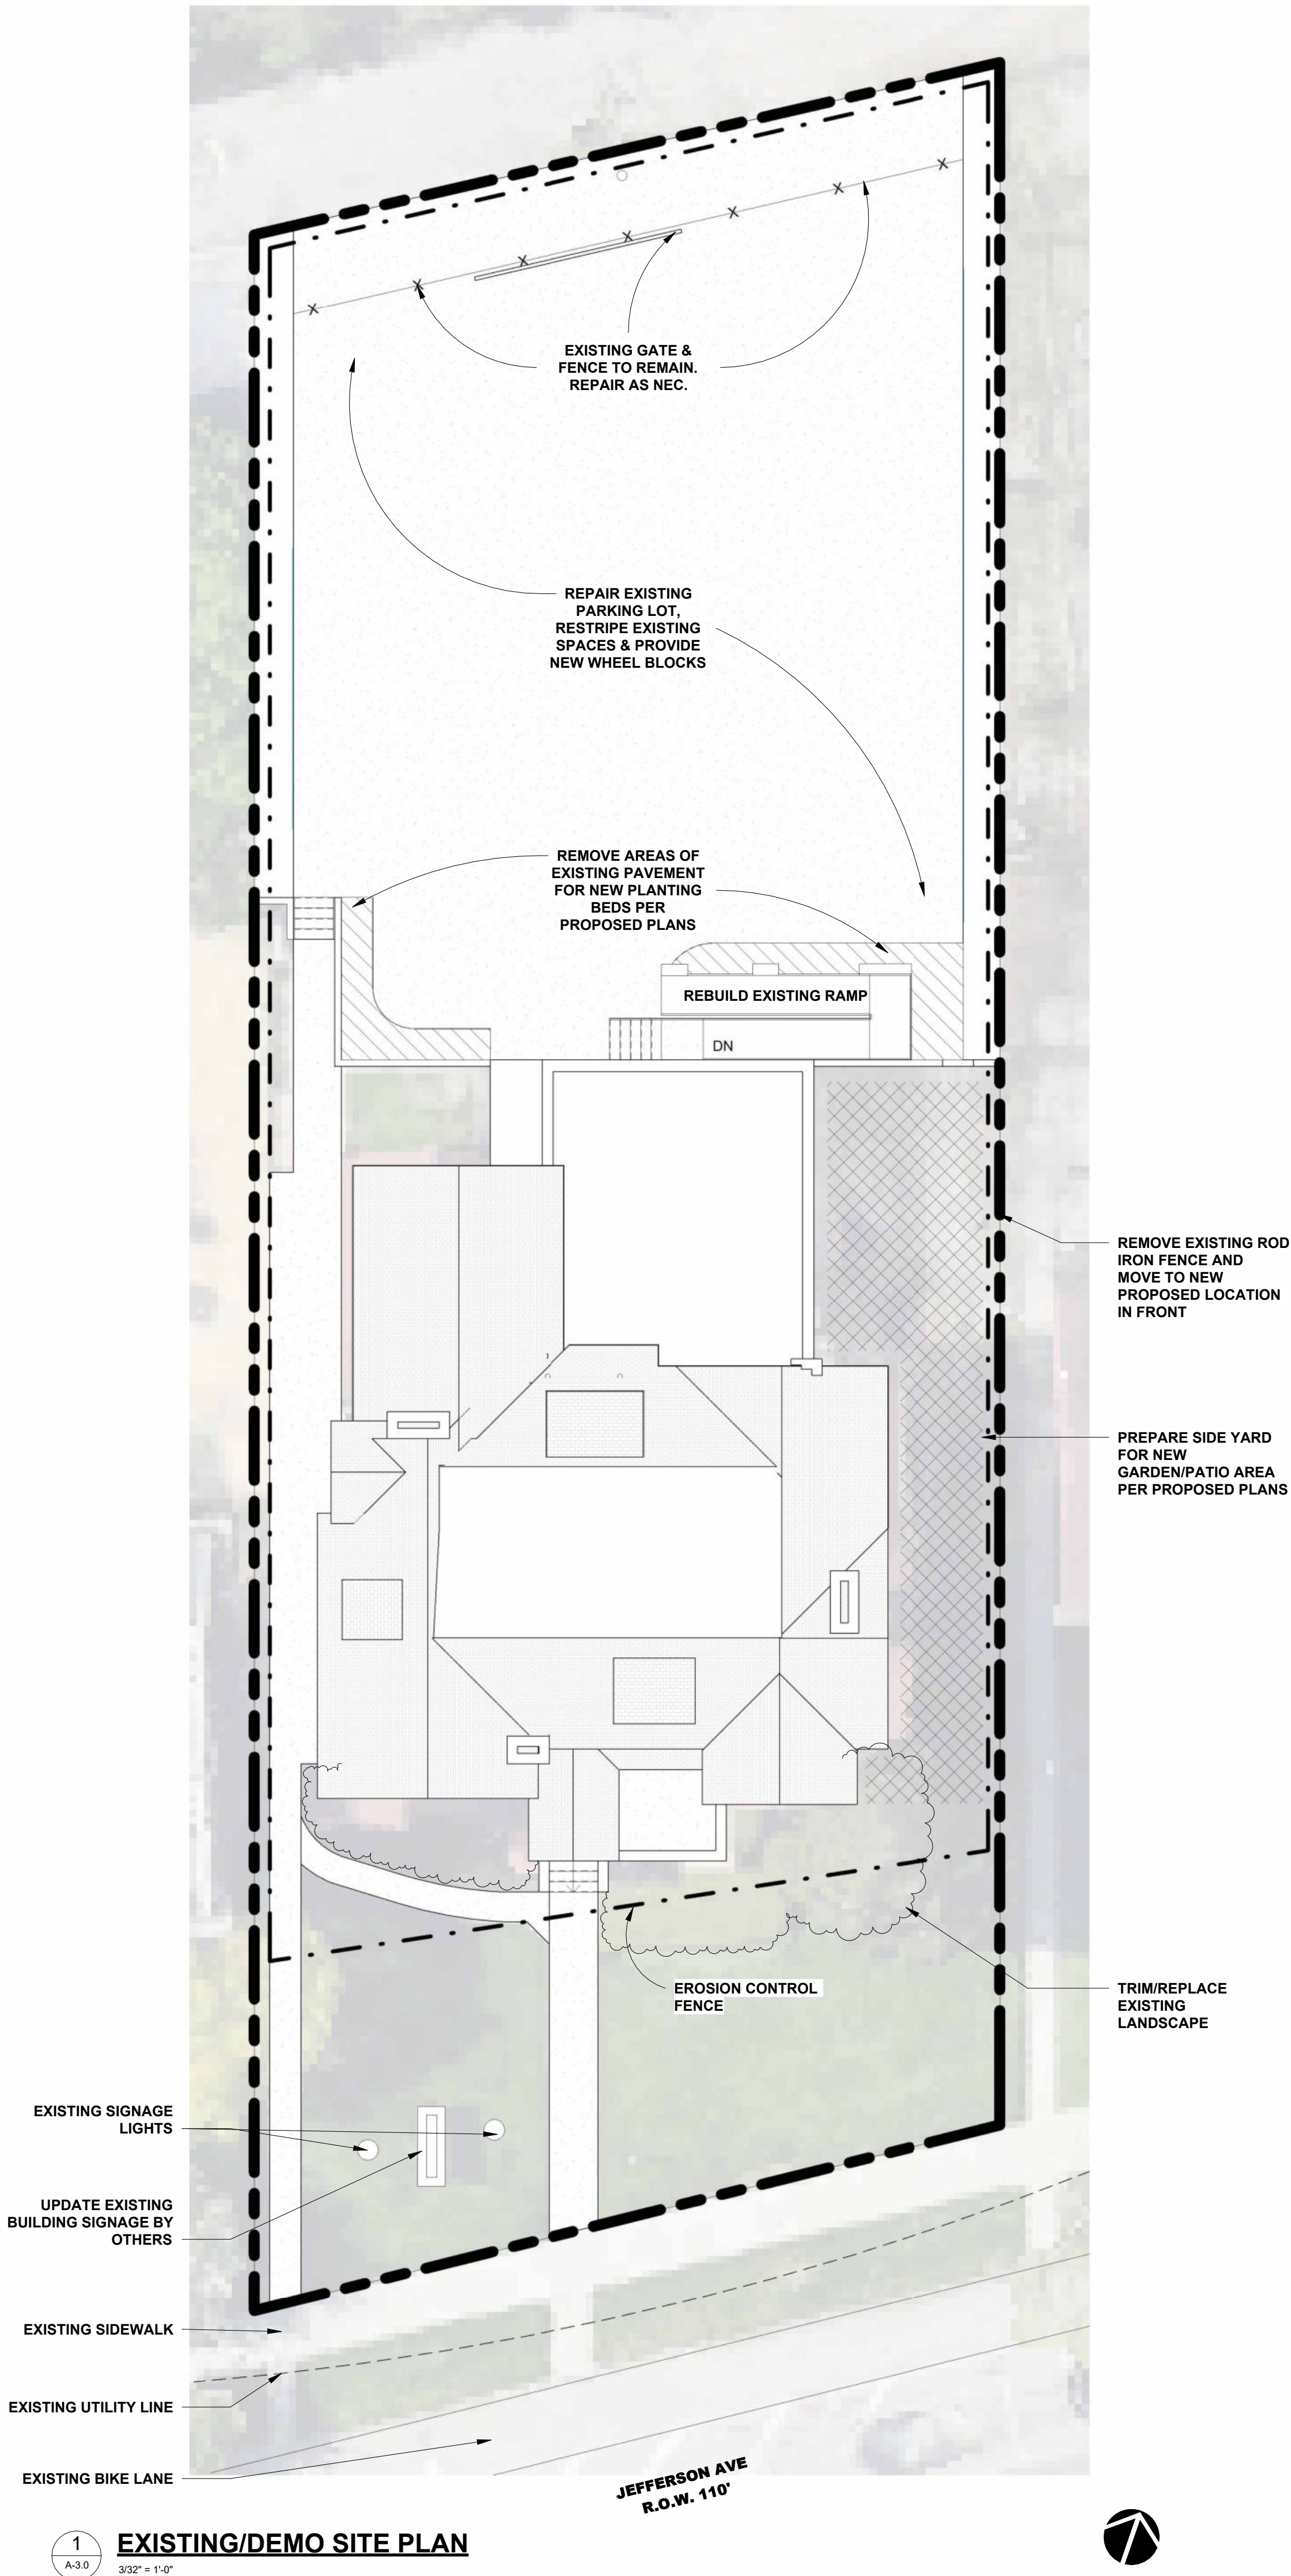



ARCHITECTS + INNOVATORS

Port Huron Office
208 Huron Ave., Suite 1
Port Huron, MI 48130
Phone: 568.265.7604

Detroit Office
1111 Bellevue St. 201
Detroit, MI 48206
Phone: 313.332.1299

Email: infuzltd@comcast.net
Web: infuzarchitects.com

Unauthorized use of this drawing set without written permission from VIRTUOSO DESIGN + BUILD and Infuz Ltd is in violation of U.S. COPYRIGHT LAWS and will be subject to civil damages and prosecution.

Revision Schedule		
#	Description	Date
1	Commercial Set	03/13/2025

SEAL

NOT FOR CONSTRUCTION

03/13/2025

BERKERY ESTATE
PROJECT NUMBER: Z2405
8325 E. JEFFERSON AVE
DETROIT, MI 48214
NIAL & MELVIE BERKERY

SHEET TITLE
EXISTING/DEMO SITE PLAN

1
A-3.0
3/32" = 1'-0"

EXISTING/DEMO SITE PLAN

3CSP

3/14/2025 1:36:40 PM

GENERAL SITE NOTES:

- THE DRAWINGS HEREIN ARE FOR INFORMATIONAL PURPOSES AND CONVEYANCE OF DESIGN INTENT. INFORMATION DEPICTED IS NOT INTENDED TO BE CONSTRUED AS LEGAL SURVEY OR ENGINEERED CIVIL. REFER TO SUBMITTALS BY PROFESSIONAL CONSULTANTS FOR WORK BEYOND THE SCOPE DEPICTED HEREIN.
- GENERAL CONTRACTOR TO VERIFY ALL EXISTING ELEVATIONS AND BUILDING CONDITIONS IN FIELD PRIOR TO START OF CONSTRUCTION. THE CONTRACTOR SHALL HAVE A REGISTERED LAND SURVEYOR TIE OUT AND RESET ANY PROPERTY CORNERS OR SECTION CORNERS PLANNED TO BE DISTURBED BY CONSTRUCTION OF THIS PROJECT, AND SHALL HAVE A REGISTERED LAND SURVEYOR RE-ESTABLISH ANY PROPERTY CORNERS OR SECTION CORNERS INADVERTENTLY DISTURBED DURING CONSTRUCTION OF THIS PROJECT.
 - ALL STREET, SANITARY SEWER, STORM SEWER AND WATERLINE CONSTRUCTION SHALL CONFORM TO THE LOCAL MUNICIPALITY STANDARDS AND SPECIFICATIONS CURRENT AT THE DATE OF EXECUTION OF THE CONSTRUCTION.
 - STREET PAVING SHALL NOT BEGIN UNTIL SUBGRADE COMPACTION TESTS ARE TAKEN AND THE CITY ENGINEER APPROVES THE RESULTS.
 - THE CONTRACTOR SHALL COMPLY WITH ALL REQUIREMENTS OF THE SOILS REPORT PREPARED FOR THIS PROJECT AND APPROVED BY THE MUNICIPALITY'S ENGINEER.
 - THE CONTRACTOR SHALL BE RESPONSIBLE FOR CONTACTING MISSDIG. CALL TWO BUSINESS DAYS PRIOR (NOT INCLUDING THE DAY OF THE CALL) TO DIGGING, GRADING OR EXCAVATING FOR THE MARKING OF UNDERGROUND MEMBER UTILITIES.
 - PRIOR TO COMMENCEMENT OF ANY CONSTRUCTION, THE CONTRACTOR SHALL PROVIDE THE ENGINEER 24 HOURS ADVANCED NOTICE.
 - TEMPORARY EROSION CONTROL MEASURES SHALL BE PROVIDED BY THE CONTRACTOR DURING CONSTRUCTION AS IDENTIFIED ON THE EROSION CONTROL PLAN. MAINTENANCE OF ONSITE DRAINAGE AND EROSION CONTROL FACILITIES DURING CONSTRUCTION SHALL BE THE RESPONSIBILITY OF THE CONTRACTOR.
 - PRIOR TO COMMENCEMENT OF ANY CONSTRUCTION, THE CONTRACTOR SHALL CONTACT ALL UTILITIES TO COORDINATE SERVICE AND SCHEDULES.
 - PRIOR TO COMMENCEMENT OF ANY CONSTRUCTION THAT WILL AFFECT TRAFFIC SIGNS OF ANY TYPE, THE CONTRACTOR SHALL CONTACT THE MUNICIPALITY.
 - THE CONTRACTOR SHALL BE RESPONSIBLE FOR ALL TRAFFIC CONTROL DURING CONSTRUCTION:
 - ALL SIGNS, STRIPING AND TRAFFIC CONTROL DEVICE SHALL CONFORM TO, AND PLACEMENT SHALL BE PERFORMED IN ACCORDANCE WITH, THE MANUAL OF UNIFORM TRAFFIC CONTROL DEVICES (MUTCD), LATEST EDITION AND MDOT OR COUNTY STANDARDS, LATEST EDITION.
 - THE CONTRACTOR SHALL BE RESPONSIBLE FOR MAINTENANCE AND CLEANING OF TRAFFIC CONTROL DEVICES.
 - THE CONTRACTOR SHALL MAINTAIN EXISTING PAVEMENT MARKINGS DURING CONSTRUCTION OPERATIONS, IN CONFORMANCE WITH CONSTRUCTION DOCUMENTS.
 - REMOVAL OF EXISTING PAVEMENT MARKINGS SHALL BE ACCOMPLISHED BY A METHOD THAT DOES NOT MATERIALLY DAMAGE THE SURFACE OR TEXTURE OF THE PAVEMENT OR EXISTING SURFACING. THE PAVEMENT MARKINGS SHALL BE REMOVED TO THE EXTENT THAT THEY ARE NOT VISIBLE UNDER DAY OR NIGHT CONDITIONS.
 - SCRAPE AND REPAINT ALL EXISTING PAINTED SITE FEATURES, INCLUDING, BUT NOT LIMITED TO CURBS, BOLLARDS, RAILINGS, & SITE LIGHTING BASES.
 - THE CONTRACTOR SHALL CONTACT THE LOCAL CONSTRUCTION INSPECTOR PRIOR TO ANY STREET CUT. THE EXISTING STREET CONDITION SHALL BE DOCUMENTED BY THE CONSTRUCTION INSPECTOR BEFORE ANY CUTS ARE MADE. ANY STREET PATCHING SHOWN ON THE DRAWINGS IS APPROXIMATE. ACTUAL LIMITS OF STREET PATCH SHALL BE DETERMINED BY THE CONSTRUCTION INSPECTOR. PATCHING SHALL BE DONE IN CONFORMANCE WITH MUNICIPAL DESIGN CRITERIA AND CONSTRUCTION SPECIFICATIONS. ALL LARGE PATCHES SHALL BE PAVED WITH AN ASPHALT LAY-DOWN MACHINE. IN STREETS WHERE MORE THAN ONE CUT IS MADE, AN OVERLAY OF THE ENTIRE STREET WIDTH, INCLUDING THE PATCHED AREA, MAY BE REQUIRED. IN ACCORDANCE WITH THE REFERENCED SPECIFICATIONS, THE ENGINEER SHALL MAKE THE DETERMINATION OF THE NEED FOR A COMPLETE OVERLAY. THE CONTRACTOR SHALL RESTORE ANY DISTURBED AREAS TO EQUAL OR BETTER CONDITION THAN EXISTED BEFORE CONSTRUCTION. DRAINAGE DITCHES OR WATERCOURSES THAT ARE DISTURBED BY CONSTRUCTION SHALL BE RESTORED TO THE GRADES AND CROSS-SECTIONS THAT EXISTED BEFORE CONSTRUCTION, UNLESS OTHERWISE SHOWN ON THE CONSTRUCTION DOCUMENTS.
 - THE CONTRACTOR SHALL CAREFULLY PRESERVE BENCHMARKS, PROPERTY CORNERS, REFERENCE POINTS, STAKES AND OTHER SURVEY REFERENCE MONUMENTS OR MARKERS. IN CASE OF WILLFUL OR CARELESS DESTRUCTION, THE CONTRACTOR SHALL BE RESPONSIBLE FOR RESTORATIONS. RESETTling OF MARKERS SHALL BE PERFORMED UNDER THE DIRECTION OF A LICENSED PROFESSIONAL LAND SURVEYOR.
 - THE CONTRACTOR SHALL IMMEDIATELY REMOVE ANY CONSTRUCTION DEBRIS AND MUD TRACKED ONTO EXISTING ROADWAYS. THE CONTRACTOR SHALL REPAIR ANY EXCAVATION OR PAVEMENT FAILURES CAUSED BY THE CONSTRUCTION.
 - ALL DAMAGED EXISTING CURB, GUTTER, AND SIDEWALK SHALL BE REPAIRED PRIOR TO ACCEPTANCE OF COMPLETED IMPROVEMENTS.
 - THE TYPE, SIZE, LOCATION AND NUMBER OF ALL KNOWN UNDERGROUND UTILITIES ARE APPROXIMATE WHEN SHOWN ON THESE CONSTRUCTION DRAWINGS. IT SHALL BE THE RESPONSIBILITY OF THE CONTRACTOR TO VERIFY THE EXISTENCE AND LOCATION OF ALL UNDERGROUND UTILITIES ALONG THE ROUTE OF THE WORK PRIOR TO COMMENCING ANY NEW CONSTRUCTION. THE CONTRACTOR SHALL BE RESPONSIBLE OF ANY UNKNOWN UNDERGROUND UTILITIES.
 - THE CONTRACTOR SHALL NOTIFY THE PUBLIC WORKS DEPARTMENT AT LEAST 48 HOURS PRIOR TO INSTALLING A NEW SEWER, WATER SERVICE OR ABANDONING AN EXISTING WATER SERVICE.
 - THE CONTRACTOR SHALL BE RESPONSIBLE FOR OBTAINING THE SERVICES OF A QUALIFIED TESTING LABORATORY TO PERFORM ALL COMPACTION TESTING, ASPHALT TESTING, CONCRETE TESTING AND ANY OTHER TESTING AS MAY BE REQUIRED TO COMPLETE THE WORK. QUALITY CONTROL TEST RESULTS MUST BE SUBMITTED FOR ALL PHASES OF THIS PROJECT PER THE MUNICIPALITY'S REQUIREMENTS.
 - THE CONTRACTOR SHALL MAINTAIN ONE (1) SET OF "REDLINED" PRINTS OF THE CONSTRUCTION PLANS. THE "REDLINED" PRINTS SHALL BE KEPT CURRENT TO ACCURATELY REPRESENT THE DIMENSIONS AND LOCATIONS OF ALL WORK PERFORMED BY THE CONTRACTOR. PRIOR TO FINAL PAYMENT, THE CONTRACTOR MUST PRESENT THE "REDLINED" PRINTS TO THE OWNER'S ENGINEER FOR PREPARATION OF A SET OF REPRODUCIBLE "RECORD DRAWINGS" WHICH SHALL BE SUBMITTED TO THE MUNICIPAL ENGINEER WITHIN 30 DAYS OF CONSTRUCTION ACCEPTANCE.
 - THE OWNER/DEVELOPER SHALL BE RESPONSIBLE FOR PROVIDING ALL REQUIRED LOT STAKING AND CONSTRUCTION STAKING. THE CONTRACTOR SHALL COORDINATE THROUGH THE OWNER'S DESIGNATED REPRESENTATIVE TO ASSURE THAT THE SURVEYOR IS GIVEN ADEQUATE NOTICE AND INSTRUCTION IN ORDER TO COMPLETE THE SURVEY REQUIREMENTS FOR THE WORK PHASES OF THIS PROJECT. THE CONTRACTOR SHALL BE RESPONSIBLE FOR THE COST OF RE-SURVEYING REQUIRED DUE TO THE CONTRACTOR'S, OR SUBCONTRACTOR'S, ACTIVITIES. THE CONTRACTOR SHALL BE RESPONSIBLE FOR THE COSTS ASSOCIATED WITH RESCHEDULING THE SURVEYOR TO ACCOMMODATE THE CONTRACTOR'S REQUESTS FOR UNSCHEDULED STAKING.
 - THE CONTRACTOR SHALL PROVIDE AND IMPLEMENT A "TRAFFIC CONTROL PLAN" RELATED TO ALL CONSTRUCTION ACTIVITIES FOR THIS PROJECT. THE CONTRACTOR SHALL PERFORM ALL WORK ACCORDING TO ALL LOCAL, COUNTY, STATE AND FEDERAL SAFETY AND HEALTH REGULATIONS. IN PARTICULAR, THE TRENCHING AND OPEN EXCAVATION OPERATIONS SHALL COMPLY WITH ALL CURRENT O.S.H.A. REGULATORY REQUIREMENTS. ALL CONSTRUCTION ACTIVITIES MUST COMPLY WITH LOCAL AND STATE PERMITTING PROCESSES FOR "STORMWATER DISCHARGES ASSOCIATED WITH CONSTRUCTION ACTIVITY."
 - WHEN DISCHARGING GROUNDWATER, ALL DEWATERING METHODS SHALL BE IN CONFORMANCE WITH ALL LAWS AND REGULATIONS OF THE STATE. THE CONTRACTOR SHALL TAKE ALL NECESSARY AND PROPER PRECAUTIONS TO PROTECT ADJACENT PROPERTIES FROM ANY AND ALL DAMAGE THAT MAY OCCUR FROM STORMWATER RUNOFF AND OR DEBRIS RESULTING FROM ANY AND ALL WORK.
 - THE ENGINEER WHO HAS PREPARED CIVIL PLANS, BY EXECUTION AND/OR SEAL HEREON, DOES HEREBY AFFIRM RESPONSIBILITY FOR ANY ERRORS AND OMISSIONS CONTAINED IN THESE PLANS, AND APPROVAL OF THESE PLANS SHALL NOT RELIEVE THE ENGINEER WHO HAS PREPARED THESE PLANS OF ANY SUCH RESPONSIBILITY.
 - ALL PARKING LOT IMPROVEMENTS SHALL MEET THE REQUIREMENTS OF THE ADA ACT AND PROVIDE FOR PARKING, SIGNAGE AND ACCESS. IT IS THE CONTRACTOR AND OWNER'S RESPONSIBILITY TO PROVIDE. PROVIDE DETECTABLE WARNING AT TRANSITION FROM SIDEWALK TO DRIVE AISLE. ACCESSIBLE PARKING SPACES AND ACCESS AISLES SHALL HAVE A SURFACE SLOPE NOT TO EXCEED 2% IN ALL DIRECTIONS. CROSS SLOPE ALONG ENTIRE LENGTH OF ACCESSIBLE ROUTE NOT TO EXCEED 2%.
 - REFER TO ELECTRICAL DRAWINGS FOR SITE RELATED ELECTRICAL SCOPE.

LIGHTING FIXTURE SCHEDULE

Type Mark	Count	Description	Comments
A	114	RECESSED DOWNLIGHT	
B	20	SCONCE	
C	3	EXTERIOR POST LIGHT FIXTURE	
D	12	BATHROOM EXHAUST FAN	
E	11	UTILITARIAN FLUSH MOUNT FIXTURE	
F	5	EXTERIOR GROUND UP-LIGHT WALL WASH	
G	2	REAR EXTERIOR GOOSE NECK	
H	4	REAR EXTERIOR SCONCE	


Grand total 171



3D BIRDSEYE


NOTE:

- ARCHITECTURAL SITE PLAN FOR REFERENCE ONLY.
- REFER TO SITE PLAN BY CIVIL ENGINEER FOR ALL CIVIL ENGINEERING INFORMATION.
- ALL INFO PROVIDED BY OWNER AND PUBLICLY PROVIDED INFO.
- ALL LANDSCAPE SELECTIONS BY OWNER/CONTRACTOR.

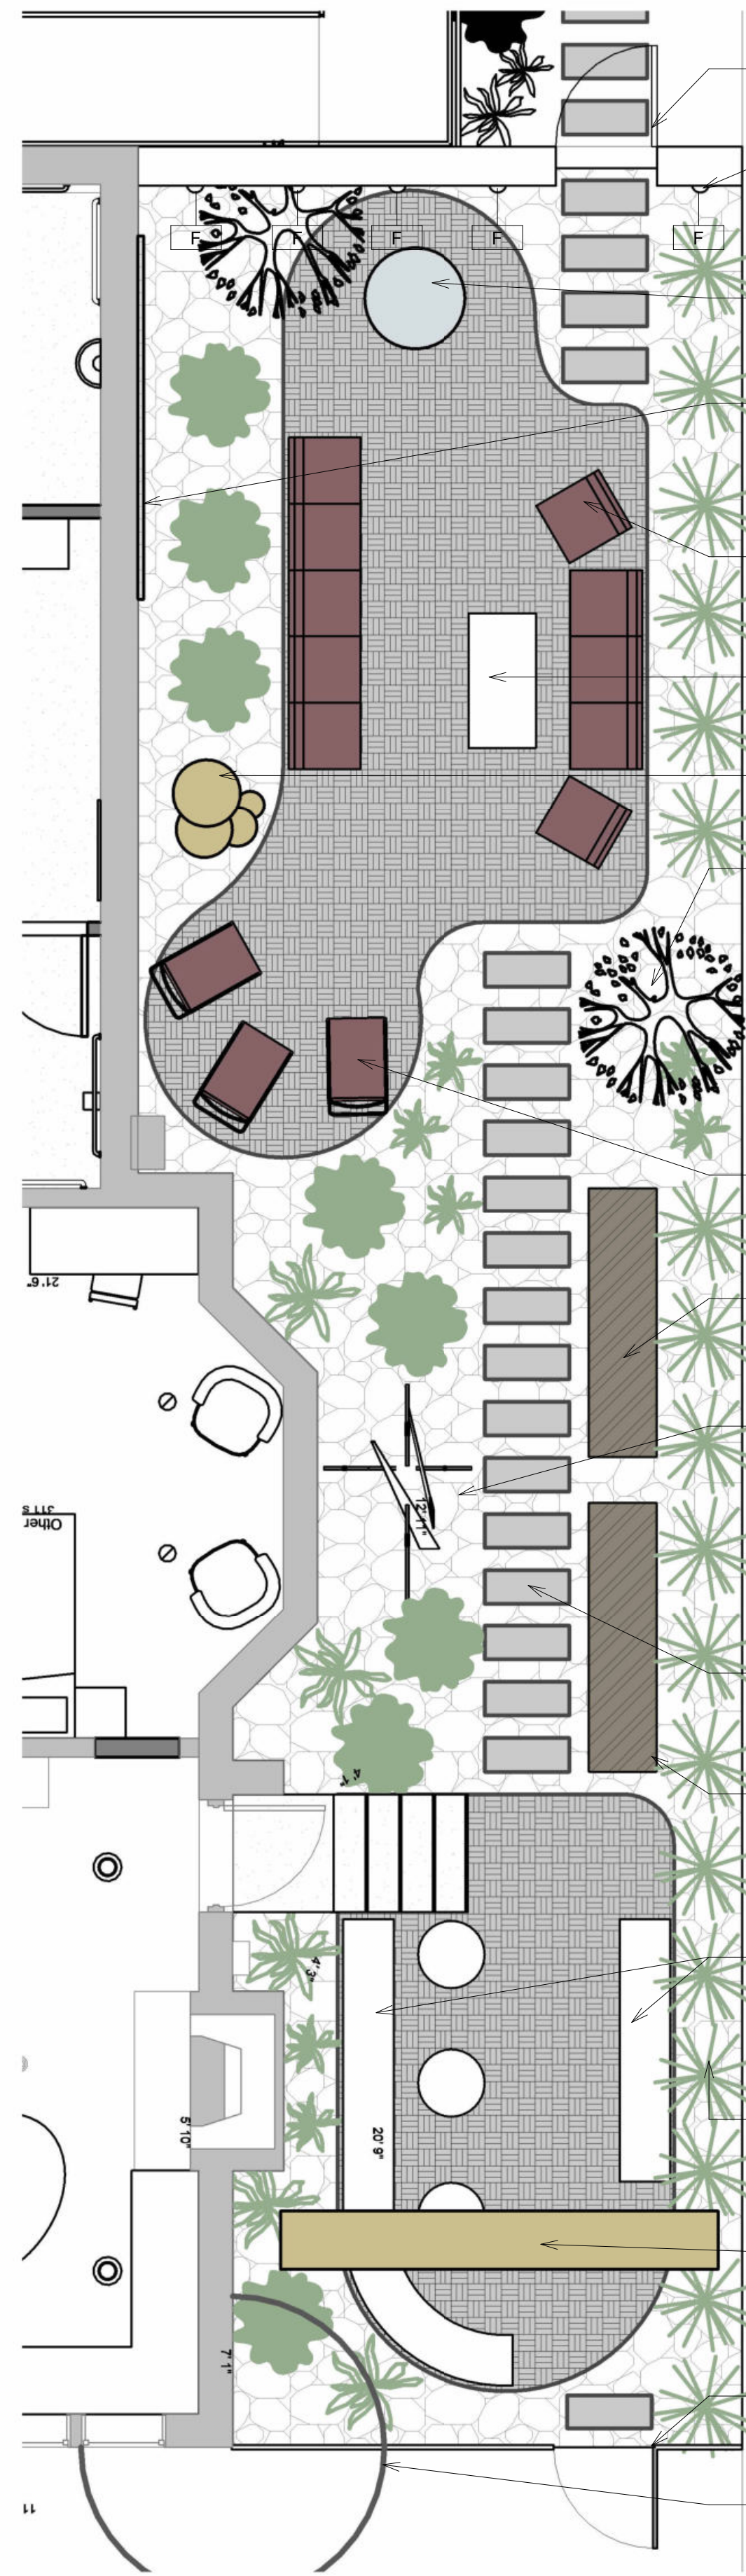

SITE PLAN - ENLARGED PLAN - PROPOSED ZEN GARDEN

1/4" = 1'-0"

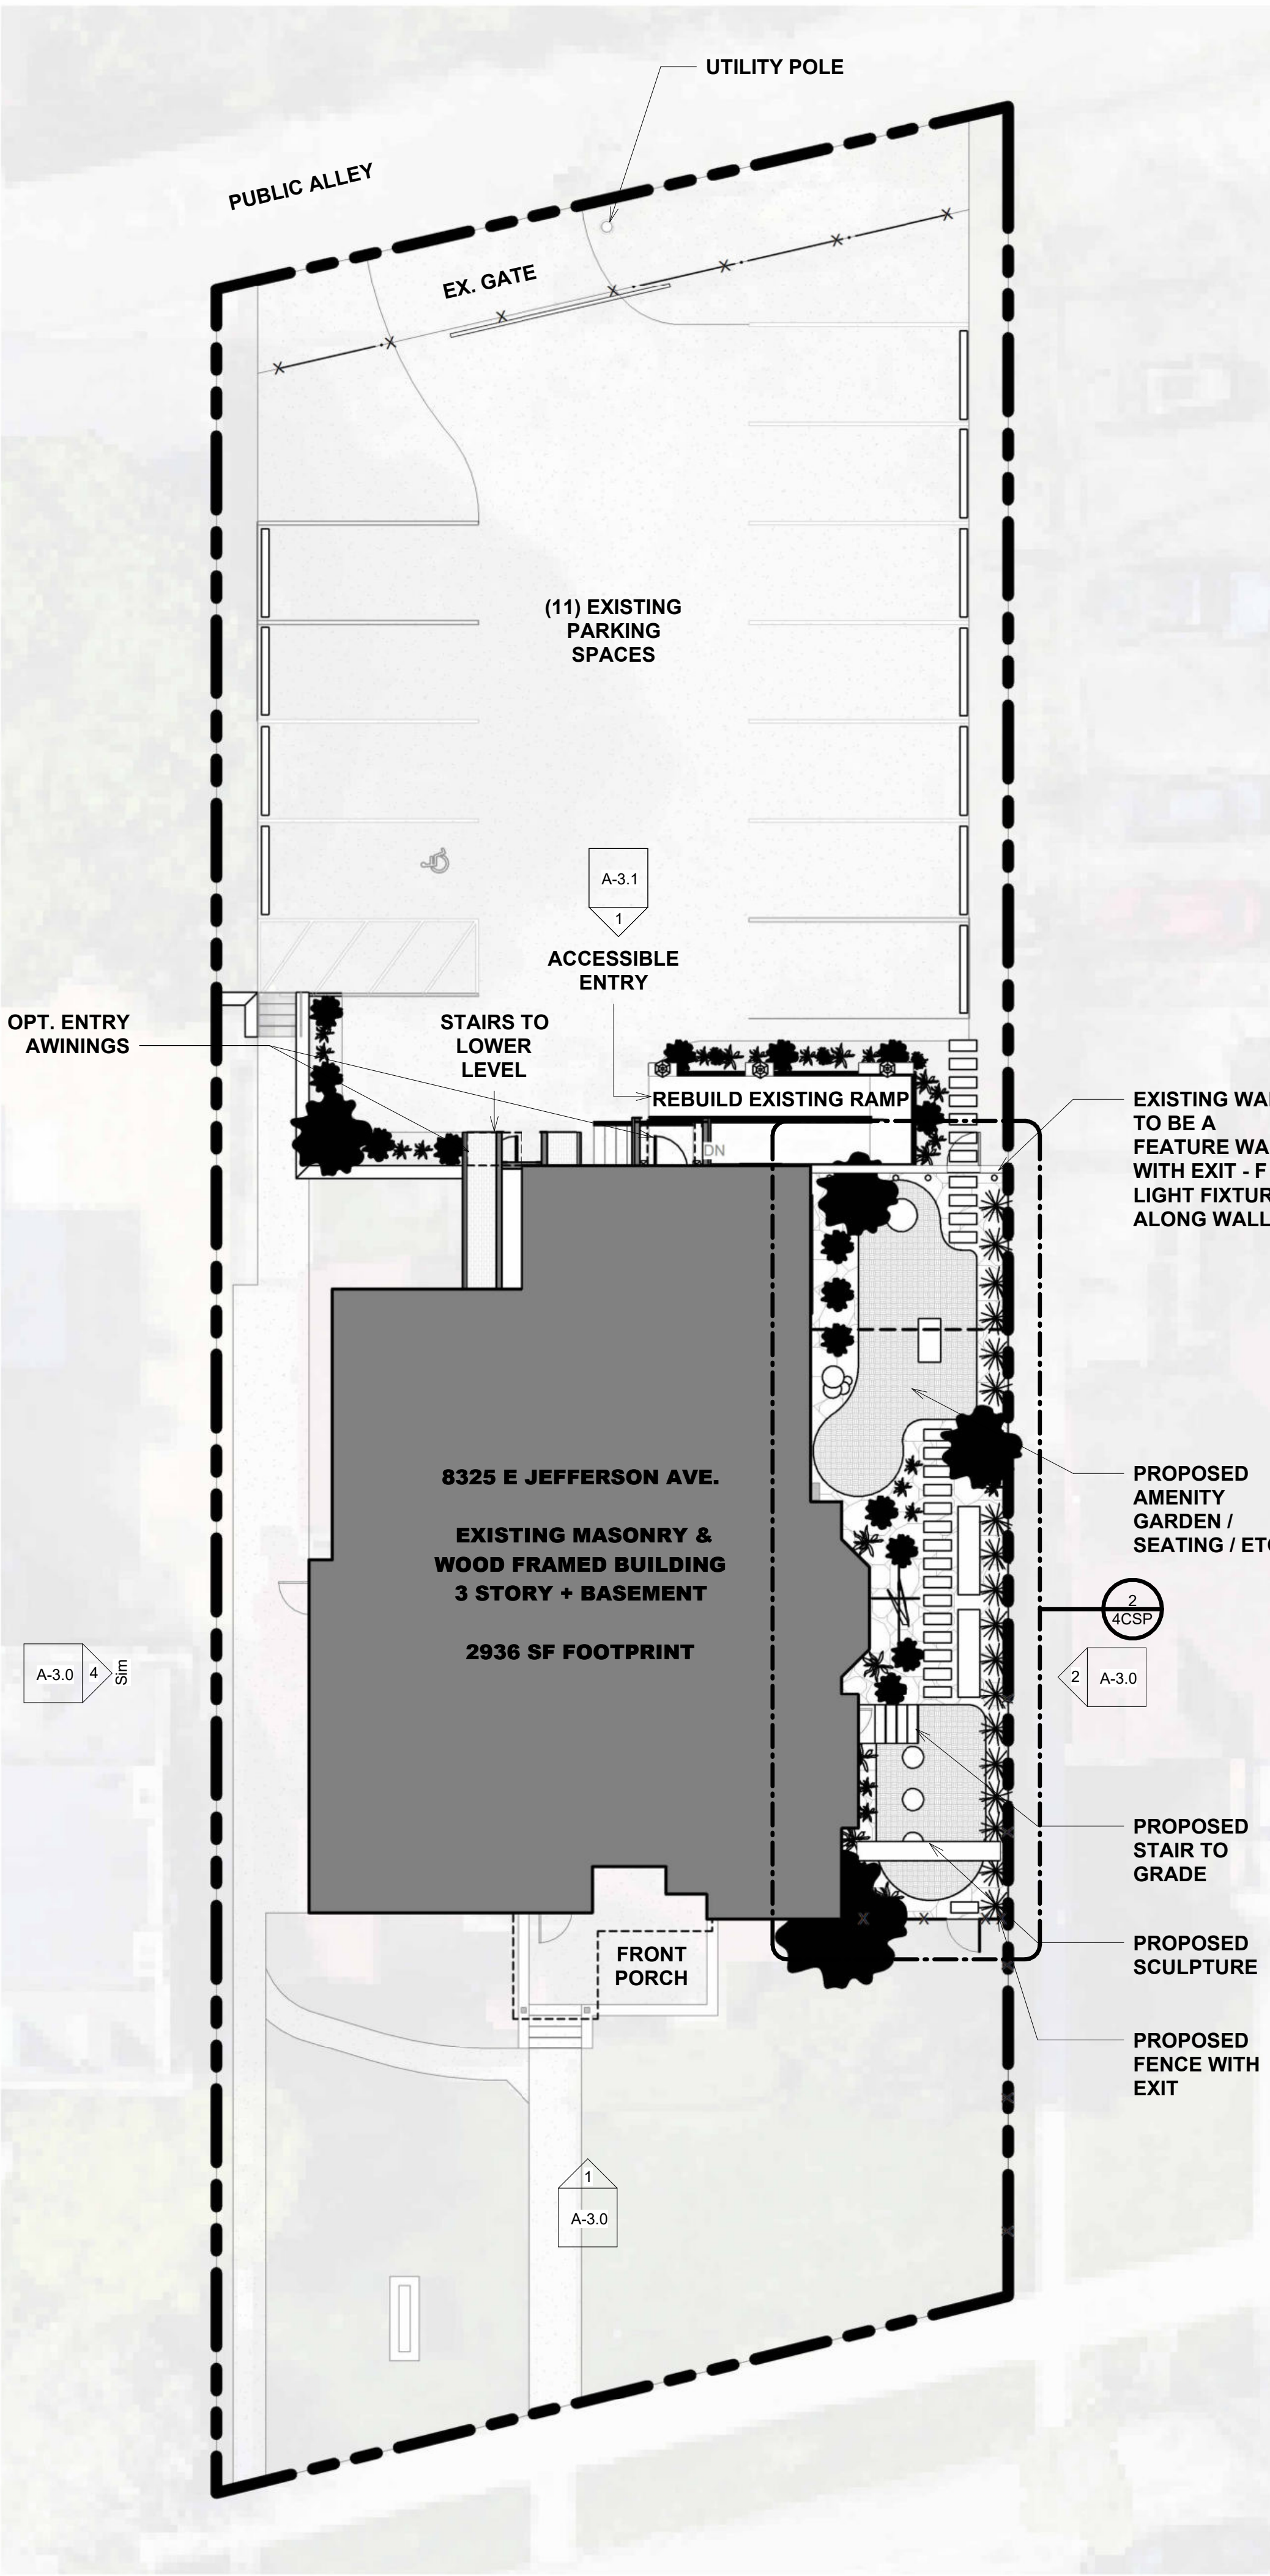

PROPOSED SITE PLAN

3/32" = 1'-0"

Unauthorized use of this drawing set without written permission from VIRTUOSO DESIGN + BUILD and infuz Ltd is in violation of U.S. COPYRIGHT LAWS and will be subject to civil damages and prosecution.

Revision Schedule

#	Description	Date
1	Commercial Set	03/13/2025

SEAL

NOT FOR CONSTRUCTION

03/13/2025

BERKERY ESTATE

PROJECT NUMBER: ZK005
8325 E. JEFFERSON AVE
DETROIT, MI 48214


NIAL & MELVIE BERKERY

SHEET TITLE

ARCHITECTURAL SITE PLAN


SHEET NUMBER

4CSP

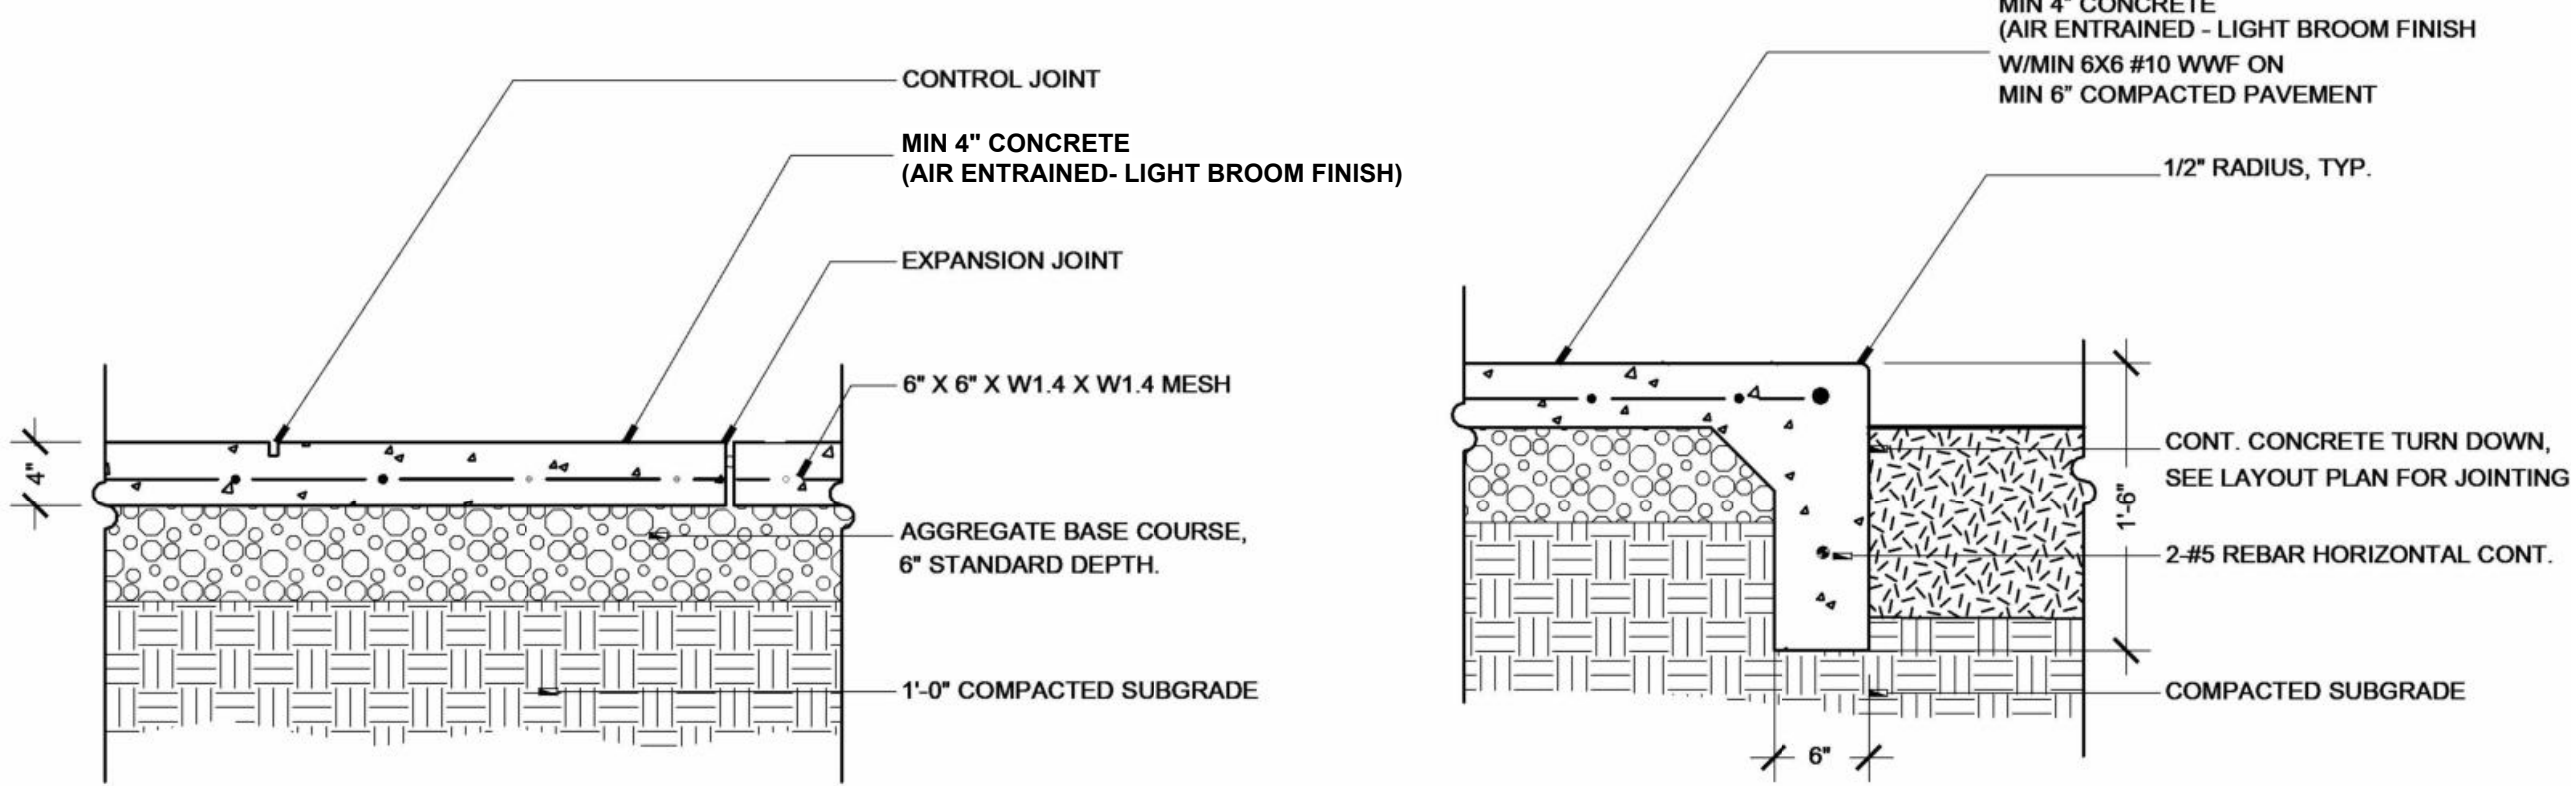


1 CONCRETE PAVING

1" = 1'-0"

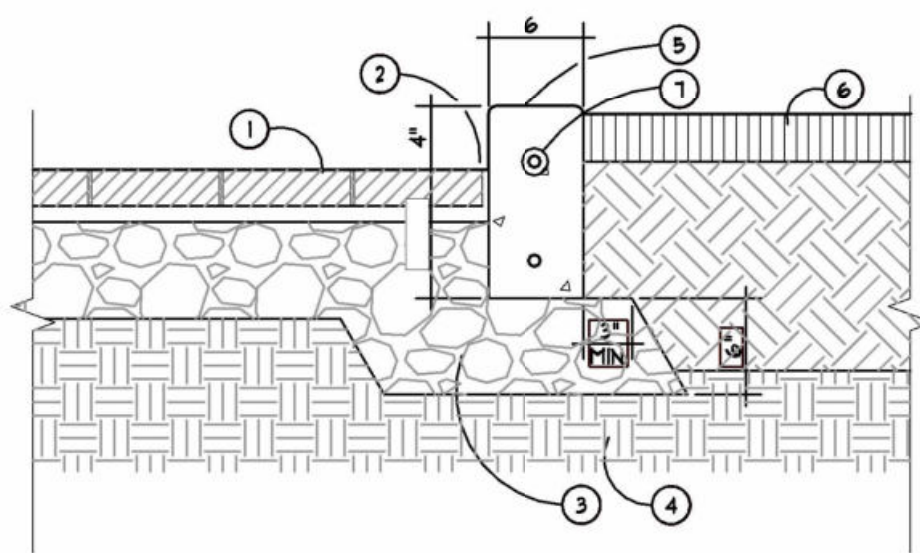


9 TYPICAL CONCRETE STRAIGHT CURB

1" = 1'-0"

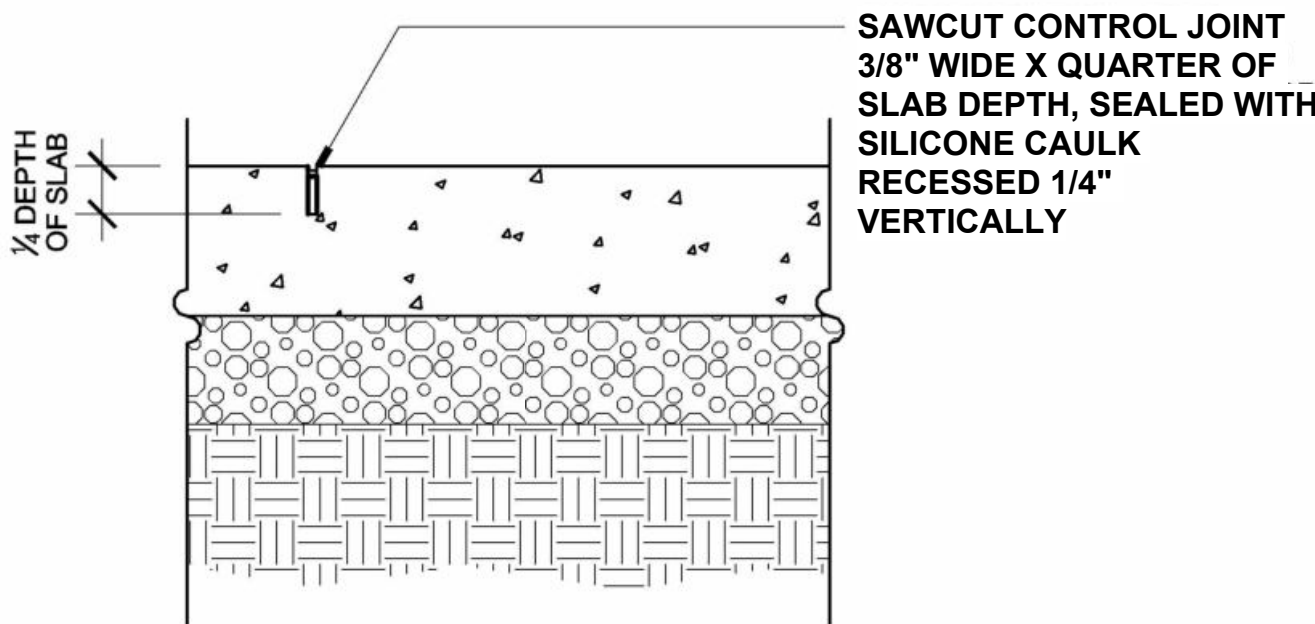


3 CONTROL JOINT

1 1/2" = 1'-0"

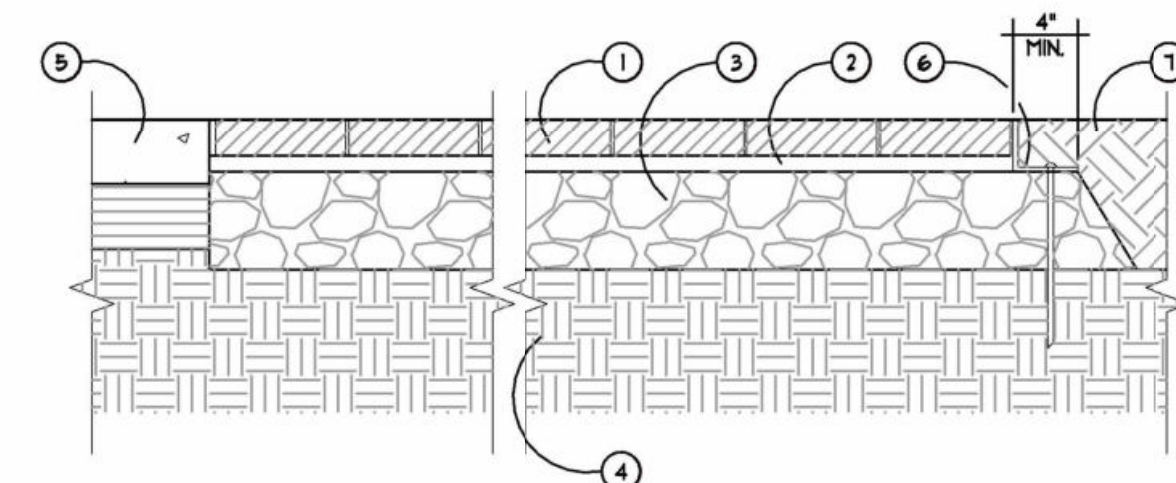

8 PAVERS ON AGGREGATE

1" = 1'-0"

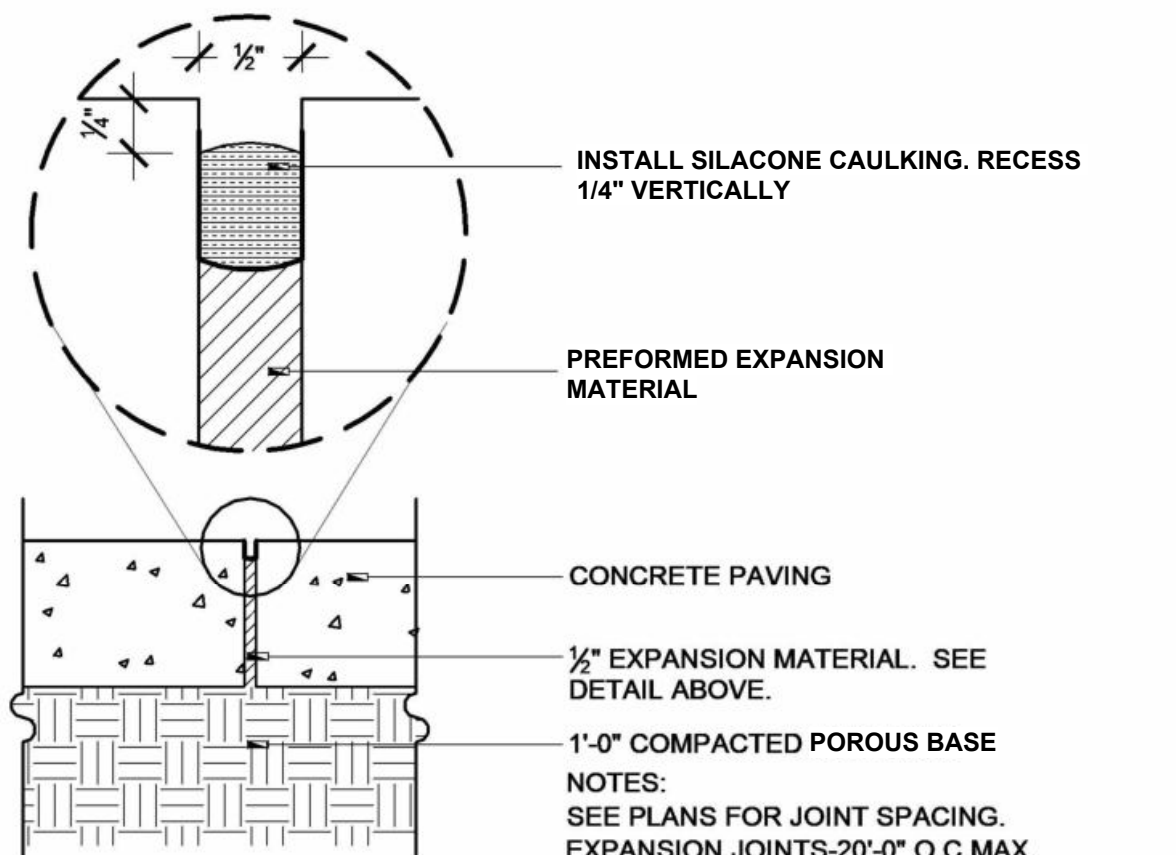

4 EXPANSION JOINT

1 1/2" = 1'-0"


- 1 TYPICAL PAVERS ON AGGREGATE BASE - REFER TO DETAIL
- 2 1" MIN. SAND JOINT ADJACENT TO CURB
- 3 6" DEPTH 21AA AGGREGATE BASE COMPACTED TO 95% MODIFIED PROCTOR
- 4 EXISTING SUBGRADE, COMPACT TOP 12" (MIN) TO 95% MODIFIED PROCTOR, TYP.
- 5 COLORED CONCRETE STRAIGHT CURB WITH SMOOTH TROUPEL FINISH SIZED AS SHOWN, 1" EASED FRONT AND BACK EDGE, 1/2" VERT. AND HORIZ. EXPANSION JOINT BETWEEN POLES (MAX 10' O.C.) WHERE APPLICABLE. SEALANT COLOR TO MATCH COLORED CONCRETE - REFER TO SPECS
- 6 LANDSCAPE AREA - REFER TO LANDSCAPE PLANS
- 7 (1) NO. 4 BAR CONTINUOUS AS SHOWN, LAP SPICE AS REQUIRED, 3" MIN. COVERAGE ON TOP BAR, 2" MIN. COVERAGE ON BOTTOM BAR, TYP.

5 GRAVEL PAVING

1" = 1'-0"

- 1 CLAY BRICK PAVERS WITH TYPICAL SAND JOINTS - REFER TO SPECIFICATIONS FOR TYPE AND PLANS FOR PATTERN
- 2 1" MIN. SAND LEVELING BED, SCREED LEVEL, TYP.
- 3 6" DEPTH 21AA AGGREGATE BASE COMPACTED TO 95% MODIFIED PROCTOR
- 4 EXISTING SUBGRADE, COMPACT TOP 12" (MIN) TO 95% MODIFIED PROCTOR, TYP. OR ENGINEERED FILL COMPACTED AND INSTALLED PER GEOTECH DOCUMENTS
- 5 ADJACENT CONCRETE PAVEMENT - REFER TO TYPICAL CONCRETE PAVEMENT DETAIL
- 6 PAVEMENT RESTRAINT WITH 10" GALVANIZED SPIKE - REFER TO SPECS
- 7 ADJACENT PLANTED AREA


- NOTES:
1. PROVIDE 3/8" SAND JOINT BETWEEN PAVERS AND CONCRETE PAVEMENT, CURBS, BUILDINGS, OR WALLS.

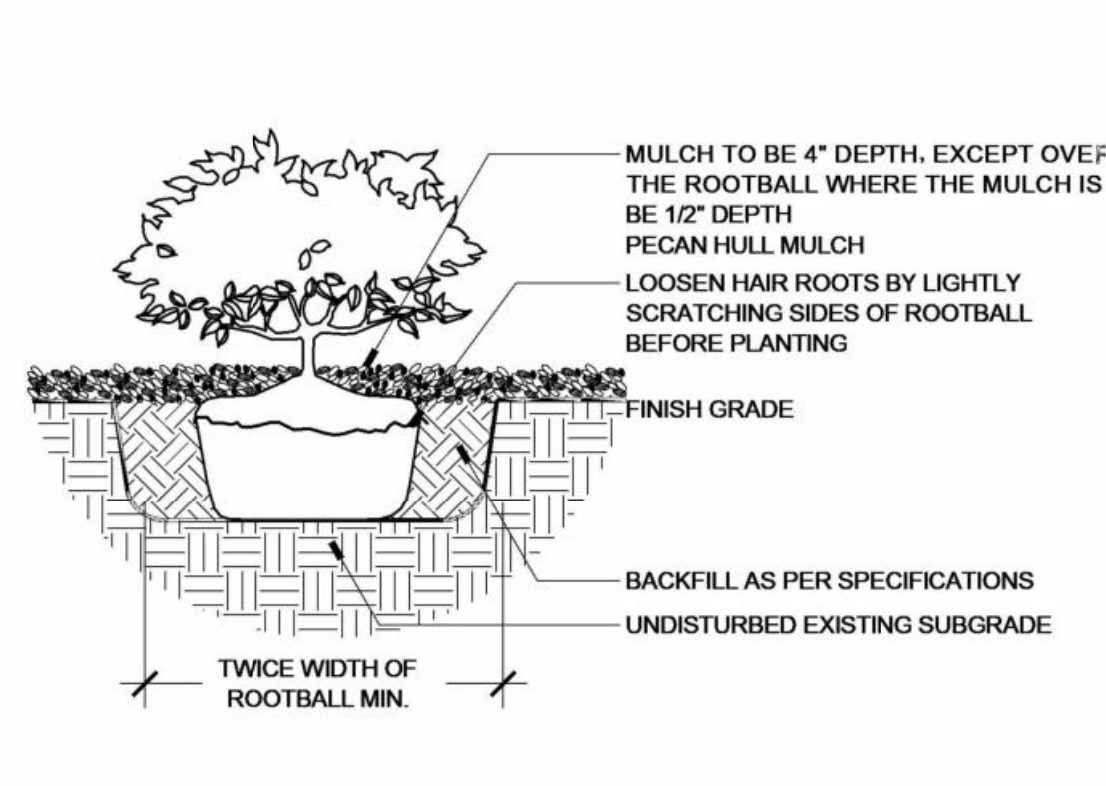

5 SHRUB PLANTING

SCALE: 1/2" = 1'-0"

SECTION

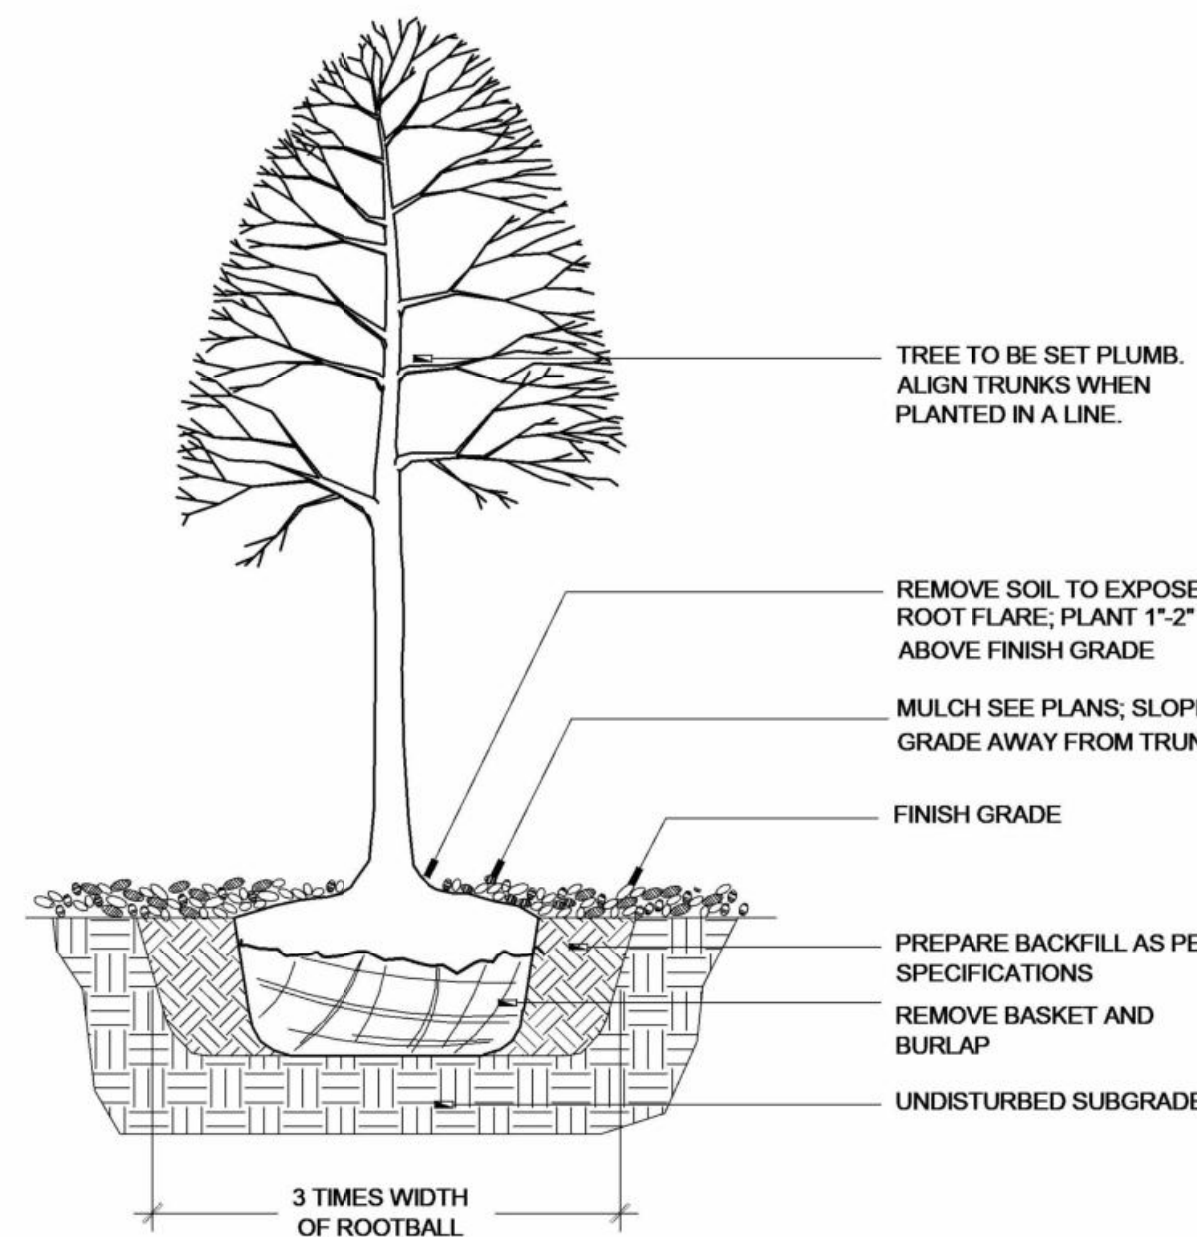


8 TREE PLANTING

SCALE: 1/2" = 1'-0"

SECTION

- SOIL PREPARATION
1. Soil preparation of a landscape design is a critical factor in creating a healthy and long-lasting landscape. Remove existing topsoil and stockpile on site. Topsoil to be incorporated back into the soil at a later date. Contractor to conduct a soil evaluation to determine the soil's composition, compaction rate, nutrient qualities, organic content, PH levels, and water holding capabilities. The ideal particle soil mix is approximately 45% sand, 40% silt, 10% clay and 5% organic material with a PH level near seven.
 2. Prior to the installation of the landscape and irrigation system, contractor to prepare soil to ensure a proper environment for plant root development.
 3. Contractor to de-compact soils in planting areas by roto-tilling, diskling or ripping to a depth of 6" - 8" from the soil.
 4. When performing soil de-compaction, multiple passes across the area will be required and, when possible, should be at varying angles to ensure adequate coverage. When using disc or ripping equipment, it is required that the final passes over the area be made with a roto-tiller to break up any large clumps to make final grading easier.
 5. After initial soil de-compaction procedures are performed, soil amendments should be added. The addition of soil amendments is determined from soil tests conducted prior to work commencing. Soil amendment may include inorganic material such as sand, silt or clay, which help improve soil texture. Organic material such as compost, manure, and peat moss may also be used and help improve soil structure. Other amendments such as fertilizer improve nutrient content and sulfur adjusts the soil PH level. Sulfur shall be incorporated at the rate of one pound of sulfur per 100 square feet.
 6. All amendments should be mixed thoroughly with existing soil and an additional soil test will be taken to ensure proper soil conditions prior to planting.
 7. During the remainder of the landscape installation, various areas of the site may be re-compacted the soil. Prior to the installation of plant material in these areas, the compaction shall be reduced to 80% or less using previously described methods.


- TREE PRESERVATION PLANTING NOTES
1. All trees to be preserved as indicated on the Landscape Demolition Plan shall be protected by 6" main link fence. The fence shall be located at a 5 ft. radius from the edge of the trunk. The fence shall be firmly anchored into the ground and shall remain upright and intact until all construction activity is complete. Construction activities or storage shall not occur within these protected areas. The Contractor shall stake the protective fencing location. The location of the protective fencing shall be approved onsite by the Landscape Architect prior to the start of any site work.
 2. When excavation near a tree to be protected must be carried out, damage can be limited by root pruning. Root pruning shall be completed before grading is started and shall occur beneath the protective fencing as shown on the plan.
 3. Root pruning shall be performed, when required, with a trencher such as a telephone cable puller or a "Ditch Witch" prior to adjacent excavation. The trenching shall be to a minimum depth of 24" or the depth of excavation. The contractor shall stake the limit of root pruning as per the plan. Limits of trenching shall be approved by the Landscape Architect prior to any trenching in the field. Do not trench for irrigation or electrical within drip lines of existing trees. Coordinate all trenching required for utility work with the landscape plans.
 4. The best method to avoid soil compaction is to KEEP OFF. This includes restricting all traffic both vehicular and pedestrian from crossing over the root zones, and restricting even temporary material storage under trees.

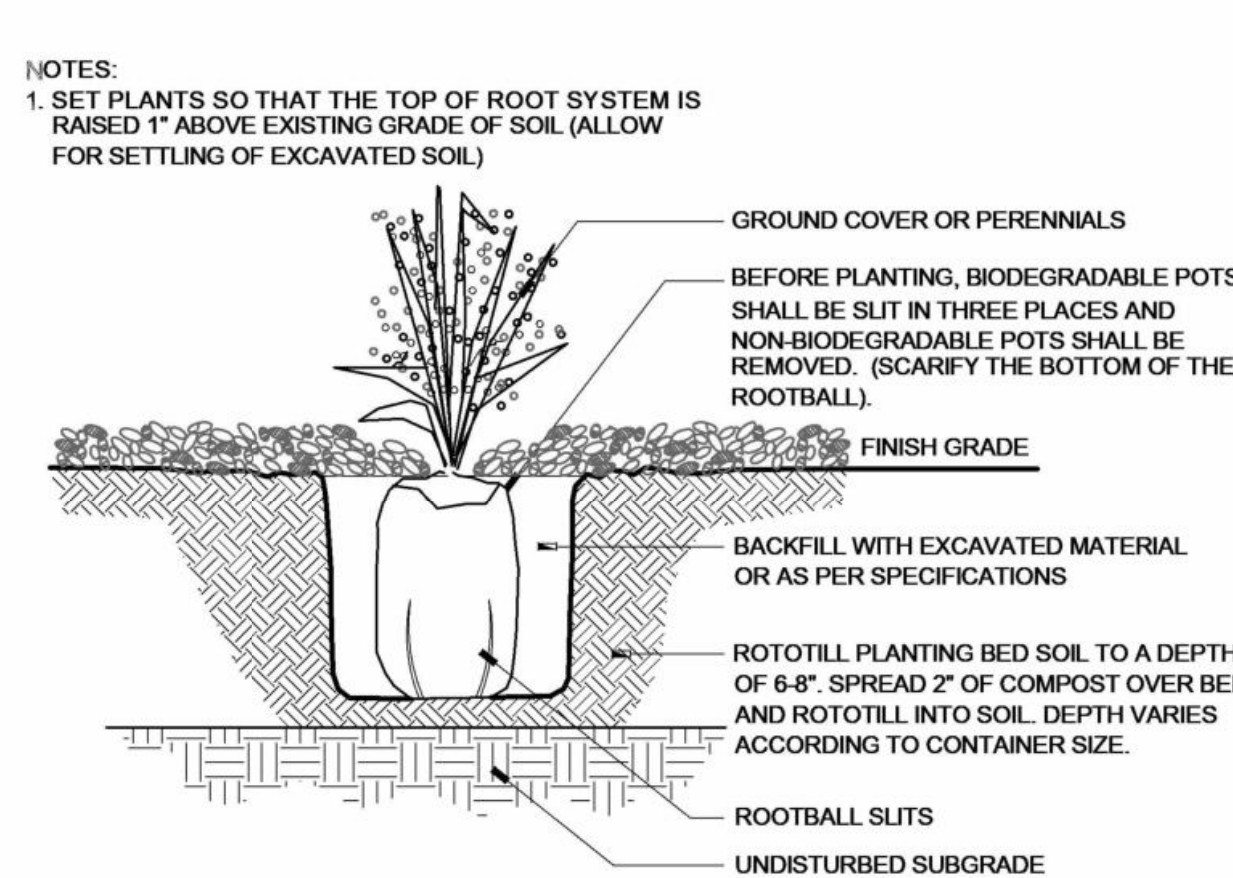

6 PERENNIAL PLANTING

SCALE: 1/2" = 1'-0"

SECTION

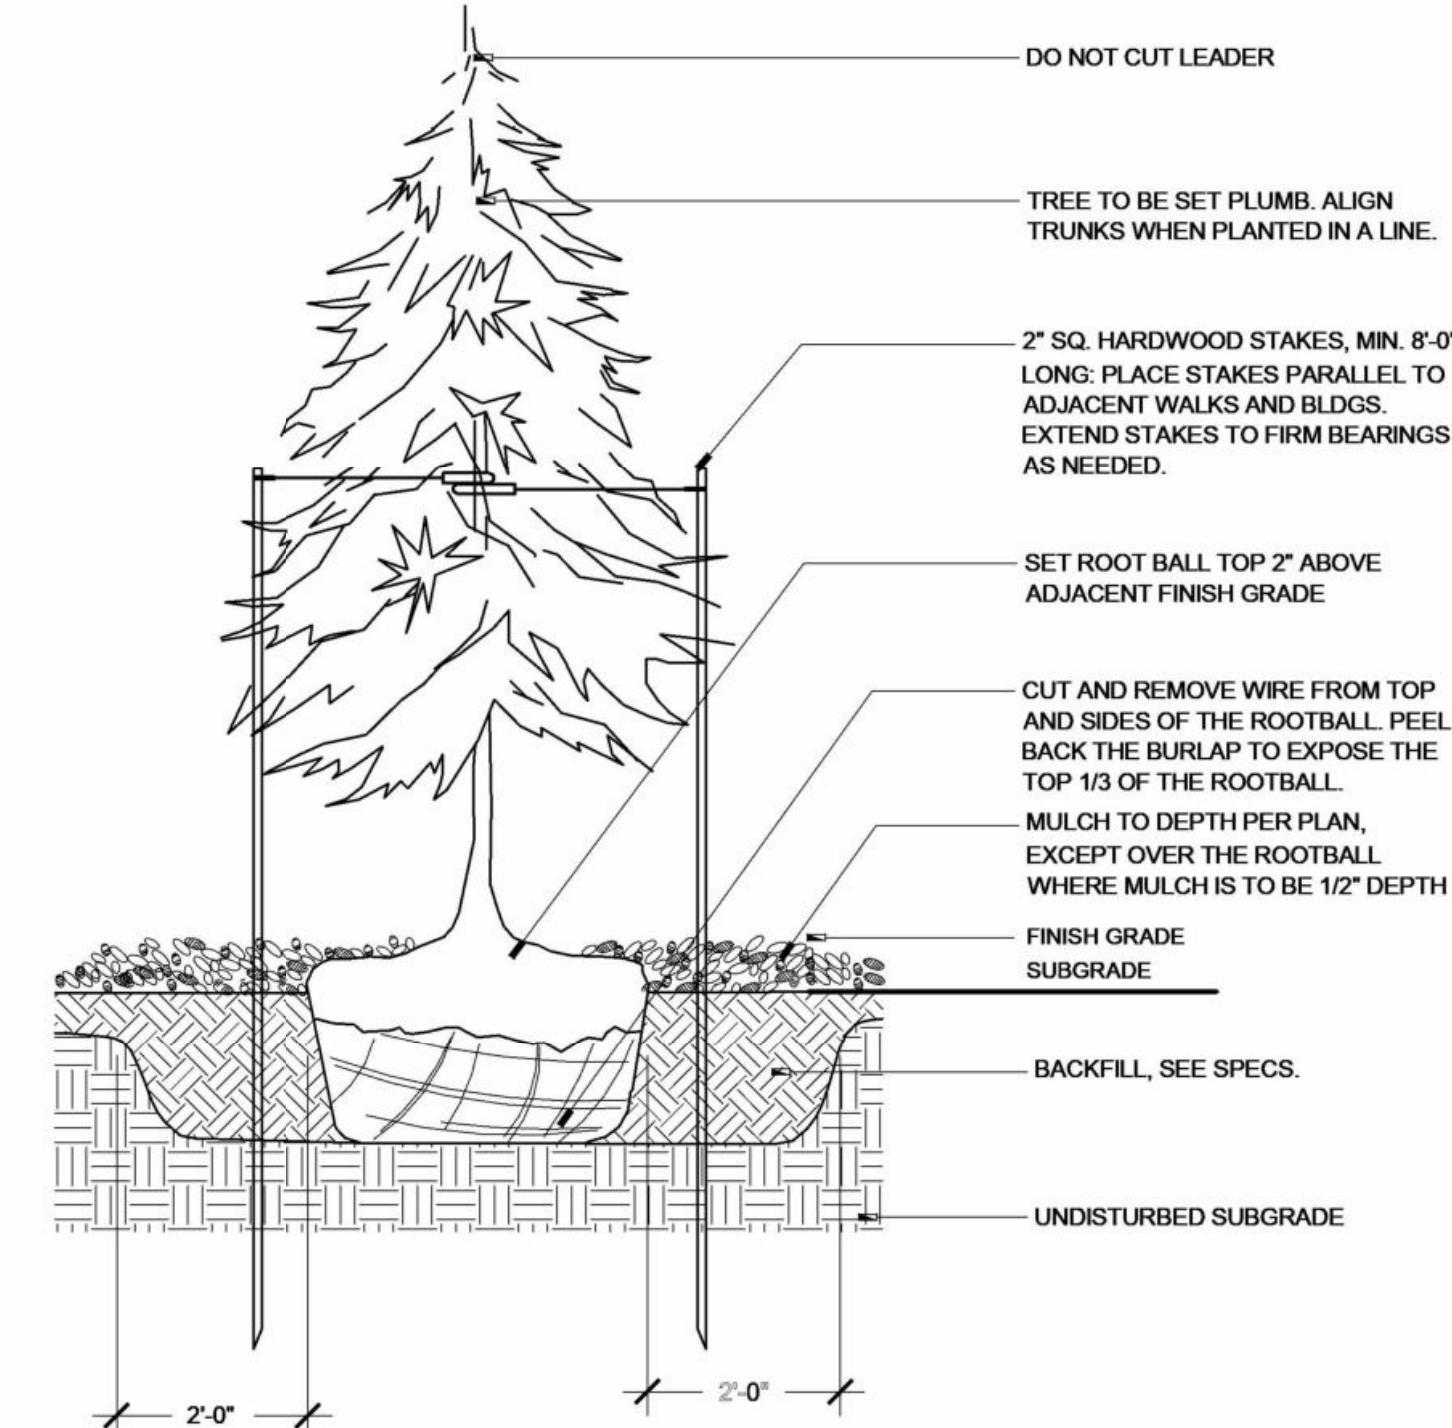

9 EVERGREEN TREE PLANTING

SCALE: 1/2" = 1'-0"

SECTION

LANDSCAPE PLANTING NOTES

1. Refer to Civil Engineer's utility and grading and drainage plans for utility location and drainage information.
2. Refer to Civil Engineer's grading plans for grading information. If actual site conditions vary from what is shown on the plans or if there are discrepancies between the plans, contact the Landscape Architect for direction as to how to proceed.
3. Verify locations of pertinent site improvements installed under other sections. If any part of this plan cannot be followed due to site conditions, contact Landscape Architect for instructions prior to commencing work.
4. Exact locations of plant materials to be approved by the Landscape Architect in the field prior to installation. Landscape Architect reserves the right to adjust plants to exact location in field.
5. Verify plant counts and square footages: Quantities are provided as Owner information only. If quantities on plant list differ from graphic indications, then graphics shall prevail.
6. Contact the local underground utility services for utility location and identification.
7. Perform excavation in the vicinity of underground utilities with care and if necessary, by hand. The Contractor bears full responsibility for this work and disruption or damage to utilities shall be repaired immediately at no expense to the Owner.
8. Trees shall bear same relation to finished grade as it bore to existing.
9. Trees to be planted a minimum of 4 feet from face of building, or pavement, except as approved by Landscape Architect.
10. Provide matching forms and sizes for plant materials within each species and size designated on the drawings.
11. Prune newly planted trees only as directed by Landscape Architect.
12. Align and equally space in all directions trees and shrubs so designated per these notes and drawings.
13. Finish grades of planter areas shall be 2 inches below adjacent paving or top of wall unless otherwise noted.
14. Provide specified edging as divider between planting beds.
15. Remove entire wire cage from rootball.
16. Cut and remove burlap from top 1/3 of ball.
17. Landscape Architect to review plant materials at source or by photographs prior to digging or shipping of plant materials.

PLANTING BED NOTES

1. Provide ground cover (Periwinkle-Vinca Minor and/or Pachysandra) at all planting bed areas.
2. Contractor to provide sufficient planting material & spacing for continuous ground coverage within 4 years of planting.
3. Provide brown or black mulch annually till ground cover matures.

IRRIGATION NOTES

1. See general conditions notes.
2. Locations of irrigation lines, valves, heads, and all other related irrigation appurtenances shown on these drawings are diagrammatic only. The exact location of the above need to be approved by the Landscape Architect.
3. Refer to Irrigation Plans and Specifications for additional requirements.

Revision Schedule		
#	Description	Date
1	Commercial Set	03/13/2025

NOT FOR CONSTRUCTION

REGULATORY REQUIREMENTS:

- PREPARATION:

- A. AS PART OF THE PROJECT SCOPE, THE CONTRACTOR SHALL PREPARE ALL DRAWINGS, DOCUMENTS, AND APPLICATIONS AND SHALL OBTAIN ALL GOVERNMENT APPROVALS AND PERMITS REQUIRED FOR DEMOLITION ACTIVITIES.
- B. CONDUCT DEMOLITION OPERATIONS AND REMOVE MATERIALS TO ENSURE MINIMUM INTERFERENCE WITH ROADS, STREETS, WALKS, AND OTHER ADJACENT OCCUPIED AND UTILIZED FACILITIES.
- C. DO NOT CLOSE OR OBSTRUCT STREETS, WALKS, OR OTHER ADJACENT OCCUPIED OR UTILIZED FACILITIES WITHOUT PERMISSION FROM AUTHORITIES HAVING JURISDICTION. PROVIDE ALTERNATE ROUTES AROUND CLOSED OR OBSTRUCTED TRAFFICWAYS IF REQUIRED BY GOVERNING REGULATIONS.
- D. CONDUCT DEMOLITION OPERATIONS TO PREVENT INJURY TO PEOPLE AND DAMAGE TO ADJACENT BUILDINGS AND FACILITIES TO REMAIN. ENSURE SAFE PASSAGE OF PEOPLE AROUND DEMOLITION AREA.
- E. PROVIDE TEMPORARY PROTECTION, SUCH AS WALKS, FENCES, RAILINGS, CANOPIES, AND COVERED PASSAGEWAYS, WHERE REQUIRED BY AUTHORITIES HAVING JURISDICTION.
- F. MAINTAIN TEMPORARY PROTECTION TO PEOPLE AT EXTERIOR AREAS OF THE EXISTING BUILDING WHERE DECORATIVE MEDALLION REMOVAL WORK IS BEING DONE.
- G. PROTECT EXISTING SITE IMPROVEMENTS, APPURTENANCES, AND LANDSCAPING THAT ARE DESIGNATED TO REMAIN IN PLACE.
- H. PROVIDE AND MAINTAIN INTERIOR AND EXTERIOR SHORING, BRACING, OR STRUCTURAL SUPPORT TO PRESERVE STABILITY AND PREVENT MOVEMENT, SETTLEMENT, OR COLLAPSE OF BUILDINGS TO BE DEMOLISHED AND ADJACENT BUILDINGS TO REMAIN.
- I. STRENGTHEN OR ADD NEW SUPPORTS WHEN REQUIRED DURING PROGRESS OF DEMOLITION.
- J. VERIFY THAT UTILITIES HAVE BEEN DISCONNECTED AND CAPPED.
- K. SURVEY EXISTING CONDITIONS AND CORRELATE WITH REQUIREMENTS INDICATED TO DETERMINE EXTENT OF DEMOLITION AND RECYCLING REQUIRED.
- L. IF THE CONDITION OF THE BUILDING OR STRUCTURE REQUIRES REMOVING ANY ELEMENT MIGHT RESULT IN A STRUCTURAL DEFICIENCY OR UNPLANNED COLLAPSE OF ANY PORTION OF THE STRUCTURE OR ADJACENT STRUCTURES DURING DEMOLITION.
- M. RETAIN A LICENSED AND QUALIFIED STRUCTURAL ENGINEER TO PROVIDE ANALYSIS, INCLUDING CALCULATIONS, NECESSARY TO ENSURE THE SAFE EXECUTION OF THE DEMOLITION WORK LEAVING THE STRUCTURAL STEEL, CONCRETE FOUNDATIONS, AND SUPPORTED SLABS WITH STRUCTURAL FRAMING SHALL NOT BE ALTERED WITHOUT A FIELD INVESTIGATION BY THE ARCHITECT OR A STRUCTURAL ENGINEER.

- A. DEMOLITION DRAWINGS INDICATE GENERAL AREAS OF DEMOLITION ONLY. EXTENT OF REMOVAL OF EXISTING CONSTRUCTION MATERIALS TO BE DETERMINED BY FIELD INVESTIGATION AND/OR ORIGINATOR'S ARCHITECTURAL, MECHANICAL, ELECTRICAL, AND PLUMBING DOCUMENTS AS REQUIRED TO ACCOMMODATE THE NEW CONSTRUCTION. EXISTING MECHANICAL, PLUMBING, AND ELECTRICAL TO BE RELOCATED PER DRAWINGS, COORDINATE WITH CONTRACTORS AS REQUIRED.
- B. COORDINATE REMOVAL OF EXISTING ITEMS WITH PROPOSED FRAMING DETAILS, INTERIOR ELEVATIONS, AND DETAILS. PROVIDE TEMPORARY STRUCTURAL SUPPORT AS REQUIRED PRIOR TO STRUCTURE DEMOLITION.
- C. PATCH AND REPAIR EXISTING MATERIALS TO REMAIN AS REQUIRED WHERE REMOVAL OF EXISTING CONSTRUCTION OR WHERE REQUIREMENTS OF NEW CONSTRUCTION NECESSITATES CUTTING OR ALTERING EXISTING MATERIALS. EXISTING WALLS, FLOORS, AND CEILING TO REMAIN INTACT AS IS INDICATED ON DRAWINGS.
- D. COORDINATE WITH ARCHITECTURAL, MECHANICAL, PLUMBING, AND ELECTRICAL DOCUMENTS. CONTRACTOR IS RESPONSIBLE FOR THE PATCH AND REPAIR OF ALL DAMAGE ARISING FROM DEMOLITION OPERATIONS AS REQUIRED TO MATCH EXISTING.
- E. ALL DEMOLITION WORK SHALL ATTEMPT TO SALVAGE ADJACENT AREAS AND RE-USABLE MATERIALS TO THE EXTENTS POSSIBLE. VERIFY OWNER'S INTENT TO REUSE OR ARE ANY BUILDING COMPONENTS PRIOR TO DISPOSAL. EXCEPT FOR ITEMS OR MATERIALS INDICATED TO BE REUSED, SALVAGED, REINSTALLED, OR OTHERWISE INDICATED TO REMAIN PROPERTY OF OWNER, DEMOLISHED MATERIALS SHALL BECOME THE CONTRACTOR'S PROPERTY AND SHALL BE REMOVED, RECYCLED, OR DISPOSED FROM PROJECT SITE IN AN APPROPRIATE AND LEGAL MANNER.
- F. REPAIR OR ATTEMPT TO REPAIR DAMAGE TO DEMOLITION CONTRACTOR TO SEPARATE BUILDING MATERIALS INTO RECYCLABLE CONTENT.
- G. LOCATE DEMOLITION EQUIPMENT THROUGHOUT THE BUILDING AND REMOVE DEBRIS AND MATERIALS SO AS NOT TO IMPOSE EXCESSIVE LOADS ON SUPPORTING WALLS, FLOORS, OR FRAMING.
- H. REMOVE STRUCTURAL FRAMING MEMBERS AND LOWER TO GROUND BY METHOD SUFFICIENT TO AVOID FREE FALL AND TO PREVENT GROUND IMPACT OR DUST GENERATION.
- I. PROVIDE TEMPORARY AND SECURE WATERPROOF ENCLOSURE DURING CONSTRUCTION.
- J. PREPARE ALL SURFACES AS REQUIRED TO RECEIVE NEW WORK AND NEW FINISHES AS INDICATED ON THE DRAWINGS AND SPECIFICATIONS.
- K. ALL SALVAGED ITEMS TO BE CLEANED, REPAIRS, OR PATCHED AS NECESSARY PRIOR TO NEW INSTALLATION.
- L. REMOVE ANY DAMAGED MASONRY AT REMAINING WALLS. PROVIDE NEW INFILL TO MATCH EXISTING.
- M. REMOVE EXISTING MECHANICAL AND PLUMBING SYSTEMS, VENTS, FIXTURES, DRAINS OR NETWORK NOT INDICATED FOR REUSE, DO NOT LEAVE THESE ITEMS IN PLACE UNLESS NOTED OTHERWISE. REFER TO MECHANICAL AND PLUMBING FOR ADDITIONAL INFORMATION.

A.	LEGALLY TRANSPORT AND DISPOSE OF MATERIALS THAT CANNOT BE DELIVERED TO A SOURCE-SEPARATED OR MIXED RECYCLING FACILITY TO A TRANSFER STATION OR DISPOSAL FACILITY THAT CAN LEGALLY ACCEPT THE MATERIALS FOR THE PURPOSE OF DISPOSAL.
B.	USE A PERMITTED WASTE HAULER OR CONTRACTOR'S TRUCKING SERVICES AND PERSONNEL TO CONFIRM VALID PERMITTED STATUS OF WASTE HAULERS, CONTACT THE APPROPRIATE WASTE MANAGEMENT AGENCY.
C.	BECOME FAMILIAR WITH THE CONDITIONS FOR ACCEPTANCE OF NEW CONSTRUCTION, EXCAVATION AND DEMOLITION MATERIALS AT RECYCLING FACILITIES, PRIOR TO DELIVERING MATERIALS.
D.	DELIVER TO FACILITIES THAT CAN LEGALLY ACCEPT NEW CONSTRUCTION, EXCAVATION AND DEMOLITION MATERIALS FOR PURPOSE OF RE-USE, RECYCLING, COMPOSTING, OR DISPOSAL.
E.	DO NOT BURN, BURY OR OTHERWISE DISPOSE OF RUBBISH AND WASTE MATERIALS ON PROJECT SITE.
F.	DEMOLISH CONCRETE AND MASONRY IN SIZES THAT WILL BE SUITABLE FOR ACCEPTANCE AT RECYCLING OR DISPOSAL FACILITIES.

A. SAFETY-RELATED WORK PRACTICES SHALL BE EMPLOYED TO PREVENT ELECTRIC SHOCK OR ELECTRICAL CONTACTS, WHEN WORK IS PERFORMED NEAR OR ON EQUIPMENT OR CIRCUITS WHICH ARE OR MAY BE ENERGIZED. LIVE PARTS SHALL BE DE-ENERGIZED BY THE ELECTRICIAN OR ONE OF THE OTHERS. ONLY QUALIFIED ELECTRICIAN MAY WORK ON ENERGIZED CIRCUITS OR EQUIPMENT.

B. THE CIRCUITS AND EQUIPMENT TO BE WORKED ON SHALL BE DISCONNECTED FROM ALL ELECTRIC ENERGY SOURCES. ELECTRIC EQUIPMENT OR CIRCUITS WHICH HAVE BEEN DE-ENERGIZED SHALL BE LOCKED OUT, TAGGED, OR BOTH.

C. A QUALIFIED ELECTRICIAN SHALL TEST EQUIPMENT (VOLT-Ohm-METER, ETC.) AND SHALL VERIFY THAT THE CIRCUIT AND EQUIPMENT ARE DE-ENERGIZED. IF THE CIRCUIT IS OVER 600 VOLTS, THE TEST EQUIPMENT SHALL BE CHECKED FOR PROPER OPERATION IMMEDIATELY BEFORE AND IMMEDIATELY AFTER THIS TEST.

D. STORED ELECTRICAL ENERGY WHICH MIGHT ENDANGER PERSONNEL SHALL BE RELEASED. CAPACITANCE AND DISCHARGED, IF THE STORED ELECTRICAL ENERGY MIGHT ENDANGER PERSONNEL.

E. A QUALIFIED ELECTRICIAN SHALL CONDUCT TESTS AND VISUAL INSPECTIONS TO VERIFY THAT ALL TOOLS, ELECTRICAL JUMPERS, SHORTS, GROUNDS, AND OTHER SUCH DEVICES HAVE BEEN REMOVED, SO THAT THE CIRCUITS AND EQUIPMENT CAN BE SAFELY ENERGIZED.

F. CAP. TERMINATE, OR REMOVE ALL MISCELLANEOUS POWER WIRES, OUTLETS, AND SWITCHES AS REQUIRED DURING CONSTRUCTION AND DEMOLITION.


G. DISCONNECT AND REMOVE ALL EXISTING ELECTRICAL LIGHTING FIXTURES, LOW VOLTAGE TRANSFORMERS, WIRING DEVICES IN ENTIRETY, ALL CONDUIT, WIRING, CABLEING, ETC. SHALL BE REMOVED BACK TO THE SOURCE.

A. ALL GAS TO BE SHUT OFF TO AREAS OF DEMOLITION BY A QUALIFIED CONTRACTOR. TEST FOR LEAKS PRIOR TO COMMENCING WORK.


B. WHERE APPLICABLE, PROVIDE NEW SHUT OFF VALVES WHERE PIPING REACHES AREA OF DEMOLITION.



EXISTING CONDITION PHOTOS - FIRST FLOOR

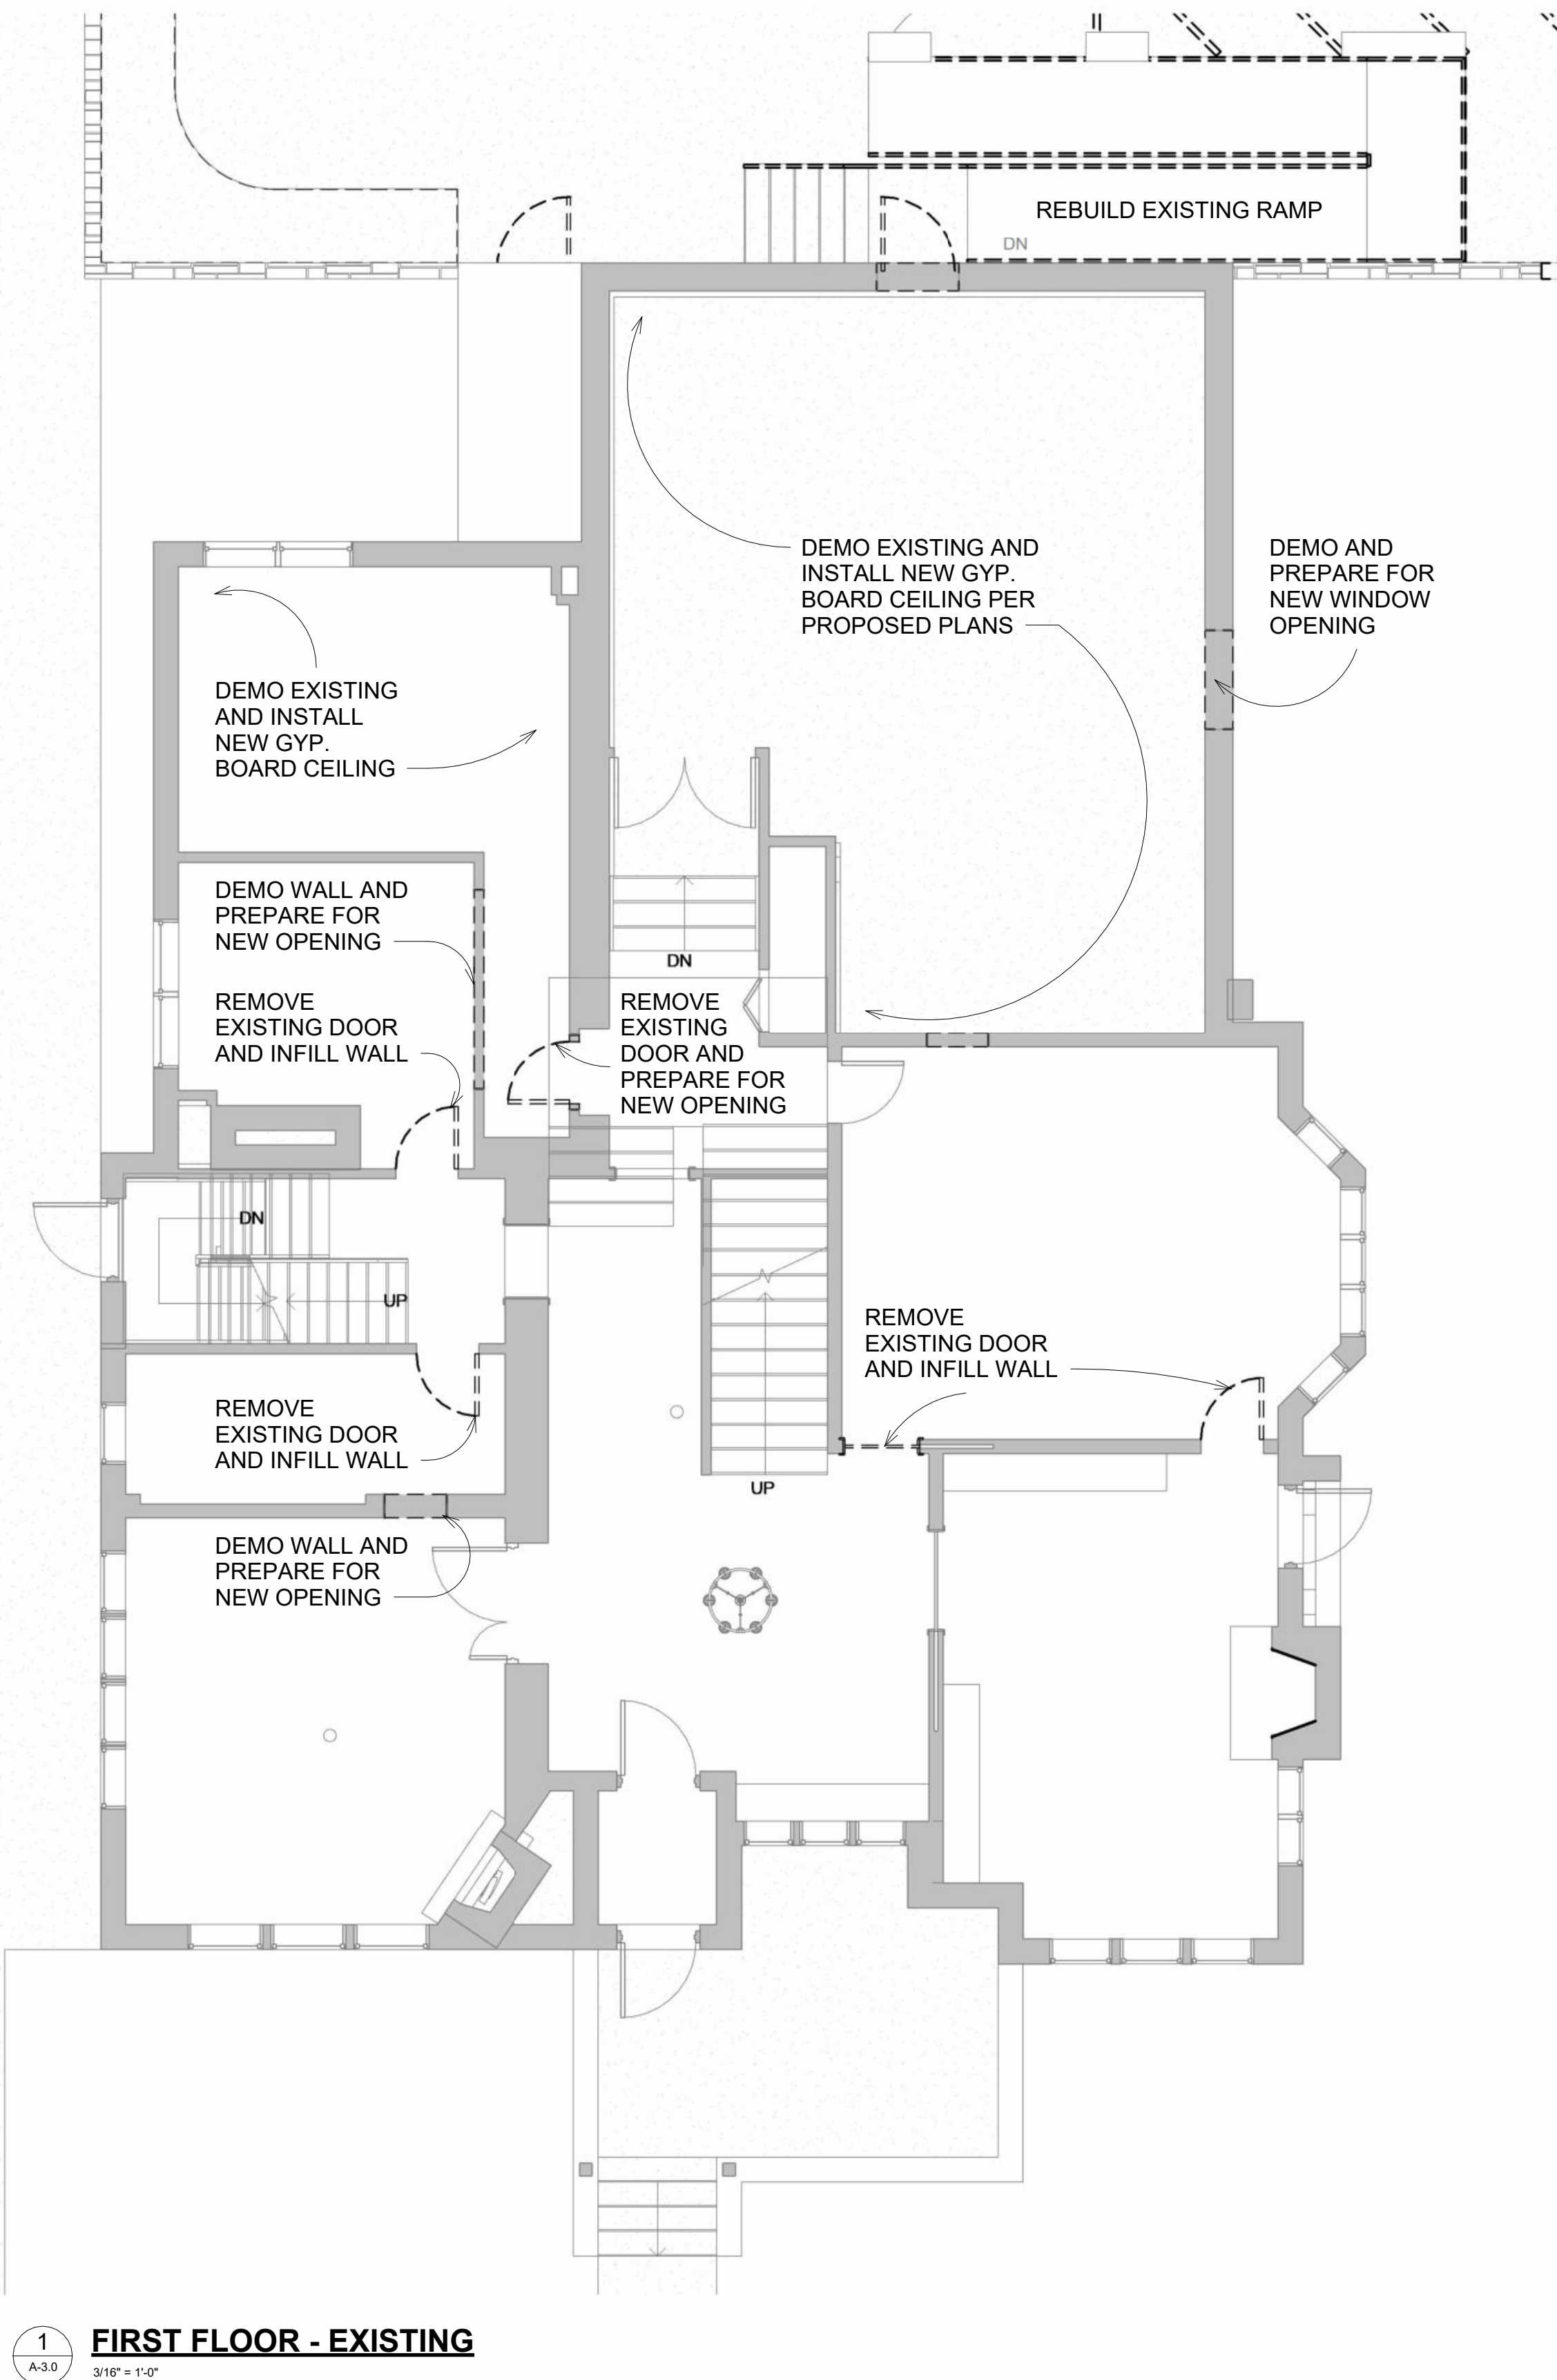

EXISTING CONDITION PHOTOS - BASEMENT

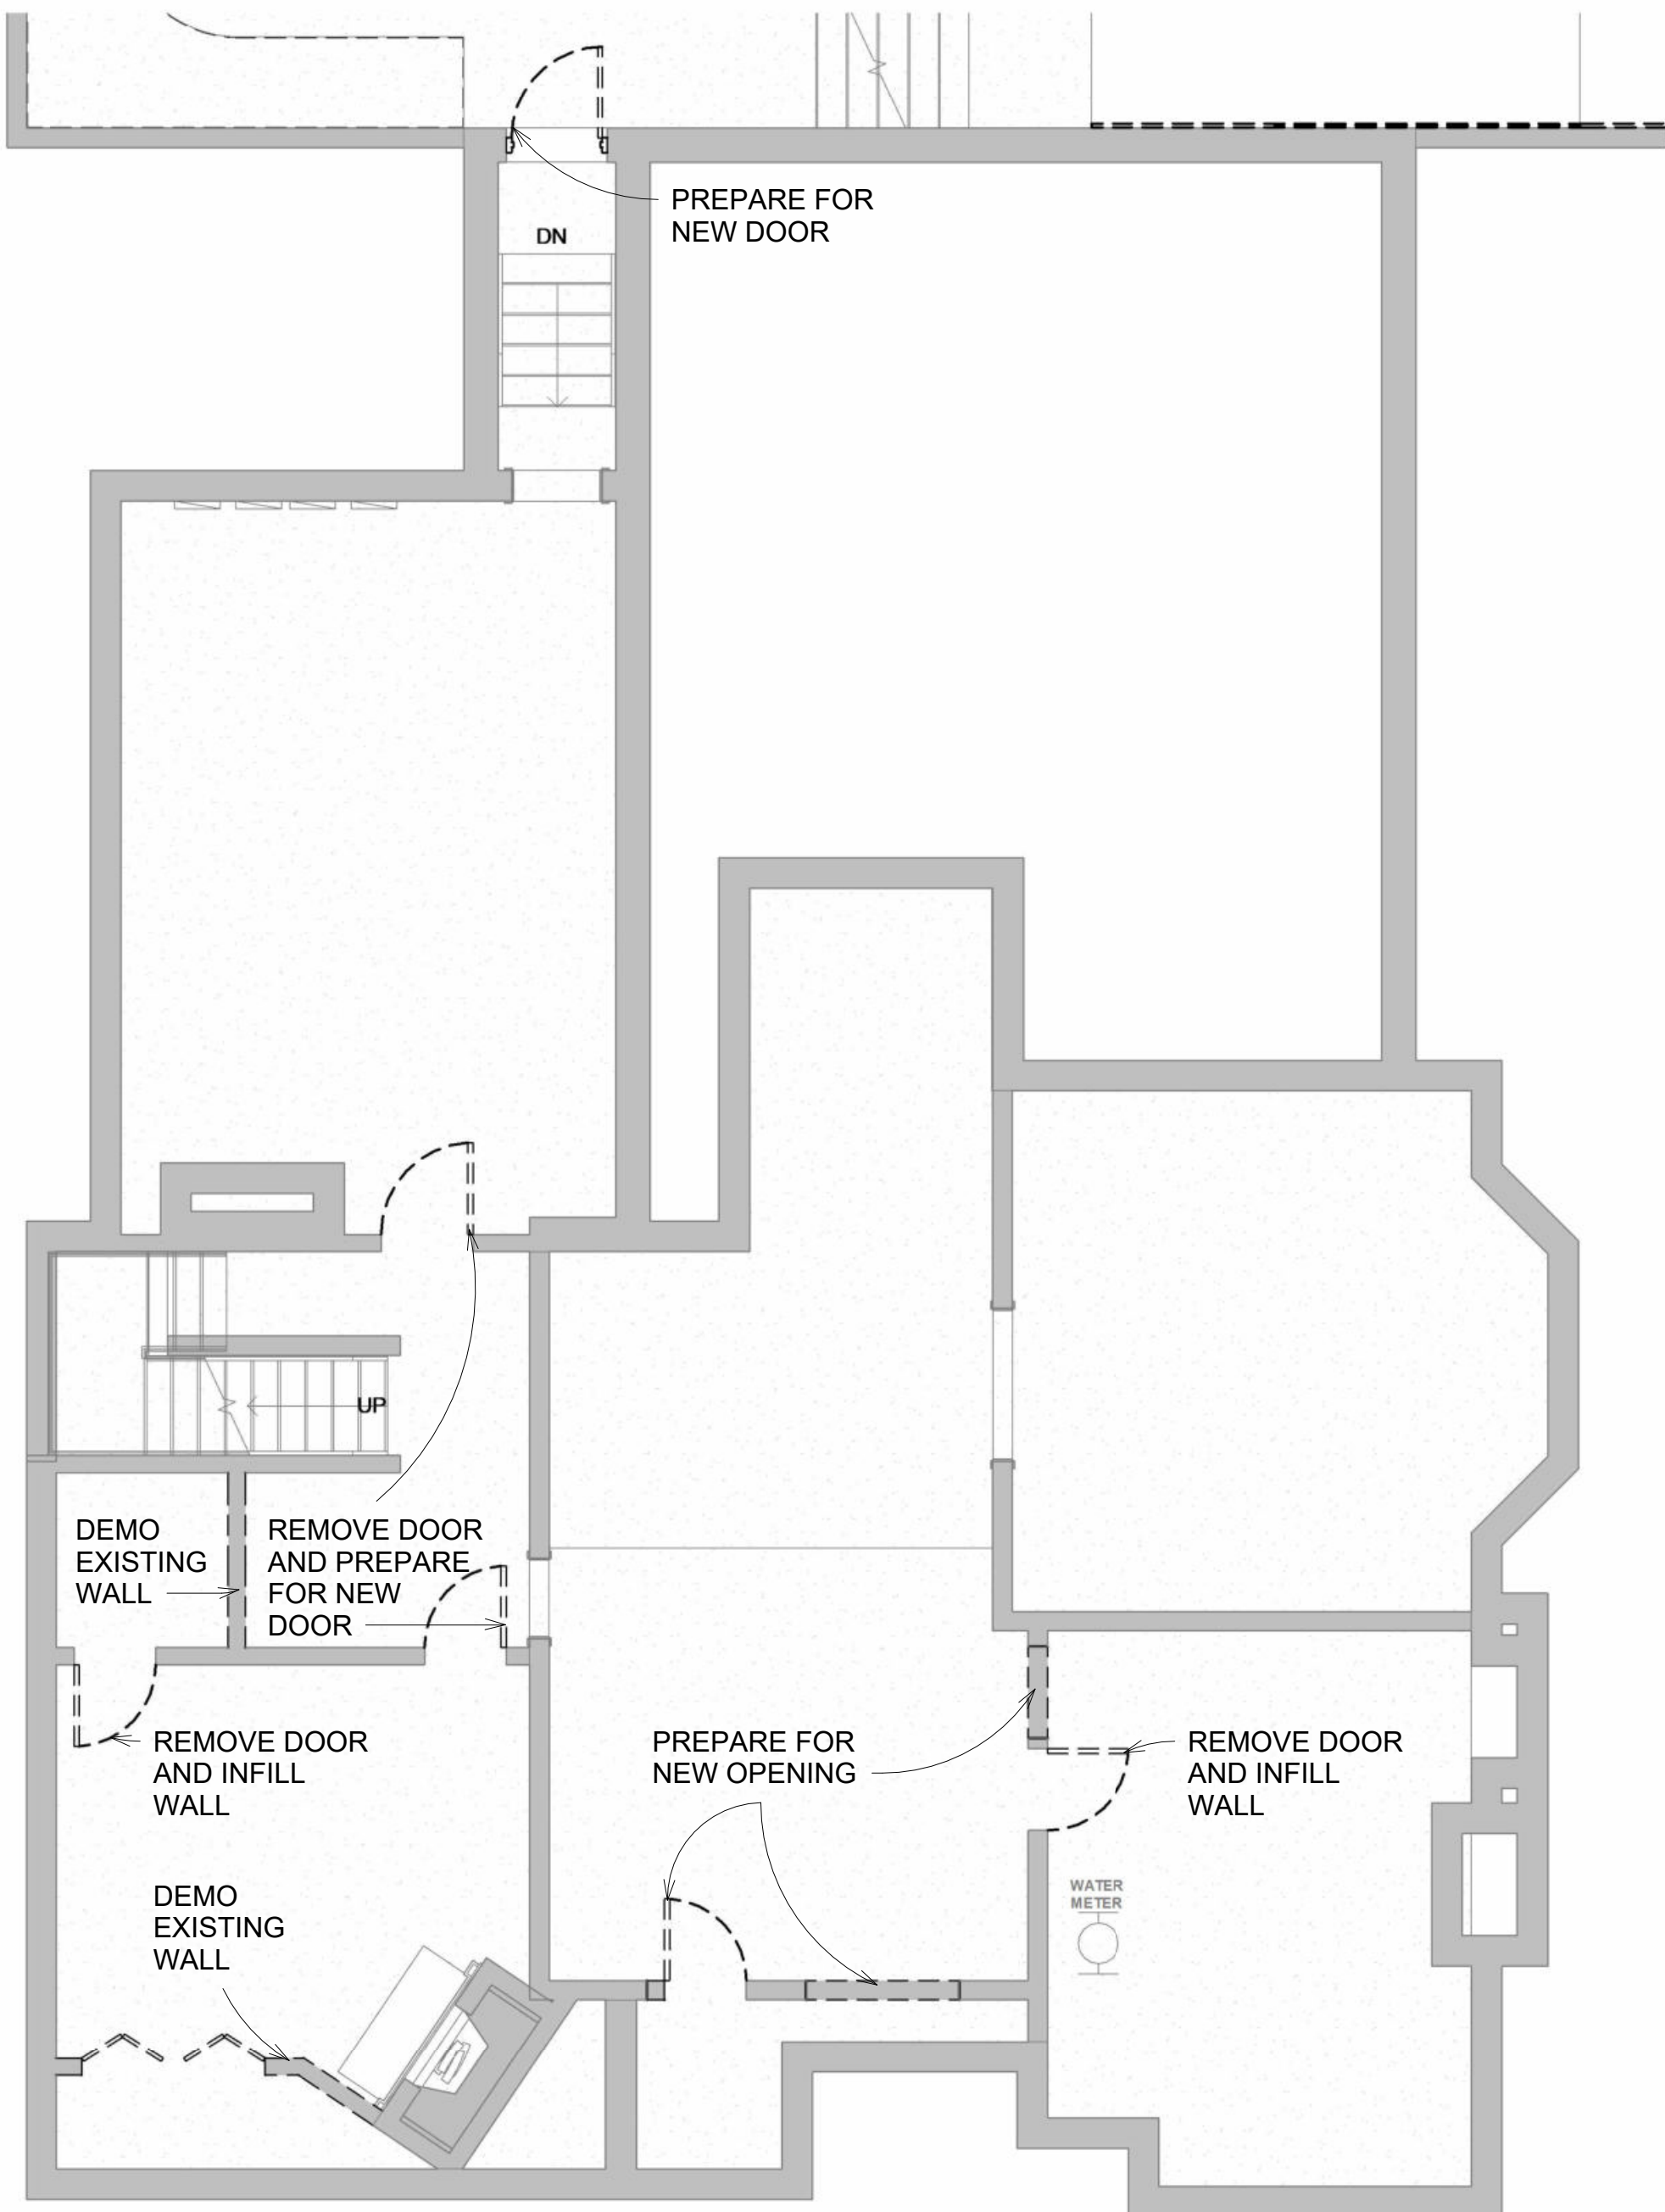

nfuz Ltd.

ARCHITECTS + INNOVATORS

Detroit Office
 11111 Bellevue Ste 201
 Detroit MI, 48207
 Phone: 313.332.7299

Port Huron Office
 203 Huron Ave. Suite 1
 Port Huron, MI 48060
 Phone: 586.295/604

Email: infuzltd@comcast.net
Web: infuzarchitects.com

Revision Schedule		
#	Description	Date
1	Commercial Set	03/13/2025

Unauthorized use of this drawing set without written permission from VIRTUOSO DESIGN + BUILD and Infuz Ltd is in violation of U.S. COPYRIGHT LAWS and will be subject to civil damages and prosecution.

SEAL

**NOT FOR
CONSTRUCTION**

03/13/2025

BERKERY ESTATE

PROJECT NUMBER: Z24075

8325 E JEFFERSON AVE

DETROIT, MI 48214

NIALL & MELVIE BERKERY

SHEET TITLE

SHEET NUMBER


A-1.0




EXISTING CONDITION PHOTOS - THIRD FLOOR



EXISTING CONDITION PHOTOS - SECOND FLOOR

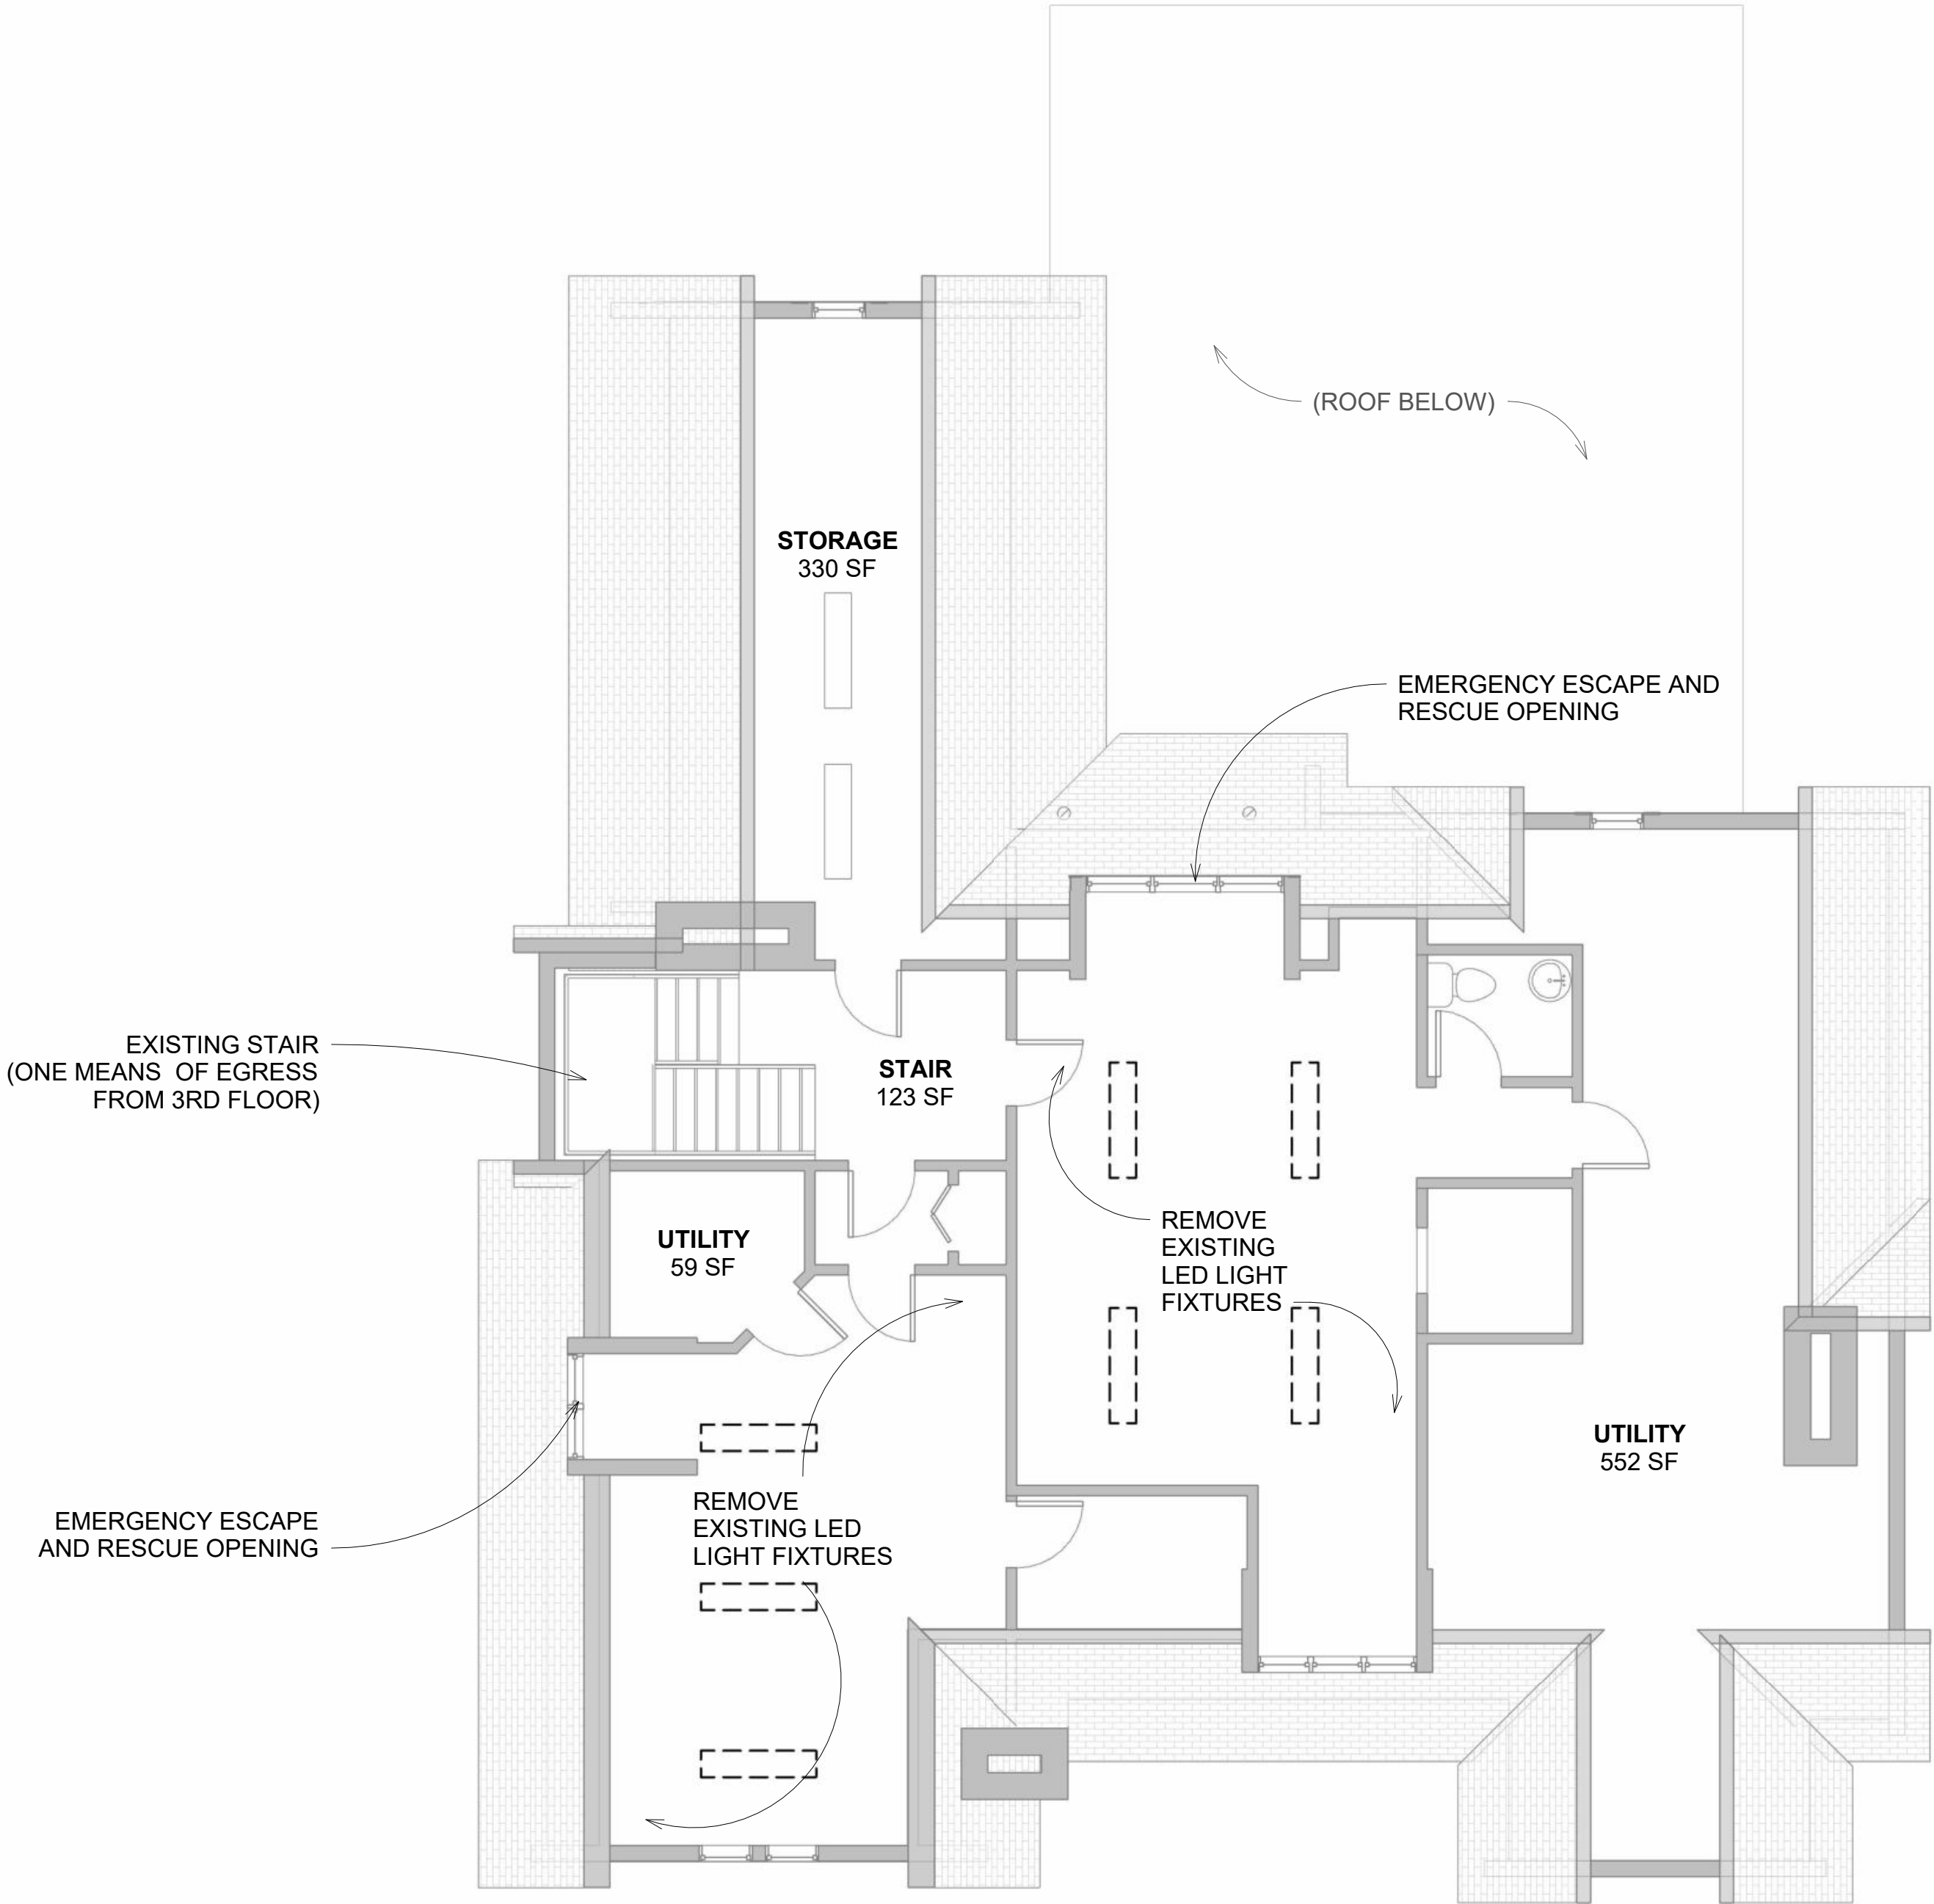

2 THIRD FLOOR / ATTIC - EXISTING
A-3.0
3/16" = 1'-0"

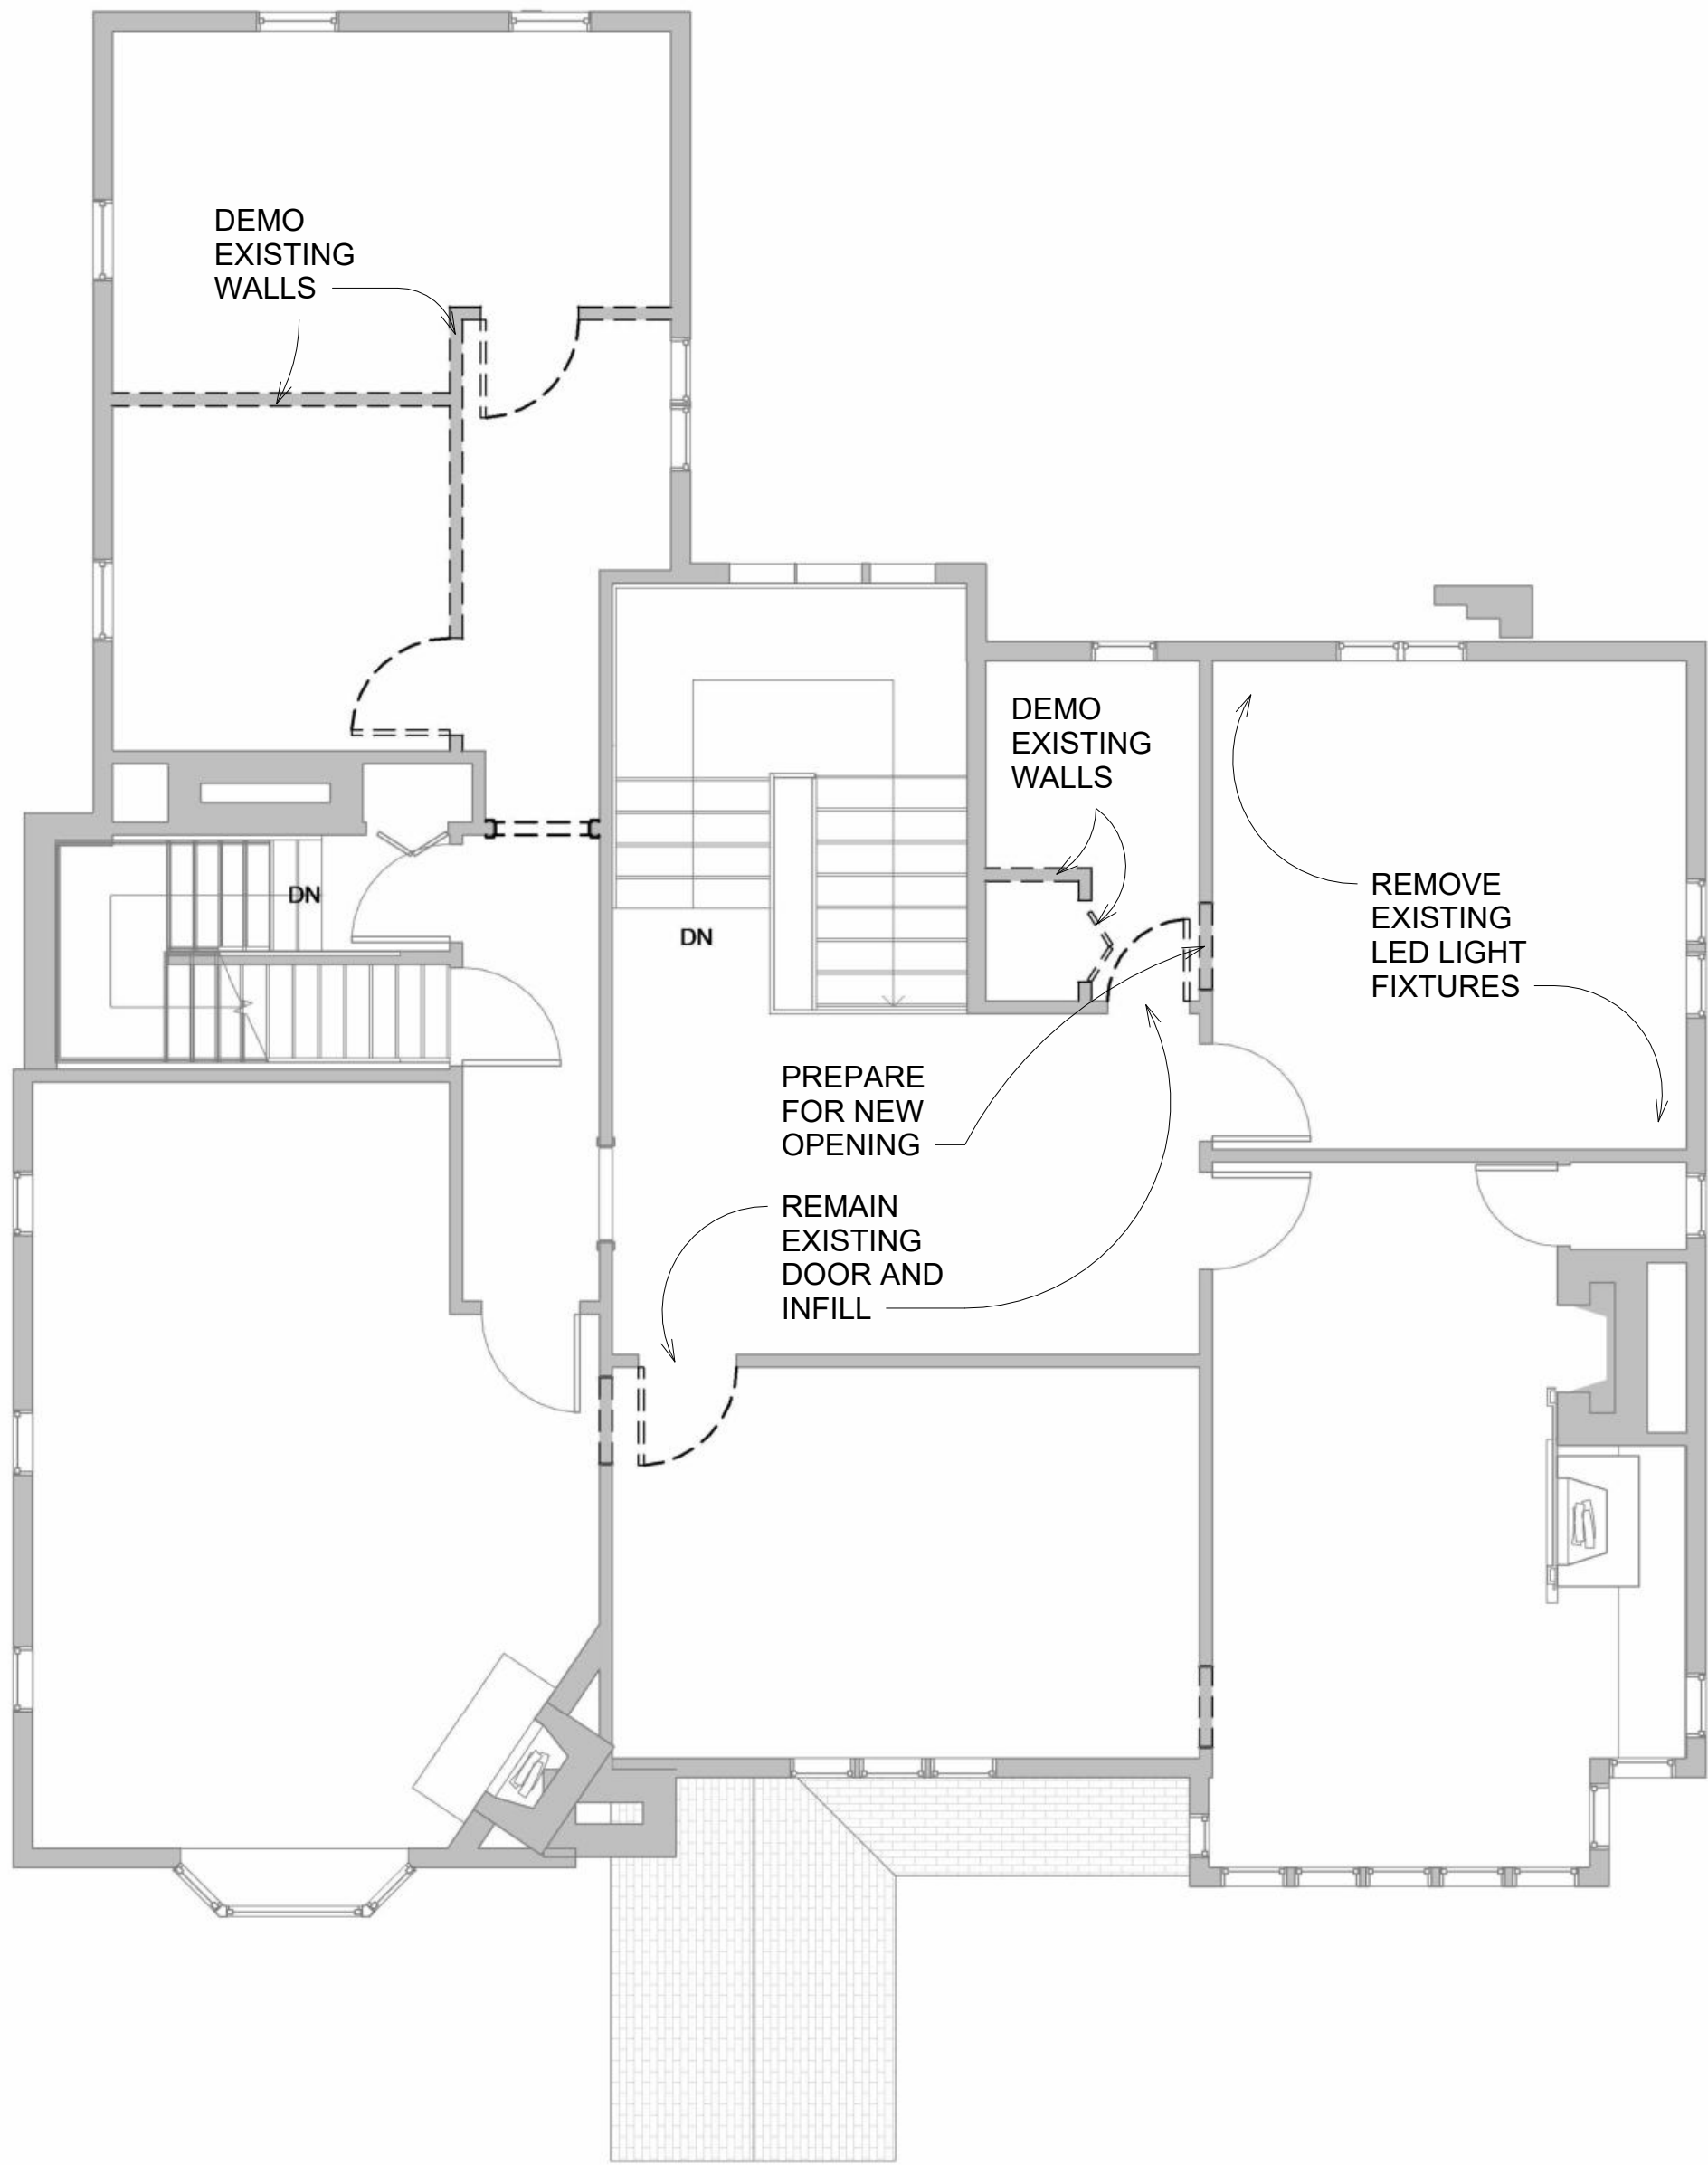

1 SECOND FLOOR - EXISTING
A-3.0
3/16" = 1'-0"

Unauthorized use of this drawing set without written permission from VIRTUOSO DESIGN + BUILD and infuz Ltd is in violation of U.S. COPYRIGHT LAWS and will be subject to civil damages and prosecution.

Revision Schedule		
#	Description	Date
1	Commercial Set	03/13/2025


SEAL
NOT FOR CONSTRUCTION
03/13/2025

BERKERY ESTATE
PROJECT NUMBER: ZJ4075
8325 E. JEFFERSON AVE
DETROIT, MI 48214
NIAL & MELVIE BERKERY
SHEET TITLE
DEMOLITION PLANS

SHEET NUMBER
A-1.1

GENERAL NOTE:
EXISTING HISTORIC WINDOW OPENINGS TO BE VERIFIED FOR COMPLIANCE WITH EGRESS REQUIREMENTS. WHERE NECESSARY, HISTORIC REPLICA CASEMENT WINDOWS TO BE PROVIDED THAT MEET MINIMUM EGRESS REQUIREMENTS.

LEGEND:

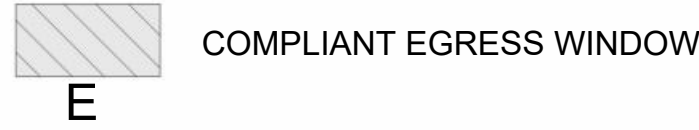

1/4" = 1'-0"

NEW WINDOW SCHEDULE					
Type Mark	Count	Width	Height	Description	Comments
IW4	2	2' - 0"	4' - 0"	NEW EGRESS WINDOWS	PROVIDE DOUBLE HUNG OR CASEMENT TO MATCH EXISTING HISTORIC WINDOW TYPES. VERIFY MIN. EGRESS CLEARANCES.

WALL SCHEDULE				
Type Mark	Area	Description	Function	Comments
IW4	1884 SF	5/8" GYP. ON 2x4 WOOD STUDS @ 16" O.C. ON 5/8" GYP.	Interior	
IW6	57 SF	5/8" GYP. ON 2x6 WOOD STUDS @ 16" O.C. ON 5/8" GYP.	Interior	
Grand total 1941 SF				

GENERAL FRAMING NOTES:

- EXTEND ALL INTERIOR PARTITIONS UP TO CEILING STRUCTURE @ MIN. 8" O.C. U.N.O. COORDINATE OPENINGS AND VERTICAL SHAFTS WITH ME/P AND FIRE TRADES.
- ALL GYP. BD. TO BE 5/8" AT CEILINGS AND MIN. 1/2" AT WALLS U.N.O.
- ALL DEMISING WALLS TO BE SECURED TO STRUCTURE ABOVE. SEALING ALL PENETRATIONS PROVIDE AND INSTALL SOUND BATT INSULATION ABOVE CEILING ALONG DEMISING PARTITION.

WALL CONSTRUCTION NOTES:

- PROVIDE DENSE OR FIBER REINFORCED GYPSUM INTERIOR PANELS TO BE USED AT ALL CORRIDOR AND HIGH IMPACT AREAS.
- WHERE EXISTING C.M.U. WALLS ARE TO BE FURRED FOR GYP. BD. FINISH, PROVIDE PROPER FURRING DEPTH FOR FLUSH TRANSITIONS TO ADJACENT WALLS.
- WHERE EXISTING C.M.U. WALLS ARE TO BE RENOVATED, TOOTH IN NEW AREAS AND PROVIDE CONSISTENT FINISH

LIGHT GAUGE METAL FRAMING:

- ALL LIGHT GAUGE FRAMING MEMBERS SHALL BE DESIGNED, FABRICATED AND ERECTED IN ACCORDANCE WITH THE AISI "SPECIFICATIONS FOR DESIGN OF COLD-FORMED STEEL STRUCTURAL MEMBERS" AND IN ACCORDANCE WITH MANUFACTURERS WRITTEN INSTRUCTIONS.
- ALL MATERIAL SHALL CONFORM TO ASTM A446, WITH MINIMUM YIELD POINT OF 33 KSI FOR 18 GAUGE, AND 50 KSI FOR 16 GAUGE AND HEAVIER MATERIAL, AND SHALL HAVE GALVANIZED COATING TO ASTM A525-590.
- ALL WELDING SHALL CONFORM TO AWS D1.3 SPECIFICATIONS FOR WELDING SHEET STEEL STRUCTURES, AND AWS D19.0 WELDING ZINC COATED STEEL.
- ALL MATERIAL SHALL BE OF A MINIMUM 18 GAUGE THICKNESS, AND SHALL MEET THE DEFLECTION REQUIREMENTS OF THE FINISH MATERIALS TO BE ATTACHED TO THE LIGHT GAUGE FRAMING WORK.
- ALL STUDS AND JOISTS SHALL BE INSTALLED AT SPACING INDICATED ON THE DRAWINGS.
- EACH SIDE OF OPENINGS SHALL BE FRAMED WITH DOUBLE STUDS.
- ALL STUDS AND JOISTS SHALL HAVE A BRIDGING LINE INSTALLED AT A MAXIMUM SPACING OF 4'-0" AND 5'-0" RESPECTIVELY.
- ALL JOISTS SHALL HAVE WEB STIFFENERS AT REACTION POINTS AND CONCENTRATED LOADS.
- STRUCTURAL CONNECTIONS OF LIGHT GAGE METAL FRAMING MEMBERS SHALL BE MADE PER MANUFACTURERS RECOMMENDATIONS, ADEQUATE TO CARRY THE IMPOSED LOADS, AND CONFORMING TO THE AISI AND AWS SPECIFICATIONS.
- CONNECTION DESIGN TO BE BASED ON REACTIONS GIVEN ON THE DRAWINGS OR AS LISTED IN THE MANUFACTURERS UNIFORM LOADING CAPACITY TABLES, WHICHEVER IS GREATER.
- SUSPENDED CEILING GRID SYSTEM SHALL COMPLY WITH THE LATEST MICHIGAN BUILDING CODE AND GRID WORK SHALL BE SUPPORTED WITH A MINIMUM OF 2-12 GA. HANGER WIRES ATTACHED TO STRUCTURE ABOVE.
- EXTERIOR CEE FRAMING TO BE STEEL FORM DELTA STUDS' W/ 1/2" FOIL FACED RIGID SHEATHING. PROVIDE DOUBLE DEFLECTION OR SLOTTED TRACKS ON TOP OF ALL CEE WALLS.
- ALL LIGHT GAUGE MTL. FRAMING TO FOLLOW PROCEDURES AND PRATICES AS RECOMMENDED BY THE "STEEL STUD MANUFACTURERS ASSOCIATION"

FIRE STOPPING:

FIRE STOPPING SHALL BE PROVIDED TO CUT OFF ALL CONCEALED DRAFT OPENING (BOTH VERTICAL AND HORIZONTAL) AND TO FORM AN EFFECTIVE FIRE BARRIER BETWEEN STORIES, AND BETWEEN A TOP STORY AND THE ROOF SPACE. FIRE STOPPING SHALL BE PROVIDED IN WOOD-FRAME CONSTRUCTION IN THE FOLLOWING LOCATIONS.


- CONCEALED WALL SPACES - FIRE BLOCKING SHALL BE PROVIDED IN CONCEALED SPACES OF STUD WALLS AND PARTITIONS, INCLUDING FURRED SPACES, AT THE CEILING AND FLOOR LEVELS AND AT 10 FOOT INTERVALS BOTH VERTICAL AND HORIZONTAL.
- CONNECTIONS BETWEEN HORIZONTAL AND VERTICAL SPACES - FIRE BLOCKING SHALL BE PROVIDED AT INTERCONNECTIONS BETWEEN CONCEALED VERTICAL STUD WALL OR PARTITION SPACES AND CONCEALED HORIZONTAL SPACES CREATED BY AN ASSEMBLY OF FLOOR JOISTS OR TRUSSES, AND BETWEEN CONCEALED VERTICAL AND HORIZONTAL SPACES SUCH AS OCCUR AT SOFFITS, DROP CEILINGS, COVE CEILINGS AND SIMILAR LOCATIONS.
- STAIRWAYS - FIRE BLOCKING SHALL BE PROVIDED IN CONCEALED SPACES BETWEEN STRINGERS AT THE TOP AND BOTTOM OF THE RUN AND BETWEEN STUDS ALONG AND IN LINE WITH THE RUN OF STAIRS IF THE WALLS UNDER THE STAIRS ARE UNFINISHED.
- ARCHITECTURAL TRIM - FIRE BLOCKING SHALL BE INSTALLED WITHIN CONCEALED SPACES OF EXTERIOR WALL FINISH AND OTHER EXTERIOR ARCHITECTURAL ELEMENTS AT MAXIMUM INTERVALS OF 20 FEET. IF NON-CONTINUOUS, SUCH ELEMENTS SHALL HAVE CLOSED ENDS, WITH AT LEAST 4 INCHES OF SEPARATION BETWEEN SECTIONS.

FIRE BLOCKING MATERIALS:


FIRE BLOCKING SHALL CONSIST OF 2-INCH NOMINAL LUMBER OR TWO THICKNESSES OF 1-INCH NOMINAL LUMBER WITH BROKEN LAP JOINTS OR ONE THICKNESS OF 0.719-INCH WOOD STRUCTURAL PANEL WITH JOINTS BACKED BY 0.719-INCH WOOD STRUCTURAL PANEL OR ONE THICKNESS OF 0.75-INCH PARTICLEBOARD WITH JOINTS BACKED BY 0.75-INCH PARTICLEBOARD, GYPSUM FIBERBOARD, CEMENT FIBERBOARD, BATTIS OR BLANKETS OF MINERAL WOOL OR GLASS FIBER OR OTHER APPROVED MATERIALS INSTALLED IN SUCH A MANNER AS TO BE SECURELY RETAINED IN PLACE SHALL BE PERMITTED AS AN ACCEPTABLE FIRE BLOCK.

DRAFTSTOPPING:


DRAFTSTOPPING (REQUIRED IN ENCLOSED AREAS AND ATTICS WHEN BUILDING IS NOT EQUIPPED THROUGHOUT WITH AN AUTOMATIC FIRE SUPPRESSION SYSTEM) SHALL BE PROVIDED IN DIRECTION OF FRAMING, MAX. 3,000 SQ.FT. COMPARTMENT AREA U.N.O.

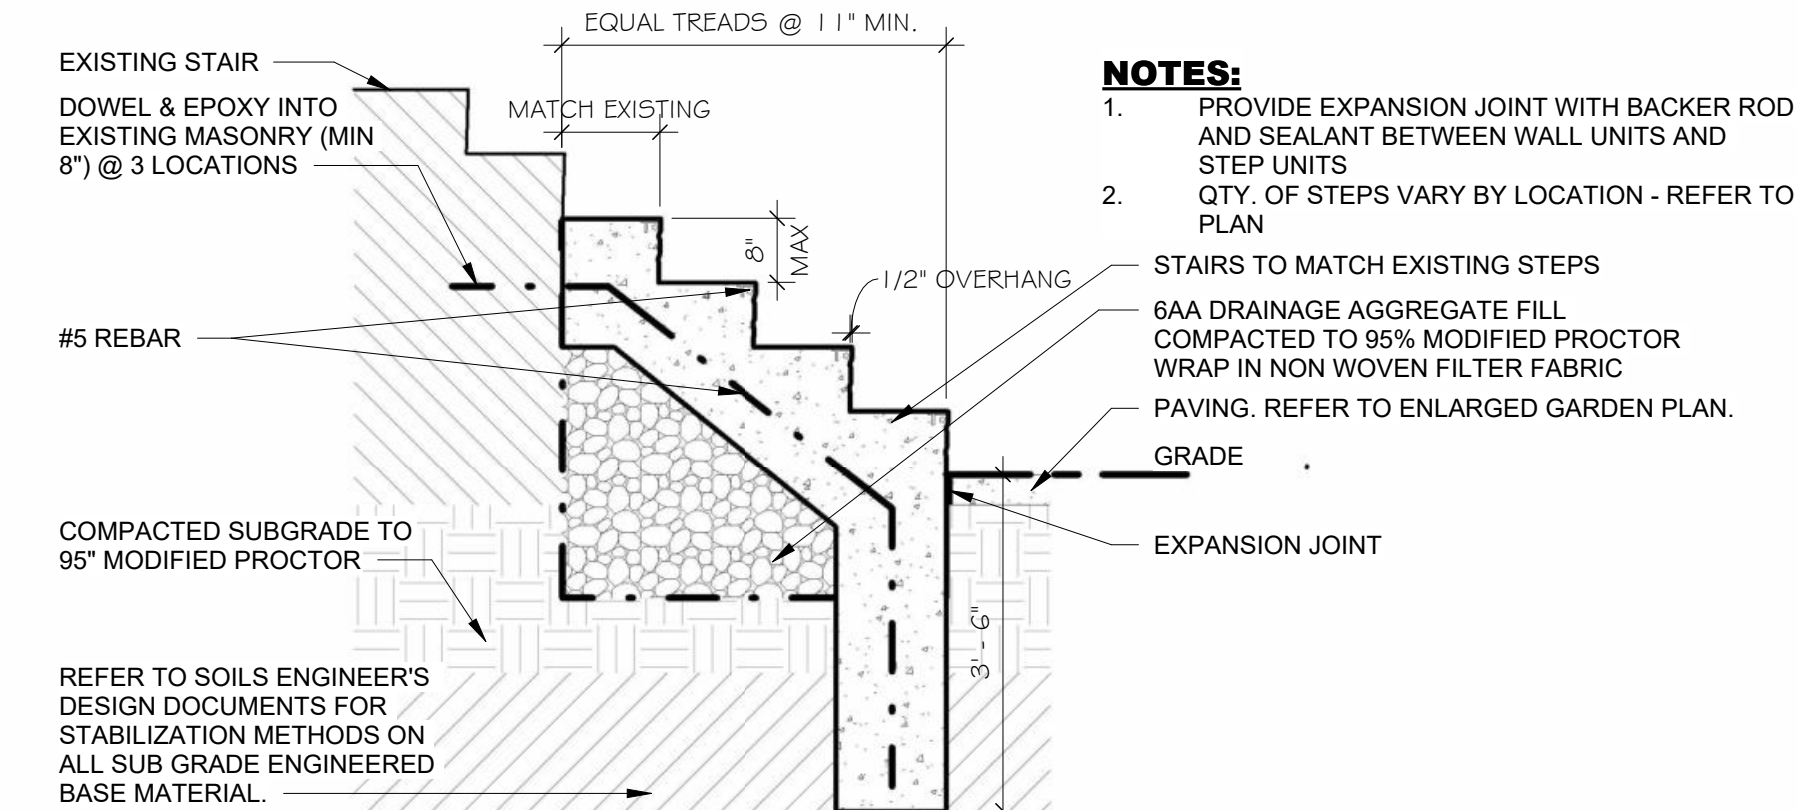


5 TYPICAL STONE STAIR DETAIL
1/2" = 1'-0"

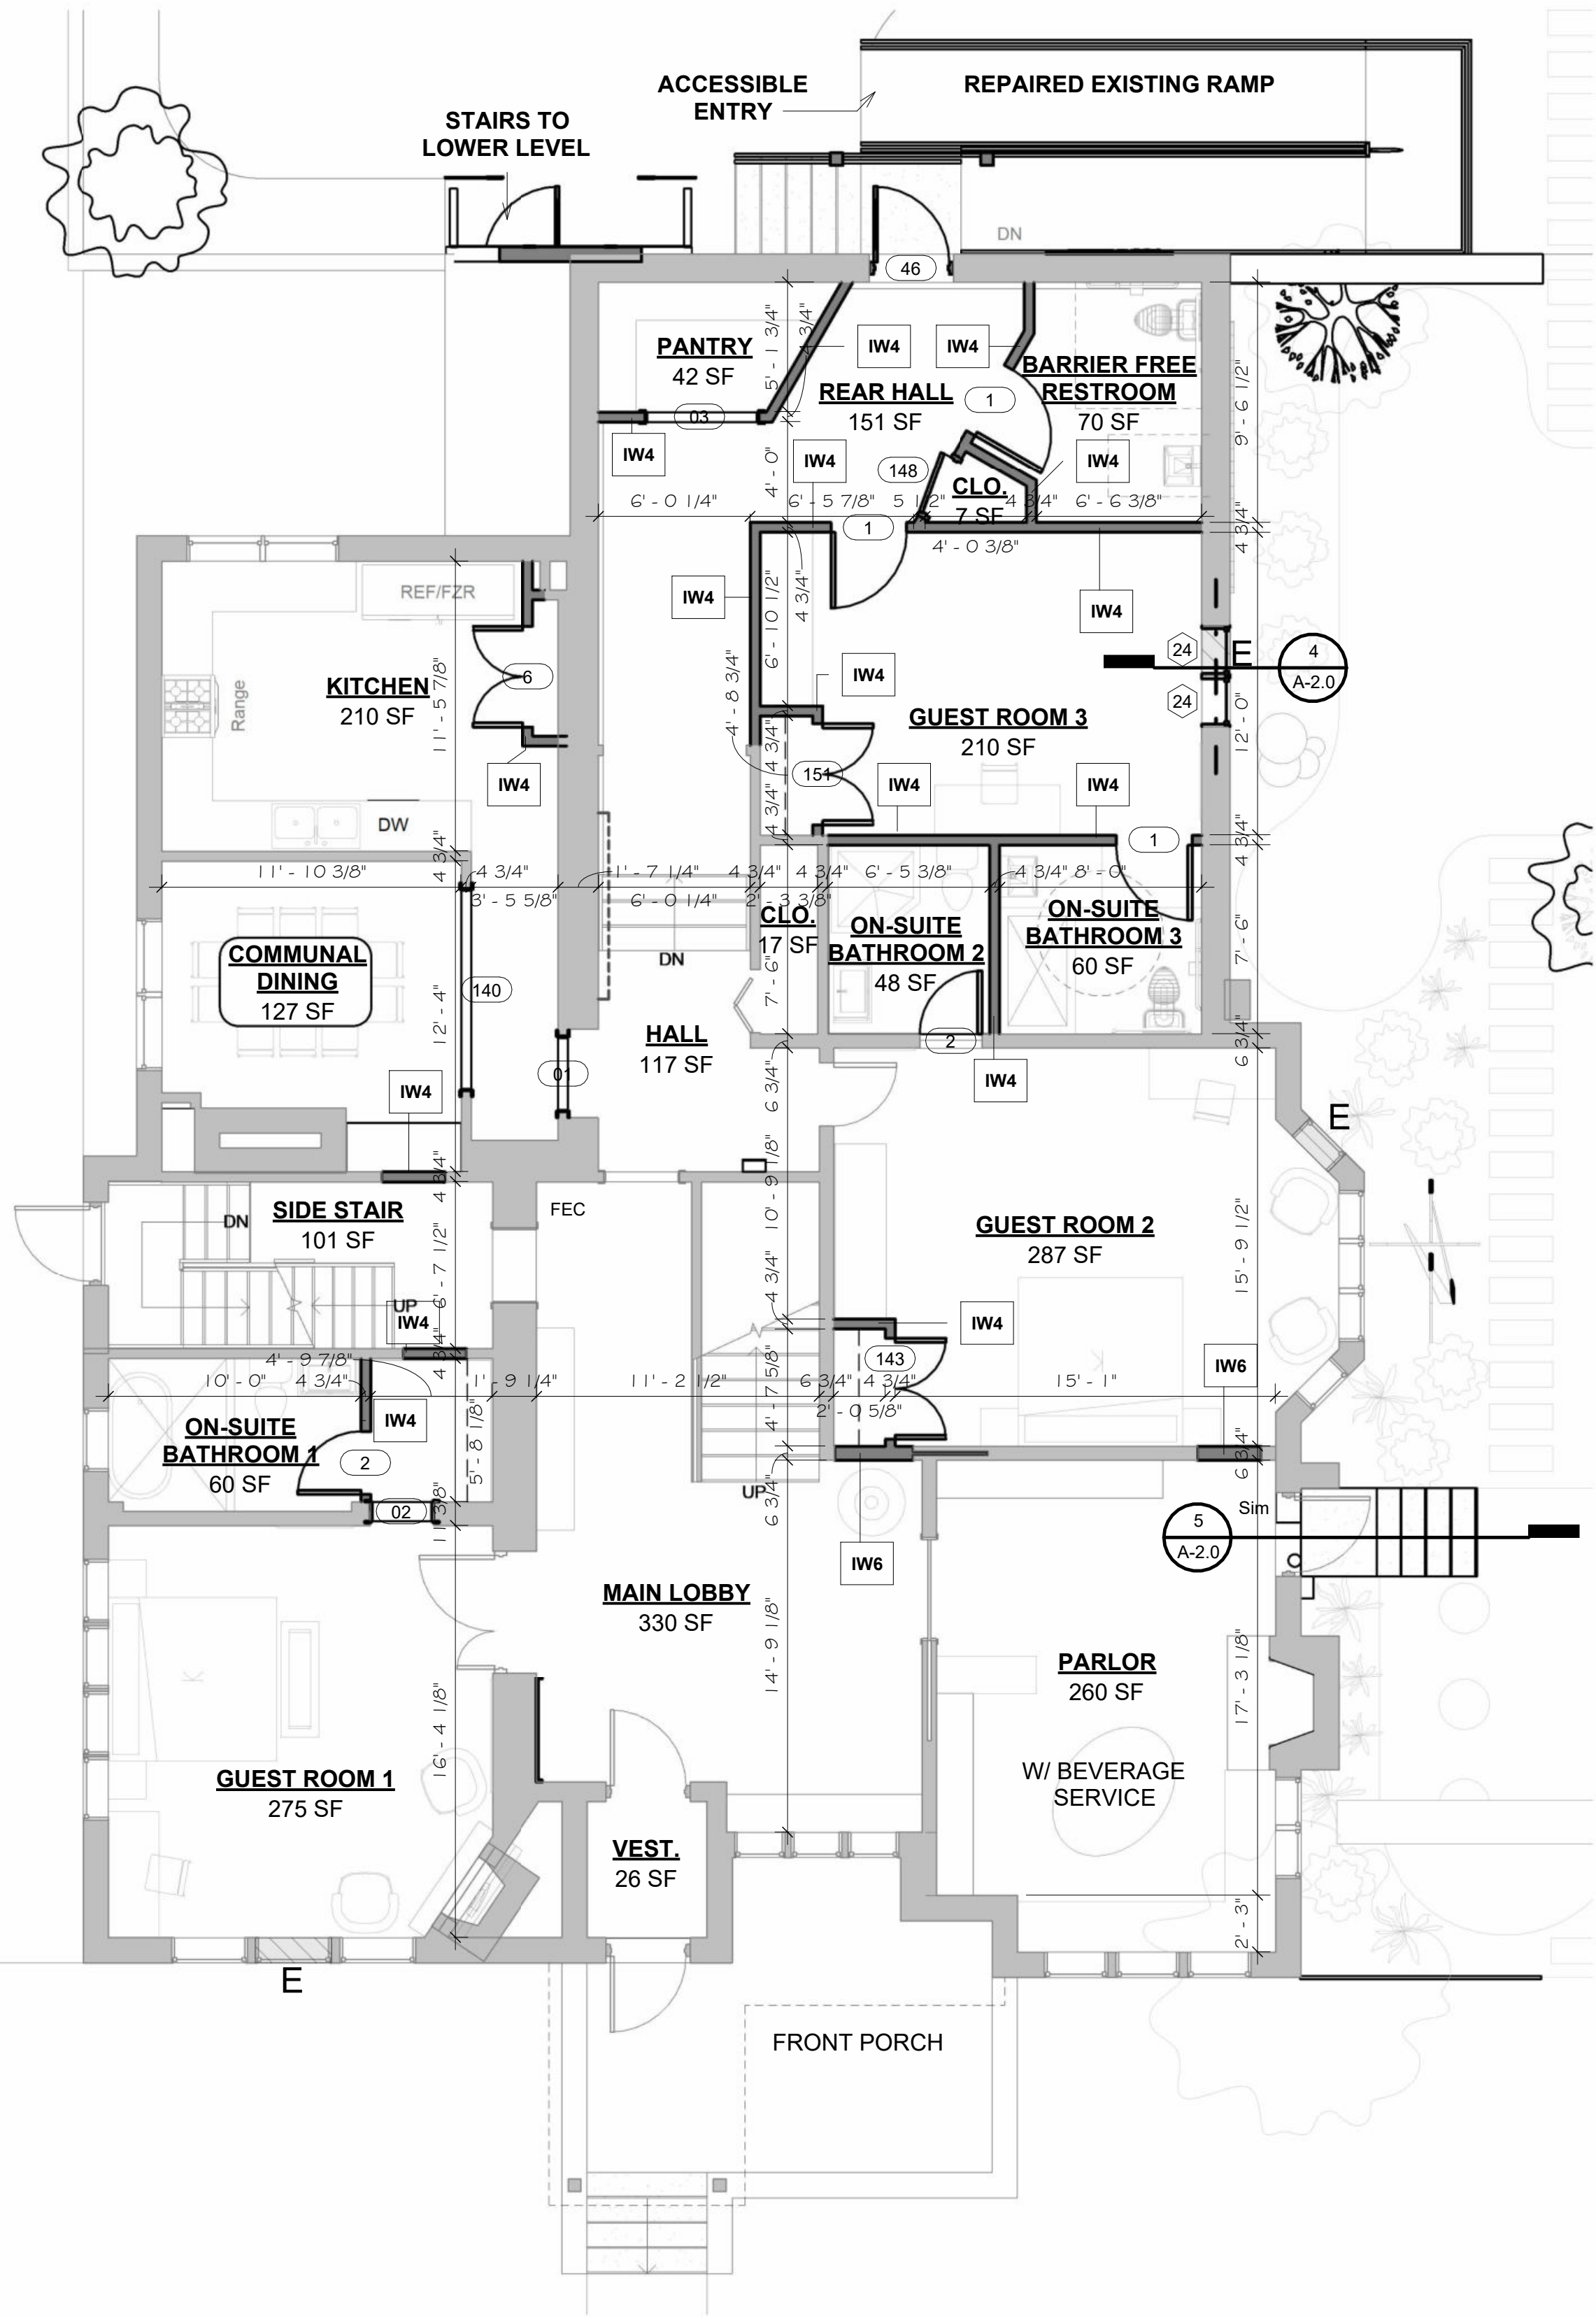


1 FIRST FLOOR - PROPOSED
3/16" = 1'-0"

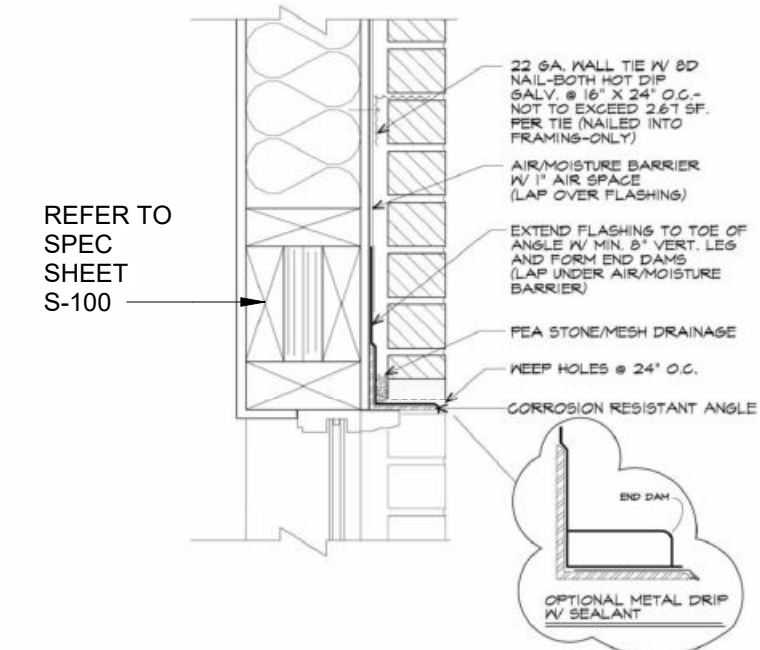

4 HEAD DETAIL
1" = 1'-0"

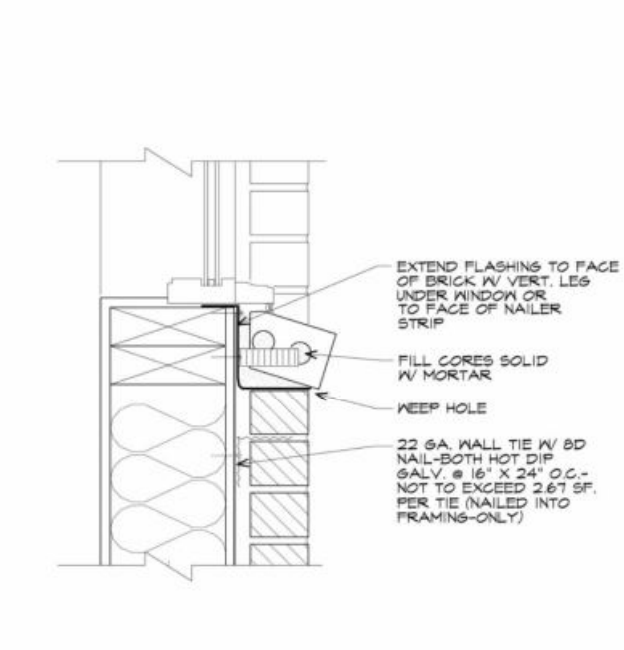

3 WINDOW SILL DETAIL
1" = 1'-0"

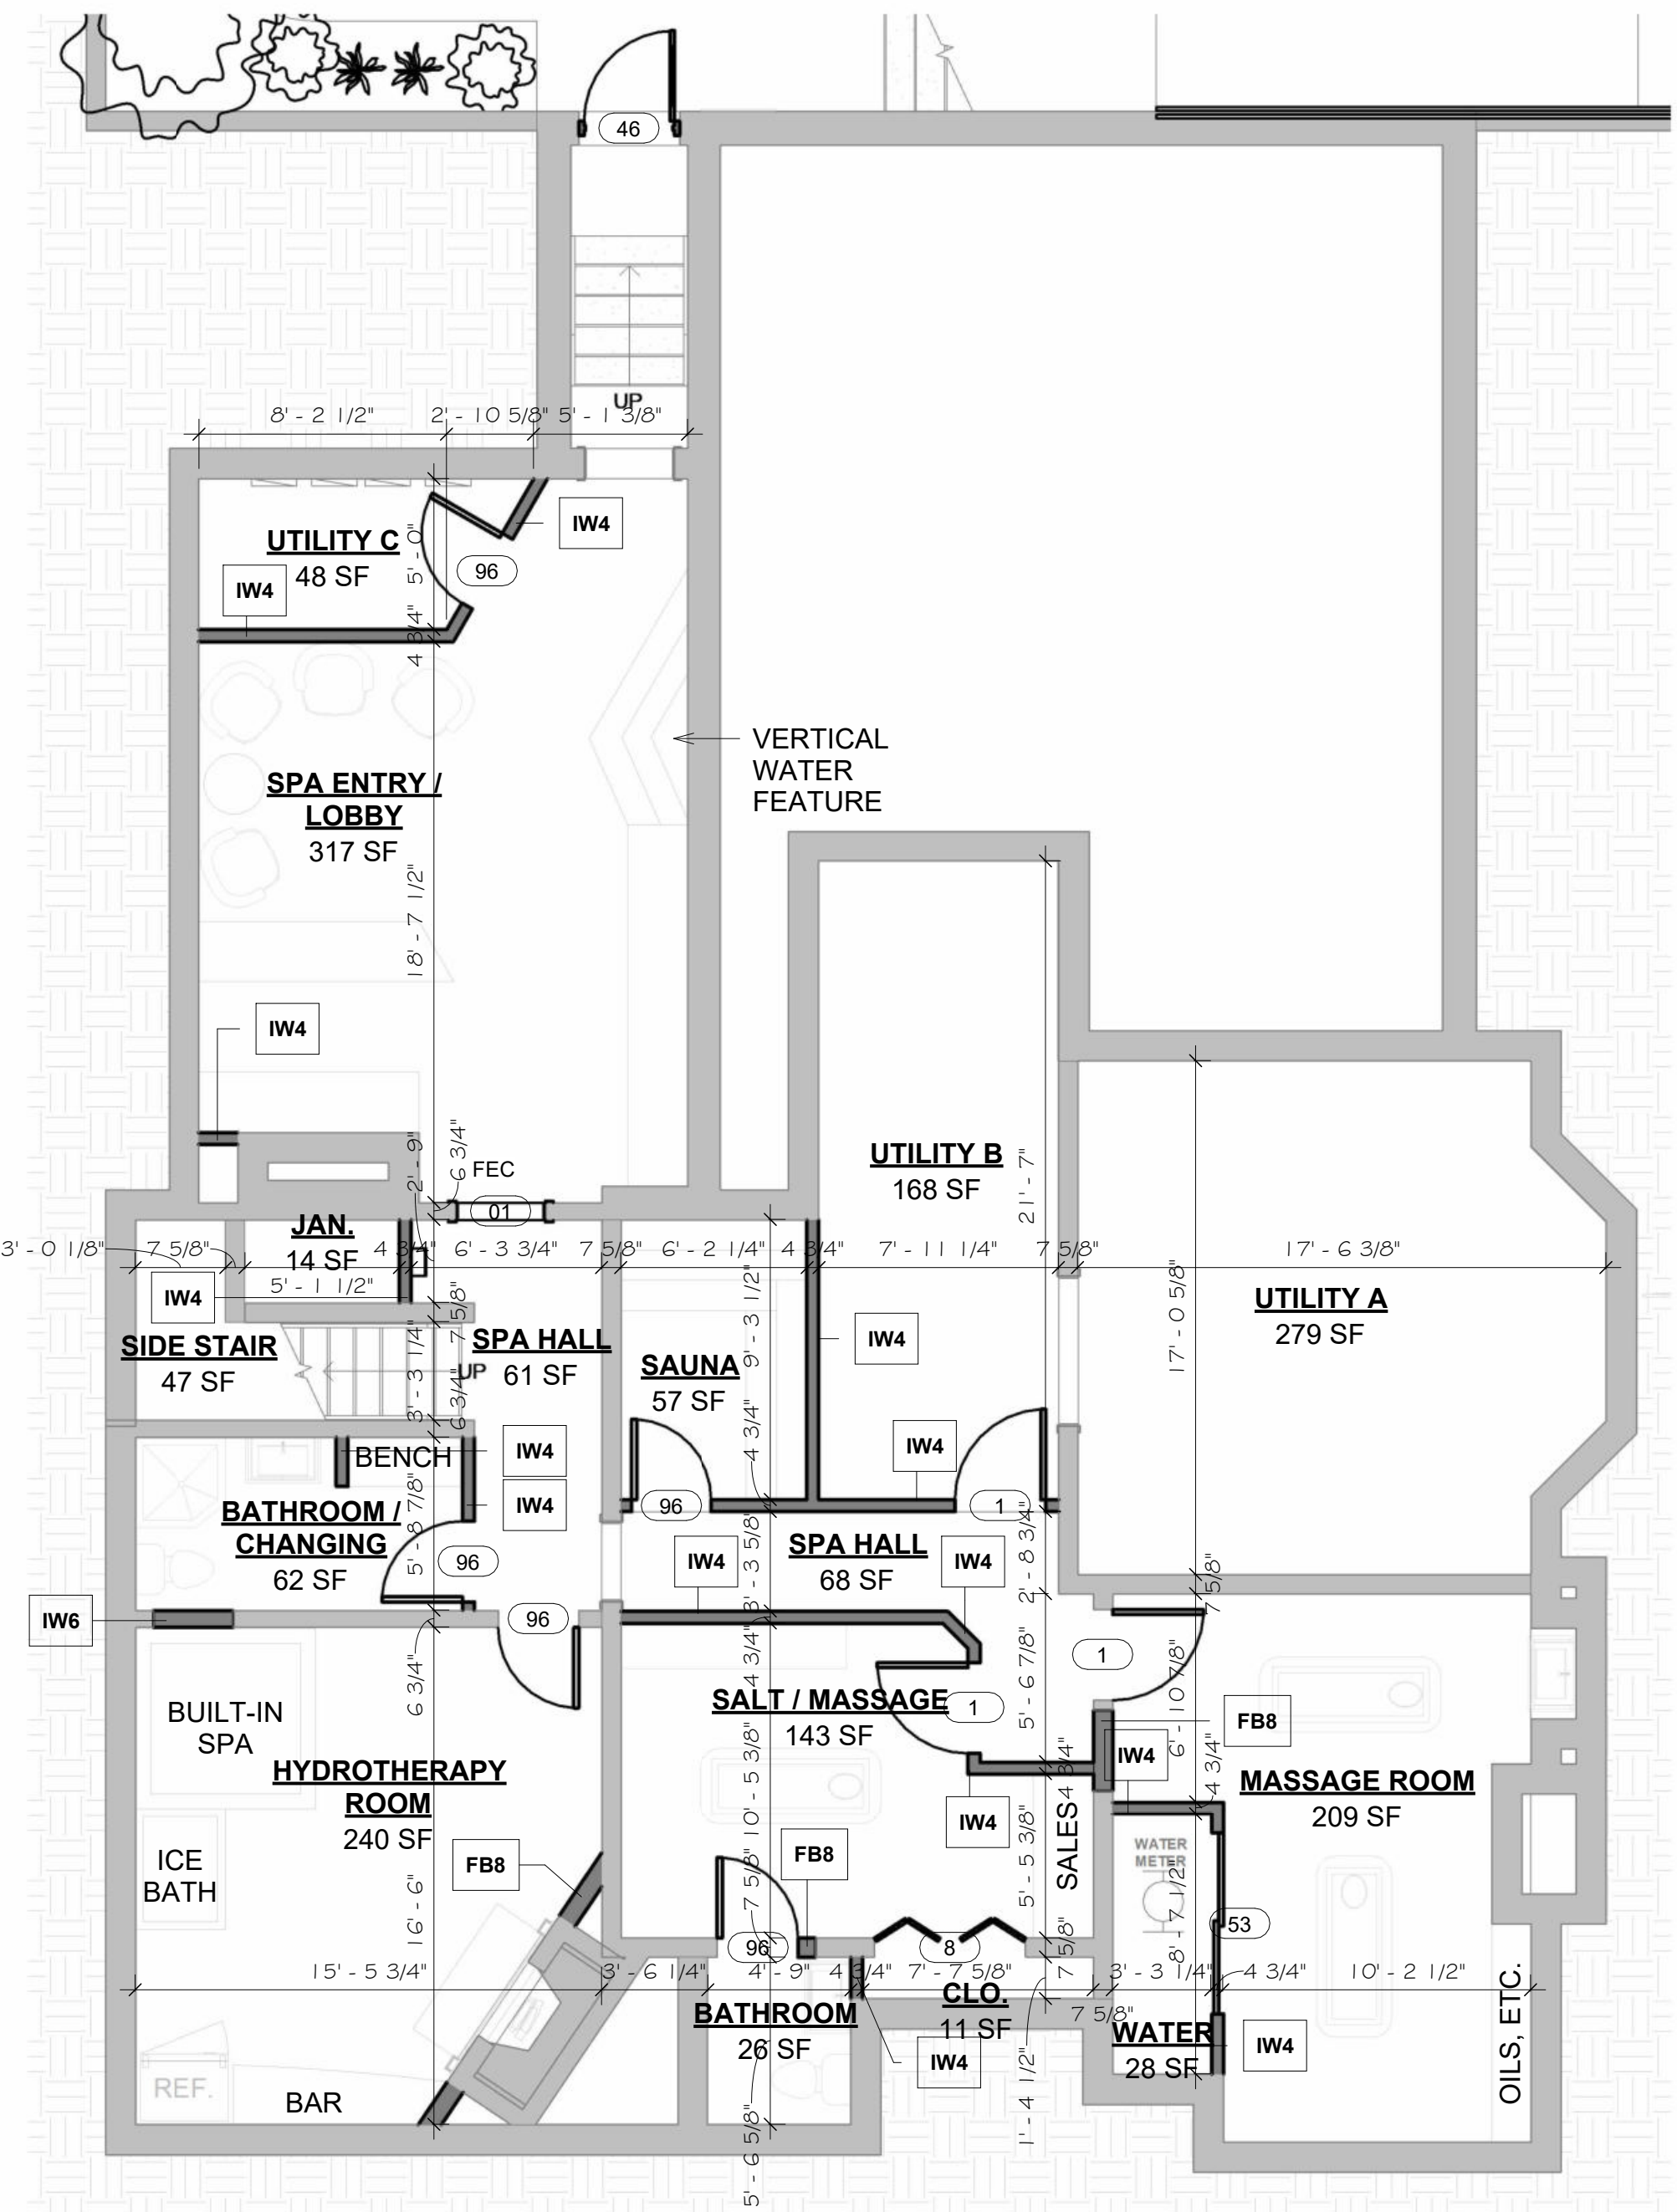

A.	PROVIDE FLASHING AT ALL WINDOW HEAD, JAMB AND SILL CONDITIONS.
B.	FIXED GLASS SIZES ARE SHOWN FOR REFERENCE ONLY. GLAZING CONTRACTOR SHALL FIELD MEASURE ALL OPENINGS PRIOR TO FABRICATION AND PROVIDE SEPARATE SHOP SUBMITTAL FOR ALL OPENINGS.
C.	PROVIDE APPROPRIATE SAFETY GLASS FOR ALL HAZARDOUS LOCATIONS IN ACCORDANCE WITH CURRENT BUILDING CODES INCLUDING ALL DOORS. GLAZED AREAS IN EXCESS OF 9'-0" FT., WITHIN 9' OF TUBS AND GLAZING WITHIN 18" OF WALKING/SITTING SURFACES.
D.	PROVIDE FOR EGRESS OPENINGS WHERE CODE REQUIRES

A.	ALL DOORS AND HARDWARE SHALL COMPLY WITH APPLICABLE CODES, INCLUDING ADA-AG & MSBC BARRIER FREE SUBCODES AND SHALL BE CAPABLE OF OPERATION WITH THE USE OF (1) HAND
B.	ALL HOLLOW METAL DOOR FRAMES ARE TO BE 16 GAUGE KNOCK DOWN TYPE
C.	ALL FRAMES ARE TO RECEIVE THREE DOOR SILENCERS
D.	CONTRACTOR SHALL SUBMIT SHOP DRAWINGS AND PRODUCT INFO (FOR REVIEW) FOR ALL DOORS, FRAMES AND HARDWARE
E.	CONTRACTOR SHALL PROVIDE ALL MISC. HARDWARE REQ'D. FOR COMPLETE OPERATION OF EACH DOOR.
F.	ALL EXTERIOR DOORS TO HAVE SELF-CLOSING HARDWARE, THRESHOLDS, AND WEATHER STRIPPING.
G.	DOOR THRESHOLDS SHALL NOT EXCEED ON-HALF INCH (1/2") IN HEIGHT. THRESHOLDS EXCEEDING ONE-QUARTER INCH (1/4") IN HEIGHT SHALL HAVE A 1:2 BEVEL.
H.	ALL LOCKS ARE TO BE KEYED PER THE REQUIREMENTS OF THE OWNER
I.	ALL HINGES BRUSHED ALUM. & BALL BRG.
J.	ALL DOORS TO BE SUPPLIED & INSTALLED WITH DOOR STOPS WITH SOLID BLOCKING FOR EACH LOCATION
K.	ALL GLASS IN DOORS MUST BE TEMPERED AS PER CODE
L.	STOREFRONT ENTRANCE DOORS TO BE KAWNEER OR EQUAL WITH FRAMING SYSTEM AS INDICATED ON SCHEDULE WITH CLOSERS, LOCK ASSEMBLIES, AND ALL OTHER HARDWARE REQUIRED FOR A COMPLETE INSTALLATION. COLOR TO BE SELECTED BY ARCHITECT.
M.	ALL EXTERIOR METAL DOORS SHALL BE INSULATED
N.	VERIFY ALL DOOR OPTIONS, INCLUDING HANDING, TYPE AND HARDWARE W/ OWNER SELECTIONS. PROVIDE BUMPERS/STOPS WHERE REQ'D

DOOR NOTES (U.N.O.):

1. ALL DOORS AND HARDWARE SHALL COMPLY WITH APPLICABLE CODES, INCLUDING ADA-AG&MSBC BARRIER FREE SUBCODES AND SHALL BE CAPABLE OF OPERATION WITH THE USE OF (1) HAND.
2. ALL HOLLOW METAL DOOR FRAMES ARE TO BE 16 GAUGE KNOCK DOWN TYPE.
3. ALL FRAMES ARE TO RECEIVE THREE DOOR SILENERS
4. CONTRACTOR SHALL SUBMIT SHOP DRAWING'S & CATALOG CUTS (FOR REVIEW) FOR ALL DOORS, FRAMES AND HARDWARE.
5. CONTRACTOR SHALL PROVIDE ALL MISC. HARDWARE REQ'D. FOR COMPLETE OPERATION OF EACH DOOR.
6. ALL EXTERIOR DOORS TO HAVE SELF-CLOSING HARDWARE; THRESHOLDS AND WEATHER STRIPPING.
7. DOOR THRESHOLDS SHALL NOT EXCEED ONE-HALF INCH (1/2") IN HEIGHT. THRESHOLDS EXCEEDING ONE-QUARTER INCH (1/4") IN HEIGHT SHALL HAVE A 1-2 BEVEL.
8. ALL LOCKS ARE TO BE KEYPED PER THE REQUIREMENTS OF THE OWNER.
9. ALL HINGES BRUSHED ALUM. & BALL BRG.
10. ALL DOORS TO BE SUPPLIED & INSTALLED WITH DOOR STOPS WITH SOLID BLOCKING FOR EACH LOCATION.
11. ALL GLASS IN DOORS MUST BE TEMPERED AS PER CODE
12. STOREFRONT ENTRANCE DOORS TO BE KAWNEER OR EQUAL WITH FRAMING SYSTEM AS INDICATED ON SCHEDULE WITH CLOSERS, LOCK ASSEMBLIES, AND ALL OTHER HARDWARE REQUIRED FOR A COMPLETE INSTALLATION.
13. ALL EXTERIOR METAL DOORS SHALL BE INSULATED.
14. VER. ALL DOOR OPTIONS; INCLUDING HANDING, TYPE AND HARDWARE W/ OWNER SELECTIONS. PROVIDE BUMPERS/STOPS WHERE REQ'D

HARDWARE NOTES:

1. LOCK AND LATCH SETS TO BE 'YALE' SERIES WITH LEVER HANDLE AND SATIN CHROME FINISH (U.N.O.)
2. ALL DOORS TO RECEIVES 'IVES' OR APPROVED EQUAL DOME FLOOR STOP OR CONVEX WALL STOP ANSI 156.16. ALL DOORS TO HAVE APPROPRIATE DOOR STOPS.
3. PANIC HARDWARE SHALL CONSIST OF PANIC BAR (HORIZONTAL BAR) AND LATCHING DEVICE WITH PROPER LATCH BOLT LENGTH, STEEL BALL BEARING HINGES AND CLOSER.
4. PROVIDE PANIC HARDWARE ON ALL EXTERIOR DOORS. IT IS 'YALE' MANUFACTURER OR APPROVED EQUAL
5. PANIC HARDWARE SHALL HAVE THE ACTIVATING MEMBER MOUNTED AT A HEIGHT OF NOT LESS THAN 30 INCHES & 44 INCHES A.F.F.
6. DOOR CLOSERS SHALL MEET OPENING FORCE AND SWEEP PERIOD REQUIREMENTS.
7. VERIFY ALL HARDWARE FINISHES AND LOCK REQUIREMENTS WITH OWNER - DOOR SUPPLIER TO PROVIDE SUBMITTAL FOR ARCHITECT APPROVAL.

ABBREVIATIONS:

AL/GL	-	GLASS IN ALUM. FRAME
SC/D	-	SOLID CORE WOOD
ANOD.	-	ANODIZED
STL	-	STEEL
STD.	-	STAIN
PTD.	-	FACTORY FINISH PAINT
H.M./R.F.	-	HOLLOW METAL / READY FRAME
H.M.	-	HOLLOW METAL
WD/GL	-	GLASS IN WOOD FRAME
STVN	-	FACTORY FINISH STAINED VENEER
BRZ. PT.	-	BRONZE PAINT

WINDOWS, GLAZING AND DOORS:

1. WINDOW SIZES AND OPERABILITY ARE SHOWN FOR REFERENCE ONLY.
2. WINDOW SUPPLIER SHALL CONFIRM ALL SIZES AND CONFIGURATIONS WITH OWNER PRIOR TO ORDER.
3. GLAZING CONTRACTOR SHALL FIELD MEASURE ALL OPENINGS.

EXISTING HISTORIC WINDOW OPENINGS TO BE VERIFIED FOR COMPLIANCE WITH EGRESS REQUIREMENTS. WHERE NECESSARY, HISTORIC REPLICA CASEMENT WINDOWS TO BE PROVIDED THAT MEET MINIMUM EGRESS REQUIREMENTS.

THE HISTORIC EGRESS NOTE



1 SECOND FLOOR - PROPOSED
A-3.0
3/16" = 1'-0"



EX. SIDE (WEST)



EX. REAR (NORTH)




EX. SIDE (EAST)



EX. FRONT (SOUTH)




HISTORIC PHOTO

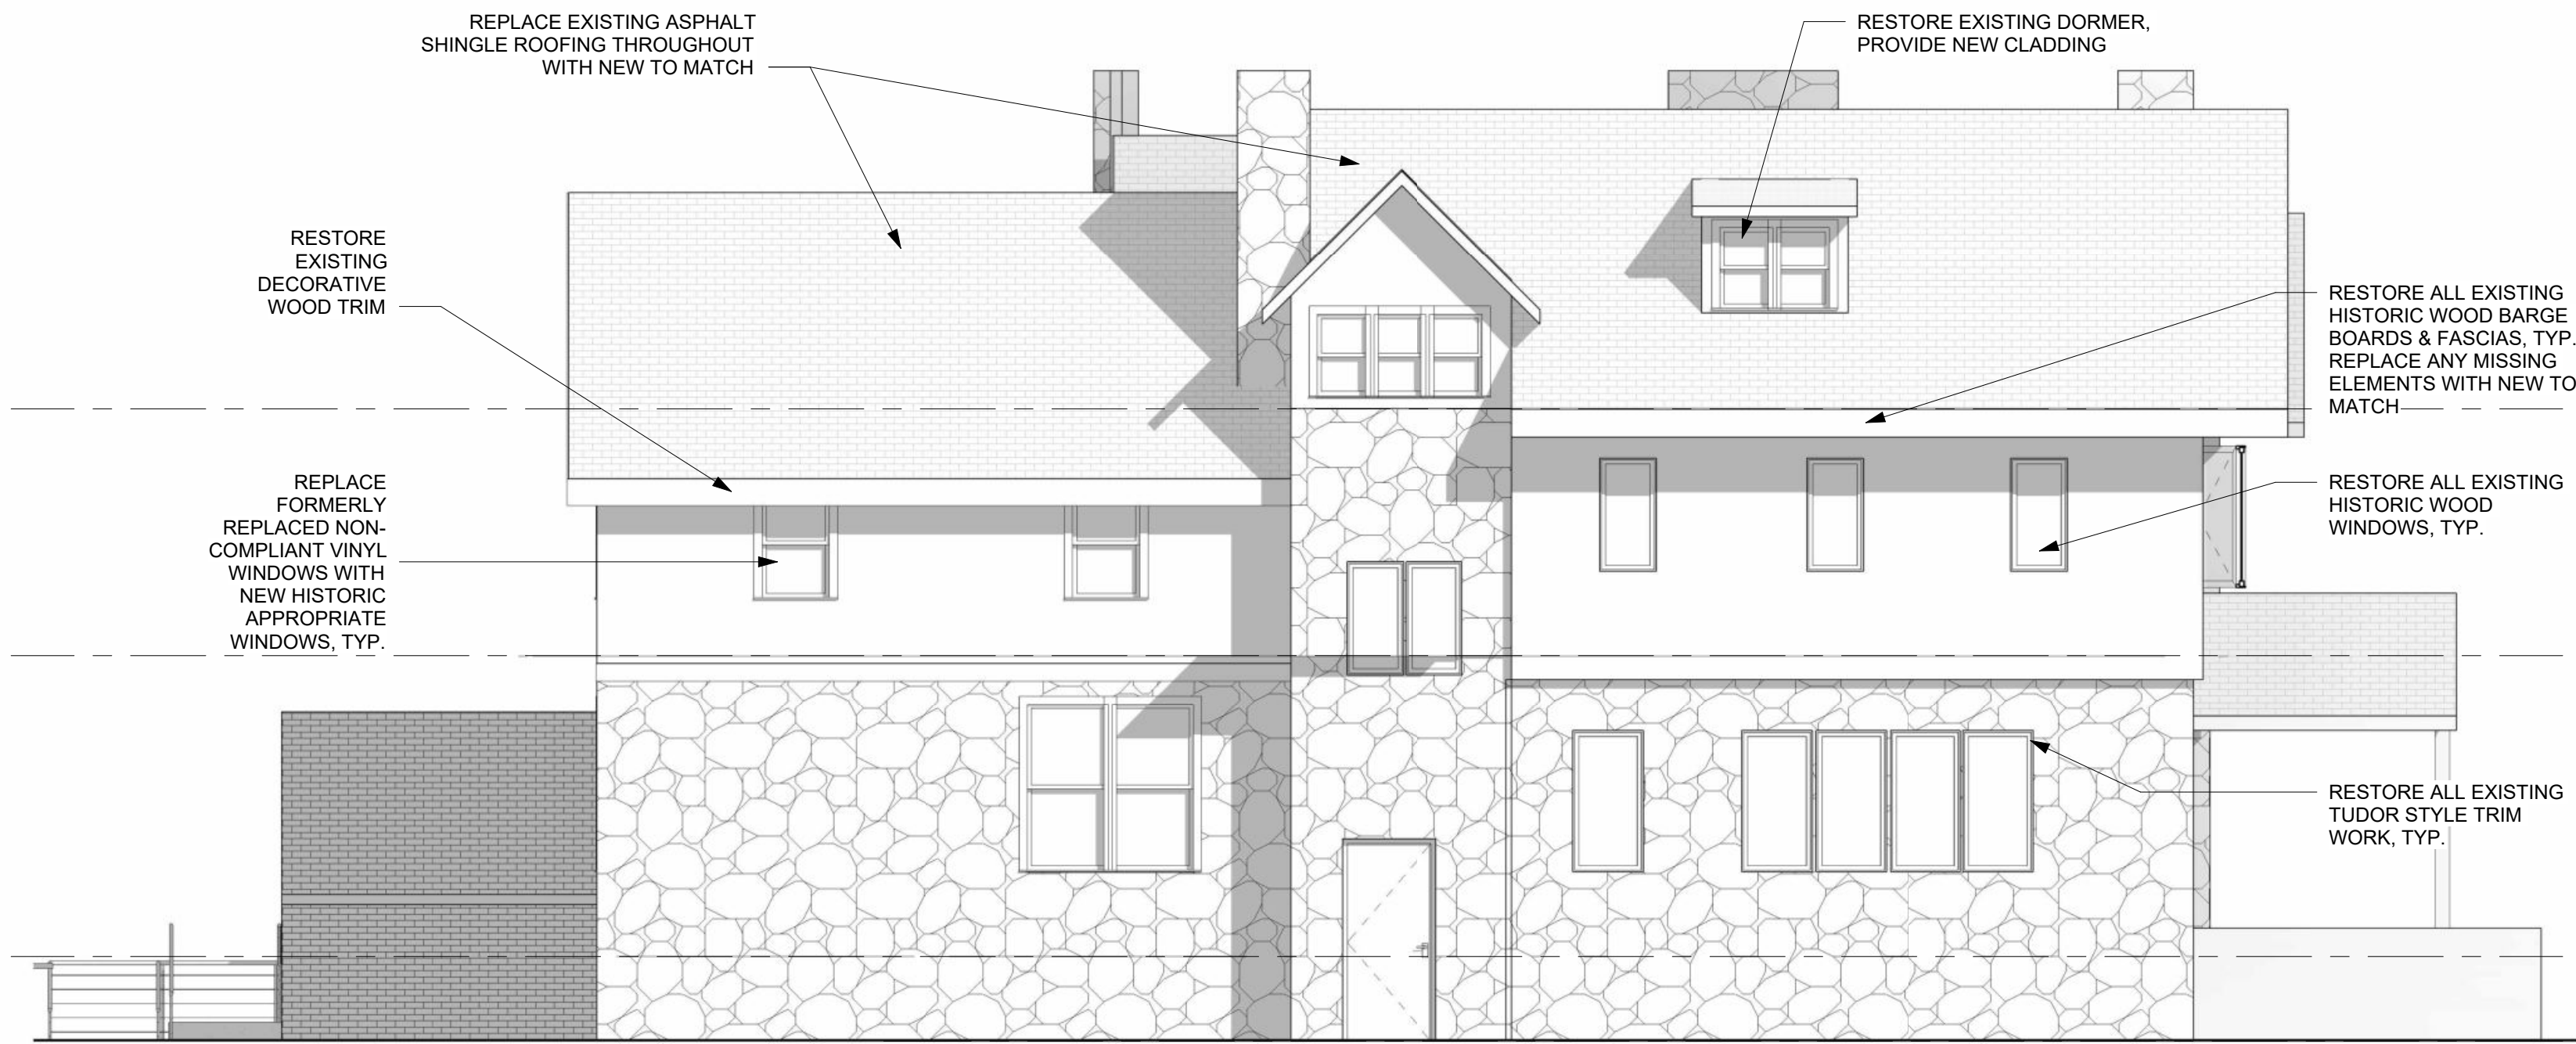


4 WEST ELEVATION - PROPOSED
3/16" = 1'-0"



3 NORTH ELEVATION - PROPOSED
3/16" = 1'-0"

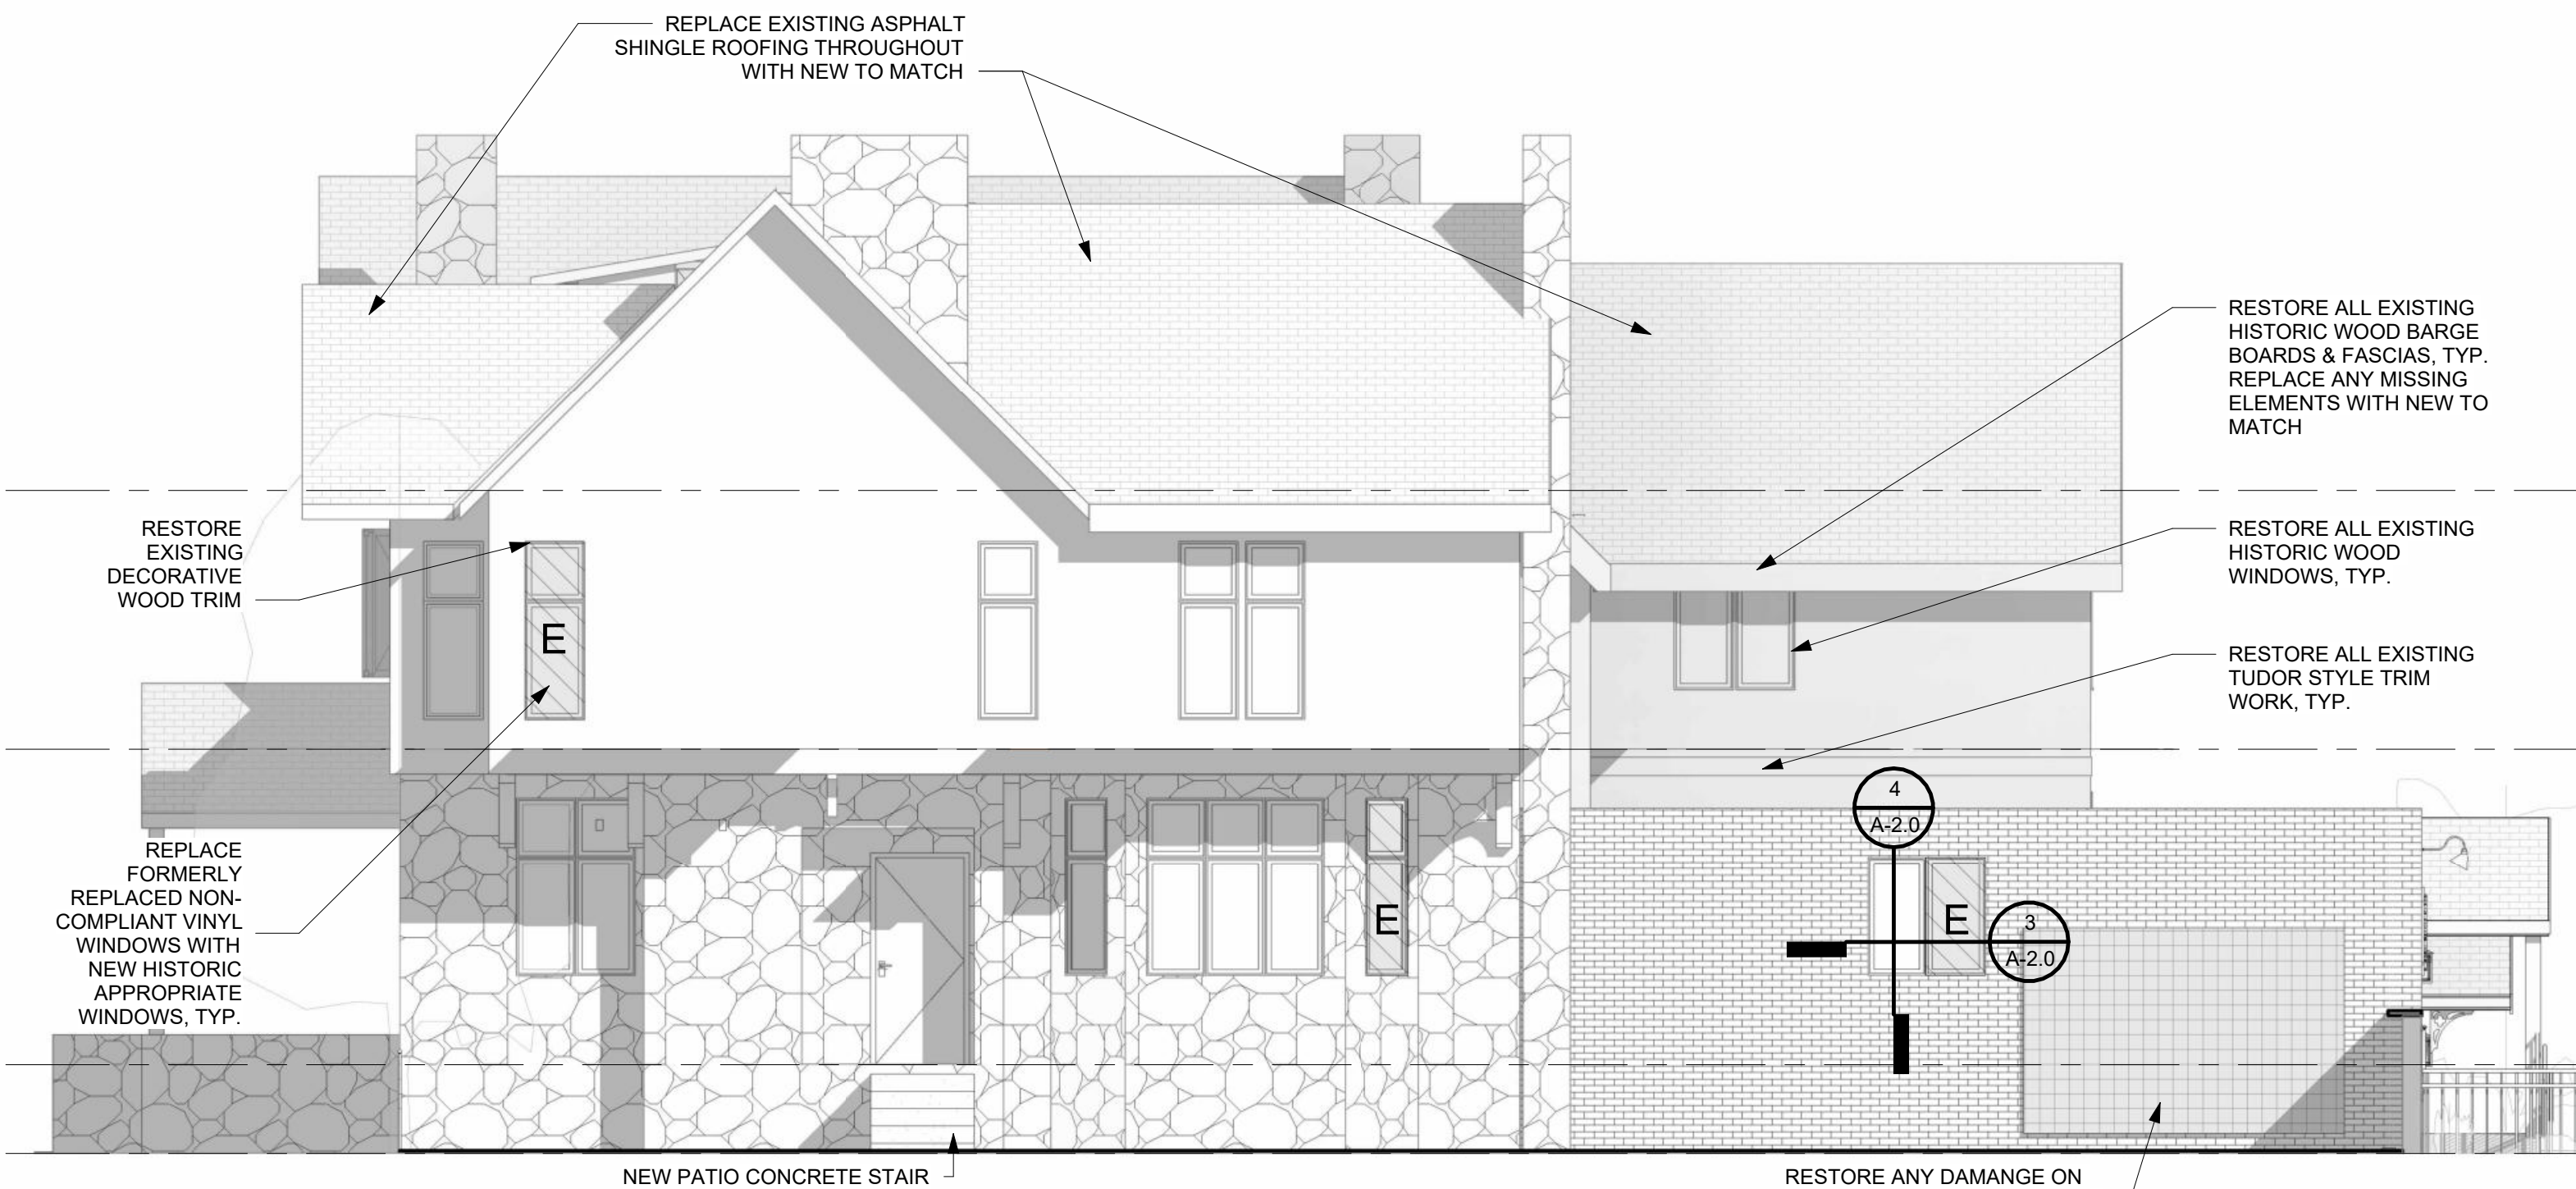

2 EAST ELEVATION - PROPOSED
3/16" = 1'-0"

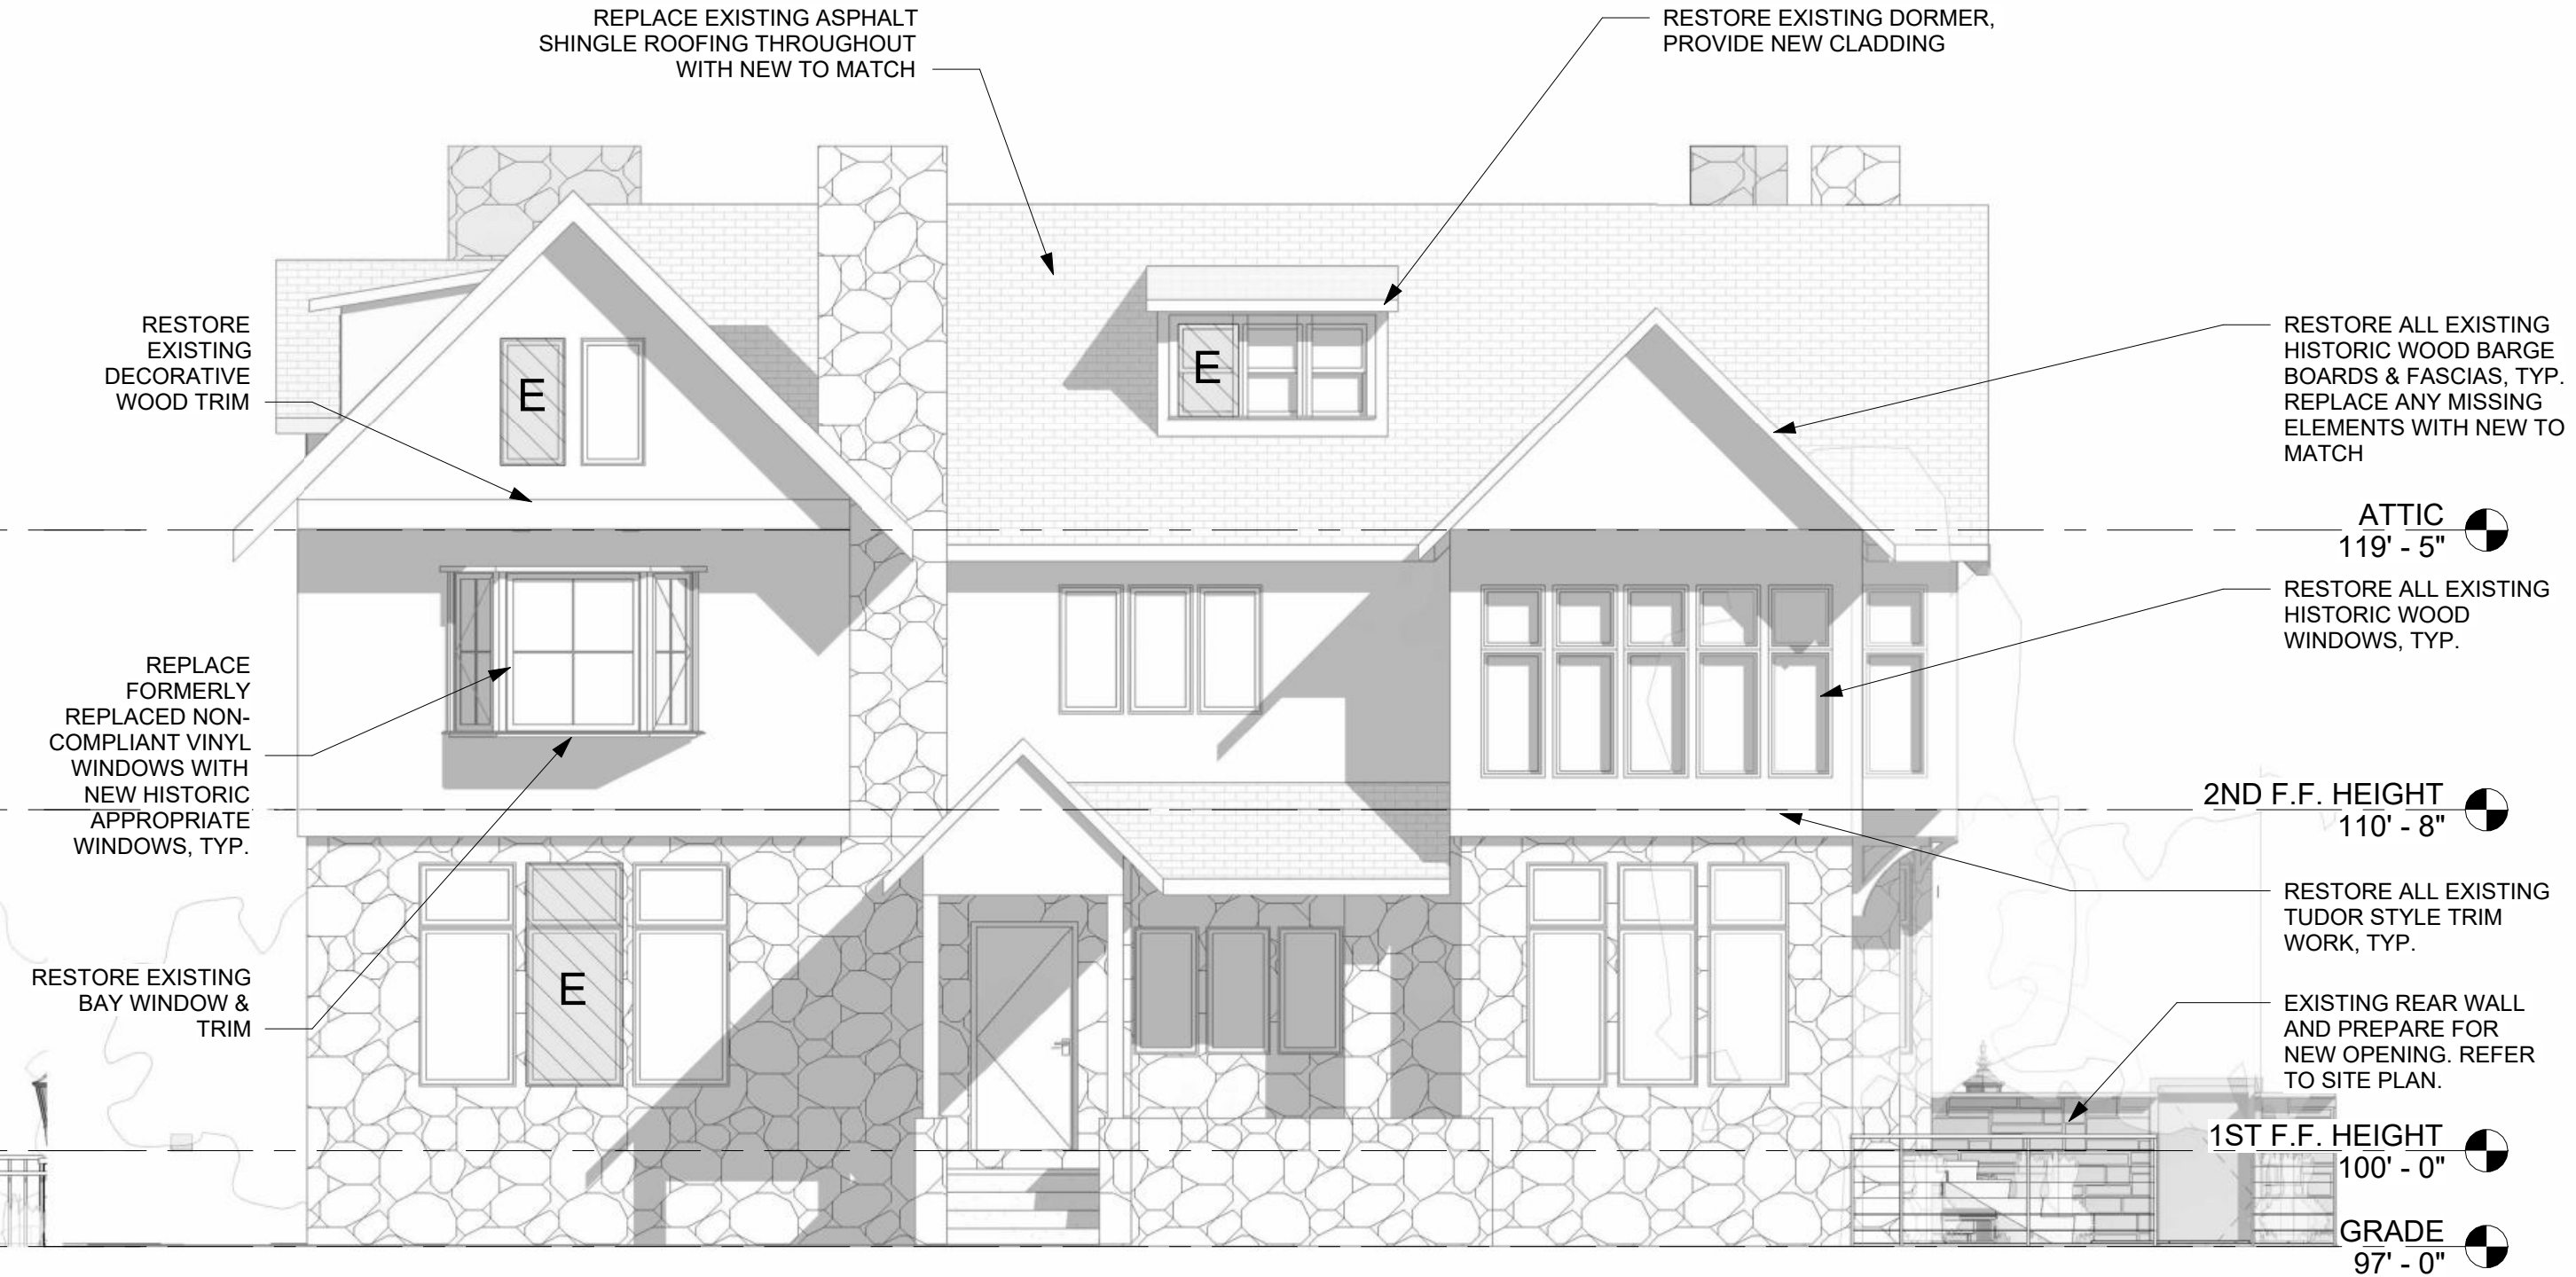

1 SOUTH ELEVATION - PROPOSED
3/16" = 1'-0"

Unauthorized use of this drawing set without written permission from VIRTUOSO DESIGN + BUILD and infuz Ltd is in violation of U.S. COPYRIGHT LAWS and will be subject to civil damages and prosecution.

Revision Schedule		
#	Description	Date
1	Commercial Set	03/13/2025

NOT FOR CONSTRUCTION

BERKERY ESTATE
PROJECT NUMBER: Z24075
8325 E. JEFFERSON AVE
DETROIT, MI 48214
NIAL & MELVIE BERKERY
SHEET TITLE
PROPOSED EXTERIOR ELEVATIONS

SHEET NUMBER
A-3.0

CONSOLIDATE POWER LINES IF POSSIBLE

REPLACE / RELOCATE LIGHTING

REMOVE AWNINGS

RELOCATE PANEL

RECONSTRUCT/REPAIR EXISTING STAIR, RAMP, & RAILINGS

NEW PAVING



EXISTING NORTH ELEVATION (REAR)



1 NORTH ELEVATION - PROPOSED
3/16" = 1'-0"



RENDERING (OPT 1)



RENDERING (OPT 2 - MANSARD ROOF)

Unauthorized use of this drawing set without written permission from VIRTUOSO DESIGN + BUILD and infuz Ltd is in violation of U.S. COPYRIGHT LAWS and will be subject to civil damages and prosecution.

Revision Schedule		
#	Description	Date
1	Commercial Set	03/13/2025

SEAL
NOT FOR CONSTRUCTION
03/13/2025

BERKERY ESTATE
PROJECT NUMBER: Z24075
8325 E. JEFFERSON AVE
DETROIT, MI 48214
SHEET TITLE
**NIAL & MELVIE BERKERY
REAR ELEVATION UPDATES**

GENERAL ELECTRICAL NOTES:

- A. CONTRACTOR SHALL FURNISH ALL MATERIALS AND LABOR AS INDICATED ON THE PLANS AND AS REQUIRED FOR A COMPLETE WORK LIGHTING AND POWER SYSTEM.
- B. ALL WORKMANSHIP, MATERIALS AND METHODS OF INSTALLATION SHALL BE GOVERNED BY THE REQUIREMENTS OF THESE SPECIFICATIONS, THE NATIONAL ELECTRICAL CODE, LATEST REVISION, LOCAL CODES, BARRIER FREE CODES, AND OSHA.
- C. EXERCISE CARE IN INSTALLING SUPPORTS TO MAINTAIN STRUCTURAL DESIGNED QUALITY. ALLOW FOR EXPANSION MOVEMENTS AS REQUIRED IN ALL SUPPORTS, CABLES AND CONDUIT.
- D. VERIFY WALL SWITCH AND POWER OUTLETS LOCATIONS WITH OWNER AND LOCAL GOVERNING ENFORCEMENT OFFICIAL. WHERE NOT SPECIFIED ALL SWITCHES SHALL BE LOCATED 48" ABOVE FINISHED FLOOR TO CENTERLINE. CONVENIENCE RECEPTACLES SHALL BE LOCATED 18" ABOVE FINISHED FLOOR TO BOTTOM OF BOX, EXCEPT WHERE INDICATED ON PLANS TO BE OTHERWISE. ALL WALL SWITCH OUTLETS SHALL BE INSTALLED ON THE LOCK SIDE OF THE DOOR IMMEDIATELY ADJACENT TO DOOR FRAME. VERIFY DOOR SWINGS WITH GENERAL CONTRACTOR PRIOR TO ROUGH-IN WORK. WHERE GLASS PARTITIONS OR OTHER ARCHITECTURAL FEATURES PREVENT SUCH LOCATIONS, SWITCHES SHALL BE LOCATED IN HOLLOW METAL DOOR FRAMES.
- E. ALL RECEPTACLES LOCATIONS SHALL BE IN ACCORDANCE WITH THE LAYOUT SHOWN EXCEPTED AS OTHERWISE NOTED OR AS OTHERWISE REQUIRED BY CODES AND/OR AGENCIES HAVING JURISDICTION. ALL OUTLETS SHALL BE OF ADEQUATE SIZE AND TYPE AS REQUIRED FOR THE PARTICULAR LOCATION AND SERVICE INTENDED. RECEPTACLES SHALL NOT BE RATED LESS THAN 20 AMPS AND SHOULD BE LABELED ON THE INSIDE OF EACH FACE PLATE WITH PANEL AND CIRCUIT NUMBER DESIGNATION. CHECK ALL RECEPTACLE CIRCUITS FOR CONTINUITY AFTER COMPLETION.
- F. ALL WIRING SHALL BE RUN IN ELECTRICAL RACEWAY AS REQUIRED PER APPLICABLE CODES.
- G. VERIFY OWNER'S DESIRE FOR DIMMING AND OTHER CONTROLS SUCH AS PHOTO-SENSORS, TIMERS, ETC. THE DRAWINGS SHOW THE GENERAL ARRANGEMENT, DESIGN AND EXTENT OF THE WORK ENUMERATED ABOVE AND ARE PARTLY DIAGRAMMATIC. THE DRAWINGS ARE NOT INTENDED TO BE SCALED FOR ROUGH-IN MEASUREMENTS, NOT TO SERVE AS SHOP DRAWINGS. CONSULT EQUIPMENT SHOP DRAWINGS FOR CORRECT MEASUREMENTS WHEREVER POSSIBLE.
- I. THE ELECTRICAL SUB-CONTRACTOR SHALL BE RESPONSIBLE FOR THE CORRECT FIT OF THE WORK INSTALLED AND SHALL TAKE FIELD MEASUREMENTS NECESSARY FOR ORDERING MATERIALS AND FITTING THE INSTALLATION TO THE BUILDING CONSTRUCTION AND ARRANGEMENT.
- J. ELECTRICAL WORK SHALL BE COORDINATED WITH OTHER TRADES. CONSULT THE PLANS COVERING WORK FOR OTHER TRADES. THE FIELD LAYOUTS OF THE CONTRACTORS FOR THESE TRADES, AND THEIR SHOP DRAWINGS, THE CONTRACTOR SHALL BE AWARE AND RESPONSIBLE IN LAYING OUT THE ELECTRICAL WORK.
- K. CUTTING, CORE DRILLING, INSERTS AND CONDUIT OR CABLE SLEEVES AND PATCHING REQUIRED IN THE GENERAL CONSTRUCTION FOR THE COMPLETION OF THE WORK, SPECIFIED HEREIN, SHALL BE FURNISHED AND INSTALLED BY THE ELECTRICAL CONTRACTOR.
- L. STANDARD PLACEMENT HEIGHTS FOR FLOOR AND COUNTERTOP LEVEL OUTLETS SHALL BE PLACED 15" AND 46" A.F.F. RESPECTIVELY.

STANDARDS OF MATERIALS AND WORKMANSHIP

ALL MATERIALS SHALL BE NEW. THE ELECTRICAL AND PHYSICAL PROPERTIES OF ALL MATERIALS, AND THE DESIGN, PERFORMANCE CHARACTERISTICS AND METHODS OF CONSTRUCTION OF ALL ITEMS OF EQUIPMENT, SHALL BE IN ACCORDANCE WITH THE LATEST ISSUE OF THE VARIOUS APPLICABLE STANDARD SPECIFICATIONS OF THE FOLLOWING RECOGNIZED AUTHORITIES:

N.E.C. -	NATIONAL ELECTRICAL CODE
A.N.S.I. -	AMERICAN NATIONAL STANDARDS INSTITUTE
I.E.E.E. -	INSTITUTE OF ELECTRICAL ELECTRONICS ENGINEERS
A.S.T.M. -	AMERICAN SOCIETY FOR TESTING MATERIALS
I.P.C.E.A. -	INSULATED POWER CABLE ENGINEERS ASSOCIATION
N.E.M.A. -	NATIONAL ELECTRICAL MANUFACTURER'S ASSOCIATION
U.L. -	UNDERWRITERS' LABORATORIES, INC.

- A. ALL WORK SHALL BE PERFORMED IN FIRST CLASS AND WORKMANLIKE MANNER, IN ACCORDANCE WITH THE LATEST ACCEPTED STANDARDS AND PRACTICES FOR THE TRADES INVOLVED. NONE BUT EXPERIENCED PERSONS IN THE WORK TO BE PERFORMED SHALL BE ALLOWED TO DO THE WORK. THIS APPLIES PARTICULARLY TO ITEMS SUCH AS CABLE SPLICING, CONTROL WORK, SYSTEMS CONNECTION, ETC.

CONDUIT

- A. CONDUIT SHALL BE EMT, PVC OR RIGID GALVANIZED STEEL. ALL CONDUIT INSTALLED UNDERGROUND SHALL BE PVC SCHEDULE 40 OR RIGID GALVANIZED STEEL AS NOTED. CONDUIT INSTALLED IN FINISHED AREAS SHALL BE CONCEALED.
- B. PROVIDE CONDUIT SLEEVES WHERE CONDUITS PASS THRU FLOORS, WALLS, ETC. ALL VOIDS BETWEEN SLEEVES AND HOLES AND CONDUITS PASSING THRU SHALL BE FIRESTOPPED. SPECSEAL 100 FIRE STOP SEALANT OR APPROVED EQUAL.

GROUNDING

- A. ALL METAL NON-CURRENT CARRYING PARTS OF ELECTRICAL EQUIPMENT, ENCLOSURES, BASES, FRAMES, LIGHTING FIXTURES, WIREWAYS AND SUPPORTS SHALL BE GROUNDED IN ACCORDANCE WITH THE LATEST N.E.C. AND LOCAL CODES.
- B. PROVIDE ANY SPECIAL GROUNDS REQUIRED BY THE LATEST N.E.C., UTILITIES, AND AS RECOMMENDED BY EQUIPMENT MANUFACTURERS.
- C. GROUND SERVICE EQUIPMENT TO BUILDING STEEL, GROUND RODS AND WATER SERVICE AS REQUIRED BY THE LATEST N.E.C.
- D. ALL FEEDER AND BRANCH CIRCUITS SERVING PANELS, LIGHTING, RECEPTACLES, MOTORS, MECHANICAL EQUIPMENT, ETC., INSTALLED IN EMT, MC, PVC OR RIGID GALVANIZED STEEL CONDUIT, SHALL BE INSTALLED WITH AN INSULATED (GREEN) GROUND CONDUCTOR.

EGRESS LIGHTING

- A. APPROVED EXIT SIGNS SHALL BE INSTALLED TO INDICATE THE LOCATION OF THE DESIGNATED MEANS OF EGRESS. ALL EXIT SIGNS SHALL HAVE CONSTANT ILLUMINATION.
- B. EMERGENCY LIGHTING SHALL BE PROVIDED THROUGHOUT THE FACILITY ACCORDING TO THE LATEST IFC/IBC AND NFPA, AS WELL AS CURRENT FIRE CODES. ELECTRICAL CONTRACTOR TO PROVIDE LIGHTING TO MEET FOOTCANDLE REQUIREMENTS.
- C. COMBINATION EXIT AND EMERGENCY LIGHTING UNITS MAY BE USED IN LIEU OF SEPARATE FIXTURES AS LONG AS ALL CODE REQUIREMENTS ARE MET.
- D. THERE SHALL BE CLEAR MARKINGS OF ARROW/CHEVRON INDICATORS TO DISTINGUISH THE DIRECTION OF TRAVEL TO THE PATH OF EGRESS.
- E. ELECTRICAL CONTRACTOR TO VERIFY STYLE AND COLOR OF EXIT FIXTURES WITH OWNER. WHERE ACCEPTABLE, USE BLUE OR GREEN LED GLASS FIXTURES.
- F. EGRESS DOORS SHALL BE READILY OPERABLE FROM THE EGRESS SIDE WITHOUT THE USE OF A KEY OR SPECIAL KNOWLEDGE OR EFFORT.

GENERATOR

- A. VERIFY WITH BUILDING OWNER THE INTENT TO PROVIDE A NATURAL GAS/LP GAS ENGINE GENERATOR SET, IN A WEATHERPROOF SOUND ENCLOSURE, OF THE LATEST COMMERCIAL TYPE AND DESIGN. IN A STAND-BY POWER CAPACITY, IT SHALL BE CAPABLE OF CONTINUOUS SERVICE AND RATED OUTPUT FOR THE DURATION OF ANY UTILITY POWER FAILURE. THE ENGINE GENERATOR MANUFACTURER AND ITS AUTHORIZED DEALER SHALL HAVE SOLE RESPONSIBILITY FOR THE PERFORMANCE OF THE ENGINE GENERATOR SET AND ITS ACCESSORIES. IT SHALL BE A NEW, FACTORY ASSEMBLED AND TESTED SET.

TELEPHONE/DATA/CABLE TELEVISION SERVICE

- A. VERIFY OWNER'S REQUIREMENTS FOR LOW VOLTAGE SYSTEM INCLUDING SECURITY SYSTEM, ALARMS, TELEPHONE AND/OR CABLE/SATELLITE TELEVISION SERVICE, AND COMPUTER NETWORK CABLE. TERMINATE SERVICE CONDUIT PER MANUFACTURER REQUIREMENTS.

CEILING SCHEDULE

Type Mark	Area	Description	Comments
-----------	------	-------------	----------

C1 2123 SF NEW GYP. BOARD CEILING

Grand total 2123 SF

LIGHTING FIXTURE SCHEDULE


Type Mark	Count	Description	Comments
-----------	-------	-------------	----------

A	114	RECESSED DOWNLIGHT	
B	20	SCONCE	
C	3	EXTERIOR POST LIGHT FIXTURE	
D	12	BATHROOM EXHAUST FAN	
E	11	UTILITARIAN FLUSH MOUNT FIXTURE PULL-SWITCH	
F	5	EXTERIOR GROUND UP-LIGHT WALL WASH	
G	2	REAR EXTERIOR GOOSE NECK	
H	4	REAR EXTERIOR SCONCE	

Grand total 171

GENERAL ELECTRICAL AND LIGHTING NOTES

- ANY EXISTING LIGHTING SHOWN TO REMAIN WITH EXISTING SWITCHING
- NEW LIGHTING FIXTURES IN ROOMS WITH EXISTING LIGHTING TO BE TIED INTO EXISTING SWITCHING, ETC.
- EXISTING POWER TO BE VERIFIED ON SITE AND RE-USED WHERE POSSIBLE
- CEILINGS NOT TAGGED ARE EXISTING TO REMAIN

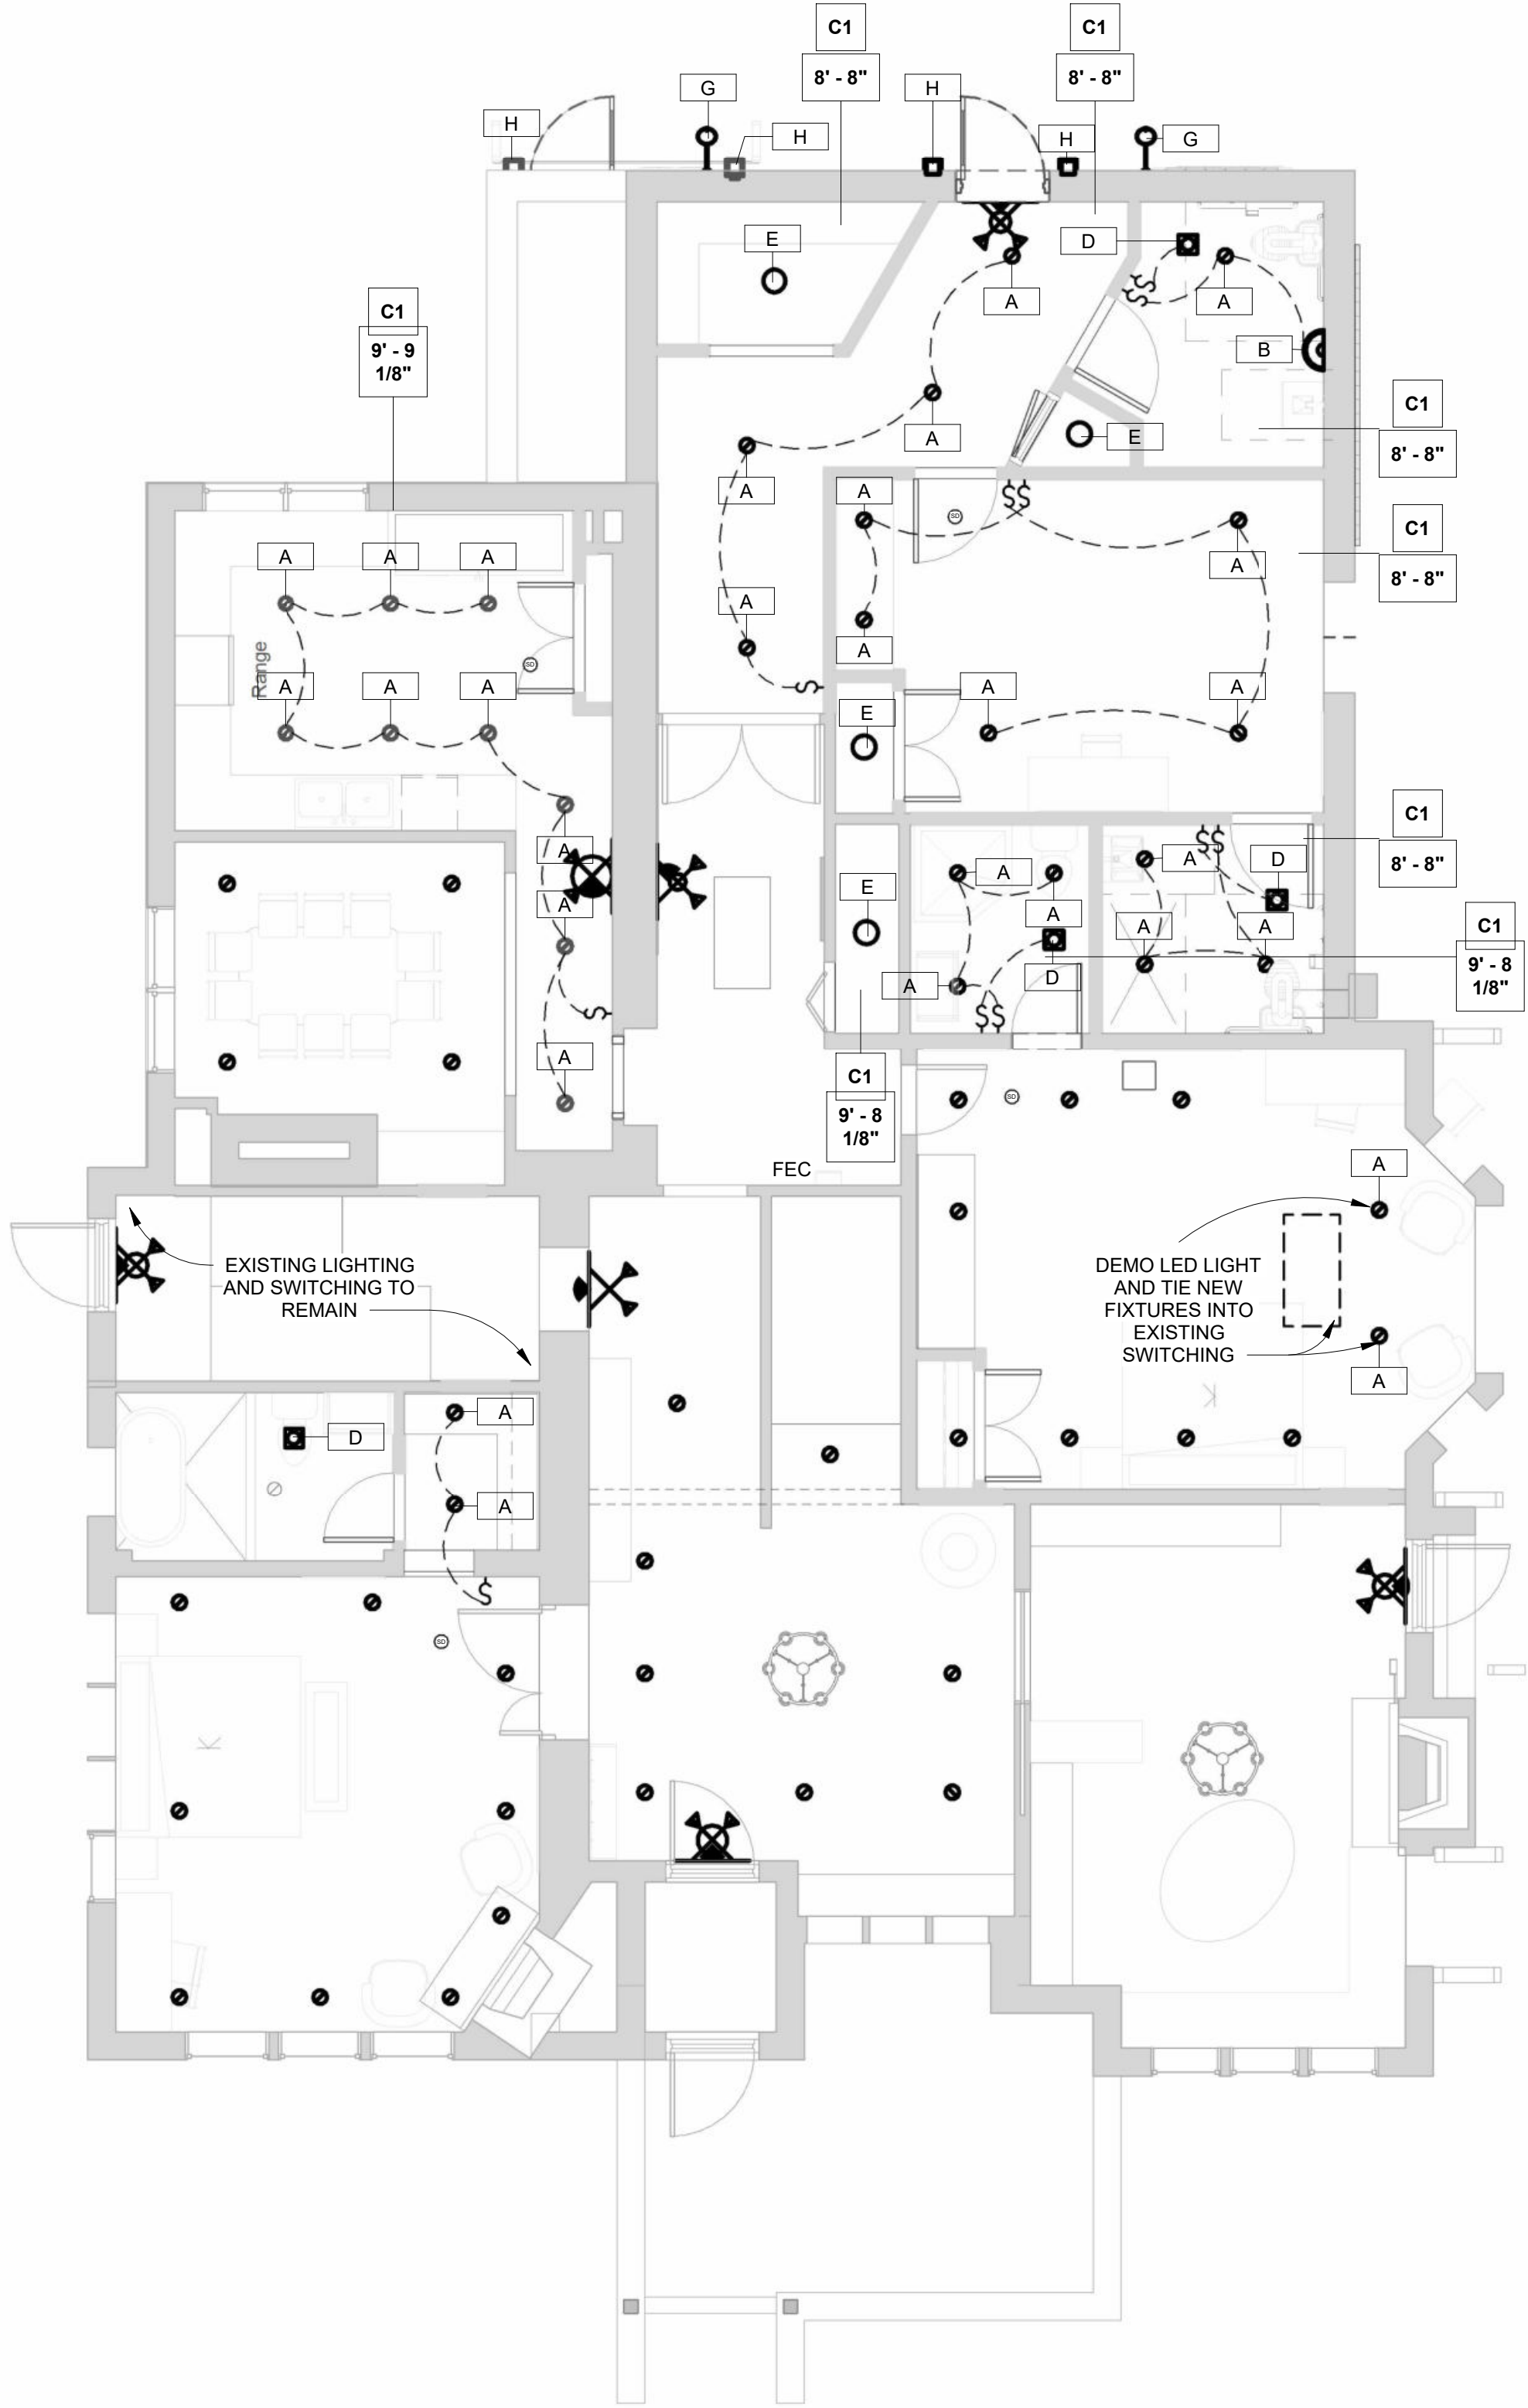

2
A-3.0


FIRST FLOOR REFLECTED CEILING PLAN

3/16" = 1'-0"

- | | |
|---|--|
| Duplex Outlet (12" AFF, 42" AFF @ Counters) | Wall Sconce (66" A.F.F.) |
| 220V Outlet | Recessed Can Lighting |
| Ground Fault Interrupted Outlet | Flood Light |
| Water Proof Outlet | Ceiling Fan |
| Ceiling/Floor Outlet | Smoke Detector |
| Telephone | Exhaust Fan |
| Cable / Television | Exhaust Fan & Light Combination |
| Switch | Track Lighting |
| 3-Way Switch | Emergency Exit Light & Backup Lighting |
| 4-Way Switch | Emergency Backup Lighting |
| Pendant Light fixture | Electrical Panel |

ELECTRICAL SYMBOLS

1/8" = 1'-0"

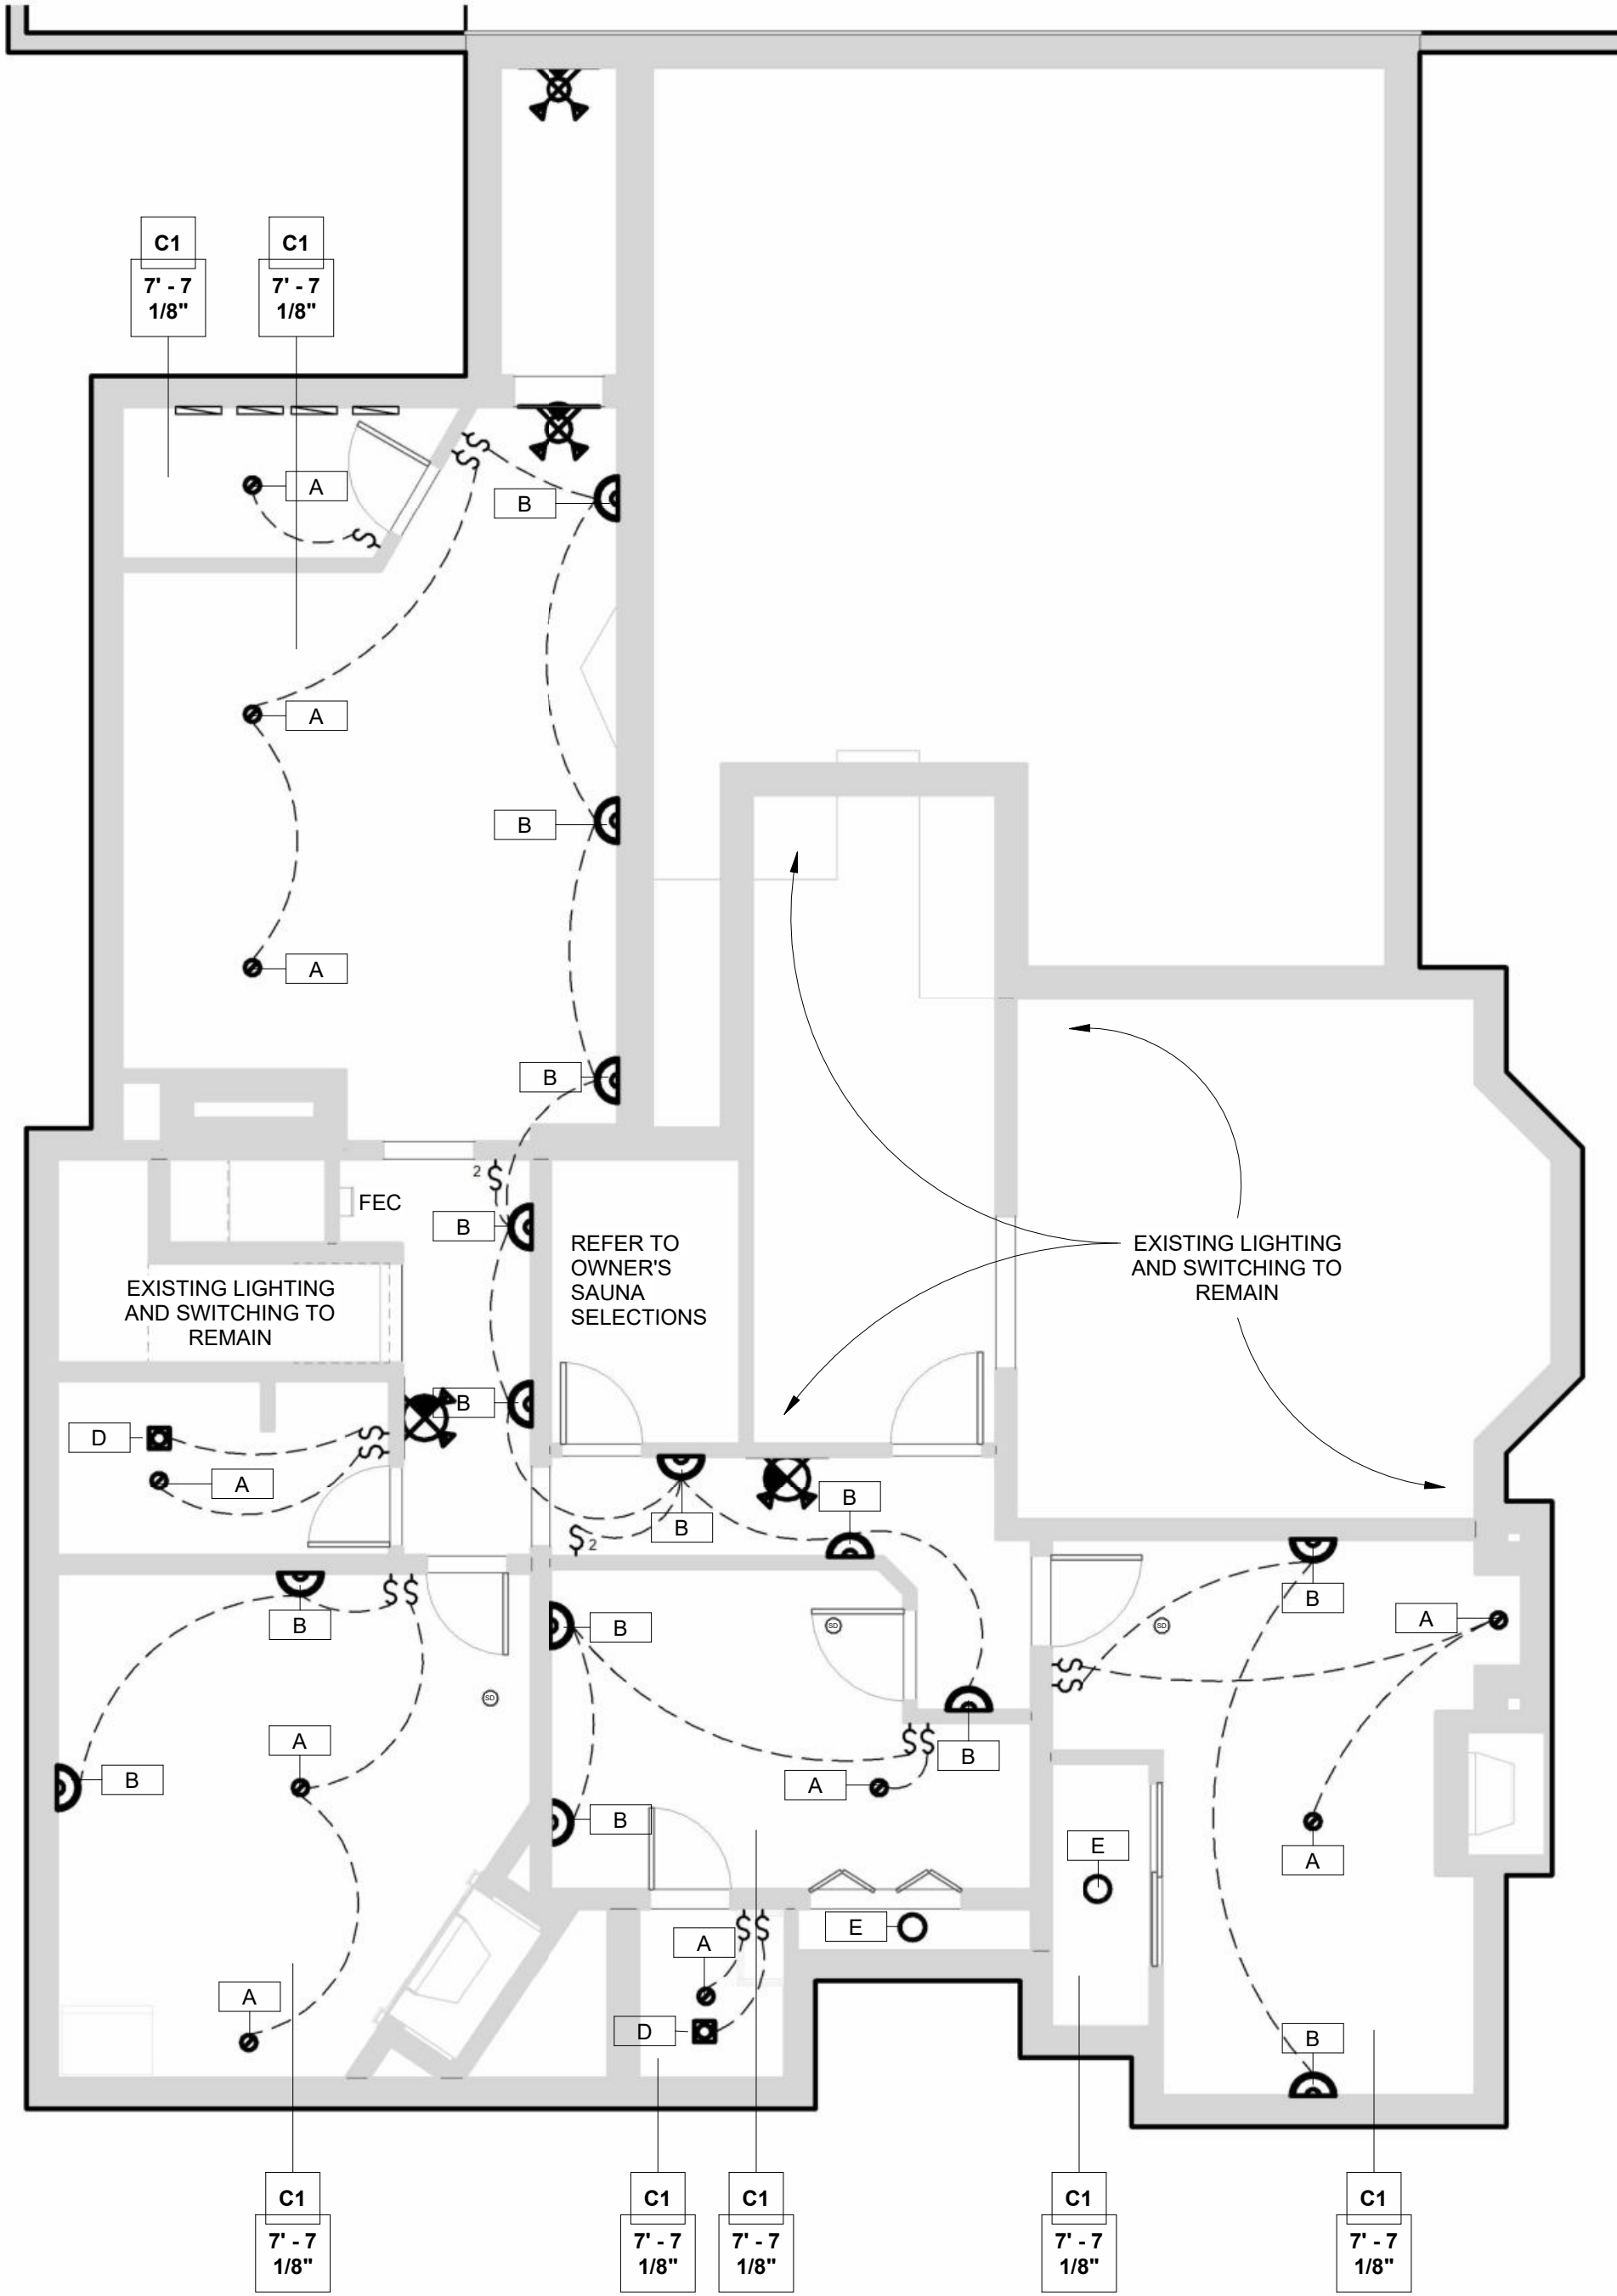

1

FOUNDATION REFLECTED CEILING PLAN

3/16" = 1'-0"

infuz Ltd
ARCHITECTS + INNOVATORS

Port Huron Office
208 Huron Ave., Suite 1
Port Huron, MI 48130
Phone: 586.265.7604

Detroit Office
1111 Bellevue Ste 201
Detroit, MI 48206
Phone: 313.332.1299

Email: infuzltd@comcast.net
Web: infuzarchitects.com

Unauthorized use of this drawing set without written permission from VIRTUOSO DESIGN + BUILD and infuz Ltd is in violation of U.S. COPYRIGHT LAWS and will be subject to civil damages and prosecution.

Revision Schedule

#	Description	Date
1	Commercial Set	03/13/2025

SEAL

NOT FOR CONSTRUCTION

BERKERY ESTATE

PROJECT NUMBER: Z2405
8325 E. JEFFERSON AVE
DETROIT, MI 48214

NIAL & MELVIE BERKERY

SHEET TITLE

PROPOSED REFLECTED CEILING PLANS

SHEET NUMBER

A-5.0




LIGHTING FIXTURE SCHEDULE			
Type Mark	Count	Description	Comments
A	114	RECESSED DOWNLIGHT	
B	20	SCONCE	
C	3	EXTERIOR POST LIGHT FIXTURE	
D	12	BATHROOM EXHAUST FAN	
E	11	UTILITARIAN FLUSH MOUNT FIXTURE PULL-SWITCH	
F	5	EXTERIOR GROUND UP-LIGHT WALL WASH	
G	2	REAR EXTERIOR GOOSE NECK	
H	4	REAR EXTERIOR SCONCE	
Grand total	171		

- ANY EXISTING LIGHTING SHOWN TO REMAIN WITH EXISTING SWITCHING
- NEW LIGHTING FIXTURES IN ROOMS WITH EXISTING LIGHTING TO BE TIED INTO EXISTING SWITCHING, ETC
- EXISTING POWER TO BE VERIFIED ON SITE AND RE-USED WHERE POSSIBLE
- CEILINGS NOT TAGGED ARE EXISTING TO REMAIN



GENERAL ELECTRICAL AND LIGHTING NOTES

- ANY EXISTING LIGHTING SHOWN TO REMAIN WITH EXISTING SWITCHING
- NEW LIGHTING FIXTURES IN ROOMS WITH EXISTING LIGHTING TO BE TIED INTO EXISTING SWITCHING, ETC.
- EXISTING POWER TO BE VERIFIED ON SITE AND RE-USED WHERE POSSIBLE
- CEILINGS NOT TAGGED ARE EXISTING TO REMAIN

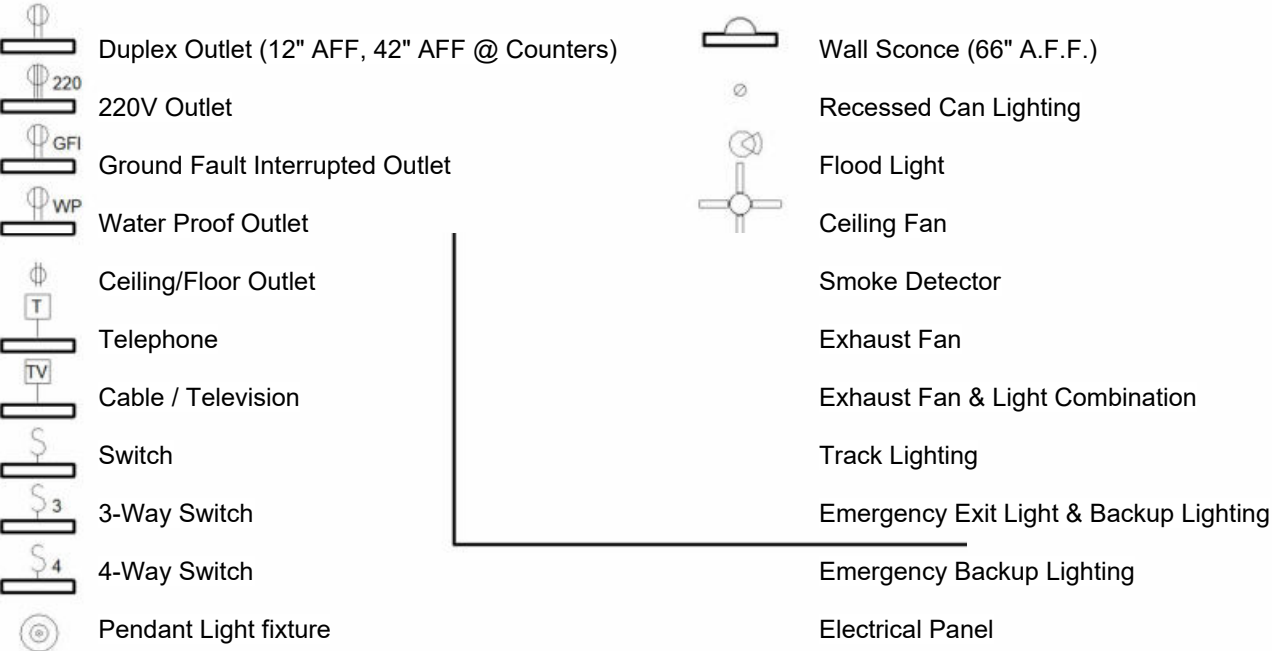

ELECTRICAL SYMBOLS

GENERAL ELECTRICAL NOTES:

- A. CONTRACTOR SHALL FURNISH ALL MATERIALS AND LABOR AS INDICATED ON THE PLANS AND AS REQUIRED FOR A COMPLETE WORK LIGHTING AND POWER SYSTEM.
- B. ALL WORKMANSHIP, MATERIALS AND METHODS OF INSTALLATION SHALL BE GOVERNED BY THE REQUIREMENTS OF THESE SPECIFICATIONS, THE NATIONAL ELECTRICAL CODE, LATEST REVISION, LOCAL CODES, BARRIER FREE CODES, AND OSHA.
- C. EXERCISE CARE IN INSTALLING SUPPORTS TO MAINTAIN STRUCTURAL DESIGNED QUALITY. ALLOW FOR EXPANSION MOVEMENTS AS REQUIRED IN ALL SUPPORTS, CABLES AND CONDUIT.
- D. VERIFY WALL SWITCH AND POWER OUTLETS LOCATION WITH OWNER AND LOCAL GOVERNING ENFORCEMENT OFFICIAL. WHERE NOT SPECIFIED ALL SWITCHES SHALL BE LOCATED 48" ABOVE FINISHED FLOOR TO CENTERLINE. CONVENIENCE RECEPTACLES SHALL BE LOCATED 18" ABOVE FINISHED FLOOR TO BOTTOM OF BOX, EXCEPT WHERE INDICATED ON PLANS TO BE OTHERWISE. ALL WALL SWITCH OUTLETS SHALL BE INSTALLED ON THE LOCK SIDE OF THE DOOR IMMEDIATELY ADJACENT TO DOOR FRAME. VERIFY DOOR SWINGS WITH GENERAL CONTRACTOR PRIOR TO ROUGH-IN WORK. WHERE GLASS PARTITIONS OR OTHER ARCHITECTURAL FEATURES PREVENT SUCH LOCATIONS, SWITCHES SHALL BE LOCATED IN HOLLOW METAL DOOR FRAMES.
- E. ALL RECEPTACLES LOCATIONS SHALL BE IN ACCORDANCE WITH THE LAYOUT SHOWN EXCEPTED AS OTHERWISE NOTED OR AS OTHERWISE REQUIRED BY CODES AND/OR AGENCIES HAVING JURISDICTION. ALL OUTLETS SHALL BE OF ADEQUATE SIZE AND TYPE AS REQUIRED FOR THE PARTICULAR LOCATION AND SERVICE INTENDED. RECEPTACLES SHALL NOT BE RATED LESS THAN 20 AMPS AND SHOULD BE LABELED ON THE INSIDE OF EACH FACE PLATE WITH PANEL AND CIRCUIT NUMBER DESIGNATION. CHECK ALL RECEPTACLE CIRCUITS FOR CONTINUITY AFTER COMPLETION.
- F. ALL WIRING SHALL BE RUN IN ELECTRICAL RACEWAY AS REQUIRED PER APPLICABLE CODES.
- G. VERIFY OWNER'S DESIRE FOR DIMMING AND OTHER CONTROLS SUCH AS PHOTO-SENSORS, TIMERS, ETC.
- H. THE DRAWINGS SHOW THE GENERAL ARRANGEMENT AND EXTENT OF THE WORK ENUMERATED ABOVE AND ARE PARTLY DIAGRAMMATIC. THE DRAWINGS ARE NOT INTENDED TO BE SCALED FOR ROUGH-IN MEASUREMENTS, NOT TO SERVE AS SHOP DRAWINGS. CONSULT EQUIPMENT SHOP DRAWINGS FOR CORRECT MEASUREMENTS WHEREVER POSSIBLE.
- I. THE ELECTRICAL SUB-CONTRACTOR SHALL BE RESPONSIBLE FOR THE CORRECT FIT OF THE WORK INSTALLED AND SHALL TAKE FIELD MEASUREMENTS NECESSARY FOR ORDERING MATERIALS AND FITTING THE INSTALLATION TO THE BUILDING CONSTRUCTION AND ARRANGEMENT.
- J. ELECTRICAL WORK SHALL BE COORDINATED WITH OTHER TRADES. CONSULT THE PLANS COVERING WORK FOR OTHER TRADES. THE FIELD LAYOUTS OF THE CONTRACTORS FOR THESE TRADES, AND THEIR SHOP DRAWINGS. THE CONTRACTOR SHALL BE AWARE AND RESPONSIBLE IN LAYING OUT THE ELECTRICAL WORK.
- K. CUTTING, CORE DRILLING, INSERTS AND CONDUIT OR CABLE SLEEVES AND PATCHING REQUIRED IN THE GENERAL CONSTRUCTION FOR THE COMPLETION OF THE WORK, SPECIFIED HEREIN, SHALL BE FURNISHED AND INSTALLED BY THE ELECTRICAL CONTRACTOR.
- L. STANDARD PLACEMENT HEIGHTS FOR FLOOR AND COUNTERTOP LEVEL OUTLETS SHALL ARE PLACED 15" AND 46" A.F.F. RESPECTIVELY.

STANDARDS OF MATERIALS AND WORKMANSHIP

ALL MATERIALS SHALL BE NEW. THE ELECTRICAL AND PHYSICAL PROPERTIES OF ALL MATERIALS, AND THE DESIGN, PERFORMANCE CHARACTERISTICS AND METHODS OF CONSTRUCTION OF ALL ITEMS OF EQUIPMENT, SHALL BE IN ACCORDANCE WITH THE LATEST ISSUE OF THE VARIOUS APPLICABLE STANDARD SPECIFICATIONS OF THE FOLLOWING RECOGNIZED AUTHORITIES:

N.E.C. -	NATIONAL ELECTRICAL CODE
A.N.S.I. -	AMERICAN NATIONAL STANDARDS INSTITUTE
I.E.E.E. -	INSTITUTE OF ELECTRICAL ELECTRONICS ENGINEERS
A.S.T.M. -	AMERICAN SOCIETY FOR TESTING MATERIALS
I.P.C.E.A. -	INSULATED POWER CABLE ENGINEERS ASSOCIATION
N.E.M.A. -	NATIONAL ELECTRICAL MANUFACTURER'S ASSOCIATION
U.L. -	UNDERWRITERS' LABORATORIES, INC.

- A. ALL WORK SHALL BE PERFORMED IN FIRST CLASS AND WORKMANLIKE MANNER. IN ACCORDANCE WITH THE LATEST ACCEPTED STANDARDS FOR THE TRADES INVOLVED. NONE BUT EXPERIENCED PERSONS IN THE WORK TO BE PERFORMED SHALL BE ALLOWED TO DO THE WORK. THIS APPLIES PARTICULARLY TO ITEMS SUCH AS CABLE SPLICING, CONTROL WORK, SYSTEMS CONNECTION, ETC.

CONDUIT

- A. CONDUIT SHALL BE EMT, PVC OR RIGID GALVANIZED STEEL. ALL CONDUIT INSTALLED UNDERGROUND SHALL BE PVC SCHEDULE 40 OR RIGID GALVANIZED STEEL AS NOTED. CONDUIT INSTALLED IN FINISHED AREAS SHALL BE CONCEALED.
- B. PROVIDE CONDUIT SLEEVES WHERE CONDUITS PASS THRU FLOORS, WALLS, ETC. ALL VOIDS BETWEEN SLEEVES AND HOLES AND CONDUITS PASSING THRU SHALL BE FIRESTOPPED. SPECSEAL 100 FIRE STOP SEALANT OR APPROVED EQUAL.

GROUNDING

- A. ALL METAL NON-CURRENT CARRYING PARTS OF ELECTRICAL EQUIPMENT, ENCLOSURES, BASES, FRAMES, LIGHTING FIXTURES, WIREWAYS AND SUPPORTS SHALL BE GROUNDED IN ACCORDANCE WITH THE LATEST N.E.C. AND LOCAL CODES.
- B. PROVIDE ANY SPECIAL GROUNDS REQUIRED BY THE LATEST N.E.C., UTILITIES, AND AS RECOMMENDED BY EQUIPMENT MANUFACTURERS.
- C. GROUND SERVICE EQUIPMENT TO BUILDING STEEL, GROUND RODS AND WATER SERVICE AS REQUIRED BY THE LATEST N.E.C.
- D. ALL FEEDER AND BRANCH CIRCUITS SERVING PANELS, LIGHTING, RECEPTACLES, MOTORS, MECHANICAL EQUIPMENT, ETC., INSTALLED IN EMT, MC, PVC OR RIGID GALVANIZED STEEL CONDUIT, SHALL BE INSTALLED WITH AN INSULATED (GREEN) GROUND CONDUCTOR.

EGRESS LIGHTING


- A. APPROVED EXIT SIGNS SHALL BE INSTALLED TO INDICATE THE LOCATION OF THE DESIGNATED MEANS OF EGRESS. ALL EXIT SIGNS SHALL HAVE CONSTANT ILLUMINATION.
- B. EMERGENCY LIGHTING SHALL BE PROVIDED THROUGHOUT THE FACILITY ACCORDING TO THE LATEST IFC/IBC AND NFPA, AS WELL AS CURRENT FIRE CODES. ELECTRICAL CONTRACTOR TO PROVIDE LIGHTING TO MEET FOOTCANDLE REQUIREMENTS.
- C. COMBINATION EXIT AND EMERGENCY LIGHTING UNITS MAY BE USED IN LIEU OF SEPARATE FIXTURES AS LONG AS ALL CODE REQUIREMENTS ARE MET.
- D. THERE SHALL BE CLEAR MARKINGS OF ARROW/CHEVRON INDICATORS TO DISTINGUISH THE DIRECTION OF TRAVEL TO THE PATH OF EGRESS.
- E. ELECTRICAL CONTRACTOR TO VERIFY STYLE AND COLOR OF EXIT FIXTURES WITH OWNER. WHERE ACCEPTABLE, USE BLUE OR GREEN LED GLASS FIXTURES.
- F. EGRESS DOORS SHALL BE READILY OPERABLE FROM THE EGRESS SIDE WITHOUT THE USE OF A KEY OR SPECIAL KNOWLEDGE OR EFFORT.

GENERATOR


- A. VERIFY WITH BUILDING OWNER THE INTENT TO PROVIDE A NATURAL GAS/LP GAS ENGINE GENERATOR SET, IN A WEATHERPROOF SOUND ENCLOSURE, OF THE LATEST COMMERCIAL TYPE AND DESIGN. IN A STAND-BY POWER CAPACITY, IT SHALL BE CAPABLE OF CONTINUOUS SERVICE AND RATED OUTPUT FOR THE DURATION OF ANY UTILITY POWER FAILURE. THE ENGINE GENERATOR MANUFACTURER AND ITS AUTHORIZED DEALER SHALL HAVE SOLE RESPONSIBILITY FOR THE PERFORMANCE OF THE ENGINE GENERATOR SET AND ITS ACCESSORIES. IT SHALL BE A NEW, FACTORY ASSEMBLED AND TESTED SET.

TELEPHONE/DATA/CABLE TELEVISION SERVICE

- A. VERIFY OWNER'S REQUIREMENTS FOR LOW VOLTAGE SYSTEM INCLUDING SECURITY SYSTEM, ALARMS, TELEPHONE AND/OR CABLE/SATELLITE TELEVISION SERVICE, AND COMPUTER NETWORK CABLE. TERMINATE SERVICE CONDUIT PER MANUFACTURER REQUIREMENTS.

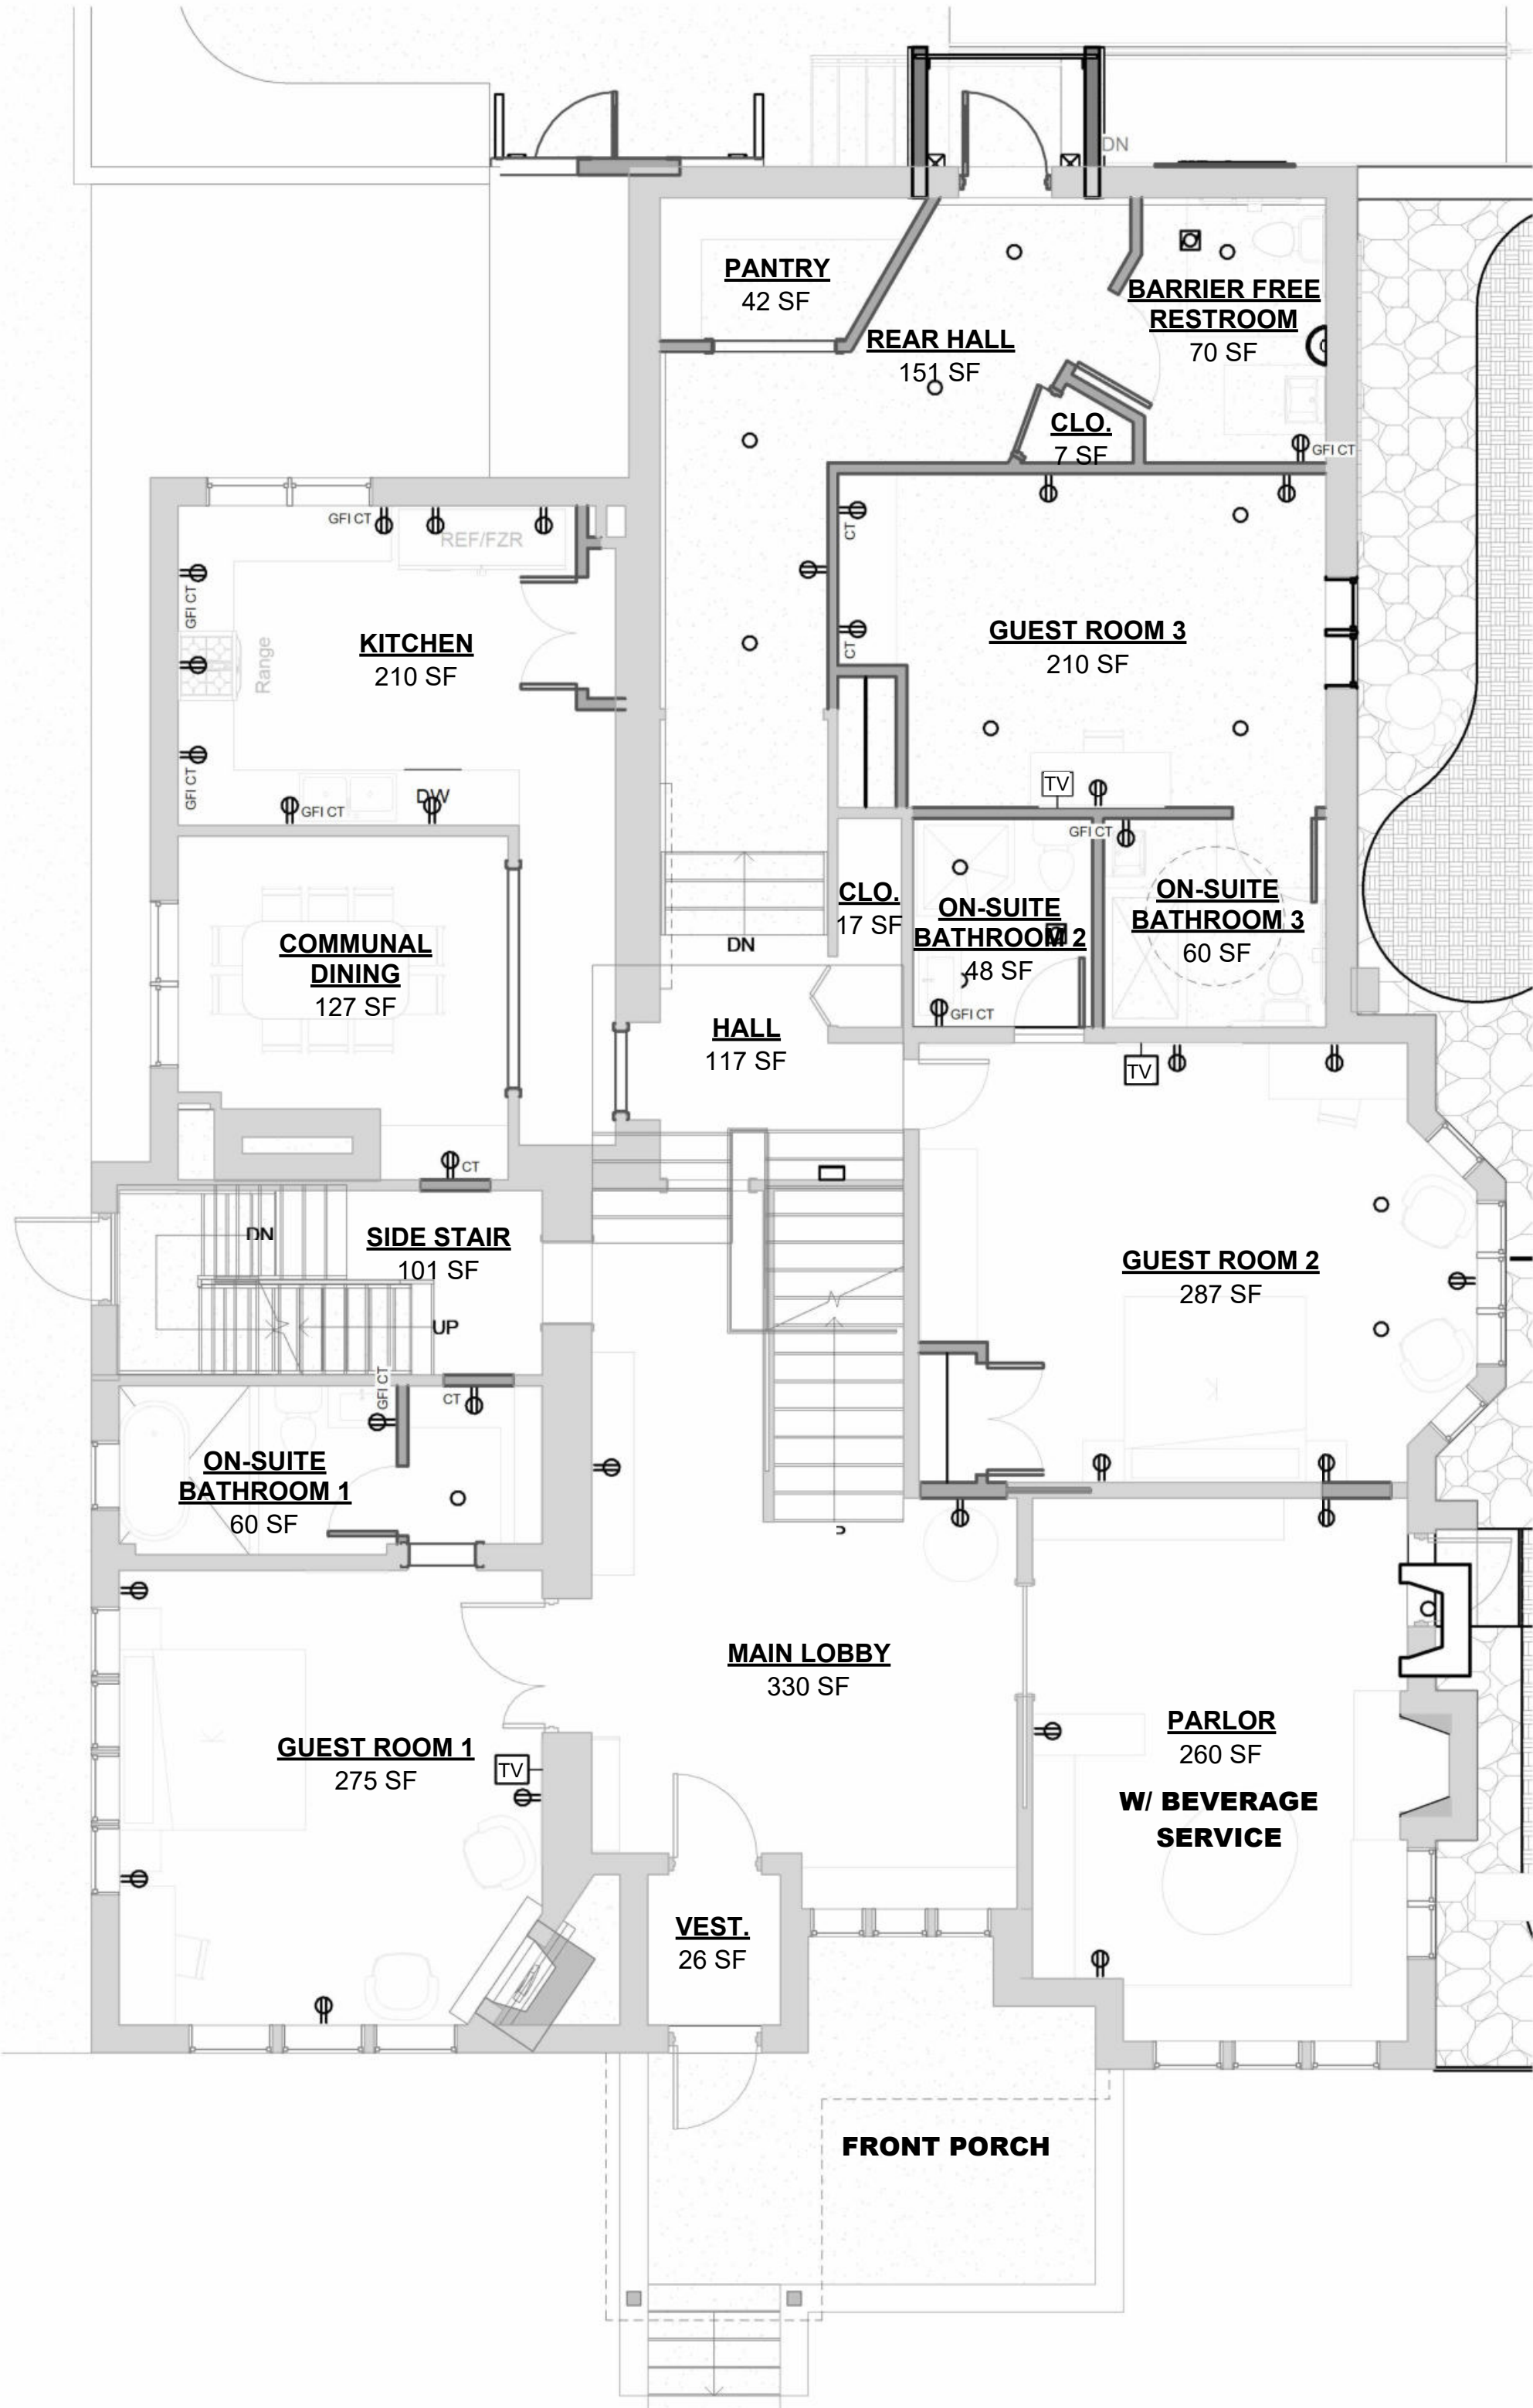

2 FIRST FLOOR - POWER PLAN

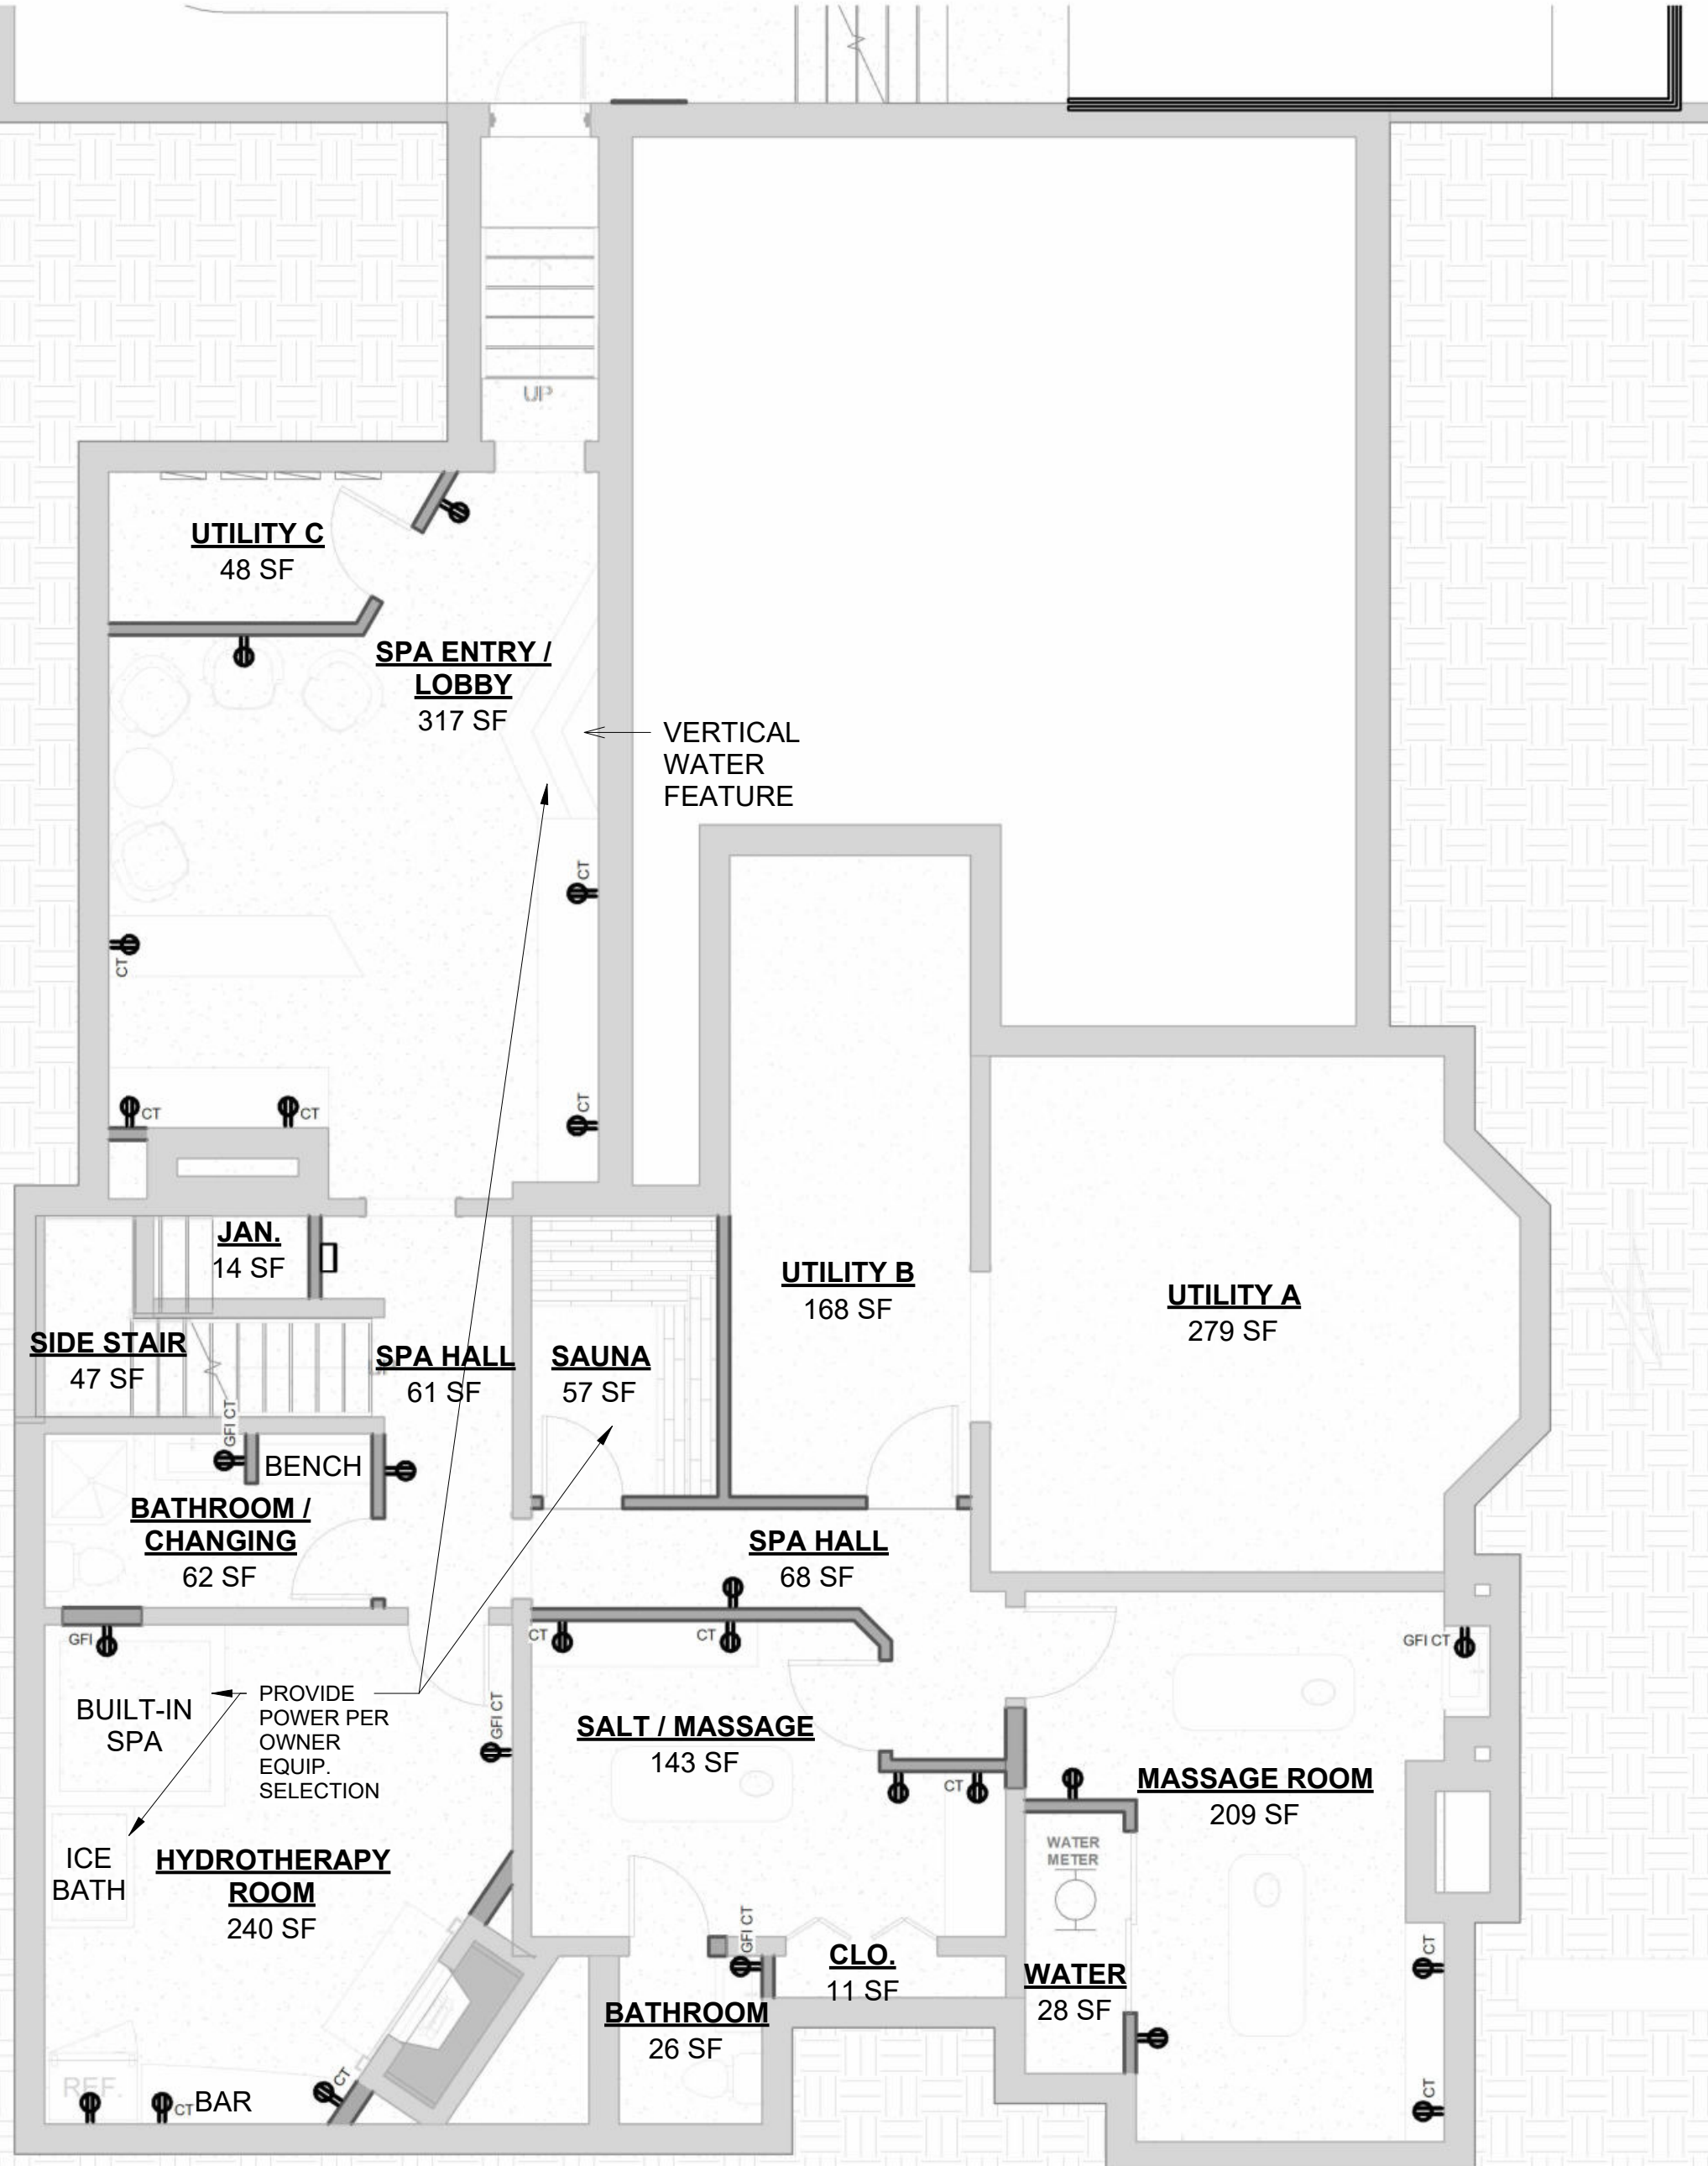

1 FOUNDATION PLAN - POWER PLAN

Email: infuzltd@comcast.net
Web: infuzarchitects.com

Unauthorized use of this drawing set without written permission from VIRTUOSO DESIGN + BUILD and infuz Ltd is in violation of U.S. COPYRIGHT LAWS and will be subject to civil damages and prosecution.

Revision Schedule

#	Description	Date
1	Commercial Set	03/13/2025

SEAL

NOT FOR CONSTRUCTION

03/13/2025

BERKERY ESTATE

PROJECT NUMBER: ZK005
8325 E. JEFFERSON AVE
DETROIT, MI 48214

NIAL & MELVIE BERKERY

SHEET TITLE

BASEMENT AND FIRST FLOOR POWER PLANS

SHEET NUMBER

E-0





FIRST FLOOR

ENTRANCE INSPIRATION


GOAL: KEEP EXISTING TRIM AND ENLIGHTEN SPACE THROUGH DESIGN ELEMENTS TO MAINTAIN HISTORIC CHARACTER.

DESIGN ELEMENTS:


- EMBRACE EXISTING WOOD TRIM
- CONTRAST WOOD TRIM W/ WHITE CEILING AND ACCENTS
- LIGHT FLOORING AND AREA RUGS
- CONTEMPORARY LIGHT FIXTURES AND FURNITURE
- REMOVE ANY INCANDESCENT LIGHTING AND REPLACE WITH DAYLIGHT TEMPERATURE LIGHTING

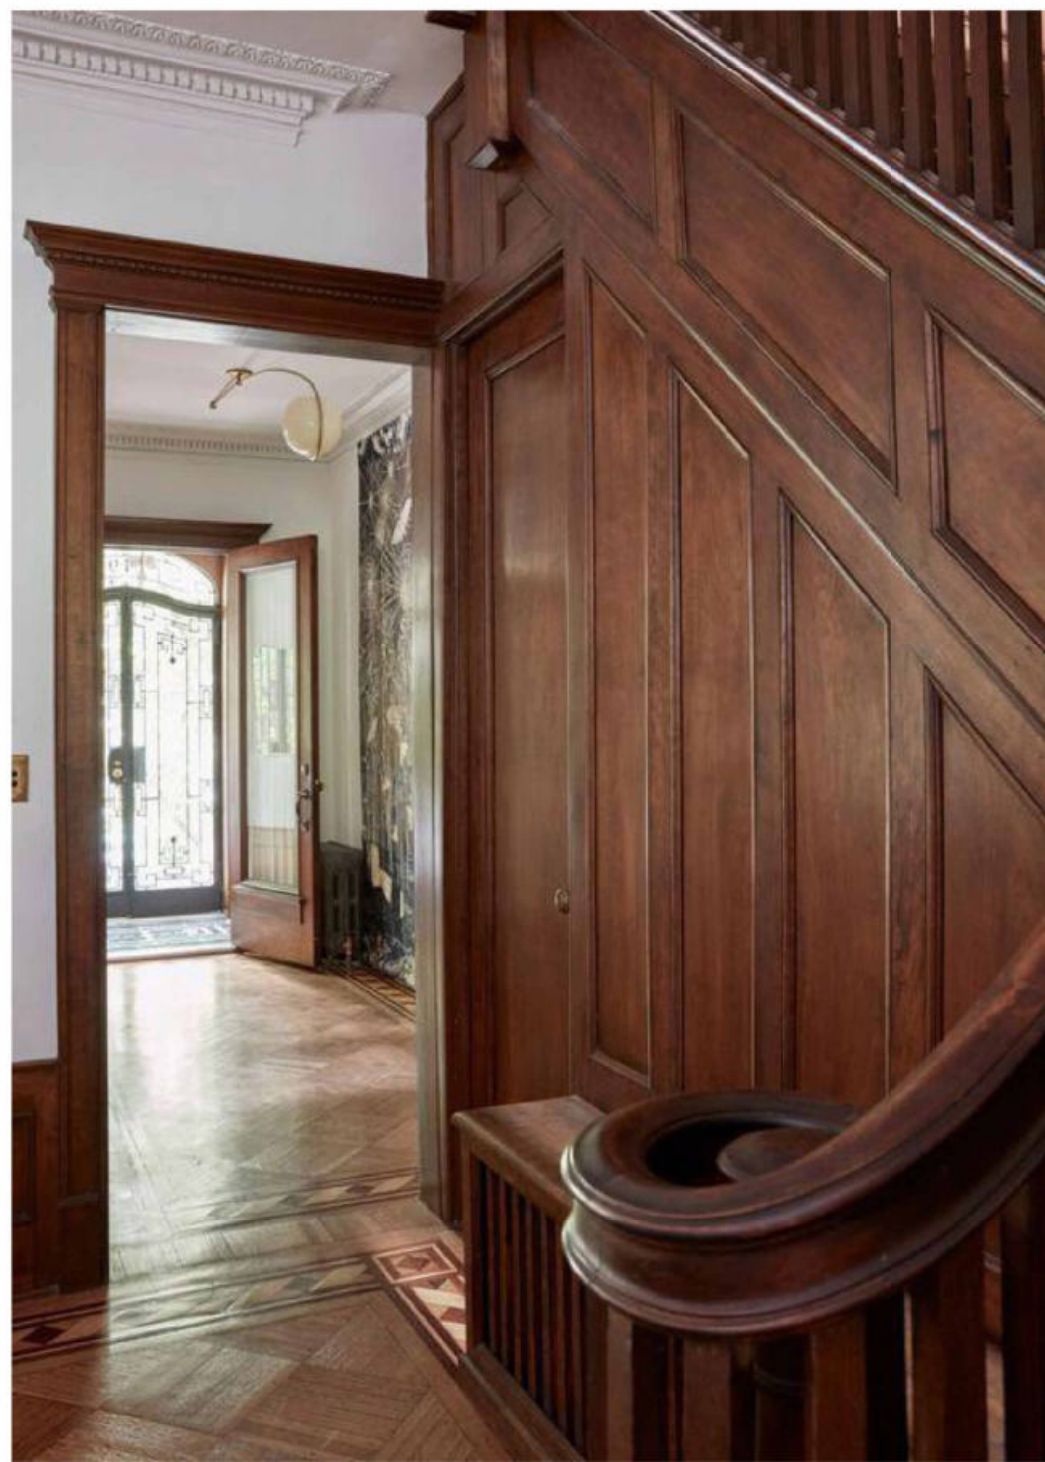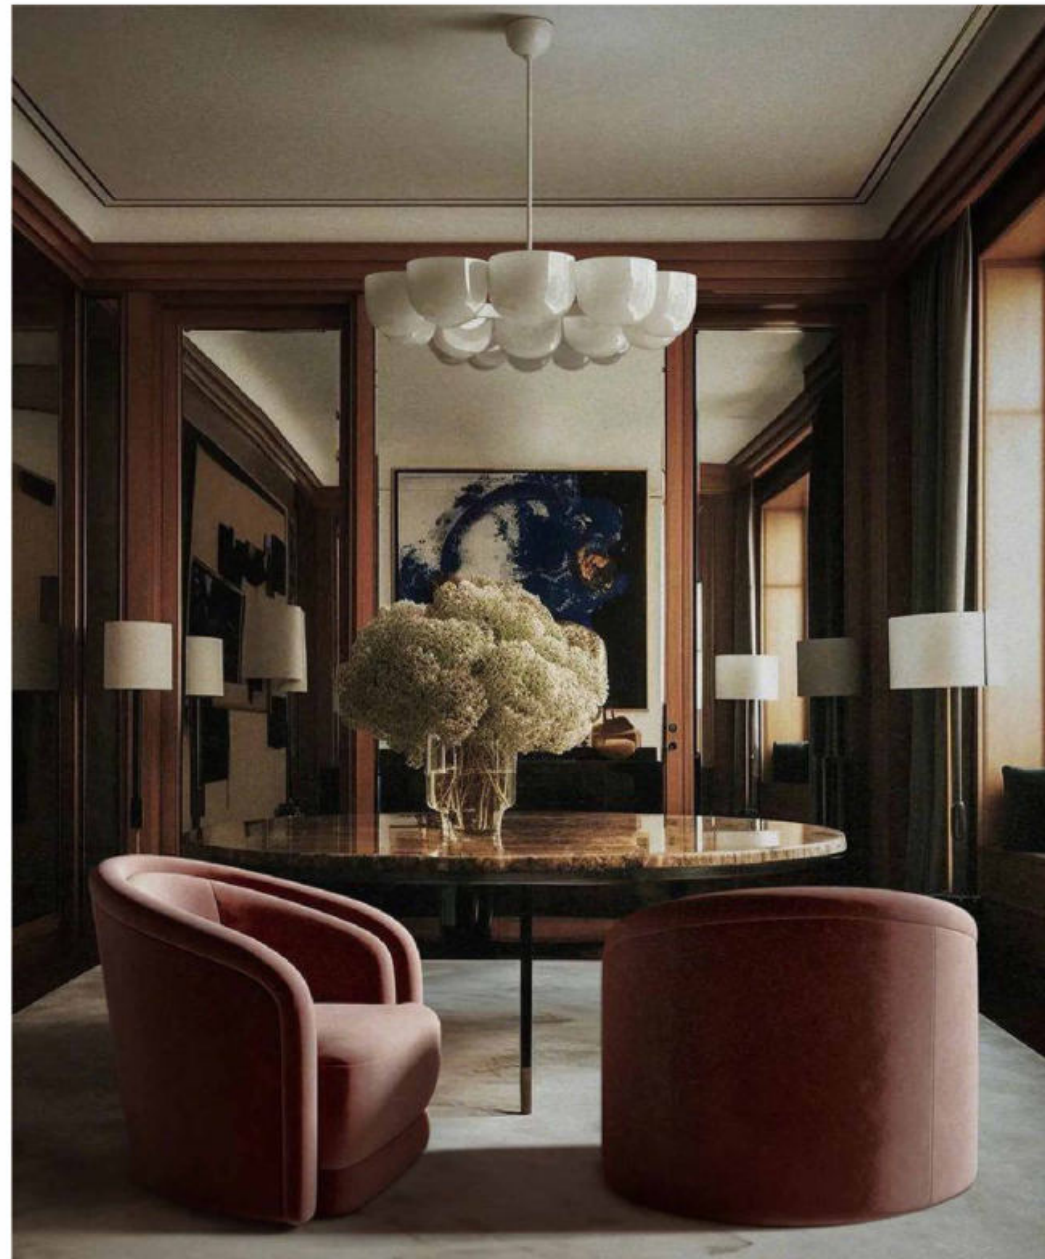


INSPIRATION

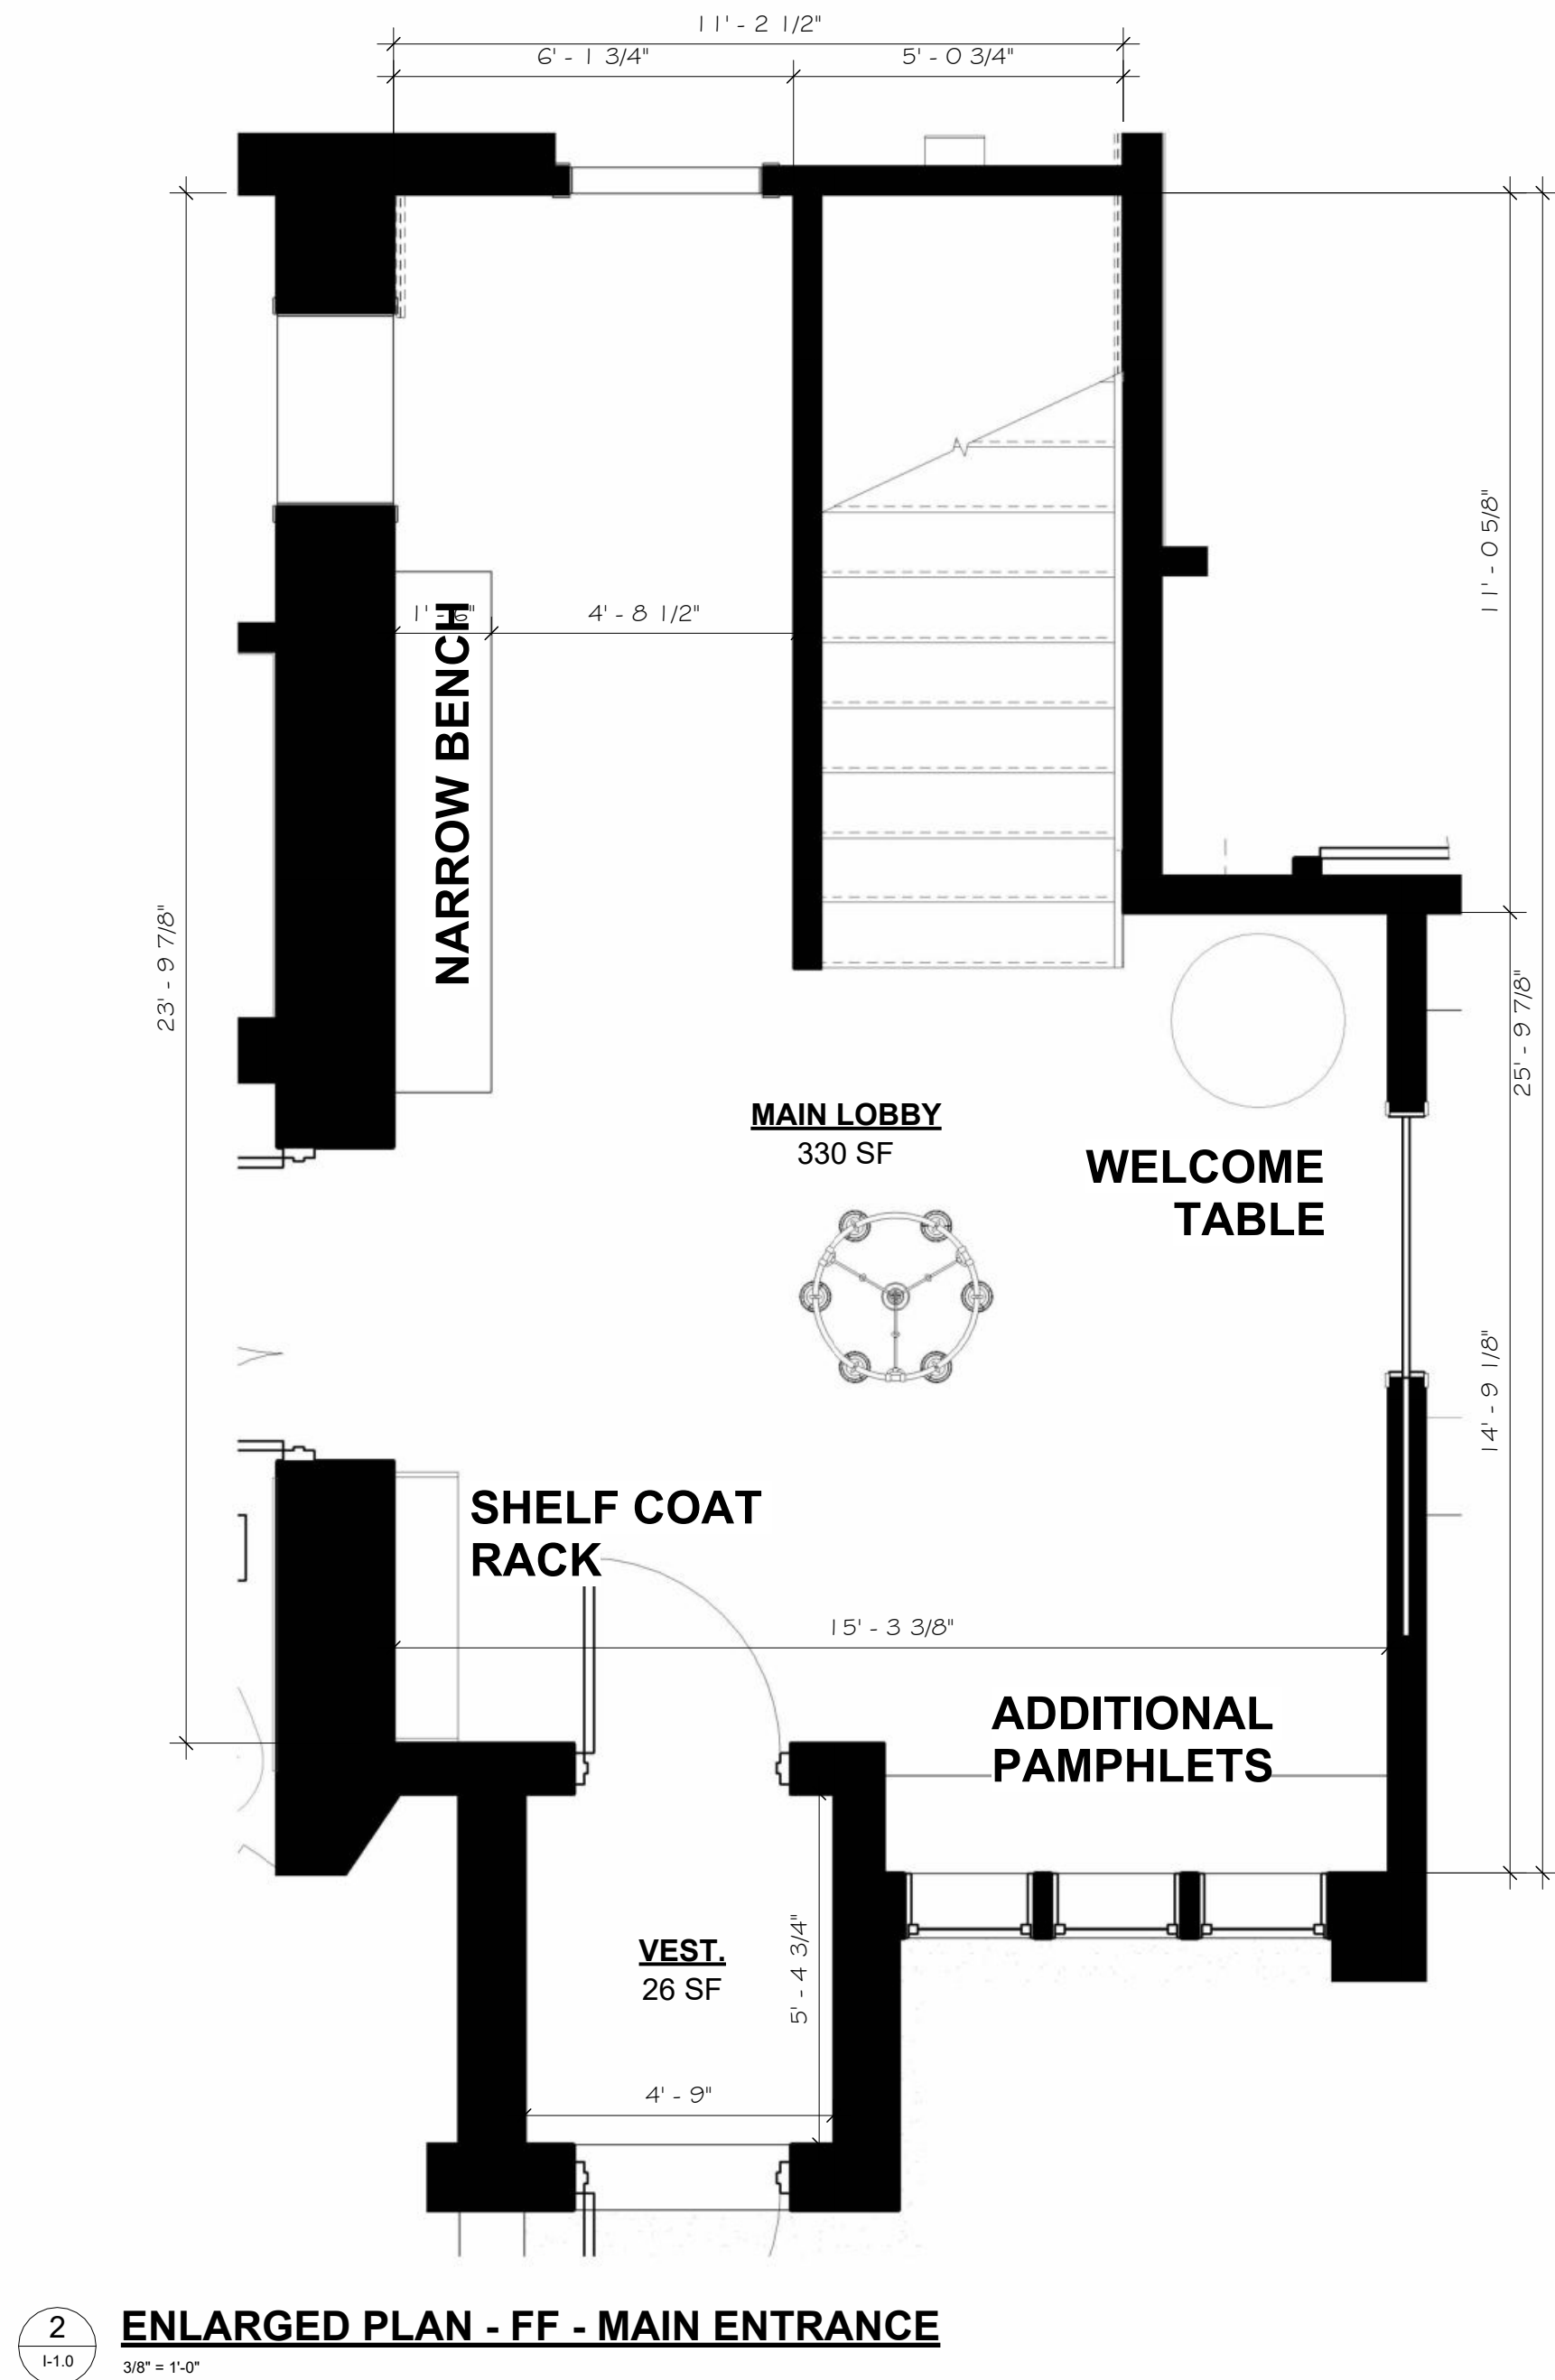

- AMENTITIES:**
- PAMPHLETS TO PROMOTE LOCAL EATERIES AND ACTIVITIES
 - WELCOME TABLE TO PROMOTE BED AND BREAKFAST

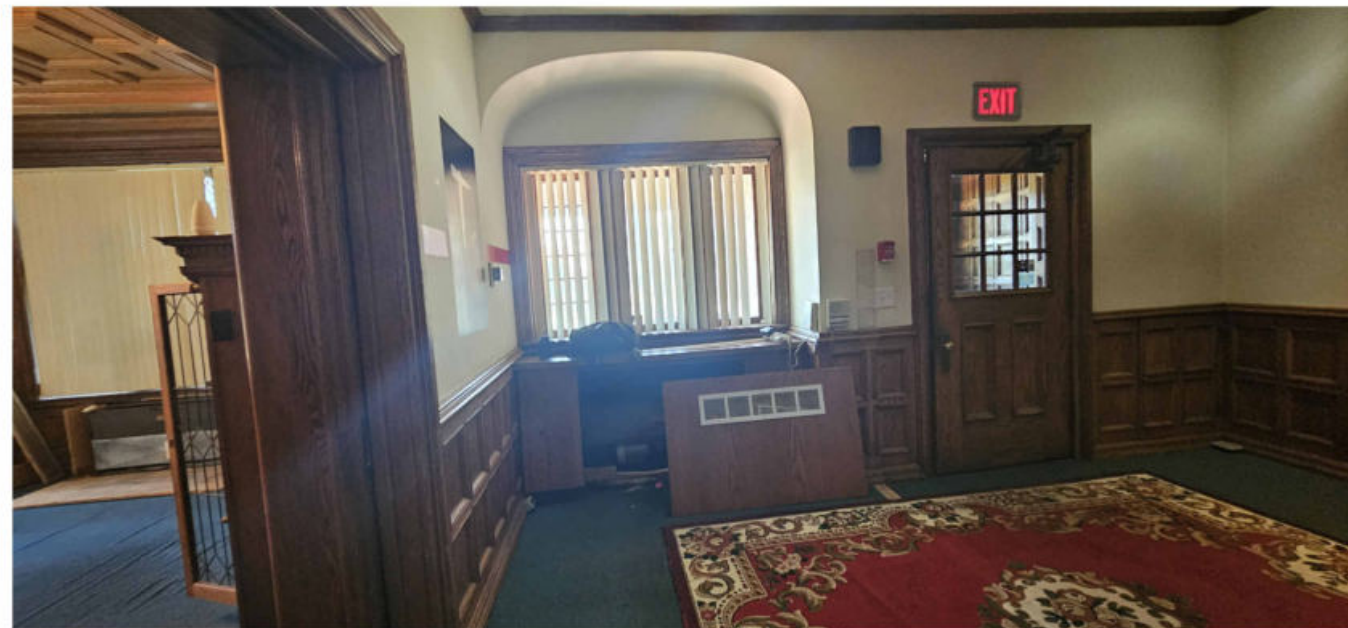

EXISTING CONDITIONS

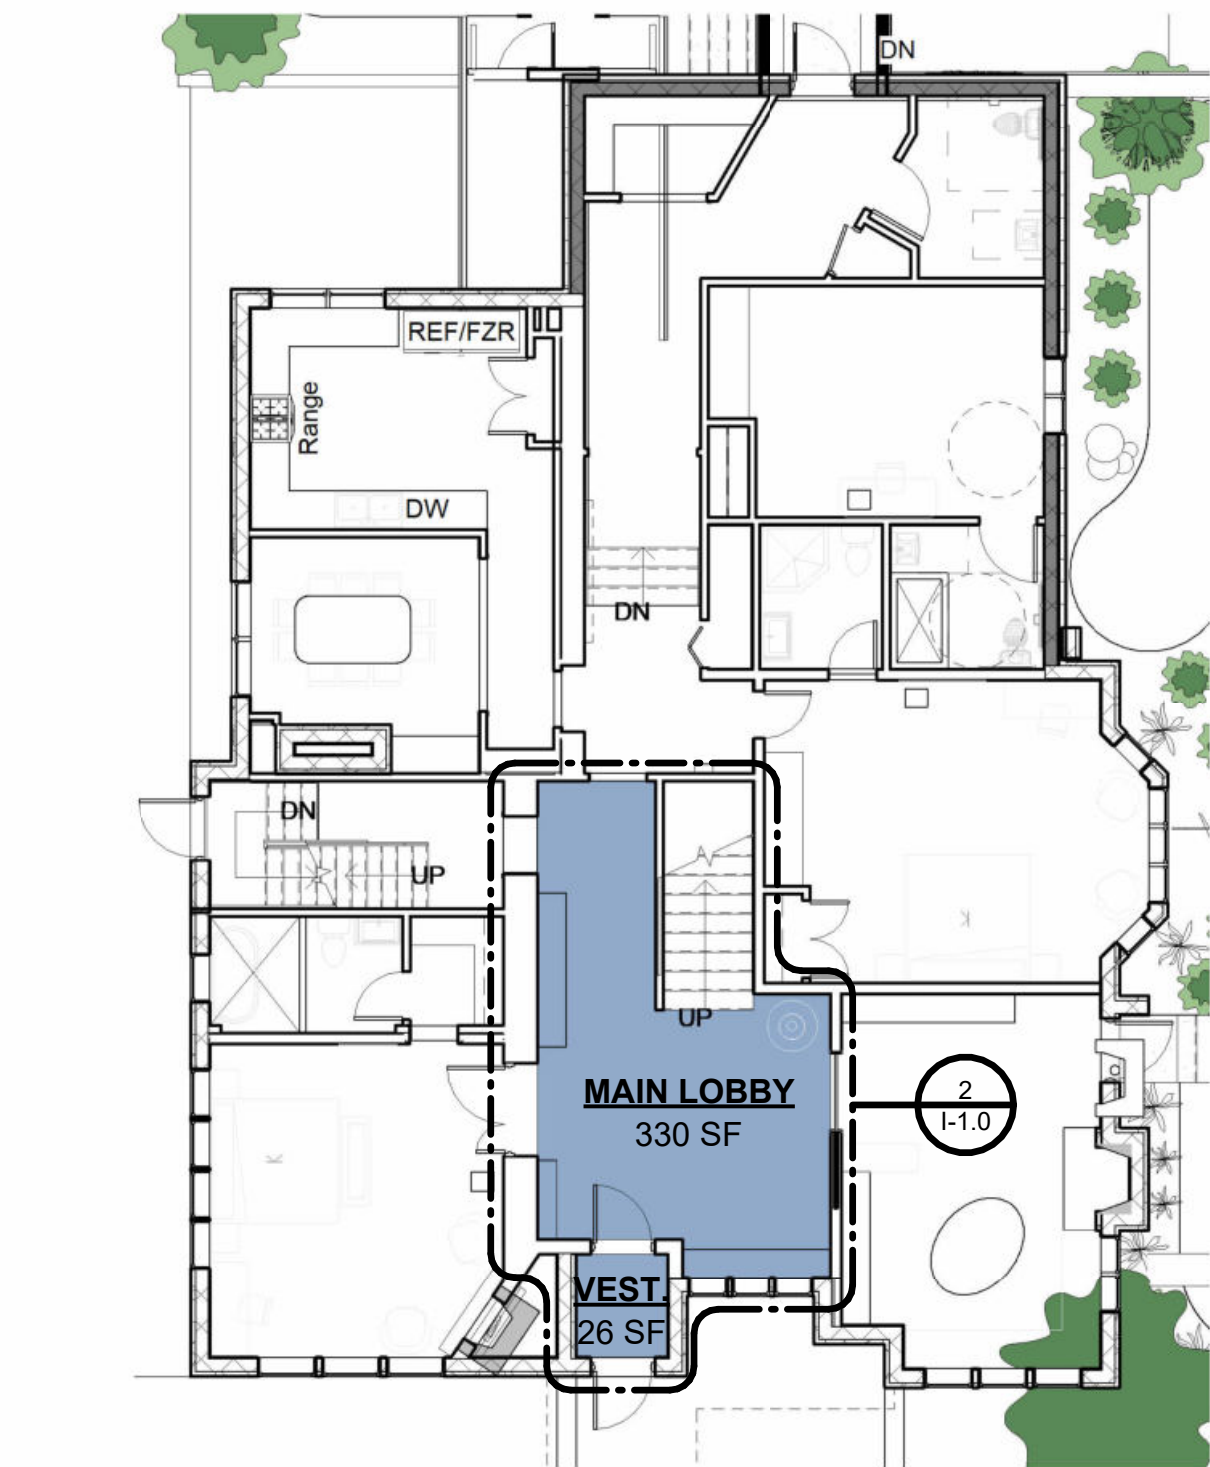

Unauthorized use of this drawing set without written permission from VIRTUOSO DESIGN + BUILD and infuz Ltd is in violation of U.S. COPYRIGHT LAWS and will be subject to civil damages and prosecution.

Revision Schedule		
#	Description	Date
1	Commercial Set	03/13/2025

SEAL

NOT FOR CONSTRUCTION

03/13/2025

BERKERY ESTATE
PROJECT NUMBER: Z24075
8325 E. JEFFERSON AVE
DETROIT, MI 48214
NIAL & MELVIE BERKERY

SHEET TITLE
FIRST FLOOR - ENTRANCE

SHEET NUMBER
I-1.0

FIRST FLOOR

PARLOR INSPIRATION


GOAL: KEEP EXISTING TRIM AND ENLIGHTEN SPACE THROUGH DESIGN ELEMENTS TO MAINTAIN HISTORIC CHARACTER.

DESIGN ELEMENTS:

- EMBRACE EXISTING WOOD TRIM
- CONTRAST WOOD TRIM W/ WHITE CEILING AND ACCENTS
- LIGHT FLOORING AND AREA RUGS
- CONTEMPORARY LIGHT FIXTURES AND FURNITURE
- REMOVE ANY INCANDESCENT LIGHTING AND REPLACE WITH DAYLIGHT TEMPERATURE LIGHTING



INSPIRATION

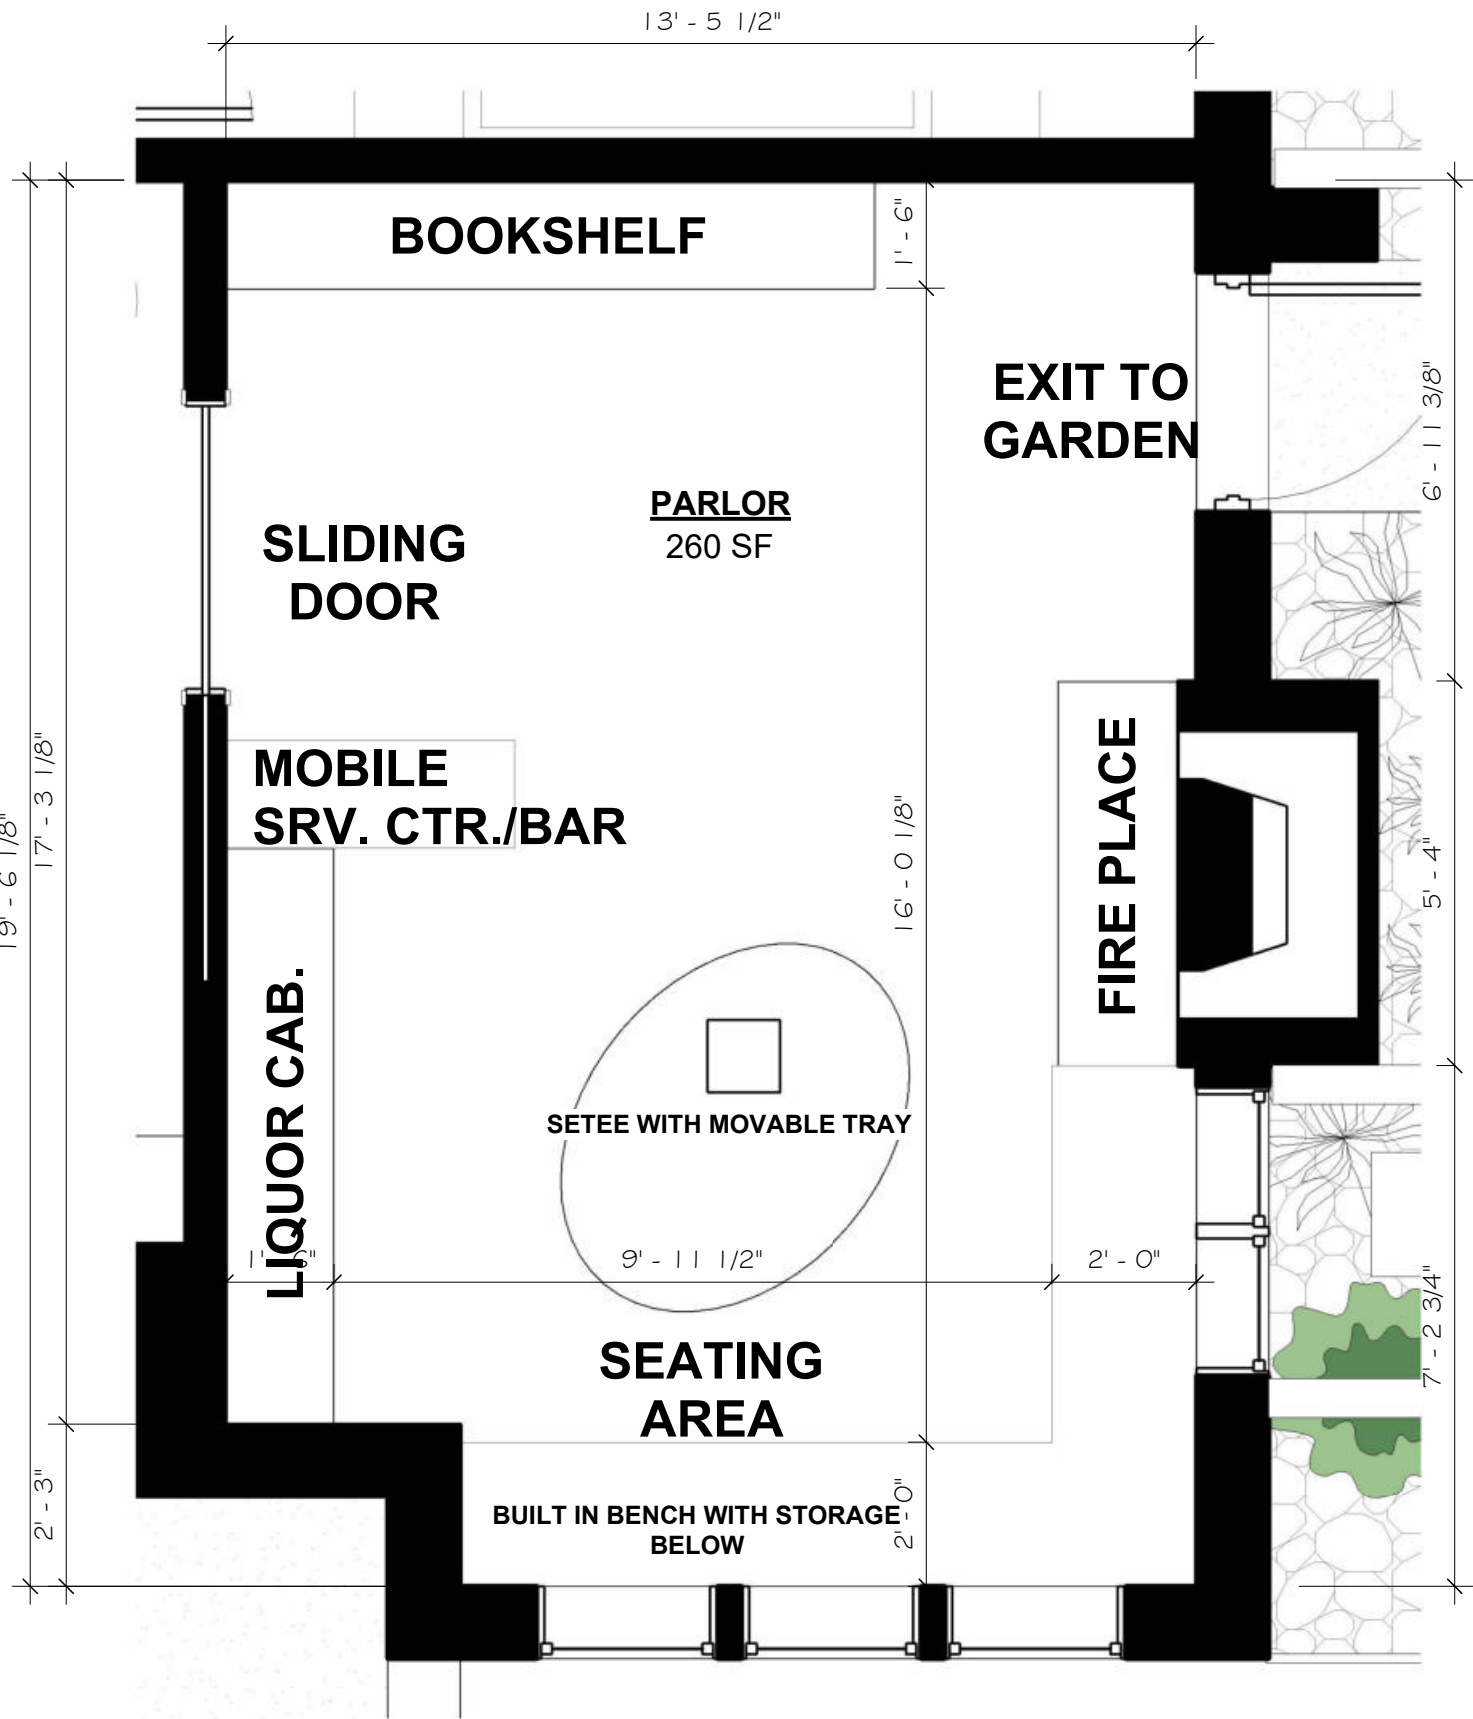

2 ENLARGED PLAN - FF - PARLOR
1/1.1
3/8" = 1'-0"

AMENITIES:


- LIBRARY
- WAITING AREA
- SERVICE COUNTER FOR BOOKING AND COCKTAILS
- SEATING AREA FOR WAITING OCCUPANTS
- EXIT TO EXTERIOR GARDEN SPACE



BUILT-IN BENCH SETTEE



EXISTING CONDITIONS

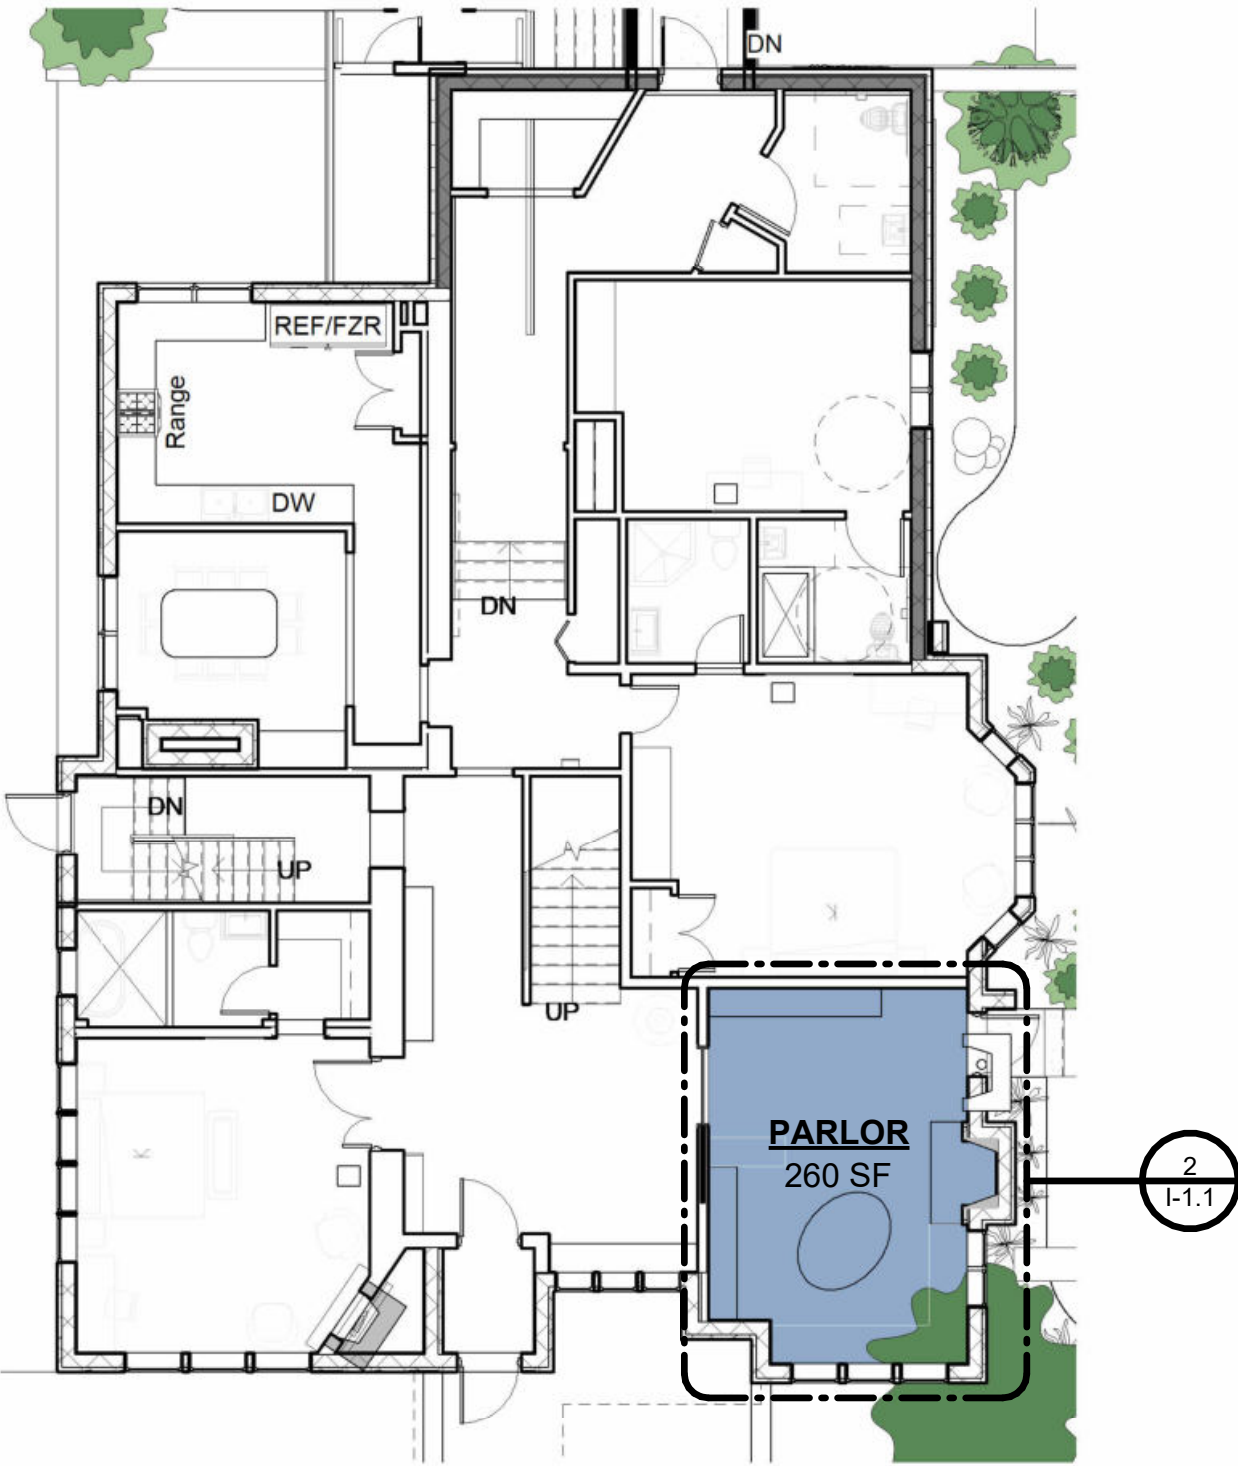

1 KEY PLAN - FF - PARLOR
A-3.0
1" = 10'-0"

infuz

ARCHITECTS + INNOVATORS

Port Huron Office

208 Huron Ave., Suite 1

Port Huron, MI 48130

Phone: 566.245.7604

Detroit Office

1111 Bellevue Ste 201

Detroit, MI 48207

Phone: 313.332.1299

Email: infuzltd@comcast.net

Web: infuzarchitects.com

Unauthorized use of this drawing set without written permission from VIRTUOSO DESIGN + BUILD and Infuz Ltd is in violation of U.S. COPYRIGHT LAWS and will be subject to civil damages and prosecution.

Revision Schedule		
#	Description	Date
1	Commercial Set	03/13/2025

NOT FOR CONSTRUCTION

BERKERY ESTATE
PROJECT NUMBER: Z24075
8325 E. JEFFERSON AVE
DETROIT, MI 48214
NIAL & MELVIE BERKERY
SHEET TITLE
FIRST FLOOR - PARLOR

SHEET NUMBER
I-1.1


DESIGN ELEMENTS:




INSPIRATION



KITCHEN

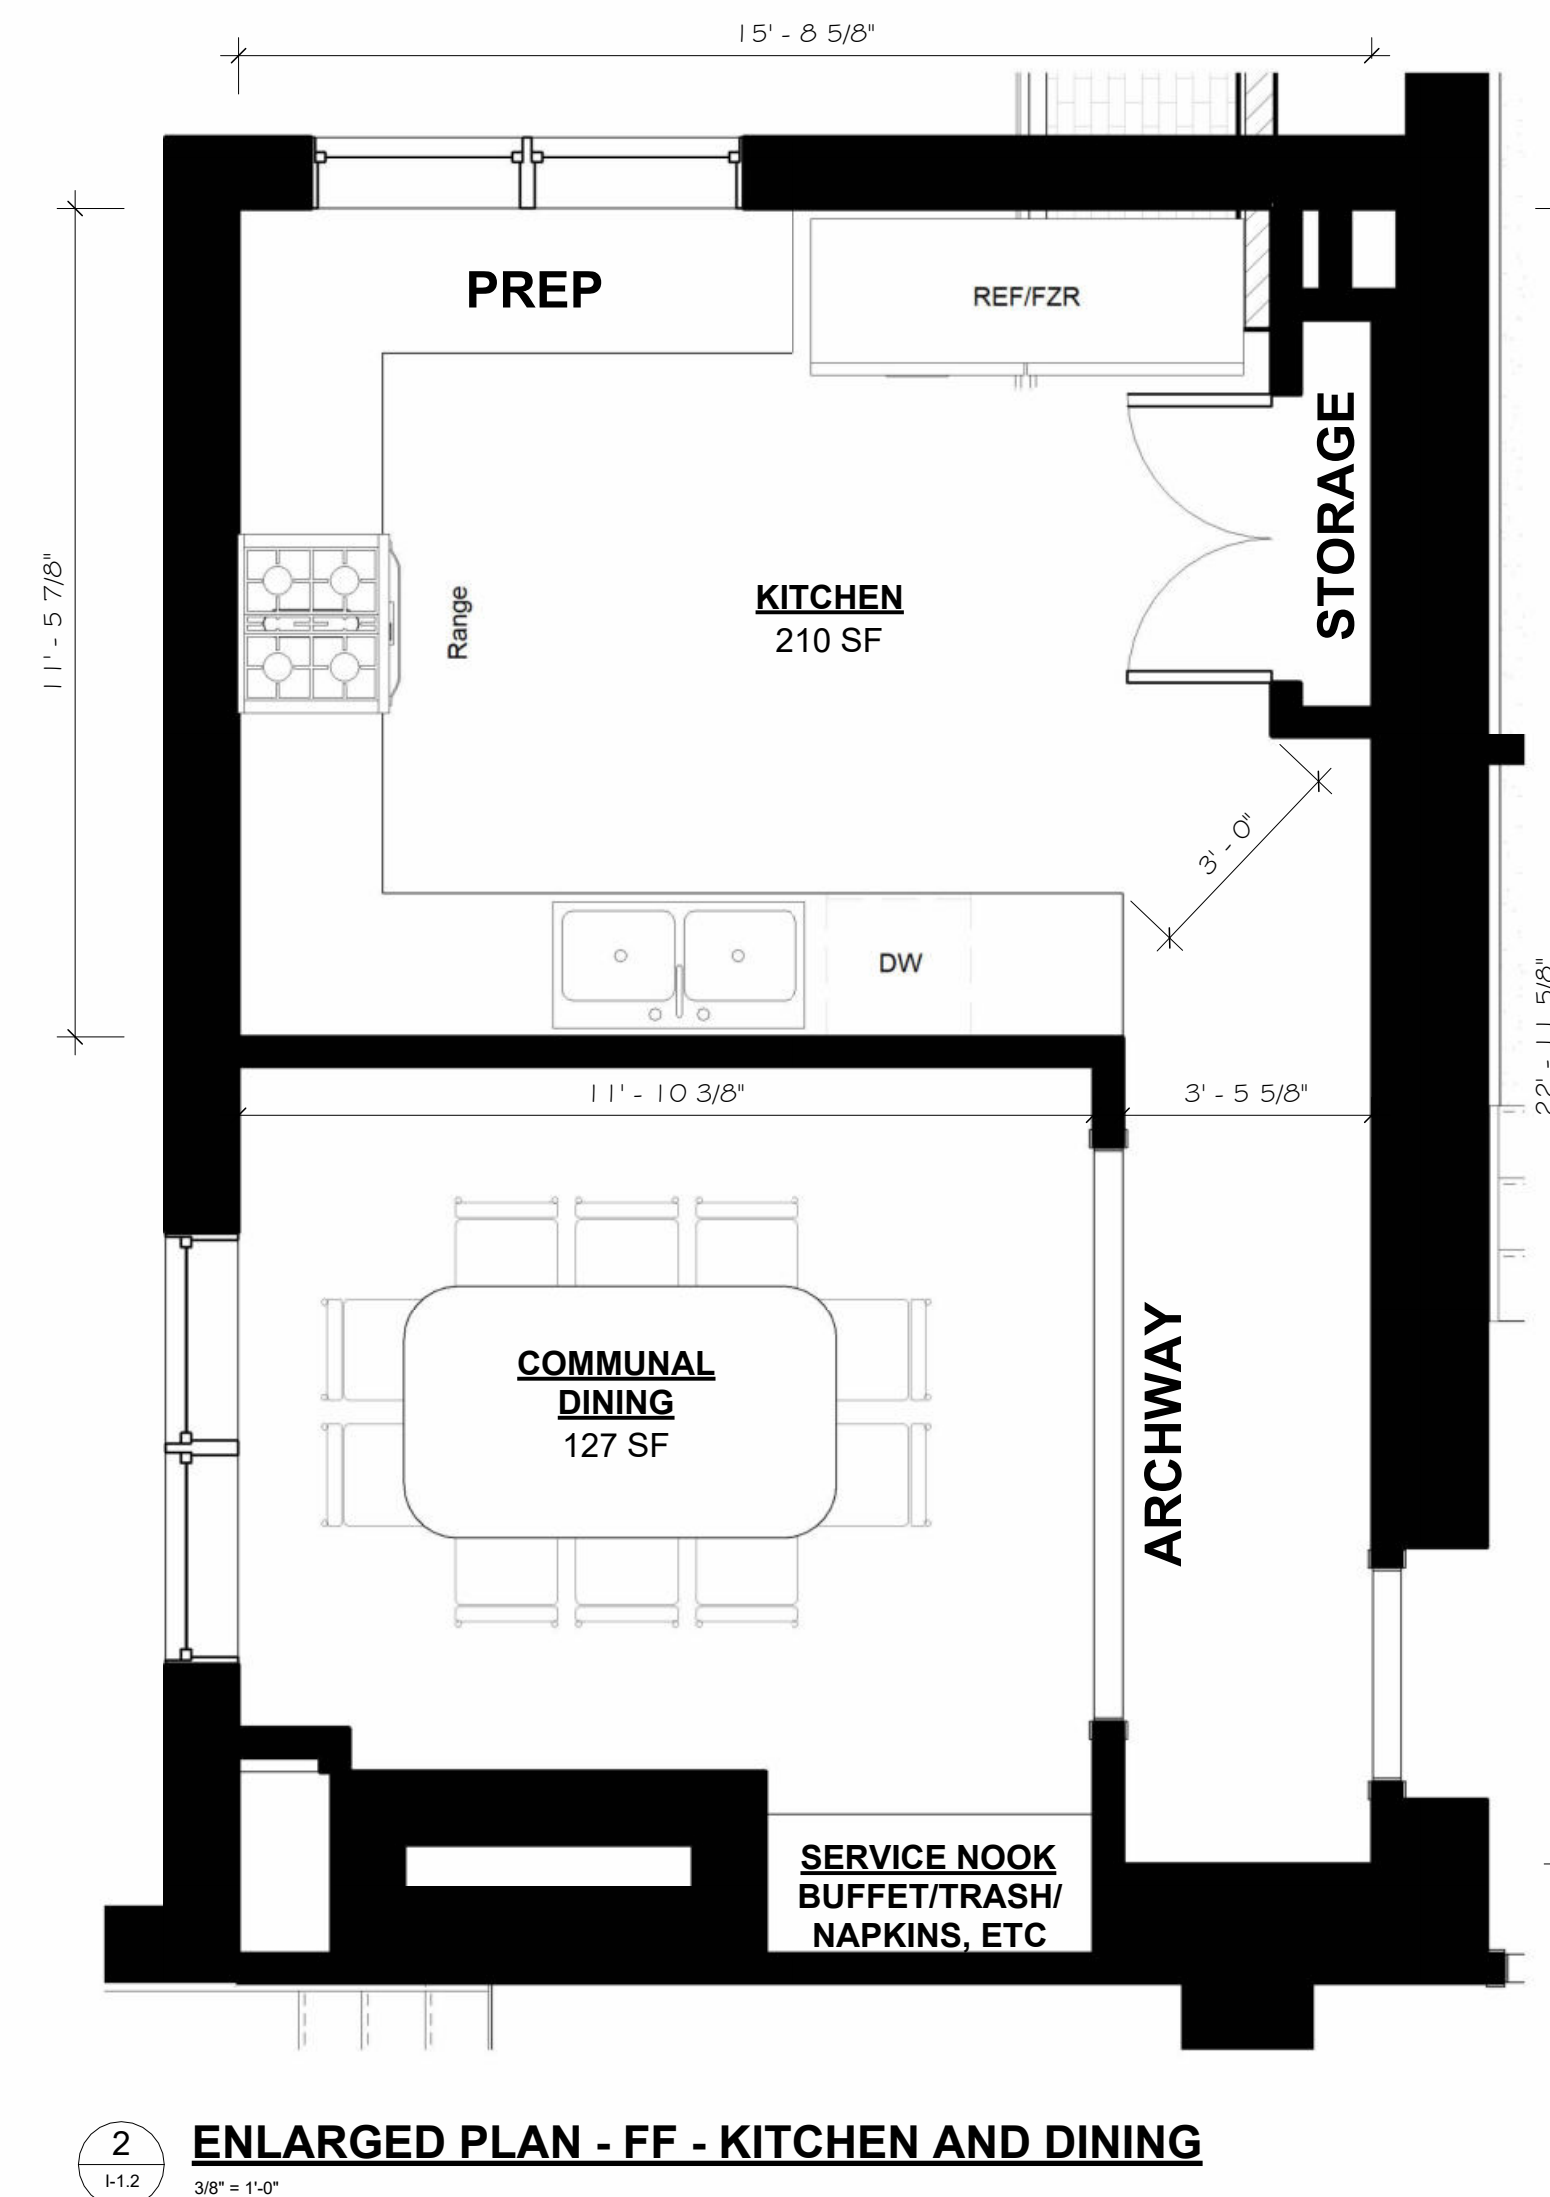

EXISTING CONDITIONS

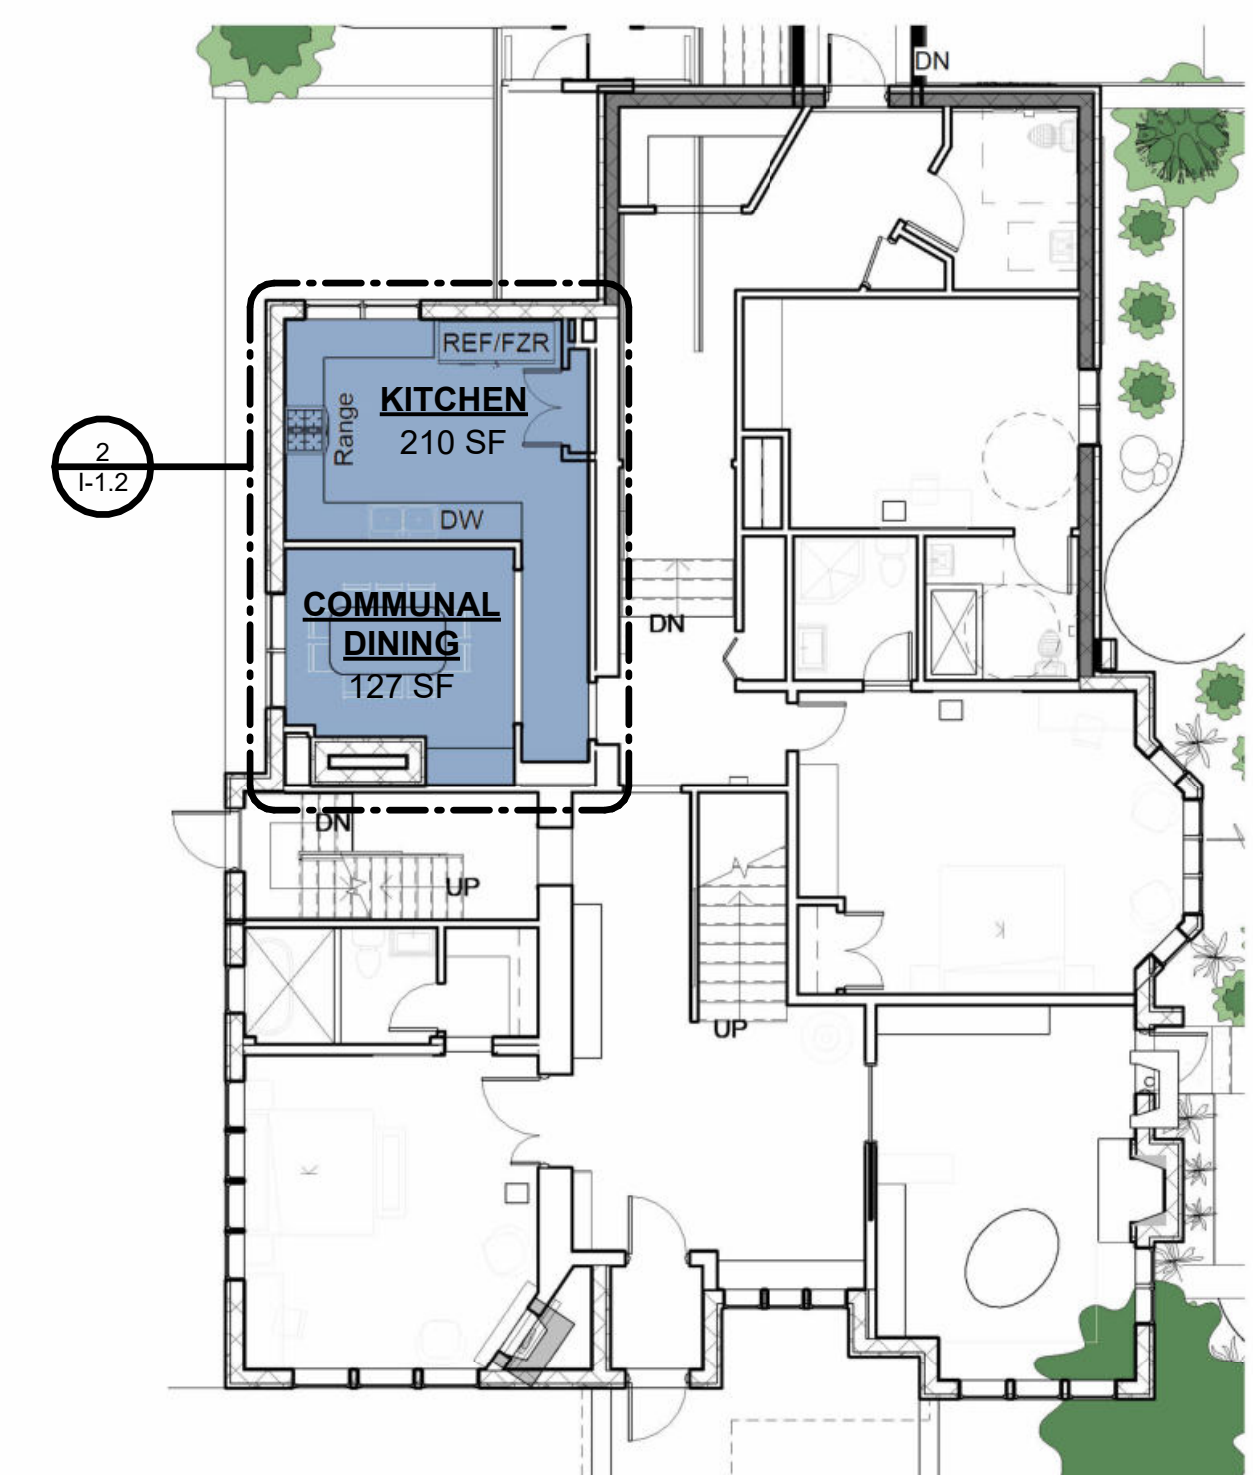

1 KEY PLAN - FF - KITCHEN AND DINING
A-3.0 1" = 10'-0"

Unauthorized use of this drawing set without written permission from VIRTUOSO DESIGN + BUILD and Infuz Ltd is in violation of U.S. COPYRIGHT LAWS and will be subject to civil damages and prosecution.

Revision Schedule		
#	Description	Date
1	Commercial Set	03/13/2025

SEAL

**NOT FOR
CONSTRUCTION**

BERKERY ESTATE
PROJECT NUMBER: Z20075
8325 E JEFFERSON AVE
DETROIT, MI 48214
NIAL & MELVIE BERKERY
SHEET TITLE
FIRST FLOOR - KITCHEN AND DINING


SECOND FLOOR LOBBY INSPIRATION

DESIGN ELEMENTS:

- TRANSITION WOOD TRIM TO WHITE TRIM
- WALL TRIM TO ELEVATE SPACE
- LIGHT FLOORING AND AREA RUGS
- CONTEMPORARY LIGHT FIXTURES AND FURNITURE
- GALLERY WALL PROMOTING DETROIT COMMUNITIES




INSPIRATION

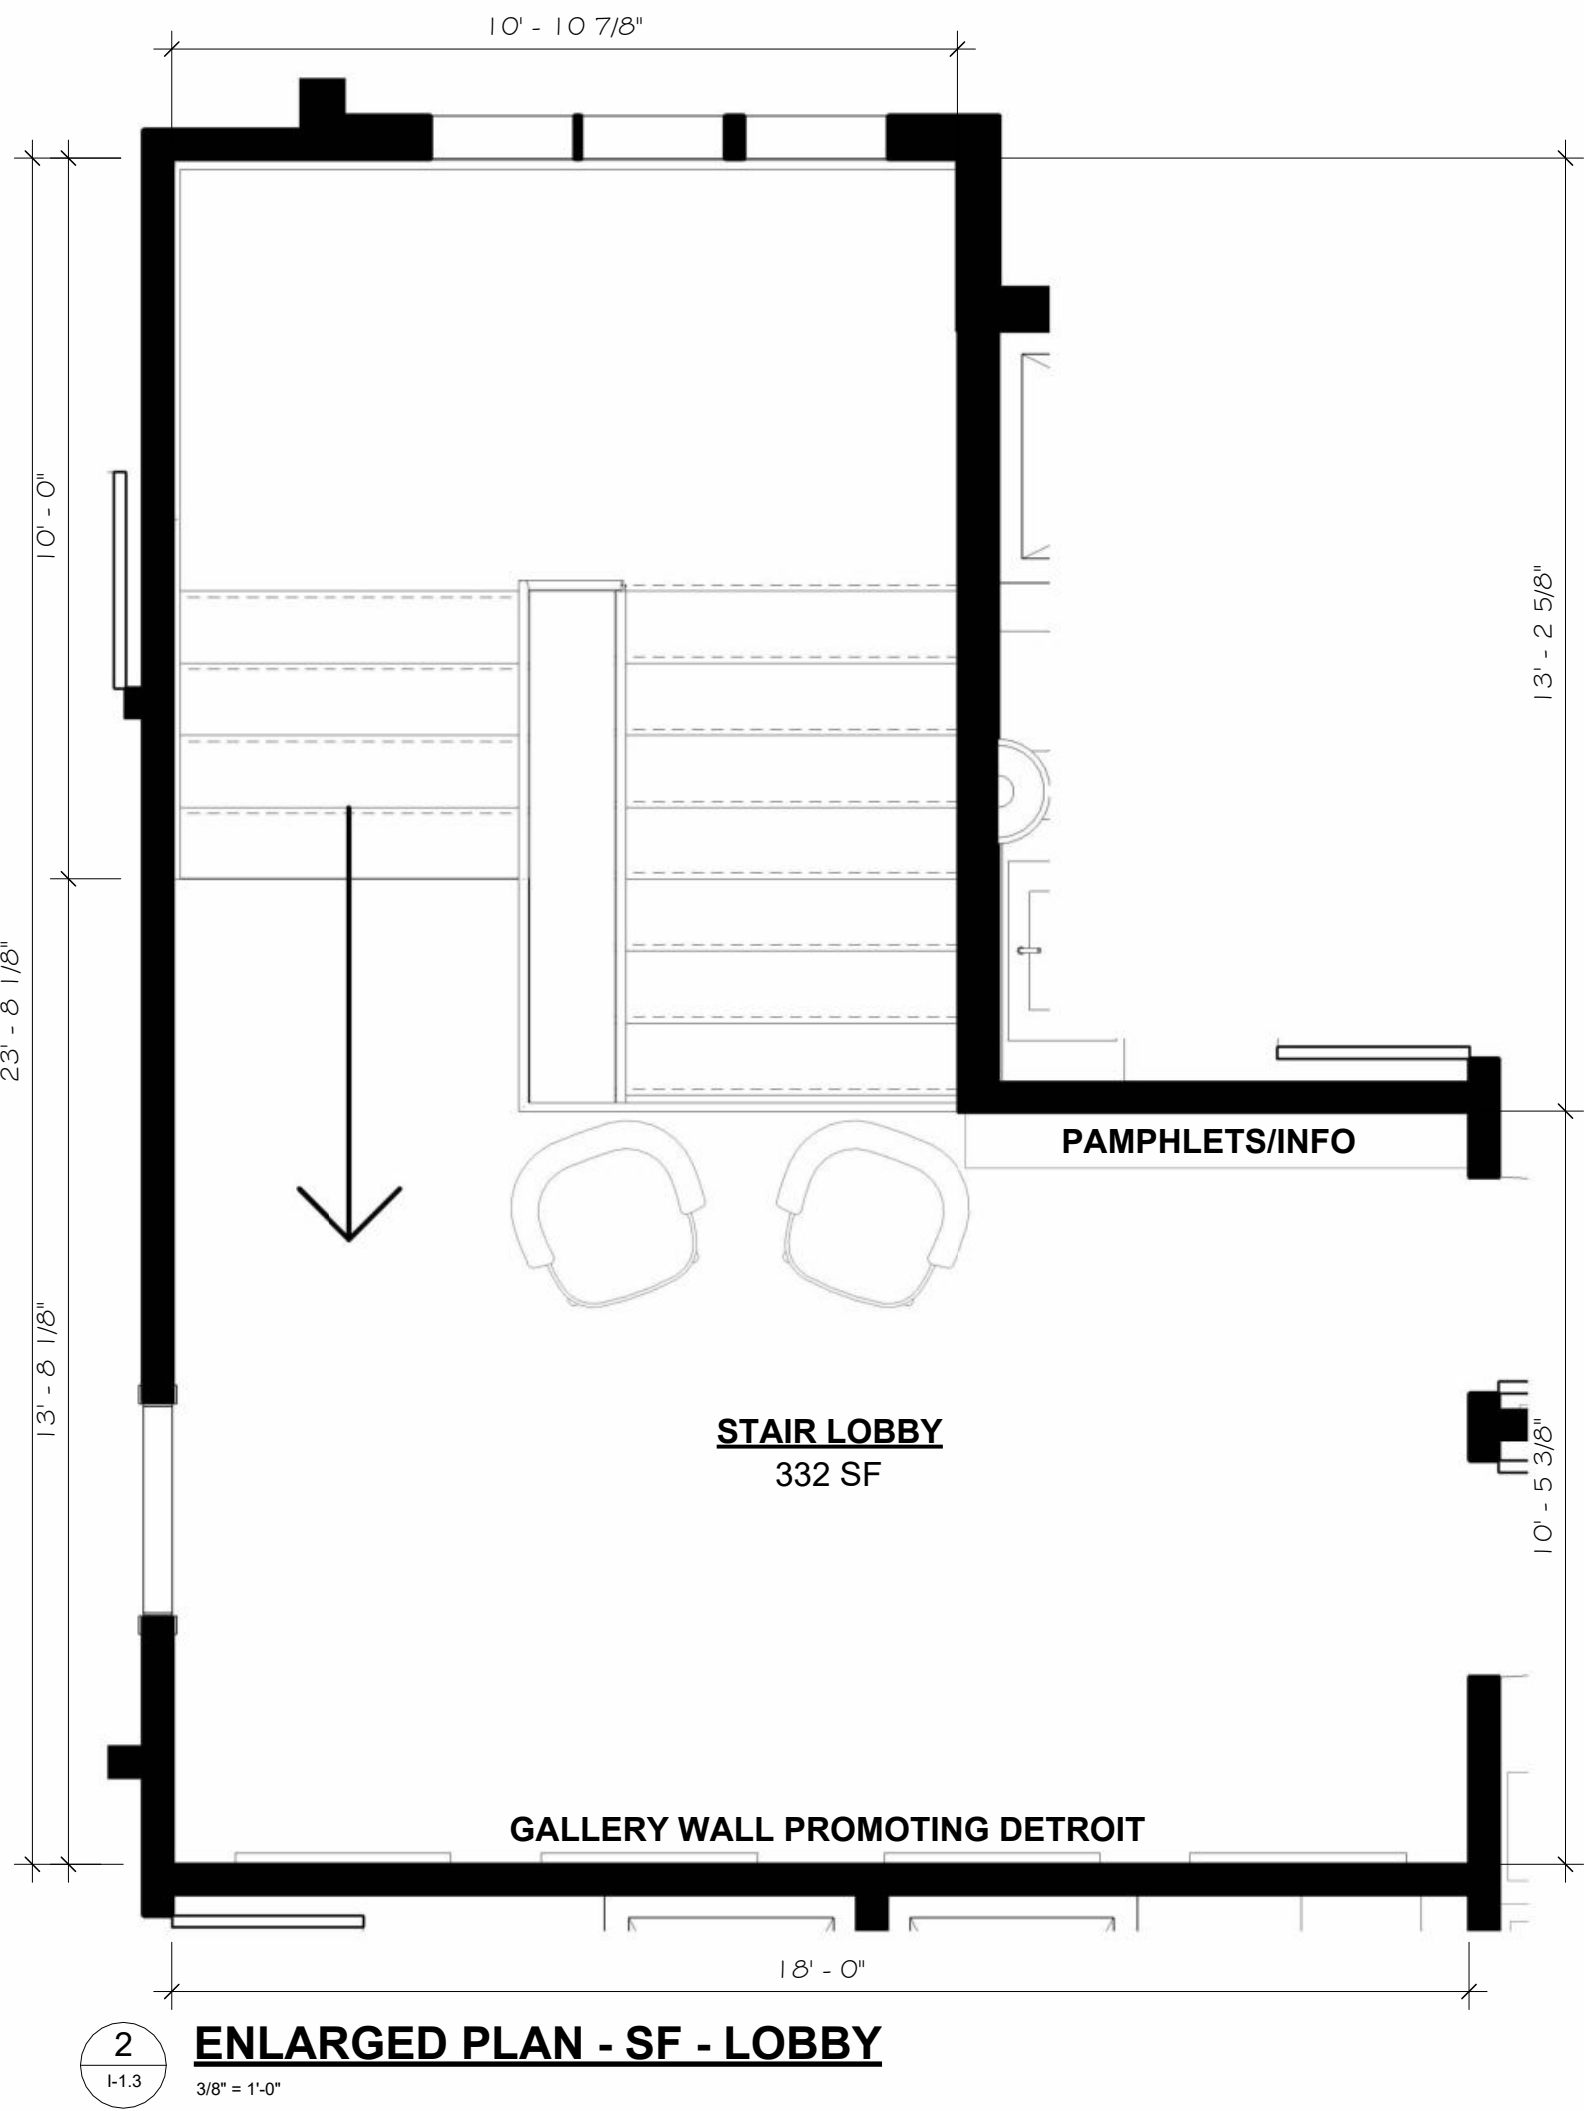


AMENTITIES:

- DETROIT GALLERY WALL
- BENCH SEATING BELOW GALLERY WALL
- FREE FLOATING STOOLS FOR SEATING
- PAMPHLET/INFORMATION STAND CORRESPONDING TO DETROIT GALLERY WALL

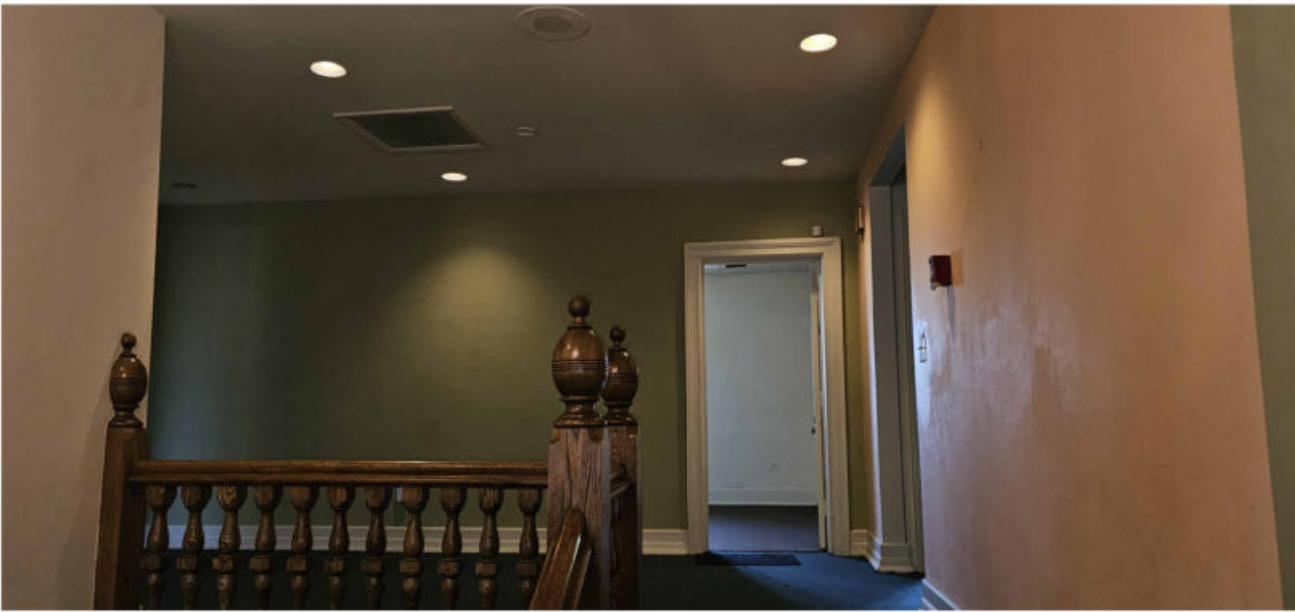

EXISTING CONDITIONS

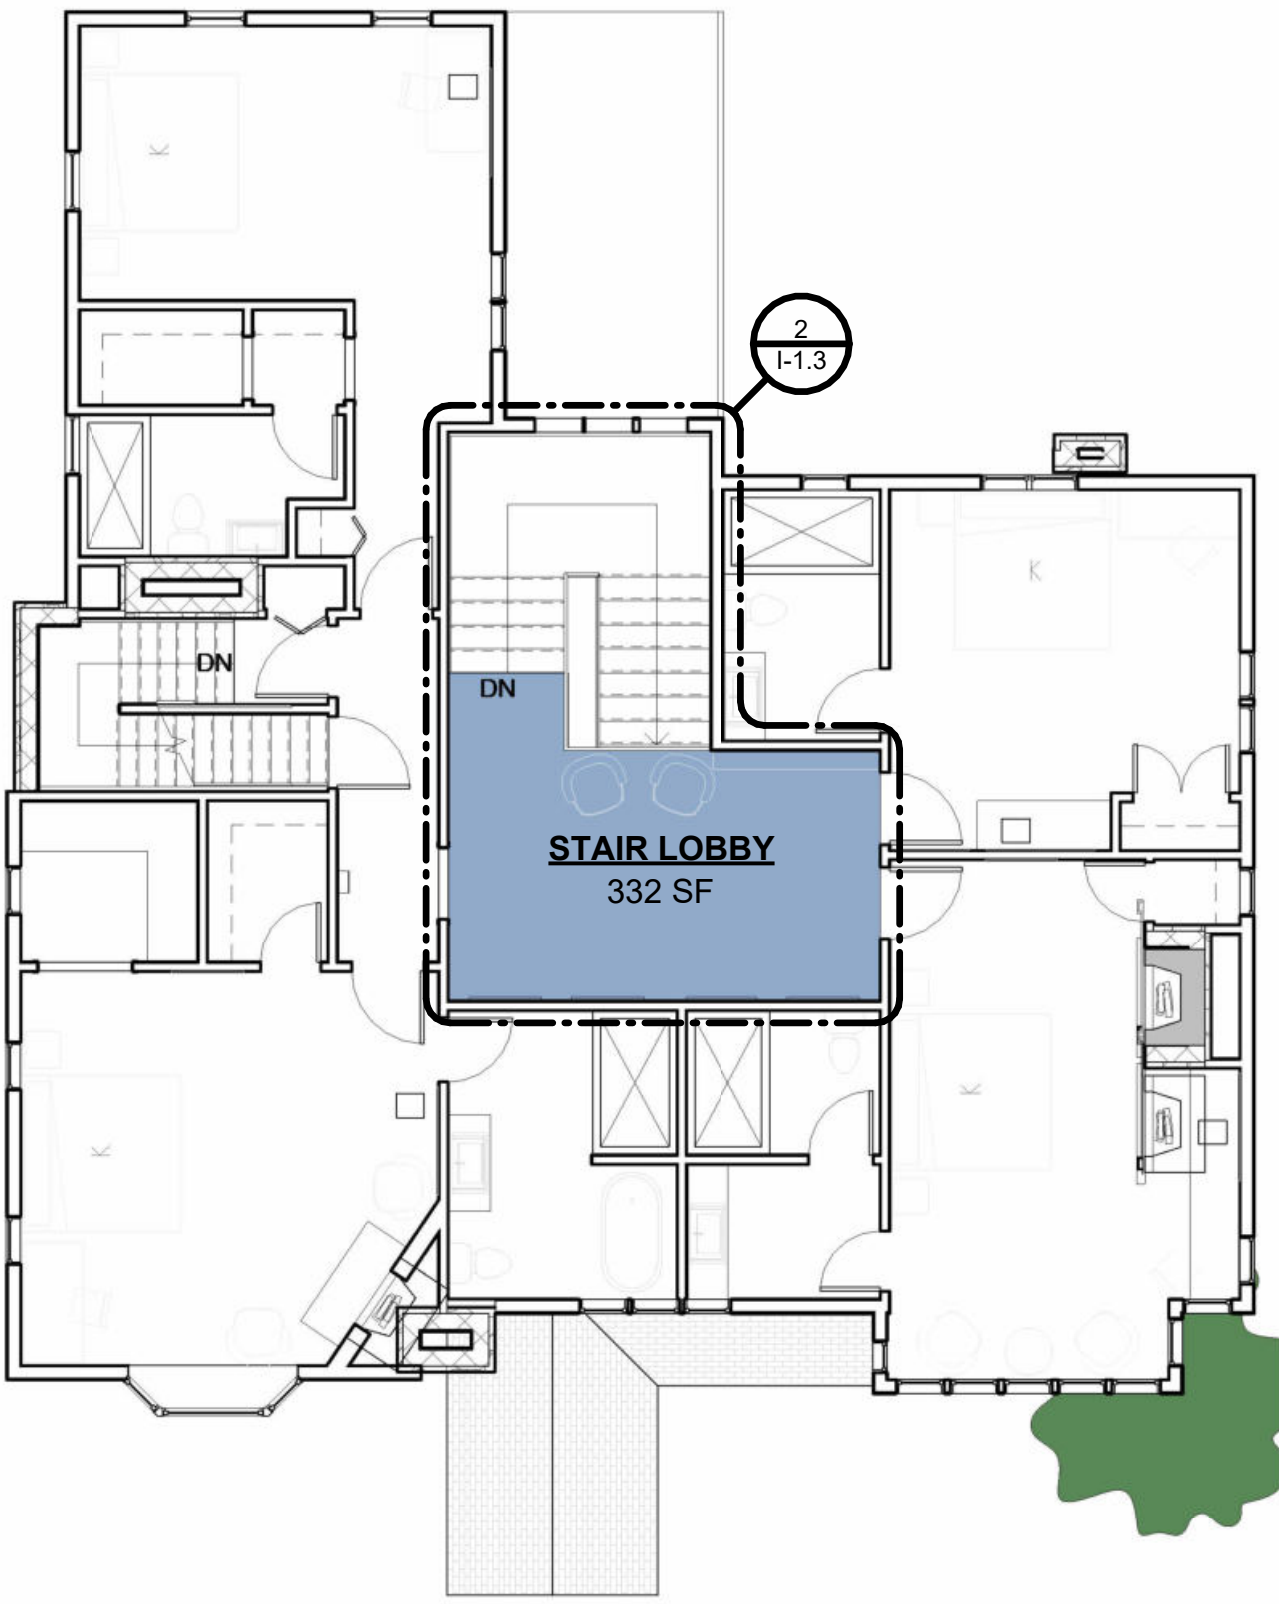

KEY PLAN - SF - LOBBY

Unauthorized use of this drawing set without written permission from VIRTUOSO DESIGN + BUILD and Infuz Ltd is in violation of U.S. COPYRIGHT LAWS and will be subject to civil damages and prosecution.

Revision Schedule		
#	Description	Date
1	Commercial Set	03/13/2025

NOT FOR CONSTRUCTION

BERKERY ESTATE
PROJECT NUMBER: Z24075
8325 E. JEFFERSON AVE
DETROIT, MI 48214
NIAL & MELVIE BERKERY
SHEET TITLE
SECOND FLOOR - LOBBY

SHEET NUMBER
I-1.3

FIRST FLOOR

GUEST ROOM 1

PALM/COASTAL

DESIGN ELEMENTS:

- WHITE, BROWN, AND GREEN COLOR PALETTE
- WHITE WALLS WITH A DARK ACCENTS AND ACCENT WALL
- PALM/COASTAL WALL DECALS WITH TROPICAL PLANTINGS
- PALM/COASTAL ARTWORK AND AREA RUG
- HISTORIC BUT COMPLEMENTING FURNITURE WITH A MIX OF CONTEMPORARY FIXTURES




INSPIRATION



CONCEPTUAL RENDERING


AMENITIES	
Key Value	Keynote Text
1	VANITY WITH STORAGE
2	FREE-STANDING TUB IN SHOWER AREA/WET ROOM
4	TOILET WITH STORAGE ABOVE
5	STORAGE
6	KING BED WITH NIGHTSTANDS
7	DESK
8	FIREPLACE
10	MINI-FRIDGE/BAR AREA
13	FLAT-SCREEN TV
15	FULL HEIGHT MIRROR
18	CUSTOM BUILT-IN FOR SAFE AND IRONING BOARD, WITH STORAGE ABOVE

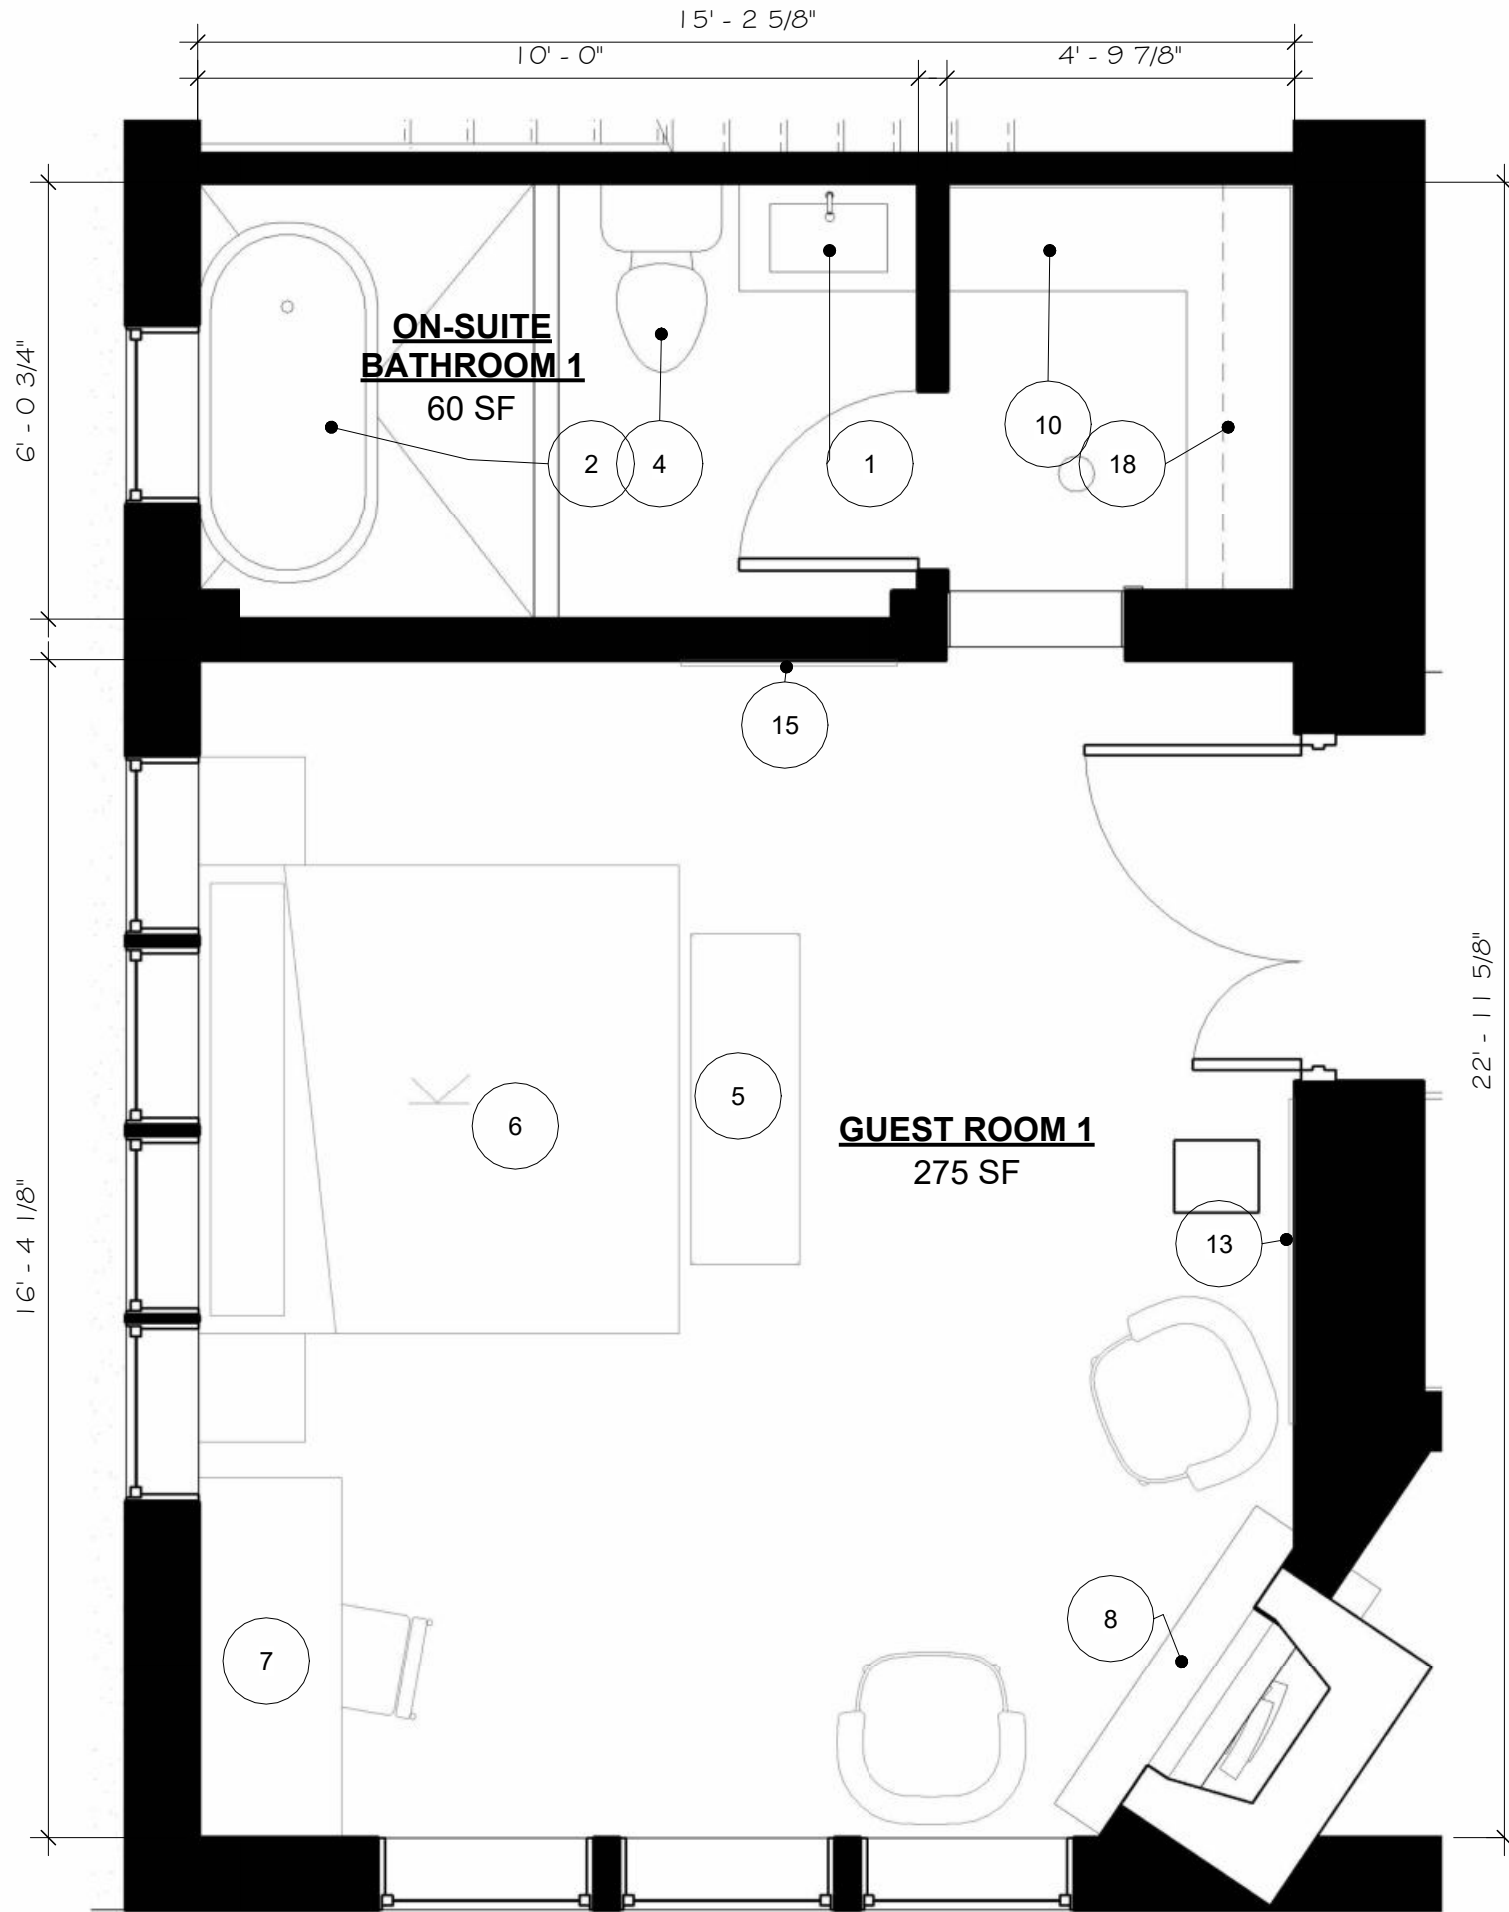

2 ENLARGED PLAN - FF - GUEST ROOM 1
1/2.0 3/8" = 1'-0"



EXISTING CONDITIONS

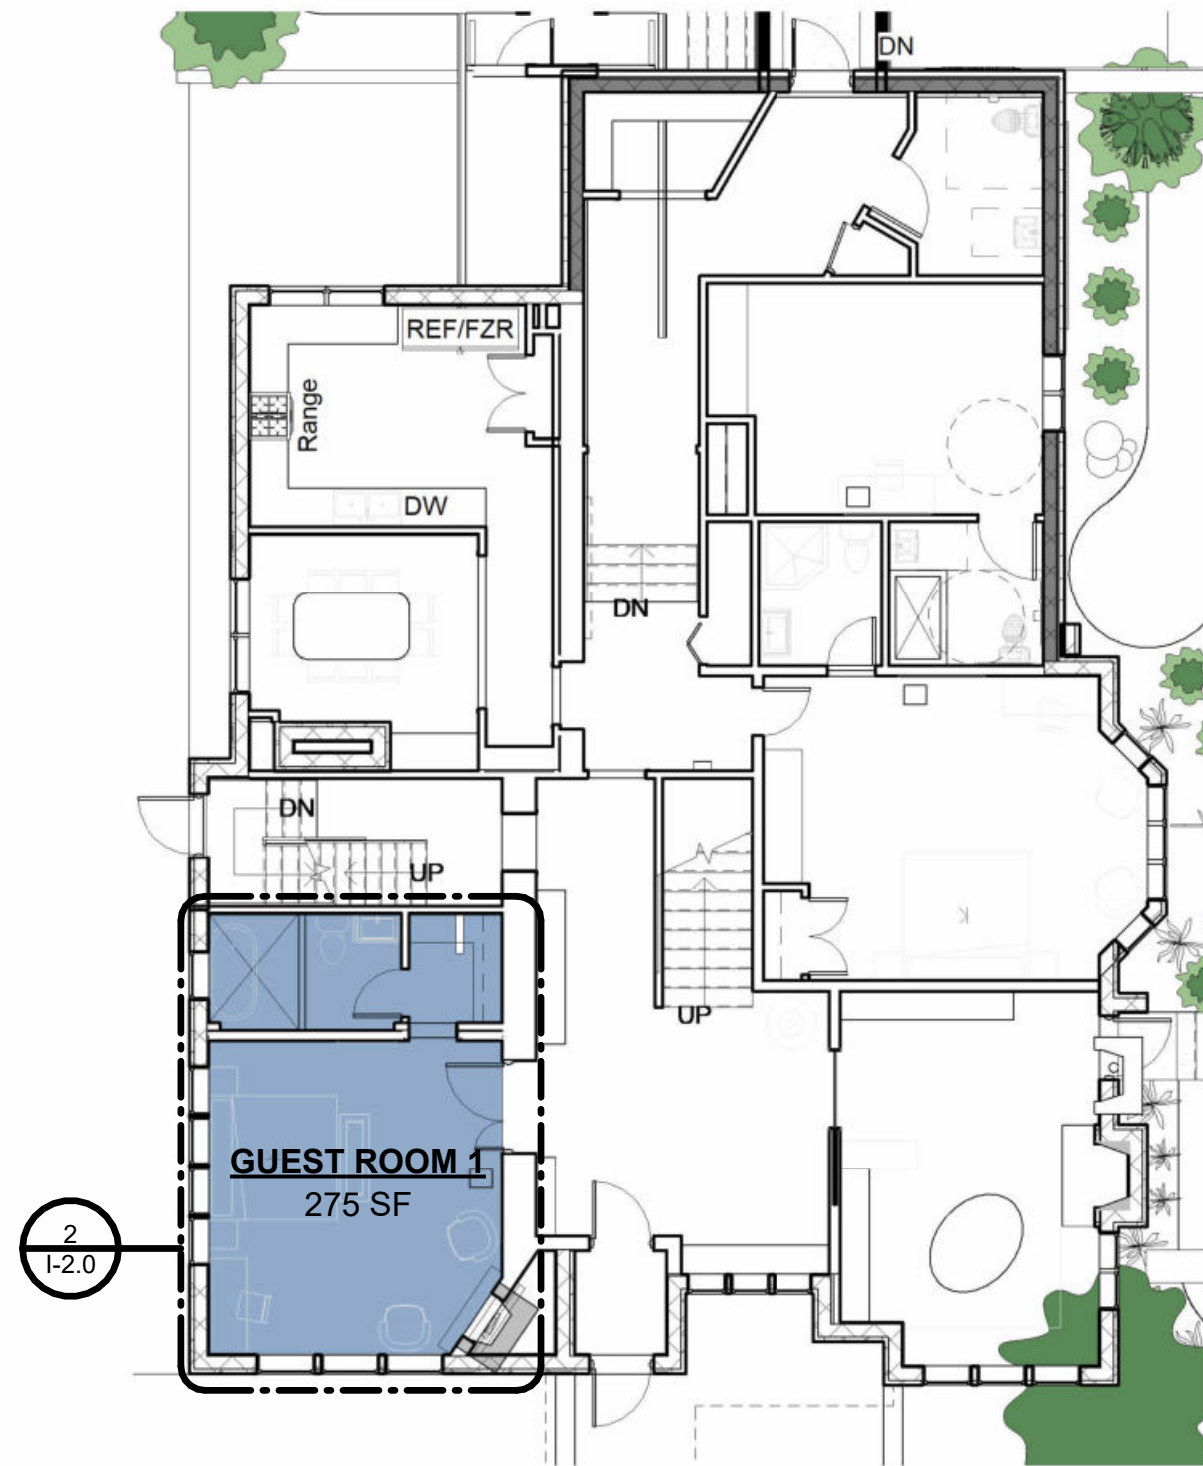

1 KEY PLAN - FF - GUEST ROOM 1
A-3.0 1" = 10'-0"

Revision Schedule		
#	Description	Date
1	Commercial Set	03/13/2025

Unauthorized use of this drawing set without written permission from VIRTUOSO DESIGN + BUILD and Infuz Ltd is in violation of U.S. COPYRIGHT LAWS and will be subject to civil damages and prosecution.

Revision Schedule		
#	Description	Date
1	Commercial Set	03/13/2025

NOT FOR CONSTRUCTION

3/14/2025 1:38:54 PM

BERKERY ESTATE
PROJECT NUMBER: Z4405
8325 E. JEFFERSON AVE
DETROIT, MI 48214
NIAL & MELVIE BERKERY
SHEET TITLE
FIRST FLOOR - GUEST ROOM 1
SHEET NUMBER

I-2.0

FIRST FLOOR

GUEST ROOM 2

SAFARI

DESIGN ELEMENTS:

- WHITE, BROWN, AND GREEN COLOR PALETTE
- WHITE WALLS WITH A DARK ACCENTS AND ACCENT WALL
- ANIMAL PRINT, ARTWORK, AND SCULPTURES
- HISTORIC BUT COMPLEMENTING FURNITURE WITH A MIX OF CONTEMPORARY FIXTURES




INSPIRATION



CONCEPTUAL RENDERING


AMENITIES	
Key Value	Keynote Text
1	VANITY WITH STORAGE
3	WALK IN SHOWER
4	TOILET WITH STORAGE ABOVE
6	KING BED WITH NIGHTSTANDS
7	DESK
10	MINI-FRIDGE/BAR AREA
11	WINE RACK AND LOCKABLE LIQUOR CABINET
13	FLAT-SCREEN TV
15	FULL HEIGHT MIRROR
18	CUSTOM BUILT-IN FOR SAFE AND IRONING BOARD, WITH STORAGE ABOVE

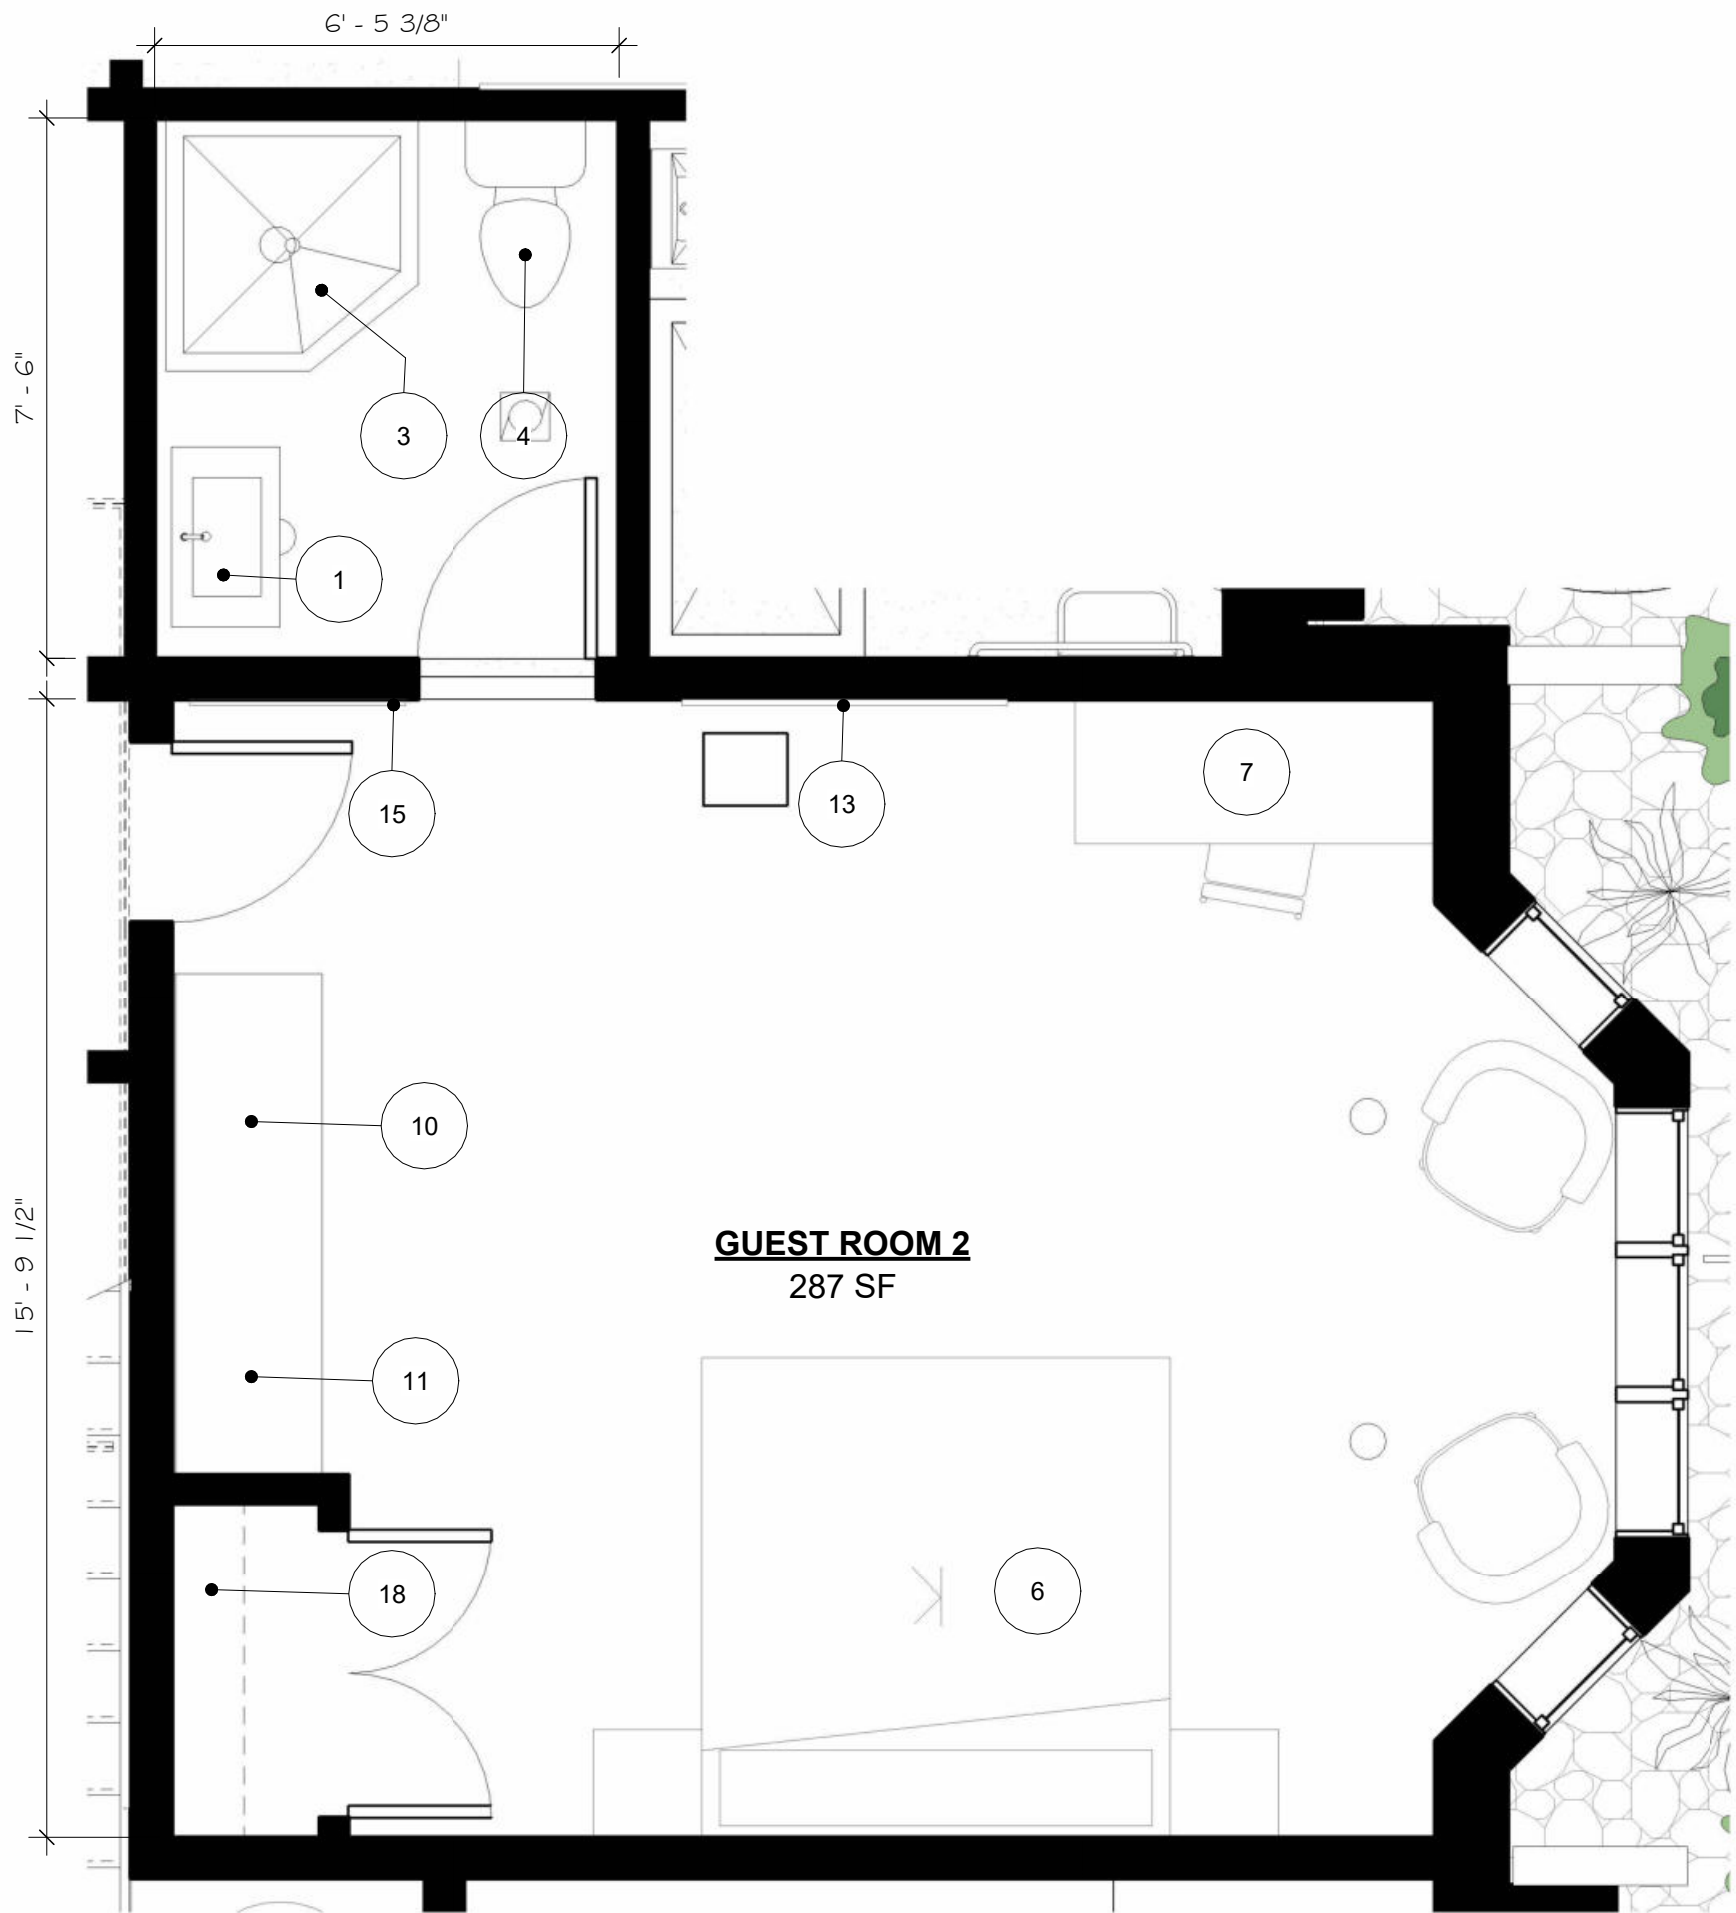


2 ENLARGED PLAN - FF - GUEST ROOM 2



EXISTING CONDITIONS

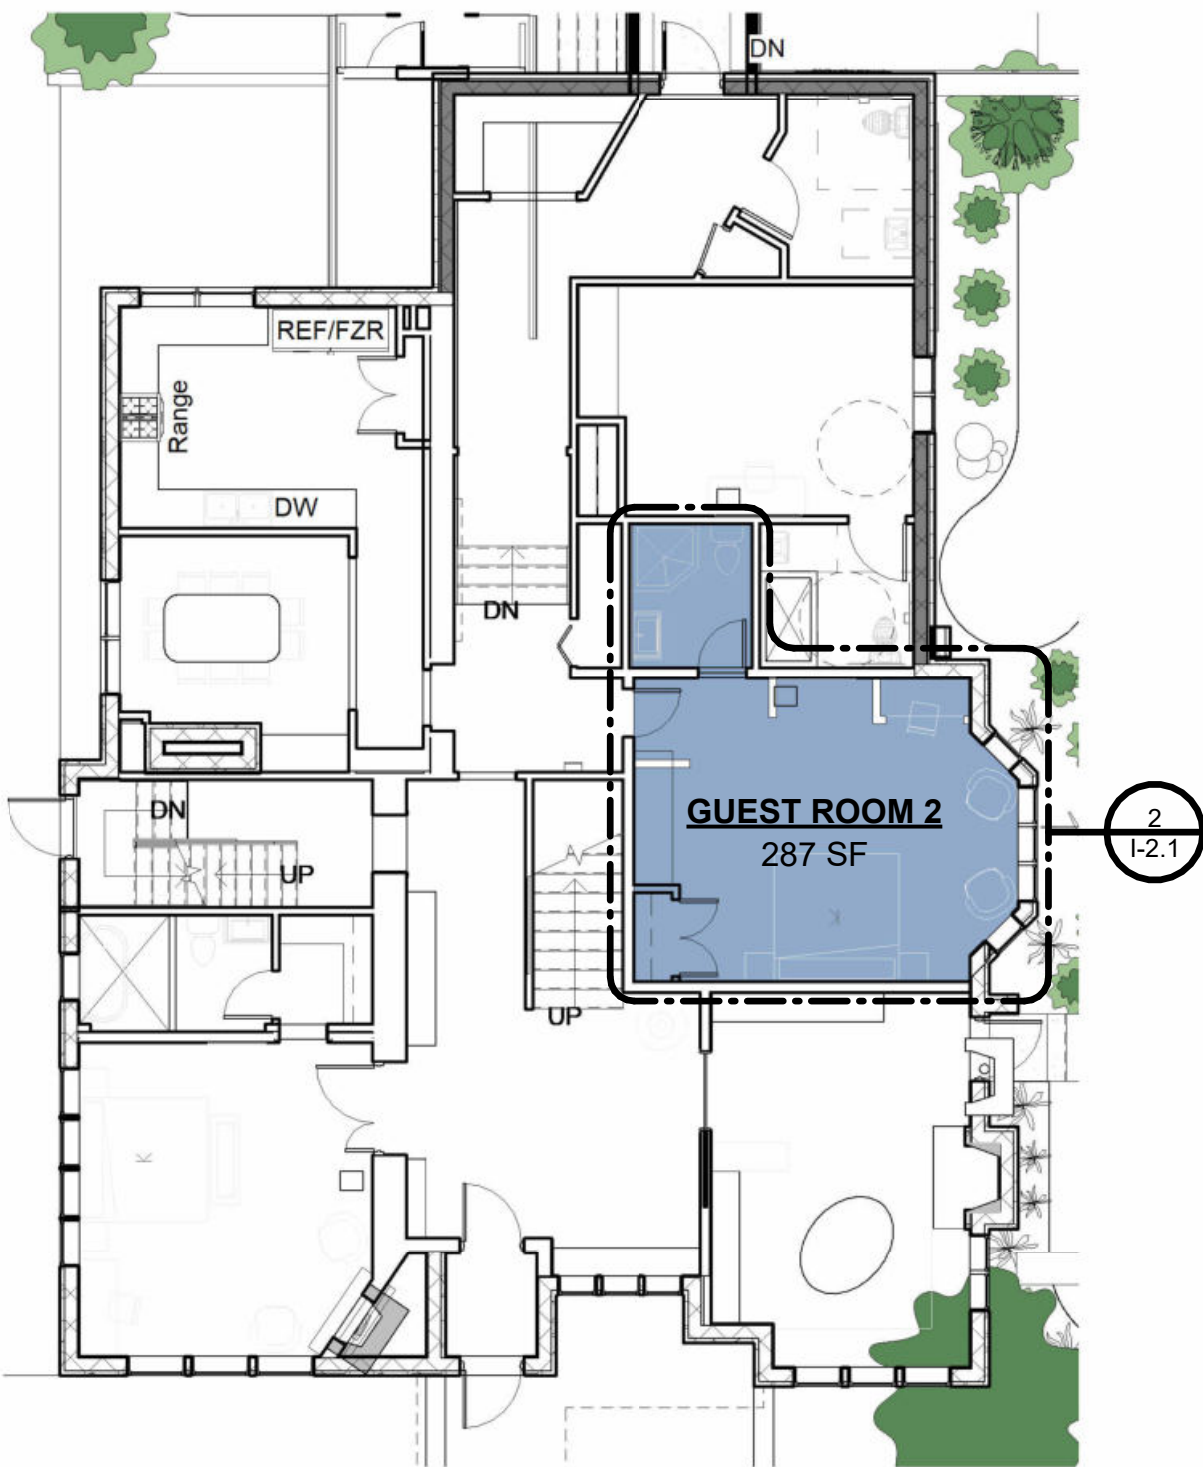

1 KEY PLAN - FF - GUEST ROOM 2

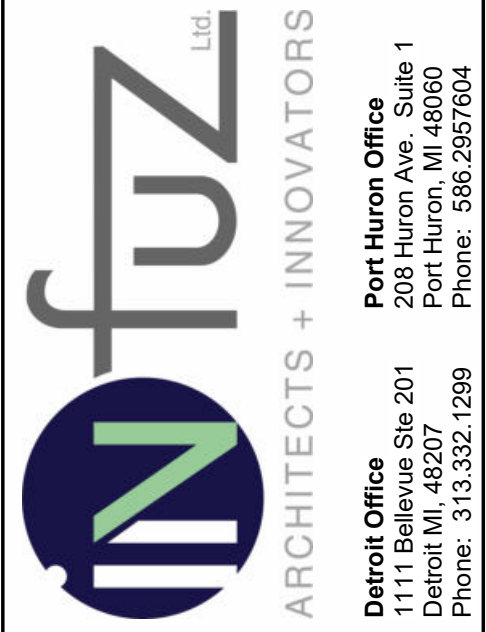

Port Huron Office
208 Huron Ave., Suite 1
Port Huron, MI 48130
Phone: 513.332.1299
Email: infuzltd@comcast.net
Web: infuzarchitects.com

Unauthorized use of this drawing set without written permission from VIRTUOSO DESIGN + BUILD and infuz Ltd is in violation of U.S. COPYRIGHT LAWS and will be subject to civil damages and prosecution.

Revision Schedule		
#	Description	Date
1	Commercial Set	03/13/2025

NOT FOR CONSTRUCTION

03/13/2025

BERKERY ESTATE
PROJECT NUMBER: Z24075
8325 E. JEFFERSON AVE
DETROIT, MI 48214
NIAL & MELVIE BERKERY
SHEET TITLE
FIRST FLOOR - GUEST ROOM 2

SHEET NUMBER

I-2.1

FIRST FLOOR

GUEST ROOM 3

ASIAN/CHERRY BLOSSOM

DESIGN ELEMENTS:

- WHITE, DEEP RED, DEEP GREEN, DEEP ORANGE COLOR PALETTE
- LIGHT WALLS WITH A DARK ACCENTS AND ACCENT WALL
- ASIAN INSPIRED ARTWORK, AND SCULPTURES
- HISTORIC BUT COMPLEMENTING FURNITURE WITH A MIX OF CONTEMPORARY FIXTURES




INSPIRATION



CONCEPTUAL RENDERING

AMENITIES	
Key Value	Keynote Text
1	VANITY WITH STORAGE
3	WALK IN SHOWER
4	TOILET WITH STORAGE ABOVE
7	DESK
10	MINI-FRIDGE/BAR AREA
11	WINE RACK AND LOCKABLE LIQUOR CABINET
13	FLAT-SCREEN TV
15	FULL HEIGHT MIRROR
18	CUSTOM BUILT-IN FOR SAFE AND IRONING BOARD, WITH STORAGE ABOVE

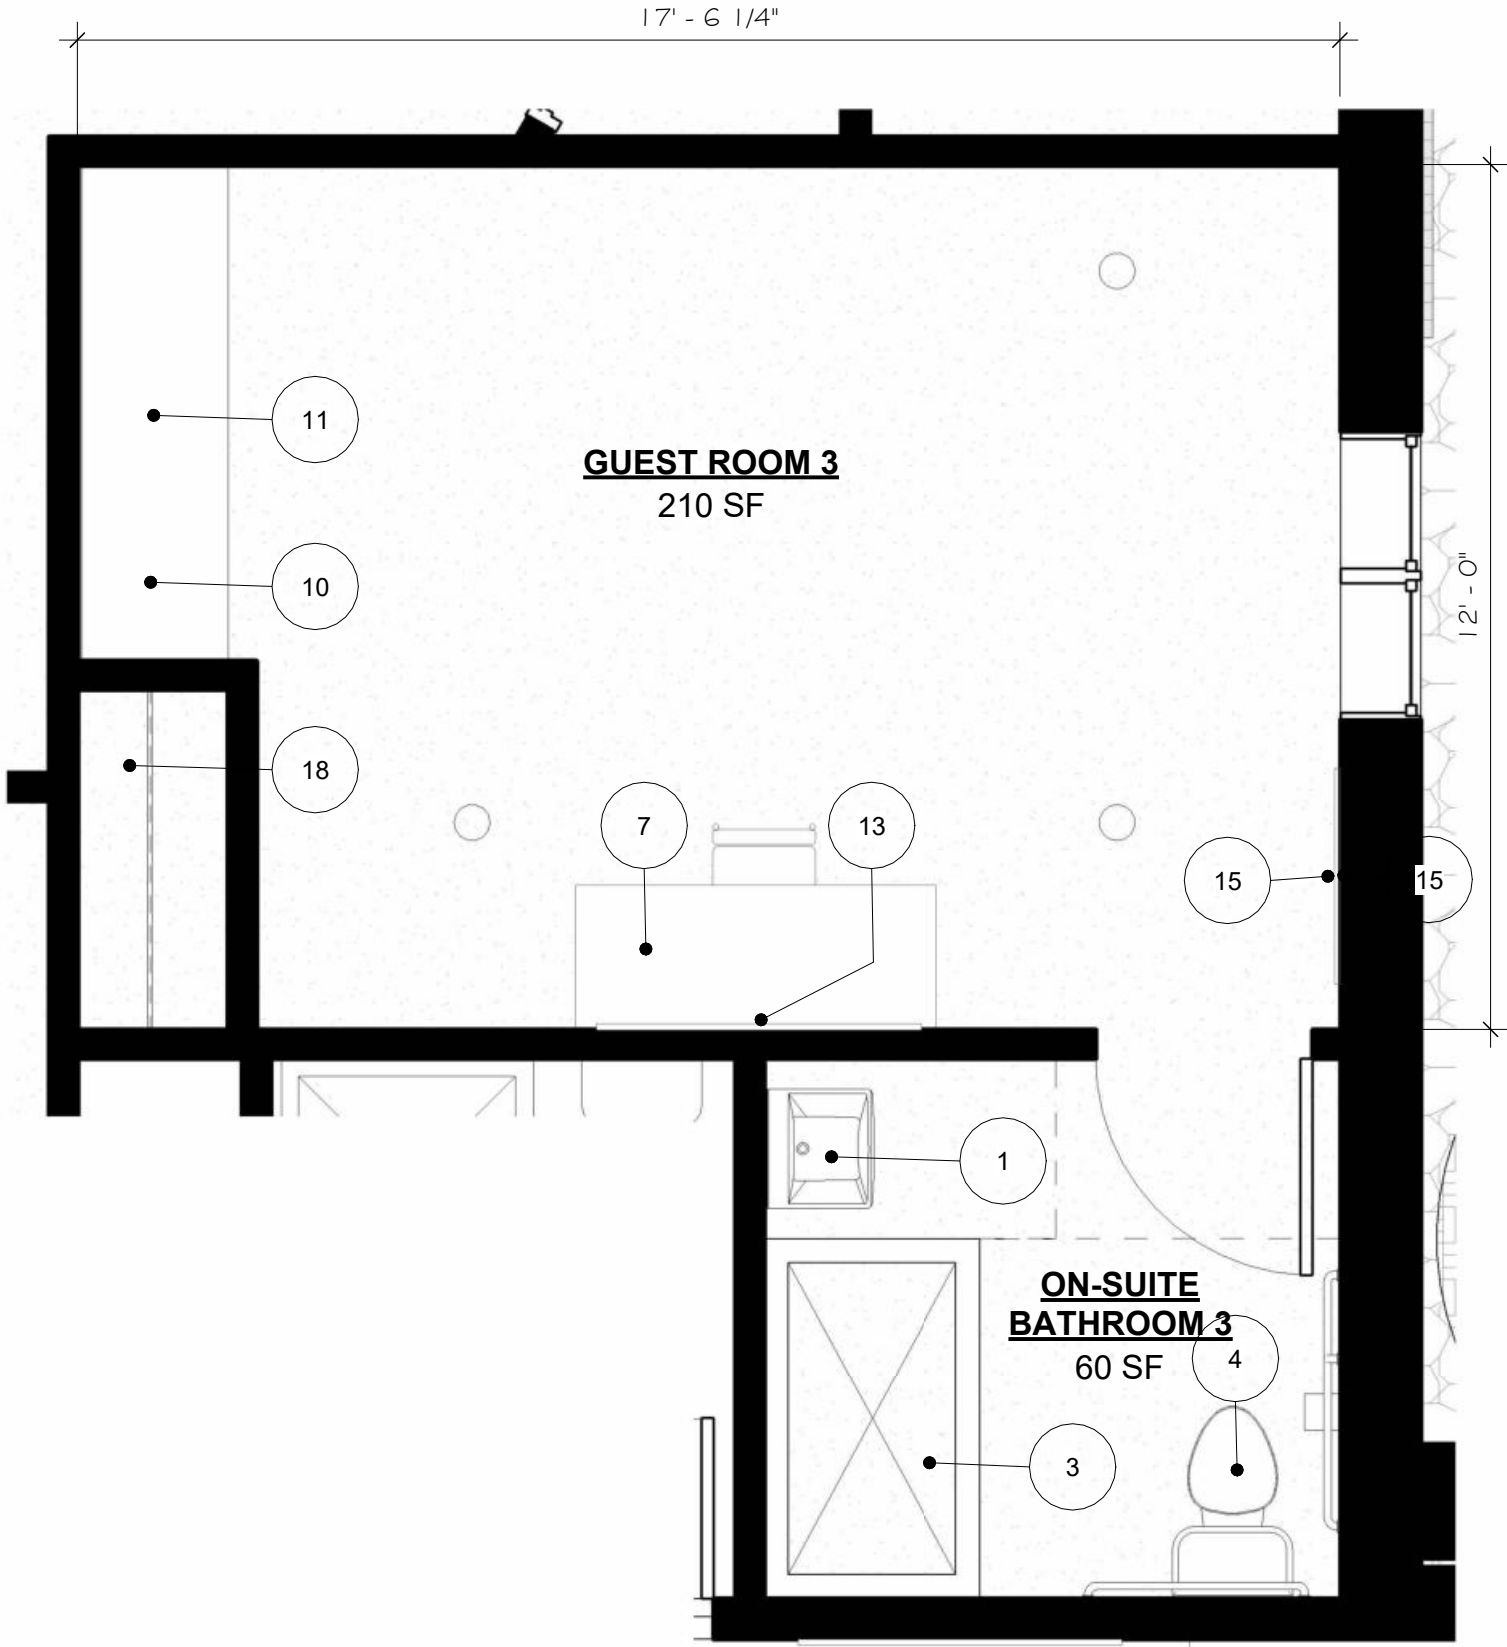


2
1:2.2
3/8" = 1'-0"

ENLARGED PLAN - FF - ADA GUEST ROOM 3



EXISTING CONDITIONS

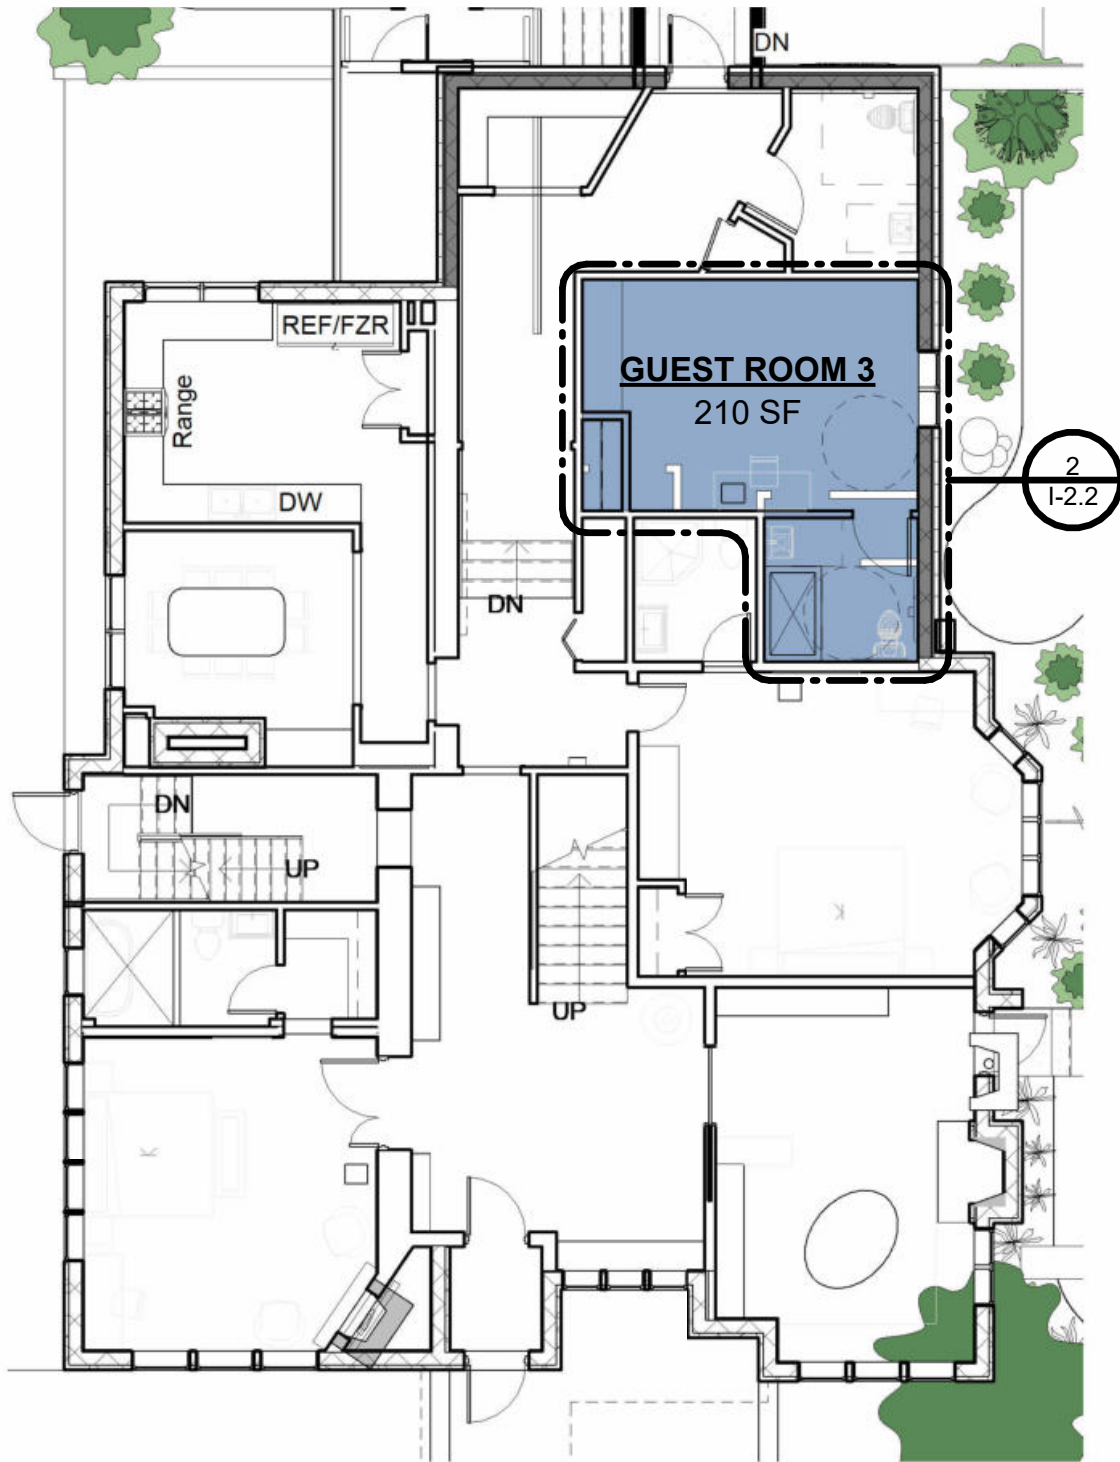

1
A-3.0
1" = 10'-0"

KEY PLAN - FF - GUEST ROOM 3

SECOND FLOOR GUEST ROOM 4 GARDEN/FLORAL

DESIGN ELEMENTS:

- WHITE, GREEN, DEEP RED, PLUSH COLOR PALETTE
- LIGHT WALLS WITH A DARK ACCENTS AND ACCENT WALL
- FLORAL ARTWORK, AND SCULPTURES
- HISTORIC BUT COMPLEMENTING FURNITURE WITH A MIX OF CONTEMPORARY FIXTURES





INSPIRATION



CONCEPTUAL RENDERING

AMENITIES	
Key Value	Keynote Text
6	KING BED WITH NIGHTSTANDS
7	DESK
8	FIREPLACE
10	MINI-FRIDGE/BAR AREA
11	WINE RACK AND LOCKABLE LIQUOR CABINET
12	SINK AND COFFEE STATION
13	FLAT-SCREEN TV
15	FULL HEIGHT MIRROR
18	CUSTOM BUILT-IN FOR SAFE AND IRONING BOARD, WITH STORAGE ABOVE
19	CUSTOM BUILT-IN STORAGE

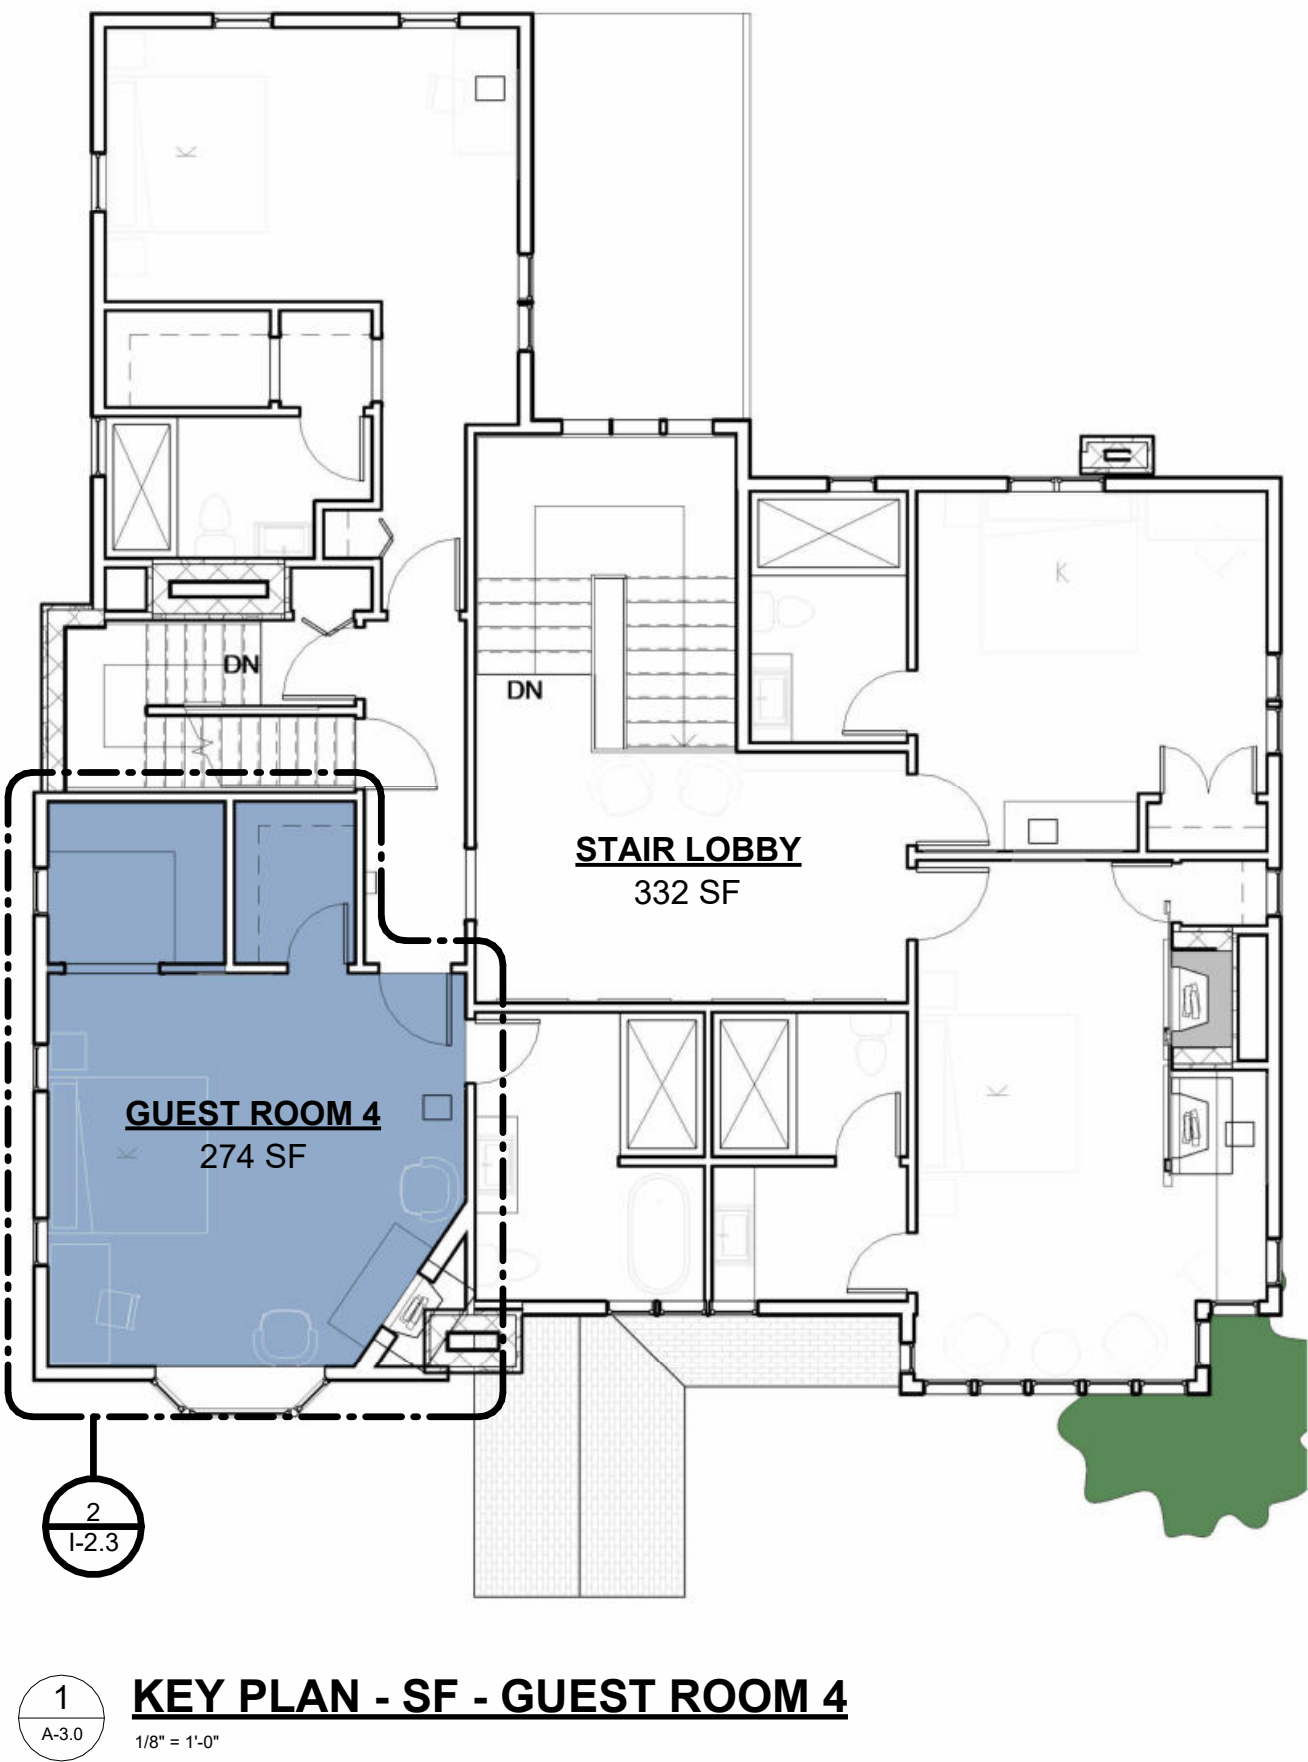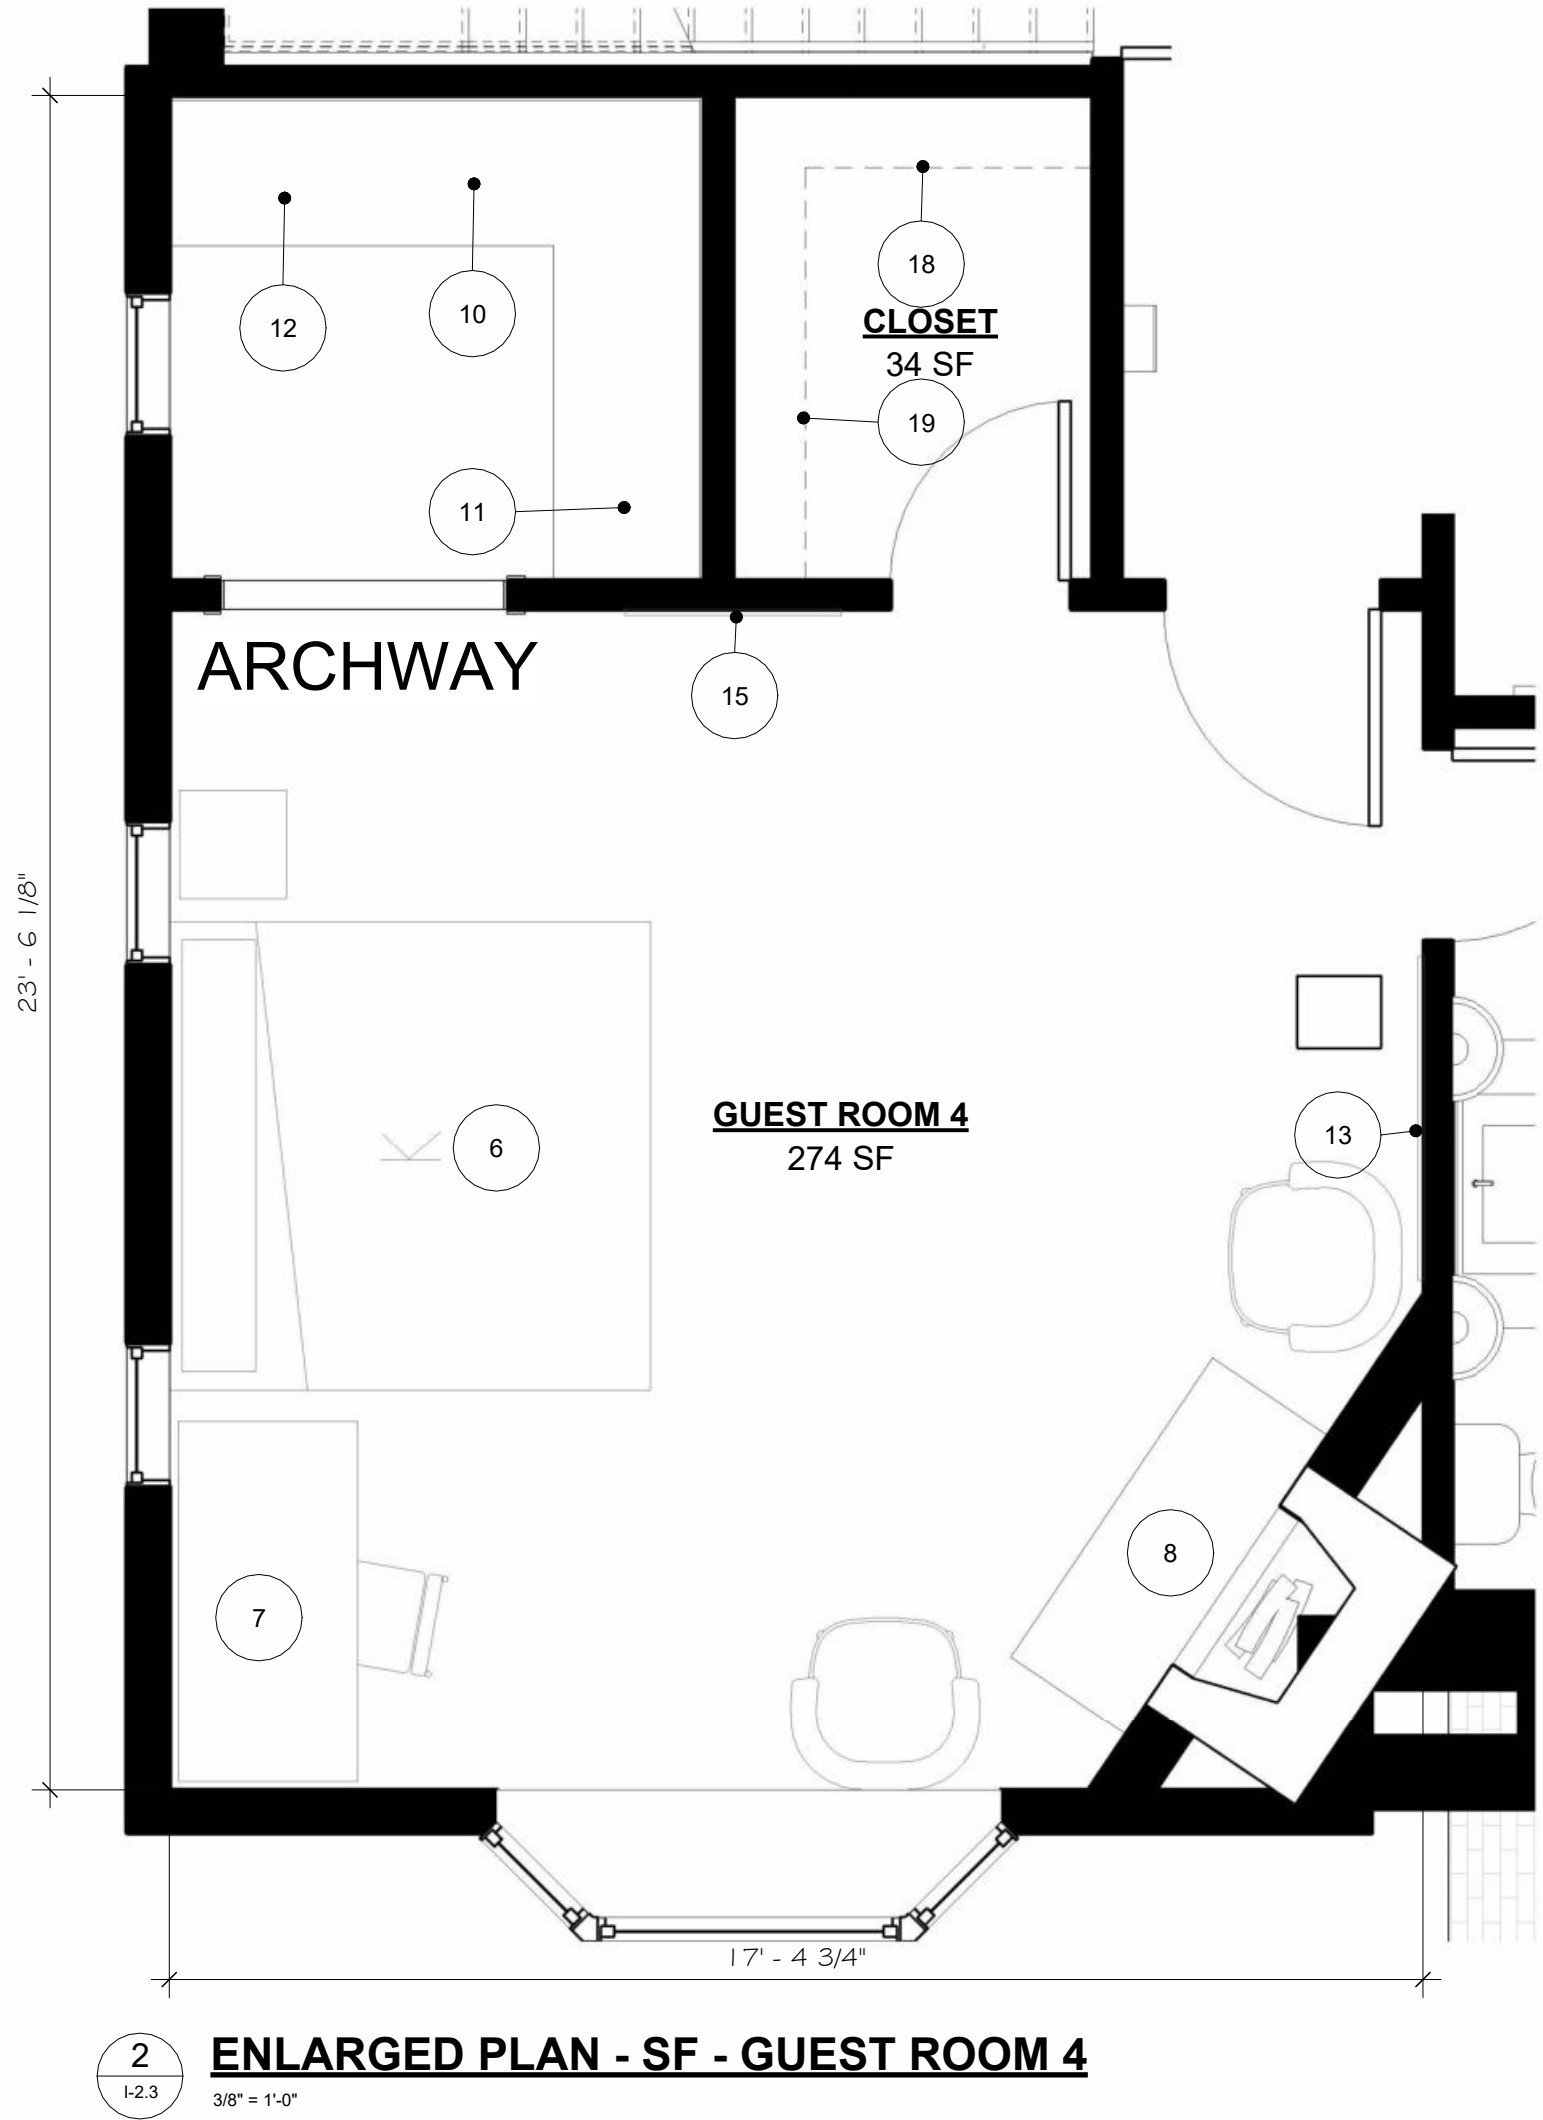

EXISTING CONDITIONS

Unauthorized use of this drawing set without written permission from VIRTUOSO DESIGN + BUILD and infuz Ltd is in violation of U.S. COPYRIGHT LAWS and will be subject to civil damages and prosecution.

Revision Schedule		
#	Description	Date
1	Commercial Set	03/13/2025

NOT FOR CONSTRUCTION

BERKERY ESTATE
PROJECT NUMBER: Z24075
8325 E. JEFFERSON AVE
DETROIT, MI 48214
NIAL & MELVIE BERKERY
SHEET TITLE
SECOND FLOOR - GUEST ROOM 4

SHEET NUMBER
I-2.3

SECOND FLOOR
GUEST ROOM 5
EUROPEAN

- DESIGN ELEMENTS:
- BROWNS, CREAMS, EARTHY COLOR PALETTE
 - LIGHT WALLS WITH A DARK ACCENTS AND ACCENT WALL
 - EUROPEAN INSPIRED ARTWORK, AND SCULPTURES
 - TRADITIONAL FURNITURE WITH A MIX OF CONTEMPORARY FIXTURES





INSPIRATION




CONCEPTUAL RENDRING

AMENITIES	
Key Value	Keynote Text
1	VANITY WITH STORAGE
4	TOILET WITH STORAGE ABOVE
6	KING BED WITH NIGHTSTANDS
7	DESK
8	FIREPLACE
9	SEATING AREA
10	MINI-FRIDGE/BAR AREA
11	WINE RACK AND LOCKABLE LIQUOR CABINET
12	SINK AND COFFEE STATION
13	FLAT-SCREEN TV
15	FULL HEIGHT MIRROR
18	CUSTOM BUILT-IN FOR SAFE AND IRONING BOARD, WITH STORAGE ABOVE

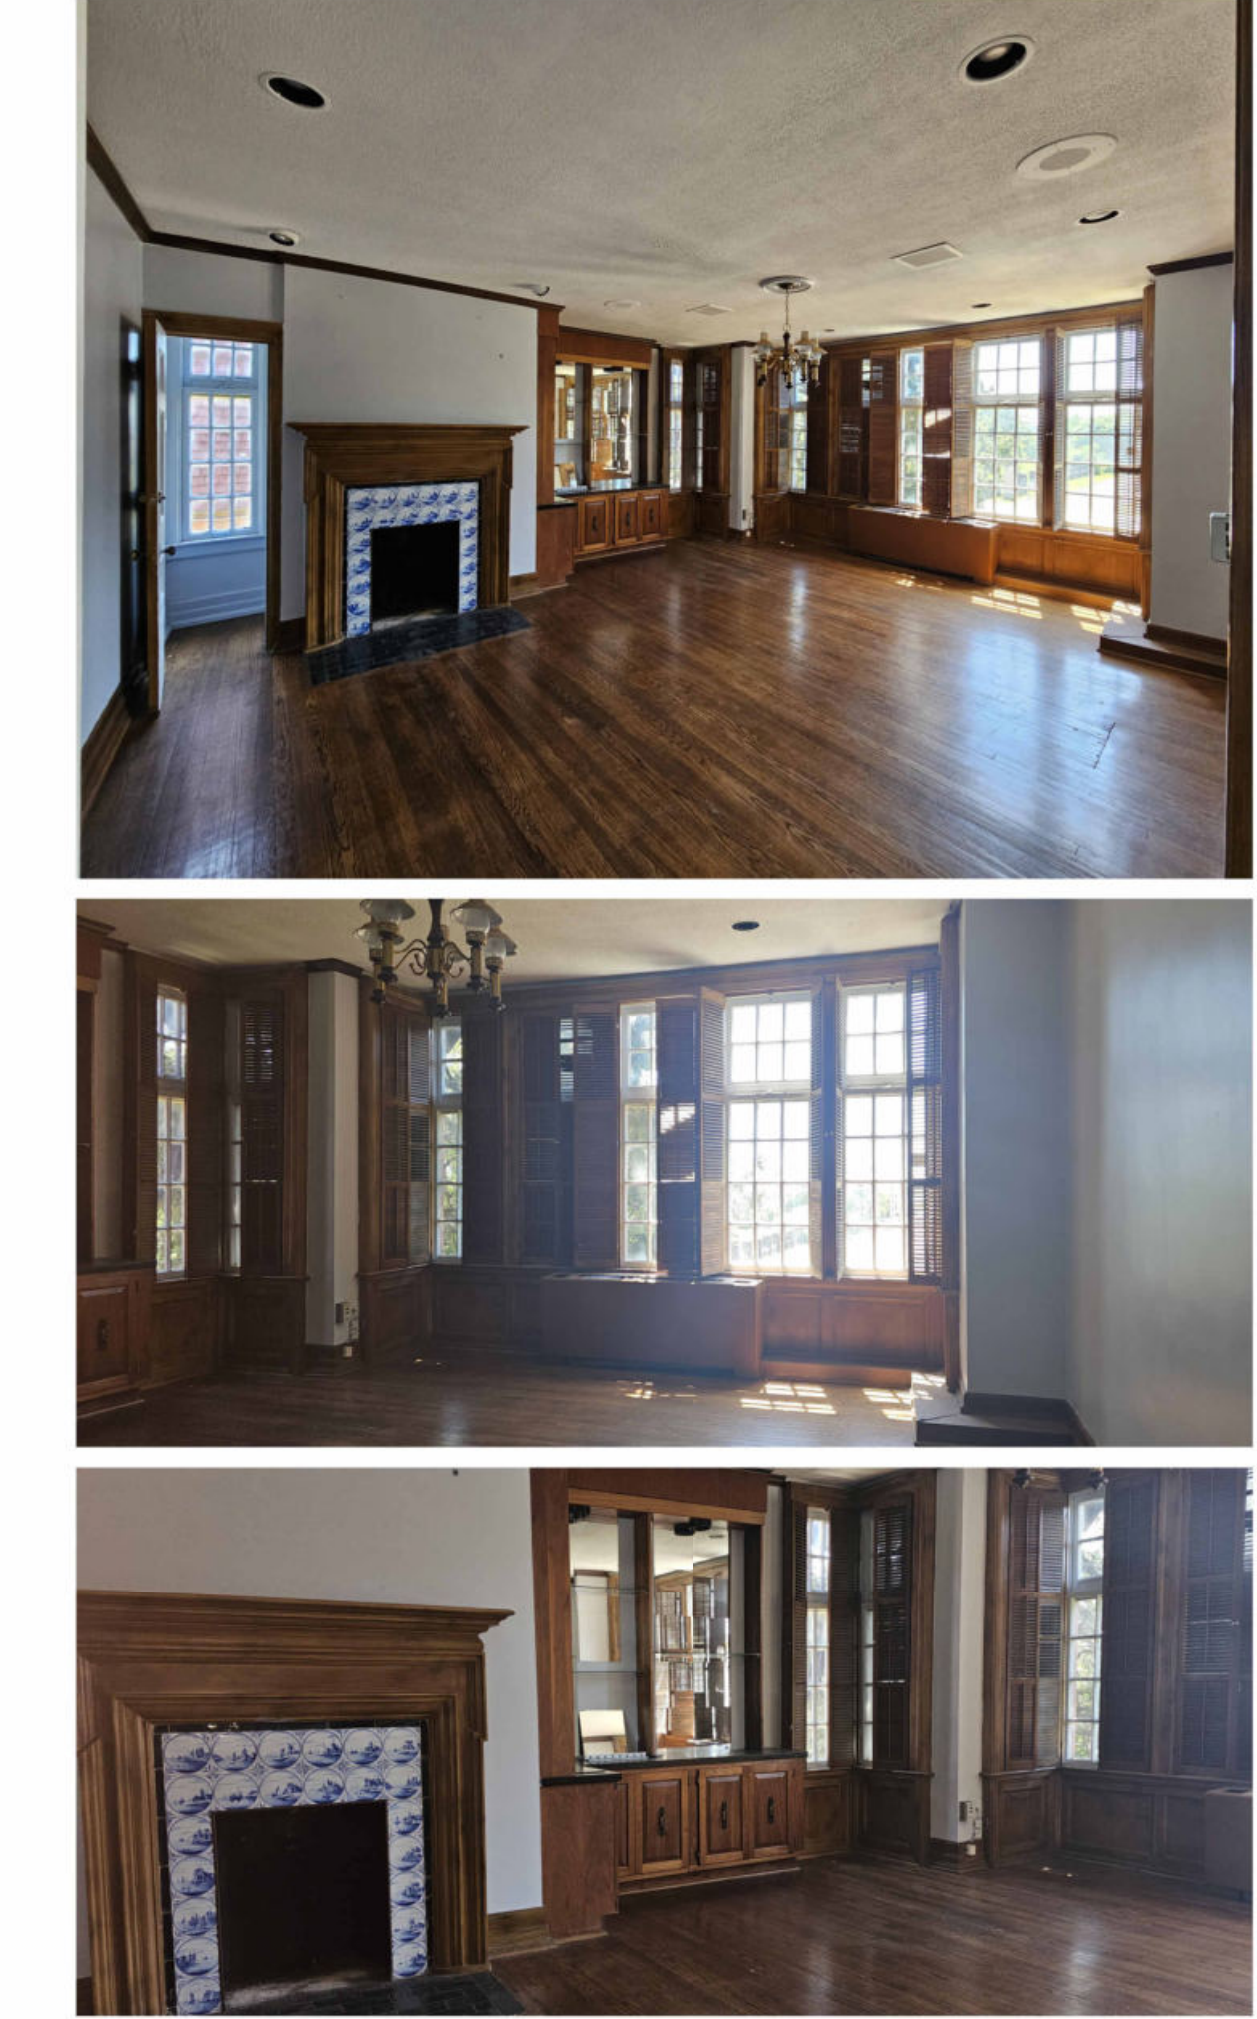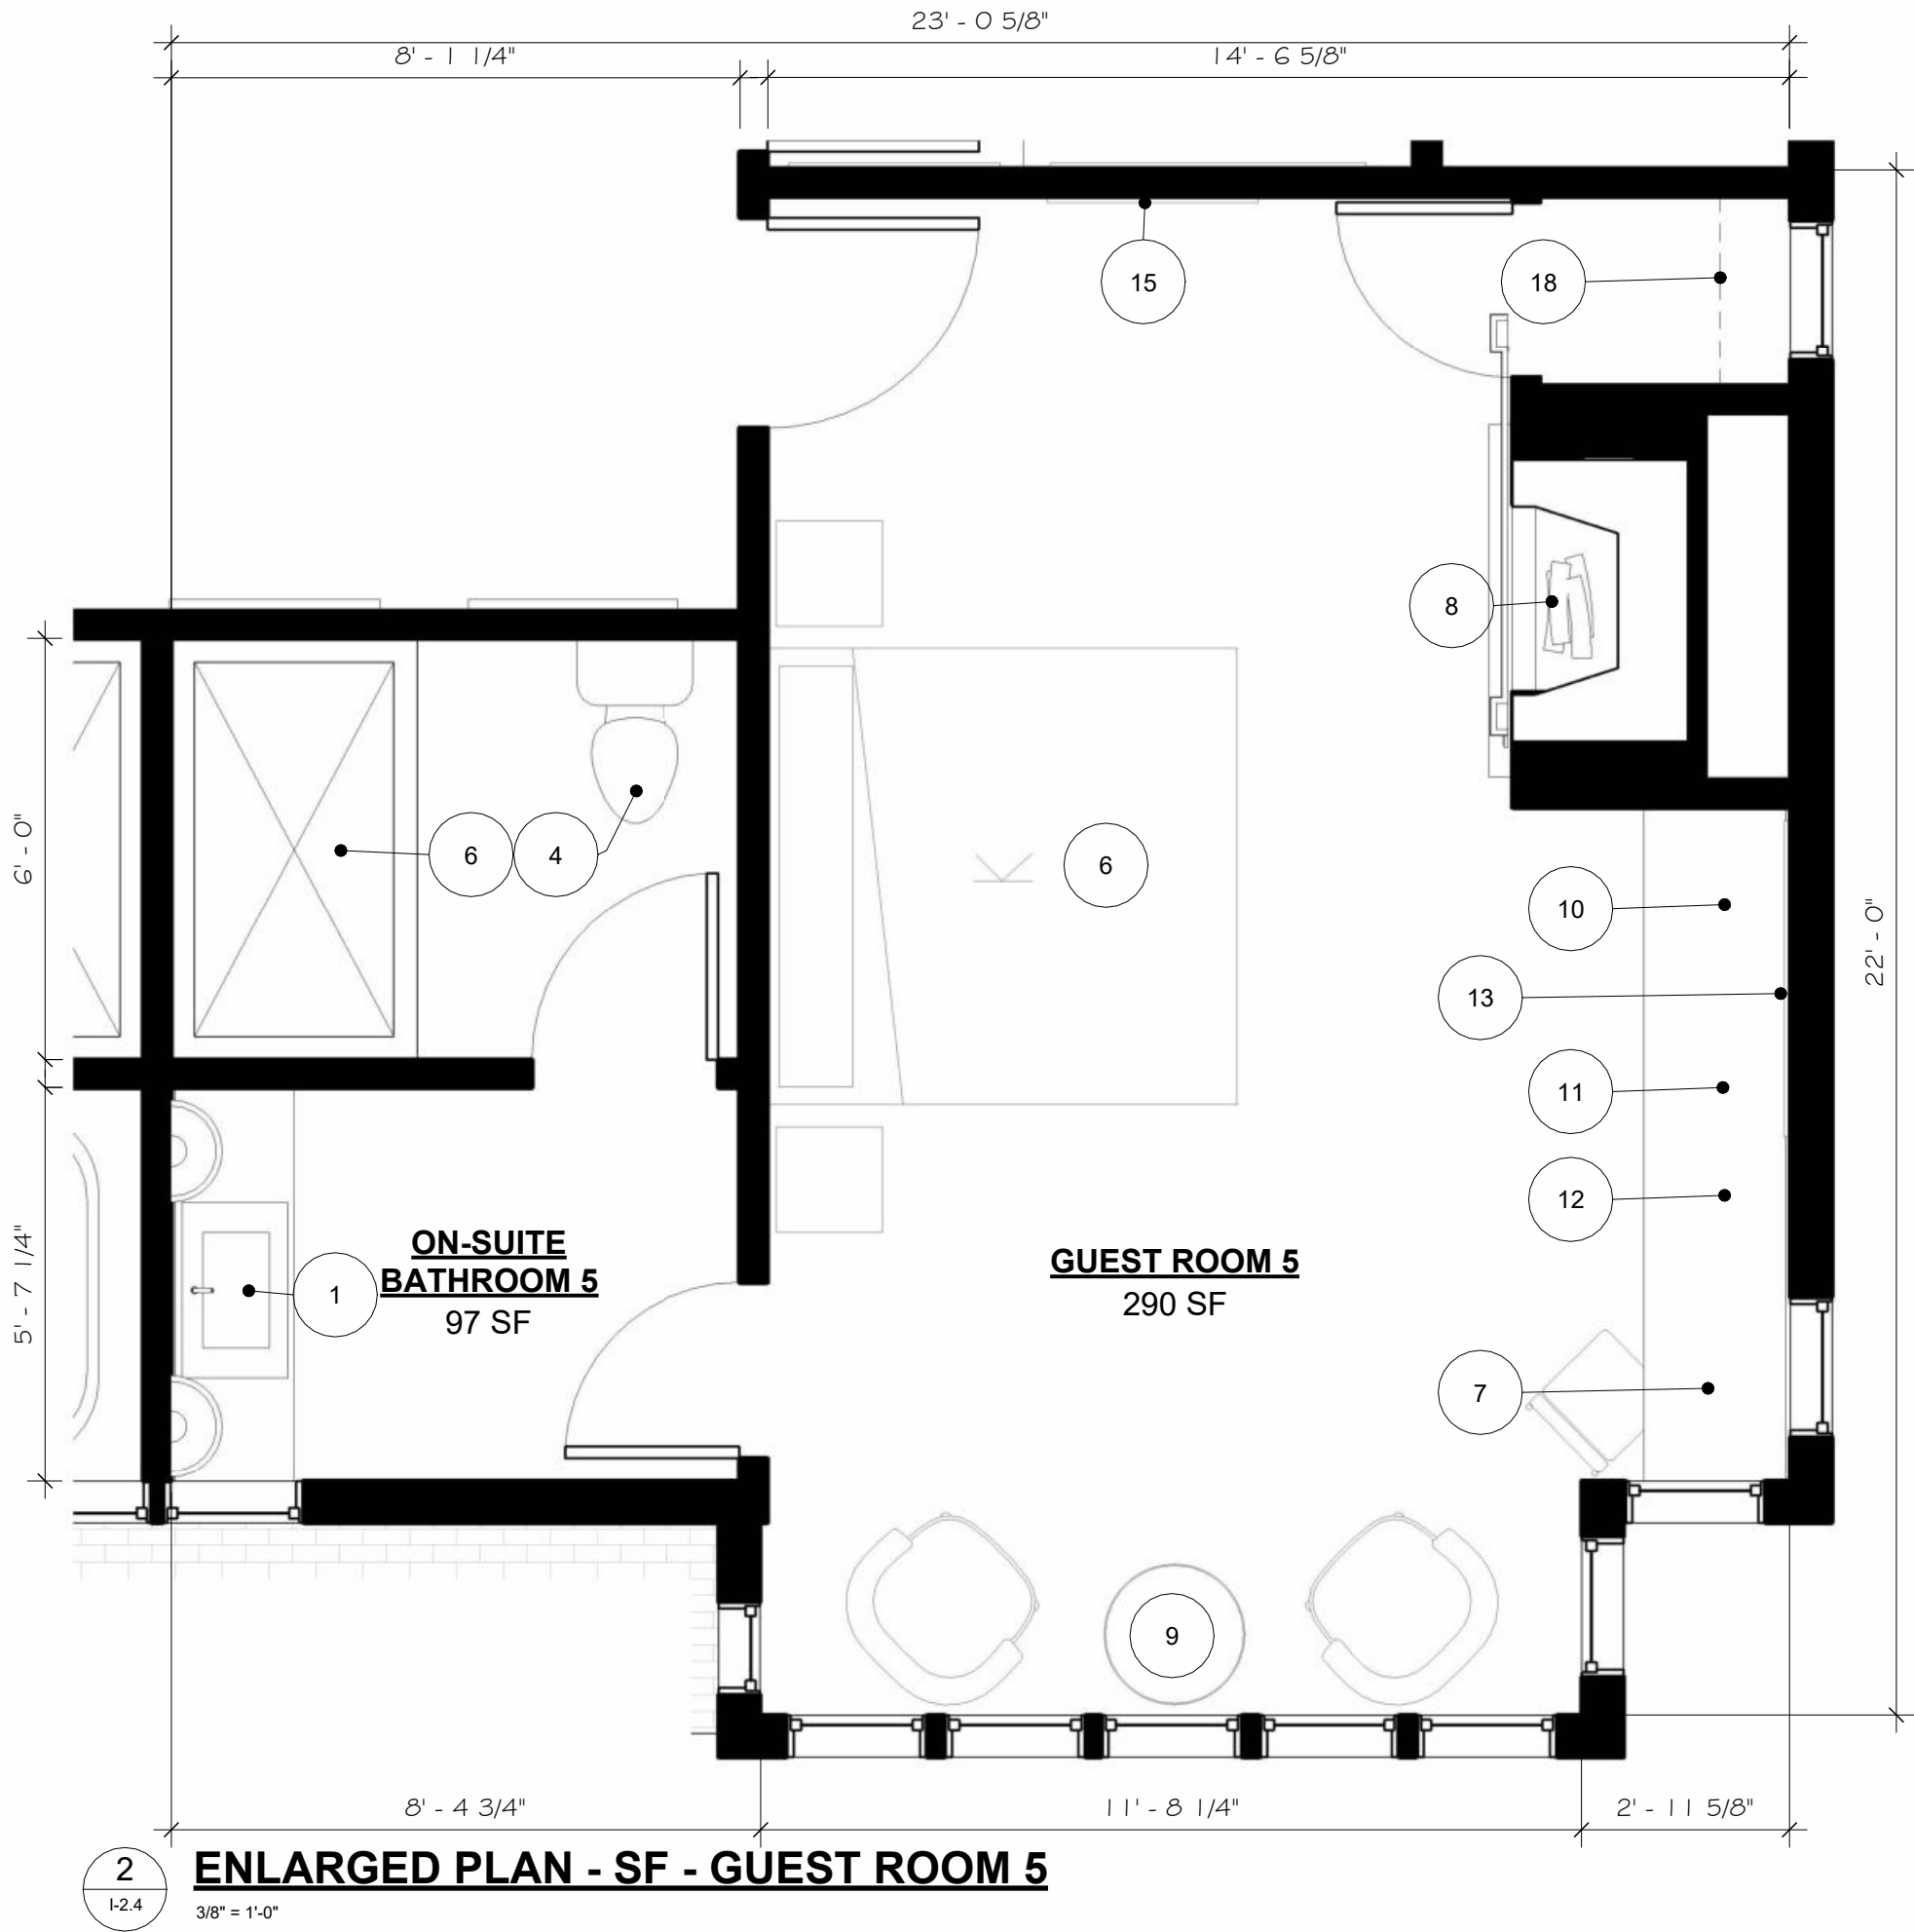

EXISTING CONDITIONS

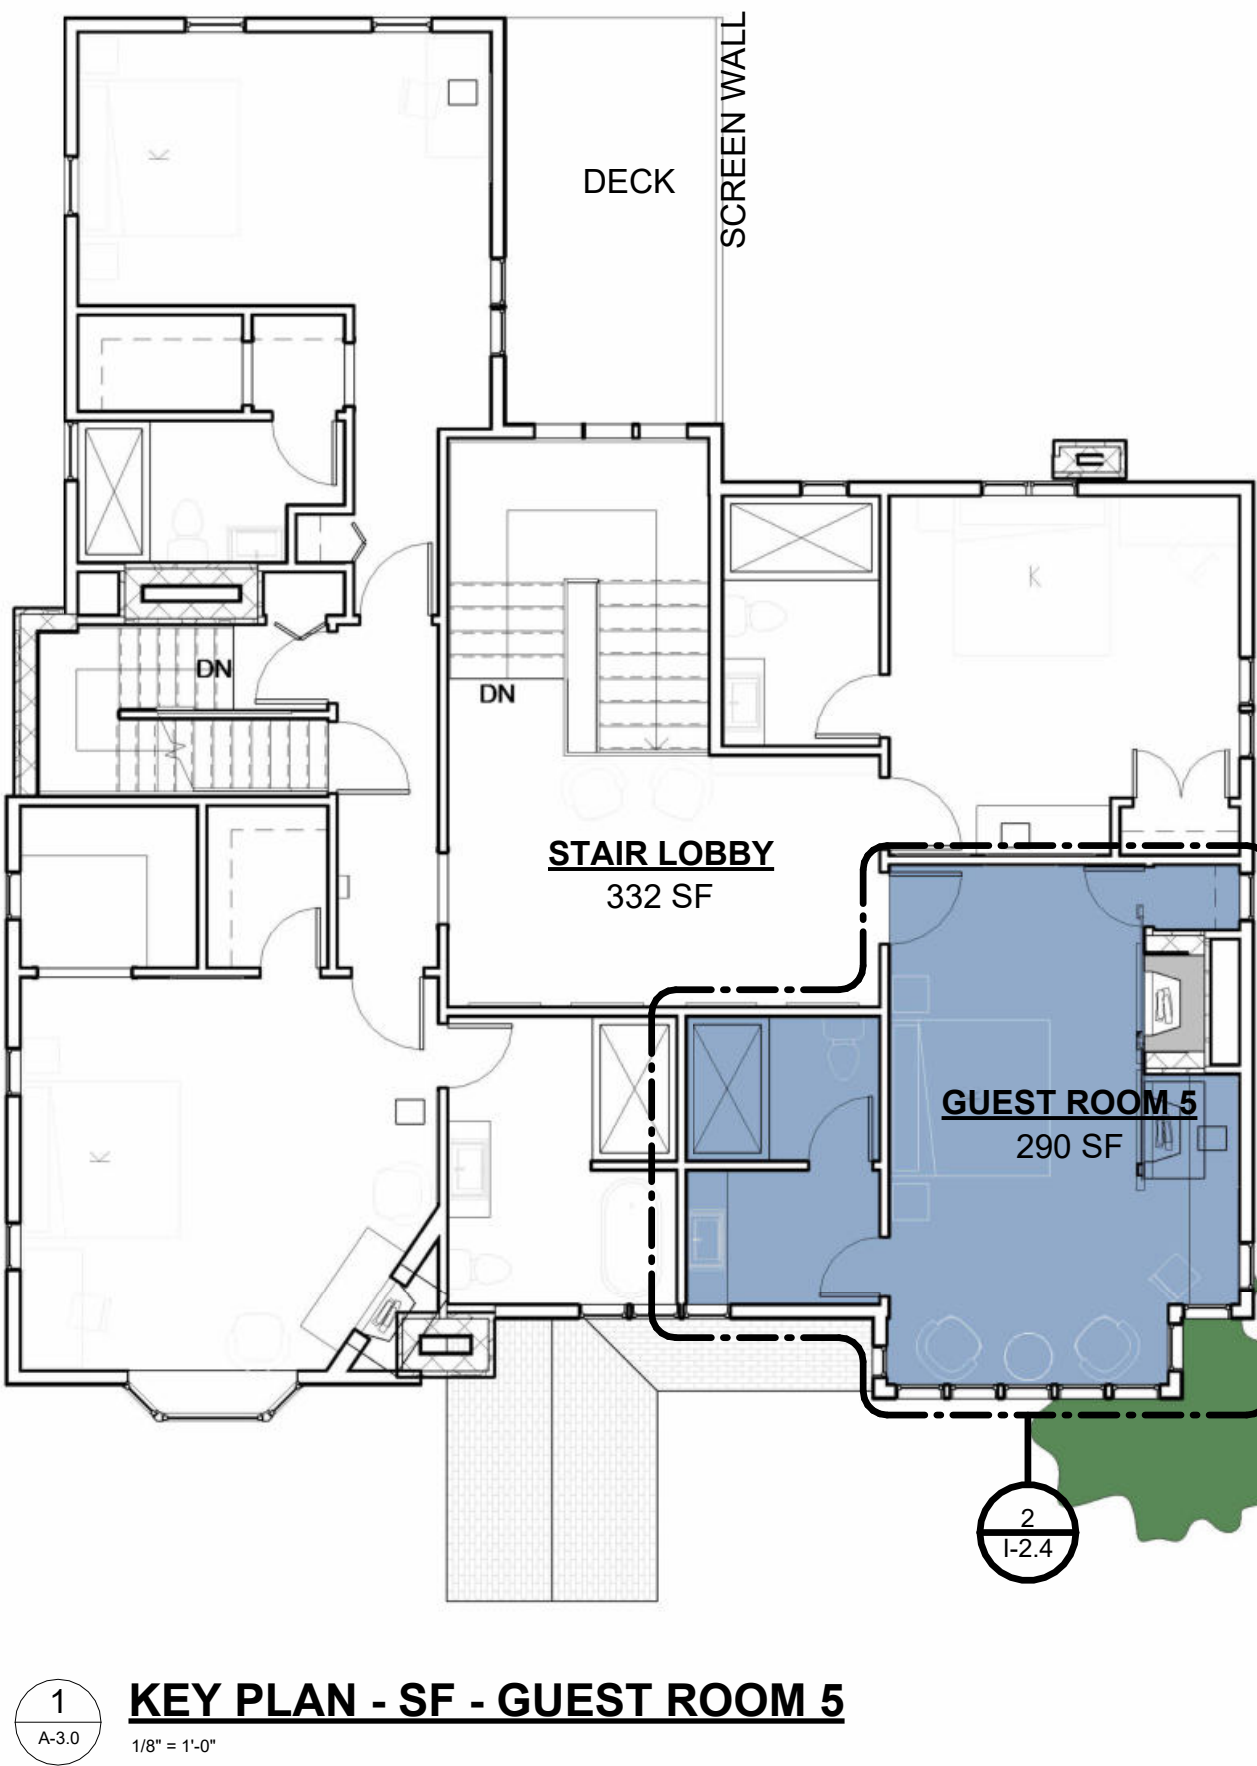

infuz

ARCHITECTS + INNOVATORS

Port Huron Office

208 Huron Ave., Suite 1

Port Huron, MI 48130

Phone: 566.245.7604

Detroit Office

1111 Bellevue Ste 201

Detroit, MI 48207

Phone: 313.332.1299

Email: infuzltd@comcast.net

Web: infuzarchitects.com

Unauthorized use of this drawing set without written permission from VIRTUOSO DESIGN + BUILD and Infuz Ltd is in violation of U.S. COPYRIGHT LAWS and will be subject to civil damages and prosecution.

Revision Schedule		
#	Description	Date
1	Commercial Set	03/13/2025

NOT FOR CONSTRUCTION

BERKERY ESTATE
PROJECT NUMBER: Z24075
8325 E. JEFFERSON AVE
DETROIT, MI 48214
NIAL & MELVIE BERKERY
SHEET TITLE
SECOND FLOOR - GUEST ROOM 5

1-2.4


SECOND FLOOR
GUEST ROOM 6
INSPIRATION
ART DECO

DESIGN ELEMENTS:

- WHITE, GRAY, DEEP ORANGE WITH POPS OF COLOR
- LIGHT WALLS WITH A DARK ACCENTS AND ACCENT WALL
- ART DECO INSPIRED ARTWORK, AND SCULPTURES
- HISTORIC BUT COMPLEMENTING FURNITURE WITH A MIX OF CONTEMPORARY FIXTURES




INSPIRATION

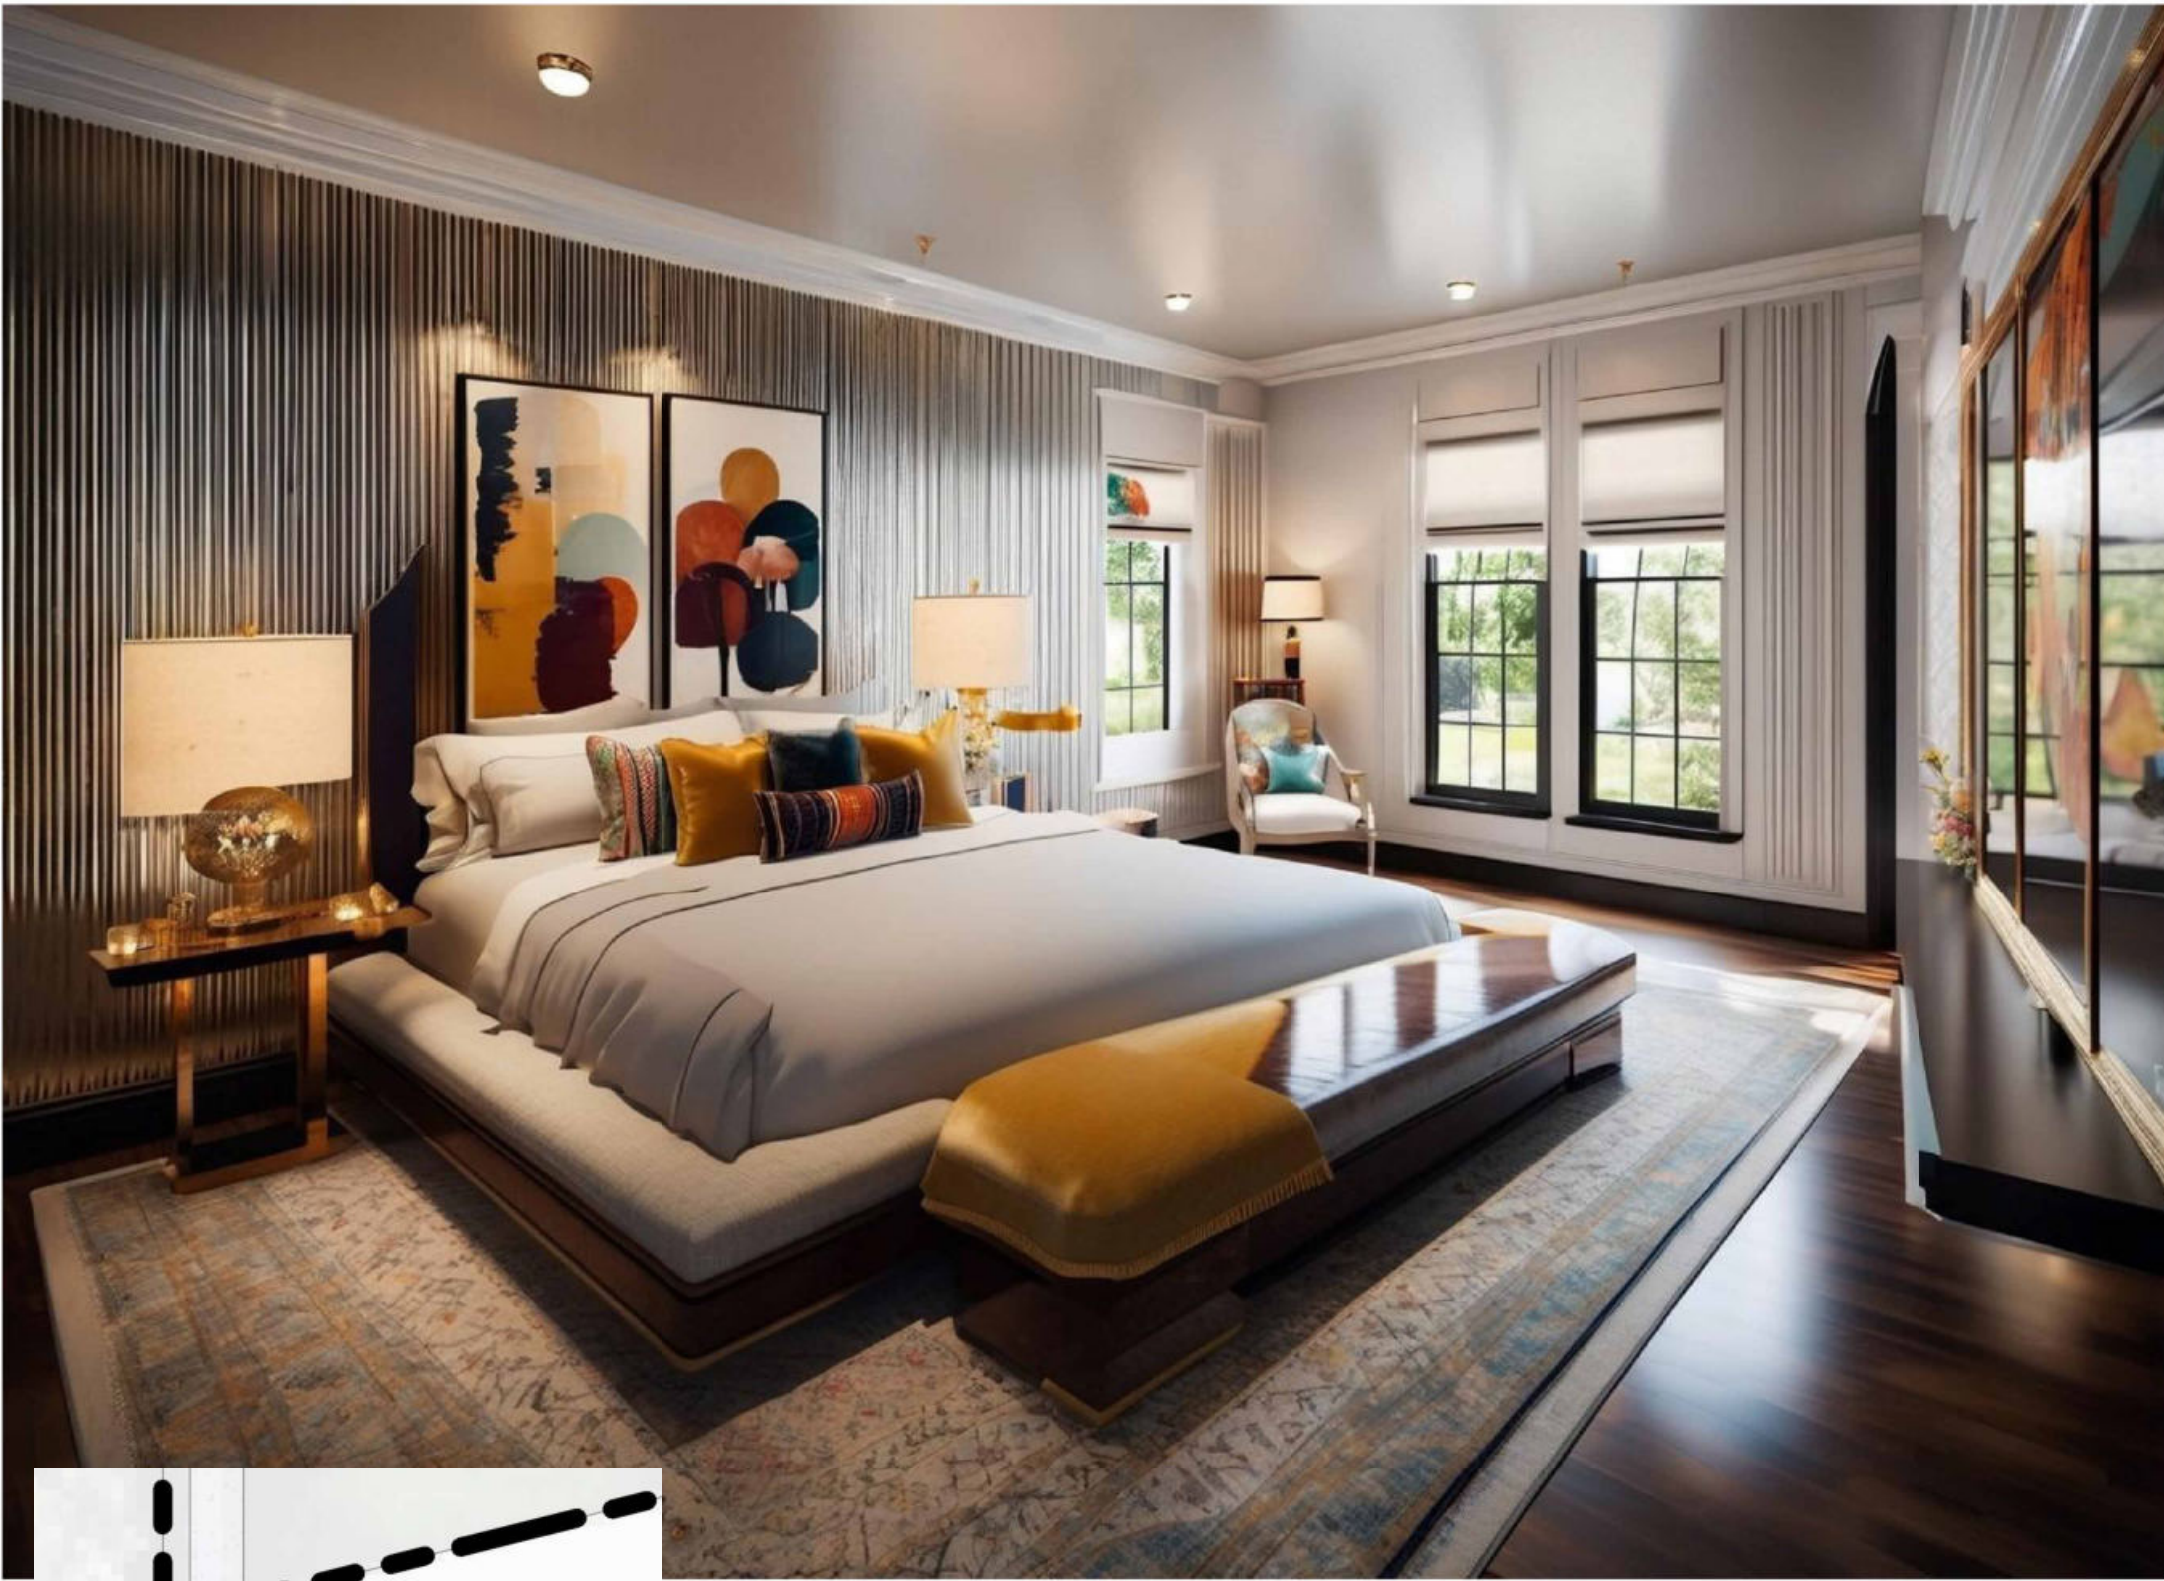


CONCEPTUAL RENDERING

AMENITIES	
Key Value	Keynote Text
1	VANITY WITH STORAGE
4	TOILET WITH STORAGE ABOVE
6	KING BED WITH NIGHTSTANDS
10	MINI-FRIDGE/BAR AREA
11	WINE RACK AND LOCKABLE LIQUOR CABINET
13	FLAT-SCREEN TV
15	FULL HEIGHT MIRROR
18	CUSTOM BUILT-IN FOR SAFE AND IRONING BOARD, WITH STORAGE ABOVE

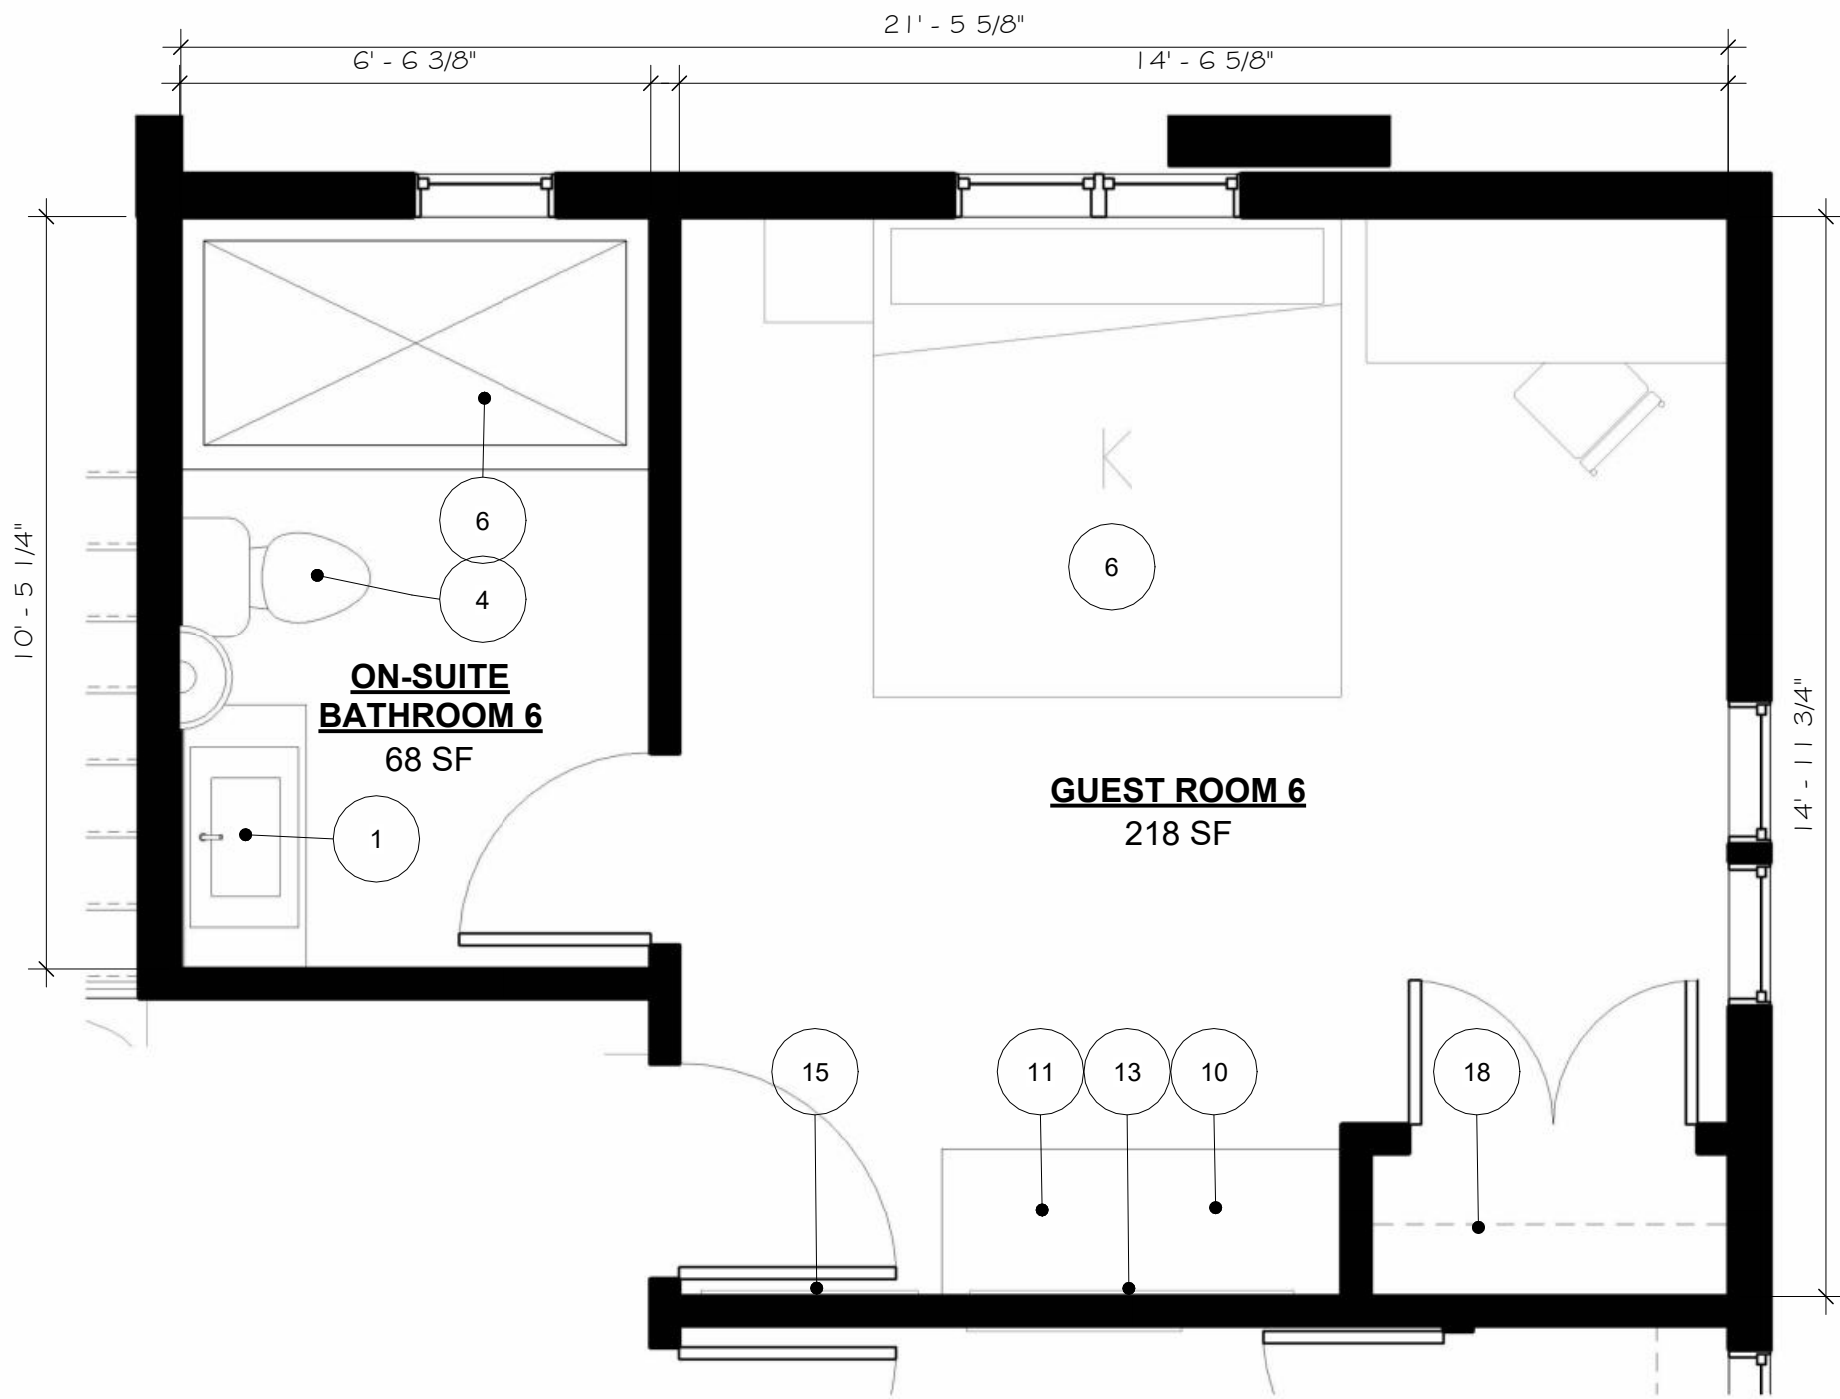

2 ENLARGED PLAN - SF - GUEST ROOM 6
1/2.5 3/8" = 1'-0"

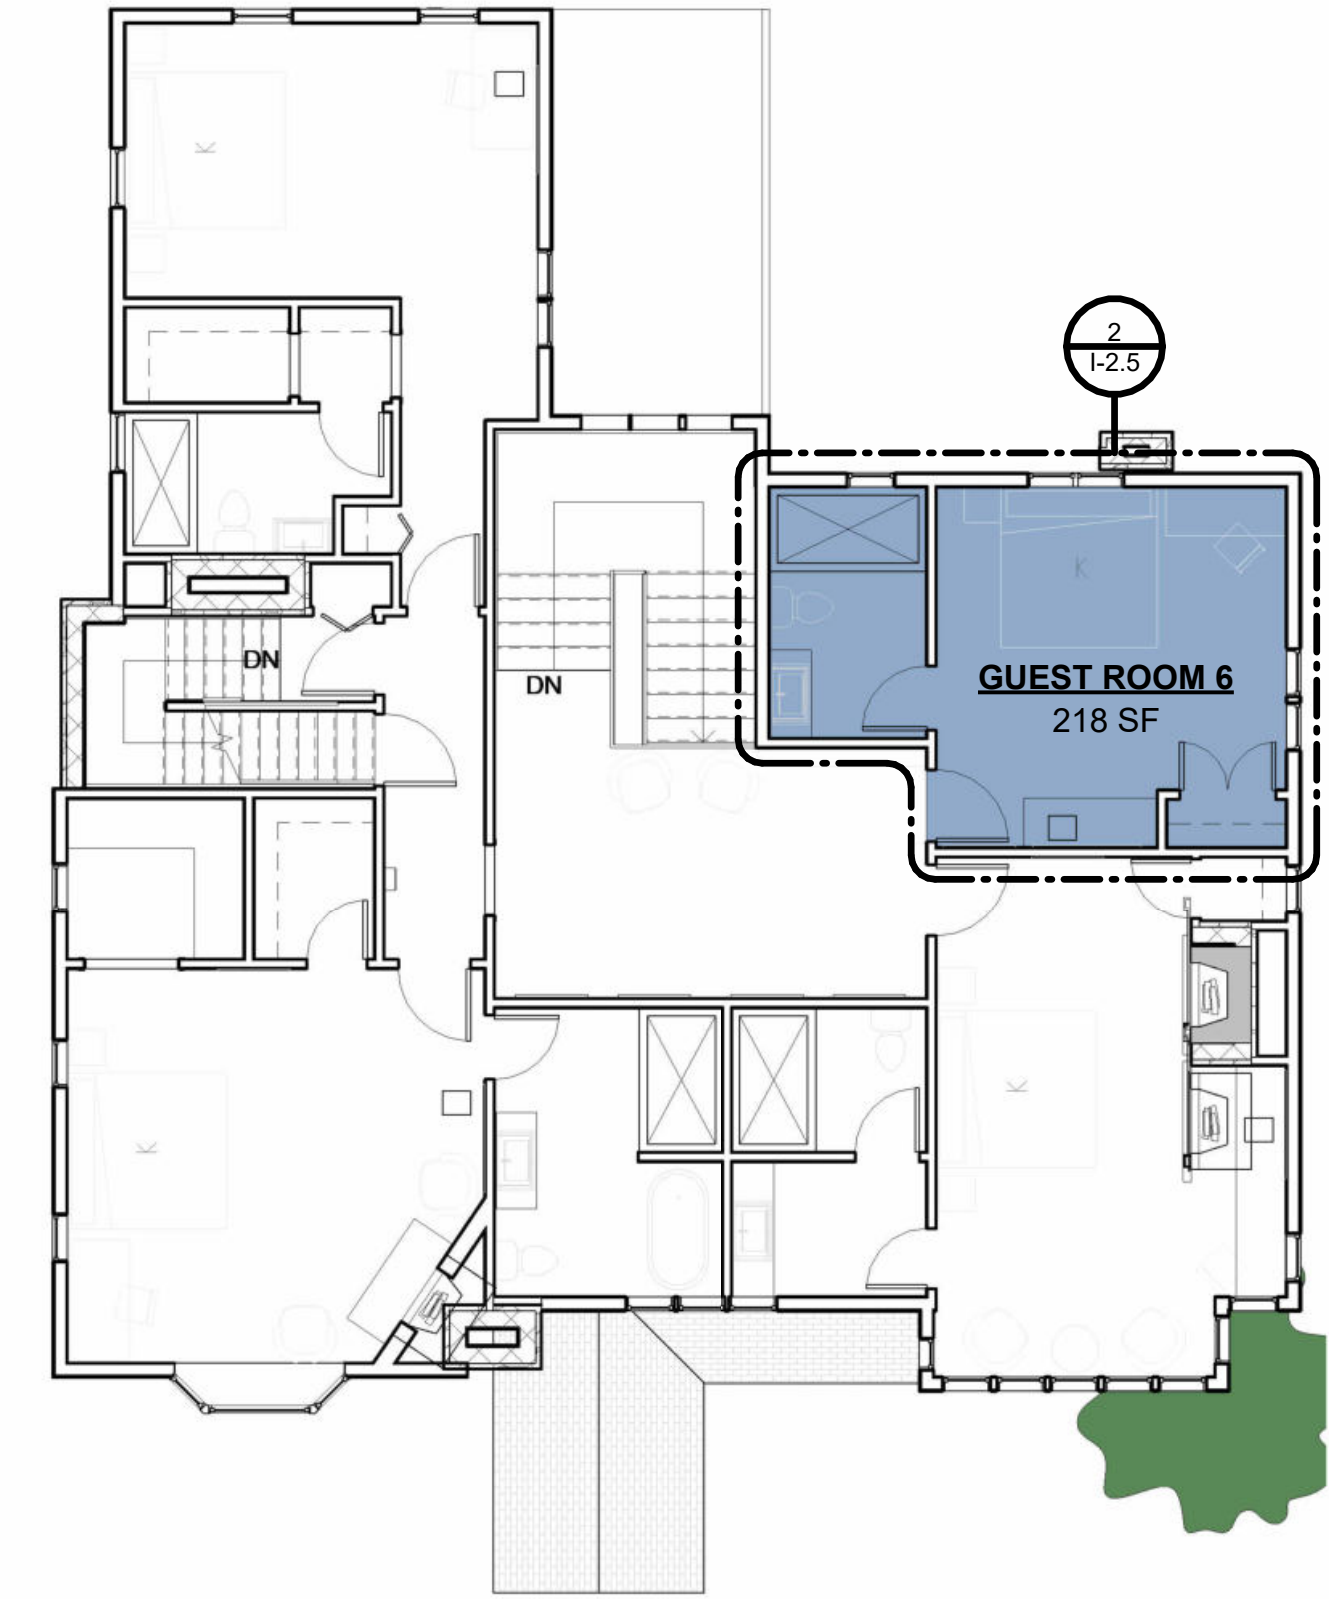

1 KEY PLAN - SF - GUEST ROOM 6
A.3.0 1/8" = 1'-0"

Unauthorized use of this drawing set without written permission from VIRTUOSO DESIGN + BUILD and Infuz Ltd is in violation of U.S. COPYRIGHT LAWS and will be subject to civil damages and prosecution.

Revision Schedule		
#	Description	Date
1	Commercial Set	03/13/2025

NOT FOR CONSTRUCTION

BERKERY ESTATE
PROJECT NUMBER: ZJ4075
8325 E. JEFFERSON AVE
DETROIT, MI 48214
NIAL & MELVIE BERKERY
SHEET TITLE
SECOND FLOOR - GUEST ROOM 6



SHEET NUMBER
I-2.5

DESIGN ELEMENTS:

-
- A modern interior design project by S Concept. The space features a curved ceiling with recessed lighting, a large potted plant, and a butterfly logo on the wall. The furniture includes a curved sofa, a coffee table, and a desk area. The overall aesthetic is clean and contemporary.




LIGHTER SCHEME

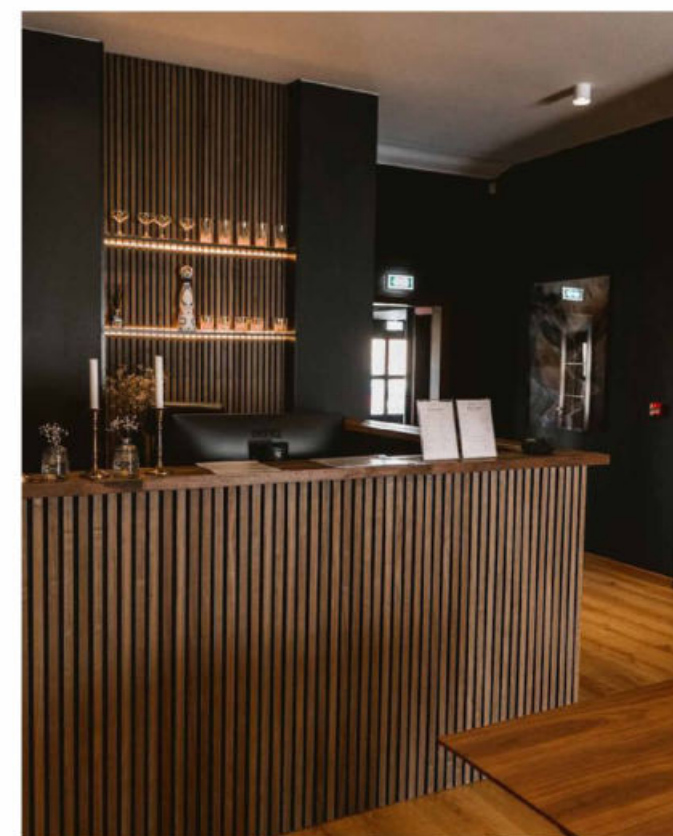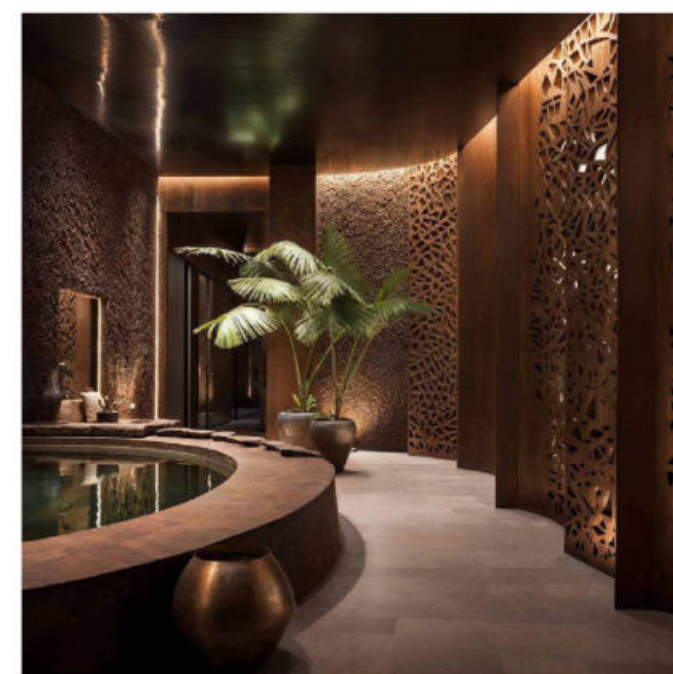

DARKER SCHEME


INSPIRATION

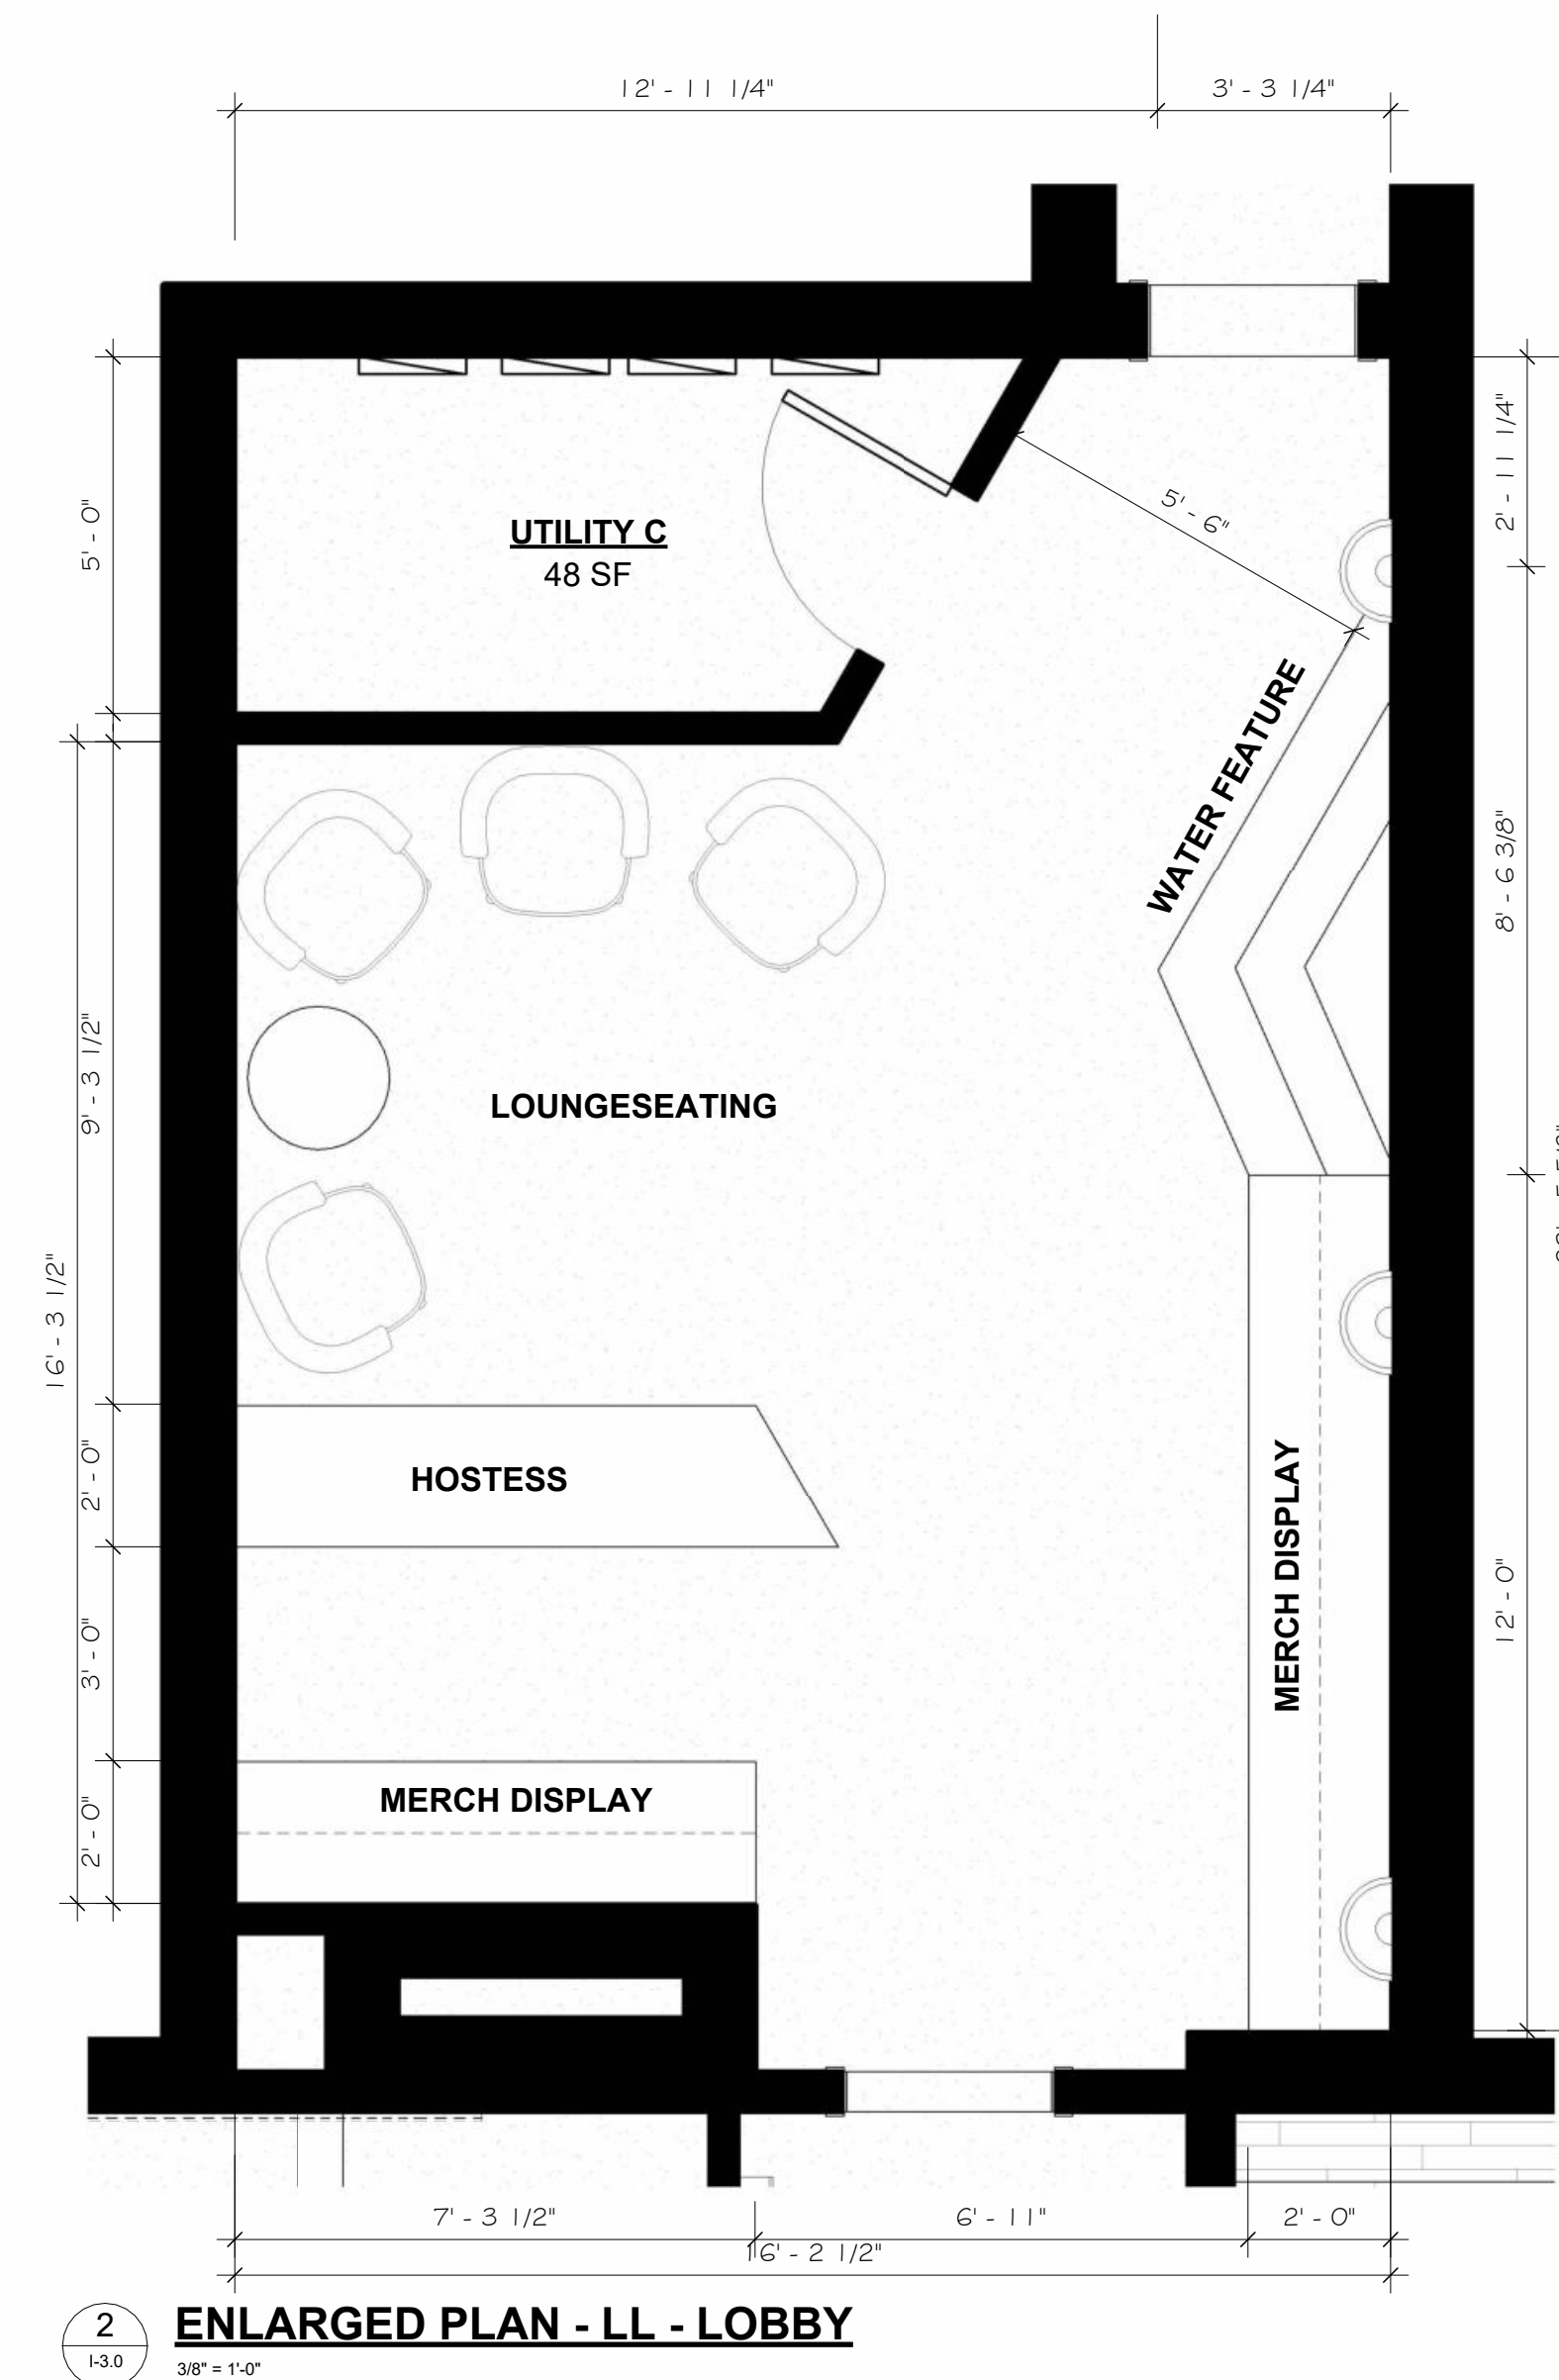

AMENITIES:

-

EXISTING CONDITIONS

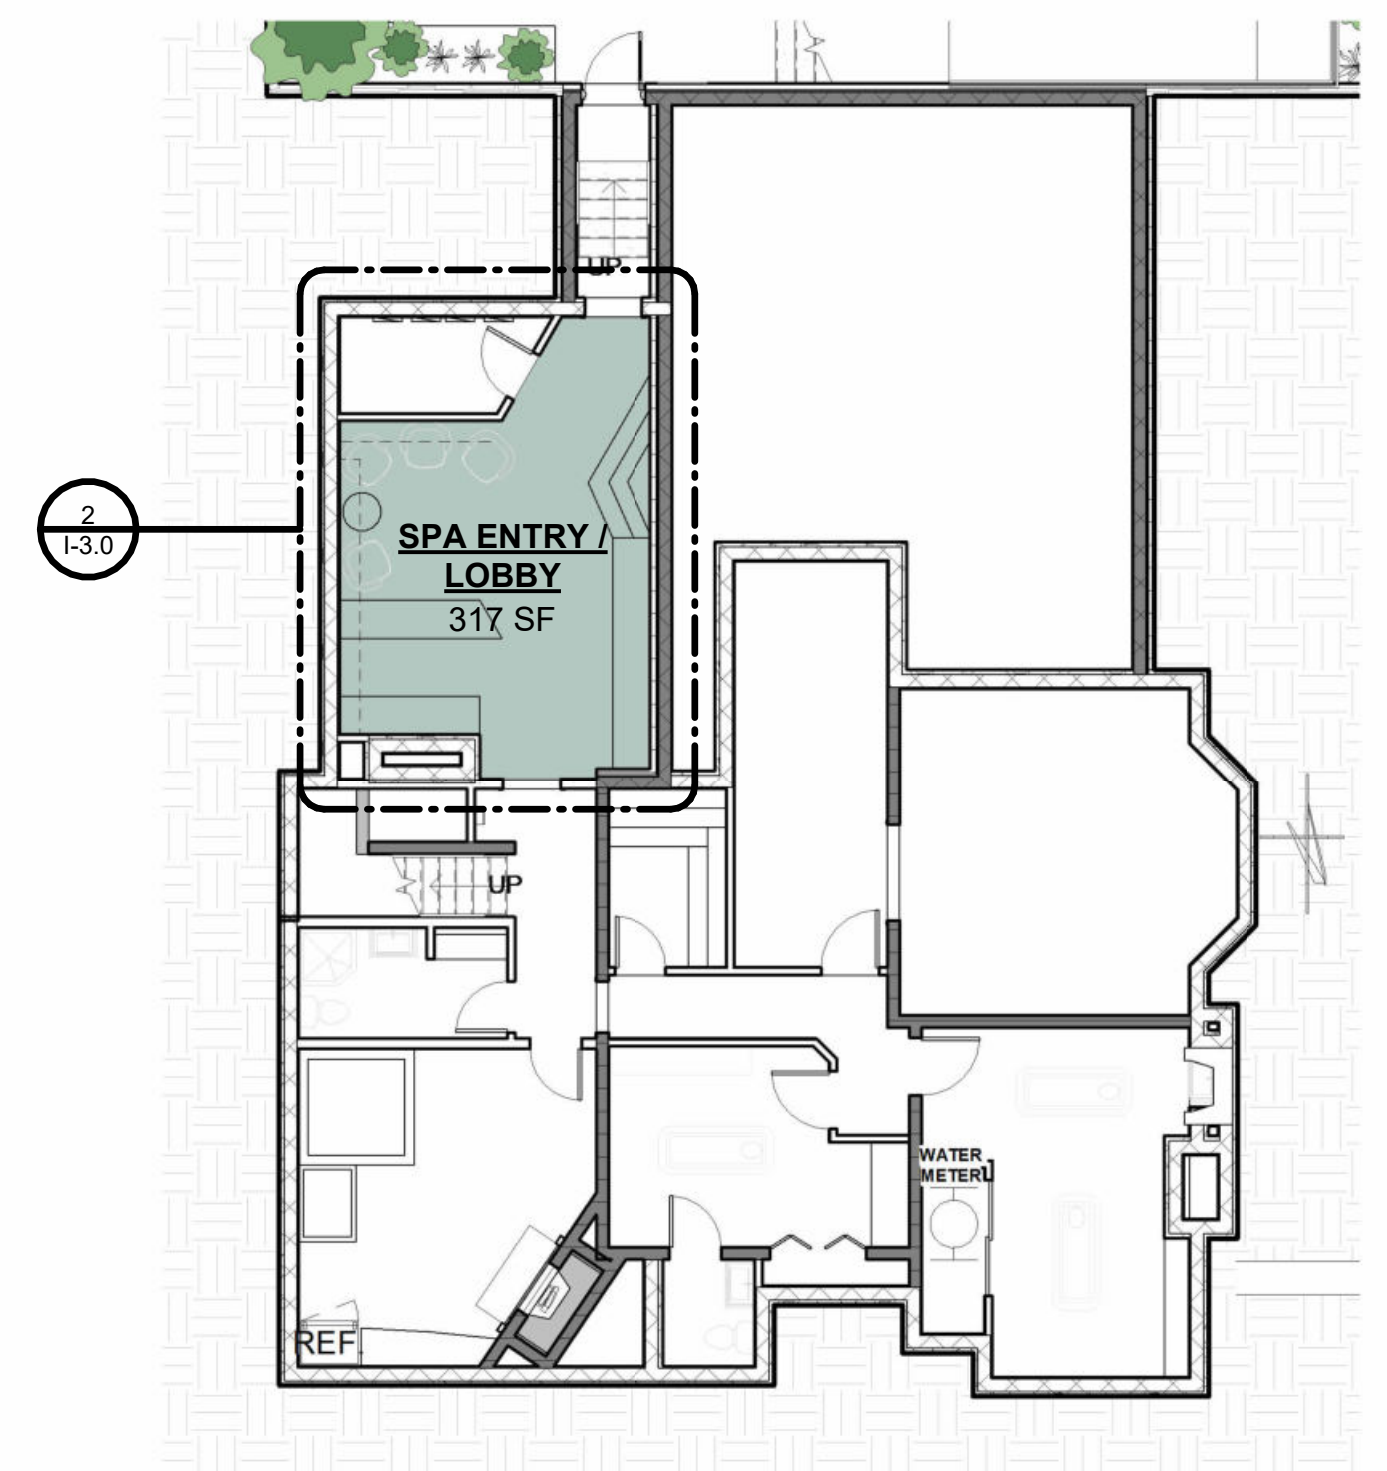

1 **KEY PLAN - LL - LOBBY**
1" = 10'-0"


LOWER LEVEL BATHROOMS

DESIGN ELEMENTS:

- EARTHY NATURAL PALETTE
- FEATURE WALLS WITH ILLUMINATING ACCENTS




DARKER SCHEME

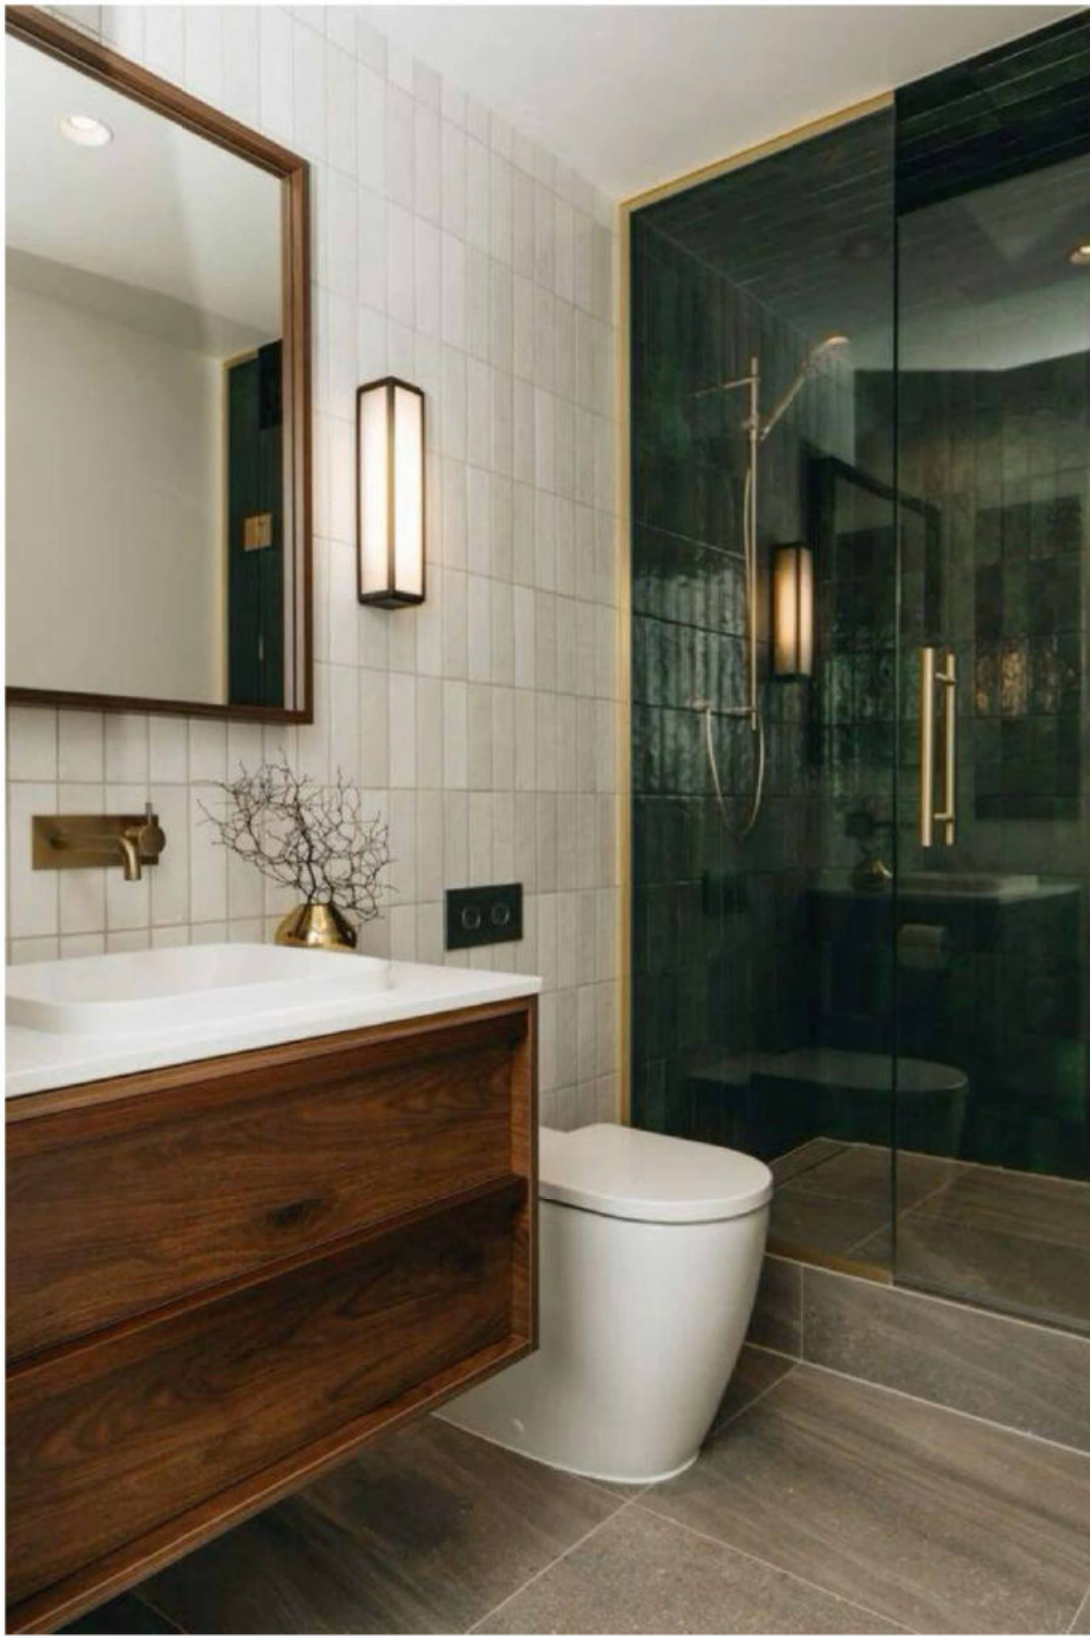


LIGHTER SCHEME

INSPIRATION

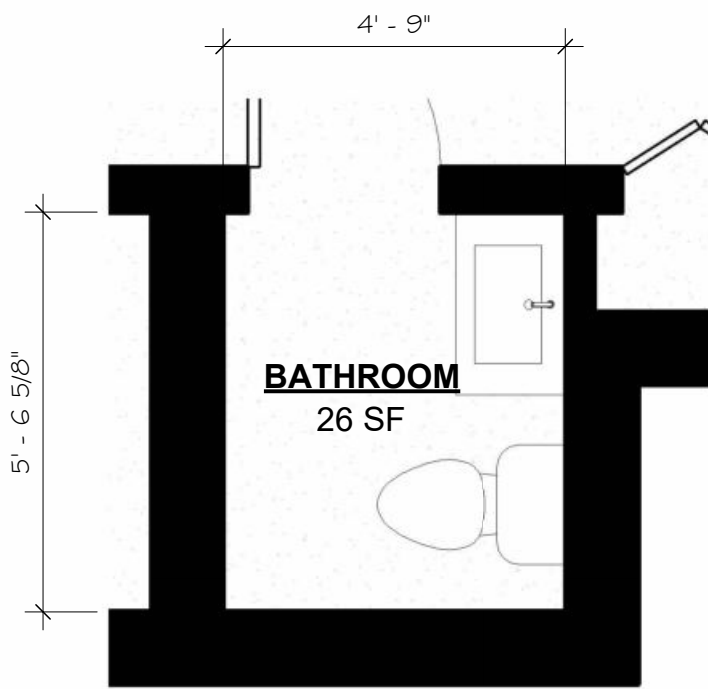

3 ENLARGED PLAN - LL - BATHROOM
1/3.1 3/8" = 1'-0"

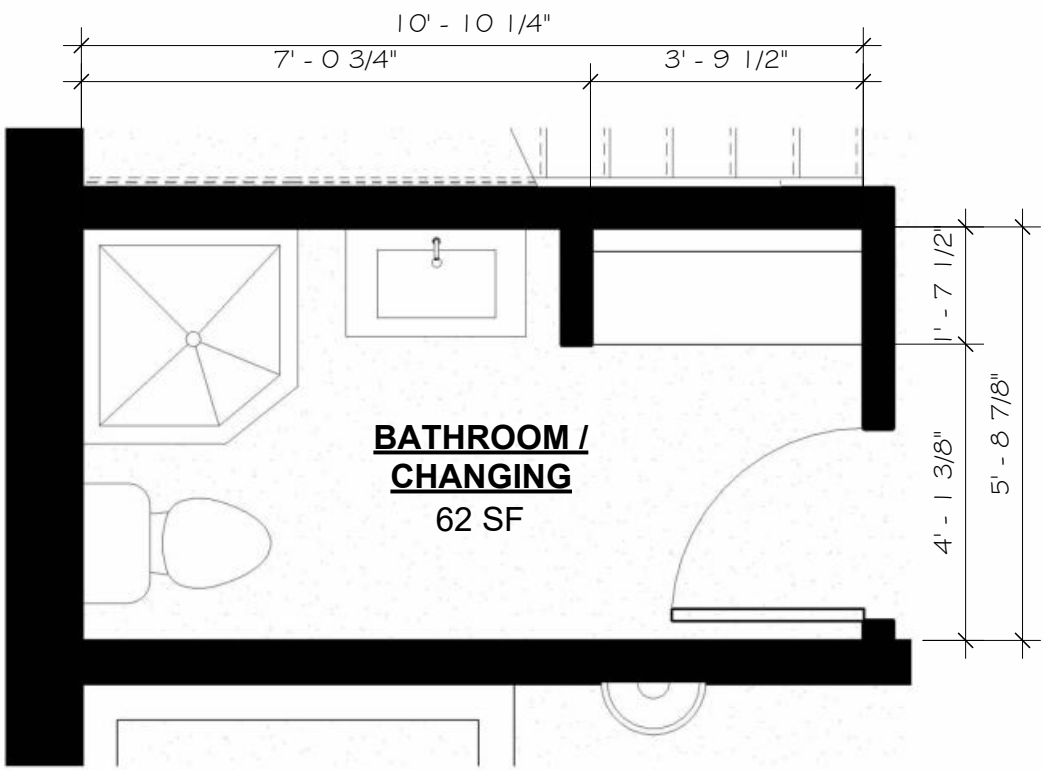


2 ENLARGED PLAN - LL - CHANGING ROOM
1/3.1 3/8" = 1'-0"

AMENTITIES:

- ONE FULL BATHROOM AND ONE HALF
- STOCK COUNTER WITH SINK
- WALK-IN SHOWER AND LIN. CLOSET




EXISTING CONDITIONS

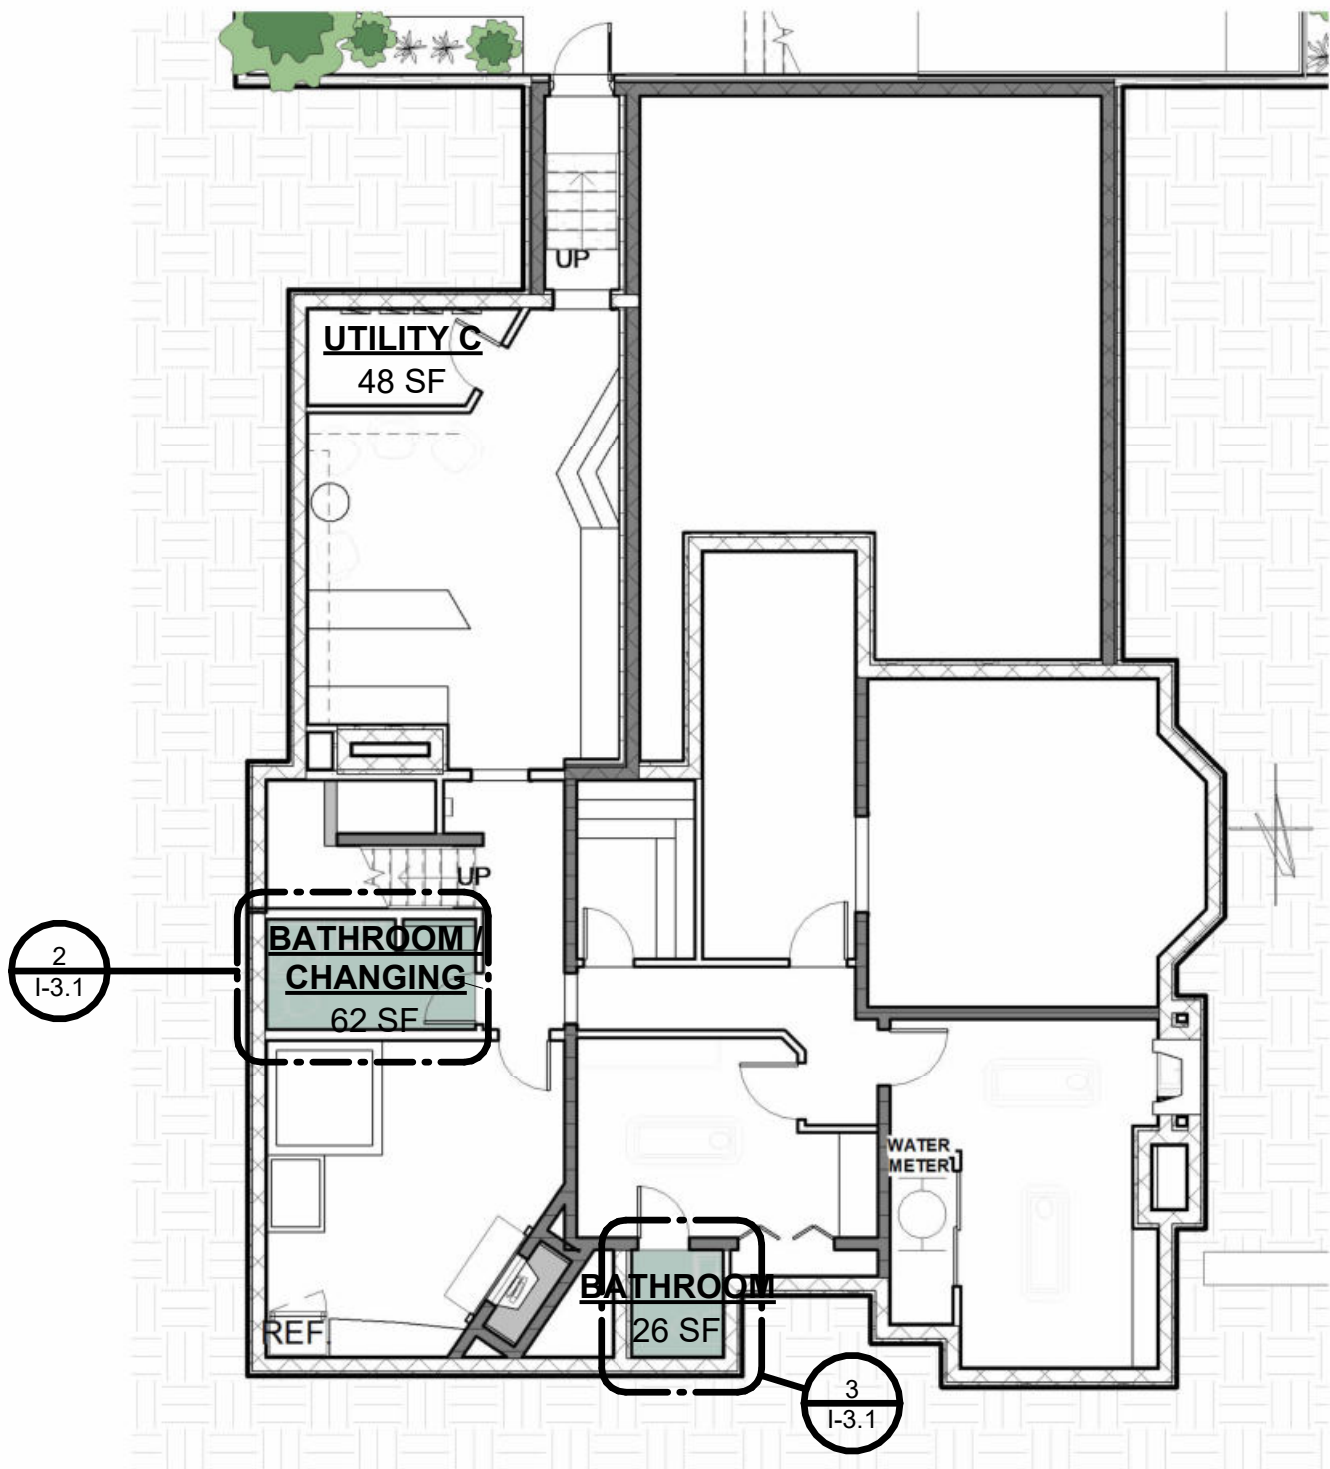


1 KEY PLAN - LL - RESTROOMS
1" = 10'-0"

LOWER LEVEL HYDRO ROOM/SAUNA INSPIRATION

- DESIGN ELEMENTS:**
- INDOOR OUTDOOR FEEL THROUGH FAUX SKYLIGHT
 - TEXTURED FEATURE WALLS
 - FEATURED FIRE PLACE
 - WATER FEATURE WITH SPA

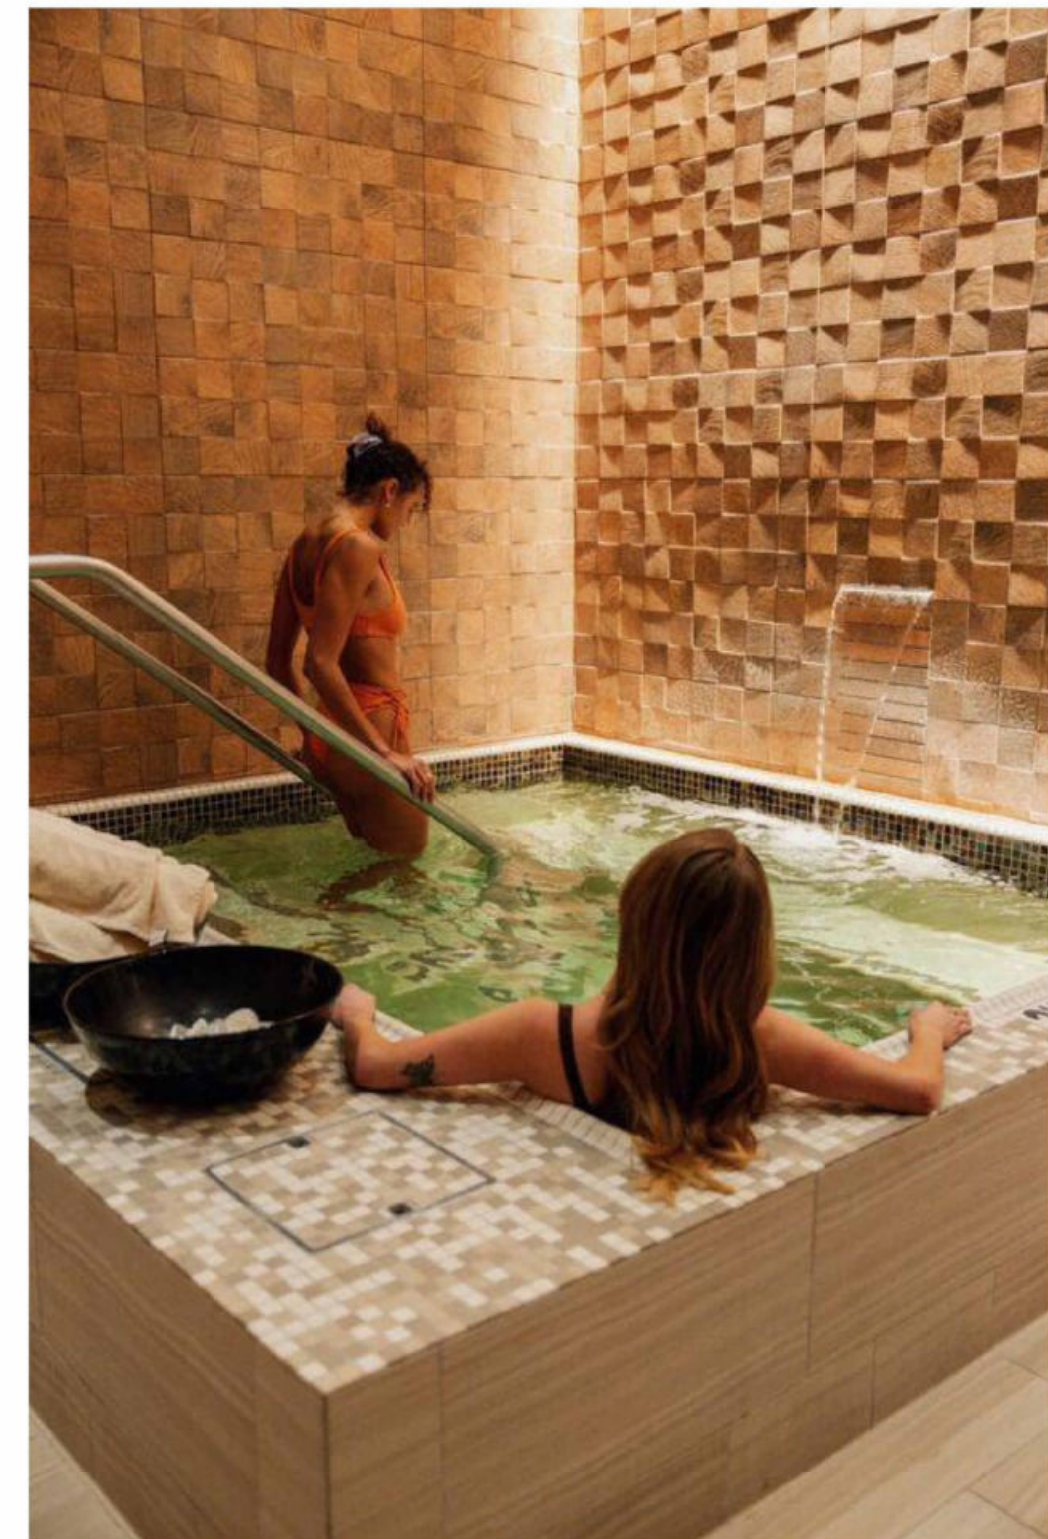


LIGHTER SCHEME

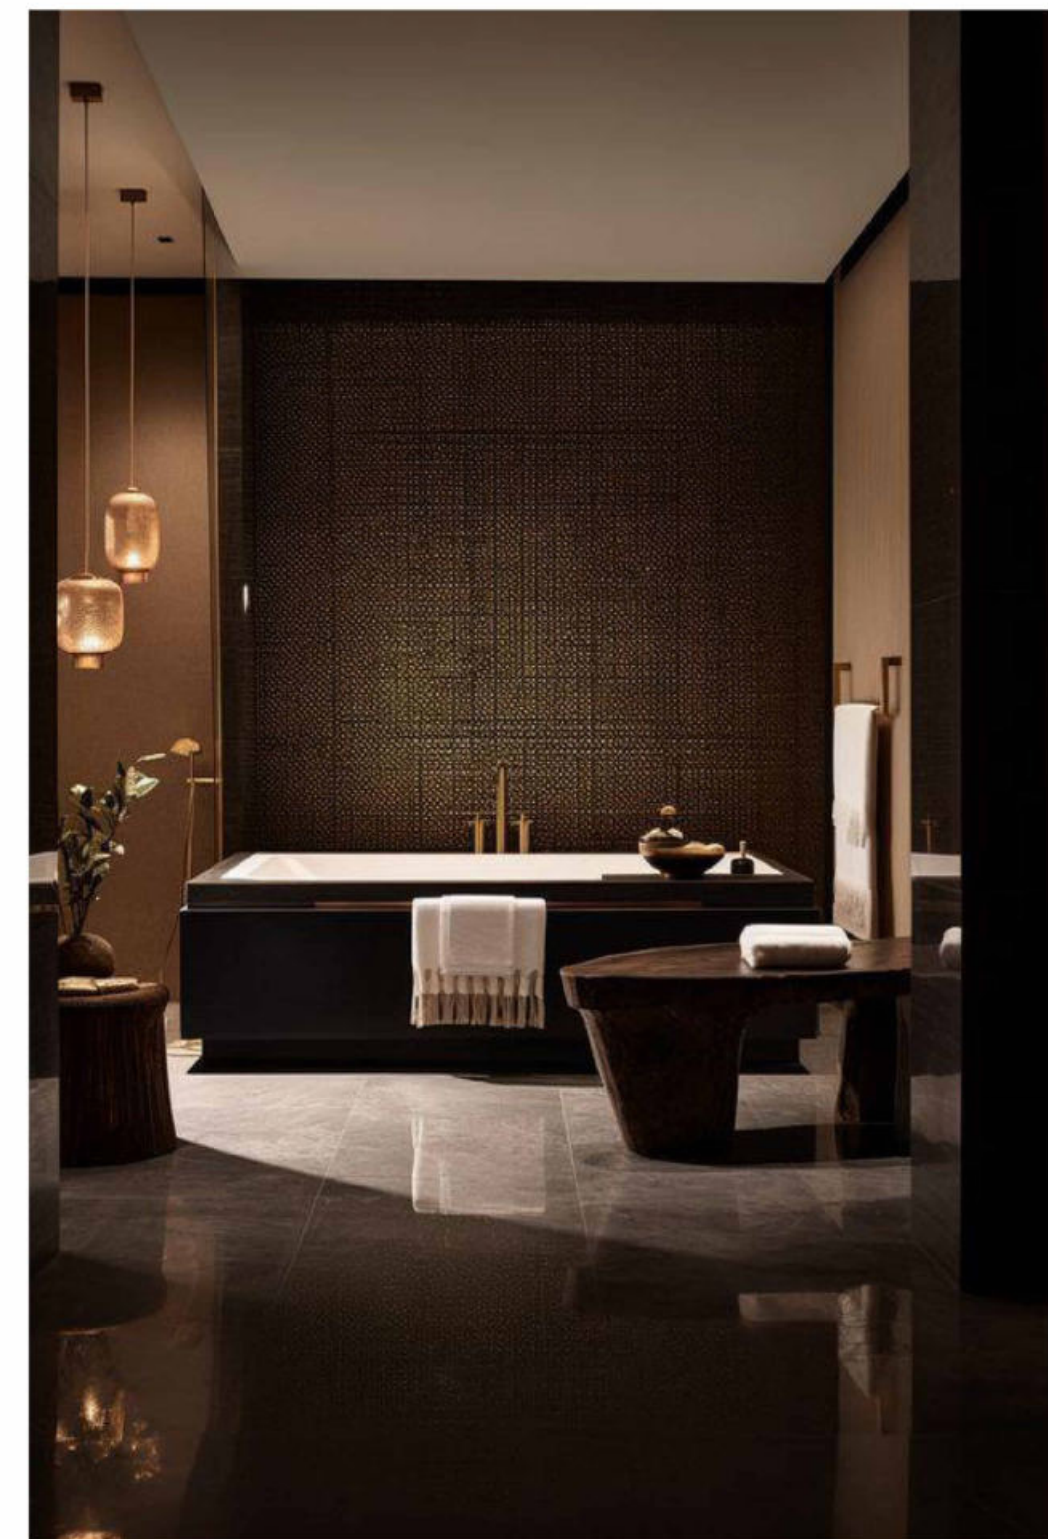

DARKER SCHEME


INSPIRATION

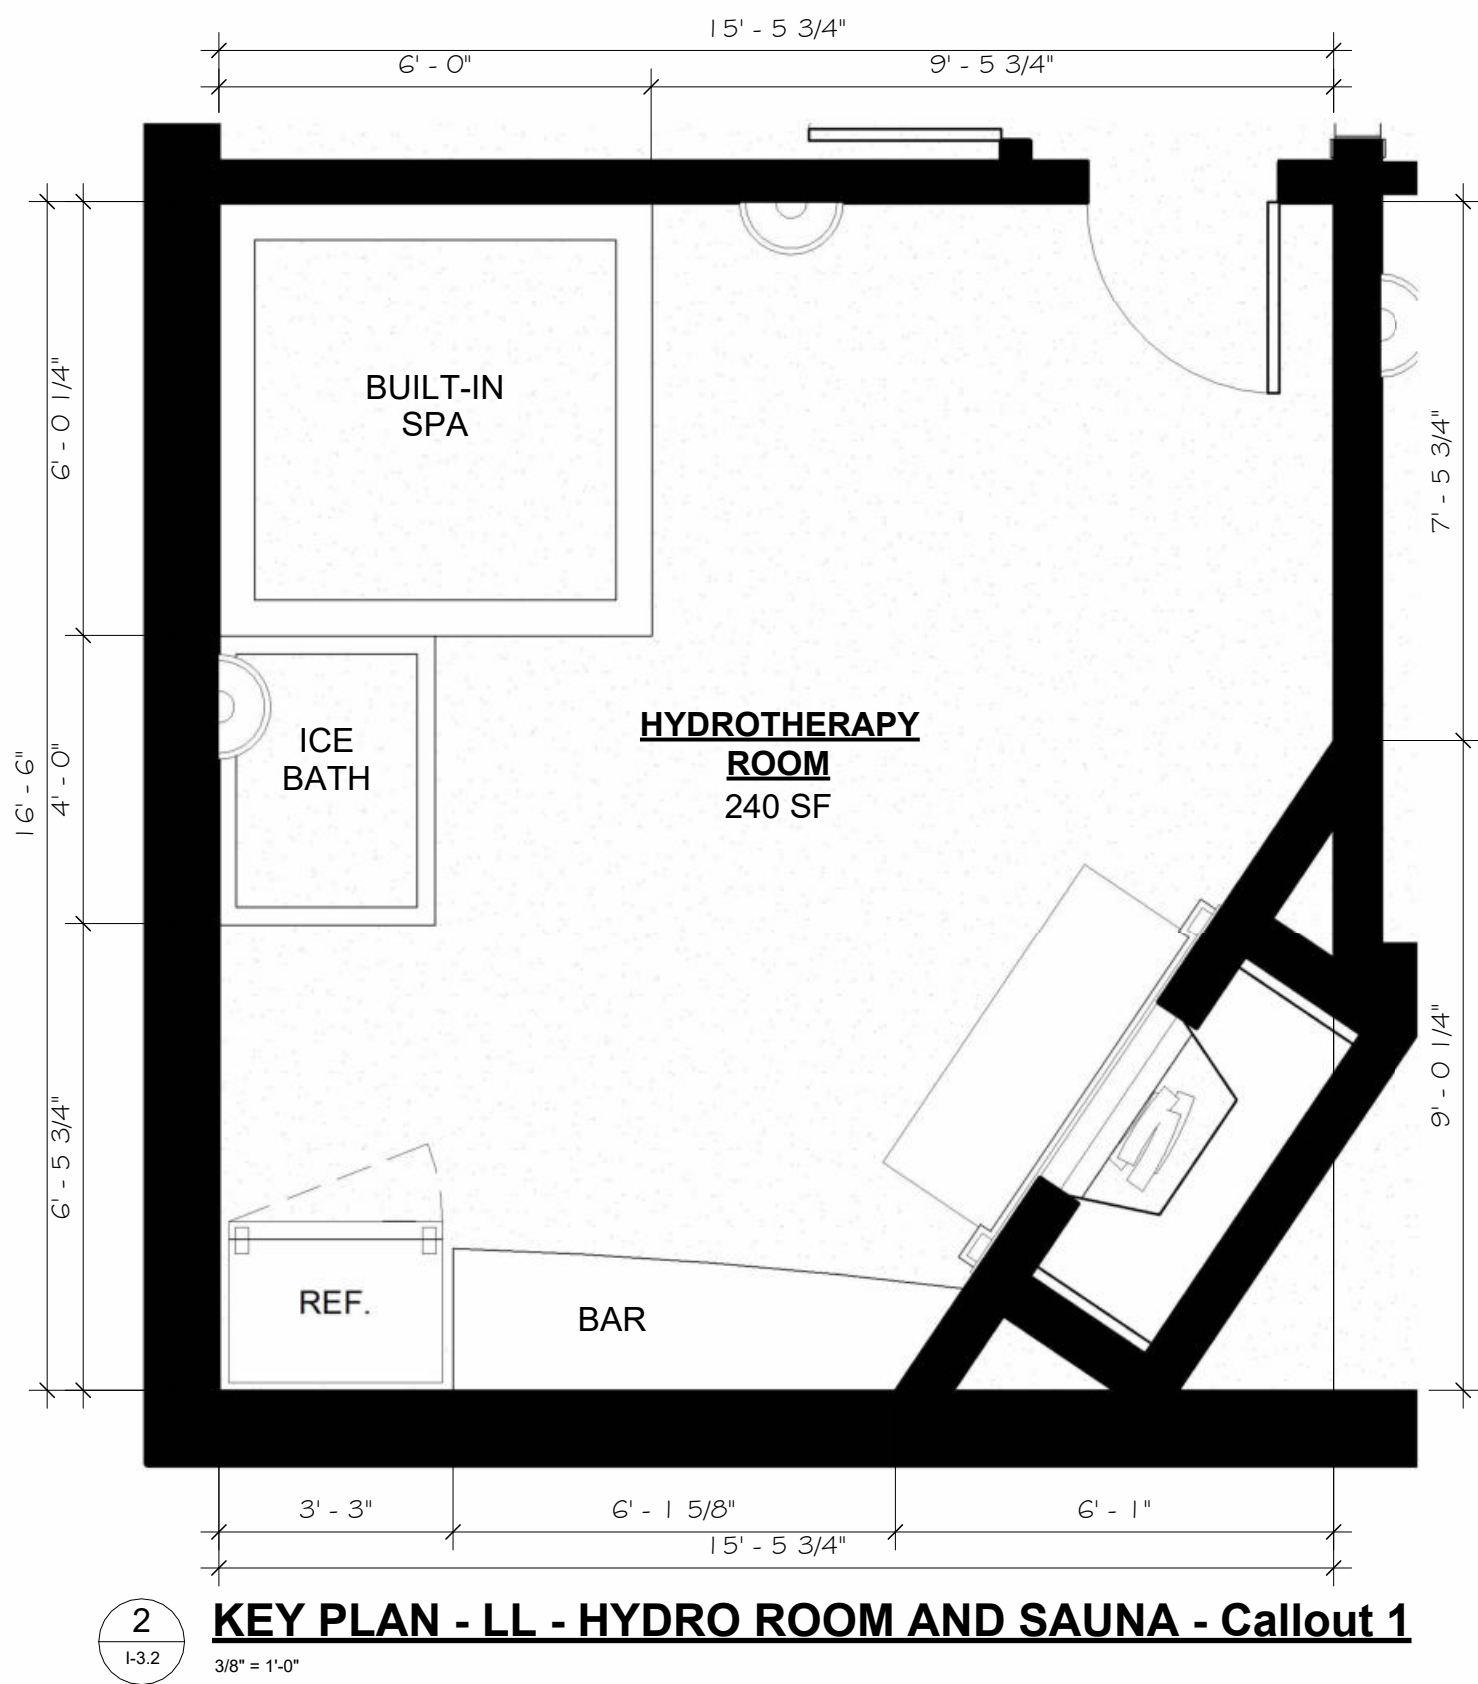

- AMENTITIES:**
- BUILT-IN SPA
 - ICE BATH
 - FRIDGE AND BAR
 - FIRE PLACE



EXISTING CONDITIONS

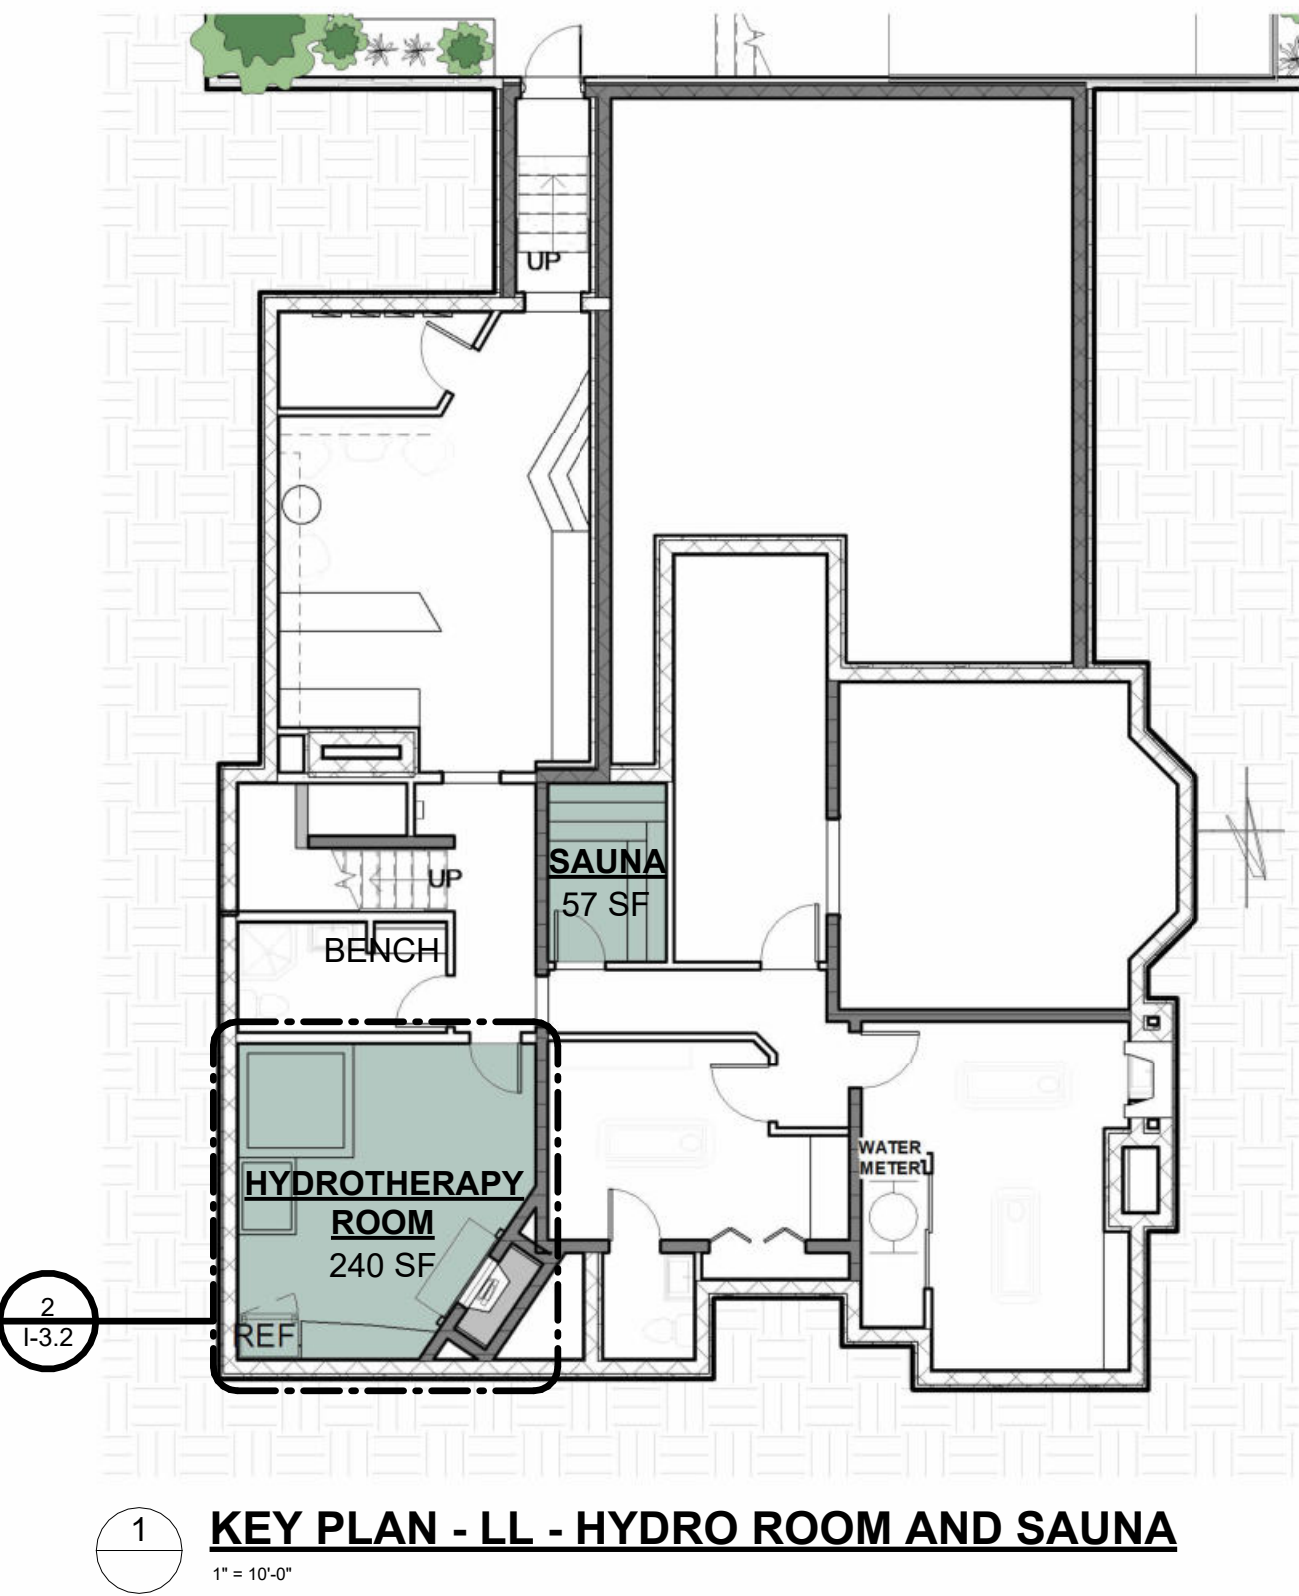

LOWER LEVEL MASSAGE ROOM

- DESIGN ELEMENTS:**
- NATURAL EARTHY TONE AND PALETTE
 - TEXTURED FEATURE WALL WITH ILLUMINATION ACCENTS
 - SERVICE COUNTER FOR OIL AND MATERIALS

- AMENITIES:**
- MASSAGE BEDS, RELAXING LIGHTING, NATURAL ELEMENTS


LIGHTER SCHEME




DARKER SCHEME



INSPIRATION

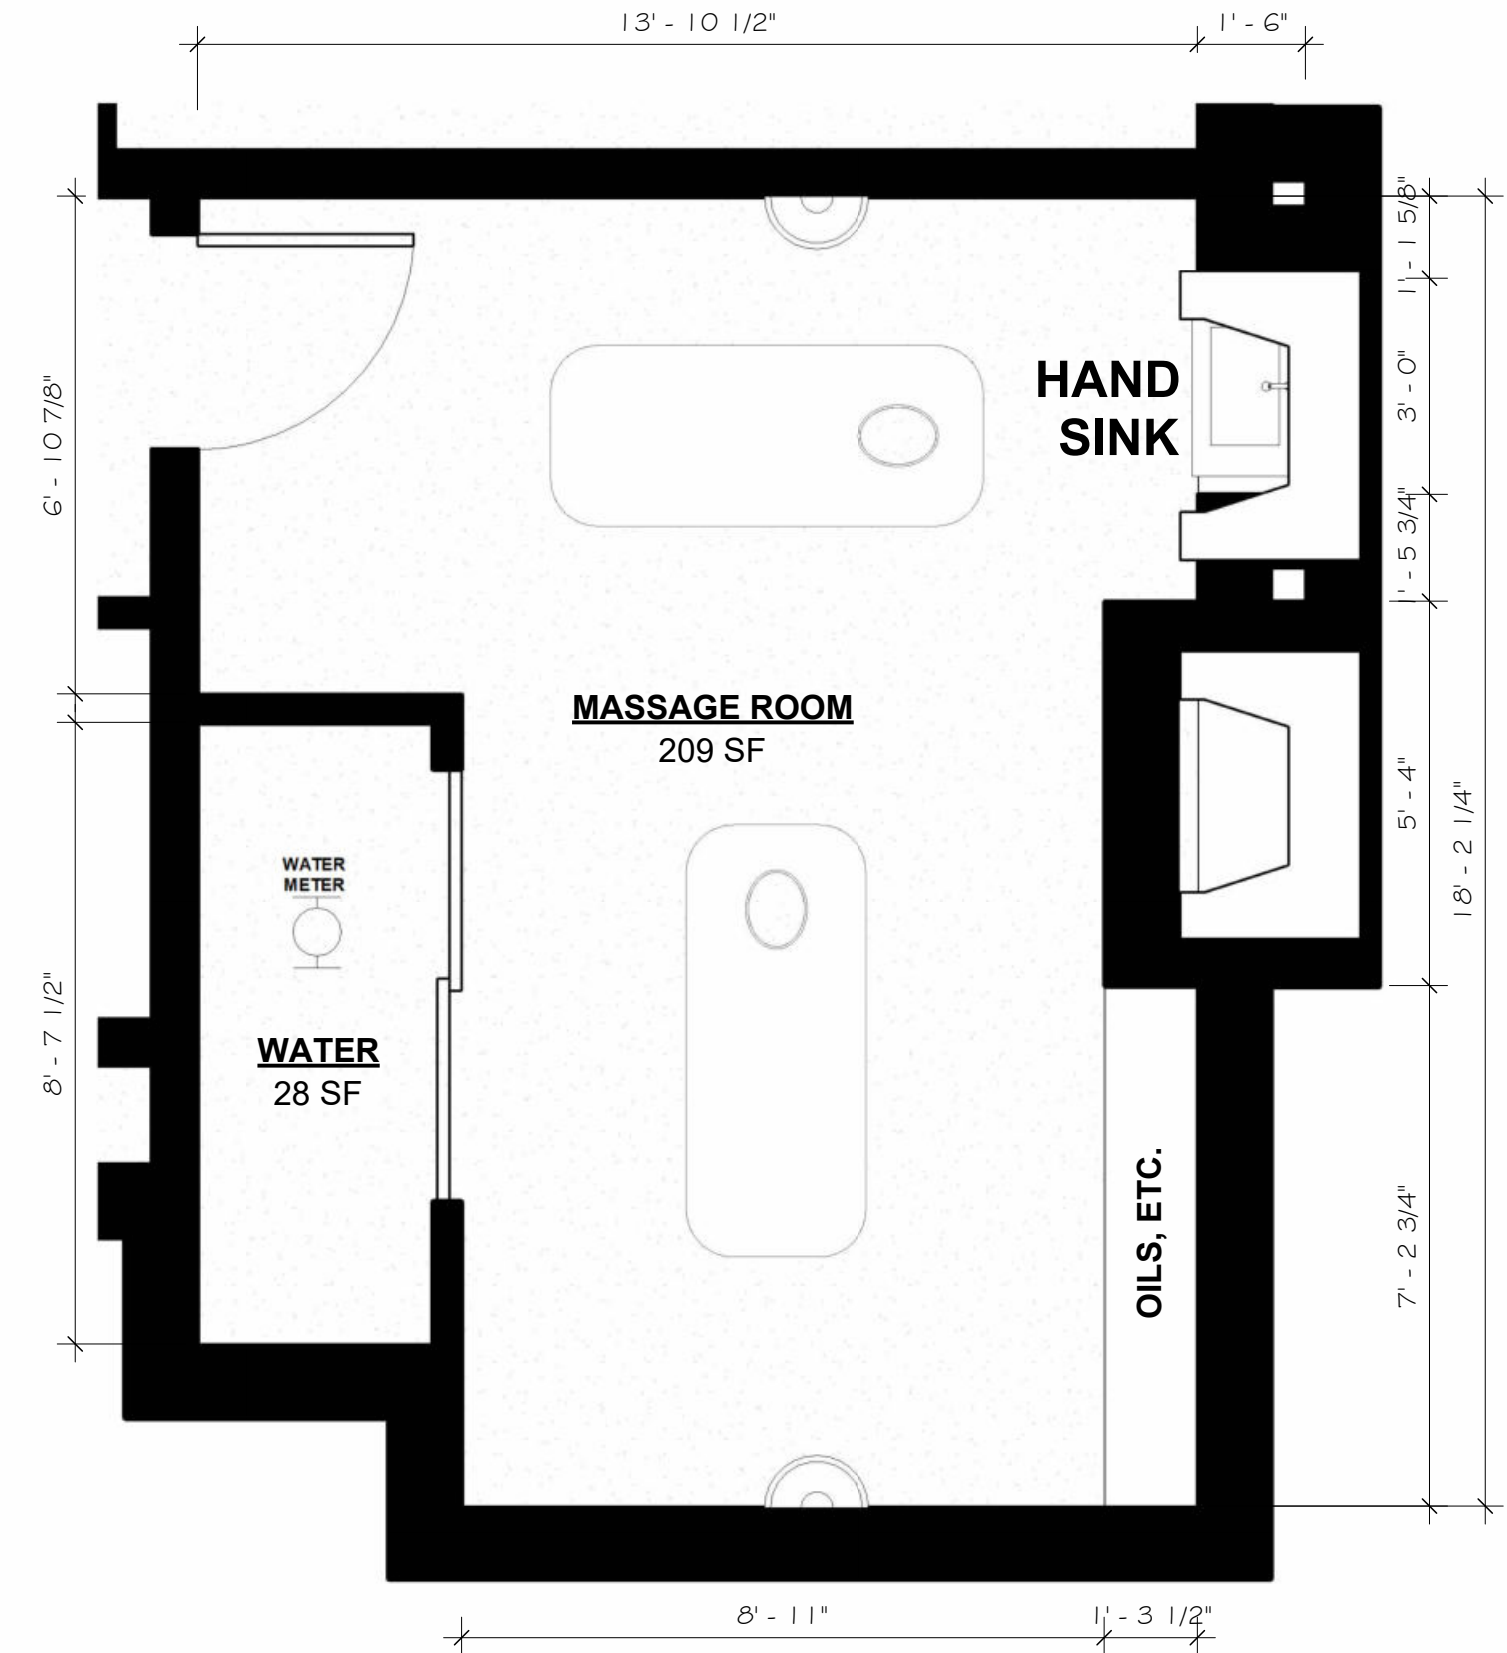

2 ENLARGED PLAN - LL - MESSAGE ROOM
3/8" = 1'-0"

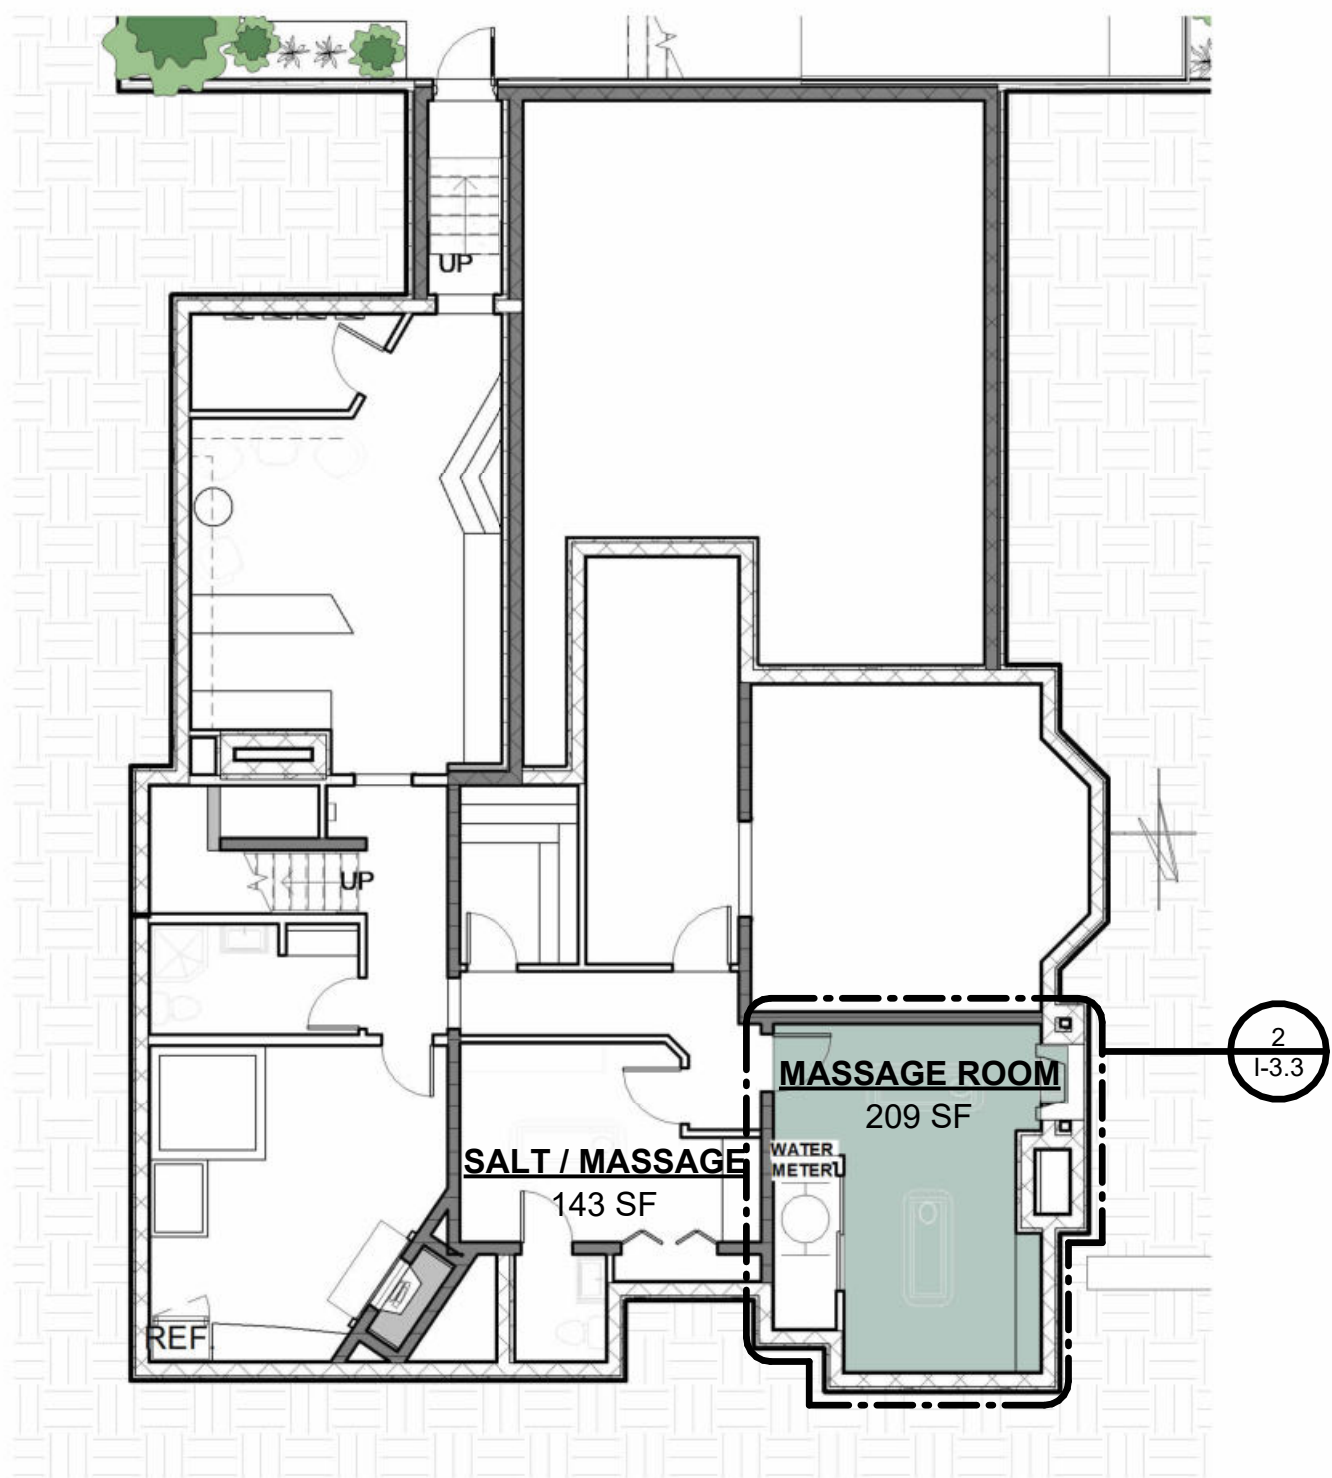

1 KEY PLAN - LL - MESSAGE ROOMS
1" = 10'-0"



EXISTING CONDITIONS

LOWER LEVEL SALT ROOM


DESIGN ELEMENTS:

- NATURAL EARTHY TONE AND PALETTE
- TEXTURED FEATURE WALL WITH ILLUMINATION ACCENTS
- SERVICE COUNTER FOR OIL AND MATERIALS


AMENITIES:

MASSAGE BEDS, RELAXING LIGHTING, NATURAL ELEMENTS


LIGHTER SCHEME

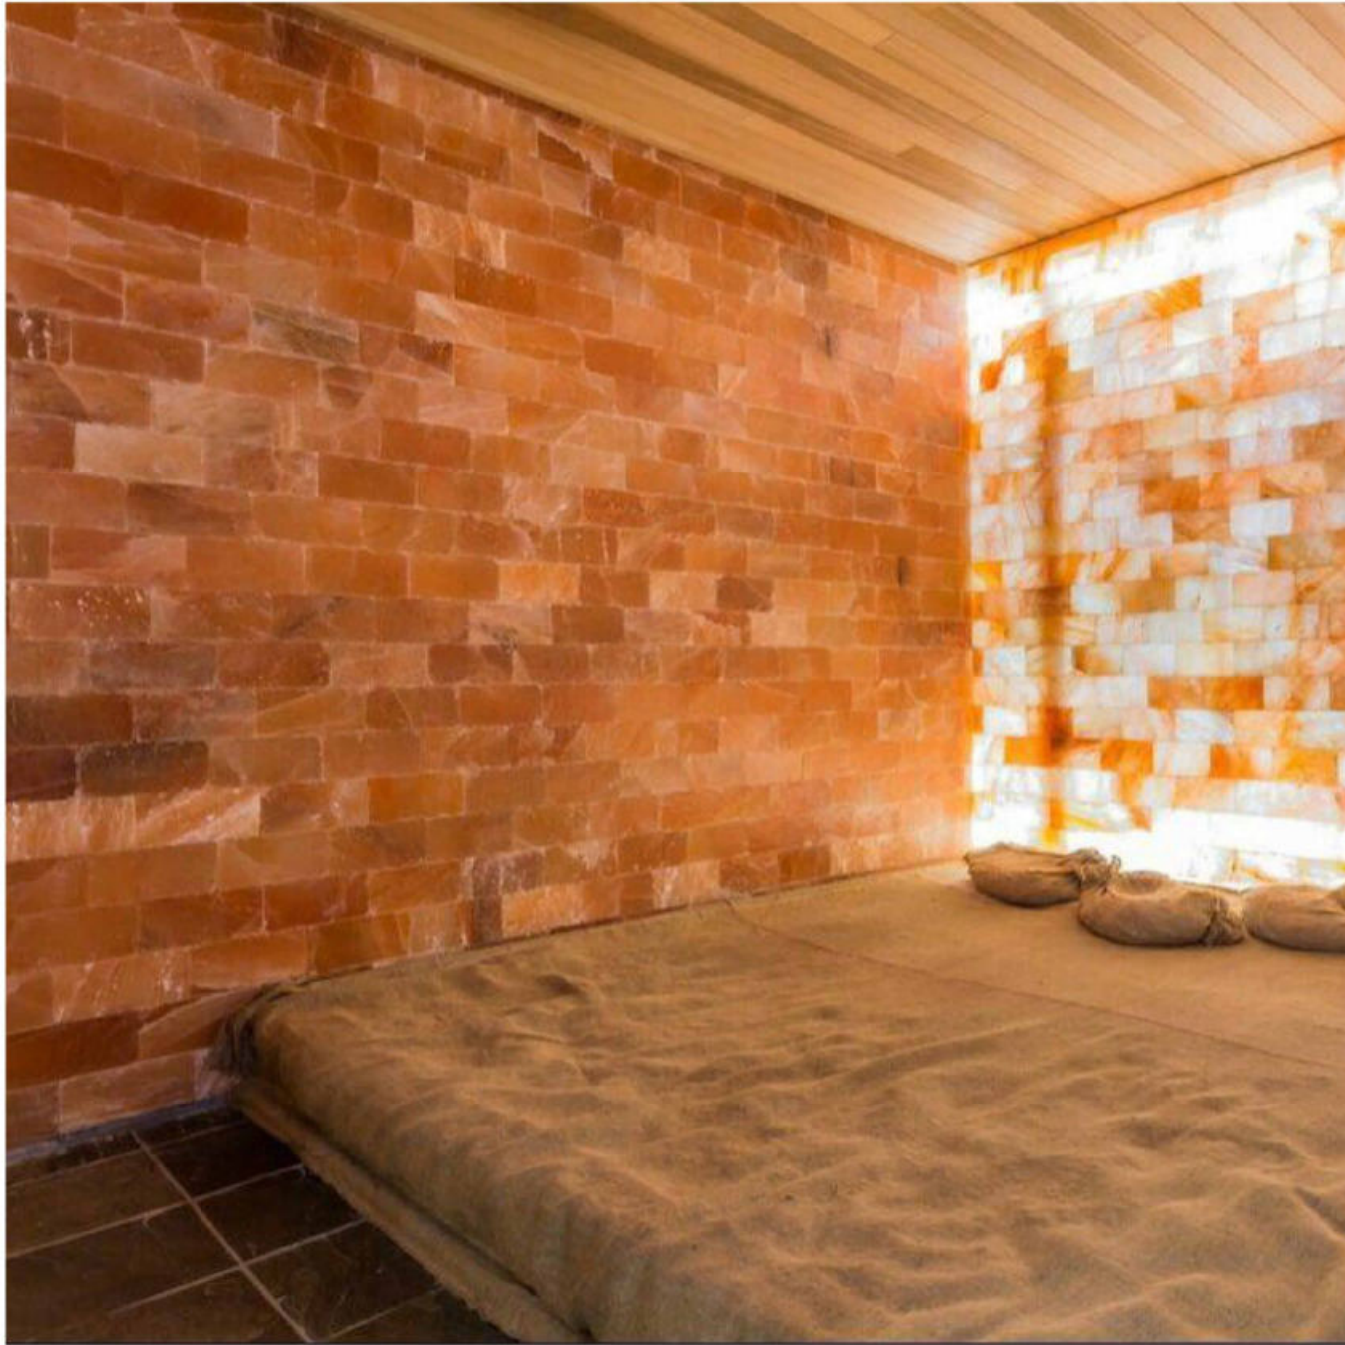

DARKER SCHEME

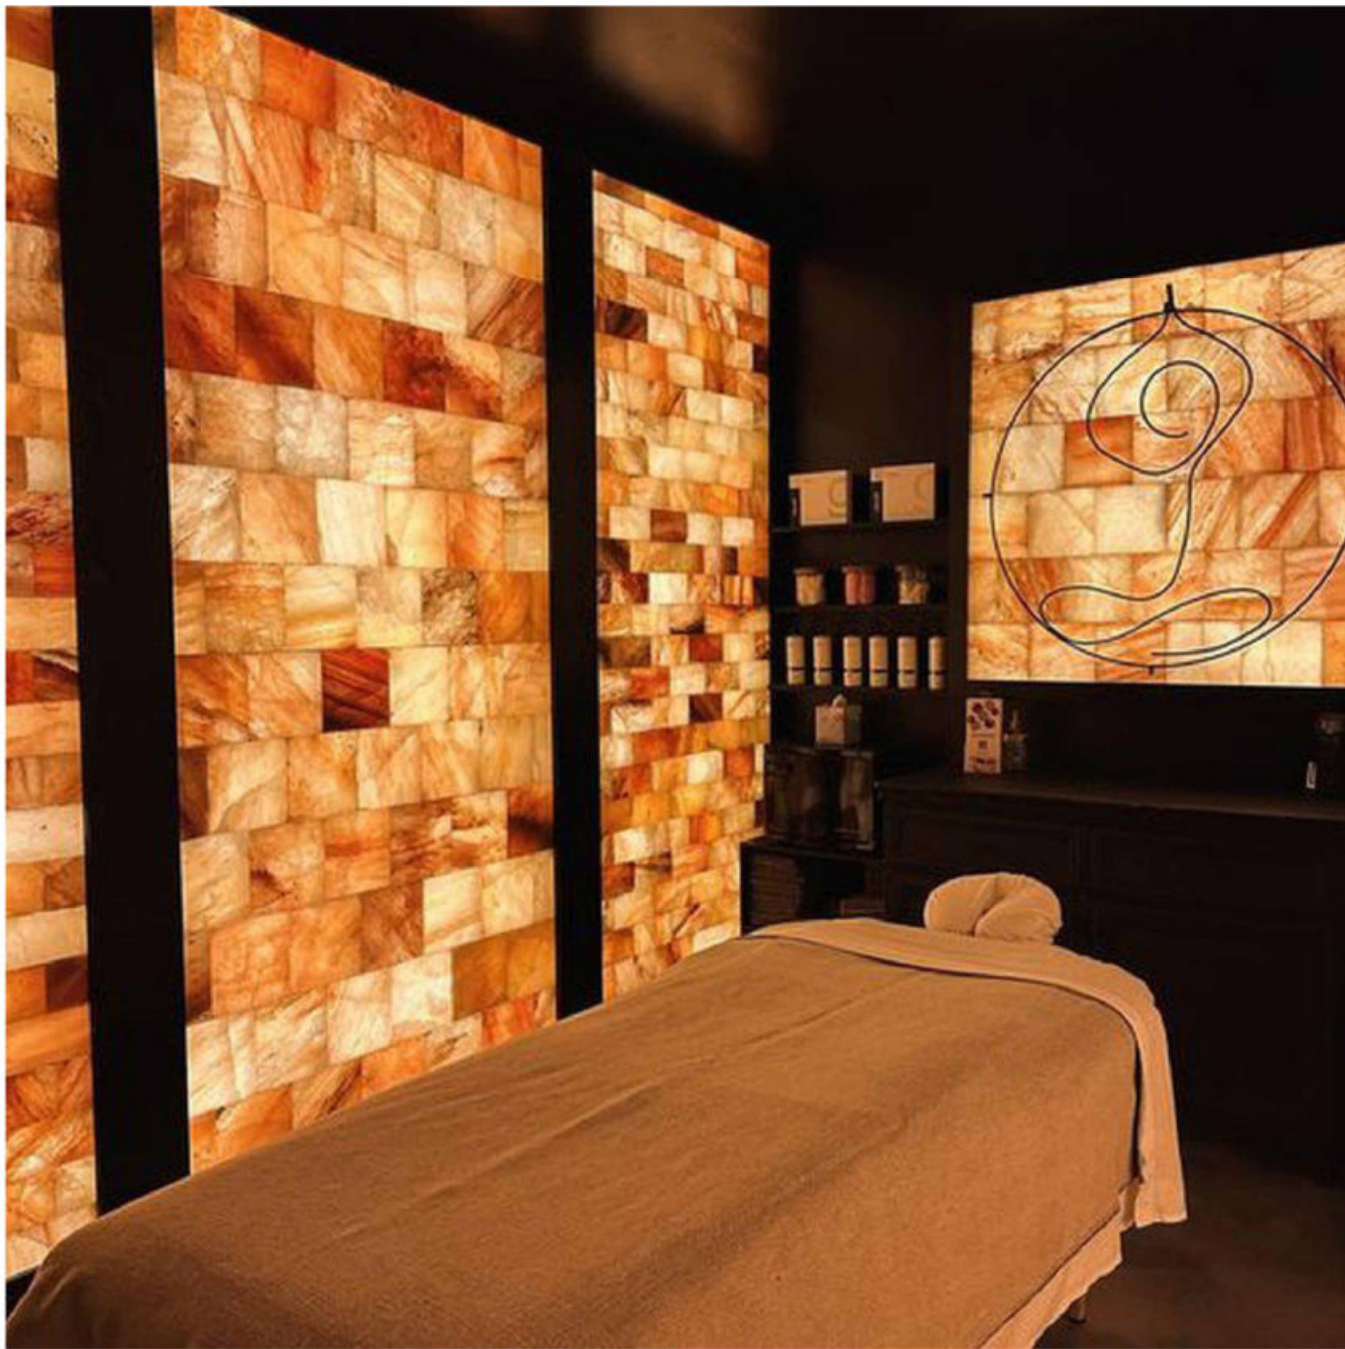


INSPIRATION

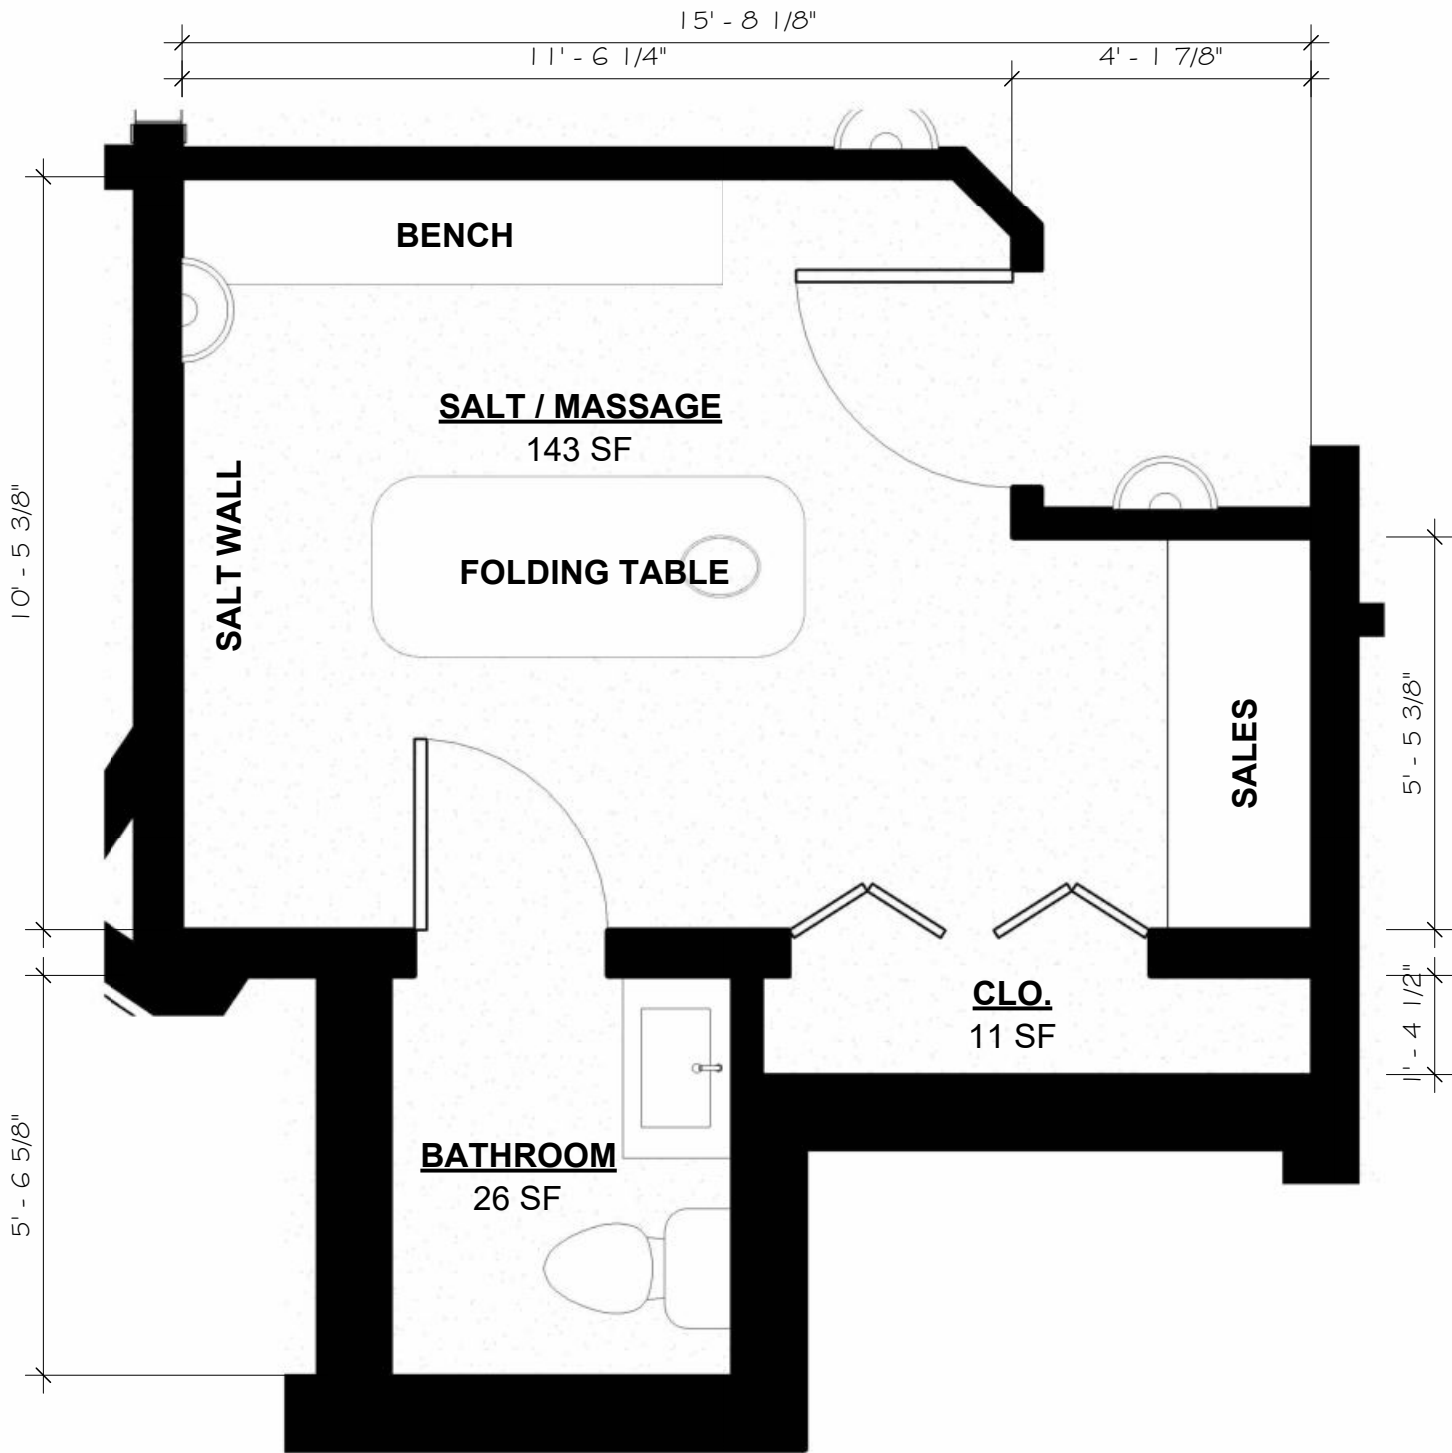

1 ENLARGED PLAN - LL - MASSAGE SALT ROOM
3/8" = 1'-0"



EXISTING CONDITIONS

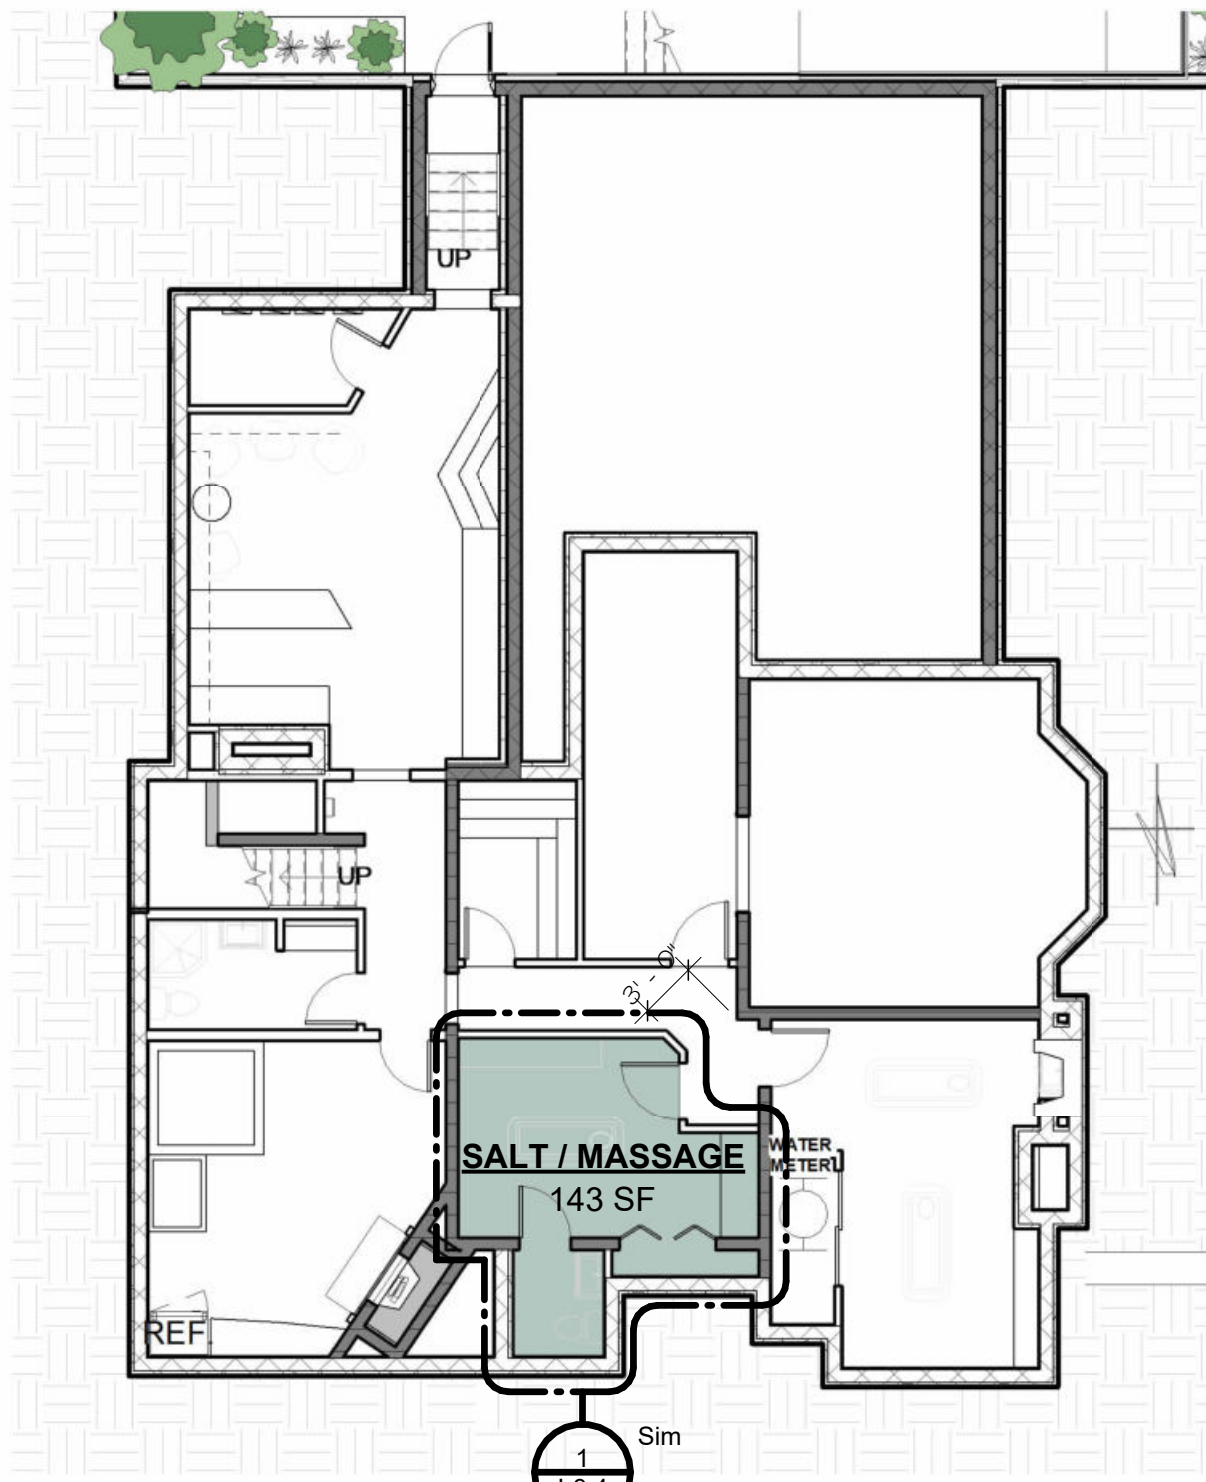

2 KEY PLAN - LL - MASSAGE SALT ROOM
1" = 10'-0"

