

## HISTORIC DISTRICT COMMISSION APPLICATION FOR WORK APPROVAL

City of Detroit - Planning & Development Department 2 Woodward Avenue, Suite 808	APPLICATION ID
Detroit, Michigan 48226	HDC2025-00068
PROPERTY INFORMATION	
ADDRESS(ES): 708 PALLISTER	
HISTORIC DISTRICT: New Center Area	
SCOPE OF WORK: (Check ALL that apply)	
Windows/ X Walls/ Painting Roof/Gutters/ X Siding	Porch/Deck/Balcony Other
X     Demolition     Signage     New Building     Addition     X	Site Improvements (landscape, trees, fences, patios, etc.)
BRIEF PROJECT DESCRIPTION: exterior renovation to add dormers, new siding, front porch and rear deck, repair garage and	d new windows.
APPLICANT IDENTIFICATION	

TYPE OF APPLICANT: Architect/Engineer/Consultant

NAME: Timothy Flintoff	COMPANY NAME: 4545 Architecture		
ADDRESS: 2761 E. Jefferson Ave, Ste 302	CITY: Detroit	STATE: MI	<b>ZIP:</b> 48207
<b>PHONE:</b> +1 (313) 450-4545	EMAIL: tim.flintoff@4545arc	hitecture.com	

#### I AGREE TO AND AFFIRM THE FOLLOWING:

I understand that the failure to upload all required documentation may result in extended review times for my project and/or a denied application.



X

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I understand that the review of this application by the Historic District Commission does not waive my responsibility to comply with any other applicable ordinances including obtaining appropriate permits (building, sign, etc.) or other department approvals prior to beginning the work.

I hereby certify that the information on this application is true and correct. I certify that the proposed work is authorized by the owner of record and I have been authorized to make this application as the property owner(s) authorized agent.

SIGNATURE

02/18/2025

DATE

NOTE: Based on the scope of work, additional documentation may be required. See <a href="www/detroitmi.gov/hdc">www/detroitmi.gov/hdc</a> for scope-specific requirements.

#### **PROJECT DETAILS – TELL US ABOUT YOUR PROJECT**

Instructions: Add project details using the text box in each section. If your details exceed the space provided, attach the details via the attachment icon for that section.

#### **ePLANS PERMIT NUMBER:**

brand and color of the shingles proposed.

(only applicable if you've already applied for permits through ePLANS)

NA

#### GENERAL

1.	<b>DESCRIPTION OF EXISTING CONDITION</b> Please tell us about the current appearance and conditions of the areas you want to change. You may use a few senter attach a separate prepared document on the right. (For example, "existing roof on my garage is covered in gray asphale in poor condition.")	nces or t shingles
		Ø
2.	<b>PHOTOGRAPHS</b> Help us understand your project. Please attach photographs of all areas where work is proposed.	Ø
3.	<b>DESCRIPTION OF PROJECT</b> In this box, tell us about what you want to do at the areas described above in box #1. (For example, Install new asphalt roofing at garage.)	shingle
		Ø
4.	<b>DETAILED SCOPE OF WORK</b> In this box, please describe all steps necessary to complete the work described in box #3. (For example, "remove exist shingles, replace wood deck as necessary, replace wood eaves, install roof vents, replace rotted fascia boards, paint, o worksite.")	
		Ø
5.	<b>BROCHURES/CUT SHEETS</b> Please provide information on the products or materials you are proposing to install. For example, a brochure on the	

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#### ADDITIONAL DETAILS

#### 6. WINDOWS/DOORS

Detailed photographs of window(s) and/or door(s) proposed for replacement showing the condition of the interior and exterior of the window(s) and/or door(s)

#### 7. DEMOLITION

If demolition is proposed for reasons of structural failure or catastrophic damage, please provide illustrated report from structural engineer or licensed architect.

#### 8. SITE IMPROVEMENTS

If site improvements are proposed, please provide any relevant site improvement plans pertaining to your project.



February 18, 2025

708 Pallister St., Detroit, MI 48202

RE: 708 Pallister Exterior Renovations

#### Project Narrative

708 Pallister is a single family home in the New Center Area historic district. It is located in the middle of the pedestrian-only block of Pallister St., between 3rd Ave. and Bethune Ct. The structure is two stories, with a traditional hip roof and covered porch entry, and an existing street-facing dormer; three new construction dormers have been added in the last year. It features painted horizontal wood siding on the first floor exterior, with painted wood shake above, on traditional wood framing. The street-facing south elevation also features a bay window on the first floor, adjacent to the existing covered porch. The structure is approximately 1557 GSF, plus an attic and basement. The property also has a detached, single-story 2 car garage that is approximately 500 GSF.

The existing front porch has had a painted brick veneer installed to match the existing foundation wall of the house, as well as a new street-facing masonry stair; the existing east-facing stair has been replaced. Two wrapped and painted wood posts have been installed, with plans to install a matching third post, in order to support the existing porch roof. Hip roofs previously built on two of the three new dormers will be removed and replaced with gable roofs to better align with the design of the existing street-facing dormer; they are to have matching overhangs and sloped soffits. Fascia and eave elements are to be painted wood, matching the existing color choices. The installed sliding windows on the new dormers are to be removed and replaced with the casement style which was previously approved by HDC (Anderson 100 series with simulated divided lites). A new casement window of the same style will be installed at the east dormer, which currently has no windows present. All dormers, including the original street-facing dormer, have had composite siding installed; this is to be removed and replaced with a wood shake siding, and painted to match the rest of the house (HDC approved C:4 "Yellowish White" with black wood trim).

A new window has been installed at the east elevation first floor. The installed inset composite trim is to be removed and replaced with a wood trim which sits atop the siding, similar to the trim of the original

# 4545 architecture

windows, with trim member sizing also to match. Further, this new window's inset trim has extended into an existing horizontal 'belt band' which visually separates the first and second stories. The 'belt band' is to be removed and replaced with a painted wood member in the same style that was previously present, extending the width of the elevation and the top of the new window.

At the east elevation second floor and the north elevation first floor, installed sliding windows will be removed and replaced Anderson 400 series casement windows with simulated divided lites in the style of the original windows, and painted black. Two glass block windows at the east elevation will be removed and reset in the same plane as the original basement windows, with appropriate window screens installed in front.

The installed patio door at the rear of the house will be removed and replaced with an aluminum-clad wood french door (Anderson E-series) with a 2-over-1 fractional divided lite configuration. All newly installed windows will have simulated divided lites installed to match the visual style of the previously present windows (see architectural drawings for specific configurations). The rear deck will have Trex composite decking and railing installed in order to be visually/materially distinct from the original house, while the front porch will have wood railing installed.


A heating/cooling unit was installed at the west elevation, along with an electric meter, in the approximately 4'-0" space between the house and existing fence. It is the project's intention to keep this here, as it is less visually present than elsewhere around the house.



1 WEST ELEVATION - JANUARY 2024



2 WEST ELEVATION - NOVEMBER 26, 2024

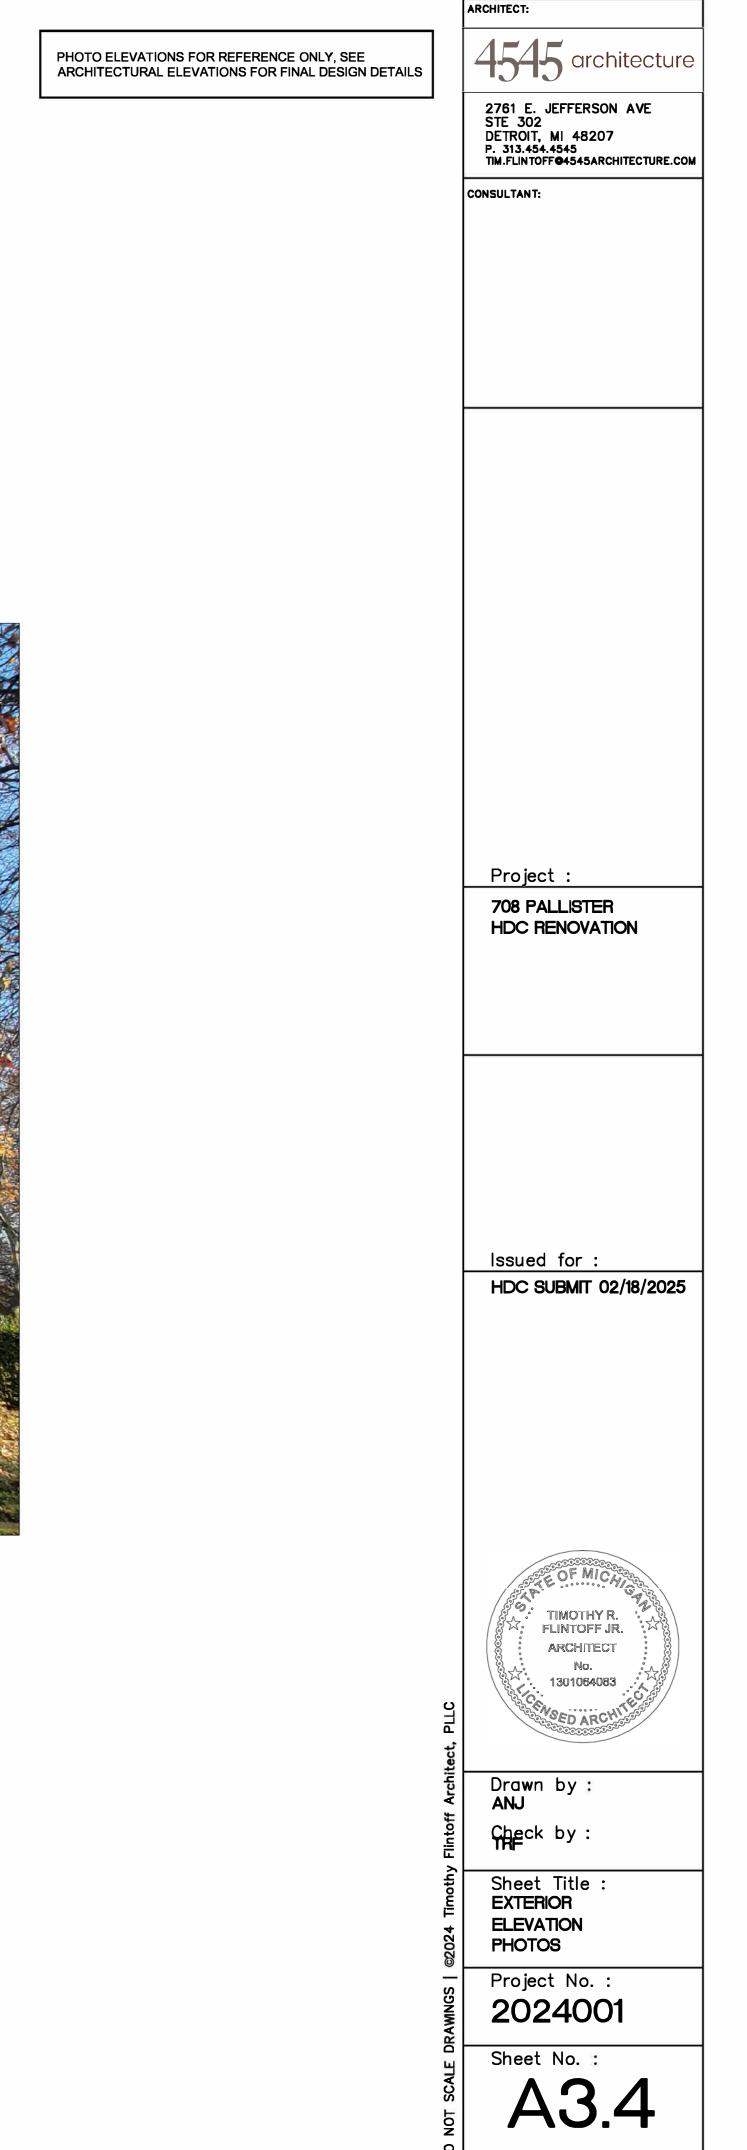




SOUTH ELEVATION - JANUARY 2024





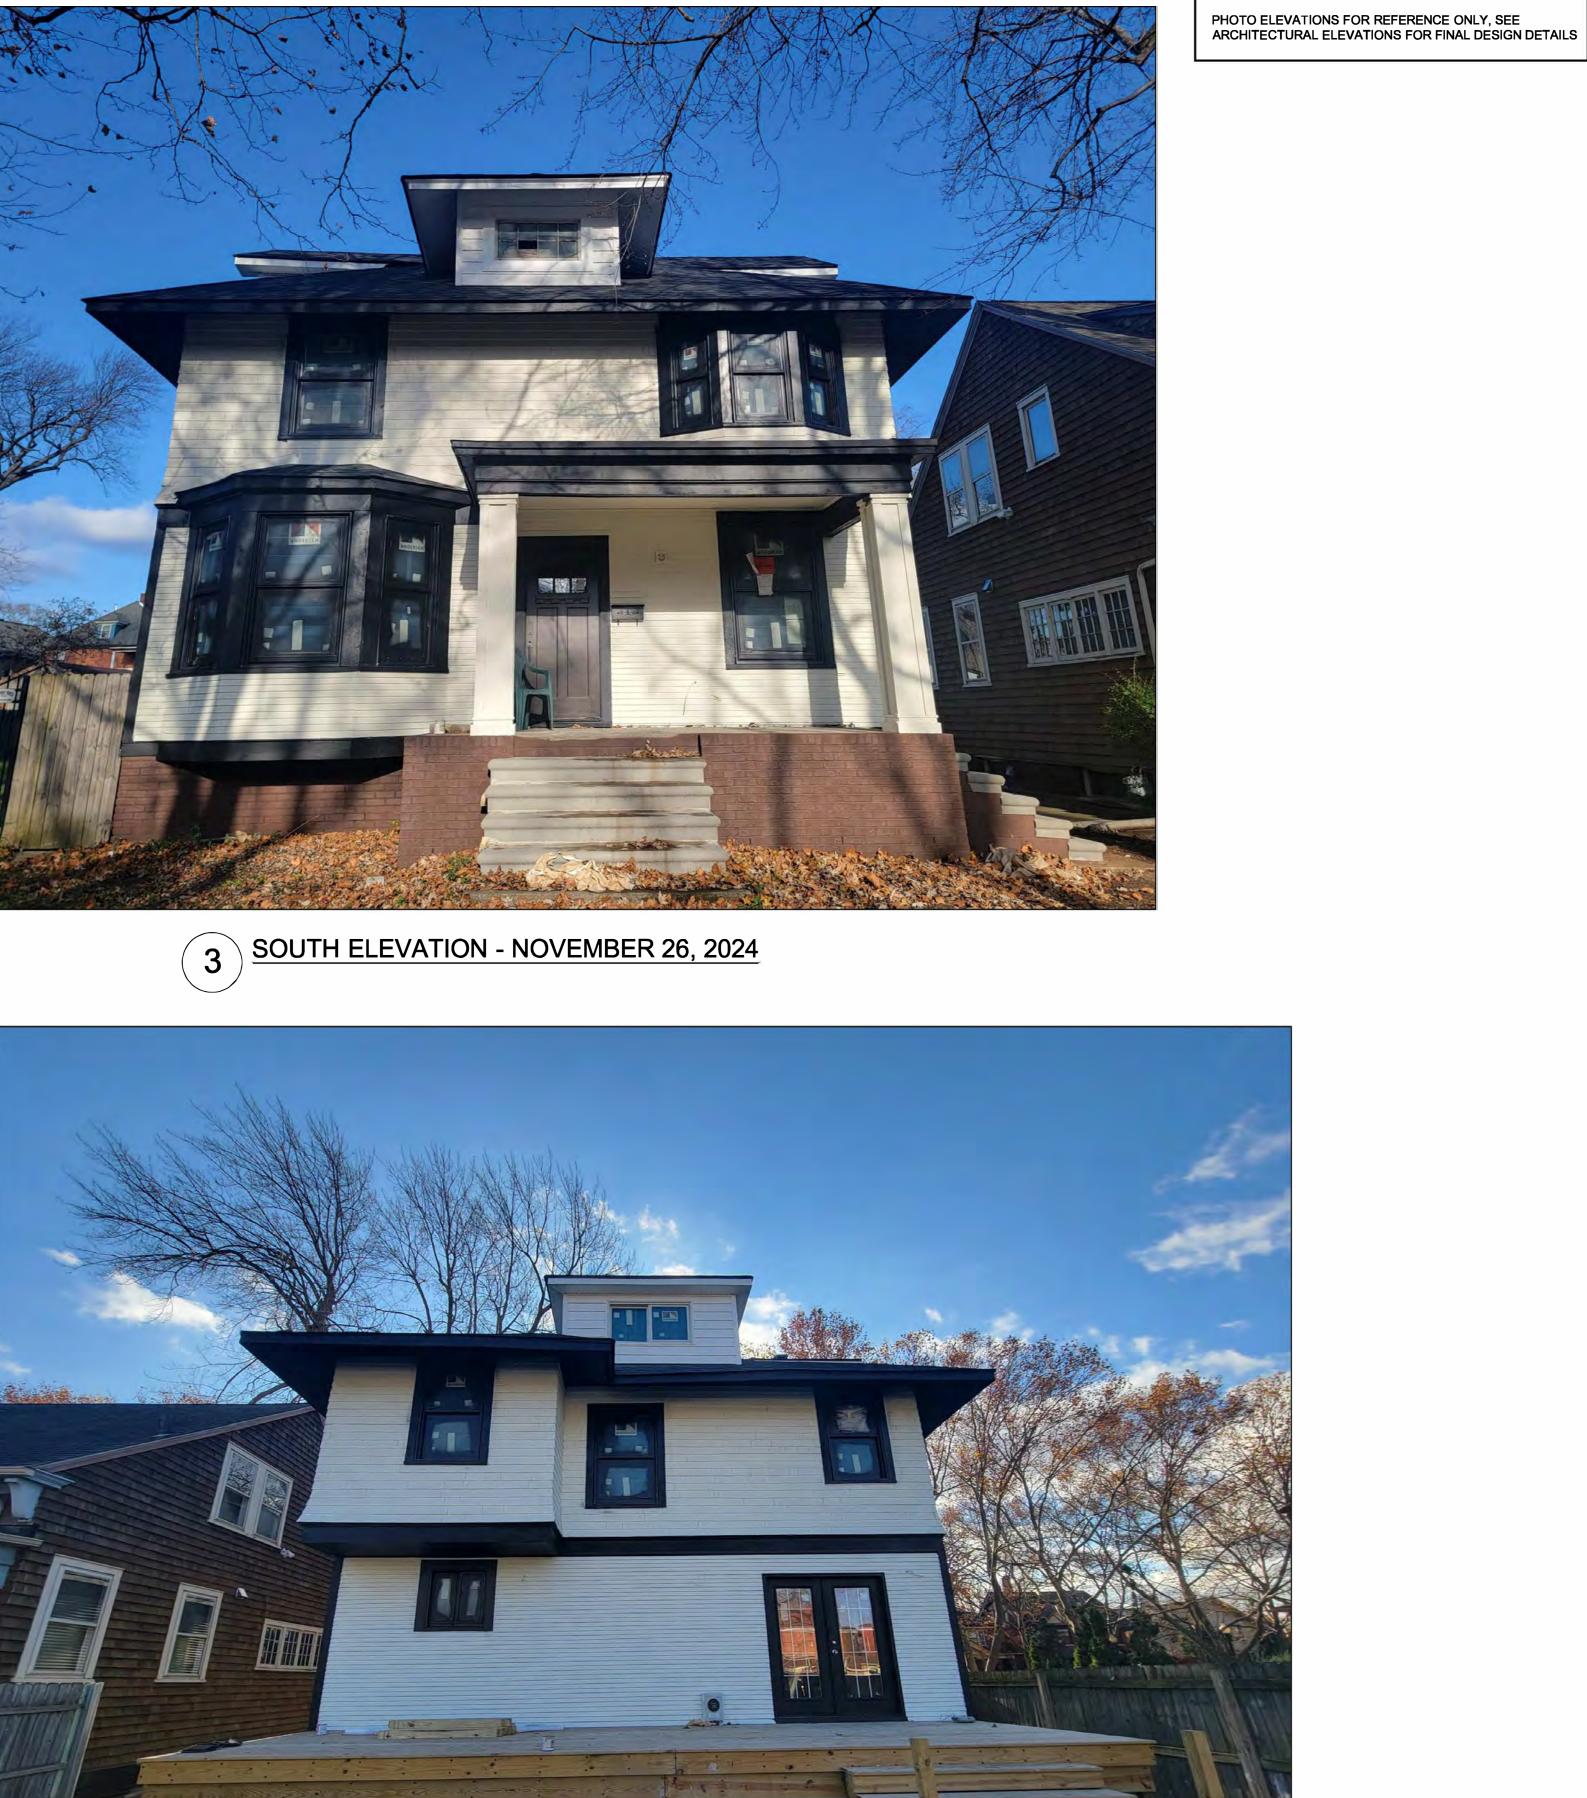





4 NORTH ELEVATION - NOVEMBER 26, 2024

ARCHITECT: 4545 architecture 2761 E. JEFFERSON AVE STE 302 DETROIT, MI 48207 P. 313.454.4545 TIM.FLINTOFF**0**4545ARCHITECTURE.COM CONSULTANT: Project : 708 PALLISTER HDC RENOVATION Issued for : HDC SUBMIT 02/18/2025 · TIMOTHY R. FLINTOFF JR. ARCHITECT 1301064083 Drawn by : ANJ Check by : Sheet Title : EXTERIOR ELEVATION PHOTOS Project No. : **2024001** Sheet No. : A3.2









— PATCH AND REPAIR AS REQ'D WITH IN-KIND MATERIALS; PAINT (COLORS TO MATCH HOUSE, SEE ELEVATIONS) (TYP.)

- REPLACE EXISTING EXTERIOR DOOR AND HARDWARE










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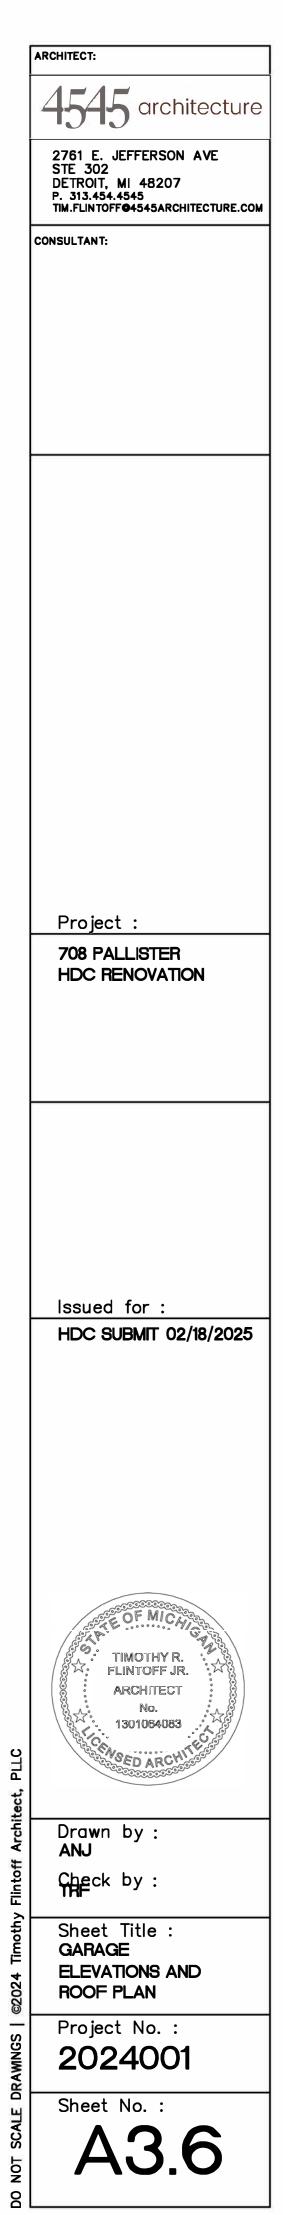





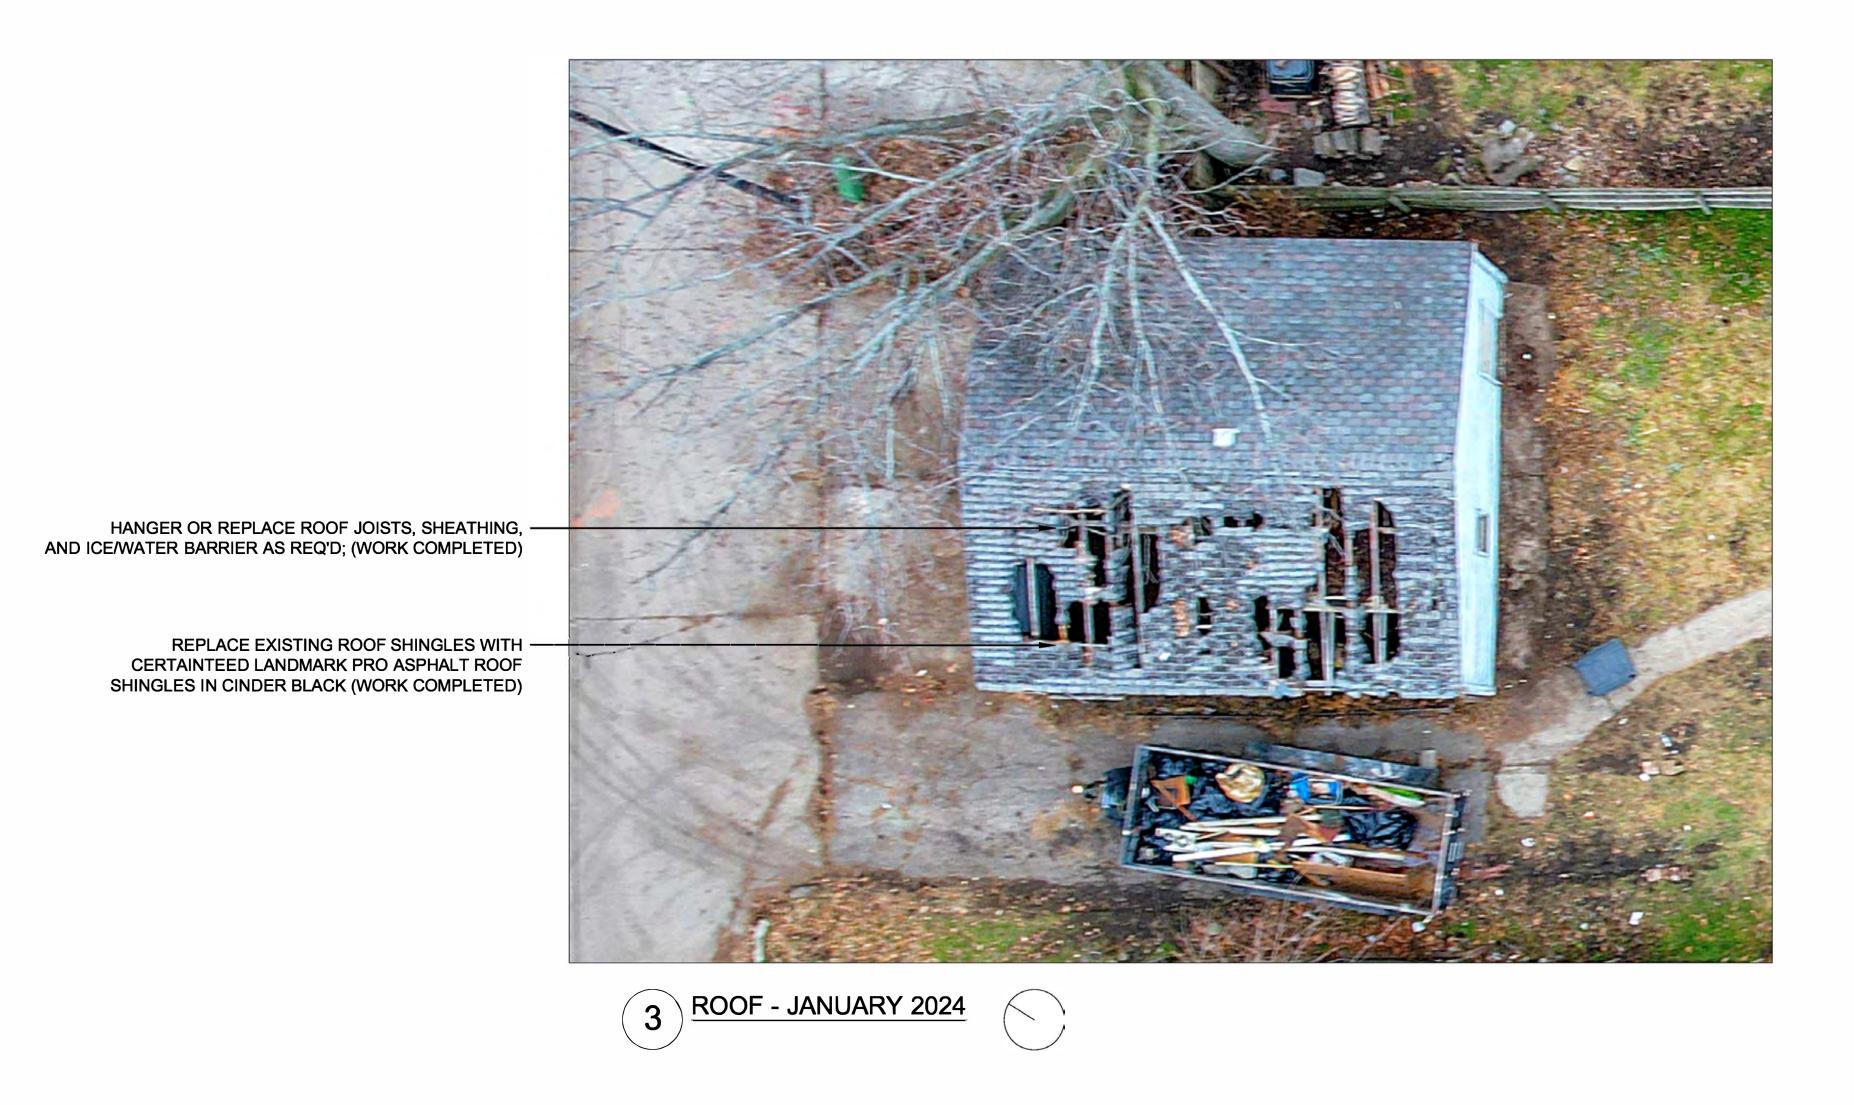

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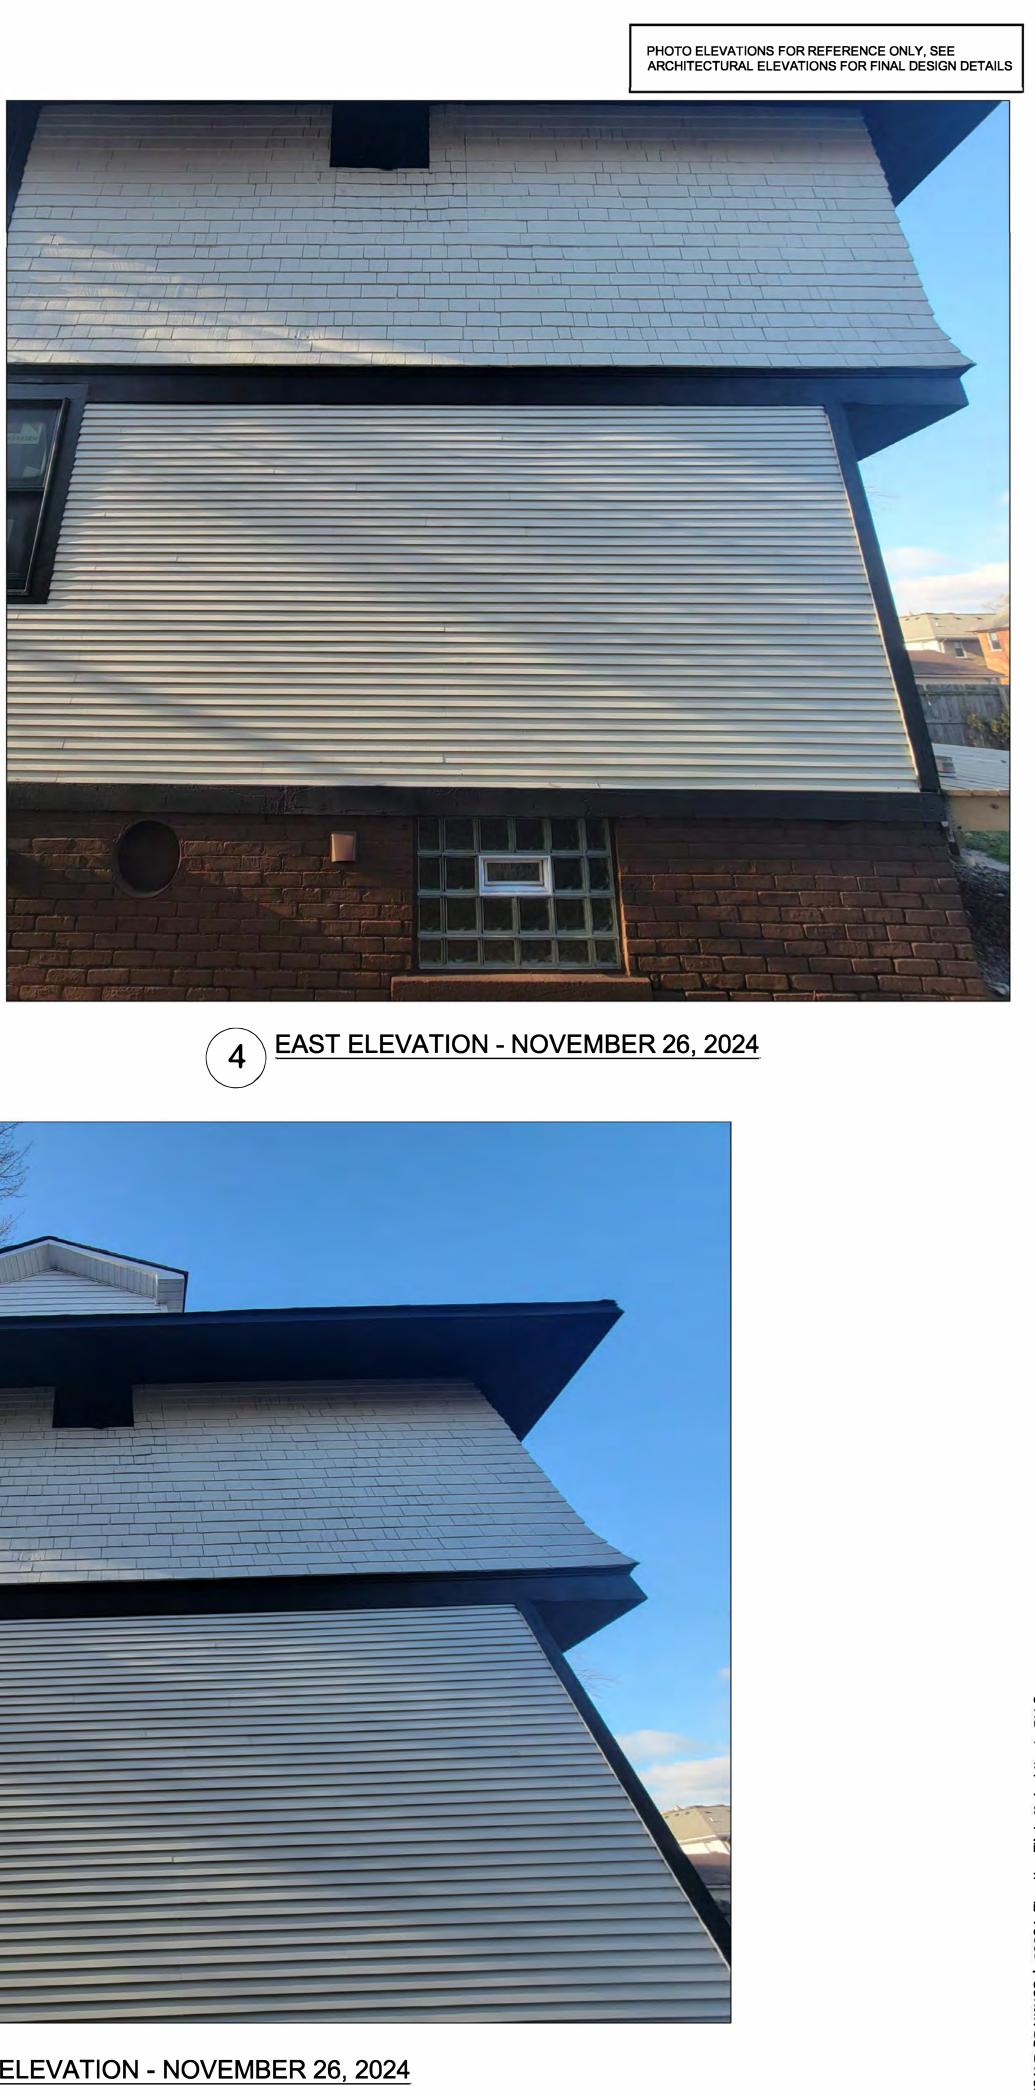






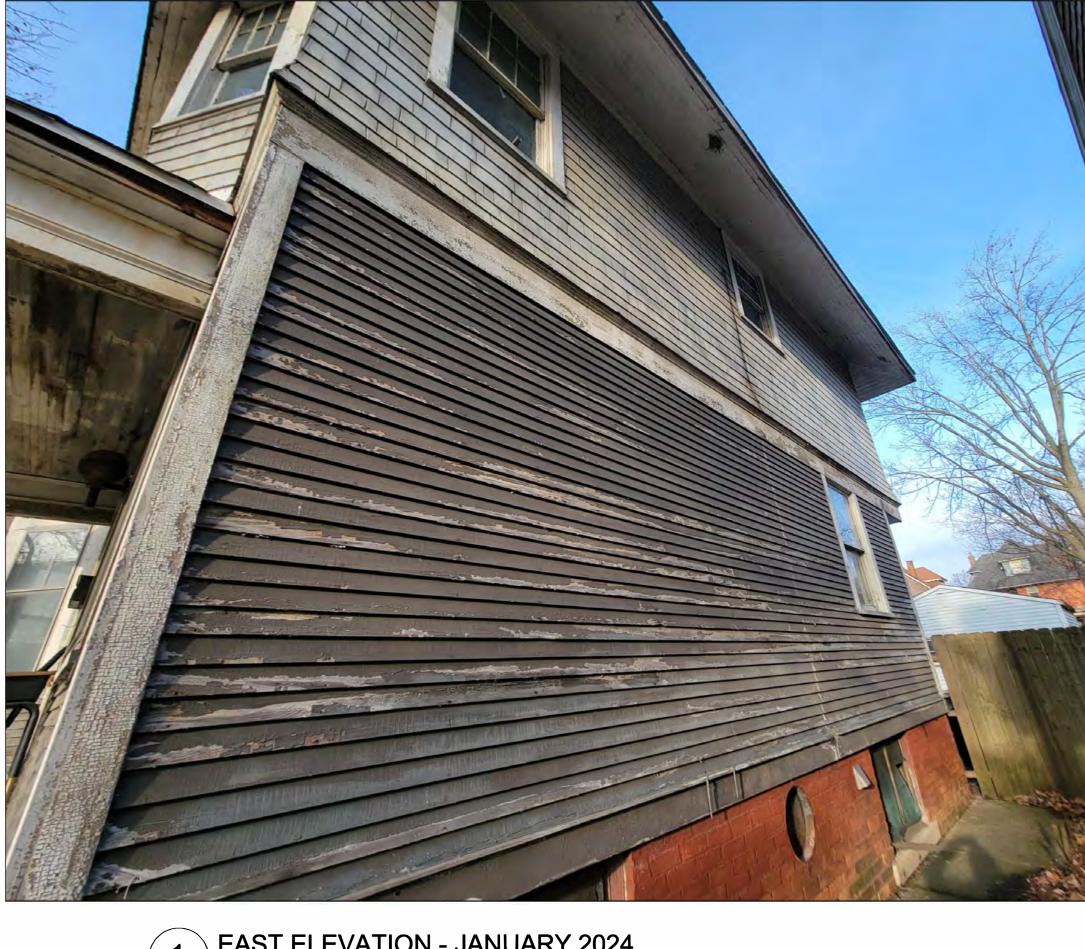










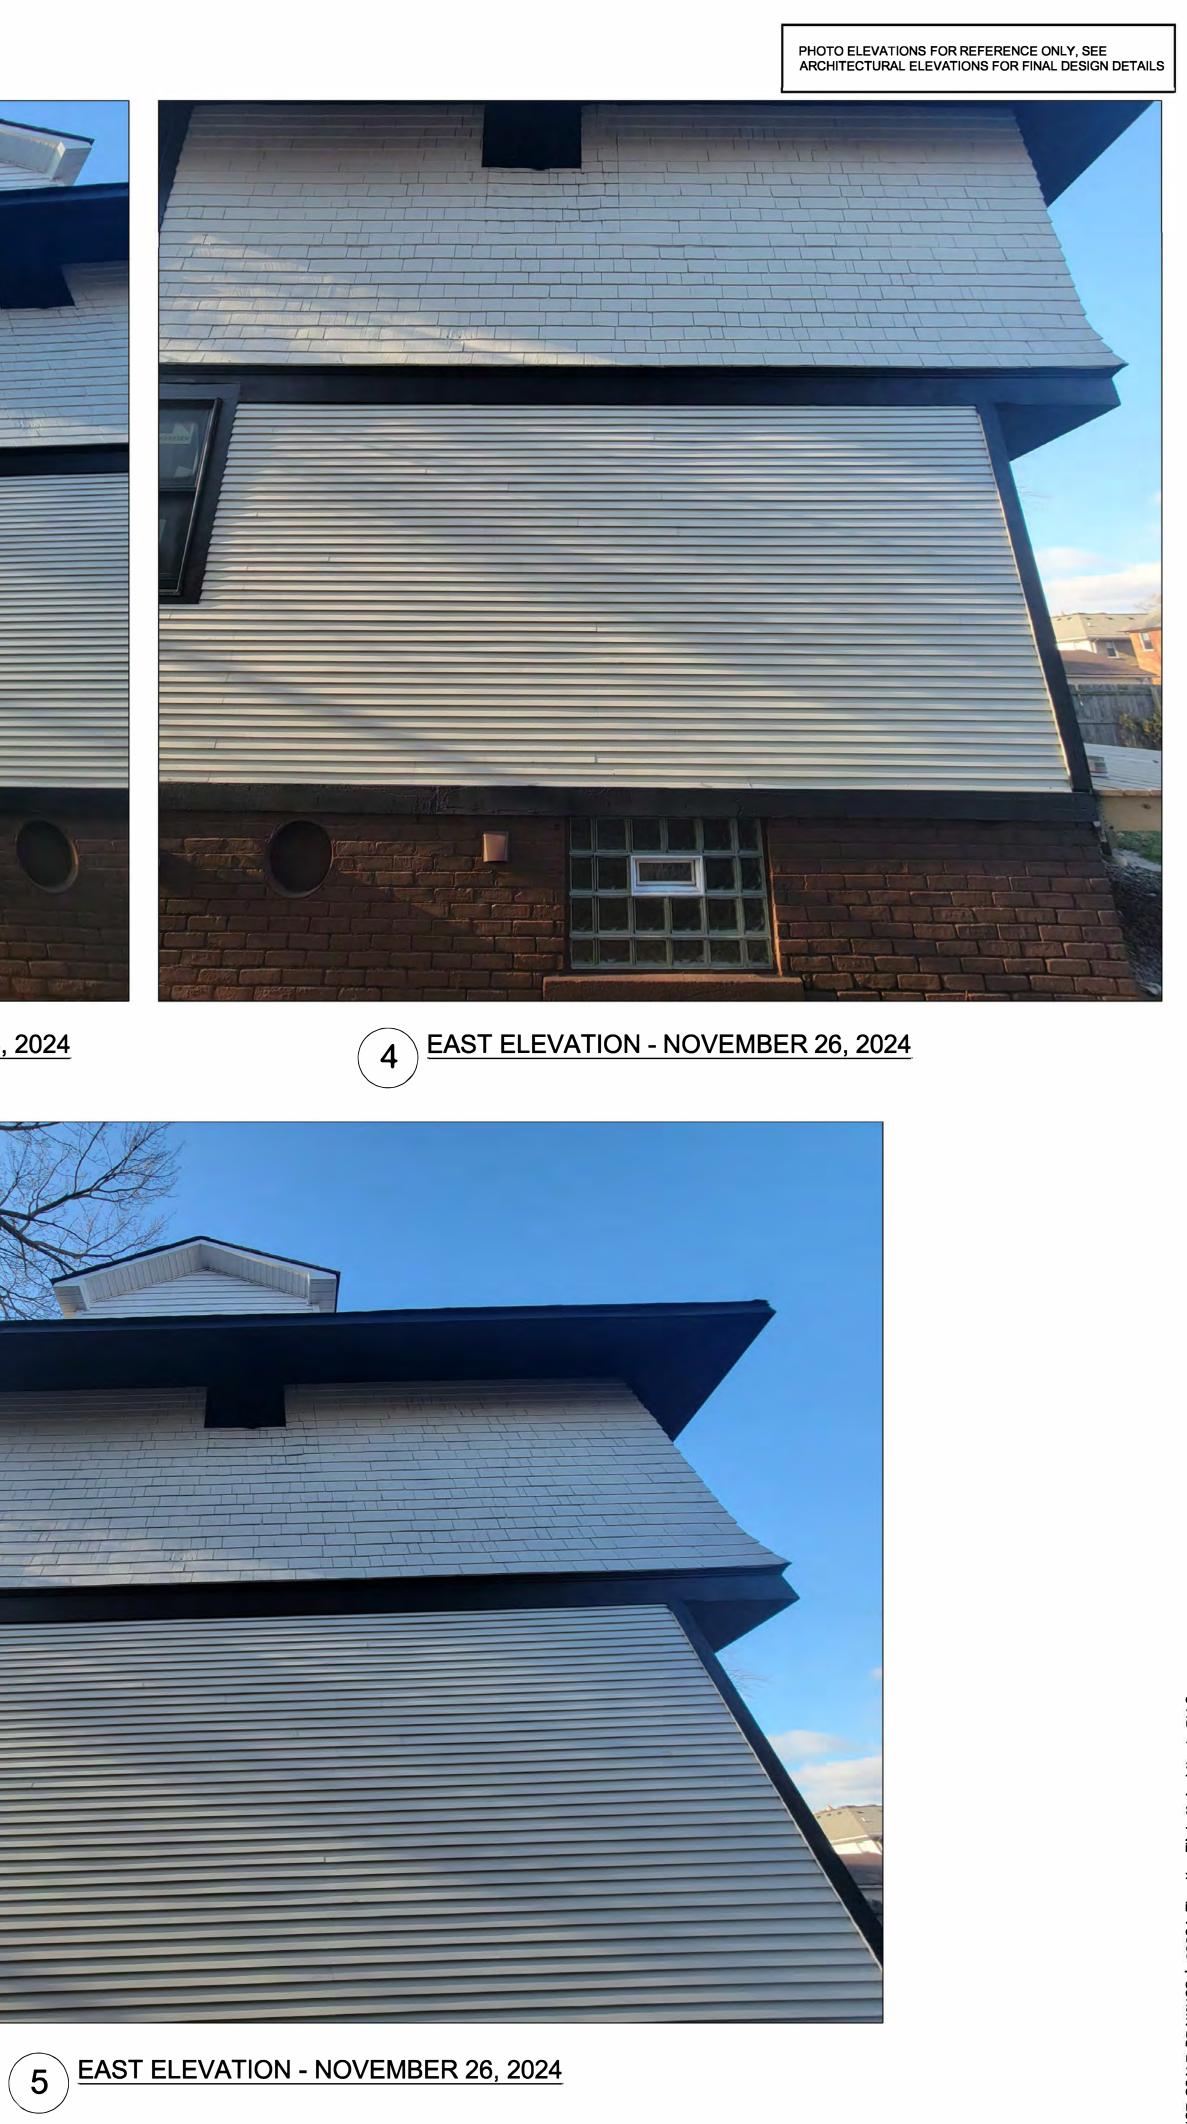


	ARCHITECT:
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	CONSULTANT:
	Project : <b>708 PALLISTER</b>
	HDC RENOVATION
	Issued for : HDC SUBMIT 02/18/2025
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	FLINTOFF JR.
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	Project No. : <b>2024001</b>
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# Trex Transcend®



# PREMIUM HIGH-PERFORMANCE DECKING & FASCIA

Trex Transcend<sup>®</sup> decking and Trex<sup>®</sup> Fascia are wood thermoplastic composite lumber (WTCL) boards with an integrated shell that covers the boards on the top surface and sides. The integrated shell consists of a proprietary surface formulation that produces a natural, wood-like grain pattern finish. An alternative to naturally durable hardwood lumber, Transcend Decking and Fascia are ICC-ES SAVE-certified to be a minimum of 95.4% recycled content by weight.



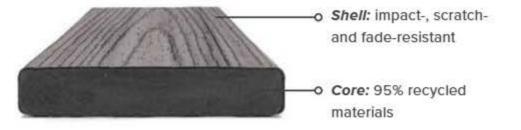



1" Grooved edge

	DECKING BOARDS		FASCIA BOARDS	
FEATURES	1" x 6"	2" x 6"	8"	12"
Actual Dimensions - Standard	.94" x 5.5"	1.3" x 5.5"	.56" x 7.25"	.56" x 11.375"
Actual Dimensions - Metric	24 mm x 140 mm	33 mm x 140 mm	14 mm x 184 mm	14 mm x 288 mm
Available Lengths - Standard	12', 16', 20'	12', 16', 20'	12'	12'
Available Lengths - Metric	365 cm, 487 cm, 609 cm	365 cm, 487 cm, 609 cm	365 cm	365 cm
Grooved Edge	x			
Square Edge	x	X	х	x
Transcend Lineage*	х		х	х
Transcend Tropicals	X	X	Х	X
Transcend Earth Tones	х		Х	x
Weight per Lineal Foot	2.4 lbs	3.6 lbs	2.0 lbs	3.3 lbs

\*Transcend® Lineage™ square edge profiles are not available in 12' lengths





#### **PHYSICAL & MECHANICAL PROPERTIES**

TEST	TEST METHOD	VALUE
Flame Spread	ASTM E 84	Class B
Thermal Expansion	ASTM D 1037	1.9 × 10⁻⁵ in/in/°F
Moisture Absorption	ASTM D 1037	< 1%
Screw Head Pull-Through	ASTM D1761	161 lbf/screw*
Fungus Resistance	ASTM D1413	Rating – no decay
Termite Resistance	AWPAE1-72	Rating = 9.6

\*Fastener used in testing: #8 x 2.5" approved Stainless Steel Screw

#### COLORS

Lineage (neutral multi-tonal)



#### Tropicals (vibrant multi-tonal)

Lava Rock



#### Earth Tones (monochromatic)



#### FASTENERS



#### Trex Hideaway® Hidden Fastening System

Self-gapping, glass-filled nylon fastener with 304 grade stainless steel, sharp point screw for wood framing.



Other approved fasteners include, color-matched composite deck screw, matching composite plug with composite screw, color-coordinated fascia screw and uncoated stainless steel fascia screw.

For a full list of approved fasteners, download our Installation Guide at trex.com/literature

**Trex**Transcend<sup>®</sup>



RAIL KITS



Rail & Square Composite Baluster Kit



Rail & Round Aluminum Baluster Kit



Cocktail Rail & Round Aluminum Baluster Kit

COMPONENT	RAIL & SQUARE COMPOSITE BALUSTER KIT	RAIL & ROUND ALUMINUM BALUSTER KIT	COCKTAIL RAIL & ROUND ALUMINUM BALUSTER KIT*
Top Rail	Crown	Crown	Universal
Bottom Rail	Universal	Universal	Universal
Heights	36" (914 mm) 42" (106 cm)	36" (914 mm) 42" (106 cm)	36" (914 mm)
Lengths	67.5" (171 cm) 91.5" (232 cm)	67.5" (171 cm) 91.5" (232 cm)	67.5" (171 cm) 91.5" (232 cm)
Applications	Horizontal, Stair	Horizontal, Stair	Horizontal, Stair
Colors	WT, BK, VL	WT, BK, VL (round aluminum balusters come in BK)	WT (round aluminum balusters come in BK)

\*A cocktail rail allows for a Trex Transcend® or Trex Select® deck board to be installed on top of a Universal top/bottom rail. All deck boards sold separately.



#### CODE REQUIREMENTS

Trex Transcend Railing meets both IRC and IBC designated requirements in accordance with ICC-ES AC174 and ASTM D7032. Refer to Code Compliance Report CCRR-0132 for specific details.

#### HARDWARE

#### **Mounting Hardware for Cut Rails**

The perfect solution for any installation that requires making two railing sections from one kit.

Includes 2 Crown top rail gaskets, 4 Universal top/bottom rail gaskets, 4 RSB rail brackets, 8 rail-to-bracket fasteners and 8 rail-to-post fasteners.





#### QUESTIONS?

Connect with our pro services team at 1-800-BUY-TREX or customercare@trex.com

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PAVERS

#### 

#### **HYDRA**

DESCRIPTION: Paver TEXTURE: Smooth

Pallet Overview

Specifications pe	r pallet	Imperial	Metric
	Product dimension $(L \times W \times H)$	11 <sup>13</sup> %6 × 7 % × 3 <sup>15</sup> %6	300×200×100
	Cubing	62 ft <sup>2</sup>	5.76 m <sup>2</sup>
96 units / pallet	Approx. Weight	2 811 lbs	1 275 kg
	Number of rows	8	
	Coverage per row	7.75 ft <sup>2</sup>	0.72 m <sup>2</sup>
	Lin. coverage per row	11.80 lin. ft	3.60 lin. m



Onyx Black Shale Grey

#### Laying Patterns Options

01 | Linear

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Patterns are for design inspiration only. The installer is responsible to calculate & purchase the correct amount of material.

#### NOTES

See page 6 for icons description.

See page 19 for more information about applications.

See page 20 and 97 for more technical information.

JOINT WIDTH: ½" (13 mm) % OF SURFACE OPENING: 8.3 % INFILTRATION RATE: 605 in./hr (15 345 mm/hr)

#### **CHARACTERISTICS**

- Clamp or Mechanical tool available for machine installation. Check with your local Techo-Bloc representative for more information.
- 6000 to 8000 sq. ft can be installed per day with mechanical installation and a team of 5 persons
- LEED<sup>®</sup> Projects.
- Reduces stormwater runoff to municipal sewers.
- Eliminates the need for retention basins and optimizes the use of land.



Pallet Overview

#### **VILLAGIO**

DESCRIPTION: Paver TEXTURE: Beveled

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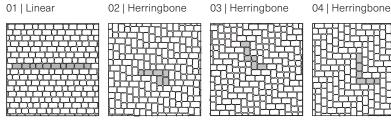
Specifications pe	r pallet	Imperial	Metric
A	Product dimension $(L \times W \times H)$	5 1% × 5 1% × 2 3%	130×130×60
	Product dimension (L×W×H)	$6 \frac{5}{16} \times 5 \frac{1}{8} \times 2 \frac{3}{8}$	160×130×60
77 units / pallet	Product dimension $(L \times W \times H)$	$7\; {}^{5}\!$	185×130×60
B	Product dimension (L×W×H)	$87_{16} \times 51_{8} \times 23_{8}$	215 × 130 × 60
1330	Cubing	117 ft <sup>2</sup>	10.88 m <sup>2</sup>
77 units / pallet	Approx. Weight	2 960 lbs	1 342 kg
	Number of rows	11	
UN THE	Coverage per row	10.64 ft <sup>2</sup>	0.99 m <sup>2</sup>
154 units / pallet	Lin. coverage per row	24.94 lin. ft	7.61 lin. m
D			

#### Laying Patterns Options

#### 02 | Herringbone

03 | Herringbone

04 | Herringbone



Patterns are for design inspiration only. The installer is responsible to calculate & purchase the correct amount of material.

#### NOTES

132 154 units / pallet

Beveled Merlot

Chocolate Brown Beveled

Chestnut Brown Beveled

Sandlewood Beveled

Champlain Grey Beveled

Shale Grey Beveled

Onyx Black Beveled

See page 6 for icons description.

See page 19 for more information about applications.

See page 56 to 58 for more technical information. When used in a permeable pavement application, see page 93 to 97 for more technical information.

JOINT WIDTH: 3/8" to 9/16" (9 to 15 mm) % OF SURFACE OPENING: 8.0 % INFILTRATION RATE: 896 in./hr (22 750 mm/hr)

The Villagio paver allows for gentle curves and winding pathways, eliminating the need for cuts.

91



400 SERIES

WOODWRIGHT® DOUBLE-HUNG FULL-FRAME WINDOWS

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Grille Patterns	63
Window Details	
Joining Details	65
Combination Designs	181
Product Performance	197



Dimensions in parentheses are in millimeters.



## WOODWRIGHT<sup>®</sup> DOUBLE-HUNG FULL-FRAME WINDOWS

#### FEATURES

#### FRAME

A Perma-Shield® exterior cladding protects the frame - beautifully. Best of all, it's low maintenance and never needs painting."

B For exceptional long-lasting performance, sill members are constructed with a wood core and a Fibrex® material exterior.

• Natural wood stops are available in pine, maple, oak and prefinished white. Wood jamb liners add beauty and authenticity to the window interior.

D A factory-applied rigid vinyl flange on the head, sill and sides of the outer frame helps secure the unit to the structure.

 Multiple weatherstrip systems help provide a barrier against wind, rain and dust. The combination of springtension vinyl, rigid vinyl and flexible bulb weatherstrip is efficient and effective.

For units with white exterior color, the exterior jamb liner is white. For all other units, the exterior jamb liner is gray.

#### SASH

**G** Balancers in the sash enable contractors to screw through the jamb during installation without interfering with the window's operation.


#### Wood Jamb Liner



(1) Natural wood sash interior with classic chamfer detailing. Available in pine, maple, oak or prefinished white.

O Low-maintenance sash exterior provides long-lasting protection and performance. Sash exteriors on most units include Fibrex material.

Sash joints simulate the look of traditional mortise-and-tenon construction inside and out.

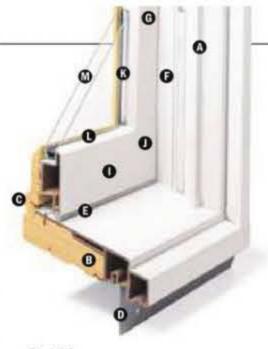

#### GLASS

In addition to stainless steel glass spacers, black or white glass spacers are now available to allow the spacer to blend in with the unit color.

Silicone bed glazing provides superior weathertightness and durability.

High-Performance options include:

- · Low-E4® alass
- Low-E4 HeatLock<sup>®</sup> glass
- Low-E4 SmartSun<sup>™</sup> glass
- Low-E4 SmartSun HeatLock glass Low-E4 Sun glass

Tempered and other glass options are available. Contact your Andersen supplier.

A removable translucent film helps shield the glass from damage during delivery and construction, and simplifies finishing at the job site.

#### **Patterned Glass**

Patterned glass options are available. See page 12 for more details.

#### HARDWARE



Standard lock and keeper design provides an easy tilt-to-clean feature integrated into the lock.

#### **EXTERIOR & INTERIOR OPTIONS**



#### HARDWARE



Antique Bross | Black | Bright Brass Brushed Chrome | Distressed Bronze Distressed Nickel | Gold Dust Oil Rubbed Bronze | Polished Chrome Satin Nickel | Stone | White

Standard Lock & Keeper

#### **OPTIONAL HARDWARE** Sold Separately



#### TRADITIONAL





Antique Brass | Black | Bright Brass | Brushed Chrome Distressed Bronze | Distressed Nickel | Gold Dust | Oil Rubbed Bronze Polished Chrome | Satin Nickel | Stone | White





Bold name denotes finish shown.

#### HARDWARE FINISHES



Printing limitations prevent exact replication of colors and finishes. See your Andersen supplier for actual color and finish samples.

\*Visit andersenwindows.com/warranty for details.

Dimensions in parentheses are in millimeters

Naturally occurring variations in grain, color and texture of wood make each window

one of a kind. All wood interiors are unfinished unless a finish is specified.

Distressed bronze and oil rubbed bronze are "living" finishes that will change with time and use.



# Storn WATCH

Performance Grade (PG) Upgrades

Performance upgrades are available for select sizes of standard, non-impact Woodwright® windows allowing these units to achieve higher performance ratings. Performance Grade (PG) ratings are more comprehensive than Design Pressure (DP) ratings for measuring product performance. For up-to-date performance information of individual products, visit andersenwindows.com. Use of this option will subtract 5/6" (16) from clear opening height. Contact your Andersen supplier for availability.

Visit andersenwindows.com/coastal for more information on Stormwatch<sup>®</sup> Protection.

#### SHAPES

Woodwright windows are available in the following shapes.



Double-Hung



Arch Double-Hung

#### SASH OPTIONS



Cottage

#### ACCESSORIES Sold Separately

#### FRAME

#### **Extension Jambs**



Standard jamb depth is 41/2" (114). Extension jambs are available in unfinished pine or prefinished white Some sizes may be veneered.

Factory-applied and non-applied interior extension jambs are available in 1/16" (1.5) increments between 5 1/4" (133) and 7 1/6" (181). Extension jambs can be factory applied to either three sides (stool and apron application) or four sides (picture frame casing).

#### **Pine Stool**



A clear pine stool is available and ready for finishing. The Woodwright stool is available in 4 1/16" (116) for use in wall depths up to 5 1/4" (133) and 6%16" (167) for use in wall depths up to 7 1/8" (181). Works with 2 1/4" (57) and 2 1/2" (64) casing widths. Shown above on a 400 Series tilt-wash double-hung window.

#### HARDWARE

#### Window Opening Control Device



A window opening control device is available, which limits sash travel to less than 4" (102) when the window is first opened. Available factory applied, or as a field-applied kit in stone or white.

#### STORM/INSECT SCREEN COMBINATION UNIT"



A self-storing storm window combined with an insect screen provides greater energy efficiency, while allowing ventilation when needed.

Constructed with an aluminum frame, single-pane upper and lower glass panels, and charcoal powder-coated aluminum screen mesh. Available in white, Sandtone and Terratone to match product exteriors. Canvas, dark bronze, forest green and black are available by special order.

Combination units can improve Sound Transmission Class (STC) and Outdoor Indoor Transmission Class (OITC) ratings. Ideal for projects near airports, busy roadways or other noisy environments. For example, adding a combination unit to a 400 Series tilt-wash double-hung (3862) unit with Low-E4® alass will improve its STC rating from 26 to 32. Contact your Andersen supplier for additional STC and OITC rating information.

#### INSECT SCREENS

#### Insect Screen Frames



Choose full insect screen or half insect screen. Half insect screen (shown above) allows ventilation without affecting the view through the upper sash. Frames are available in colors to match product exteriors.

#### TruScene® Insect Screens

Andersen TruScene insect screens let in over 25% more fresh air" and provide 50% areater clarity than conventional Andersen insect screens, all while keeping out unwanted small insects.

#### **Conventional Insect Screens**

Conventional insect screens have charcoal powder-coated aluminum screen mesh.

#### GRILLES

Grilles are available in a variety of configurations and widths. For doublehung grille patterns, see page 63.

#### EXTERIOR TRIM

Available with Andersen® exterior trim, See exterior trim section starting on page 175.

#### CAUTION:

- · Painting and staining may cause damage to rigid vinyl.
- · 400 Series windows in Terratone color may be painted any color lighter than Terratone color using quality oil-based or latex paint.
- · Do not point 400 Series windows with white, canvas, Sandtone, dark bronze, forest green or black exterior colors.
- Andersen does not warrant the adhesion or performance of homeowner-applied paint over vinyl or other factory-coated surfaces.
- For vinyl painting instructions and preparation. contact your Andersen supplier.
- Do not paint weatherstrip.
- · Creasate-based stains should not come in contact with Andersen products.
- · Abrasive cleaners or solutions containing corrosive solvents should not be used on Andersen products.

\*Shown on 400 Series tilt-wash double-hung windows.

Reverse Cottage


\*\* Do not add combination units to windows with Low-E4 Sun glass unless window glass is tempered. Combination units may also reduce the overall clear operable area of the window. See your local code official for egress requirements in your area.

†TruScene insect screens let in over 25% more fresh air than standard Andersen fiberglass insect screens. Dimensions in parentheses are in millimeters.


#### WOODWRIGHT® DOUBLE-HUNG FULL-FRAME WINDOWS

#### Woodwright\* Double-Hung Window Details

Scale 11/2" (38) = 1'-0" (305) - 1:8

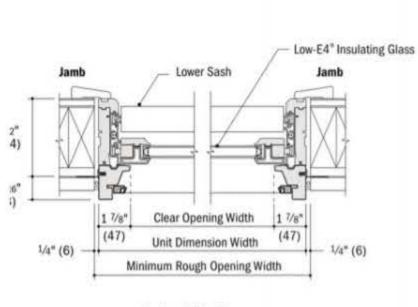




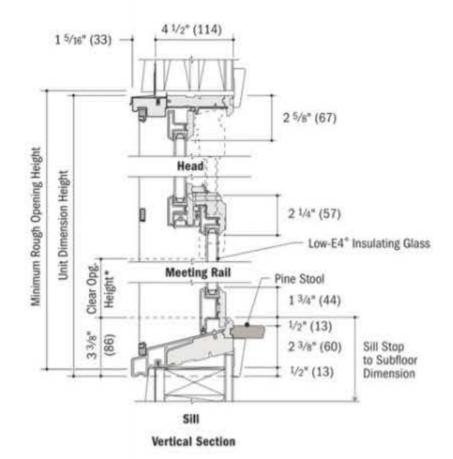


#### Woodwright<sup>®</sup> Picture Window Details

Scale 11/2" (38) = 1'-0" (305) - 1:8

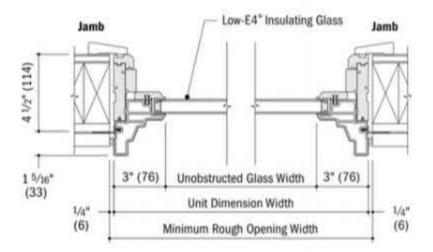

**Horizontal Section** 

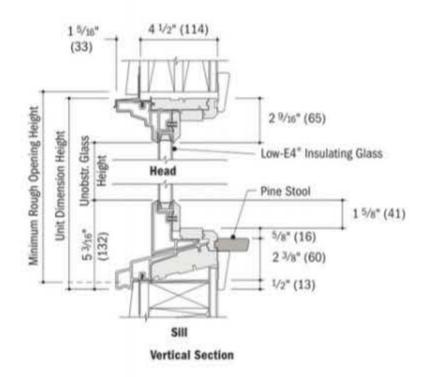

\* Light-colored areas are parts included with window. Dark-colored areas are additional Andersen" parts required to complete window assembly as shown.

• Minimum rough openings may need to be increased to allow for use of building wraps, flashing, sill panning, brackets, fasteners or other items. See installation information on pages 210-211. • Details are for illustration only and are not intended to represent product installation methods or materials. Refer to product installation guides at andersenwindows.com.

Dimensions in parentheses are in millimeters.

\*Clear opening height dimension is less on arch, unequal leg arch and Springline" hung windows.



#### 400 SERIES

#### Horizontal (stack) Joining Detail


Scale 11/2" (38) = 1'-0" (305) - 1:8


#### **Overall Window Dimension Height**

Sum of individual window heights plus 1/16" (1.5) for each join.

#### **Overall Rough Opening Height**

Overall window dimension height.\*

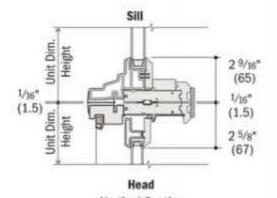

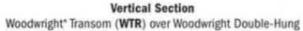

For more joining information, see the combination designs section starting on page 181.

#### Vertical (ribbon) Joining Detail


Scale 11/2" (38) = 1'-0" (305) - 1:8

#### **Overall Window Dimension Width**

Sum of individual window widths plus 1/16" (1.5) for each join.

#### **Overall Rough Opening Width**

Overall window dimension width plus 1/2" (13).

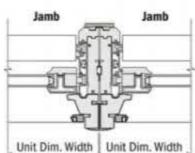

1/16" (1.5)


**Horizontal Section** 

Woodwright\* Double-Hung to Woodwright Double-Hung

#### Separate Rough Openings Detail

Scale 11/2" (38) = 1'-0" (305) - 1:8

To meet structural requirements or to achieve a wider joined appearance, windows may be installed into separate rough openings having vertical support (by others) in combination with Andersen\* exterior filler and exterior vinyl trim.

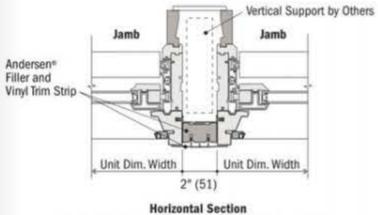

Woodwright\* Double-Hung and Woodwright Double-Hung

\* Light-colored areas are parts included with window. Dark-colored areas are additional Andersen" parts required to complete window assembly as shown.

• Minimum rough openings may need to be increased to allow for use of building wraps, flashing, sill panning, brackets, fasteners or other items. See installation information on pages 210-211.

Details are for illustration only and are not intended to represent product installation methods or materials. Refer to product installation guides at andersenwindows.com.
 Consult with an architect or structural engineer regarding minimum requirements for structural support members between adjacent rough openings.

Dimensions in parentheses are in millimeters.

\*For stacks where bottom unit in combination is a double-hung or picture window with a sloped sill. If bottom window has a flat sill, add 1/2" (13) to the overall window dimension height.



# **100 SERIES**

# A MODERN LOOK THAT'S EASY ON THE BUDGET

2024-25 PRODUCT GUIDE FOR PROFESSIONALS

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#### **100 SERIES WINDOWS**


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For warranty information, visit andersenwindows.com/warranty





Andersen Corporation, including its subsidiaries, has been named a 2023 ENERGY STAR® Partner of the Year – Sustained Excellence Award winner, the highest honor given by ENERGY STAR, for continued leadership in protecting the environment through superior energy efficiency achievements.

# AMERICA'S MOST LOVED BRAND

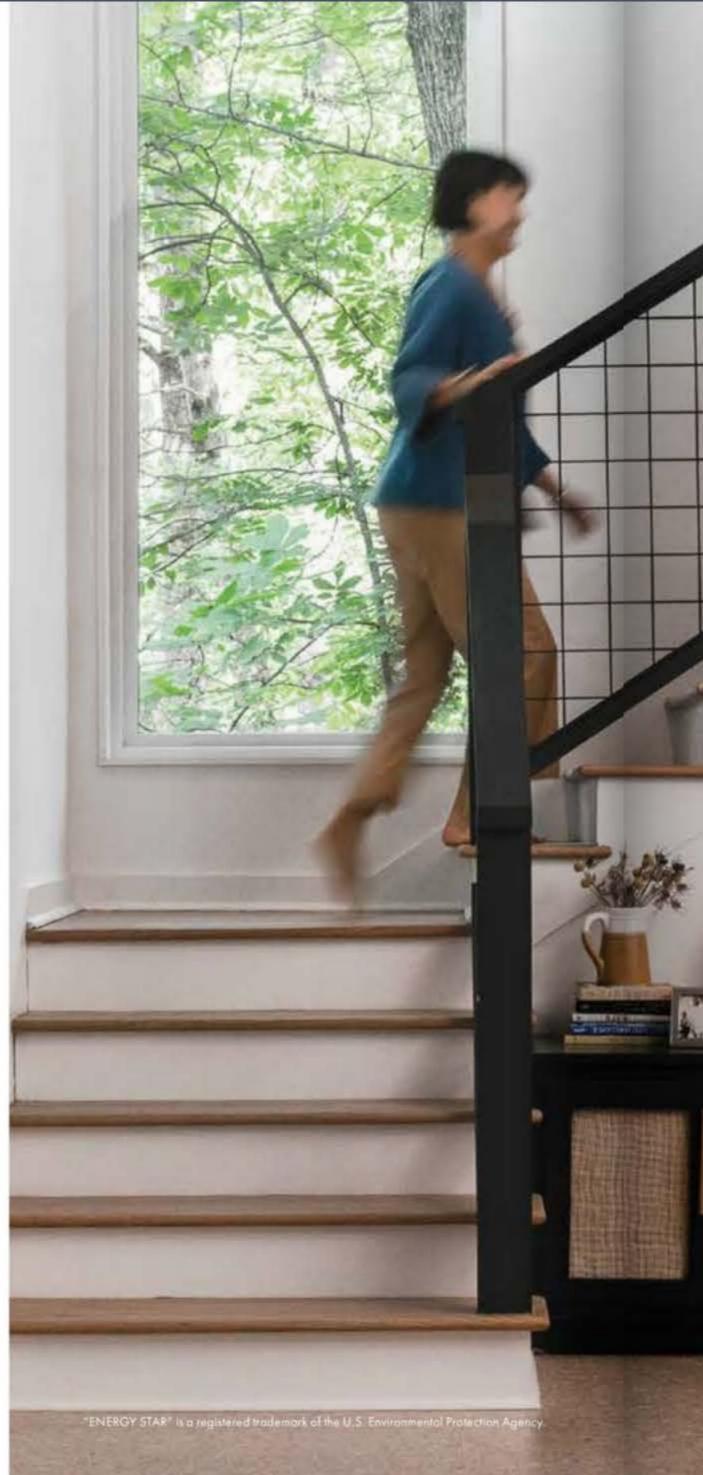You want to give your customers a home they love, and we're here to make that easy for you. That's why we're proud to offer you products that rate #1 in quality and performance;" and to be the #1 trusted and recommended window and door brand" by pros.

# **100 SERIES PRODUCTS**

The best way to give your customers a modern look that's within budget and lasts! The 100 Series product line is made from our proprietary Fibrex® material that's energy efficient, environmentally responsible and stronger than vinyl.

\*2022 Andersen brand surveys of U.S. realtors, contractors, builders and homeowners. \*\*2022 Andersen brand adriveys of U.S. contractors, builders, architects and homeowners. \*Visit andersenwindows, con / warrow? for details.

# PERFORMANCE

100 Series products simply perform like modern windows and doors should. They're made from our proprietary Fibrex® material, which is extremely low maintenance and blocks thermal transfer 700 times better than aluminum to help your customers save money on heating and cooling costs.

#### ATTRACTIVE CORNER SEAMS

Low-visibility corner seams for a cleaner and more modern look.

#### COLORS THAT LAST

Durable factory-finished interiors and exteriors never need painting and won't fade, flake, blister or peel," even in extreme cold or heat.

#### ATTRACTIVE MATTE INTERIORS

Premium matte finish isn't shiny like vinyl and is available in white, Sandtone, dark bronze and black."

#### ENERGY EFFICIENT IN EVERY CLIMATE

Energy-efficient 100 Series products are available with options that make them ENERGY STAR® v. 7.0 certified throughout the U.S. so they can help reduce heating and cooling bills.

#### Visit andersenwindows.com/energystar

for more information and to verify that the product with your glass option is certified in your area.





#### DESIGNED FOR PERFORMANCE

100 Series products are designed to meet or exceed performance requirements in all 50 states<sup>1</sup> See pages 112-113 for details.



#### EASY TO OPERATE FOR YEARS TO COME

All 100 Series products are tested to the extreme to deliver years' of smooth, reliable operation.

#### SUPERIOR WEATHER RESISTANCE

Our weather-resistant construction seals out drafts, wind and water so well that your reputation is protected whatever the weather.

#### QUALITY SO SOLID, THE WARRANTY IS TRANSFERABLE'

Many other window and door warranties end when a home is sold, but our coverage – 20 years on glass, 10 years on non-glass parts – transfers from each owner to the next. And because it's not prorated, the coverage offers full benefits year after year, owner after owner. So it can add real value when you decide to sell your home.



\*Visit <u>andersenwindows cont/warranty</u> for details, \*\*Products with Sandtone, dark bronze and black interlars have matching exteriors. †See your local code official for code requirements in your area. #100SH54066 PGUP +50/-50 (AAMA/WDMA/CSA 101/1.5.2/A440-08 & -11). Optional PG50 performance grade upgrade is available for most sizes. For more information, visit <u>andersenwindows.com/100strins</u>. \*ENERGY STAR\* is a registered trademark of the U.S. Environmental Protection Agency.

2

# DURABILITY

Think vinyl, only stronger. The proprietary Fibrex® material in our 100 Series products has all the benefits of vinyl while holding up better to weather and wear. This way your customers' windows and doors are better protected from warping and cracking, even in tough climates.



The finish on 100 Series products has superior scratch resistance compared to painted vinyl windows" so they'll look beautiful for years to come.




Fibrex material retains its stability and rigidity in all climates, delivering exceptional durability. It makes our 100 Series products rigid and strong so the weathertight seals stay weathertight.



100 Series products can withstand temperatures up to 150°F, even for dark colors, meaning they won't warp due to sun exposure.

\*Visit andersenwindows.com/warranty for details. \*\*When 100 Series products were tested against five leading competitors' painted vinyl window products.

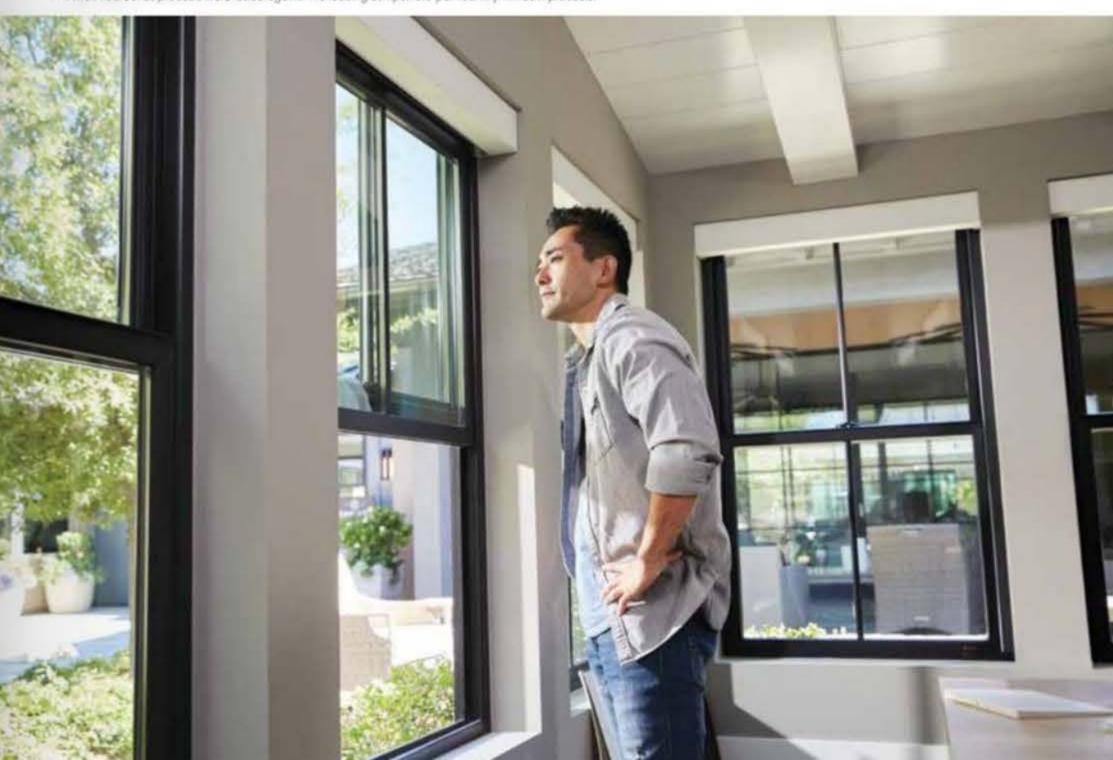

# **FIBREX® MATERIAL**

Developed by Andersen, Fibrex material is a revolutionary structural composite material that blends the very best attributes of vinyl and wood. Fibrex material saves on natural resources because it's composed of 40% reclaimed wood fiber by weight. Special polymer formulations surround and fill each wood fiber, enabling top performance. The result is a material that provides uncommon value and enhances the quality of any project. In use for over two decades in Andersen® products, Fibrex material has proven its strength and durability in all types of climates.

#### **REVOLUTIONARY BUILDING MATERIAL**

- · Twice as strong as vinyl so weathertight seals stay weathertight
- · Blocks thermal transfer nearly 700 times better than aluminum to help reduce heating and cooling bills
- · Retains its stability and rigidity in all climates for exceptional durability
- Offers superior scratch resistance compared to painted vinyl'

#### ENVIRONMENTALLY RESPONSIBLE

- Since Andersen developed the highly sustainable Fibrex material, reuse of waste wood fiber has prevented the harvesting of nearly 90 million board feet of timber
- 100 Series products can help builders earn LEED<sup>®</sup> points in three key categories: Energy & Atmosphere, Materials & Resources and Indoor Environmental Quality
- 100 Series products meet or exceed California Section 01350 Specification, a California indoor emission standard – one of the toughest in the country
- Like all Andersen products, 100 Series products are designed to last" and help reduce future waste streams








See how Andersen created Fibrex material at andersenwindows.com/fibrex.

#### **STABLE & PREDICTABLE**


Fibrex<sup>®</sup> material is twice as stiff as vinyl. This strength makes it a better choice over time. Stiffness

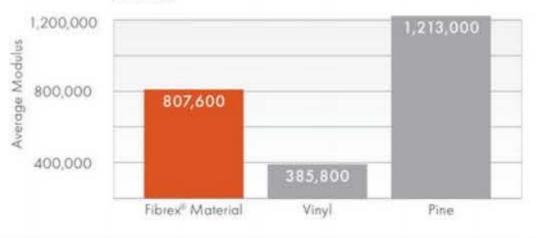

#### **DURABLE & RELIABLE**


All materials expand and contract when exposed to extreme temperatures. In these types of conditions, Fibrex material performs twice as well as vinyl, which can bow and crack over time.

#### Thermal Expansion

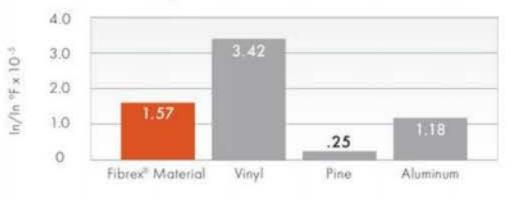

#### **EXCELLENT INSULATOR**


The built-in thermal qualities of Fibrex material mean that less heat and cold get transferred through the product into your customers' homes. As an insulator, it's on par with vinyl and far superior to aluminum.

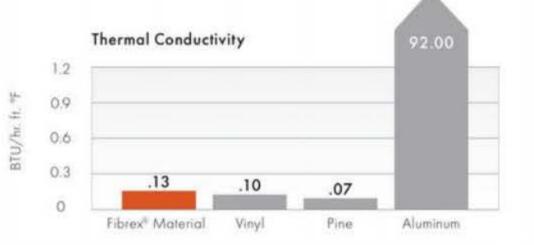

#### MOISTURE RESISTANT

Because Fibrex material combines wood fiber and a special polymer formula, water has a tough time penetrating. The result is an increased resistance to rot.



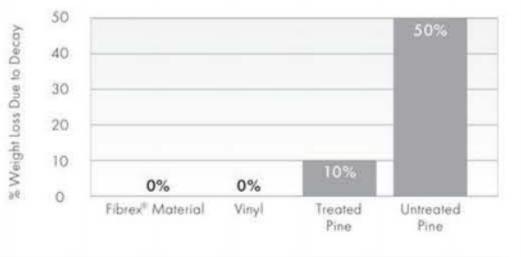

#### **HEAT RESISTANT**

Fibrex material can withstand temperatures in excess of 150°F, even for dark colors, making it a great fit for your projects in hot climates.

# WINDOW & DOOR TYPES

#### **CASEMENT & AWNING WINDOWS**

Casement windows are hinged on the side and open outward to the left or right, while awning windows are hinged at the top and open outward. Both are also available as non-operating stationary windows.








Picture With Flanking Cosements


#### SINGLE-HUNG WINDOWS

Single-hung windows feature a fixed upper sash with an operable lower sash that slides up and down. For convenience, the hardware locks automatically when the window is closed. An arch single-hung is also available to add architectural interest.



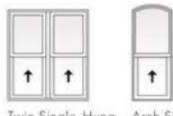



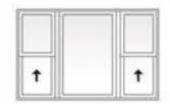

Picture With Flanking Single-Hungs


#### **GLIDING WINDOWS**

Gliding windows have one stationary sash and one operating sash that glides horizontally. A three-sash configuration, where two sash glide past a fixed center sash, is also available.




+	+



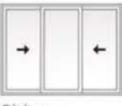

Gliding Active-Stationary-Active, 1:1:1 Sash Ratio

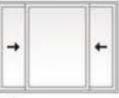

Gliding Active-Stationary-Active, 1:2:1 Sash Ratio



#### PICTURE, TRANSOM & SPECIALTY WINDOWS

Choose from a variety of shapes to make a signature statement or provide a delicate lighting accent. Shapes include picture, transom, half circle, quarter circle, circle, Springline™ and arch windows. Custom shapes are also available, including unequal leg arch, trapezoid, pentagon, octagon and triangle windows.



#### **GLIDING PATIO DOORS**

Patio doors feature one stationary panel and one operating panel that glides smoothly on adjustable rollers. They feature a multi-point locking system for enhanced security and an optional exterior keyed lock for convenience. Sidelights and transoms are also available.






# WINDOW FRAME OPTIONS

You'll find a 100 Series window to match any project from commercial to residential, no matter the location. And with uniform sight lines, it's easy to specify 100 Series products for the entire project. Additionally, 100 Series window frame options offer the flexibility needed to complete everything from new construction to home improvement, and they're available in ½" (3) increments when custom sizing is required.


- 3 1/4" (79) uniform sight lines allow for easy specification
- An extension jamb attachment flange is available for easy application of extension jambs on the job site
- Single-hung drywall pass-through windows have an upper sash that can be easily removed on the job site after the window is installed." With both sash removed, drywall can easily fit through upper-floor windows.

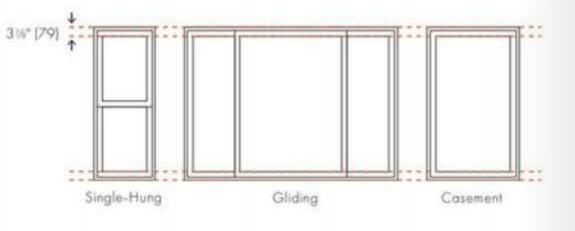

#### NEW CONSTRUCTION WINDOW FRAME OPTIONS

#### 13/8" (35) Flange Setback

- Designed for new construction
- Integral installation flange makes installation into a new opening easy and helps make sure the windows and doors are weathertight

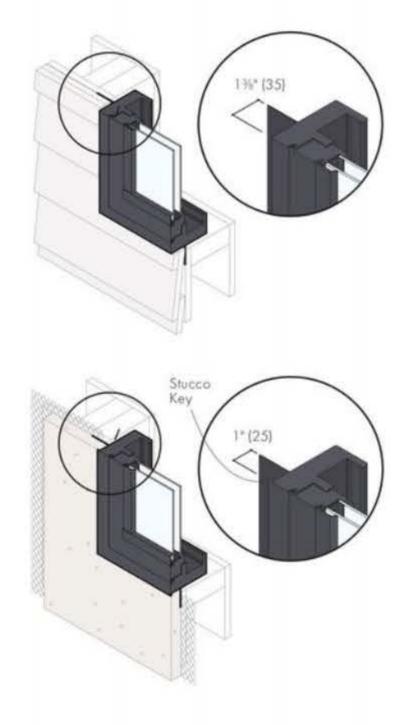


#### 1" (25) Flange Setback With Stucco Key

- · For new construction with stucco exteriors
- Stucco key eliminates gaps that can result from the natural contraction of the exterior stucco
- Integral installation flange makes installation into a new opening easy and helps make sure the windows and doors are weathertight

#### **REPLACEMENT WINDOW FRAME OPTIONS**

#### No Flange Frame

- Allows for full removal of an existing window when the existing frame is rotten or damaged
- Installed into the existing rough opening
- Includes pre-drilled, through-the-jamb installation holes and installation screws to save you time

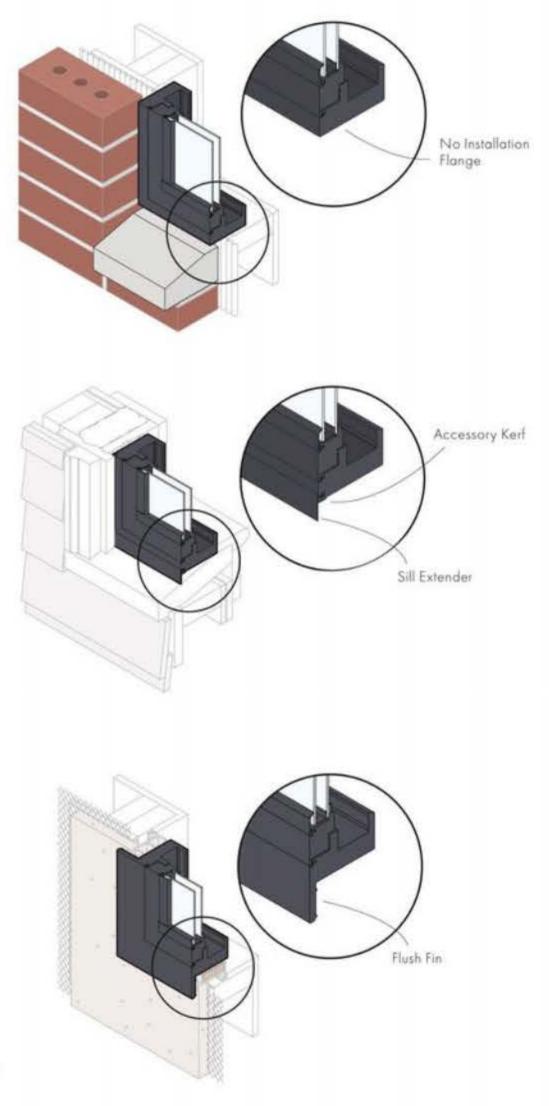

#### **Insert Frame**

- Provides fast and easy window replacement when installing into an existing window frame
- Saves time and money with minimal disruption to the interior or exterior trim
- Exterior accessory kerf for convenient finishing of the window
- Installation accessories include an exterior sill extender to fill the gap at the sill (shown) in addition to exterior frame extender for sides and a head expander

# Flush Fin Frame NEW

- Allows for easy replacement in stucco applications when
   installing over an existing aluminum window frame
- · Minimizes disruption to the home's stucco exterior
- Flush fin has grooves at ½" (13) and 1" (25) for easy trimming.
- Flat and curved interior trim is available to cover the existing window frame
- Available in select Southwestern states including Arizona, California, Nevada, New Mexico and Utah. Limited configuration availability. See your Andersen supplier for more information.

# **EXTERIORS & INTERIORS**

100 Series windows and patio doors come in five exterior colors, including dark bronze and black - colors that are darker and richer than those of most vinyl windows. The interiors feature a premium matte finish for an attractive appearance.

#### EXTERIOR COLORS



#### INTERIOR COLORS



\*Products with Sandtone, dark bronze and black interiors have matching exteriors. Printing limitations prevent exact duplication of colors. See your Andersen supplier for actual color samples.



# HARDWARE

#### **Casement & Awning Windows**



Sandtone | Satin Nickel | White

Folding handles avoid interference with window treatments.

#### Single-Hung & Gliding Windows



Optional Lift/Pull

Hardware color matches the window's interior. Shown in white, Lock automatically engages when window is closed.



Optional Metal Slim Line Lock

Antique Brass | Black | Dark Bronze Sandtone | Satin Nickel | White

Lock automatically engages when window is closed.

#### WINDOW HARDWARE FINISHES



White



Sotin Nickel

Bald name denotes color or linish shown.



#### **Gliding Patio Doors**



#### TULSA

Standard Handle

Exterior handle color matches the door's exterior. Interior handle color matches the door's interior. Exterior handle shown in dark bronze. Interior handle shown in white.

Optional auxiliary foot lock is available. See page 100.

#### **TULSA HARDWARE FINISHES**



Dark Bronze Sandtone

Terratone

White





Antique Brass Black Bright Brass Satin Nickel

Optional auxiliary foot lock is available. See page 100/ Bold name denotes color or finish shown.

#### AFTON HARDWARE FINISHES



Antique. Brass

Black Bright Brass Satin Nickel

\*Available for exterior handle only. Printing limitation prevent exact replication of colors and finishes.

See your Andersen supplier for actual color and finish samples.

# 100 SERIES UNIQUELY ANDERSEN, INCREDIBLY STRONG

Docusign Envelope ID: 835E5593-4C4E-4F63-8135-79D94EAD7CC1

# GLASS

Andersen has the glass you need to get the performance you want, with options for every climate, project and customer. Check with your supplier for the selections that meet ENERGY STAR® requirements in your area.

			ENERGY										LIGHT							
GLASS		U-Factor How well a ploduct prevents heat from escoping.			Solar Heat Gain Coefficient How well a product blocks heat caused by swilight.				Visible Light Transmittance How muck visible light comes through a product.				UV Protection How well a product blocks ultraviolet rays							
SmartSun"	Thermal control similar to tinted glass, with visible light transmittance similar to Low-E glass				0							0	0		0		•			
SmartSun with HeatLock® Coating	Applied to the room-side surface, it reflects heat back into the home and improves U-Factor values.			0	0				•		0	0	0		0	0	•			
Low-E	Outstanding overall performance for climates where both heating and cooling costs are a concern.				0	•	•	•	0			0	ò	•			0			
Low-E with HeatLock Coating	Applied to the room-side surface, it reflects heat back into the home and improves U-Factor values.		0	0	Ø				0		0	0	0				0			
Sun	Outstanding thermal control in southern climates where less solar heat gain is desired.				0				•		0	0	0				0			
PassiveSun®	ldeal for northern, passive solar construction applications where solar heat gain is desired.	•			0	•	0	0	0		0		0			0	0			
PassiveSun with HeatLock Coating	Applied to the room-side surface, it inflects heat back into the home and improves U-Factor values.				0	•	0	Ø	0	0		0	Ð			0	0			
Clear Dual-Pane	High visibility, with basic thermal performance.		Ð	0	0	0	0	0	0	0	0	0		0	0	0	0			
the second se																				

Center of glass performance only. Ratings based on glass options as of August 2023. Visit and essenwindows.com/energystar for ENERGY STAR map and NERC total unit performance data.

#### HEATLOCK TECHNOLOGY

Applied to the room-side glass surface, HeatLock coating reflects heat back into the home for improved performance.

#### **TIME-SAVING FILM**


We protect our products during delivery and construction with translucent film on the glass that peels away for a virtually spotless window.

For more details on our glass options, visit andersenwindows.com/glass.



#### ADDITIONAL GLASS OPTIONS

Tempered safety glass is standard on patio doors and required for larger window sizes. Patterned glass lets in light while obscuring vision and adds a unique, decorative touch.

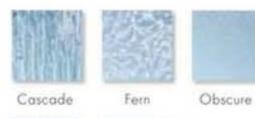




Reed Satin Etch

Cascade and Reed patterns are only available in a vertical orientation.

#### **GLASS SPACER OPTIONS**

In addition to stainless steel glass spacers, black glass spacers are available as another way to customize project designs and achieve a contemporary style. Black glass spacers can blend in with the color of the window or door for a sleek design or serve as a shadow line.

Add full divided light grilles and the grille spacer bar between the glass will match.

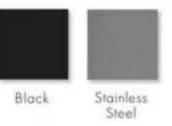

# GRILLES

Grilles for 100 Series windows and patio doors are available in a wide variety of patterns to complement virtually any style of home. Plus, they have options for easy cleaning and architectural authenticity many vinyl windows can't match.



Finelight grillesbetween-the-glass



#### FINELIGHT" GRILLES-BETWEEN-THE-GLASS

Make glass easy to clean and have an elegant, sculpted profile. Choose a two-sided color scheme to match both the interior and exterior of the window or patio door. Also available with exterior grilles to provide architectural style and detail.

Grille Patterns



#### FULL DIVIDED LIGHT


Permanently applied to the exterior and interior of the window, with a spacer between the glass.



Permanent exterior and permanent interior without spacer

#### SIMULATED DIVIDED LIGHT

Permanently applied to the exterior and interior of the window, without a spacer between the glass.

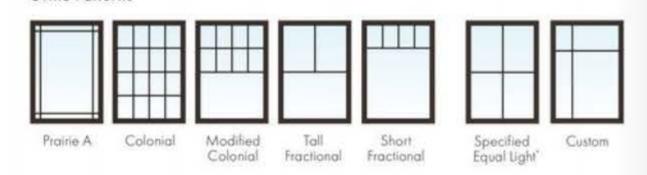

To see all of the standard patterns available for a specific window or door, refer to the detailed product sections in this product guide or contact your Andersen supplier.

Grille Bar Widths Actual width shown.

19 width grille bar for windows.



1" (25) width grille bar for patio doors.

A 2 ¼" (57) width grille is available for most units to simulate a meeting rail or a multi-unit combination such as a transom over a window or patio door.

# **INSECT SCREENS**



Insect screens for venting windows have a fiberglass screen mesh. Optional TruScene® insect screens are made with a micro-fine stainless steel mesh, providing more than 50% greater clarity than our conventional insect screens. Insect screen frames for casement and awning windows are color matched to the product interior and for single-hung and gliding windows are matched to the product exterior.



Gliding insect screens for two-panel gliding patio doors have a fiberglass screen mesh. Insect screen frames for doors are color matched to the product exterior.

\*Specify number of same-size rectangles across or down. Dimensions in parentheses are in millimeters.

# BUILDERS AGREE WINDOWS MADE OF ANDERSEN'S FIBREX® COMPOSITE MATERIAL OUTPERFORM VINYL WINDOWS'

THE REAL PROPERTY AND A DESCRIPTION OF A

NATE AND ADDRESS OF TAXABLE PARTY.

#### FEATURES

#### HINGED PATIO DOORS

#### FRAME & PANEL

Select wood components are kiln dried and treated with water/insect repellent and preservative. Interior wood surfaces are available in pine, mixed grain Douglas fir, cherry, hickory, mahogany, maple, oak, walnut, alder or vertical grain Douglas fir, Interior surfaces are available unfinished or factory primed. Optional factoryapplied finishes are available in a variety of stains and paints.

Wood components are fitted with aluminum extrusions on the exterior. 50 exterior colors that meet AAMA 2604 and 2605 specifications are available, as well as custom colors. Also available is a selection of seven exterior anodized options.

**O** The frame perimeter consists of a high-quality foam-filled weatherstrip.

Inswing and outswing doors receive a factory-applied vinyl installation flange with drip cap. Some inswing patio doors require an adjustable metal installation flange. Optional aluminum flanges and metal installation clips are available.


#### SILL

#### **Drainage Sill for Inswing Patio Doors**

Premium grade aluminum inswing sill with an oak threshold. Sills have a built-in drainage channel that allows water to drain away from the interior of the door. A top plate is removable for easy channel cleaning. A polyurethane thermal barrier helps reduce heat loss. Available in clear anodized or dark bronze anodized finish, shown below.






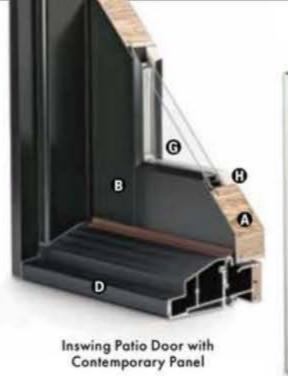

#### **On-Floor Sill for Outswing Patio Doors**


Premium grade aluminum outswing sill with oak threshold. Outswing door sill is backed with a compression foam weatherstrip. Available in clear anodized or dark bronze anodized finish, shown below.

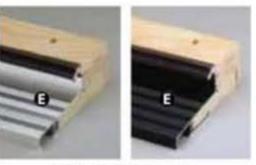


On-floor sills for outswing

#### Low-Threshold Sill

Aluminum low threshold sill available for outswing doors and inswing doors. Available for inswing doors with jamb depths of 4 %6° and 6 %16°. Low threshold design provides a smooth transition fram interior to exterior and is wheelchair-accessible. A polyurethane thermal barrier helps reduce heat loss. Available in dark bronze anodized finish, shown below.

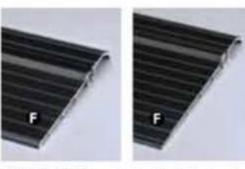

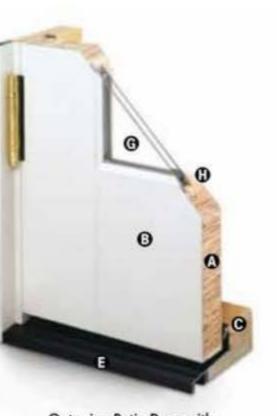

Outswing Patio Door with French Panel

#### GLASS

G High-Performance Low-E4<sup>III</sup> glass with a low-conductivity spacer. Triple-pane glass, tinted, clear dualpane, high-altitude glass and other special glazing options are available.

Glass is fixed in place from the interior with wood stops that can be removed for easy reglazing if necessary. Glass stops available in ovolo (colonial) and contemporary profiles.

GLASS SPACERS available in black, white and stainless steel.

#### HARDWARE

#### Multi-Point Locking System

Autolatch® stainless steel multi-point lacking system lacks the panel in three locations to provide a secure, weather-resistant entry system. Some door heights lock the panel in four locations.

Hinges



Heavy-duty commercial grade hinges are available in finishes of antique brass, black, bright brass, and character pewter, gold dott oil rubbed branze, bright character stainless steel, and white to go with your handle set. Hinges are complete with matching screws. An innovative hinge shimming system allows for minor adjustments.

Satin Chrome, Gold Dust and Bright Chrome DISCONTINUED



Drainage sills for inswing

4 %16" & 6 %16" Low-threshold sills for inswing



4%16" Low-threshold sill for outswing

\*Actual wood species is either Sapele or Sipo, both non-endangered species grown in Africa, with color and characteristics similar to Central American mahaganies.

NDOWS &

#### ACCESSORIES Sold Separately

#### HINGED PATIO DOORS

#### HARDWARE

#### **Construction Handle**



Temporary construction handle is sent with all hinged patio doors. This handle allows operation during the construction phase, protecting finished hardware from damage or jobsite theft.

#### **Hardware Options**

Additional hardware options such as exterior keyed locks and more are also available. Contact your Andersen supplier.

#### SENSORS

#### Yale® Assure Lock®

Monitor, lock and unlock from anywhere with the Yale Assure Lock. The sleek keyless lock includes Bluetooth® technology for key-free unlocking and is compatible with Z-Wave® for integration with a wide range of smart home platforms. Available on select hinged doors, see your Andersen supplier for details.

#### VeriLock & Open/Closed Sensors DISCONTINUED

detect whether the doors are locked or unlocked" — a teature no other sensors can pravide. Available in all hardware linteles.

#### Open/Closed Sensors

Winless open/clased sensors are available in faur colors.

See page 27 for Smart Home options.

#### INSECT SCREENS

Retractable Insect Screens



Concealed, retractable insect screen has charcoal fiberglass screen mesh. Available for inswing single or double door units. Insect screen rolls out when needed and retracts into concealed housing when not in use. Available in 50 exterior colors.

Retractable insect screens for outswing doors are field applied to the interior of the door. Available in five colors including white, almond, desert sand, bronze and black.

#### Hinged Insect Screens for Inswing Patio Doors

Charcoal fiberglass screen mesh fits into an aluminum frame in 50 exterior colors. Provided with a black lockable latch and automatic closer for smooth operation. Available in single or multiple door units. Aluminum screen mesh is also available.

#### Top-Hung Gliding Insect Screens for Inswing Center Post Patio Doors

Charcoal fiberglass screen mesh fits into an aluminum frame available in 50 exterior colors. Aluminum screen mesh is also available.

#### PRIVACY OPTIONS

#### Blinds-Between-the-Glass




A %\* aluminum slat blind mounted between two panes of insulated glass in a dust-free environment. Available in white, tan and almond. Blinds are magnetically controlled and can be tilted or raised and lowered with one cord." Not available on arch patio doors.

#### GRILLES

#### Full Divided Light

11%

Permanent interior and exterior grilles with grille spacer bars between two panes of glass. Available in %\*, %\*, 1 %\*, 1 ½\*, or 2 ¼\* widths and avala or contemporary profile. Ovala profile shown below, not all widths are pictured.

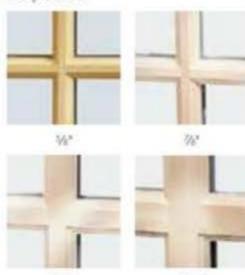

#### 115\*

#### Simulated Divided Light

Permanent exterior and interior grilles without grille spacer bars. Available in %s, %s, 1 %s, 1 %s, and ovelo or contemporary profile. Ovelo profile shown below, not all widths are pictured.



#### Finelight" Grilles-Between-the-Glass

Available in <sup>5</sup>/e" flat or 1" contoured aluminum profiles. Two-tone colors of pebble tan/colony white, sierra bronze/colony white or forest green/colony white are available on the 1" profile.



W/ Flat

#### I\* Contoured

#### **Removable Interior Wood Grilles**

Removable interior wood grilles are available in a 7%" width and avalo or contemporary profiles. Optional surround for removable grille and permanent exterior grilles also available. Ovolo profile shown below.



See page 22 for more information

E-Series Hinged Patio Doors


on grilles.

\*When properly configured and maintained with a professionally installed security system and/or self-monitoring system compatible with Honeywell® 5800 controls. See your Andersen supplier for more information.


\*\*Not all sizes are retractable. See your local Andersen supplier for details.

#### **Hinged Outswing Patio Doors**


#### **Hinged Outswing Patio Door**

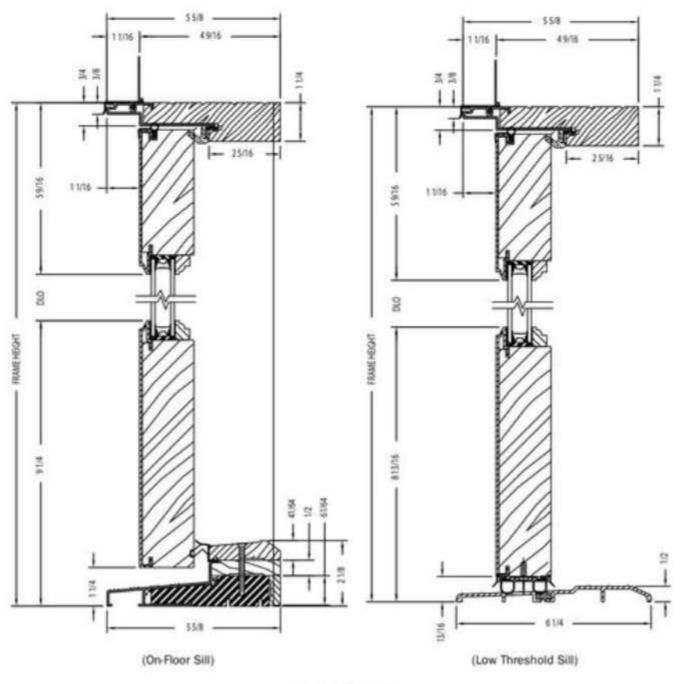


Vertical Section

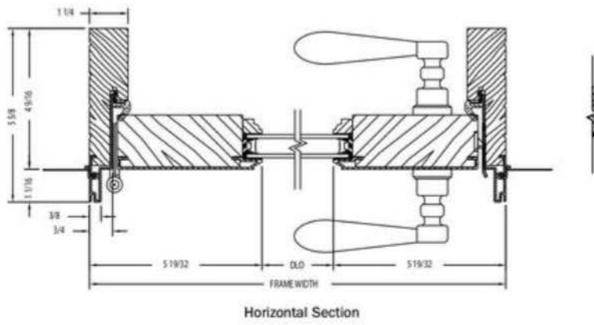


Astragal

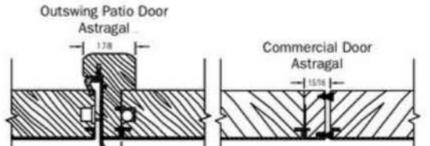

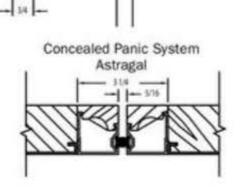

Shown with ovolo (colonial) glass stops. French panel shown, also available with a contemporary panel.

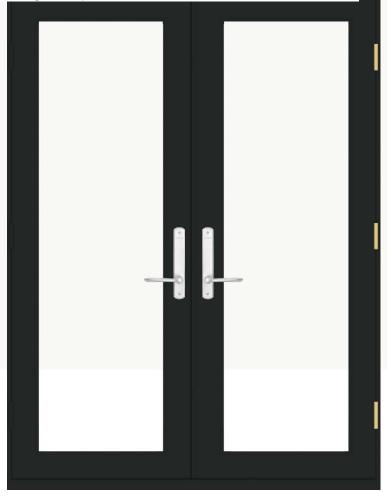

INTERIOR





February 18, 2025

708 Pallister St., Detroit, MI 48202


RE: 708 Pallister Exterior Renovations


#### Scope of Work


- 1. Demolish (2) new construction dormer roofs (east and west dormers)
- 2. Rebuild (2) dormer roofs as hipped roofs with wide eaves (depth to match existing)
  - a. Eaves to be sloped to match existing dormer
  - b. Eaves and fascia to be wood, painted (to match existing)
- (2) installed sliding windows in new dormers to be replaced with 8-lite, simulated divided lite fibrex windows casement units, painted black (Anderson 100 series) (style to match existing dormer)
- 4. Install 8-lite, simulated divided lite fibrex window casement unit (Anderson 100 series) (style to match existing dormer) in east side dormer; paint window black
  - a. Drywall interior face of window
- 5. Remove composite shake siding from all dormers
- 6. Install wood shake siding and trim at all dormers; paint HDC approved color C:4 "Yellowish White" with Black trim
- 7. At new east elevation forward ground floor window, remove installed inset trim; replace with wood trim atop/pronounced from siding, to match existing window trim; trim size (WxD) to match existing
  - a. At new east elevation forward ground floor window, remove 'belt band' wood trim above window as required (where window extends into band), replace with continuous trim piece to match previously existing style; paint black
- Replace east elevation second floor sliding window with 6-lite, simulated divided lite aluminum-clad wood awning window unit, painted black (Anderson 400 series); lite style to match previously existing window
- 9. At east elevation, remove and reset (2) basement glass block windows
  - a. Glass block to be set in same plane as previously existing basement windows
  - b. Install window screen over each window, to match previously existing




- 10. Replace rear elevation ground floor sliding window with 12-lite, simulated divided lite aluminum-clad wood single-hung window unit, painted black (Anderson 400 series) (to match previously existing window)
- Replace installed french door at rear elevation with aluminum-clad wood french door with 2/1 simulated divided lite pattern, painted black (to match previously existing windows at same location) (Anderson E series)
- 12. Install 3rd wood column at front porch, paint to match others already installed
- 13. Install 36" wood railing at front porch
- 14. Install "Trex Transcend Series" composite deck boards and 36" railing at rear deck
- 15. Install simulated divided lites into newly installed windows, lite style to match previously existing windows (see architectural drawings)
- 16. HVAC unit installed at west elevation: intended to remain
- 17. Brick veneer installed at front porch, painted to match existing: intended to remain

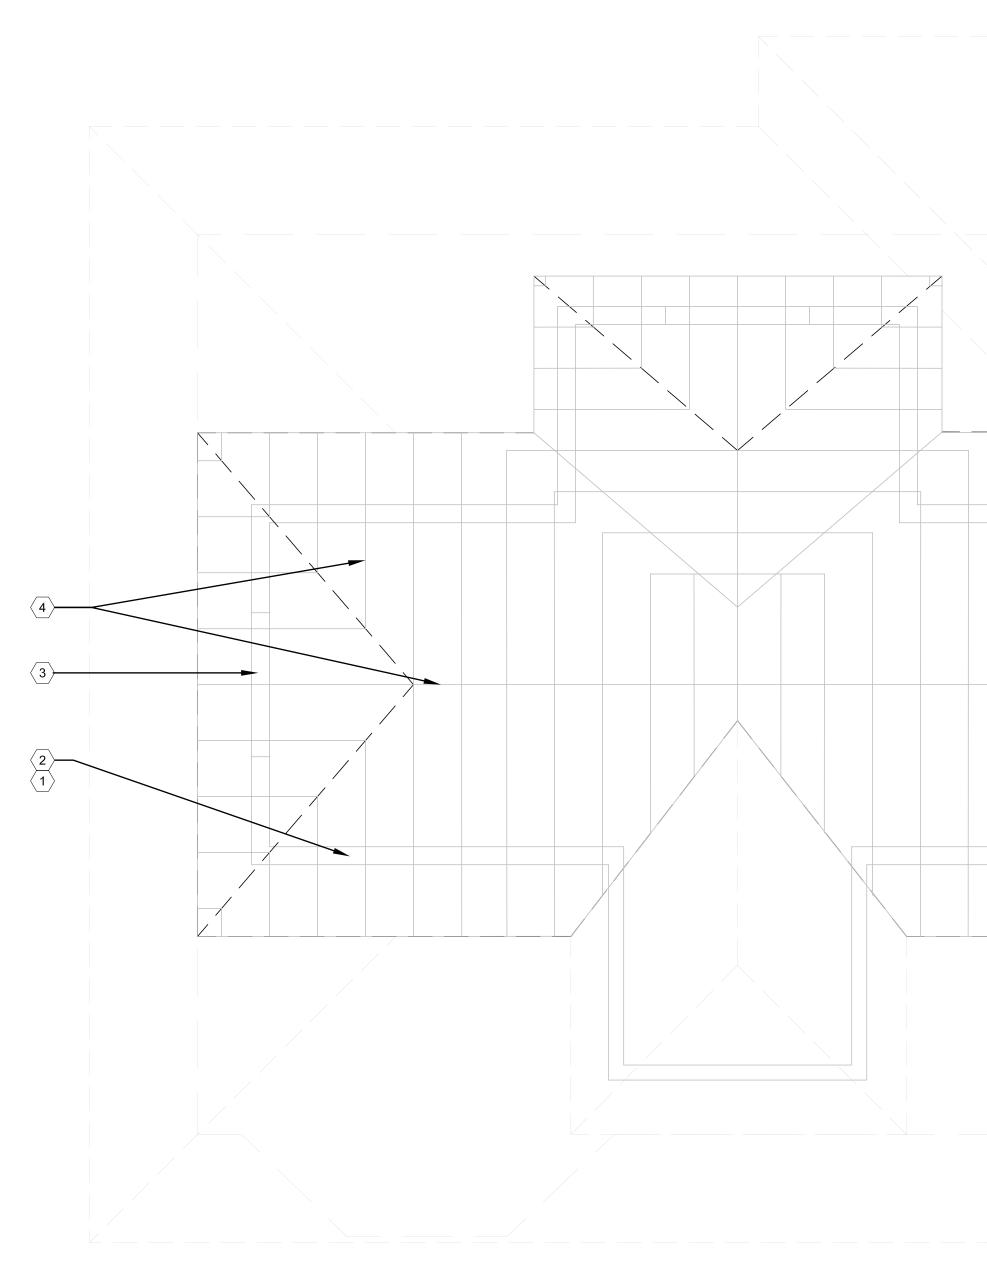

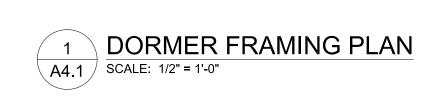

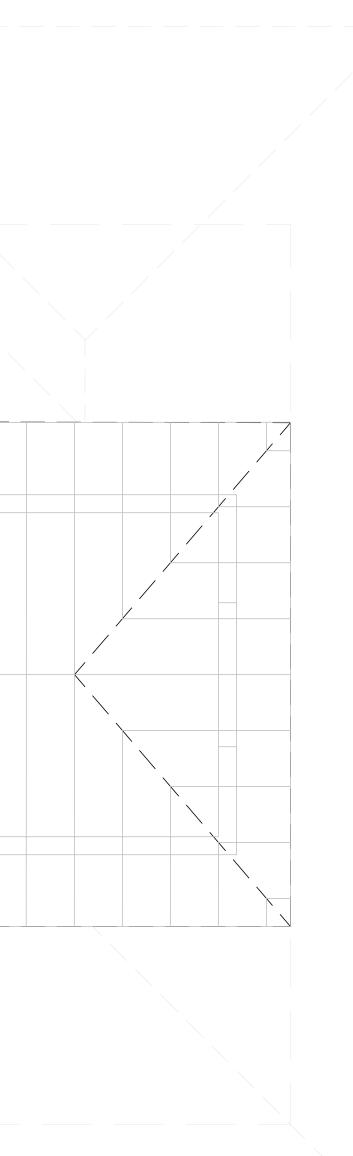

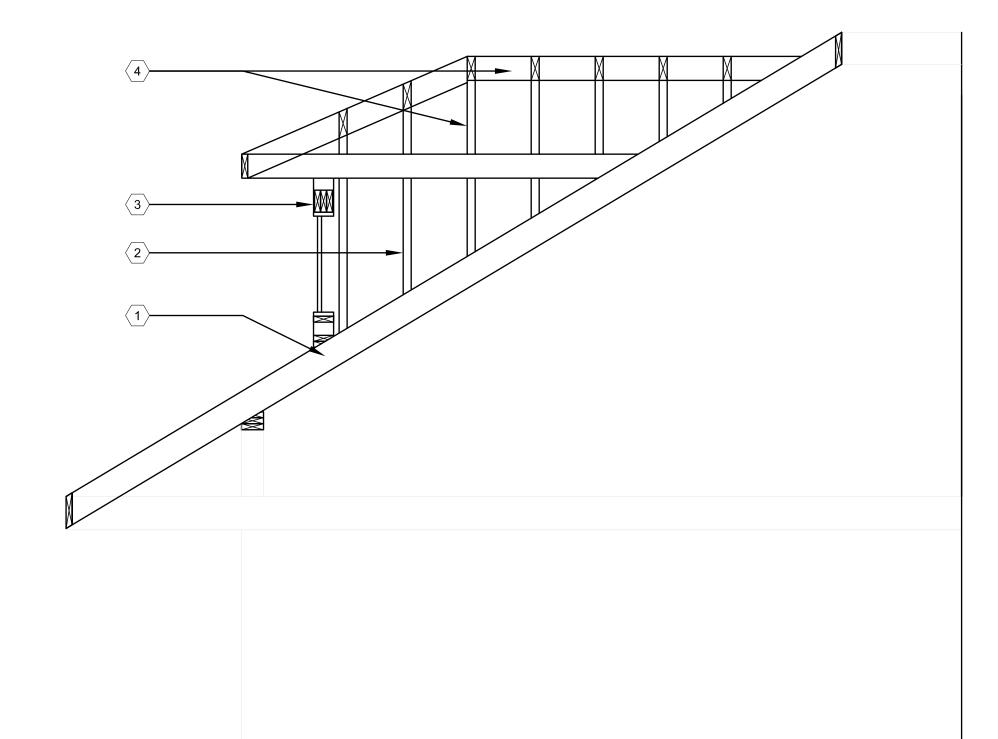

2 A4.1 DORMER FRAMING SECTION SCALE: 1/2" = 1'-0"

# ARCHITECT: 4545 architecture 2761 E. JEFFERSON AVE STE 302 DETROIT, MI 48207 P. 313.454.4545 TIM.FLINTOFF@4545ARCHITECTURE.COM CONSULTANT: Project : 708 PALLISTER HDC RENOVATION Issued for : HDC SUBMIT 02/18/2025 TIMOTHY R. FLINTOFF JR. ARCHITECT No. 1301064083 Drawn by : **ANJ** Check by : TRF Sheet Title : DORMER FRAMING DETAILS Project No. : 2024001 Sheet No. : A4.

## PLAN KEY NOTES:


- (TYPICAL THIS SHEET ONLY)
- $\left< 1 \right>$  SISTER SIMILAR 2x
- $\left< 2 \right> 2x6$  wood stud wall
- $\langle 3 \rangle$  2x6 DOUBLE HEADER
- $\overline{4}$  2x6 RIDGE BEAM AND RAFTERS

#### Glass Block


The Detroit Historic District Commission ("Commission") realizes that safety and energy concerns results in the desire to install glass block in basement window openings. While this treatment is not recommended, it may be acceptable provided certain conditions are met.

The installation of glass block in historic districts is work that is regulated by the City of Detroit's Historic District Ordinance No. 161-H. Any proposal for the installation of glass block in a historic district shall meet the following applicable conditions:

- A. The glass block shall be located at the same plane as the existing historic window, set back from the face of the building wall.
- B. The glass block shall be covered with the historic screen placed back in the window or with a new screen.
- C. Glass block will only be permitted in basement window openings.
- D. Openings with glass block that are on the front or visible from a side street shall be screened with foundation plantings that cover the windows.
- E. All glass block installations require a permit and Commission approval
- F. See the drawing below for more information.

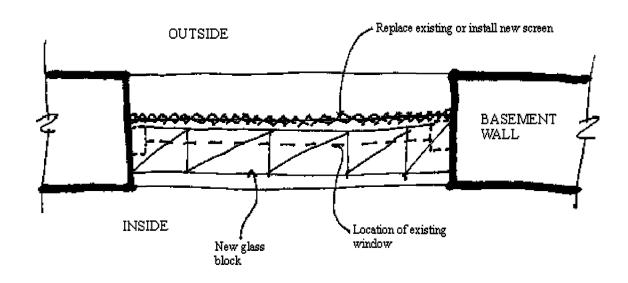



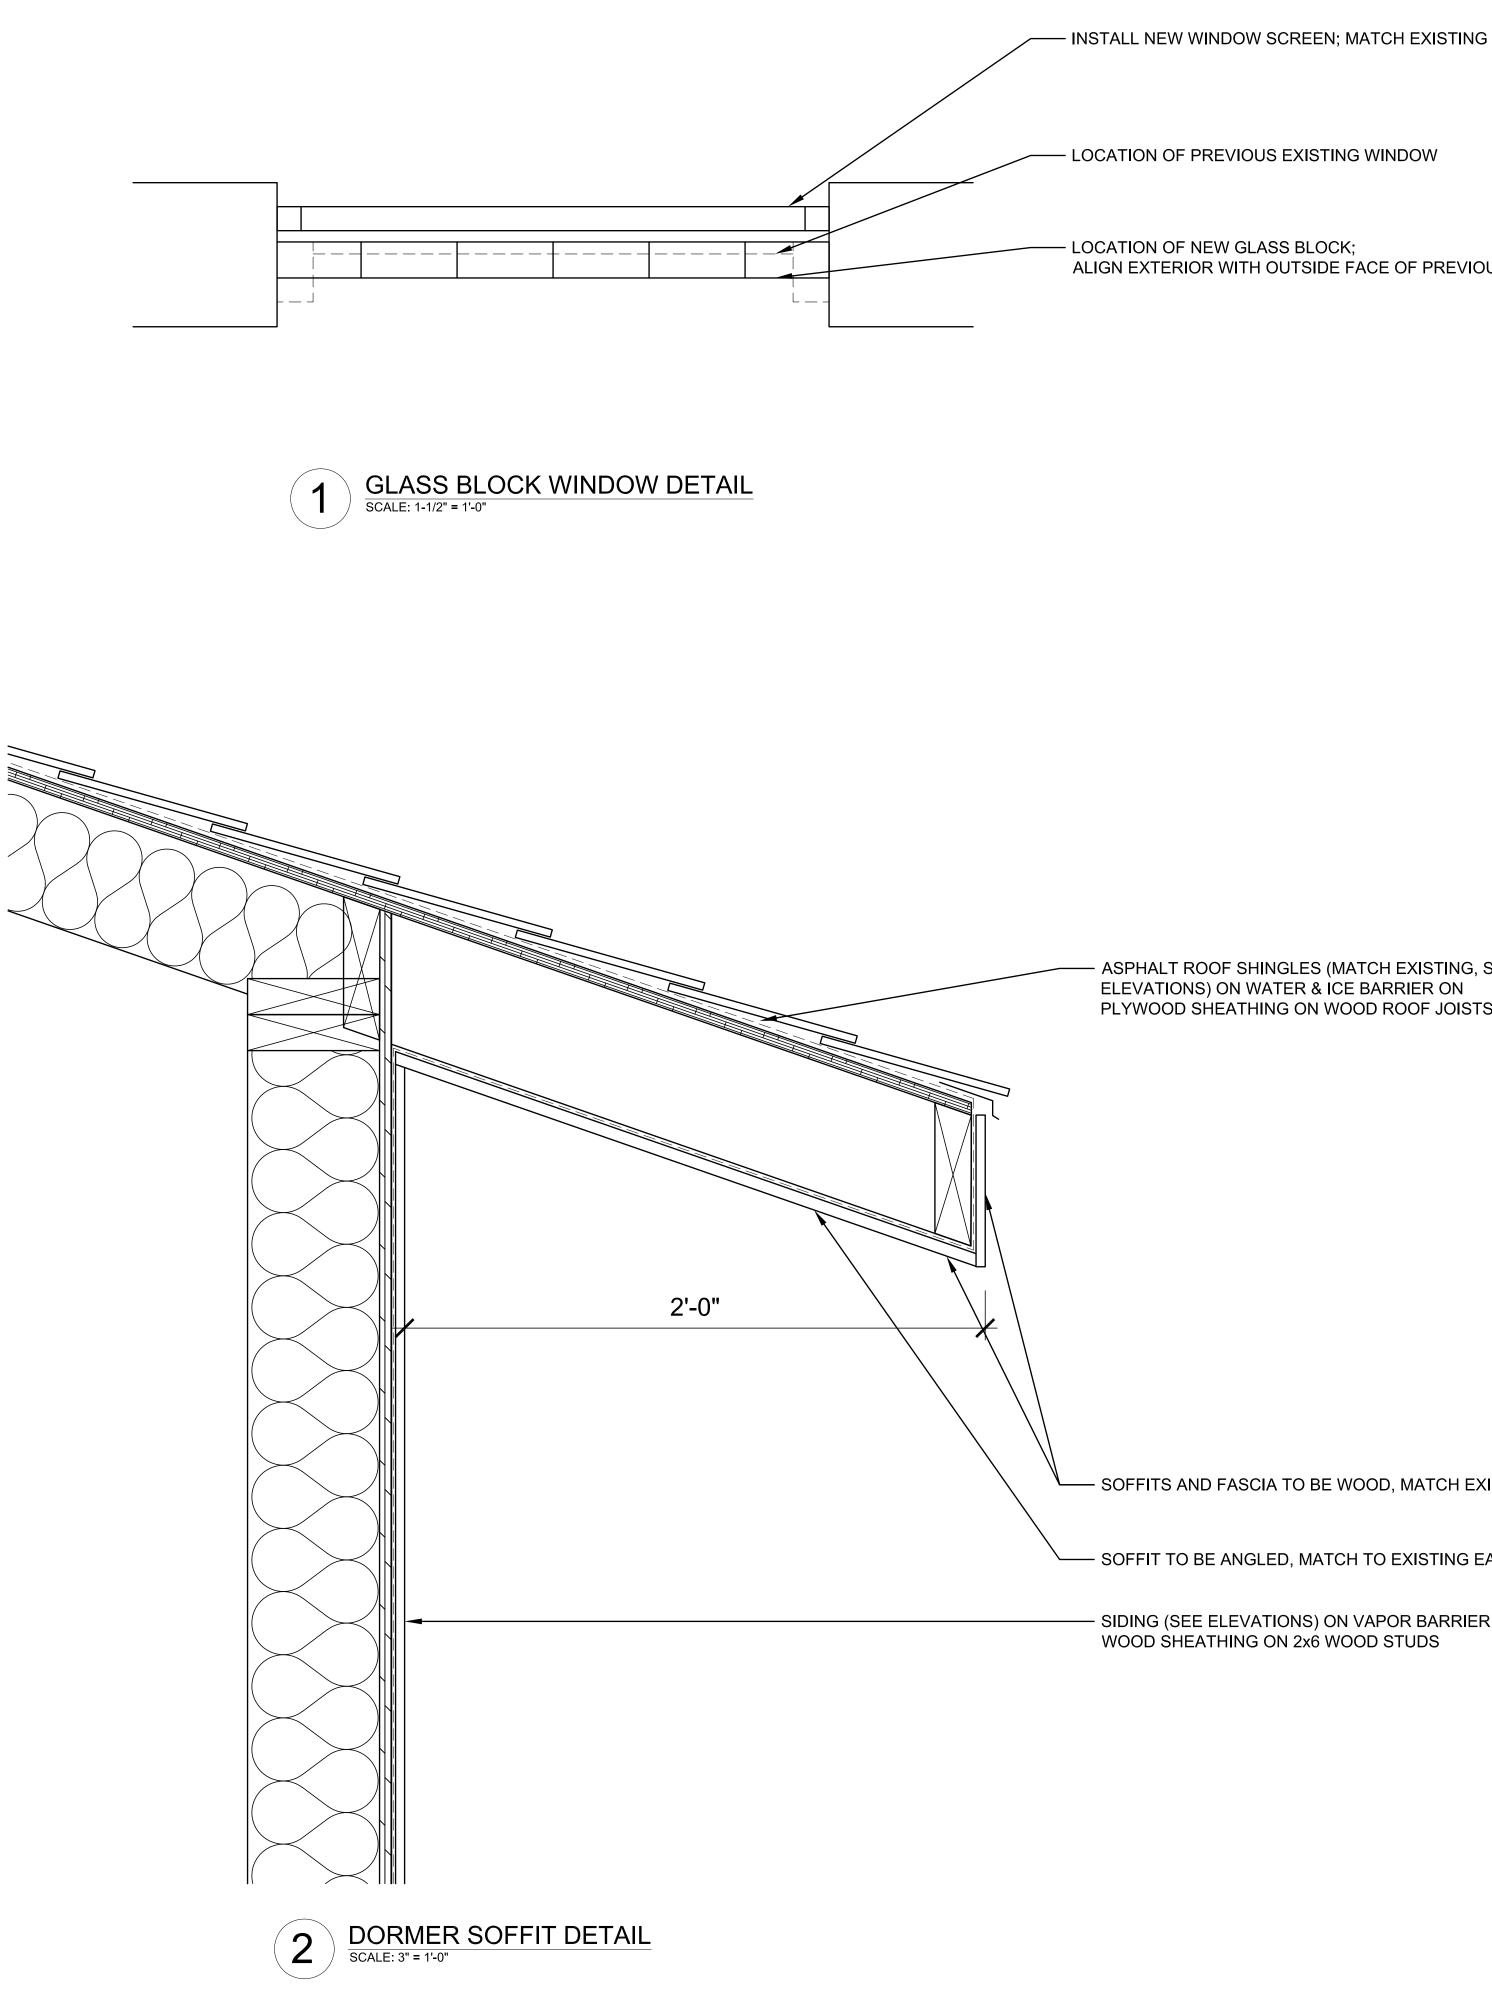

	4545 architecture 2761 E. JEFFERSON AVE STE 302 DETROIT, MI 48207 P. 313.454.4545 TIM.FLINTOFF@4545ARCHITECTURE.COM
	Project : 708 PALLISTER HDC RENOVATION
	lssued for : HDC SUBMIT 02/18/2025
Flintoff Architect, PLLC	Drawn by : ANJ Check by :
DO NOT SCALE DRAWINGS   ©2024 Timothy Flintoff	Sheet Title : DETAIL DRAWINGS Project No. : 2024001
O NOT SCALE DF	Sheet No. : <b>A5.1</b>

- LOCATION OF PREVIOUS EXISTING WINDOW


- LOCATION OF NEW GLASS BLOCK; ALIGN EXTERIOR WITH OUTSIDE FACE OF PREVIOUS WINDOW


– ASPHALT ROOF SHINGLES (MATCH EXISTING, SEE ELEVATIONS) ON WATER & ICE BARRIER ON PLYWOOD SHEATHING ON WOOD ROOF JOISTS

SOFFITS AND FASCIA TO BE WOOD, MATCH EXISTING


— SOFFIT TO BE ANGLED, MATCH TO EXISTING EAVES

SIDING (SEE ELEVATIONS) ON VAPOR BARRIER ON WOOD SHEATHING ON 2x6 WOOD STUDS

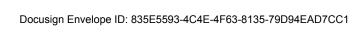

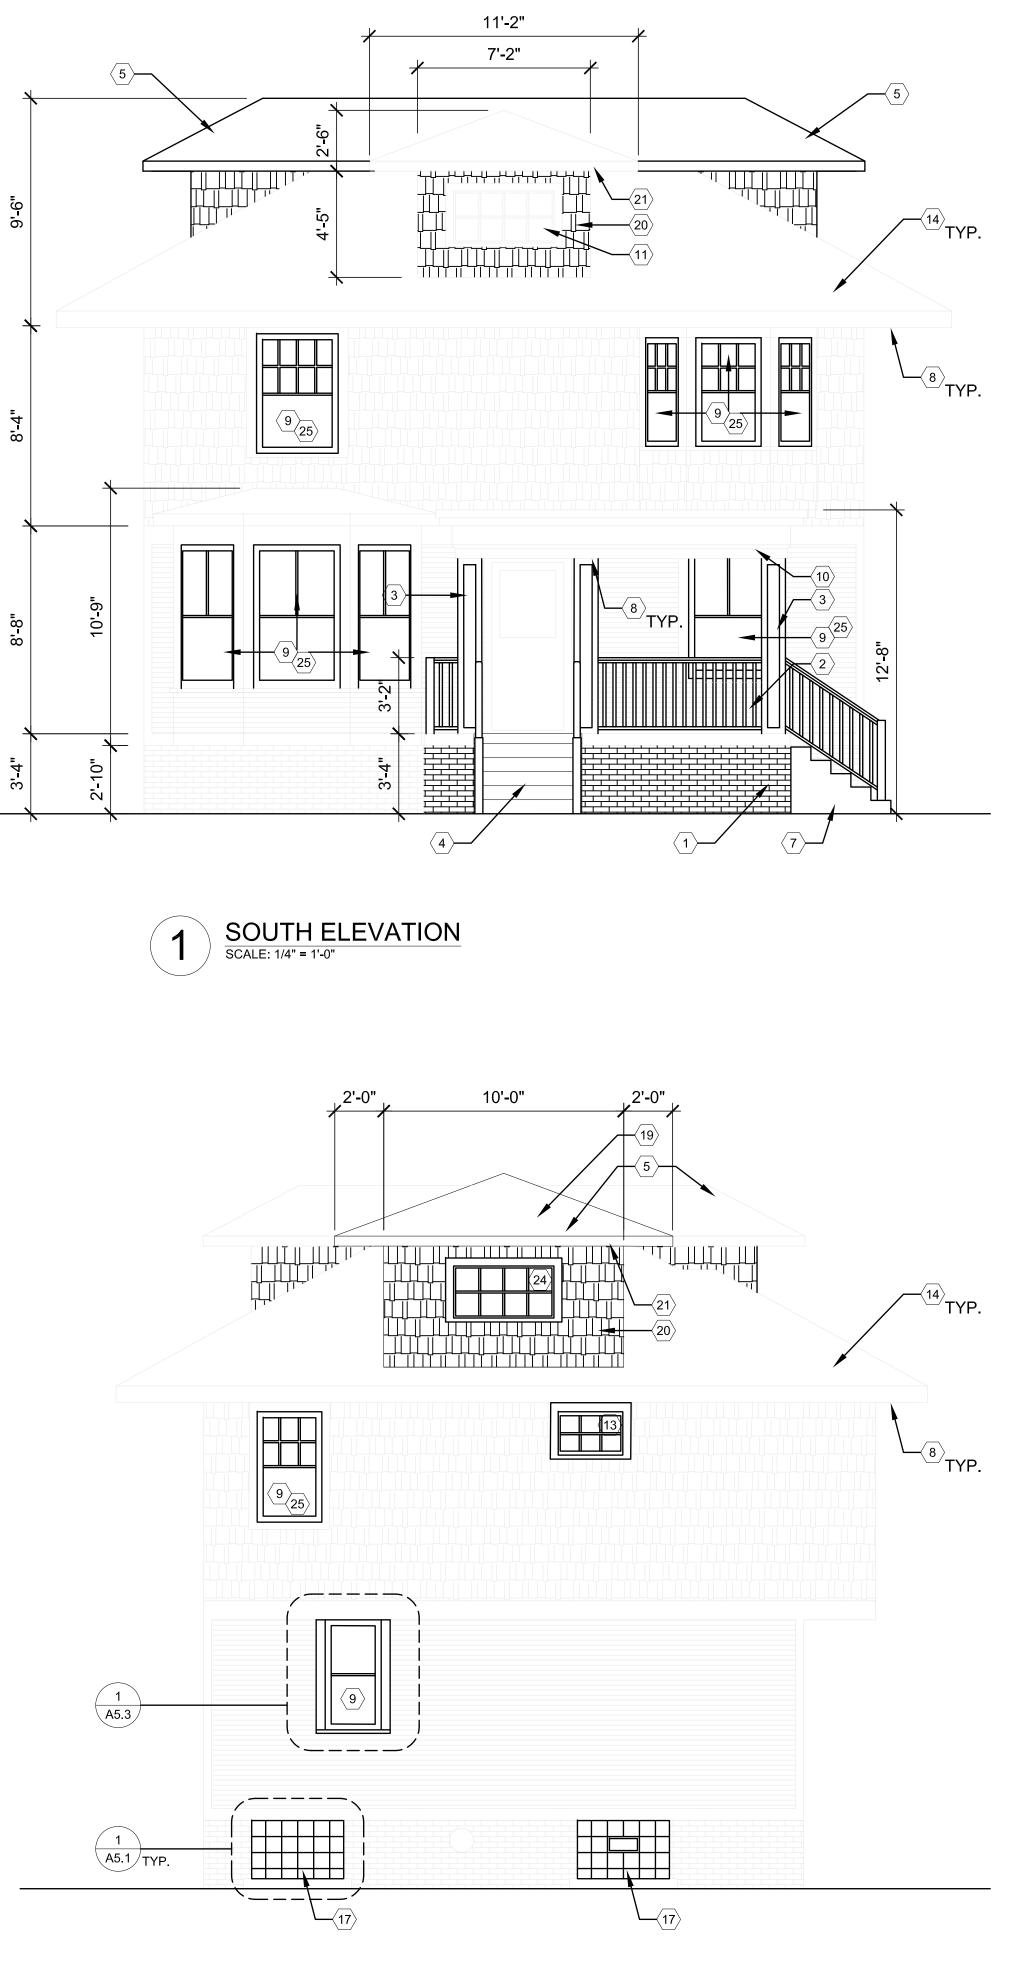



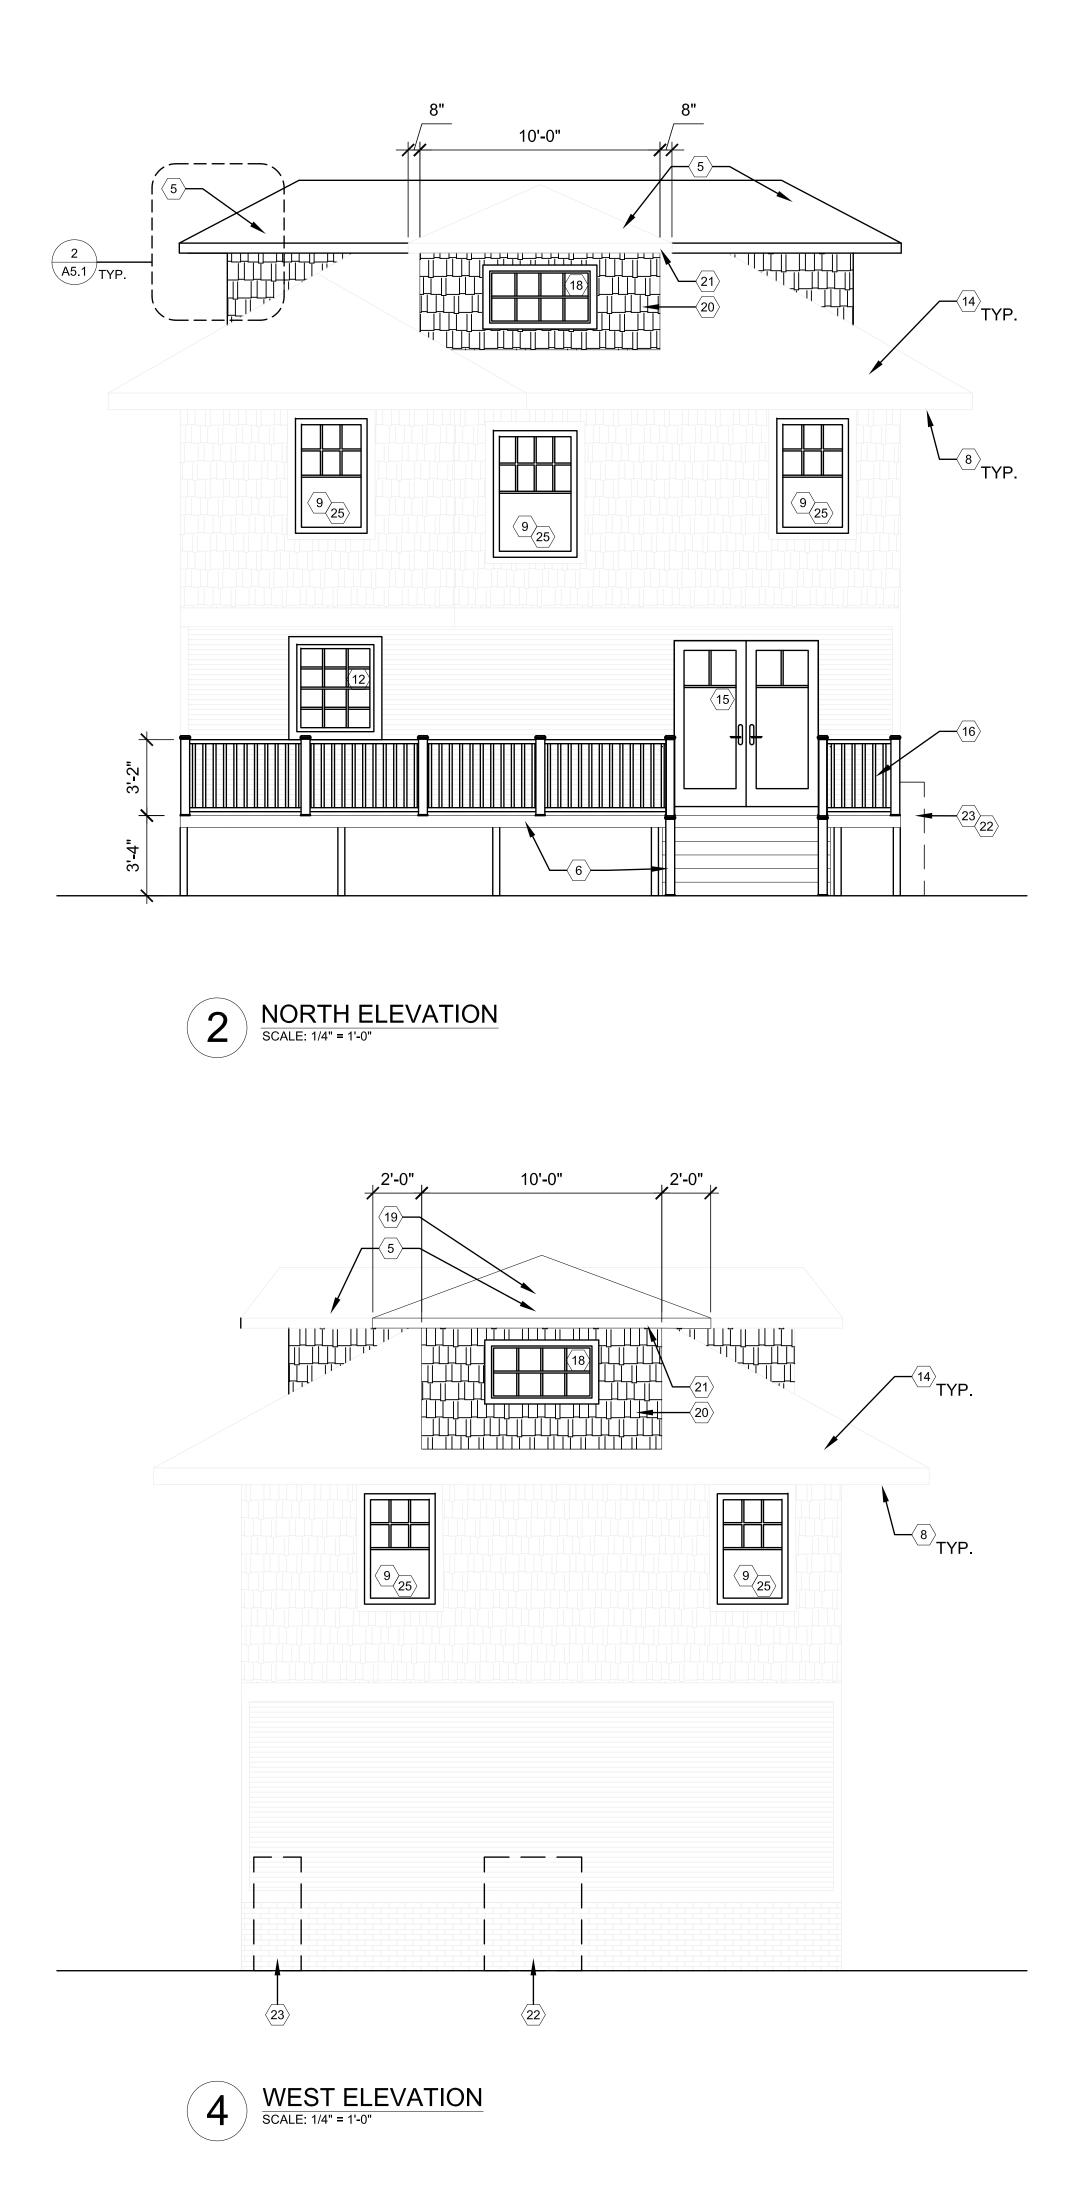


		Γ	ARCHITECT:
EL	EVATION KEY NOTES:		4545 architecture
(TYP	ICAL THIS SHEET ONLY)		2761 E. JEFFERSON AVE STE 302
$\langle 1 \rangle$	EXISTING MASONRY PORCH; ADDED BRICK VENEER, PAINTED TO MATCH EXISTING;		DETROIT, MI 48207 P. 313.454.4545
$\langle 2 \rangle$	WOOD RAILING, MIN. 36" TALL SEE A5.2 FOR BASIS OF DESIGN	-	TIM.FLINTOFF@4545ARCHITECTURE.COM
$\langle 3 \rangle$	PINE WRAPPED 4x4 WOOD POSTS, PAINTED WHITE		CONSULTANT:
$\langle 4 \rangle$	NEW MASONRY STAIR		
5	NEW DORMER; ROOF SHINGLES TO MATCH EXISTING		
<b>6</b>	NEW BACK DECK AND STAIR; BASIS OF DESIGN: TREX TRANSCEND COMPOSITE DECKING, COLOR 'SADDLE'		
$\langle 7 \rangle$	REPLACE DAMAGED MASONRY STAIR WITH NEW		
$\langle 8 \rangle$	SOFFITS TO BE PATCHED & REPAIRED WITH IN-KIND MATERIALS		
<b>9</b>	EXIST. SINGLE-HUNG WINDOWS REPLACED W/ VINYL-CLAD WOOD SINGLE-HUNG, PAINTED BLACK; (ALREADY INSTALLED); ANDERSON 400 SERIES		
<b>(10)</b>	EXISTING PORCH ROOF TO REMAIN		
$\langle 11 \rangle$	EXISTING WINDOW TO BE REPAIRED, REPAINTED (BLACK)		
<b>(12)</b>	REPLACE INSTALLED WINDOW WITH: ANDERSON 400 SINGLE HUNG WINDOW IN BLACK, WITH SIMULATED DIVIDED LITES AS SHOWN		
(13)	REPLACE INSTALLED WINDOW WITH: ANDERSON 400 AWING WINDOW IN BLACK, WITH SIMULATED DIVIDED LITES AS SHOWN		
<ul><li>(14)</li></ul>	ROOF TO BE REPAIRED AS REQ'D USING IN-KIND MATERIALS; ROOF TO BE SHINGLED WITH CERTAINTEED LANDMARK PRO ASPHALT ROOF SHINGLES IN CINDER BLACK		
< <u>15</u> 	REPLACE INSTALLED DOUBLE DOOR WITH: FRENCH DOOR, BASIS OF DESIGN: ANDERSON E-SERIES HINGED PATIO DOOR IN BLACK WITH 'SHORT FRACTIONAL' GRILLE STYLE.		
< <u>16</u>	COMPOSITE RAILING, MIN, 36" TALL; SEE A5.2 FOR BASIS OF DESIGN		
< <u>17</u> >	REPLACE EXIST. BASEMENT WINDOWS WITH GLASS BLOCK (ALREADY INSTALLED); RESET GLASS BLOCK TO ENSURE INSTALLATION IS INSET INTO ORIGINAL WINDOW PLANE		
(18)	REPLACE INSTALLED WINDOW WITH: ANDERSON 100 CASEMENT WINDOW IN BLACK, WITH SIMULATED DIVIDED LITES AS SHOWN		
(19)	GABLE DORMER ROOF TO BE REPLACED WITH HIP ROOF TO MATCH EXISTING		
(20)	INSTALLED COMPOSITE SIDING TO BE REPLACED WITH WOOD SHAKE SIDING, TO MATCH EXISTING, AND PAINTED TO MATCH EXISTING		Project :
<u>\</u> 21	ARTIFICIAL ROOF EAVE COVER(S) TO BE REMOVED; REPLACED WITH WOOD EAVE		708 PALLISTER HDC RENOVATION
(22)	LOCATION OF HVAC UNIT		
(23)	LOCATION OF ELECTRIC METER - PLACED BY DTE ENERGY COMPANY		
<b>(24)</b>	INSTALL "FAKE" WINDOW (DRYWALL INTERIOR OF WINDOW, PAINT INSIDE FACE OF DRYWALL WHITE); WINDOW TO BE ANDERSON 100 CASEMENT WINDOW IN BLACK, WITH SIMULATED DIVIDED LITES AS SHOWN		
<b>25</b>	SIMULATED DIVIDED LITES TO BE PLACED IN PREVIOUSLY INSTALLED WINDOWS AS SHOWN		
	GENERAL NOTE: ROOF, EXTERIOR CLADDING TO BE PATCHED AND REPAIRED AS REQ'D. ALL REPAIRS TO USE IN-KIND MATERIALS.		
	HOUSE TO BE PAINTED IN ACCORDANCE WITH HDC COLOR SYSTEM E ALL SIDING TO BE C:4 YELLOWISH WHITE		
	ALL TRIM AND SASH TO BE B:19 BLACK SEE A6.1 FOR COLOR RENDER		
			lssued for :
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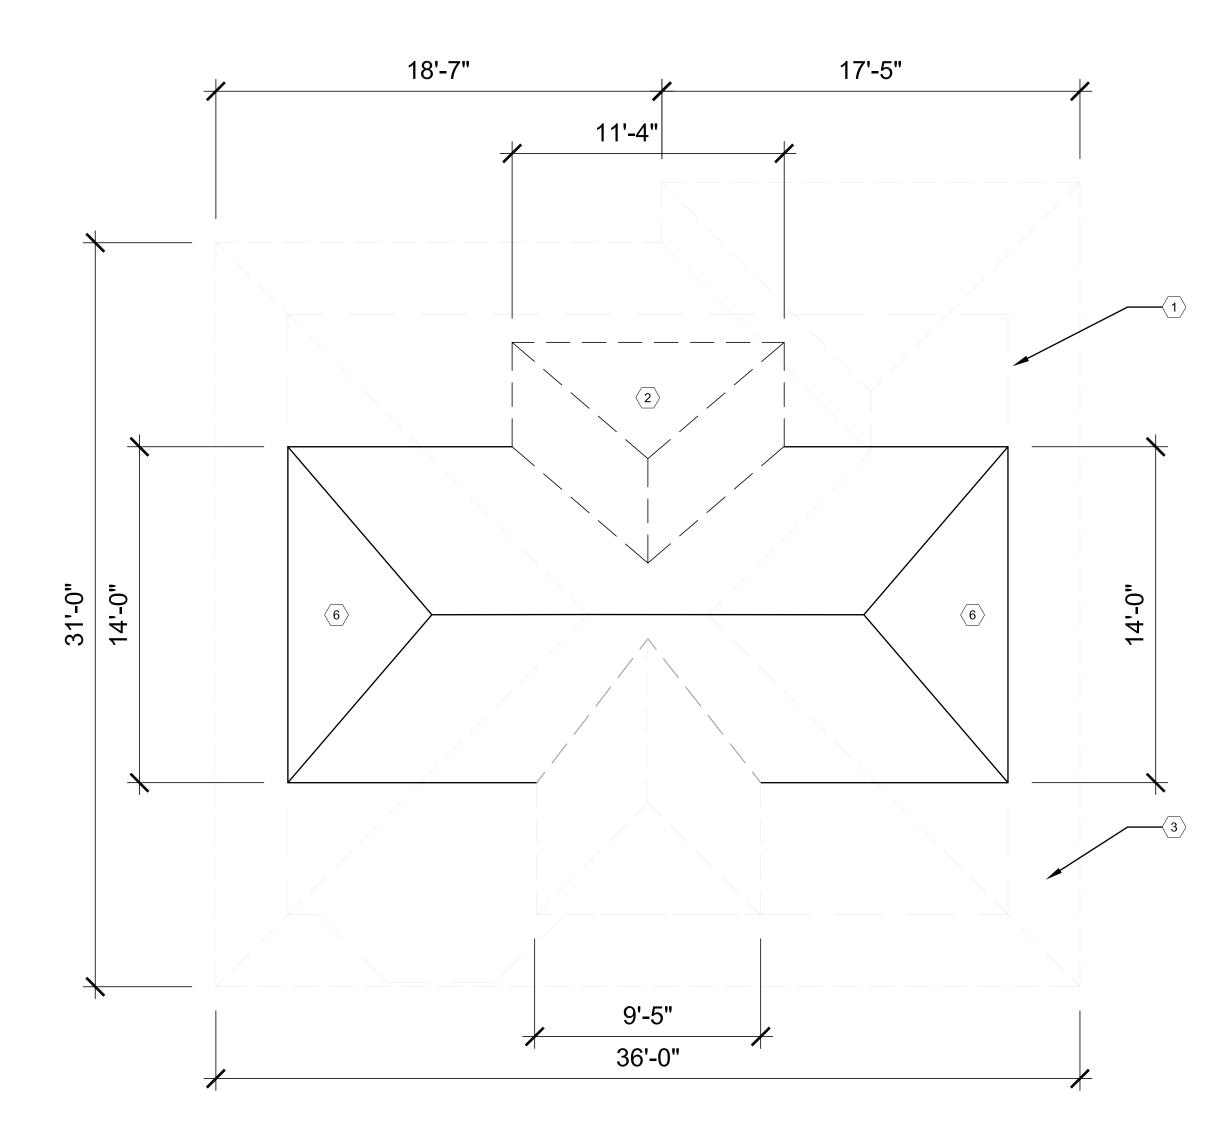
Project No. : **2024001** 

Sheet No. :

A3.1





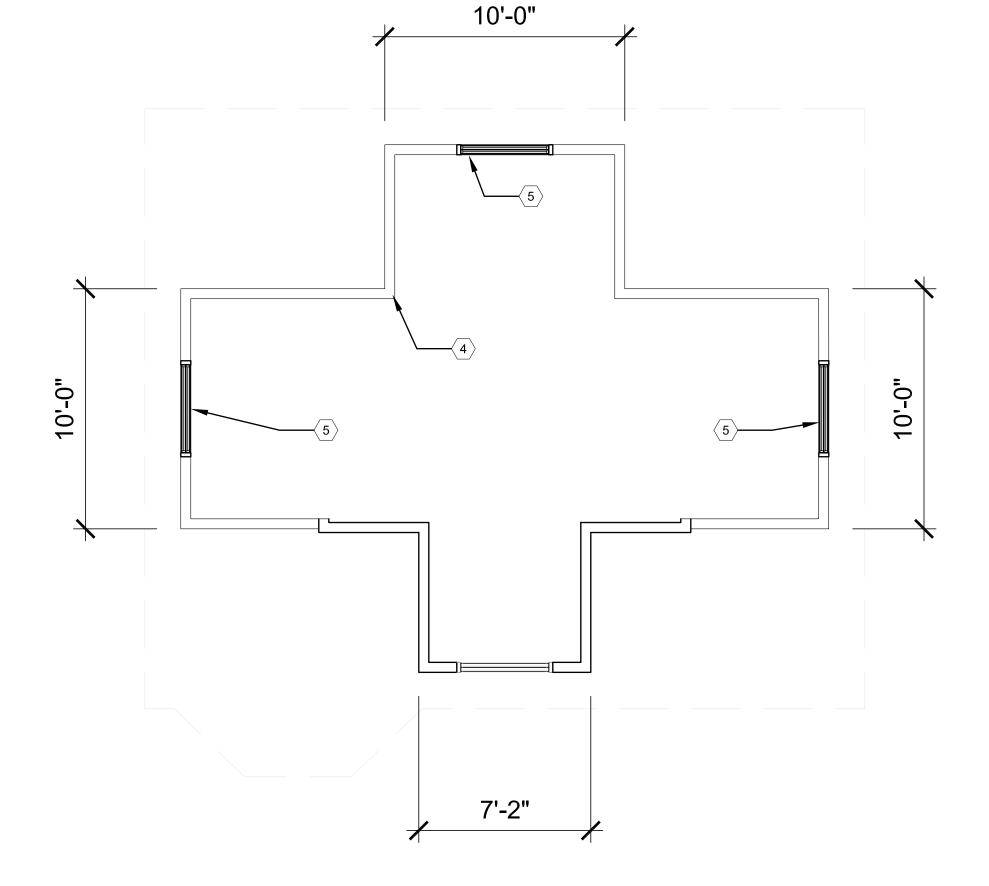




GENERAL FLOOR PLAN NOTES	3:
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- 1. THIS DRAWING IS DIAGRAMMATIC AND SHOULD BE USED TO DETERMINE THE DESIGN INTENT. THE CONTRACTOR IS RESPONSIBLE FOR THE COMPLETE SET OF WORK AS INDICATED AND SHALL FIELD VERIFY ALL WORK, COORDINATE ALL DRAWINGS / NEW WORK AND SHALL NOTIFY ARCHITECT IMMEDIATELY OF ANY DISCREPANCIES IN THE DOCUMENTS BEFORE PROCEEDING. FAILURE TO DO SO WILL RESULT IN THE CONTRACTOR TAKING FULL RESPONSIBILITY AND LIABILITY FOR SAID DISCREPANCIES.
- 2. ALL DIMENSIONS ARE SHOWN FROM FINISH FACE TO FINISH FACE OF PARTITION UNLESS OTHERWISE NOTED.
- 3. WALL THICKNESS' ARE NOMINAL NOT ACTUAL DIMENSIONS. SEE WALL SCHEDULE FOR ACTUAL DIMENSIONS.
- ALL WORK SHALL BE DONE IN ACCORDANCE WITH ALL LOCAL, STATE, COUNTY CODE REGULATIONS, O.S.H.A., AND THE AMERICAN WITH DISABILITIES ACT (ADA). REFER TO THE CODE PLAN FOR MORE INFORMATION.
- 5. PROVIDE POSITIVE SLOPE TO ALL FLOOR DRAINS WHILE KEEPING FLOOR LEVEL AT WALL BASE CONDITION.

#### PLAN KEY NOTES:

- (TYPICAL THIS SHEET ONLY)
- 1 LINE OF WALLS BELOW
- 2 NEW DORMER ROOF TO REMAIN
- 3 EXISTING ROOF TO BE REPAIRED WITH IN-KIND MATS. AS REQ'D (TYP.) SHINGLES TO BE REPLACED WITH CERTAINTEED LANDMARK PRO ROOF SHINGLES IN CINDER BLACK
- 4 FINAL LAYOUT OF INTERIOR KNEE WALLS TO BE DETERMINED BY EXISTING CONDITIONS AND OWNER INTERIOR CONFIGURATIONS, COORDINATE WITH OWNER (WORK COMPLETED)
- $\left< 5 \right>$  NEW WINDOW, SEE ELEVATIONS
- $\fbox{6}$  dormer roof to be removed, replaced with coordinating gable roof, see elevations
- GENERAL NOTE: SEE A4.1 FOR ROOF FRAMING PLAN


ARCHITECT: 4545 architecture 2761 E. JEFFERSON AVE STE 302 DETROIT, MI 48207 P. 313.454.4545 TIM.FLINTOFF@4545ARCHITECTURE.COM CONSULTANT: Project : 708 PALLISTER HDC RENOVATION Issued for : HDC SUBMIT 02/18/2025 COF MIC

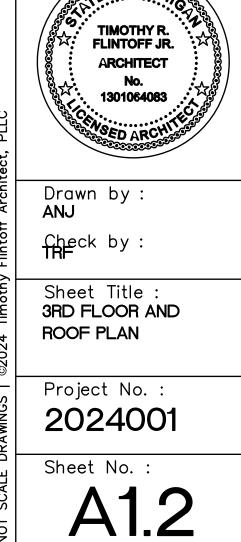



# FRONT PORCH RAILING

AMERICAN PORCH 4" 3 PC.PORCH RAIL SYSTEM, CEDAR WITH BOTTOM RAIL


AMERICAN PORCH 1-5/8" SQUARE BALUSTER, CEDAR 32" LENGTH

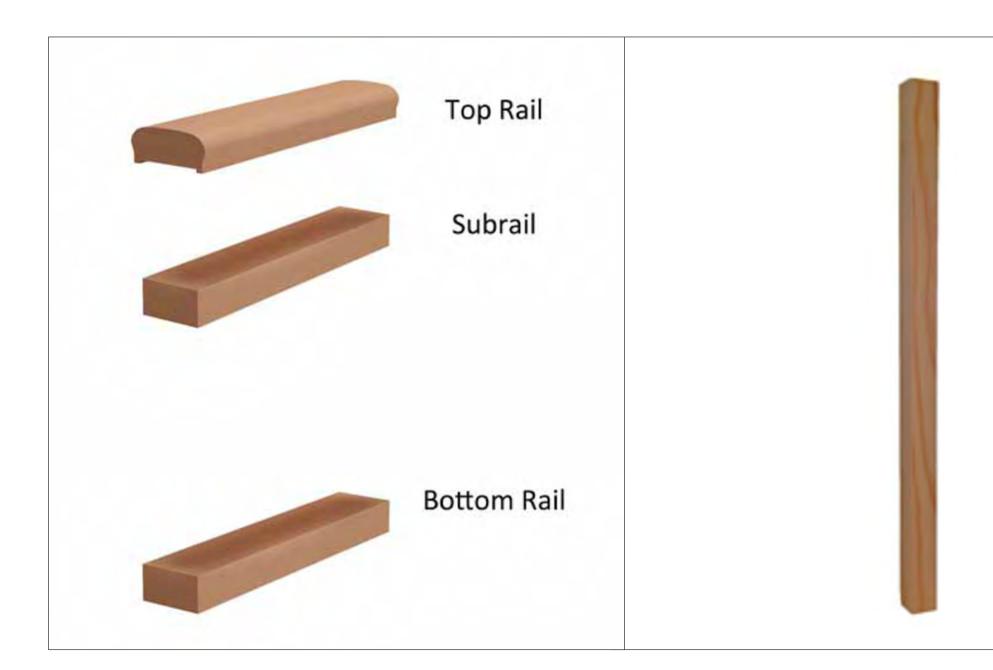


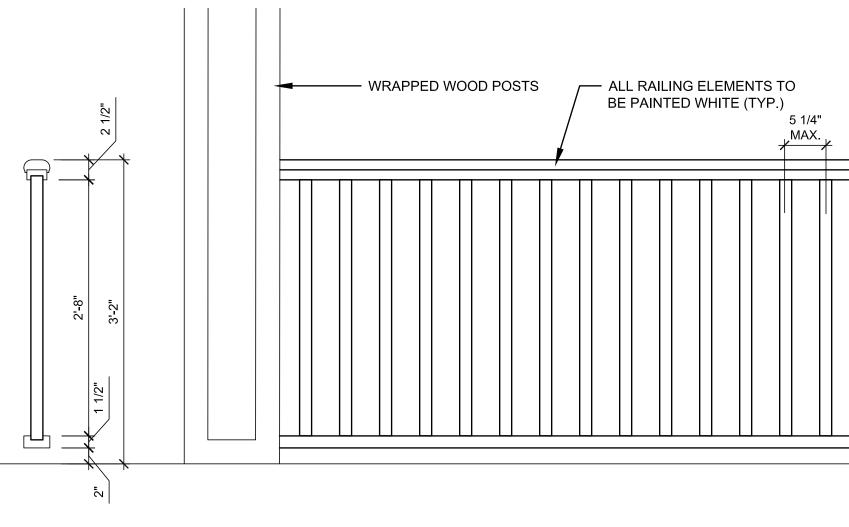


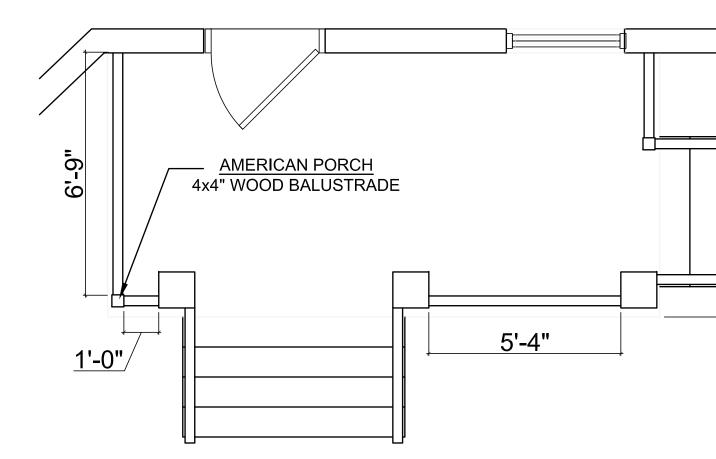

# REAR DECK RAILING

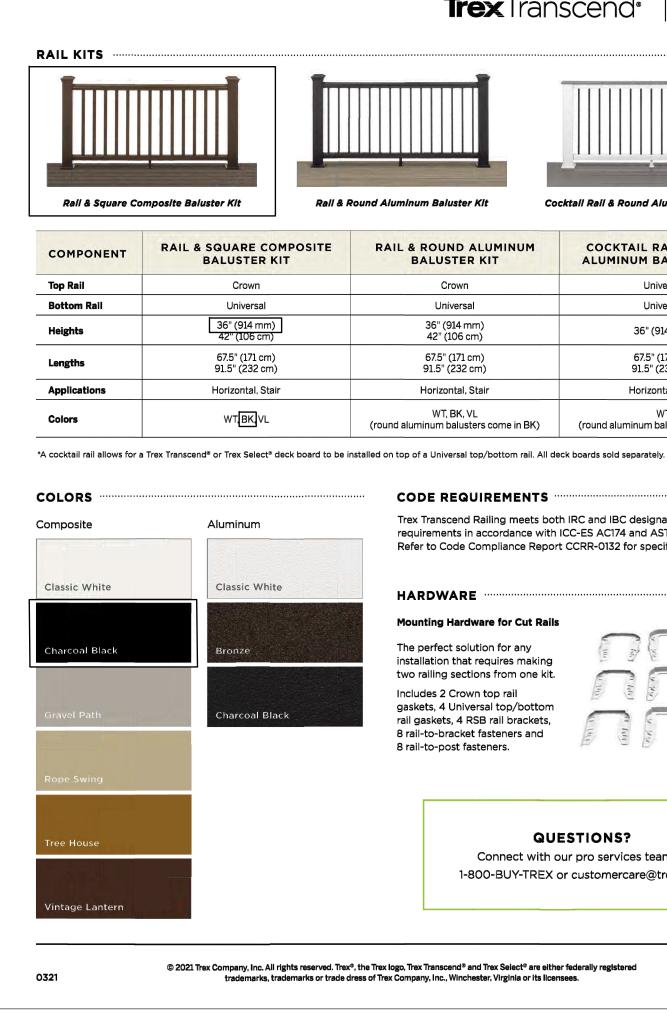

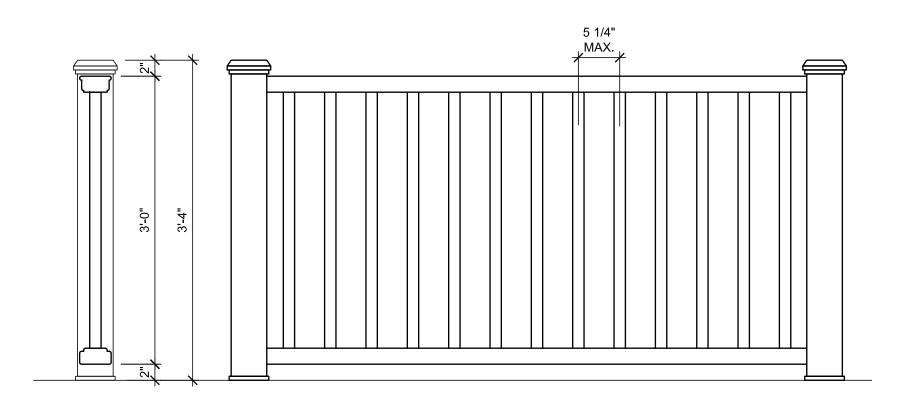

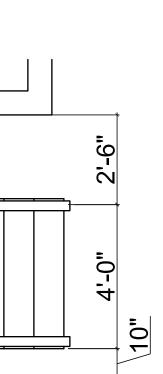

**Trex**Transcend<sup>®</sup>

T	П		IП	П	T

Cocktail Rail & Round Aluminum Baluster Kit

Trex

OUND ALUMINUM	COCKTAIL RAIL & ROUND ALUMINUM BALUSTER KIT*						
Crown	Universal						
Universal	Universal						
36" (914 mm) 42" (106 cm)	36" (914 mm)						
67.5" (171 cm) 91.5" (232 cm)	67.5" (171 cm) 91.5" (232 cm)						
lorizontal, Stair	Horizontal, Stair						
WT, BK, VL num balusters come in BK)	WT (round aluminum balusters come in BK)						

#### CODE REQUIREMENTS

Trex Transcend Railing meets both IRC and IBC designated requirements in accordance with ICC-ES AC174 and ASTM D7032. Refer to Code Compliance Report CCRR-0132 for specific details.

#### HARDWARE


Mounting Hardware for Cut Rails The perfect solution for any installation that requires making two railing sections from one kit. Includes 2 Crown top rail gaskets, 4 Universal top/bottom W. rail gaskets, 4 RSB rail brackets, 8 rail-to-bracket fasteners and 8 rail-to-post fasteners.

#### QUESTIONS? Connect with our pro services team at 1-800-BUY-TREX or customercare@trex.com


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TIM.FLINTOFF@4545ARCHITECTURE.(	сом
CONSULTANT:	
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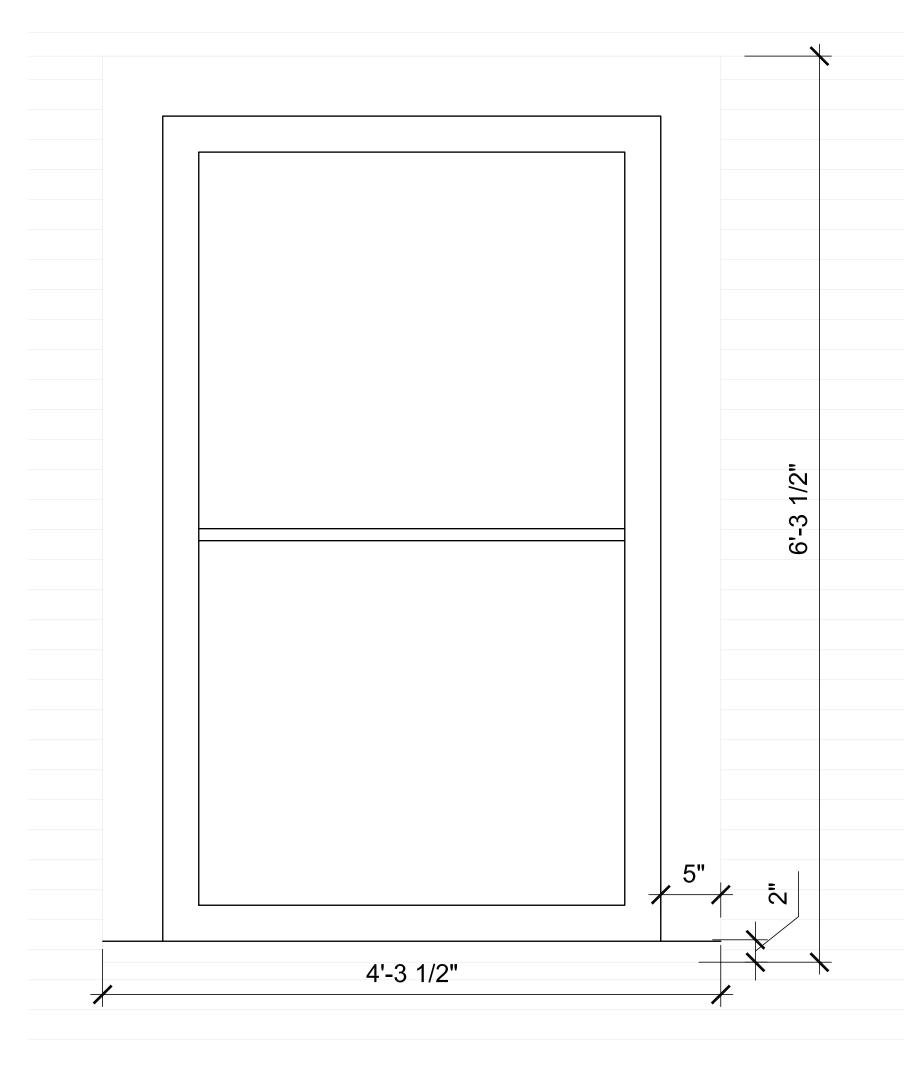




PREVIOUS WINDOW FRAMING DETAIL (INFILLED WINDOW AT EAST ELEVATION)

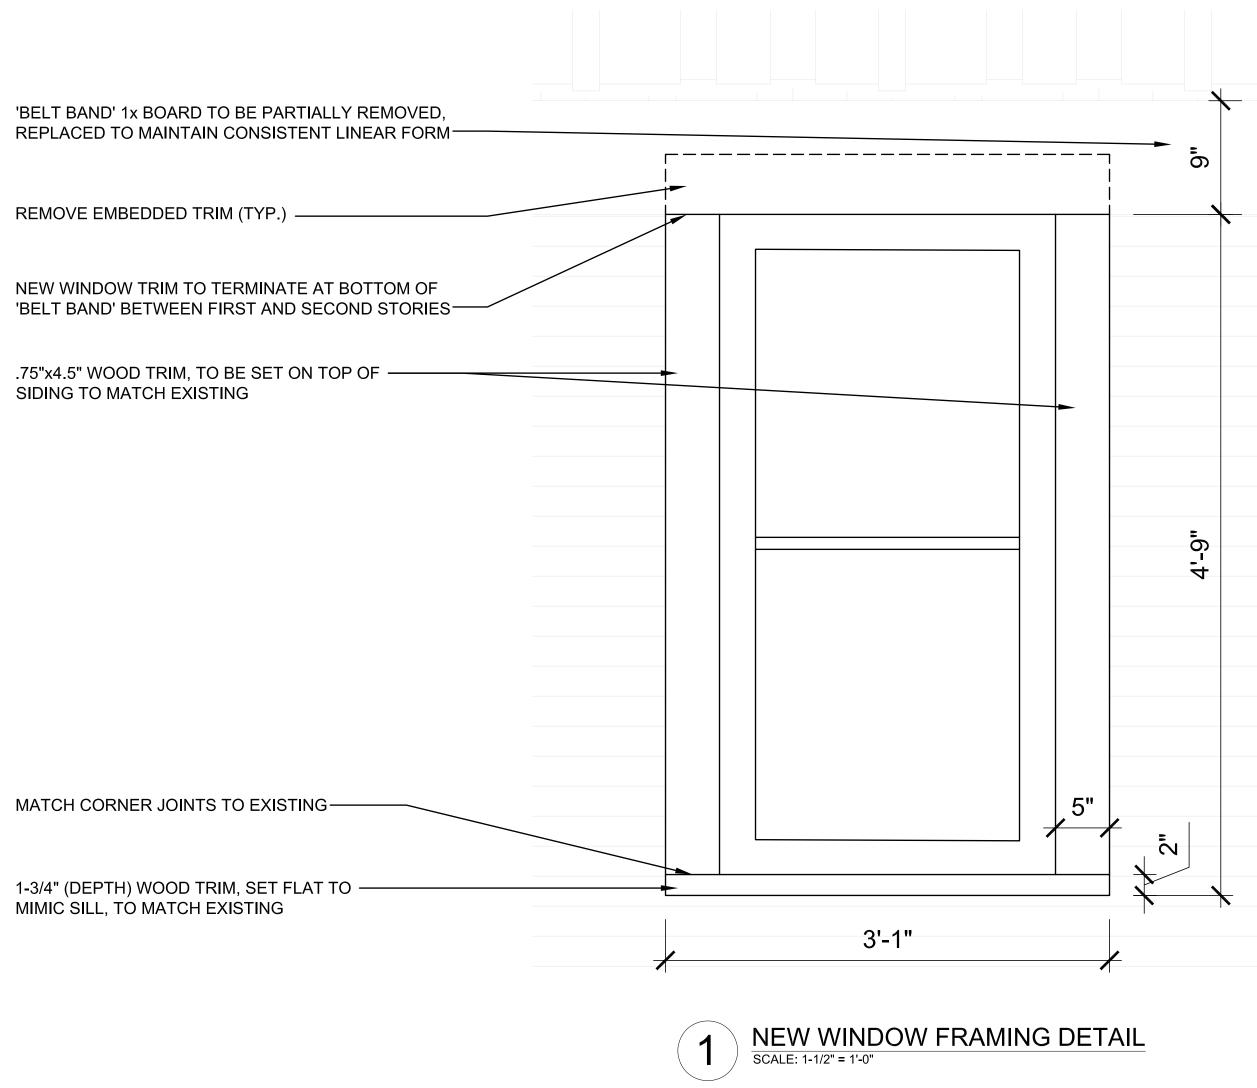

NEW WINDOW PHOTO TAKEN NOVEMBER 26, 2024

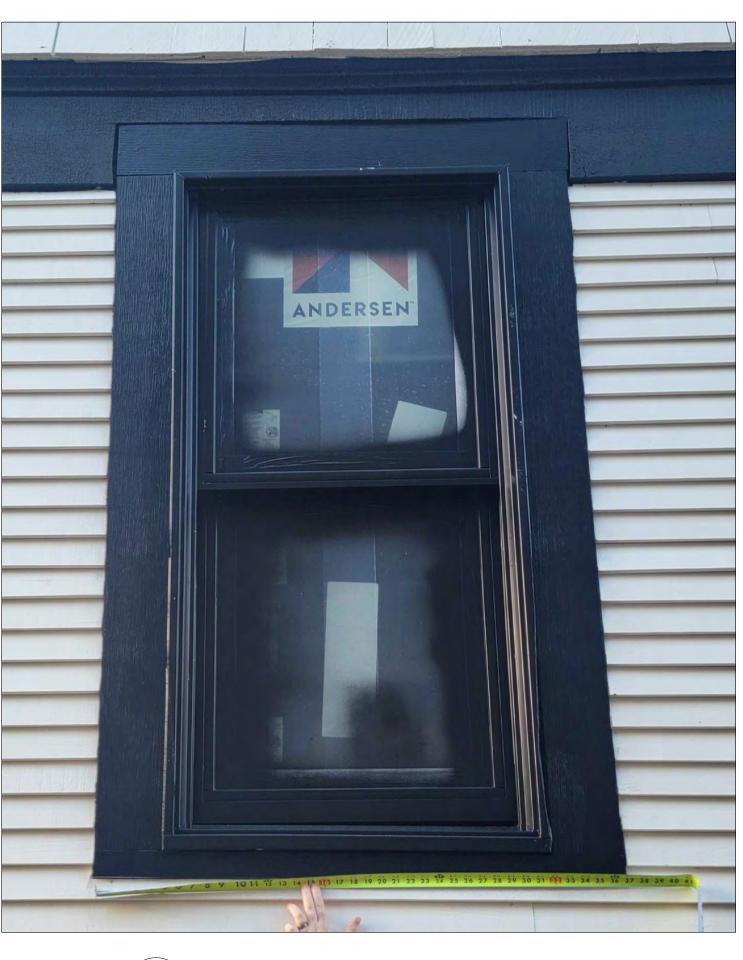




FRONT ELEVATION EXISTING WINDOW FRAMING DETAIL SCALE: 1-1/2" = 1'-0"






ARCHITECT: 4545 architecture 2761 E. JEFFERSON AVE STE 302 DETROIT, MI 48207 P. 313.454.4545 TIM.FLINTOFF@4545ARCHITECTURE.COM CONSULTANT: Project : 708 PALLISTER HDC RENOVATION lssued for : HDC SUBMIT 02/18/2025 TIMOTHY R. FLINTOFF JR ARCHITECT 30106408 Drawn by : **ANJ** Check by : TRF Sheet Title : WINDOW TRIM DETAILS Project No. : 2024001 Sheet No. : A5.3

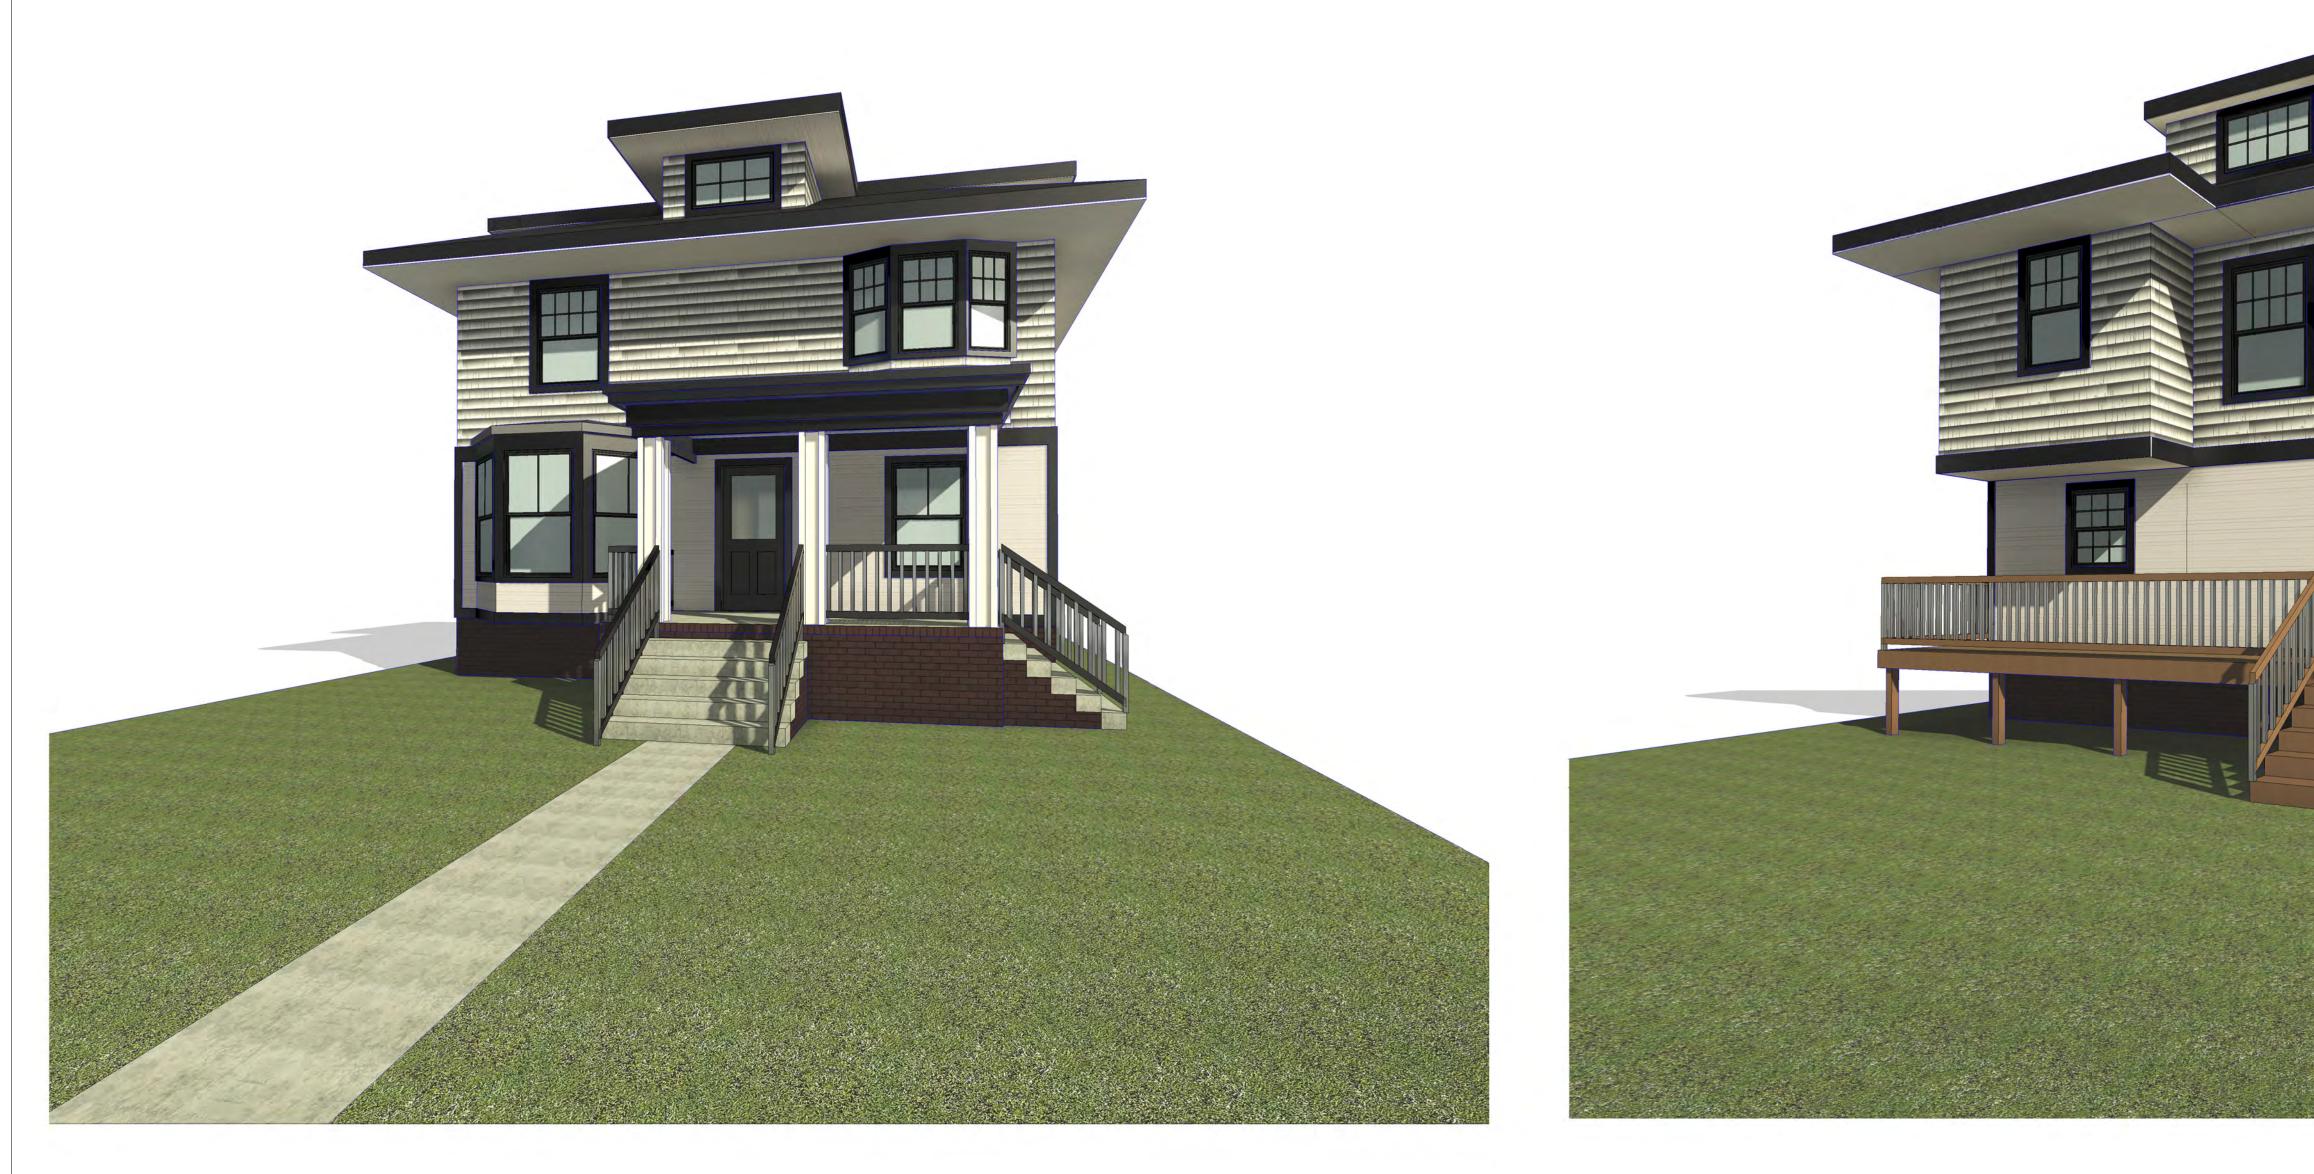





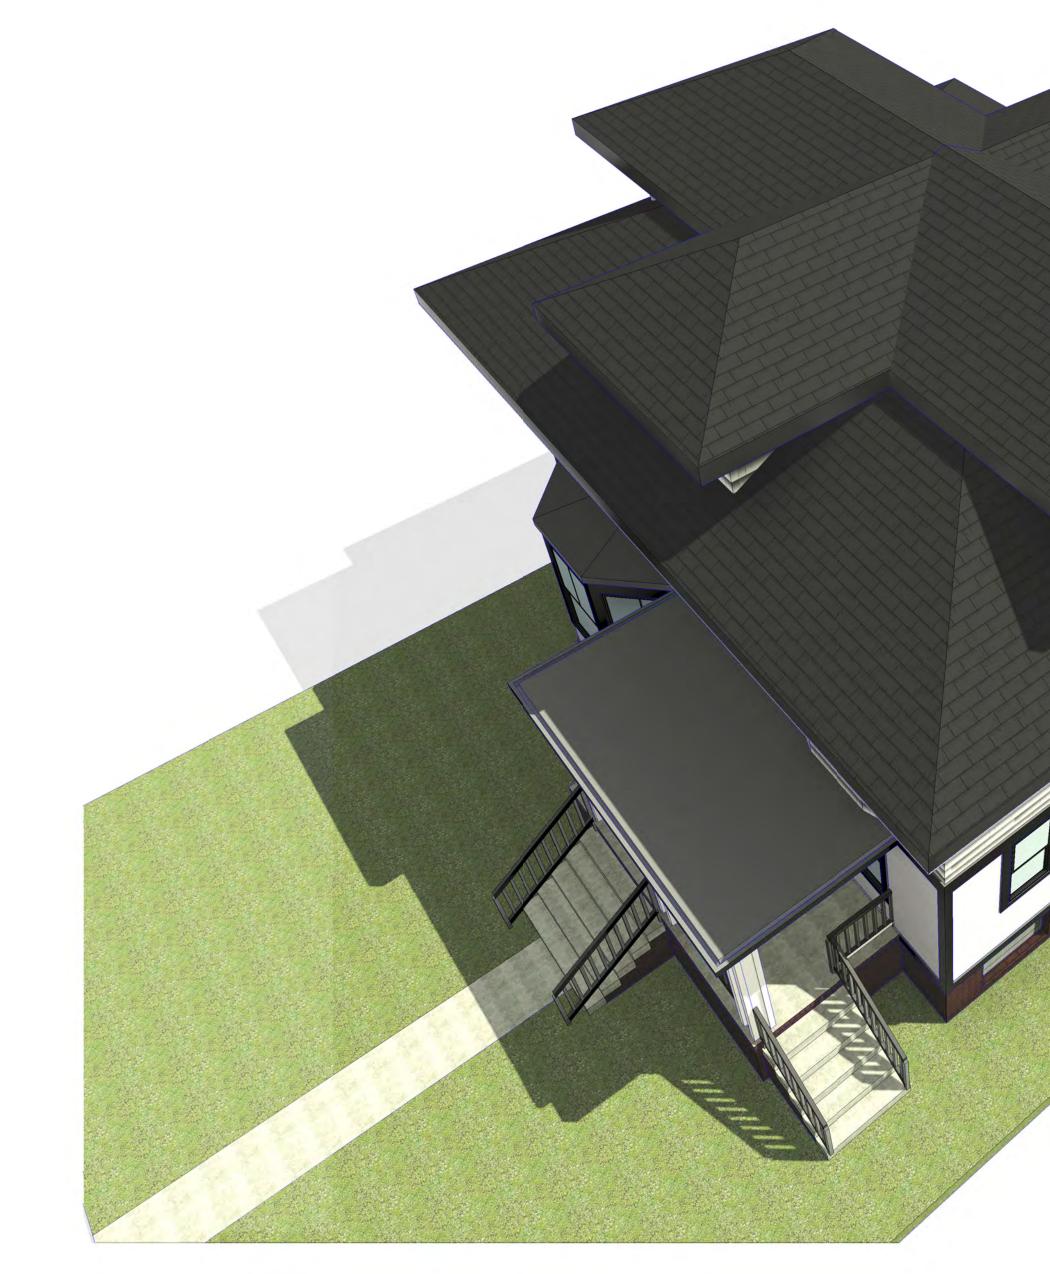

	ARCHITECT: 4545 architecture 2761 E. JEFFERSON SUITE 302 DETROIT, MI 48207 P. 313.450.4545 TIM.FLINTOFF@4545ARCHITECTURE.COM CONSULTANT:
	Project : 708 PALLISTER HDC RENOVATION
	Issued for : HDC SUBMIT 02/18/2025
	CONTRACTOR OF MICAN
Architect, PLLC	TIMOTHY R. FLINTOFF JR. ARCHITECT No. 1301064083 Drawn by : Author Checked by : Author
DO NOT SCALE DRAWINGS   @2021 Timothy Flindet, PLLC	Sheet Title : 3D RENDERS Project No. : 2024001
DO NOT SCALE DRAWIN	Sheet No. : A6.2

# 708 PALLISTER RENOVATION

EXTERIOR RENOVATION 708 PAILISITTER STREET,

DETROIT, MI. 48202

#### ARCHITECT

#### 4545 ARCHITECTURE | DESIGN, PLLC TIMOTHY FLINTOFF, AIA, NCARB 2761. E JEFFERSON, SUITE 302 DETROIT, MI 48207 248-320-6098

#### PROJECT DATA

**BUILDING CODE AUTHORITY:** CITY OF DETROIT, MICHIGAN

OWNER: THOMAS TYPINKSKI 708 PALLISTER ST,. DETROIT, MI 48202

APPLICABLE CODES: BUILDING CODE ALSO KNOWN AS THE "MICHIGAN RESIDENTIAL CODE" 2015 MICHIGAN RESIDENTIAL CODE (MRC) AS AMENDED APPENDIX J: EXISTING BUILDING AND STRUCTURES

MECHANICAL CODE ALSO KNOWN AS THE "MICHIGAN MECHANICAL CODE" 2021 MICHIGAN MECHANICAL CODE AS AMENDED

PLUMBING CODE ALSO KNOWN AS THE "MICHIGAN PLUMBING CODE" 2021 MICHIGAN PLUMBING CODE AS AMENDED

ELECTRICAL CODE ALSO KNOWN AS THE "MICHIGAN ELECTRICAL CODE" 2023 NATIONAL ELECTRIC CODE (NEC) AS AMENDED & MICHIGAN AMMENDMENTS PART 8.

#### ENERGY CODE 2015 UNIFORM ENERGY CODE

BARRIER FREE REQUIREMENTS AMERICANS WITH DISABILITIES ACT (ADA) MBC-2015, CHAPTER 11 ICC / ANSI 117.1 - 2010, EXCEPT SECTION 611 & 707 **BUILDING DATA:** 

#### LOT SIZE: 5,800 GSF

EXIST. BUILDING FOOTPRINT: 770 GSF

STORIES: 3 SPRINKLERED: NO

BUILDING CODE INFORMATION:

OCCUPANCY/USE

**R-2 RESIDENTIAL - SINGLE FAMILY** 

CONSTRUCTION TYPE: V-B (EXISTING AND PROPOSED)

**REQUIRED EXITS:** DWELLING UNIT: 1 EXIT + 1 EMERGENCY WINDOW EGRESS PER UNIT


PROVIDED EXITS: DWELLING UNIT: 2 EXTERIOR EXITS + 1 EMERGENCY WINDOW EXIT






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A6.2	3D RENDERS

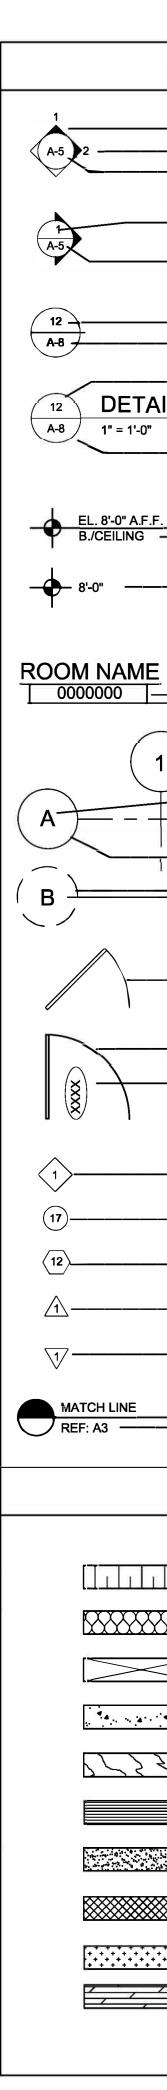

SYN	/BOL LEGEND	AB	BREVIATION
		@	
	- DARKENED ARROW INDICATES ELEVATED SECTION	ACOUST. A.C.T.	ACOUSTICAL ACOUSTIC CEILING TILE
	- ELEVATION NUMBER	ADJ.	ADJACENT
	- SHEET NUMBER WHERE ELEVATION IS LOCATED	A.F.F. ALUM.	ABOVE FINISH FLOOR ALUMINUM
		ANOD. BD.	ANODIZED BOARD
	- ELEVATION NUMBER	BLDG. BLK.	BUILDING BLOCK
	- SHEET NUMBER WHERE ELEVATION IS LOCATED	BLKG. CEM.	BLOCKING CEMENT
		C.J.	CONTROL JOINT
	- DETAIL REFERENCE NUMBER	CLG. ଜୁ	CEILING CENTER LINE
	-SHEET NUMBER WHERE DETAIL IS LOCATED	C.O. COL.	CLEAN OUT COLUMN
		CONC. C.G.	CONCRETE CORNER GUARD
	- DETAIL NUMBER	CONST.	CONSTRUCTION
	- DETAIL NAME	CONT. CORR.	CONTINUOUS CORRUGATED
		CPT. C.T.	CARPET CERAMIC TILE
	- SHEET NUMBER WHERE DETAIL IS REFERENCED	DET. DIA.	DETAIL DIAMETER
		DM.	DIMENSION
F	- HEIGHT ABOVE FINISHED FLOOR	DN. D.O.	DOWN DOOR OPENING
	REFERENCE POINT OF ELEVATION	DR. DWG.	DOOR DRAWING
		EA. ELEV.	EACH ELEVATION
	- HEIGHT ABOVE FINISHED FLOOR	E.W.	EACH WAY
	NOTE: DATUM SYMBOL INDICATES A SPECIFIC	EXG. EXIST.	EXISTING EXISTING
	REFERENCE HEIGHT OF MATERIAL INDICATED	EXP. EXT.	EXPANSION, EXPOSED EXTERIOR
: —	- ROOM NAME	F.D.	FLOOR DRAIN
		FDN. F.R.P.	FOUNDATION FIBER REINFORCED PANELS
		FIN. FLR.	FINISH FLOOR
		F.O. F.O.S.	FACE OF FACE OF STUD
1		FR.	FRAME
	- NUMBERS DESIGNATE VERTICAL COLUMN LINES	FTG. FV.	FOOTING FIELD VERIFY
_	LETTERS DESIGNATE HORIZONTAL COLUMN LINES	GA. GALV.	GAUGE GALVANIZED
		GYP. HDW.	GYPSUM
1	- CIRCLES REPRESENT NEW COLUMN LINES	H.M.	HARDWARE HOLLOW METAL
	DASHED CIRCLES REPRESENT EXISTING COLUMNS	HORIZ. HT.	HORIZONTAL HEIGHT
		I.D. INSUL.	INSIDE DIAMETER
		INT.	INTERIOR
	- EXISTING DOOR SYMBOL	JT. LAV.	JOINT LAVATORY
		LG. L.L.O.	LONG LONG LEG OUTSTANDING
		L.L.V. MAX.	LONG LEG VERTICAL MAXIMUM
	- NEW DOOR SYMBOL	MECH.	MECHANICAL
		MET. MEZZ.	METAL MEZZANINE
	- DOOR DESIGNATION	M.I. MIN.	MISCELLANEOUS IRON
		MISC.	MISCELLANEOUS
		M.O. N.I.C.	MASONRY OPENING NOT IN CONTRACT
	- WALL TYPE DESIGNATION NUMBER -	N.T.S. O.C.	NOT TO SCALE ON CENTER
	COORDINATE WITH SCHEDULE	O.D. OPNG.	OUTSIDE DIAMETER OPENING
	- EQUIPMENT DESIGNATION NUMBER - COORDINATE WITH PLAN NOTES	OPP. PL.G.	OPPOSITE PLATE GLASS
		PL.S.	PLATE STEEL
	- KEY NOTE DESIGNATION NUMBER - COORDINATE WITH PLAN NOTES	P.LAM PLAS.	PLASTIC LAMINATE PLASTER
	- ADDENDUM DESIGNATION NUMBER	PREFAB. PROJ.	PREFABRICATED PROJECT, PROJECTION
		P.S.F. PT.	POUNDS PER SQUARE FOOT PAINT, POINT
	- BULLETIN DESIGNATION NUMBER	R.	RISER
		R.A. R.B.	RETURN AIR RUBBER BASE
-		R.C. R.C.P.	ROOF CONDUCTOR REFLECTED CEILING PLAN
	- SHEET REFERENCE FOR DRAWING CONTINUATION	R.D. R.F.	ROOF DRAIN RUBBER FLOORING
		REINF.	REINFORCED, REINFORCING REQUIRED
MA	TERIAL LEGEND	RFG.	ROOFING
		RM. R.S.	ROOM ROOF SUMP
		R.T. SAN.	RUBBER TILE SANITARY
	ACOUSTICAL CEILING	SCHED. SHT.	SCHEDULE SHEET
		SIM. SPEC.	SIMILAR
	BATT/LOOSE INSULATION	S.S.	SPECIFICATION SERVICE SINK
		STL. STD.	STEEL STANDARD
$\sim$	BLOCKING/ROUGH LUMBER	STOR. STRUCT.	STORAGE STRUCTURAL
		SUSP.	SUSPENDED SWITCH
	CONCRETE	SYM.	SYMMETRICAL
		Т. Т&В	TREAD TOP AND BOTTOM
イレ	FINISHED WOOD	TEL. TERR.	TELEPHONE TERRAZZO
		T&G THK.	TONGUE AND GROOVE
	GLASS	THRES.	THICK, THICKNESS THRESHOLD
·		T.O.S. TYP.	TOP OF STEEL TYPICAL
	GYPSUM WALLBOARD	U/C U.N.O.	UNDERCUT UNLESS NOTED OTHERWISE
<u> </u>		V.B.	VINYL BASE
	MASONRY	V.C.T. V.I.F.	VINYL COMPOSITION TILE VERIFY IN FIELD
·-···		W. VERT.	WIDE
• <u>••••</u> ]	PARTICLE BOARD	WAINS.	WAINSCOT
//	PLYWOOD	W.C. WD.WIN.	WATER CLOSET WOOD WINDOW
,		WT. W.W.F.	WEIGHT WELDED WIRE FABRIC
		-	


	ARCHITECT:
	4545 architecture
	2761 E. JEFFERSON AVE STE 302
	DETROIT, MI 48207 P. 313.454.4545 TIM.FLINTOFF <b>0</b> 4545ARCHITECTURE.COM
	CONSULTANT:
	Project :
	708 PALLISTER HDC RENOVATION
	Issued for :
	HDC SUBMIT 02/18/2025
	CONTRACTOR OF MICATION
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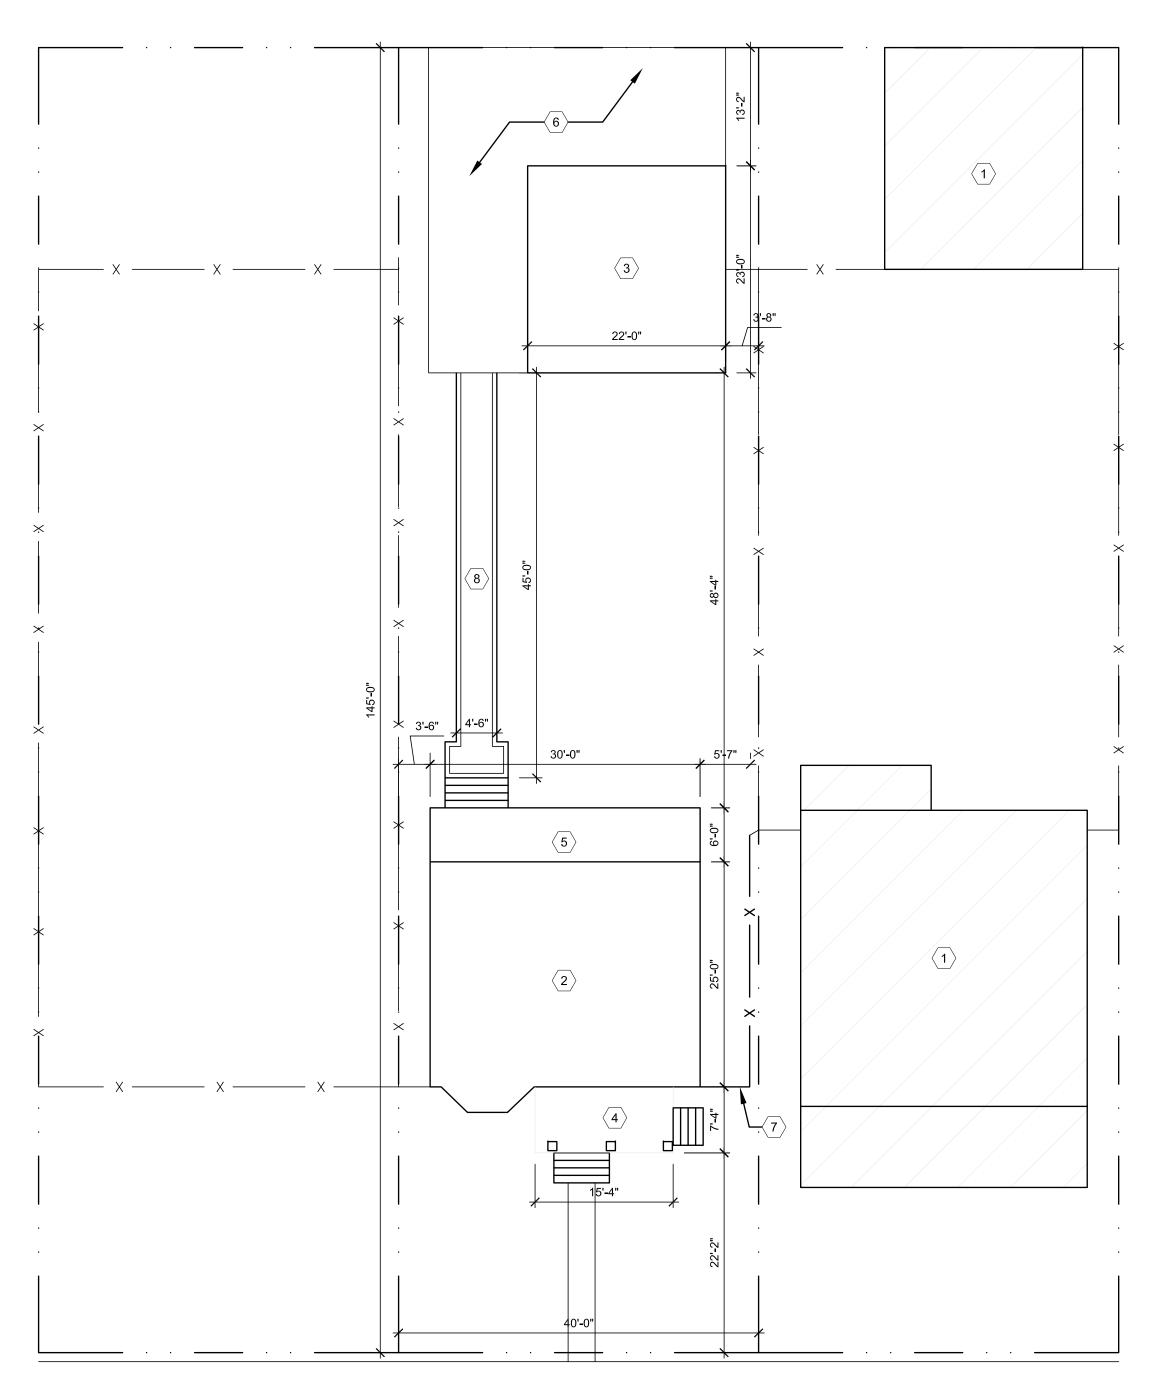
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	ARCHITECT:
GENERAL FLOOR PLAN NOTES:	<b>4545</b> architecture
1. THIS DRAWING IS DIAGRAMMATIC AND SHOULD BE USED TO DETERMINE THE	
DESIGN INTENT. THE CONTRACTOR IS RESPONSIBLE FOR THE COMPLETE SET OF WORK AS INDICATED AND SHALL FIELD VERIFY ALL WORK, COORDINATE ALL DRAWINGS / NEW WORK AND SHALL NOTIFY ARCHITECT IMMEDIATELY OF ANY DISCREPANCIES IN THE DOCUMENTS BEFORE PROCEEDING. FAILURE TO DO SO WILL RESULT IN THE CONTRACTOR TAKING FULL RESPONSIBILITY AND	2761 E. JEFFERSON AVE STE 302 DETROIT, MI 48207 P. 313.454.4545 TIM.FLINTOFF <b>@4</b> 545ARCHITECTURE.COM
LIABILITY FOR SAID DISCREPANCIES. 2. ALL DIMENSIONS ARE SHOWN FROM FINISH FACE TO FINISH FACE OF PARTITION	CONSULTANT:
UNLESS OTHERWISE NOTED. 3. WALL THICKNESS' ARE NOMINAL NOT ACTUAL DIMENSIONS. SEE WALL	
SCHEDULE FOR ACTUAL DIMENSIONS.	
<ol> <li>ALL WORK SHALL BE DONE IN ACCORDANCE WITH ALL LOCAL, STATE, COUNTY CODE REGULATIONS, O.S.H.A., AND THE AMERICAN WITH DISABILITIES ACT (ADA). REFER TO THE CODE PLAN FOR MORE INFORMATION.</li> </ol>	
5. PROVIDE POSITIVE SLOPE TO ALL FLOOR DRAINS WHILE KEEPING FLOOR LEVEL AT WALL BASE CONDITION.	
PLAN KEY NOTES:	
(TYPICAL THIS SHEET ONLY) $\langle 1 \rangle$ EXISTING MASONRY PORCH TO REMAIN	
$\langle 2 \rangle$ NEW DECK FOOTPRINT	
3 10" SONOTUBE (TYP.), B.O.F. TO BE MIN. 42" BELOW GRADE	
4 4x4 WOOD POST (TYP.)	
<ul> <li>(5) LEDGER DECK TO HOUSE, USING STRUCTURAL EPOXY AS REQ'D,</li> <li>STAGGER BOLTS 12" T &amp; B</li> </ul>	
<ul> <li>(6) INSTALL NEW FRENCH DOOR (WORK COMPLETED), SEE ELEVATIONS.</li> <li>INFILL WALL AS REQ'D.</li> </ul>	
TREX COMPOSITE DECKING ON 2x8 WOOD DECK JOISTS, MAX 16" O.C.	
$\langle 8 \rangle$ REMOVE AND INFILL EXISTING DOOR (WORK COMPLETED) $\langle 9 \rangle$ NEW MASONRY STAIR (WORK COMPLETED)	
$\langle 10 \rangle$ WOOD WRAPPED 4x4 WOOD POSTS, SEE ELEVATIONS	
NEW HANDRAIL, MIN. 36" TALL. SEE ELEVATIONS.	Project :
$\langle 12 \rangle$ EXISTING WINDOW REMOVED/INFILLED (WORK COMPLETED), SEE ELEVATIONS $\langle 13 \rangle$ NEW TREX COMPOSITE STAIR	708 PALLISTER
$\langle 14 \rangle$ EXISTING WINDOW REPLACED WITH VINYL-CLAD SLIDING WINDOW (WORK COMPLETED)	HDC RENOVATION
(15) SLIDING WINDOW TO BE REMOVED, REPLACED WITH ALUMINUM-CLAD WOOD SINGLE-HUNG WINDOW (ANDERSON 400 SERIES) W/ SIMULATED DIVIDED LITES TO MATCH PREVIOUSLY EXISTING WINDOW; PAINTED BLACK	
(16) INSTALL NEW VINYL-CLAD WOOD SINGLE-HUNG WINDOW (ANDERSON 400 SERIES), PAINTED BLACK; SEE ELEVATIONS (WORK COMPLETED)	
$\langle \overline{17} \rangle$ REPLACE DAMAGED MASONRY STAIR; NEW STAIR TO MATCH EXISTING	
(WORK COMPLETED)	
	Issued for : HDC SUBMIT 02/18/2025
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	Check by : TRF
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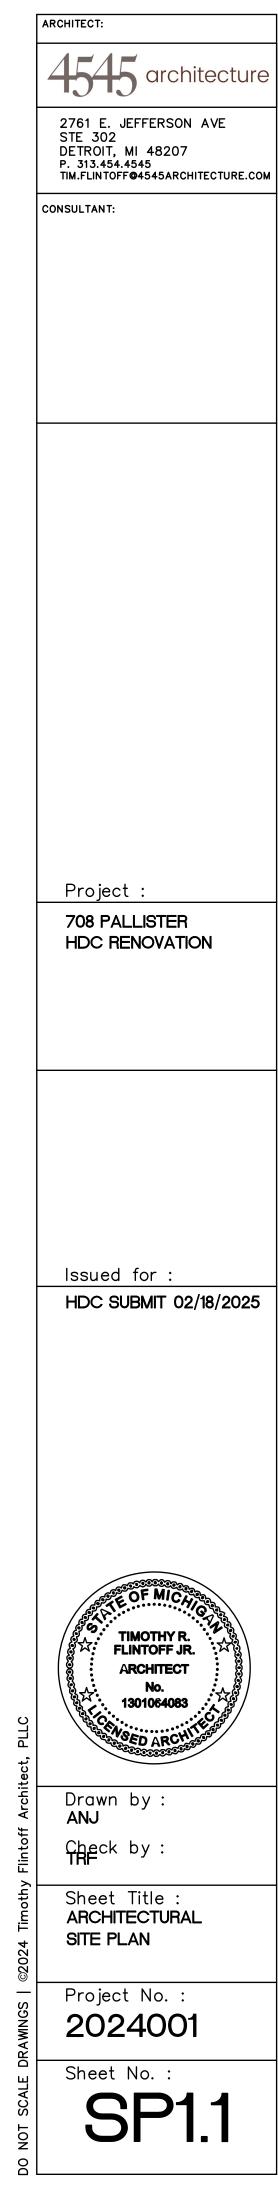
PALLISTER

## GENERAL SITE PLAN NOTES:

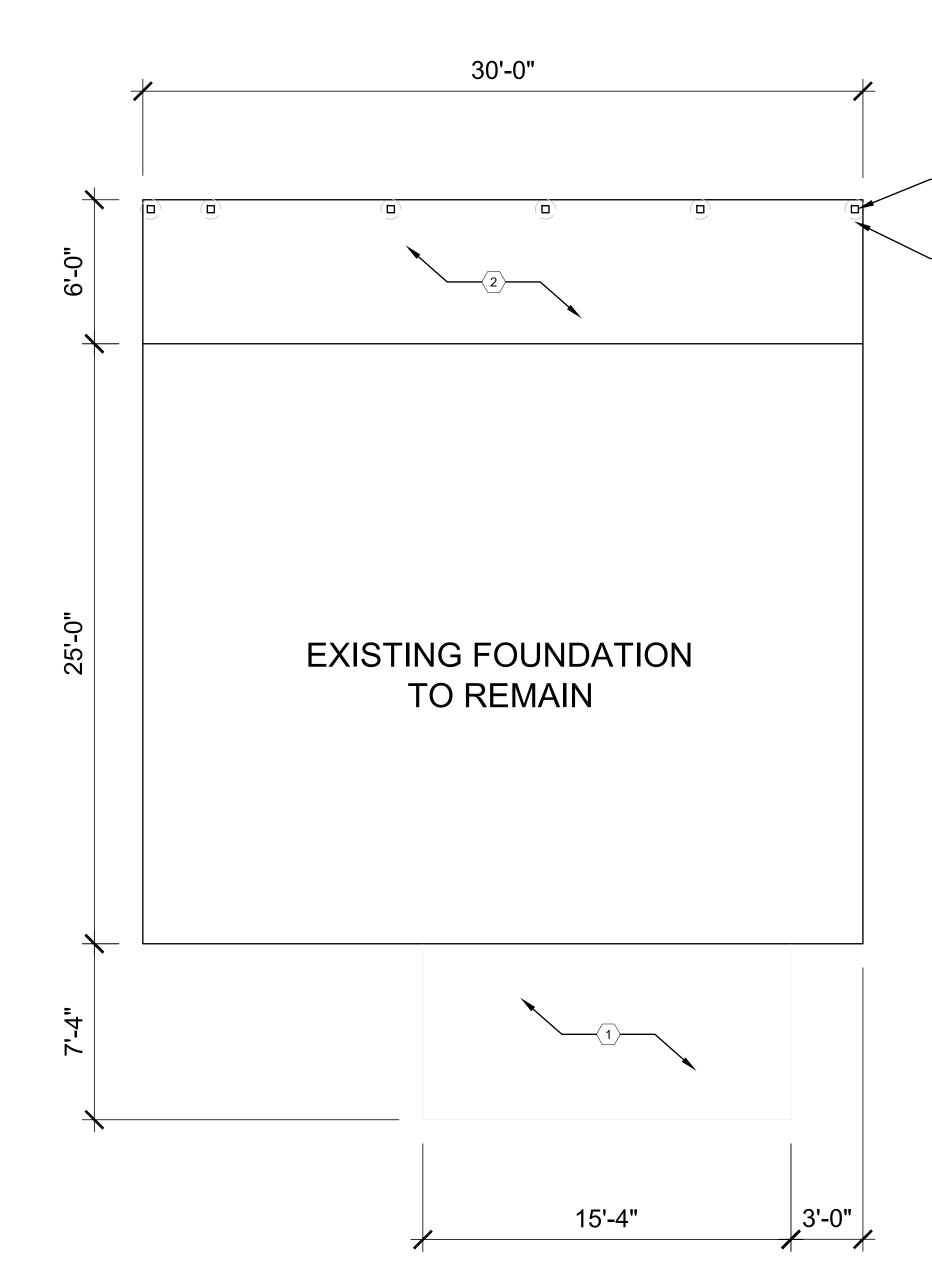
- 1. PAVEMENT SHALL BE OF THE TYPE, THICKNESS AND CROSS SECTION AS INDICATED ON THE PLANS AND AS FOLLOWS:
- 2. CONCRETE: PORTLAND CEMENT TYPE IA (AIR-ENTRAINED) WITH A MINIMUM CEMENT CONTENT OF SIX SACKS PER CUBIC YARD, MINIMUM 28 DAY COMPRESSIVE STRENGTH OF 3,500 PSI AND A SLUMP OF 1 1/2 TO 3 INCHES.
- ASPHALT: BASE COURSE MDOT BITUMINOUS MIXTURE NO. 1100L, 20AA; SURFACE COURSE - MDOT BITUMINOUS MIXTURE NO. 1100T, 20AA; ASPHALT CEMENT PENETRATION GRADE 85-100, BOND COAT - MDOT SS-1H EMULSION AT 0.10 GALLON PER SQUARE YARD; MAXIMUM 2 INCH LIFT.
- PAVEMENT BASE SHALL BE COMPACTED TO 95% OF THE MAXIMUM DENSITY (MODIFIED PROCTOR) PRIOR TO PLACEMENT OF PROPOSED PAVEMENT. EXISTING SUB-BASE SHALL BE PROOF-ROLLED IN THE PRESENCE OF THE ENGINEER TO DETERMINE STABILITY.
- 5. ALL CONCRETE PAVEMENT, DRIVEWAYS, CURB & GUTTER, ETC., SHALL BE SPRAY CURED WITH WHITE MEMBRANE CURING COMPOUND IMMEDIATELY FOLLOWING FINISHING OPERATION.
- ALL CONCRETE PAVEMENT JOINTS SHALL BE FILLED WITH HOT POURED RUBBERIZED ASPHALT JOINT SEALING COMPOUND IMMEDIATELY AFTER SAWCUT OPERATION. FEDERAL SPECIFICATION SS-S164.
- 7. ALL WORKMANSHIP AND MATERIALS SHALL BE IN ACCORDANCE WITH THE CURRENT STANDARDS AND SPECIFICATIONS OF THE MUNICIPALITY AND THE MICHIGAN DEPARTMENT OF TRANSPORTATION STANDARD SPECIFICATIONS FOR CONSTRUCTION, CURRENT EDITION.
- 8. ALL TOP OF CURB ELEVATIONS, AS SHOWN ON THE PLANS, ARE CALCULATED FOR A 6" CONCRETE CURB UNLESS OTHERWISE NOTED.
- 9. ALL SIDEWALK RAMPS, CONFORMING TO PUBLIC ACT NO. 8, 1993, SHALL BE INSTALLED AS INDICATED ON THE PLANS.
- 10. CONSTRUCTION OF A NEW OR RECONSTRUCTED DRIVE APPROACH CONNECTING TO AN EXISTING STATE OR COUNTY ROADWAY SHALL BE ALLOWED ONLY AFTER AN APPROVED PERMIT HAS BEEN SECURED FROM THE AGENCY HAVING JURISDICTION OVER SAID ROADWAY.
- 11. FOR ANY WORK WITHIN THE PUBLIC RIGHT-OF-WAY, THE CONTRACTOR SHALL PAY FOR AND SECURE ALL NECESSARY PERMITS AND LIKEWISE ARRANGE FOR ALL INSPECTION.
- EXISTING TOPSOIL, VEGETATION AND ORGANIC MATERIALS SHALL BE STRIPPED AND REMOVED FROM PROPOSED PAVEMENT AREA PRIOR TO PLACEMENT OF BASE MATERIALS.
- 13. EXPANSION JOINTS SHOULD BE INSTALLED AT THE END OF ALL INTERSECTION RADII.
- 14. SIDEWALK RAMPS, CONFORMING TO PUBLIC ACT NO. 8, 1973, SHALL BE INSTALLED AS SHOWN AT ALL STREET INTERSECTIONS AND AT ALL BARRIER FREE PARKING AREAS AS INDICATED ON THE PLANS.
- 15. ALL PAVEMENT AREAS SHALL BE PROOF-ROLLED UNDER THE SUPERVISION OF A GEOTECHNICAL ENGINEER PRIOR TO THE PLACEMENT OF BASE MATERIALS AND PAVING MATERIALS.
- 16. FILL AREAS SHALL BE MACHINE COMPACTED IN UNIFORM LIFTS NOT EXCEEDING 9 INCHES THICK TO 98% OF THE MAXIMUM DENSITY (MODIFIED PROCTOR) PRIOR TO PLACEMENT OF PROPOSED PAVEMENT.
- 17. ALL LANDSCAPED AREAS TO BE PROVIDED W/ SPRINKLER SYSTEMS FOR 100% COVERAGE.


#### SITE PLAN KEY NOTES: (TYPICAL THIS SHEET ONLY)

- (1) EXISTING BUILDING NOT IN SCOPE
- $\langle 2 \rangle$  EXISTING HOUSE
- $\langle 3 \rangle$  EXISTING GARAGE
- $\langle 4 \rangle$  EXISTING FRONT PORCH
- $\overline{5}$  NEW REAR DECK
- $\overline{6}$  EXISTING CONCRETE PARKING PAD
- $\overline{\langle 7 \rangle}$  NEW WOOD FENCE WITH GATE
- $\left< 8 \right>$  NEW PAVED WALKWAY

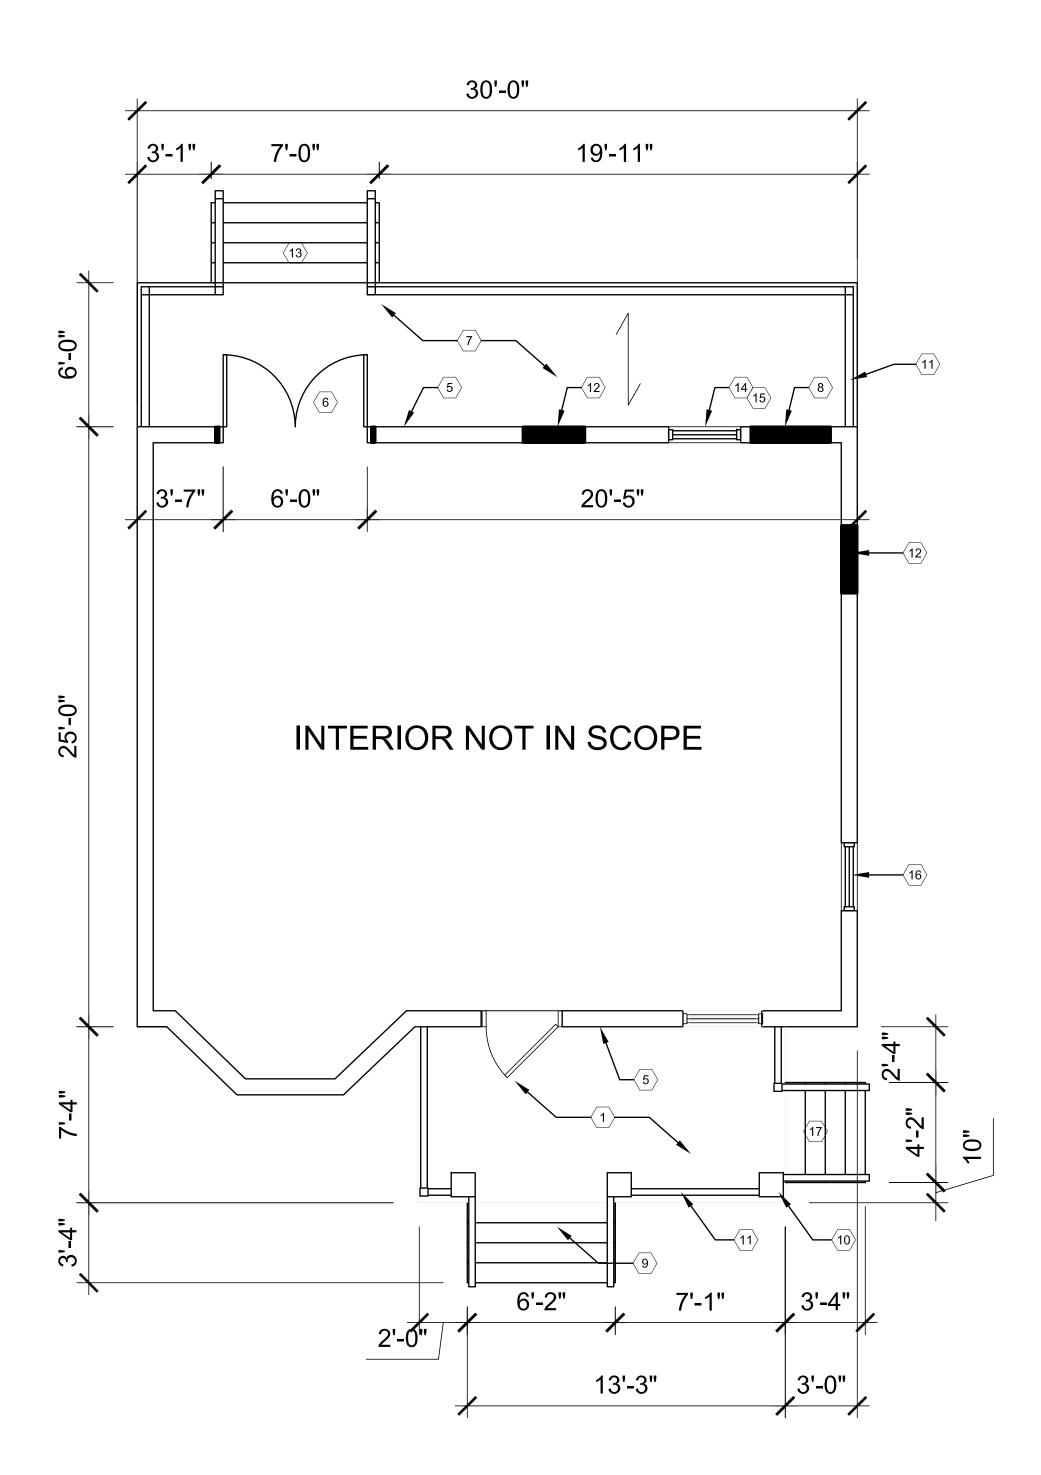



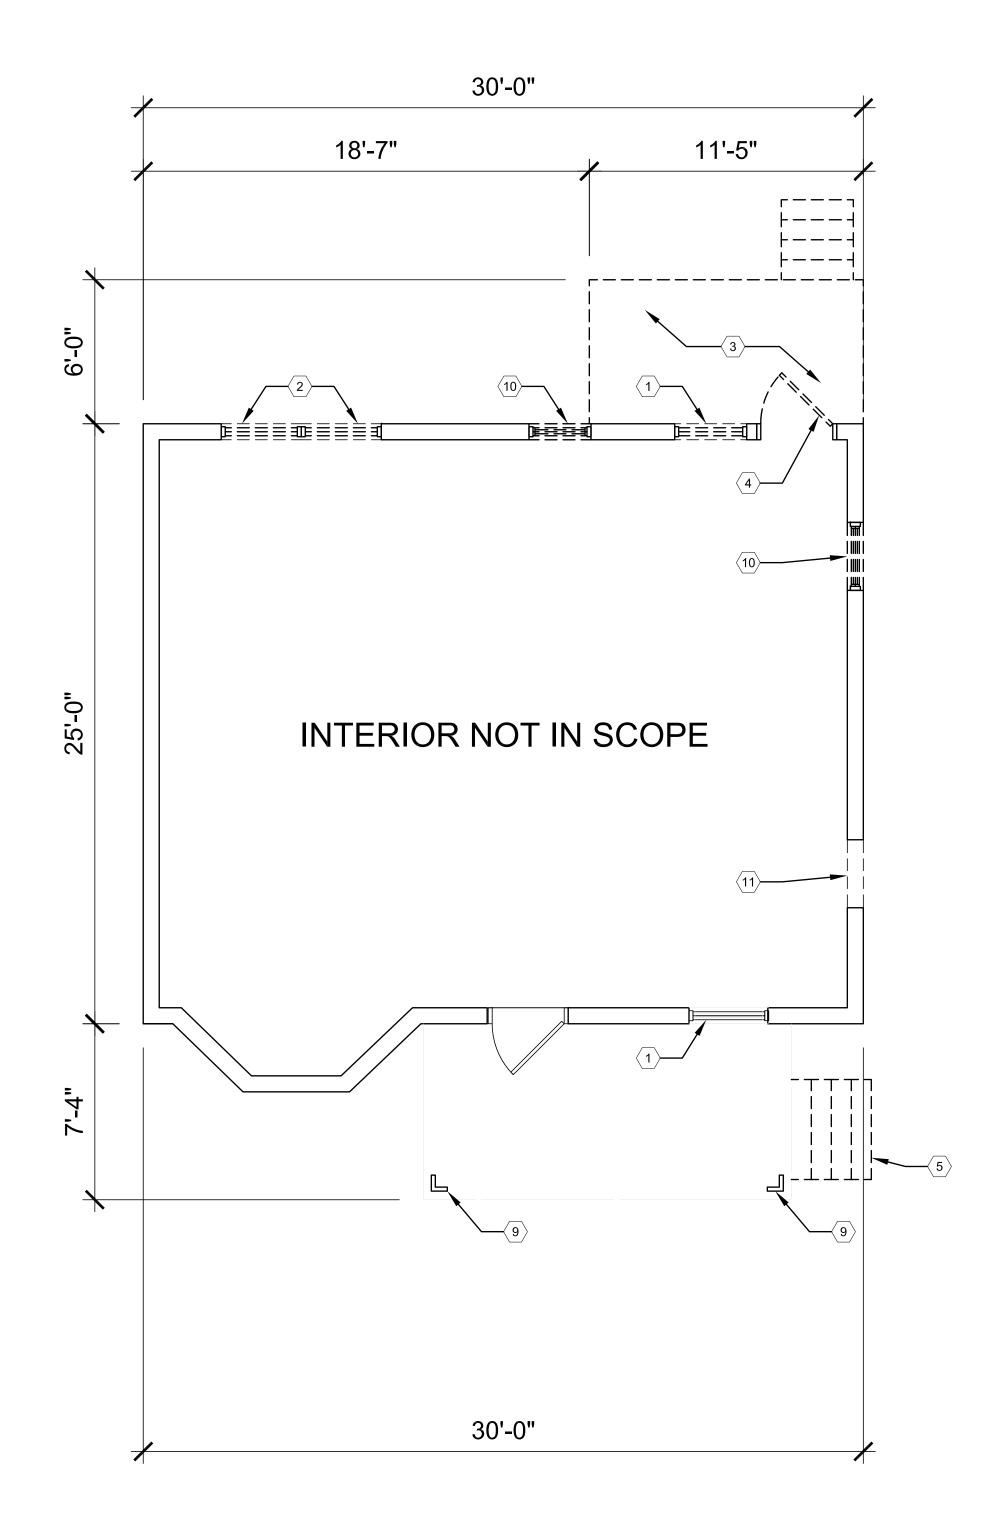

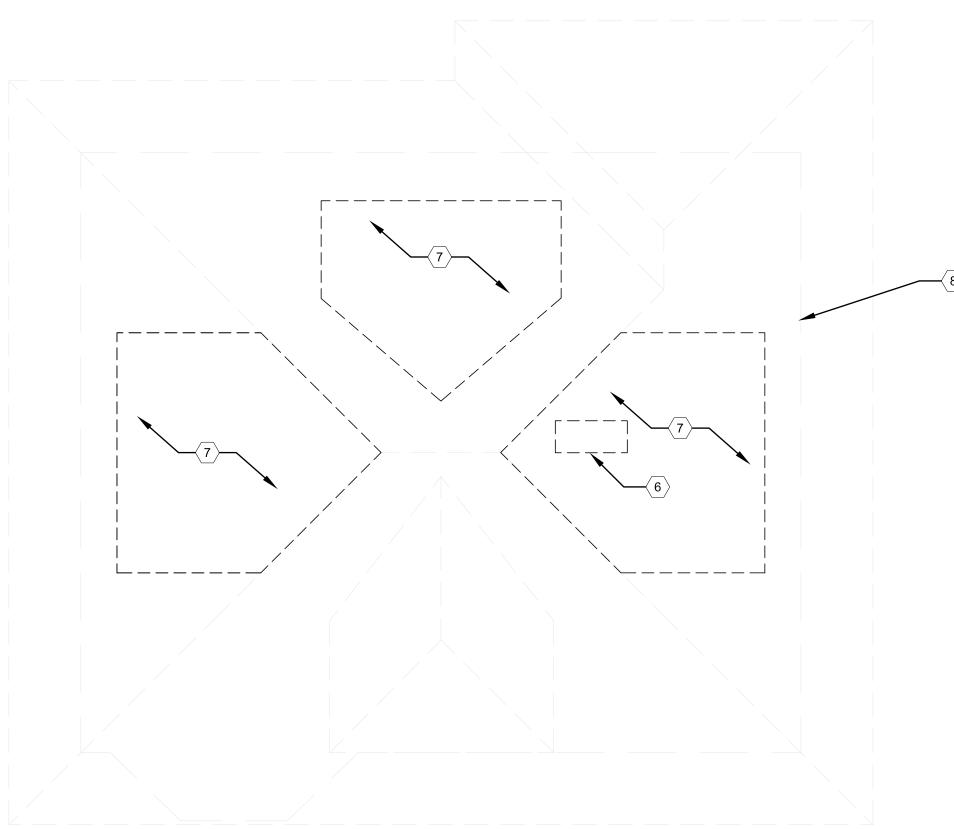



# GENERAL FLOOR PLAN NOTES:

- 1. THIS DRAWING IS DIAGRAMMATIC AND SHOULD BE USED TO DETERMINE THE DESIGN INTENT. THE CONTRACTOR IS RESPONSIBLE FOR THE COMPLETE SET OF WORK AS INDICATED AND SHALL FIELD VERIFY ALL WORK, COORDINATE ALL DRAWINGS / NEW WORK AND SHALL NOTIFY ARCHITECT IMMEDIATELY OF ANY DISCREPANCIES IN THE DOCUMENTS BEFORE PROCEEDING. FAILURE TO DO SO WILL RESULT IN THE CONTRACTOR TAKING FULL RESPONSIBILITY AND LIABILITY FOR SAID DISCREPANCIES.
- 2. ALL DIMENSIONS ARE SHOWN FROM FINISH FACE TO FINISH FACE OF PARTITION UNLESS OTHERWISE NOTED.
- 3. WALL THICKNESS' ARE NOMINAL NOT ACTUAL DIMENSIONS. SEE WALL SCHEDULE FOR ACTUAL DIMENSIONS.
- 4. ALL WORK SHALL BE DONE IN ACCORDANCE WITH ALL LOCAL, STATE, COUNTY CODE REGULATIONS, O.S.H.A., AND THE AMERICAN WITH DISABILITIES ACT (ADA). REFER TO THE CODE PLAN FOR MORE INFORMATION.
- 5. PROVIDE POSITIVE SLOPE TO ALL FLOOR DRAINS WHILE KEEPING FLOOR LEVEL AT WALL BASE CONDITION.


#### DEMO PLAN KEY NOTES:


(TYPICAL THIS SHEET ONLY)

- $\langle 1 \rangle$  WINDOW REMOVED AND REPLACED, SEE ELEVATIONS
- $\langle 2 \rangle$  window removed and replaced with door, see elevations
- $\langle 3 \rangle$  DEMOLISHED EXISTING REAR DECK AND STAIR
- $\langle \overline{4} \rangle$  REMOVED AND INFILLED REAR DOOR, SEE ELEVATIONS
- $\overline{(5)}$  DEMOLISHED & REPLACED EXISTING MASONRY STAIR
- $\langle 6 \rangle$  DEMOLISHED CHIMNEY
- $\langle 7 \rangle$  REMOVED ROOF AS REQ'D FOR NEW DORMER
- $\langle 8 \rangle$  LINE OF WALLS BELOW
- $\langle 9 \rangle$  EXISTING COLUMNS REMOVED, REPLACED (SEE ELEVATIONS)
- $\langle 10 \rangle$  WINDOW REMOVED, WALL INFILLED
- $\langle \overline{11} \rangle$  wall demolished as Req'd for New Window


3

ARCHITECT: 4545 architecture 2761 E. JEFFERSON AVE STE 302 DETROIT, MI 48207 P. 313.454.4545 TIM.FLINTOFF@4545ARCHITECTURE.COM CONSULTANT: Project : 708 PALLISTER HDC RENOVATION Issued for : HDC SUBMIT 02/18/2025 TIMOTHY R. FLINTOFF JR ARCHITECT 30106408 Drawn by : **ANJ** <u>Che</u>ck by : Sheet Title : **DEMO PLANS** Project No. : 2024001 Sheet No. : D1.1

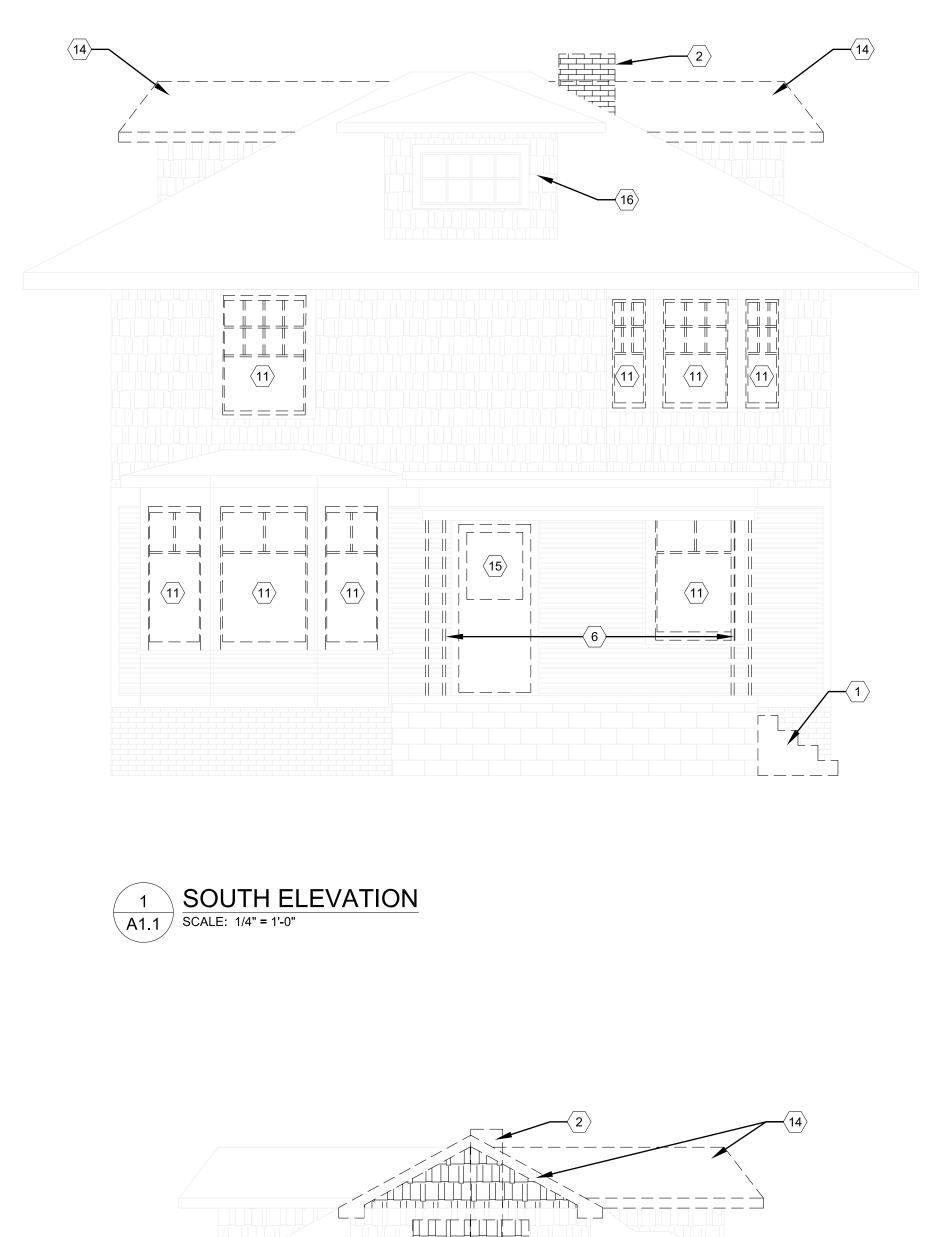

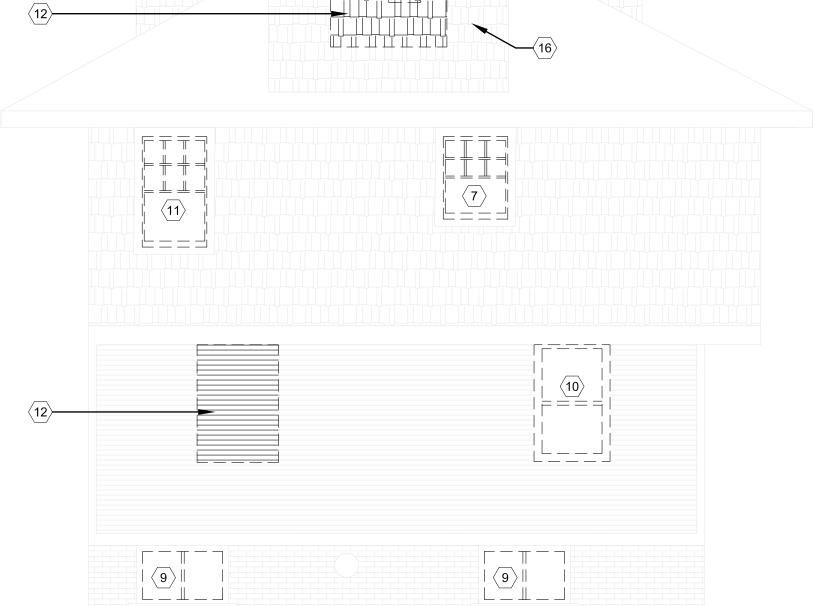



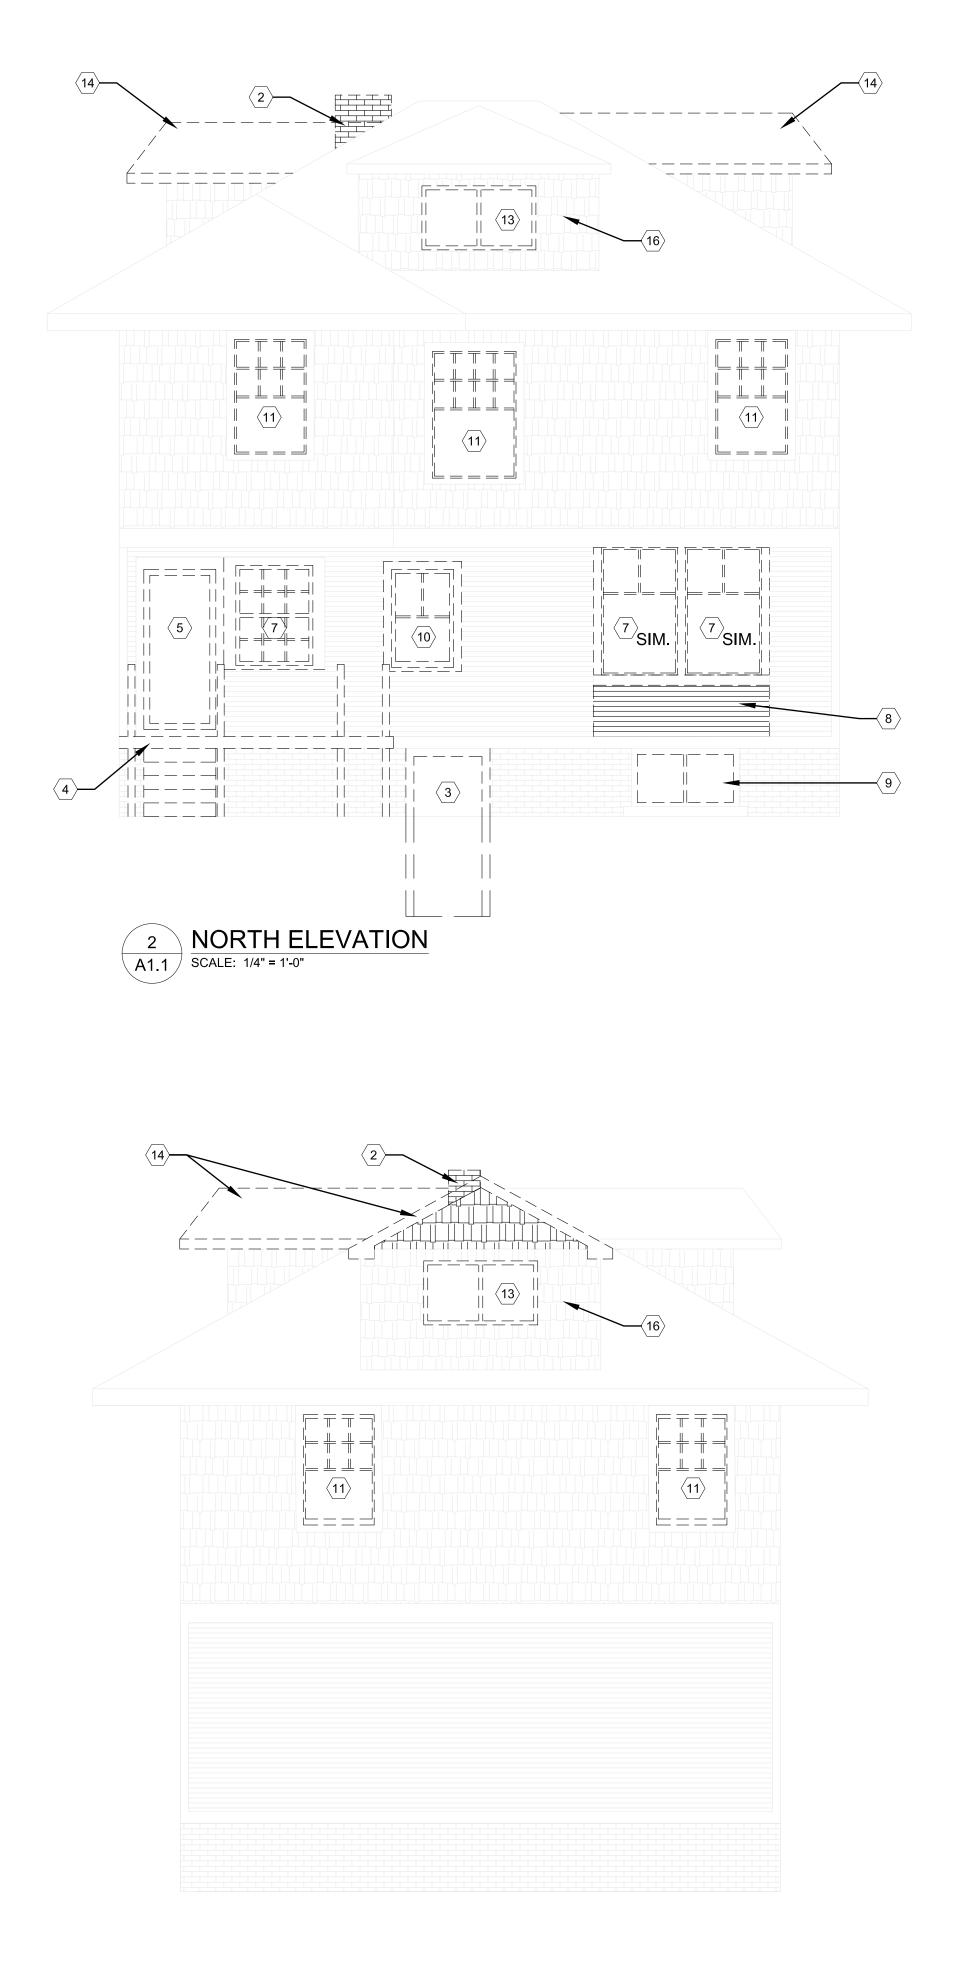




#### **ELEVATION KEY NOTES:**

(TYPICAL THIS SHEET ONLY)

- $\langle 1 \rangle$  MASONRY STAIRS REMOVED, REPLACED
- $\langle 2 \rangle$  CHIMNEY DEMOLISHED
- 3 EXISTING BASEMENT DOOR REMOVED, WALL INFILLED; USE IN-KIND MATERIALS FOR EXTERIOR CLADDING. EARTH TO BE INFILLED
- $\langle 4 \rangle$  REAR DECK AND STAIR DEMOLISHED
- $\overline{(5)}$  door removed, wall infilled; use in-kind materials for exterior cladding
- $\overline{(6)}$  EXISTING COLUMNS TO BE REMOVED AND REPLACED; SHORE ROOF AS REQ'D
- $\langle 7 \rangle$  EXISTING WINDOW REMOVED AND REPLACED, SEE EXTERIOR ELEVATIONS
- $\langle 8 \rangle$  wall removed for New Door, see exterior elevations
- $\langle 9 \rangle$  basement windows removed, replaced with glass block; see exterior elevations
- $\langle 10 \rangle$  WINDOW REMOVED, WALL INFILLED; SEE EXTERIOR ELEVATIONS
- (11) EXISTING SINGLE-HUNG WINDOW REMOVED, REPLACED W/ VINYL-CLAD WOOD SINGLE-HUNG WINDOW (ANDERSON 400 SERIES) (WORK COMPLETED); TO BE PAINTED BLACK
- $\langle \overline{12} \rangle$  wall demolished as Req'd for New Window
- (13) SLIDING WINDOW TO BE REMOVED, REPLACED (SEE EXTERIOR ELEVATIONS)
- $\langle 14 \rangle$  DORMER ROOF TO BE REMOVED, REPLACED (SEE EXTERIOR ELEVATIONS)
- $\langle 15 \rangle$  ENTRY DOOR REMOVED, REPLACED
- $\langle \overline{16} \rangle$  REMOVE INSTALLED COMPOSITE SIDING

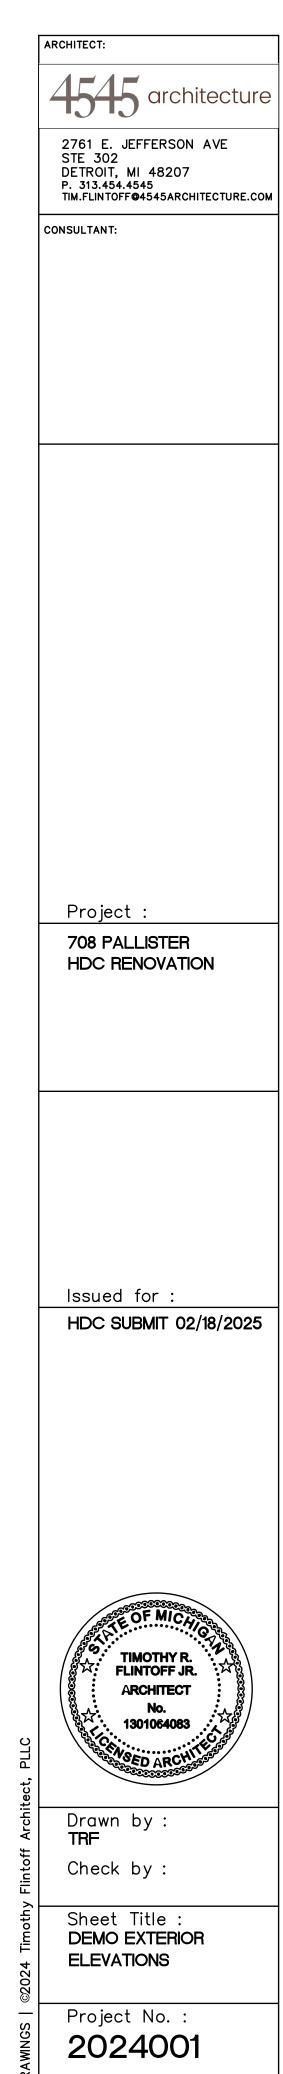

Sheet No. :

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