

HISTORIC DISTRICT COMMISSION APPLICATION FOR WORK APPROVAL

City of Detroit - Planning & Development Department 2 Woodward Avenue, Suite 808 Detroit, Michigan 48226 APPLICATION ID

HDC2025-00024

Dellon	i, Michigan 40220					11002025-000	024	
PROPERTY INFORMATION								
ADDRESS(ES): 14528 Ashton Rd.								
HISTORIC DISTRICT: Rosedale Park								
TIISTONIO DISTNICT. Rosedale Park								
SCOPE OF WORK: (Check ALL that apply)								
	Windows/	Walls/ Siding	Painting	Roof/Gutters/ Chimney	x Po	rch/Deck/Balcony	Other	
	Demolition	Signage	New Building	Addition	(lan	e Improvements adscape, trees, fences ios, etc.)	s,	
Renovation of front porch including: Replace existing wood decking in-kind; replace existing wood railing with metal railing, replace existing wood porch stair in-kind. Reconstruct concrete walkway at the front of the house. Reconstruct concrete driveway between sidewalk and front of house.								
APPLICANT IDENTIFICATION								
TYPI	E OF APPLICANT	: Architect/Engine	er/Consultant					
	IE: Joshua R. Maddo			COMPANY NAME: 4545 Architecture				
ADDRESS: 2761 E. Jefferson Ave. Suite 302			CITY: Detroit		STATE: MI	ZIP: 48207		
PHONE: +1 (313) 670-6377			EMAIL: Josh.maddox@4545architecture.com					
I AC	GREE TO AND	AFFIRM TH	E FOLLOW	ING:				
I understand that the failure to upload all required documentation may result in extended review times for my project and/or a denied application.								
X	I understand that the review of this application by the Historic District Commission does not waive my responsibility to comply with any other applicable ordinances including obtaining appropriate permits (building, sign, etc.) or other department approvals prior to beginning the work.							
X	I hereby certify that the information on this application is true and correct. I certify that the proposed work is authorized by the owner of record and I have been authorized to make this application as the property owner(s) authorized agent.							
010;	— DocuSigned by: Joshua K. Mado 7-18499041854185	lox		01/21/20:	25			
01GI	NATURE			DATE				

NOTE: Based on the scope of work, additional documentation may be required. See www/detroitmi.gov/hdc

for scope-specific requirements.

PROJECT DETAILS - TELL US ABOUT YOUR PROJECT

Instructions: Add project details using the text box in each section. If your details exceed the space provided, attach the details via the attachment icon for that section.

ePLANS PERMIT NUMBER:	N/A	
(only applicable if you've already applied for permits through ePLANS)	IN/A	

GENERAL

1. DESCRIPTION OF EXISTING CONDITION

Please tell us about the current appearance and conditions of the areas you want to change. You may use a few sentences or attach a separate prepared document on the right. (For example, "existing roof on my garage is covered in gray asphalt shingles in poor condition.")



2. PHOTOGRAPHS

Help us understand your project. Please attach photographs of all areas where work is proposed.



3. DESCRIPTION OF PROJECT

In this box, tell us about what you want to do at the areas described above in box #1. (For example, Install new asphalt shingle roofing at garage.)



4. DETAILED SCOPE OF WORK

In this box, please describe all steps necessary to complete the work described in box #3. (For example, "remove existing shingles, replace wood deck as necessary, replace wood eaves, install roof vents, replace rotted fascia boards, paint, clean worksite.")



5. BROCHURES/CUT SHEETS

Please provide information on the products or materials you are proposing to install. For example, a brochure on the brand and color of the shingles proposed.



ADDITIONAL DETAILS					



14528 Ashton Rd., Detroit, MI 48223

RE: 14528 Ashton Rd. Porch Renovations, District Historic Commission Submission

Project Narrative

14528 Ashton Rd. is an existing two-story home in Detroit's Rosedale Park Historic Neighborhood. Constructed in 1926, the home is wood framed with lap siding. The home is square in footprint and features a hipped roof with a front-facing dormer. From the street, a major feature of the home is its front porch spanning across the full width of the house. The porch consists of three brick piers supporting robust square columns and a low-slopped hip roof. The porch surface is currently wood decking, and railings spanning between the brick piers and the porch stairs are also wood. None of the wood elements are finished with any noticeable paint or stain and are in a very worn and deteriorating condition. The owner of the home has contracted CHN Housing solutions to perform accessibility upgrades to the home to suit her needs. These items include reconstruction of the wood stairs, wood decking, installation of new railings, and reconstruction of the existing concrete pedestrian walkway and driveway at the front of the property. No other work on the exterior of the home itself is being proposed as part of this project.

Proposed Work

The proposed work consists of demolition and reconstruction of all existing deteriorated elements of the porch and hardscape that are creating a dangerous condition for the owner.

Beginning with the porch itself, the wood decking, wood handrails, wood stairs, and wood siding on the North and South elevations of the porch will be removed. The decking will be replaced in-kind with 5/4 x 6" wood planks to create a consistent and level walking surface. The wood stairs will be replaced in-kind with new wood stringers, 5/4 wood treads, and wood risers of equal tread depth and riser height to meet code and accessibility requirements. The existing unfinished T1-11 siding at the north and south elevations of the porch will be removed, and new framing/blocking installed as required to support new James Hardie Lap Siding to enclose the area under the porch. This siding, along with the new wood stair and wood decking will be painted B:19, Black, according to Detroit HDC's Color System E Chart.

The existing wood railing will be removed and replaced with a new pre-finished aluminum railing in the same locations as the existing rail, i.e. between the brick piers along the West elevation of the porch, between the brick piers and house along the North and South elevations, and on both sides of the new wood stair. The railing will be



36" tall to meet current code, and will feature intermediate posts, top and bottom rails, and thin vertical balusters. All elements are generally square in profile. The specified manufacturer of the railing is Ultra Fencing-Railing, and the specific product is the Signature Series UAR-200-TR in black.

In addition to the porch work, the existing hardscape in the front of the property will be replaced. The current concrete walk between the porch and sidewalk features a low, awkwardly placed step-up near the sidewalk that poses a tripping hazard to the owner. The proposal is to remove the existing walk and replace it in-kind with a new concrete walk that slopes consistently from the sidewalk elevation up to the bottom of the porch stairs. Width and finish of the new walk will match the old.

The existing driveway along the North property line is currently a "two-track" design from the back of the sidewalk to the rear yard. The differences in surfaces and deteriorated state of the existing concrete pose tripping hazards to the owner. The proposal is to remove the "two-track" driveway between the back of the sidewalk and front (Northwest) corner of the house, and replace it with a full-width concrete driveway The continuous surface will make it much safer for the owner to walk across when coming to and from their vehicle, and make it easier to maintain.



14528 Ashton Rd., Detroit, MI 48223


RE: 14528 Ashton Rd. Porch Renovations, District Historic Commission Submission

Existing Photos



West Elevation



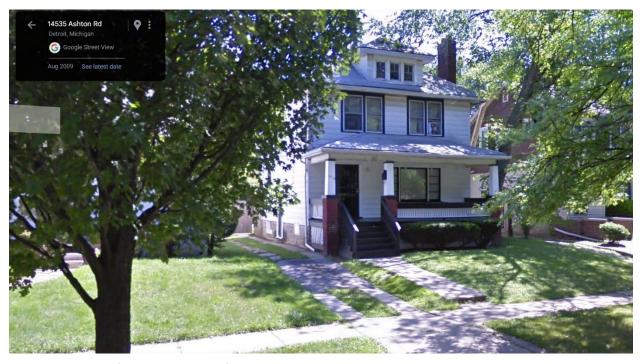

Google Street View from 2009 showing front porch with black stairs and railings, black wood decking, and black and white porch railings.



North Elevation






South Elevation







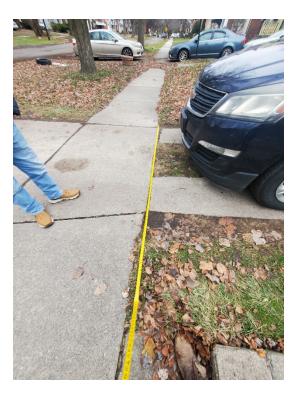



2761 E. Jefferson, Suite 302, Detroit, MI 48207



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RE: 14528 Ashton Rd. Porch Renovations, District Historic Commission Submission

Scope of Work - Front Porch Renovation

- Remove existing wood porch decking and perimeter wood railings
- Remove existing wood stair and railings
- Remove existing T1-11 siding on north and south elevations of porch
- Demolish existing concrete walkway
- Demolish existing "two-track" driveway between back of sidewalk and northwest corner of house
- Install new wood decking on porch
- Construct new wood stair
- Install new James Hardie lap siding at north and south elevations of porch
- Install new prefinished aluminum railings at perimeter of porch and each side of stair
 - o Product: Ulta Fencing-Railing Signature Series UAR-200-TR, black
- Construct new concrete walkway
- Construct new concrete driveway between back od sidewalk and northwest corner of house.



Ultra Signature® Post-To-Post Railing

Components	Post-To-Post		
Square Picket	0.75" Sq. x .050" Thickness		
Top Cap Adams	1.700" H x 1.716" W 0.080" Thickness		
Bottom Rail	1.320" H x 1.352" W 0.070" Thickness		
Boss Screw Posts	2.5" x 2.5" x 0.100" 3.0" x 3.0" x 0.125"		
Spacing Between Pickets	3.625"		
Nominal Panel Length*	4', 5', 6', & 8'		
Heights Available	37' & 43"		
Signature® Columns and	6" Square 0.100" Thickness		
Newel Posts	o Square 0.100" Thickness		



Ultra Aluminum™ Warranty



Ultra Aluminum[™] fencing products are warranted against defects in workmanship and/or materials. The Ultra powder coat finish is guaranteed against cracking, peeling or chipping.

Ultra Aluminum Alloys



Ultra's high strength, aluminum alloy is as strong as steel, but will never rust. Our 6005-T5 alloy has a minimum strength of 35,000 psi.

Environmentally Responsible



Ultra Aluminum™ is proud to use recycled aluminum in our products, and our powder coat coating process is environmentally friendly and virtually pollution-free.

Textured Finishes



Our advanced powder coat finish meets AAMA 2604 allowing us to produce a high-quality, long-lasting finish.











UAR-250-3RS Three Rail with Spears






UAG-200-2R Glass Railing *4' Max Panel

UAG-270-3R Glass Railing *4' Max Panel





Ultra Signature® Post-To-Post Railing

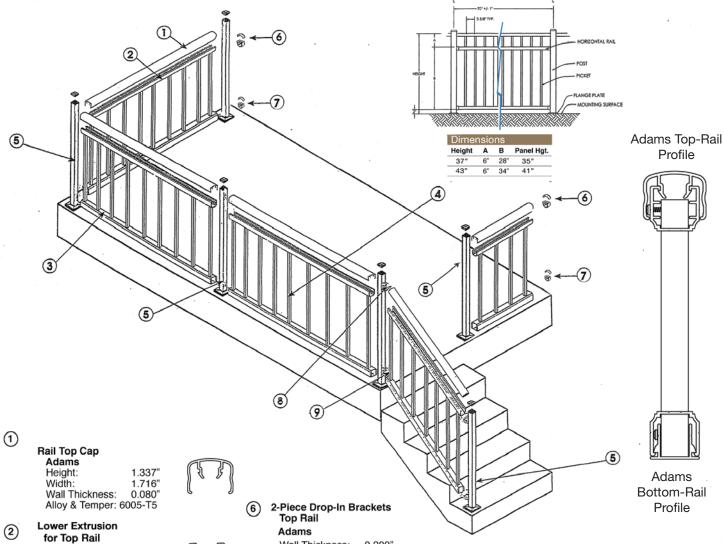

Height: 1.235" Width: 1.352" Wall Thickness: 0.070'Alloy & Temper: 6005-T5

(3) **Bottom Rail**

Height: 1.375" Width: 1.375" Wall Thickness: 0.070" Alloy & Temper: 6005-T5

Square Picket

Wall Thickness: 0.050" Alloy & Temper: 6005-T5

(5) Post

21/2" Sq. x 21/2" Sq. Wall Thickness: 0.100" Alloy & Temper: 6005-T5 3" Sq. x 3" Sq. Wall Thickness:

0.125" Alloy & Temper: 6005-T5 Wall Thickness: 0.200" Alloy & Temper: A-360

(7) 2-Piece Drop-In Brackets **Bottom Rail**

Adams

Wall Thickness: 0.200" Alloy & Temper: A-360

(8) Adjustable Rail End Vertical or Horizontal Top Rail

> Wall Thickness: 0.200" Alloy & Temper: A-360

Adjustable Rail Ends-Vertical or Horizontal **Bottom Rail**

> Wall Thickness: 0.200" Alloy & Temper: A-360





Premium*

*Premium Colors are available at an extra charge and may require additional lead times Ask your Ultra Representative for details.

Visit our website for more information and a copy of the warranty.











FRONT PORCH RECONSTRUCTION CHN HOUSING PARTNERS

14528 ASHTON RD. DETROIT, MI 48223

ARCHITECT
4545 ARCHITECTURE | DESIGN
TIMOTHY FLINTOFF
2761 E. JEFFERSON, SUITE 302
DETROIT, MI 48207

PROJECT DATA

BUILDING CODE AUTHORITY: CITY OF DETROIT

APPLICABLE CODES

BUILDING CODE
ALSO KNOWN AS THE "MICHIGAN RESIDENTIAL BUILDING CODE"
2015 MICHIGAN RESIDENTIAL CODE (MRC) AS AMENDED

BARRIER FREE REQUIREMENTS
AMERICANS WITH DISABILITIES ACT (ADA)
MBC-2015, CHAPTER 11
ICC / ANSI 117.1 - 2010, EXCEPT SECTION 611 & 707


2009 MICHIGAN ACCESSIBILITY CODE

PROJECT DESCRIPTION


THE PROJECT CONSISTS OF DEMOLISHING EXISTING WOOD DECKING, WOOD STAIR, AND WOOD RAILINGS AT THE FRONT PORCH OF 14528 ASHTON RD. THE CURRENT PORCH ELEMENTS HAVE DETERIORATED TO A POINT THAT THEY ARE UNSAFE FOR THE RESIDENT WHO HAS ACCESSIBILITY REQUIREMENTS. NEW WOOD DECKING, A WOOD STAIR MEETING CURRENT RESIDENTIAL CODE AND ADA REQUIREMENTS, AND A NEW METAL RAILING WILL BE INSTALLED. IN ADDITION, THE EXISTING CONCRETE WALK FROM THE SIDEWALK TO THE PORCH STAIR WILL BE DEMOLISHED AND RECONSTRUCTED TO REMOVE A DANGEROUS STEP AT THE SIDEWALK. ALSO, THE EXISTING "2-TRACK" DRIVEWAY WILL BE DEMOLISHED BETWEEN THE SIDEWALK AND THE FRONT CORNER OF THE HOUSE AND WILL BE REPLACED WITH AN 8'-WIDE CONCRETE DRIVEWAY MATCHING THE WIDTH OF THE EXISTING CURB CUT

SHEET INDEX

A1.0 ARCHITECTURAL SITE PLAN AND DETAILS
A1.1 PORCH DEMO AND NEW WORK PLANS
A1.2 PORCH DEMO AND NEW WORK ELEVATIONS AND DETAILS

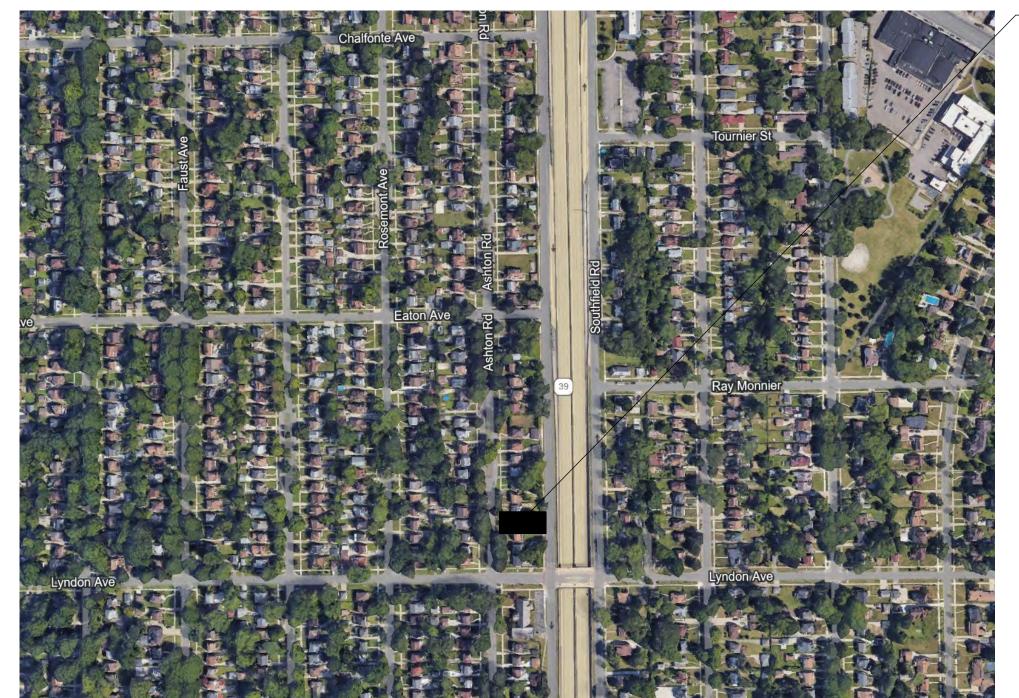

PROJECT LOCATION: 14528 ASHTON RD. DETROIT, MI 48223

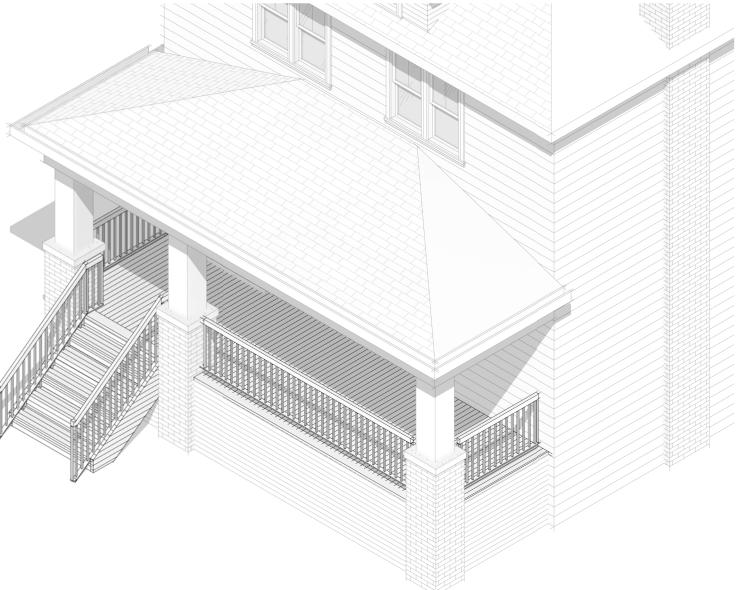

PROJET IMAGE
SCALE:

SYMBOL LEGEND ABBREVIATIONS Acoustical Acoustic Ceiling Tile SUITE 302 DETROIT, MI 48207 **Drawing Navigation Symbols** Above Finish Floor TIM.FLINTOFF@4545ARCHITECTURE.COM ALUM ANOD CONSULTANT: BLK BLKG CEM Control Joint Clean Out COL CONC Concrete Corner Guard CONST Construction "SIM" (If present) means this condition is similar to Continuous CORR Ceramic Tile Dimension DWG ELEV EXG **EXIST** EXP Expansion, Exposed Floor Drain Foundation Fiber Reinforced Panels Keynote Tag - refer to keynotes on that sheet FLR Face Of Wall Tag - refer to Wall Schedule FOS Face of Stud FTG Footing Door Tag - refer to Door Schedule GALV Galvanized GYP Gypsum Window Tag - refer to Window Schedule HDW Hollow Metal Horizontal Name Floor Level Elevation Project Inside Diamtere INSUL CHN HOUSING **PARTNERS** ASHTON RD. FRONT PORCH RENOVATION Long Leg Vertical **14528 ASHTON RD** MAX DETROIT, MI 48223 MECH Mechanical MET Metal Mezzanine Miscellaneous Iron MISC Miscellaneous MO Masonry Opening Outside Diameter OPNG Plate Glass Plate Steel Issued for : **PREFAB** Prefabricated 01/21/2025 Project, Projection Pounds per Square Foot Paint, Point, Pressure Treated Rubber Base Roof Conductor Reflected CEiling Plan Roof Drain Rubber Flooring Reinforced, Reinforcing REQD RFG Roof Sump SCHED SPEC Specification Service Sink STD FLINTOFF JR. STOR ARCHITECT **STRUCT** Structural SUSP SW Symmetrical Top and Bottom TEL TERR Teelephone Tongue and Groove Drawn by Thick, Thickness **THRESThreshold** Checked by Unless Noted Otherwise Vinyl Base Sheet Title: Vinyl Composition Tile TITLE SHEET Vertical WAINS Wainscot WD WIN Wood Window Project No. 2024041 Welded Wire Fabric


2 LOCATION PLAN
SCALE: 1" = 100'-0"

SECTION @ NEW CONC. WALK

SCALE: 1/2" = 1'-0" 5' - 0" +/-EXIST SIDEWALK **ELIMINATE STEP** EXIST. CONC. WALK -


SECTION @ EXIST CONC WALK

SCALE: 1/2" = 1'-0"

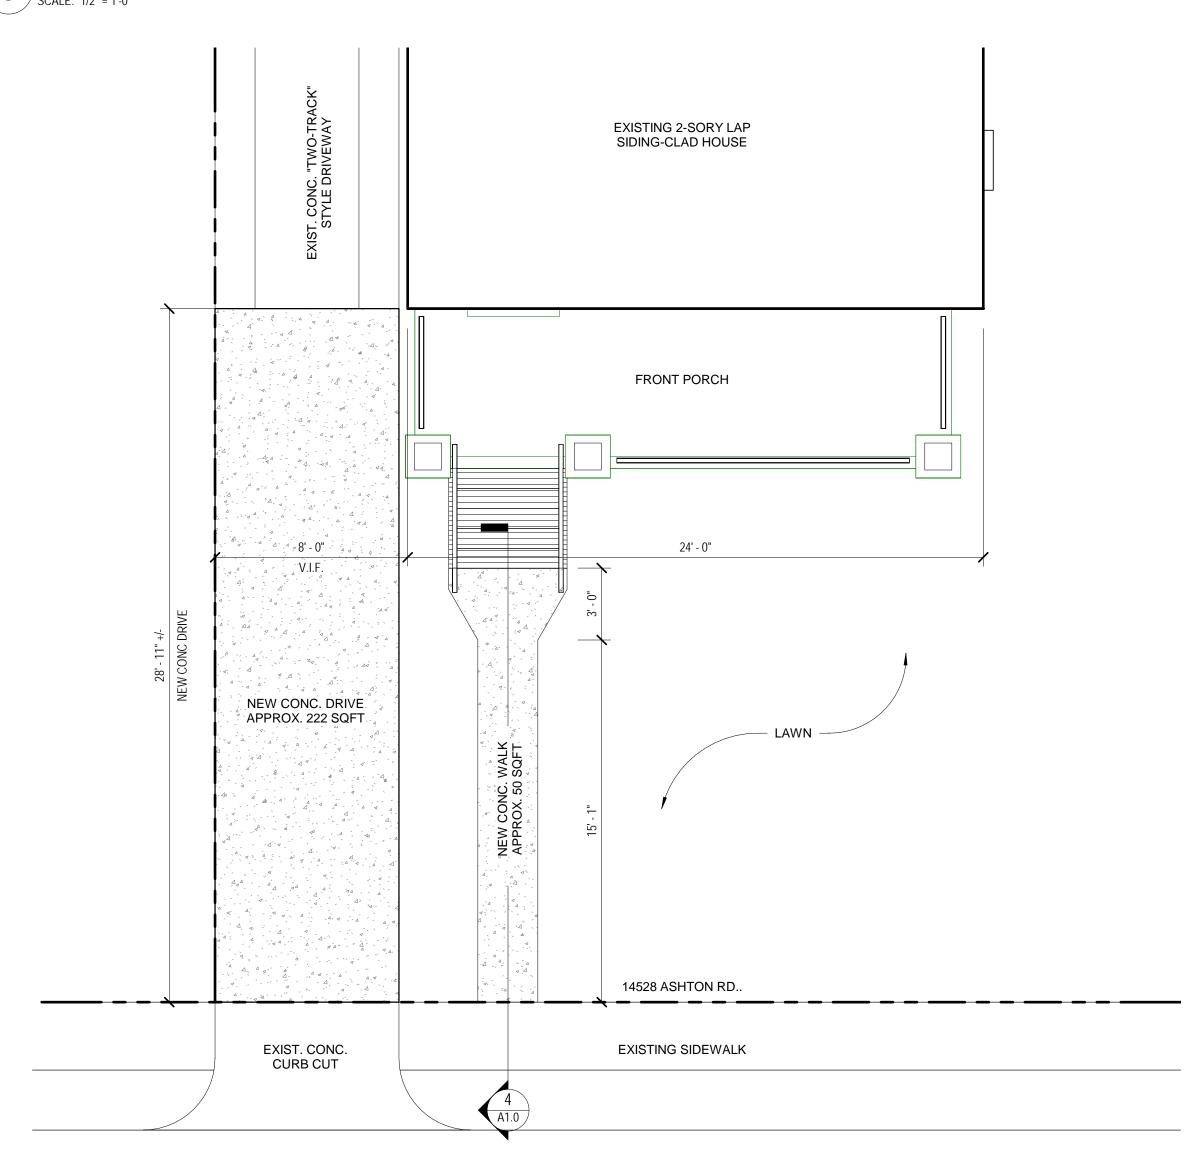

2 ENLARGED ARCHITECTURAL SITE PLAN - NEW WORK

SCALE: 1/4" = 1'-0"

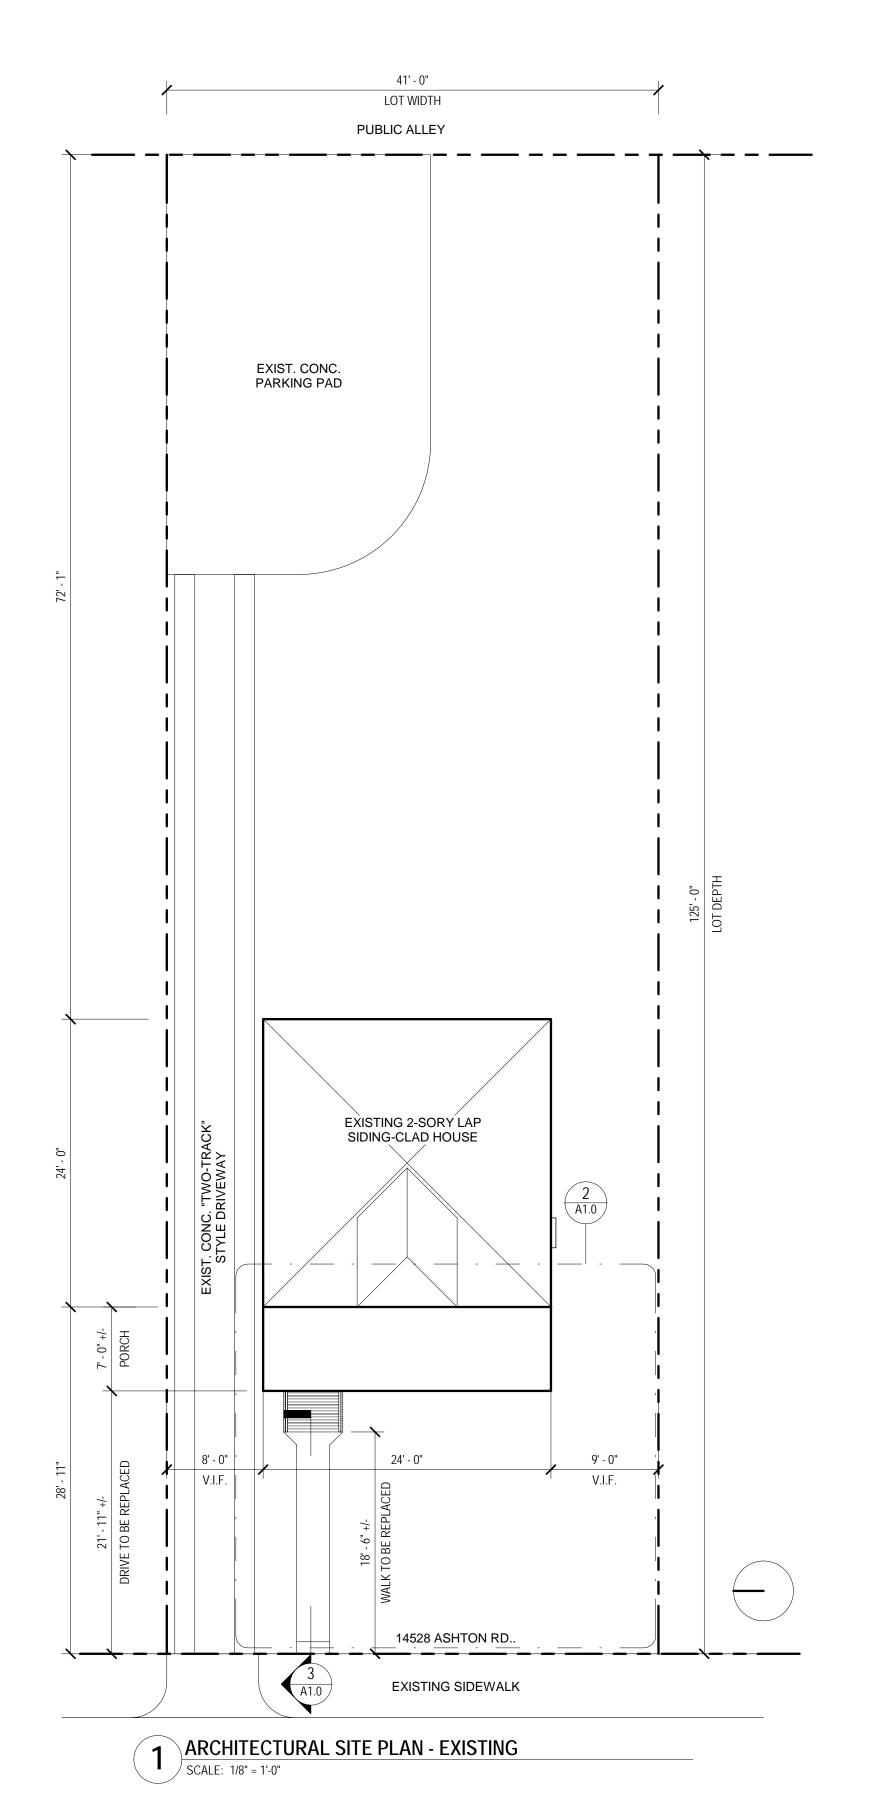

GENERAL NOTES:

- THIS DRAWING IS DIAGRAMMATIC AND SHOULD BE USED TO DETERMINE THE DESIGN INTENT. THE CONTRACTOR IS RESPONSIBLE FOR THE COMPLETE SET OF WORK AS INDICATED AND SHALL FIELD VERIFY ALL WORK, COORDINATE ALL DRAWINGS / NEW WORK AND SHALL NOTIFY ARCHITECT IMMEDIATELY OF ANY DISCREPANCIES IN THE DOCUMENTS BEFORE PROCEEDING. FAILURE TO DO SO WILL RESULT IN THE CONTRACTOR TAKING FULL RESPONSIBILITY AND LIABILITY FOR SAID DISCREPANCIES.
- 2. ALL DIMENSIONS ARE SHOWN FROM FINISH FACE TO FINISH FACE OF PARTITION UNLESS OTHERWISE NOTED.
- WALL THICKNESS' ARE NOMINAL NOT ACTUAL DIMENSIONS. SEE WALL SCHEDULE FOR ACTUAL DIMENSIONS.
- ALL WORK SHALL BE DONE IN ACCORDANCE WITH ALL LOCAL, STATE, COUNTY CODE REGULATIONS, O.S.H.A., AND THE AMERICAN WITH DISABILITIES ACT (ADA). REFER TO THE CODE PLAN FOR MORE INFORMATION.

W ELEVATION OF HOME



- CONC. WALK IS CRACKED AND HEAVING WOOD STAIRS ARE NOT EQUAL RISER
- HEIGHTS
- SETTLING HAS CAUSED TREADS TO NOT BE
- HANDRAILS ARE NOT SECURE

EXISTING CONC. WALK



AWKWARD 5" STEP AT SIDEWALK IS TRIPPING HAZARD

EXISTING "2-TRACK" DRIVEWAY



CONC. IS DETERIORATED
DIFFICULT TO MAINTAIN, ESPECIALLY IN
WINTER

2761 E. JEFFERSON SUITE 302 DETROIT, MI 48207 P. 313.450.4545 TIM.FLINTOFF@4545ARCHITECTURE.COM


CONSULTANT:

Project:

CHN HOUSING **PARTNERS** ASHTON RD. FRONT PORCH RENOVATION 14528 ASHTON RD. DETROIT, MI 48223

Issued for :

01/21/2025

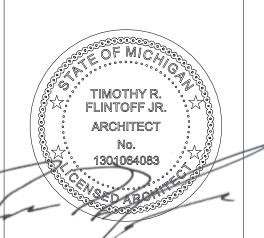

Drawn by:

Checked by:

Sheet Title: ARCHITECTURAL SITE PLAN AND DETAILS

Project No.: 2024041


Sheet No.:

NEW WORK PORCH PLAN

SCALE: 1/2" = 1'-0"

EXISTING PORCH PLAN

SCALE: 1/2" = 1'-0"

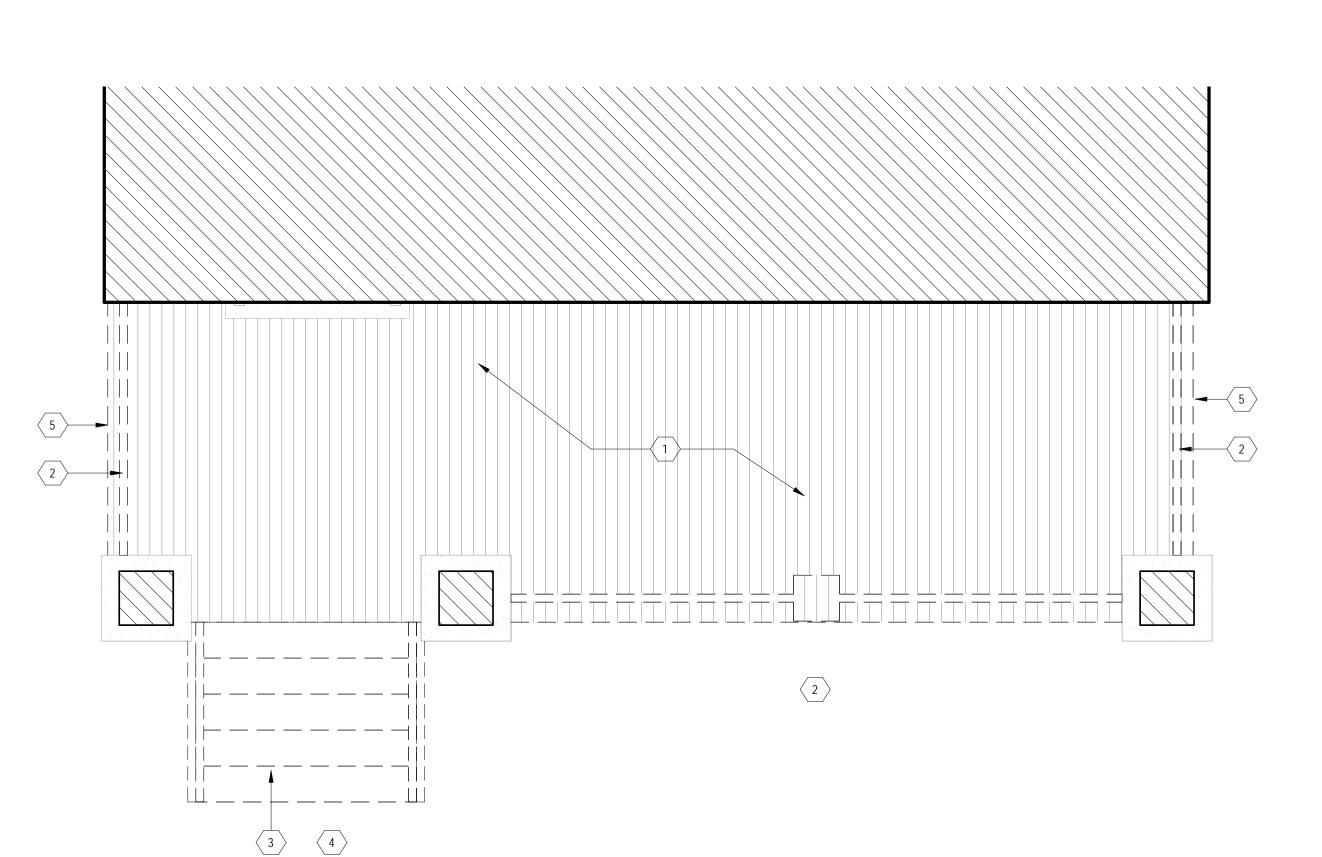

ON PORCH LOOKING SW



- RAILINGS ARE IMPROVISED 2x
- CONSTRUCTION. 30" TALL, NOT TO CODE ALL WOOD IS UNFINISHED/UNPROTECTED AND IS VERY WEATHERED

W ELEVATION OF STAIR



- CONC. WALK IS CRACKED AND HEAVING WOOD STAIRS ARE NOT EQUAL RISER
- HEIGHTS
- SETTLING HAS CAUSED TREADS TO NOT BE
- HANDRAILS ARE NOT SECURE

N ELEVATION OF PORCH AND RAILING



AT 30" TALL, RAILING IS NOT TO CODE UNFINISHED "T1-11" SIDING IS NOT VENTED AND NOT WEATHER RESISTANT

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DEMOLITION KEY NOTES:

(TYPICAL THIS SHEET ONLY)

- (1) REMOVE WOOD PORCH DECKING
- 2 DEMOLISH WOOD RAILING
- DEMOLISH WOOD STAIR AND STRINGERS AND ANY SUPPORT
- 4 DEMOLISH CONC. WALK COMPLETE
- 5 DEMOLISH PLYWOOD PANELING ON PORCH SIDE-WALLS

NEW WORK KEY NOTES:

(TYPICAL THIS SHEET ONLY)

- 1 NEW PT DECK BOARDS ON EXISTING STRUCTURE, PAINT B:19, BLACK
- 2 NEW WOOD STAIR: PT WOOD TREADS AND RISERS ON PT 2x STRINGERS, PAINT B:19, BLACK
- NEW PREFINISHED ALUM RAILING. 36" HIGH. BASES OF DESIGN: ULTRA RAILING SIGNATURE SERIES UAR-200-TR, BLACK
- 4 NEW CONC. WALK. PROVIDE THICKENED SLAB UNDER FIRST STAIR RISER
- INSTALL SIMPSON STRINGER HANGERS AND BASE BRACKETS AS REQ'D
- JAMES HARDIE LAP SIDING W/ 3.5" TRIM ON PT 2x FRAMING TO INFILL OPEN PORCH CRAWLSPACE ENDS. PAINT B:19, BLACK. VENT AS REQ'D.
- 7 SET FIRST DECK BOARD PARALLEL TO FRONT EDGE OF PORCH TO CREATE BORDER

COLOR SYSTEM E CHART UNLESS NOTED OTHERWISE.

(8) LOUVERED WALL-VENTS EA. SIDE, AS REQ'D, PAINT B:19, BLACK NOTE: ALL NEW WOOD ELEMENTS TO BE PAINTED B:19, BLACK BASED ON DETROIT HDC'S Project:

2761 E. JEFFERSON SUITE 302

DETROIT, MI 48207

CONSULTANT:

TIM.FLINTOFF@4545ARCHITECTURE.COM

CHN HOUSING **PARTNERS** ASHTON RD. FRONT PORCH RENOVATION 14528 ASHTON RD. DETROIT, MI 48223

Issued for:

01/21/2025

N ELEVATION OF PORCH AND RAILING



FLINTOFF JR. ARCHITECT

Drawn by:

Checked by:

JRM Sheet Title: PORCH DEMO AND

NEW WORK PLANS

2024041

Project No. :


Sheet No.:

3 NEW WORK PORCH STAIR SECTION
SCALE: 1/2" = 1'-0"



OVERALL NEW WORK SOUTH ELEVATION

SCALE: 3/8" = 1'-0"

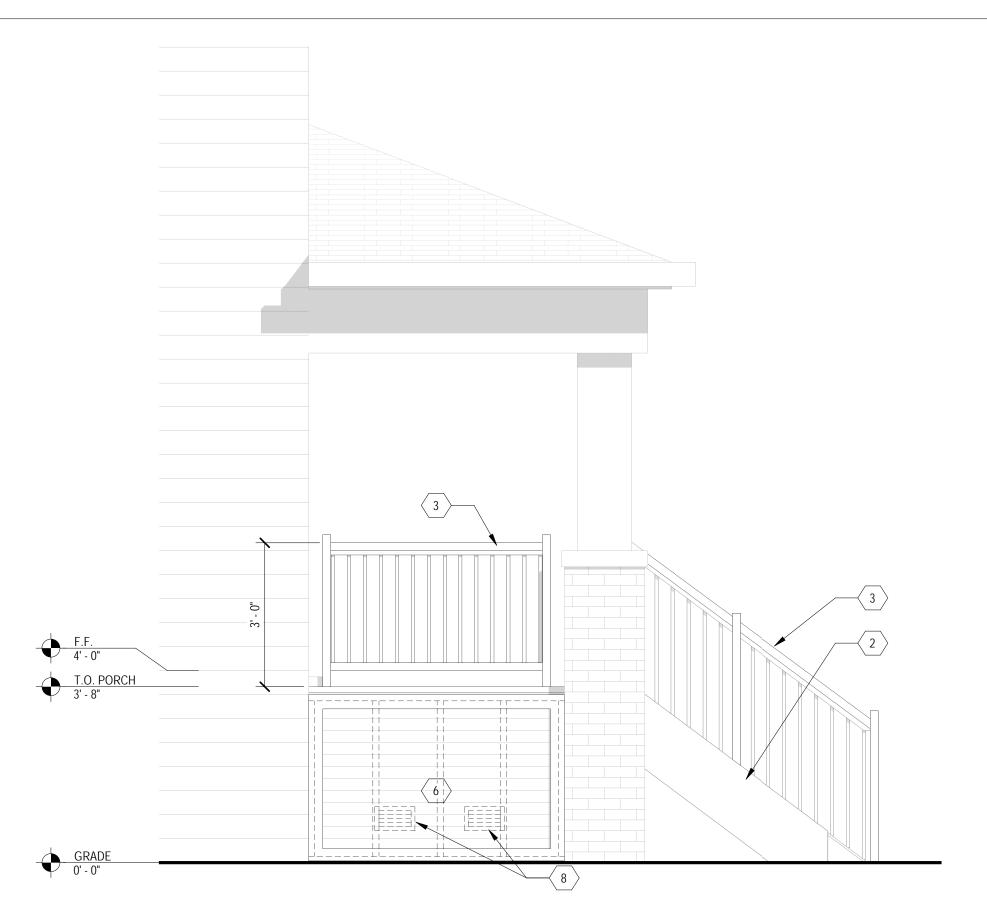

NEW WORK NORTH ELEVATION

SCALE: 1/2" = 1'-0"



OVERALL EXISTING SOUTH ELEVATION

SCALE: 3/8" = 1'-0"

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DEMOLITION KEY NOTES:

(TYPICAL THIS SHEET ONLY)

1 REMOVE WOOD PORCH DECKING

2 DEMOLISH WOOD RAILING

NEW WORK KEY NOTES:

(TYPICAL THIS SHEET ONLY)

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4 NEW CONC. WALK. PROVIDE THICKENED SLAB UNDER FIRST STAIR RISER

INSTALL SIMPSON STRINGER HANGERS AND BASE BRACKETS AS REQ'D

JAMES HARDIE LAP SIDING W/ 3.5" TRIM ON PT 2x FRAMING TO INFILL OPEN PORCH CRAWLSPACE ENDS. PAINT B:19, BLACK. VENT AS REQ'D.

5 SET FIRST DECK BOARD PARALLEL TO FRONT EDGE OF PORCH TO CREATE BORDER

8 LOUVERED WALL-VENTS EA. SIDE, AS REQ'D, PAINT B:19, BLACK

NOTE: ALL NEW WOOD ELEMENTS TO BE PAINTED B:19, BLACK BASED ON DETROIT HDC'S COLOR SYSTEM E CHART UNLESS NOTED OTHERWISE.

DETERMINE THE DESIGN INTENT. THE CONTRACTOR IS RESPONSIBLE FOR THE COMPLETE SET OF WORK AS INDICATED AND SHALL FIELD VERIFY ALL WORK, COORDINATE ALL DRAWINGS / NEW WORK AND SHALL NOTIFY ARCHITECT IMMEDIATELY OF ANY DISCREPANCIES IN THE DOCUMENTS BEFORE PROCEEDING. FAILURE TO DO SO WILL

INFORMATION.

DEMOLISH WOOD STAIR AND STRINGERS AND ANY SUPPORT

4 DEMOLISH CONC. WALK COMPLETE

5 DEMOLISH PLYWOOD PANELING ON PORCH SIDE-WALLS

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