NOTE: Based on the scope of work, additional documentation may be required. See www/detroitmi.gov/hdc for scope-specific requirements.

PROJECT DETAILS – TELL US ABOUT YOUR PROJECT

Instructions: Add project details using the text box in each section. If your details exceed the space provided, attach the details via the attachment icon for that section.

ePLANS PERMIT NUMBER:

(only applicable if you've already applied for permits through ePLANS)

N/A

GENERAL

1. DESCRIPTION OF EXISTING CONDITION

Please tell us about the current appearance and conditions of the areas you want to change. You may use a few sentences or attach a separate prepared document on the right. (For example, "existing roof on my garage is covered in gray asphalt shingles in poor condition.")

New construction single family home with Detached Garage. The property is located at 1760 Wabash, this property was split, the existing home is not in scope. this submission is for a new single family home and detached carriage house and vacant split portion of the property. we are still waiting for an address to be assigned.

2. PHOTOGRAPHS

Help us understand your project. Please attach photographs of all areas where work is proposed.

3. DESCRIPTION OF PROJECT

In this box, tell us about what you want to do at the areas described above in box #1. (For example, Install new asphalt shingle roofing at garage.)

New construction single family home with Detached Garage. The property is located at 1760 Wabash, this property was split, the existing home is not in scope. this submission is for a new single family home and detached carriage house and vacant split portion of the property. we are still waiting for an address to be assigned.

Ø

4. DETAILED SCOPE OF WORK

In this box, please describe all steps necessary to complete the work described in box #3. (For example, "remove existing shingles, replace wood deck as necessary, replace wood eaves, install roof vents, replace rotted fascia boards, paint, clean worksite.")

New construction single family home with Detached Garage. The property is located at 1760 Wabash, this property was split, the existing home is not in scope. this submission is for a new single family home and detached carriage house and vacant split portion of the property. we are still waiting for an address to be assigned.



5. BROCHURES/CUT SHEETS

Please provide information on the products or materials you are proposing to install. For example, a brochure on the brand and color of the shingles proposed.



ADDITIONAL DETAILS

6. WINDOWS/DOORS

Detailed photographs of window(s) and/or door(s) proposed for replacement showing the condition of the interior and exterior of the window(s) and/or door(s)

NEW SINGLE FAMILY HOME AND **CARRIAGE HOUSE 1760 WABASH STREET** SHEET INDEX

DETROIT, MI 48216

OWNER

SHARIF AFFAS 1760 WABASH ST. DETROIT, MI 48216

ARCHITECT

4545 ARCHITECTURE | DESIGN TIMOTHY FLINTOFF 2761 JEFFERSON AVE., SUITE 302 **DETROIT**, **MI 48207**

PROJECT DATA

BUILDING CODE AUTHORITY: CITY OF DETROIT

APPLICABLE CODES:

BUILDING CODE ALSO KNOWN AS THE "MICHIGAN RESIDENTIAL BUILDING CODE" 2015 MICHIGAN RESIDENTIAL BUILDING CODE (MRBC) AS AMENDED

MECHANICAL CODE ALSO KNOWN AS THE "MICHIGAN MECHANICAL CODE" 2015 MICHIGAN MECHANICAL CODE AS AMENDED

PLUMBING CODE ALSO KNOWN AS THE "MICHIGAN PLUMBING CODE" 2018 MICHIGAN PLUMBING CODE AS AMENDED

ELECTRICAL CODE ALSO KNOWN AS THE "MICHIGAN ELECTRICAL CODE" 2018 NATIONAL ELECTRIC CODE (NEC) AS AMENDED & MICHIGAN AMMENDMENTS PART 8.

ENERGY CODE 2015 UNIFORM ENERGY CODE

BARRIER FREE REQUIREMENTS AMERICANS WITH DISABILITIES ACT (ADA) MBC-2015, CHAPTER 11 ICC / ANSI 117.1 - 2010, EXCEPT SECTION 611 & 707

STORIES:

SPRINKLER **BUILDING F**


BUILDING A

STORIES: SPRINKLER **BUILDING H**

PARKING GARAGE: 2 SPACES

ENERGY EFFICIENCY CLIMATE ZONE: 5A

PROJECT LOCATION: 1760 WABASH ST.

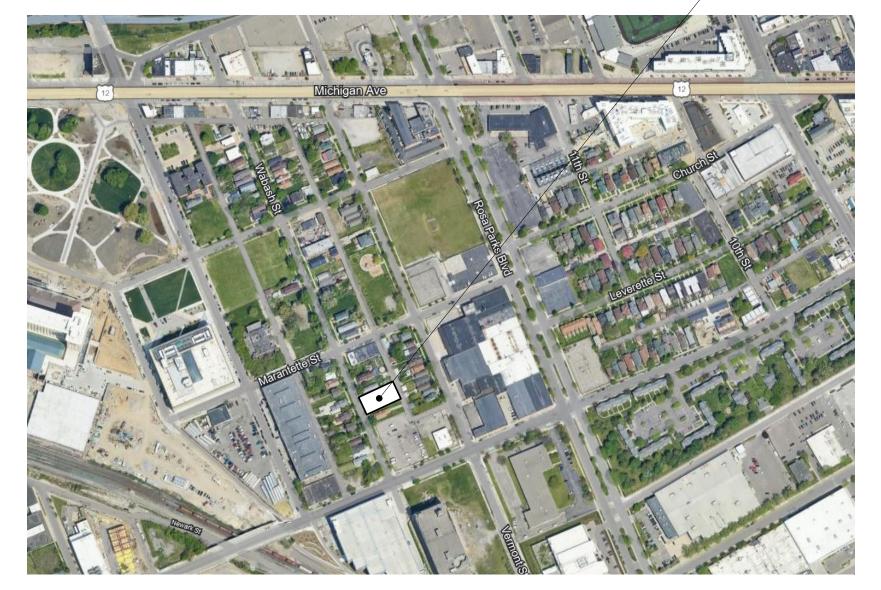

SHEET NUMBER	SHEET NAME
SP1.1	ARCHITECTURAL SITE PLAN
A1.1	HOUSE FLOOR PLANS
A1.2	ACCESSORY DWELLING UNIT FLOOR PLANS
A3.4	EXTERIOR RENDERINGS

PROJECT DESCRIPTION **RESIDENTIAL TWO-FAMILY NEW CONSTRUCTION**

FRONT HOUSE BUILDING DATA:

	2 STORIES			
RED:	NO			
HEIGHTS: FIRST FLOOI SECOND FLO ROOF (MID F ALLOWABLE	DOR	FROM GRADE 2'-0" 13'-6" 24-6" 35'-0"	Ξ	CEILING HEIGHT 10'-0" 9'-0"
AREAS (CONDITI LEVEL	ONED NET):		UNIT	

LEVEL	UNII	
FIRST FLOOR	1300 GSF	
SECOND FLOOR	1200 GSF	
TOTAL BUILDING AREA (CONDITIONED GF	ROSS): 2500 GSF	

CARRIAGE HOUSE BUILDING DATA:

	2 STORIES		
RED:	NO		
HEIGHTS: FIRST FLOOF SECOND FLO ROOF (MID P ALLOWABLE)or Oint)	FROM GRADE 0'-8" 9'-0" 24'-3" 35'-0"	CEILING HEIGHT 8'-0"

BUILDING AREAS (CONDITIONED NET):

LEVEL FIRST FLOOR	UNIT(NET) 625 NSF (UNCONDITIONED)
SECOND FLOOR	625 NSF (LIVABLE/CONDITIONED)
TOTAL BUILDING AREA:	1250 GSF

COMPLY WITH SECTION N102 OF THE 2015 MICHIGAN RESIDENTIAL CODE


CEILING:
WOOD FRAMED WALL:
MASS WALL:
FLOOR:
SLAB:

R-38 R-20 OR R-13(CAVITY)+R5(SHEATHING) R-20/R-17 R-20 OR FILL CAVITY, R-19 MIN. R-10 (2'-0" DEEP)





SYMBOL LEGEND	ABB	REVIATIONS	ARCHITECT:
Drawing Navigation Symbols <u>Elevation Callout</u> $1 \xrightarrow{1}_{1}$ Sheet Number $1 \xrightarrow{1}_{1}$ Drawing Number	@ ACOUST ACT ADJ AFF ALUM ANOD BD BLDG BLK BLKG CEM CJ CLG CL CO	At Acoustical Acoustic Ceiling Tile Adjacent Above Finish Floor Aluminum Anodized Board Building Block Blocking Cement Control Joint Ceiling Centerline Clean Out	2761 E. JEFFERSON AVE. SUITE 302 DETROIT, MI 48207 P. 313.450.4545 TIM.FLINTOFF@4545ARCHITECTURE.COM CONSULTANT:
Section CalloutImage: Simple of the drawing referenced. Drawing Number Sheet NumberDetail Callout Image: Simple of the drawing referenced. Drawing Number Sheet NumberImage: Detail Callout Image: Simple of the drawing referenced. Drawing Number Sheet NumberImage: Detail Callout Image: Simple of the drawing referenced. Drawing Number Sheet NumberImage: Detail Callout Image: Simple of the drawing referenced. Drawing Number Sheet NumberImage: Detail Callout Image: Detail Callout Image: Simple of the drawing referenced. Drawing Number Sheet NumberImage: Detail Callout Image: Detail Callout <br< th=""><th>COL CONC CG CONST CONT CORR CPT CT DET DIA DM DN DO DR DWG EA ELEV EW EXG EXIST EXP FD FDN FRP FIN FLR FO FOS FR FTG FV GA GALV GYP HDW</th><th>Column Concrete Corner Guard Construction Continuous Corrugated Carpet Ceramic Tile Detail Diameter Dimension Down Door Opening Door Drawing Each Elevation Each Way Existing Existing Existing Existing Existing Expansion, Exposed Floor Drain Foundation Fiber Reinforced Panels Finish Floor Face Of Face of Stud Frame Footing Field Verify Gauge Galvanized Gypsum Hardware</br></br></br></br></th><th></th></br<>	COL CONC CG CONST CONT CORR CPT CT DET DIA DM DN DO DR DWG EA ELEV EW EXG EXIST EXP FD FDN FRP FIN FLR FO FOS FR FTG FV GA GALV GYP HDW	Column Concrete Corner Guard Construction Continuous 	
Neme Elevation Flor Level Elevation	HM HORIZ HT ID INSUL INT JT LAV LG LLO LLV MAX MECH MET MEZZ MI MIN MISC MO NIC NTS OC OD OPNG OPP PLG PLS PLAM PLAS PREFAB PROJ PSF PT	Hollow Metal Horizontal Height Inside Diamtere Insulation Interior Joint Lavatory Long Long Leg Outstanding Long Leg Vertical Maximum Mechanical Metal Mezzanine Miscellaneous Iron Minimum Miscellaneous Iron Minimum Miscellaneous Masonry Opening Not In Contract Not To Scale On Center Outside Diameter Opening Opposite Plate Glass Plate Steel Plastic Laminate Plaster Prefabricated Project, Projection Pounds per Square Foot	Project : NEW SINGLE FAMILY HOME AND CARRIAGE HOUSE 1760 WABASH STREET, DETROIT, MI 48216
	PI R RA RB RC RCP RD RF REINF REQD RFG RM RS RT SAN SCHED SHT SIM SPEC SS STL STD STOR STRUCT SUSP SW SYM T T&B TEL TERR T&G	Paint, Point, Pressure Treated Riser Return Air Rubber Base Roof Conductor Reflected CEiling Plan Roof Drain Rubber Flooring Reinforced, Reinforcing Required Roofing Room Roof Sump Rubber Tile Sanitary Schedule Sheet Similar Specification Service Sink Steel Standard Storage Structural Suspended Switch Symmetrical Tread Top and Bottom Teelephone Terrazzo Tongue and Groove	or construction
	T&G THK THRESThre TOS TYP U/C UNO VB VCT VIF W VERT WAINS Wait WC WD WIN WT WWF	Thick, Thickness eshold Top Of STeel Typical Undercut Unless Noted Otherwise Vinyl Base Vinyl Composition Tile Verify In Field Wide Vertical	Drawn by : JRM Checked by : JRM Sheet Title : TITLE SHEET Project No. : 2024015 Sheet No. : Sheet No. : TTSL 1

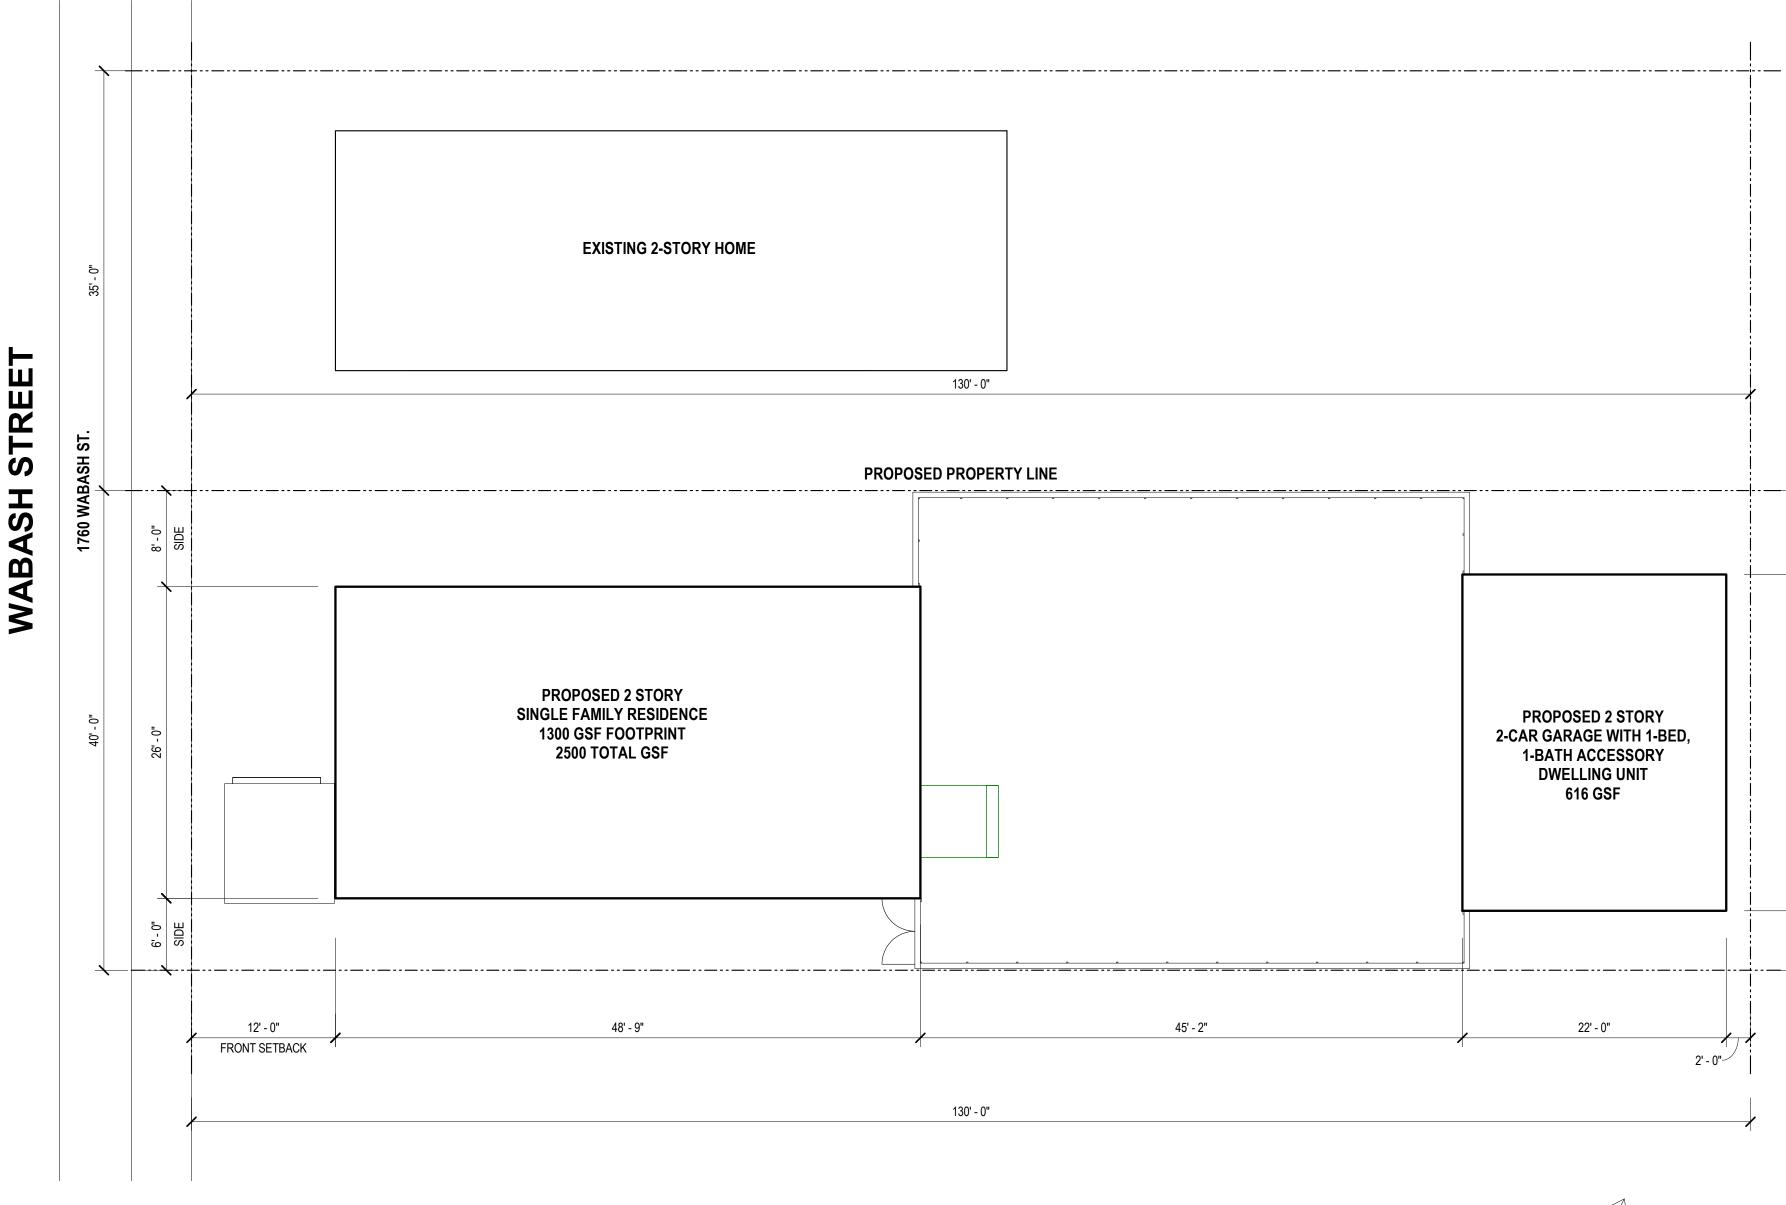



ARCHITECTURAL SITE PLAN / SCALE: 1/8" = 1'-0"

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SITE PLAN GENERAL NOTES:

- PAVEMENT SHALL BE OF THE TYPE, THICKNESS AND CROSS SECTION 1 AS INDICATED ON THE PLANS AND AS FOLLOWS:
- 2. CONCRETE: PORTLAND CEMENT TYPE IA (AIR-ENTRAINED) WITH A MINIMUM CEMENT CONTENT OF SIX SACKS PER CUBIC YARD, MINIMUM 28 DAY COMPRESSIVE STRENGTH OF 3,500 PSI AND A SLUMP OF 1 1/2 TO 3 INCHES.
- ASPHALT: BASE COURSE MDOT BITUMINOUS MIXTURE NO. 1100L, 3. 20AA; SURFACE COURSE - MDOT BITUMINOUS MIXTURE NO. 1100T, 20AA; ASPHALT CEMENT PENETRATION GRADE 85-100, BOND COAT -MDOT SS-1H EMULSION AT 0.10 GALLON PER SQUARE YARD; MAXIMUM 2 INCH LIFT.
- 4. PAVEMENT BASE SHALL BE COMPACTED TO 95% OF THE MAXIMUM DENSITY (MODIFIED PROCTOR) PRIOR TO PLACEMENT OF PROPOSED PAVEMENT. EXISTING SUB-BASE SHALL BE PROOF-ROLLED IN THE PRESENCE OF THE ENGINEER TO DETERMINE STABILITY.
- 5. ALL CONCRETE PAVEMENT, DRIVEWAYS, CURB & GUTTER, ETC., SHALL BE SPRAY CURED WITH WHITE MEMBRANE CURING COMPOUND IMMEDIATELY FOLLOWING FINISHING OPERATION.
- 6. ALL CONCRETE PAVEMENT JOINTS SHALL BE FILLED WITH HOT POURED RUBBERIZED ASPHALT JOINT SEALING COMPOUND IMMEDIATELY AFTER SAWCUT OPERATION. FEDERAL SPECIFICATION SS-S164.
- ALL WORKMANSHIP AND MATERIALS SHALL BE IN ACCORDANCE WITH 7. THE CURRENT STANDARDS AND SPECIFICATIONS OF THE MUNICIPALITY AND THE MICHIGAN DEPARTMENT OF TRANSPORTATION STANDARD SPECIFICATIONS FOR CONSTRUCTION, CURRENT EDITION.
- ALL TOP OF CURB ELEVATIONS, AS SHOWN ON THE PLANS, ARE 8. CALCULATED FOR A 6" CONCRETE CURB UNLESS OTHERWISE NOTED.
- ALL SIDEWALK RAMPS, CONFORMING TO PUBLIC ACT NO. 8, 1993, 9. SHALL BE INSTALLED AS INDICATED ON THE PLANS.
- 10. CONSTRUCTION OF A NEW OR RECONSTRUCTED DRIVE APPROACH CONNECTING TO AN EXISTING STATE OR COUNTY ROADWAY SHALL BE ALLOWED ONLY AFTER AN APPROVED PERMIT HAS BEEN SECURED FROM THE AGENCY HAVING JURISDICTION OVER SAID ROADWAY.
- 11. FOR ANY WORK WITHIN THE PUBLIC RIGHT-OF-WAY, THE CONTRACTOR SHALL PAY FOR AND SECURE ALL NECESSARY PERMITS AND LIKEWISE ARRANGE FOR ALL INSPECTION.
- 12. EXISTING TOPSOIL, VEGETATION AND ORGANIC MATERIALS SHALL BE STRIPPED AND REMOVED FROM PROPOSED PAVEMENT AREA PRIOR TO PLACEMENT OF BASE MATERIALS.
- 13. EXPANSION JOINTS SHOULD BE INSTALLED AT THE END OF ALL INTERSECTION RADII.
- SIDEWALK RAMPS, CONFORMING TO PUBLIC ACT NO. 8, 1973, SHALL 14. BE INSTALLED AS SHOWN AT ALL STREET INTERSECTIONS AND AT ALL BARRIER FREE PARKING AREAS AS INDICATED ON THE PLANS.
- 15. ALL PAVEMENT AREAS SHALL BE PROOF-ROLLED UNDER THE SUPERVISION OF A GEOTECHNICAL ENGINEER PRIOR TO THE PLACEMENT OF BASE MATERIALS AND PAVING MATERIALS.
- FILL AREAS SHALL BE MACHINE COMPACTED IN UNIFORM LIFTS NOT 16. EXCEEDING 9 INCHES THICK TO 98% OF THE MAXIMUM DENSITY (MODIFIED PROCTOR) PRIOR TO PLACEMENT OF PROPOSED PAVEMENT.

4545 architecture 2761 E. JEFFERSON AVE. SUITE 302 DETROIT, MI 48207 P. 313.450.4545 TIM.FLINTOFF@4545ARCHITECTURE.COM CONSULTANT: Project : NEW SINGLE FAMILY HOME AND CARRIAGE HOUSE 1760 WABASH STREET, DETROIT, MI 48216 Issued for : HDC 08/19/2024 NOTFOR CONSTRUCTION Drawn by : JRM Checked by :

JRM

PLAN

Sheet Title :


Project No. : 2024015

Sheet No.


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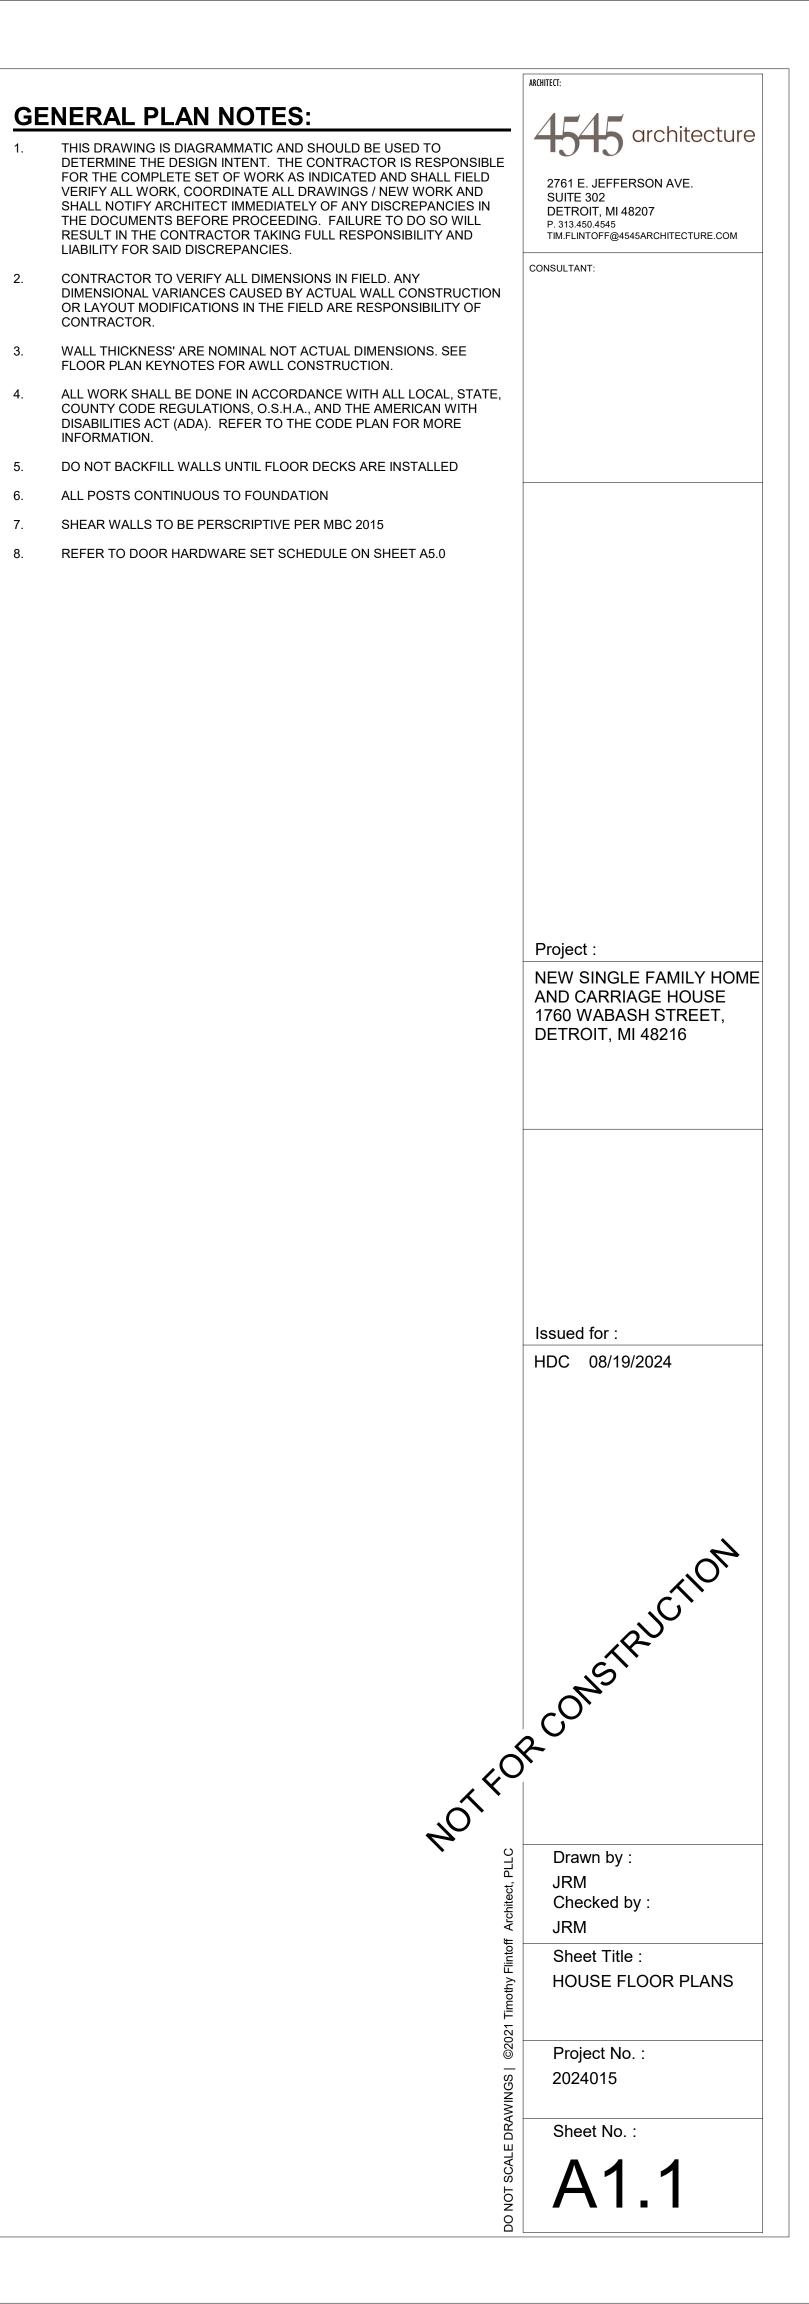
ARCHITECTURAL SITE

ARCHITECT:

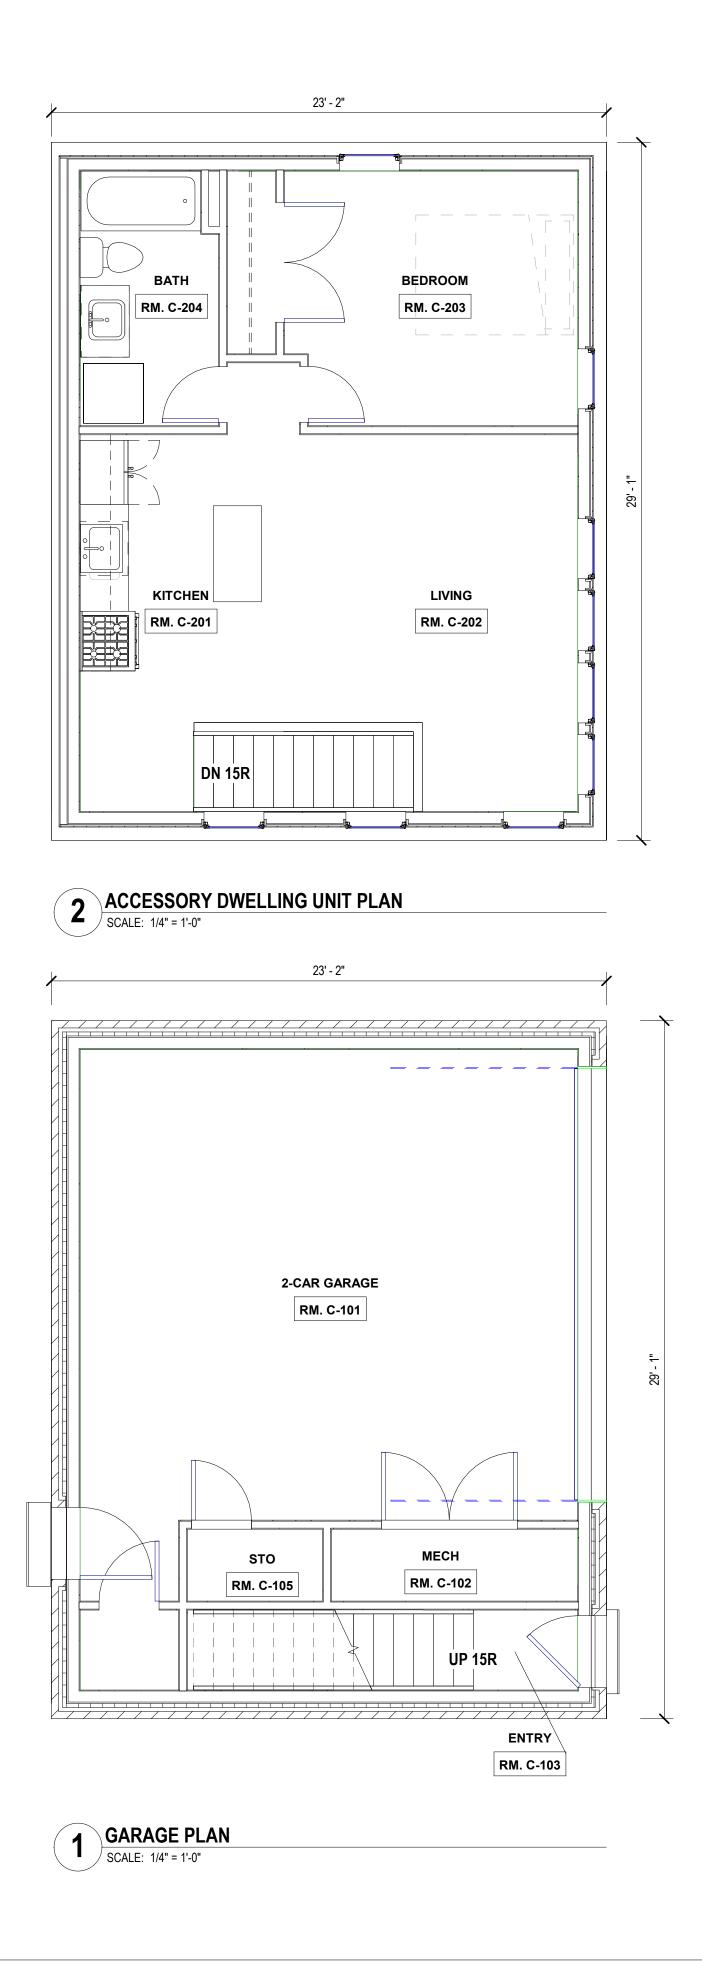

GE	NERAL PLAN NOTES:	
1.	THIS DRAWING IS DIAGRAMMATIC AND SHOULD BE USED TO DETERMINE THE DESIGN INTENT. THE CONTRACTOR IS RESPONSIBLE FOR THE COMPLETE SET OF WORK AS INDICATED AND SHALL FIELD VERIFY ALL WORK, COORDINATE ALL DRAWINGS / NEW WORK AND SHALL NOTIFY ARCHITECT IMMEDIATELY OF ANY DISCREPANCIES IN THE DOCUMENTS BEFORE PROCEEDING. FAILURE TO DO SO WILL	3011 W. GRAND BLVD SUITE 400 DETROIT, MI 48202 P. 313.450.4545
2.	RESULT IN THE CONTRACTOR TAKING FULL RESPONSIBILITY AND LIABILITY FOR SAID DISCREPANCIES. CONTRACTOR TO VERIFY ALL DIMENSIONS IN FIELD. ANY DIMENSIONAL VARIANCES CAUSED BY ACTUAL WALL CONSTRUCTION	TIM.FLINTOFF@4545ARCHITECTURE.COM
3.	OR LAYOUT MODIFICATIONS IN THE FIELD ARE RESPONSIBILITY OF CONTRACTOR. WALL THICKNESS' ARE NOMINAL NOT ACTUAL DIMENSIONS. SEE	
4.	FLOOR PLAN KEYNOTES FOR AWLL CONSTRUCTION. ALL WORK SHALL BE DONE IN ACCORDANCE WITH ALL LOCAL, STATE, COUNTY CODE REGULATIONS, O.S.H.A., AND THE AMERICAN WITH DISABILITIES ACT (ADA). REFER TO THE CODE PLAN FOR MORE INFORMATION.	
5.	DO NOT BACKFILL WALLS UNTIL FLOOR DECKS ARE INSTALLED	
6. 7.	ALL POSTS CONTINUOUS TO FOUNDATION SHEAR WALLS TO BE PERSCRIPTIVE PER MBC 2015	
8.	REFER TO DOOR HARDWARE SET SCHEDULE ON SHEET A5.0	
		Project : NEW SINGLE FAMILY HOME AND CARRIAGE HOUSE 1760 WABASH STREET, DETROIT, MI 48216
		Issued for : HDC 08/19/2024
		Drawn by :
	DO NOT SCALE DRAWINGS @2021 Timothy Flintoff Architect, PLLC	Drawn by : JRM Checked by : JRM Sheet Title : ACCESSORY DWELLING UNIT FLOOR PLANS Project No. : 2024015 Sheet No. : A1.2



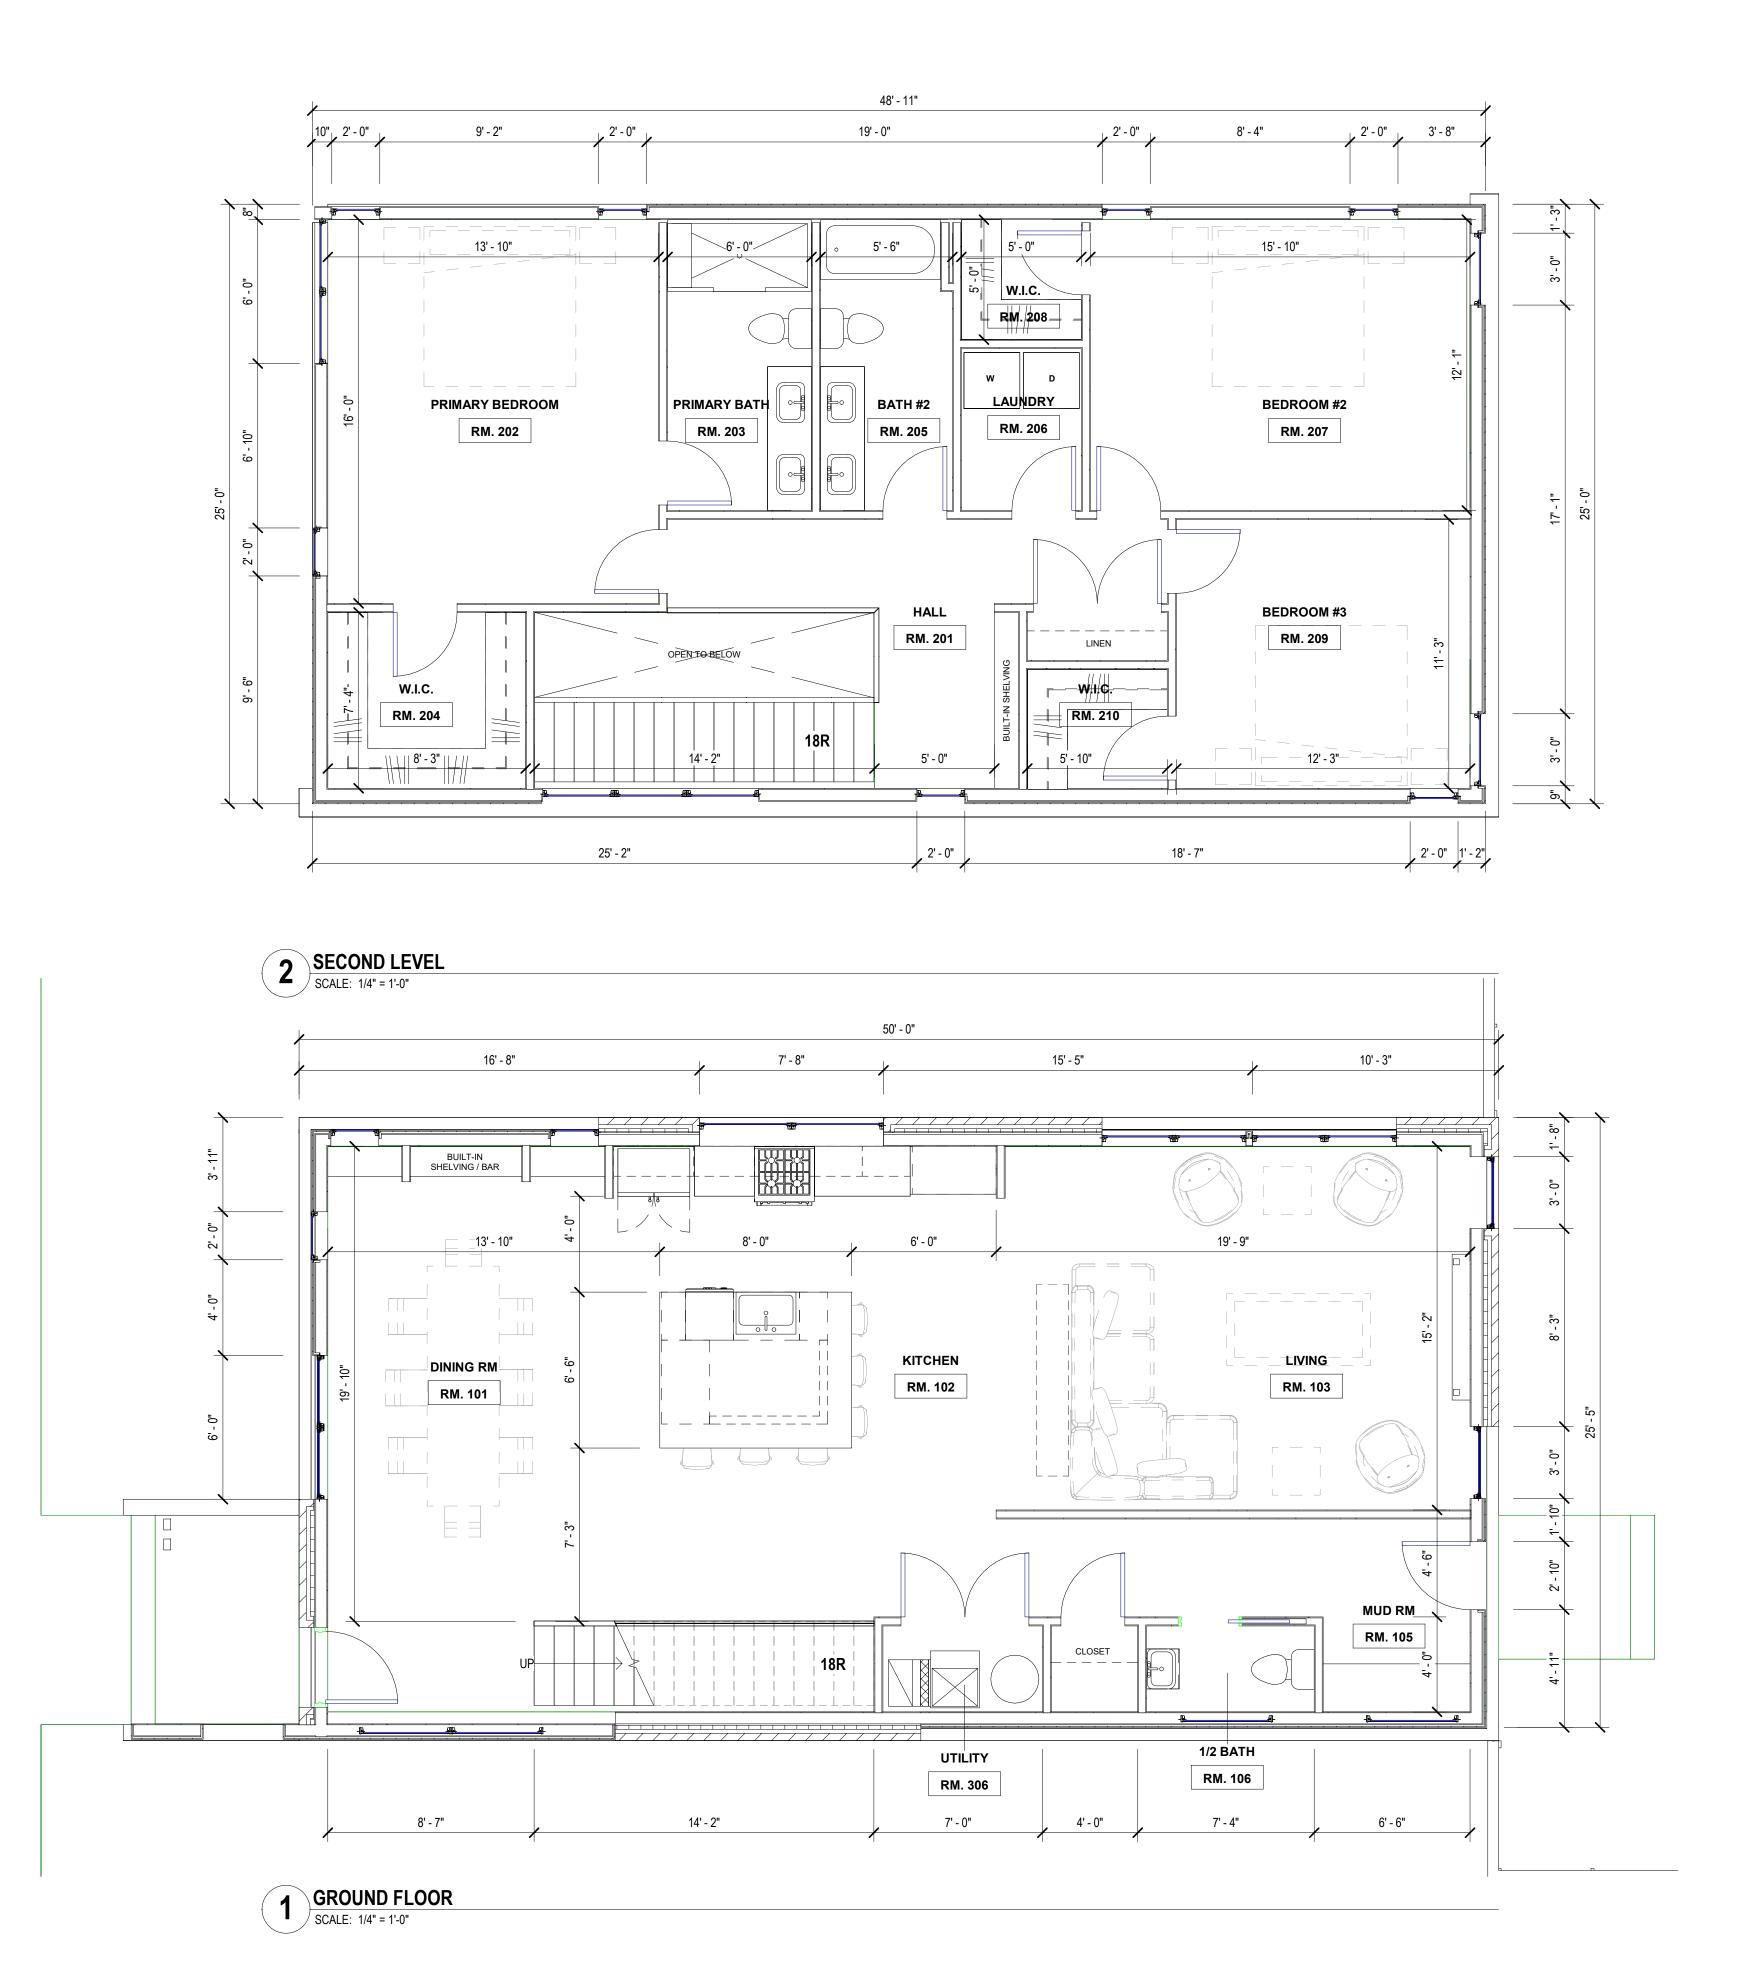

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3.


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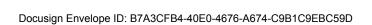
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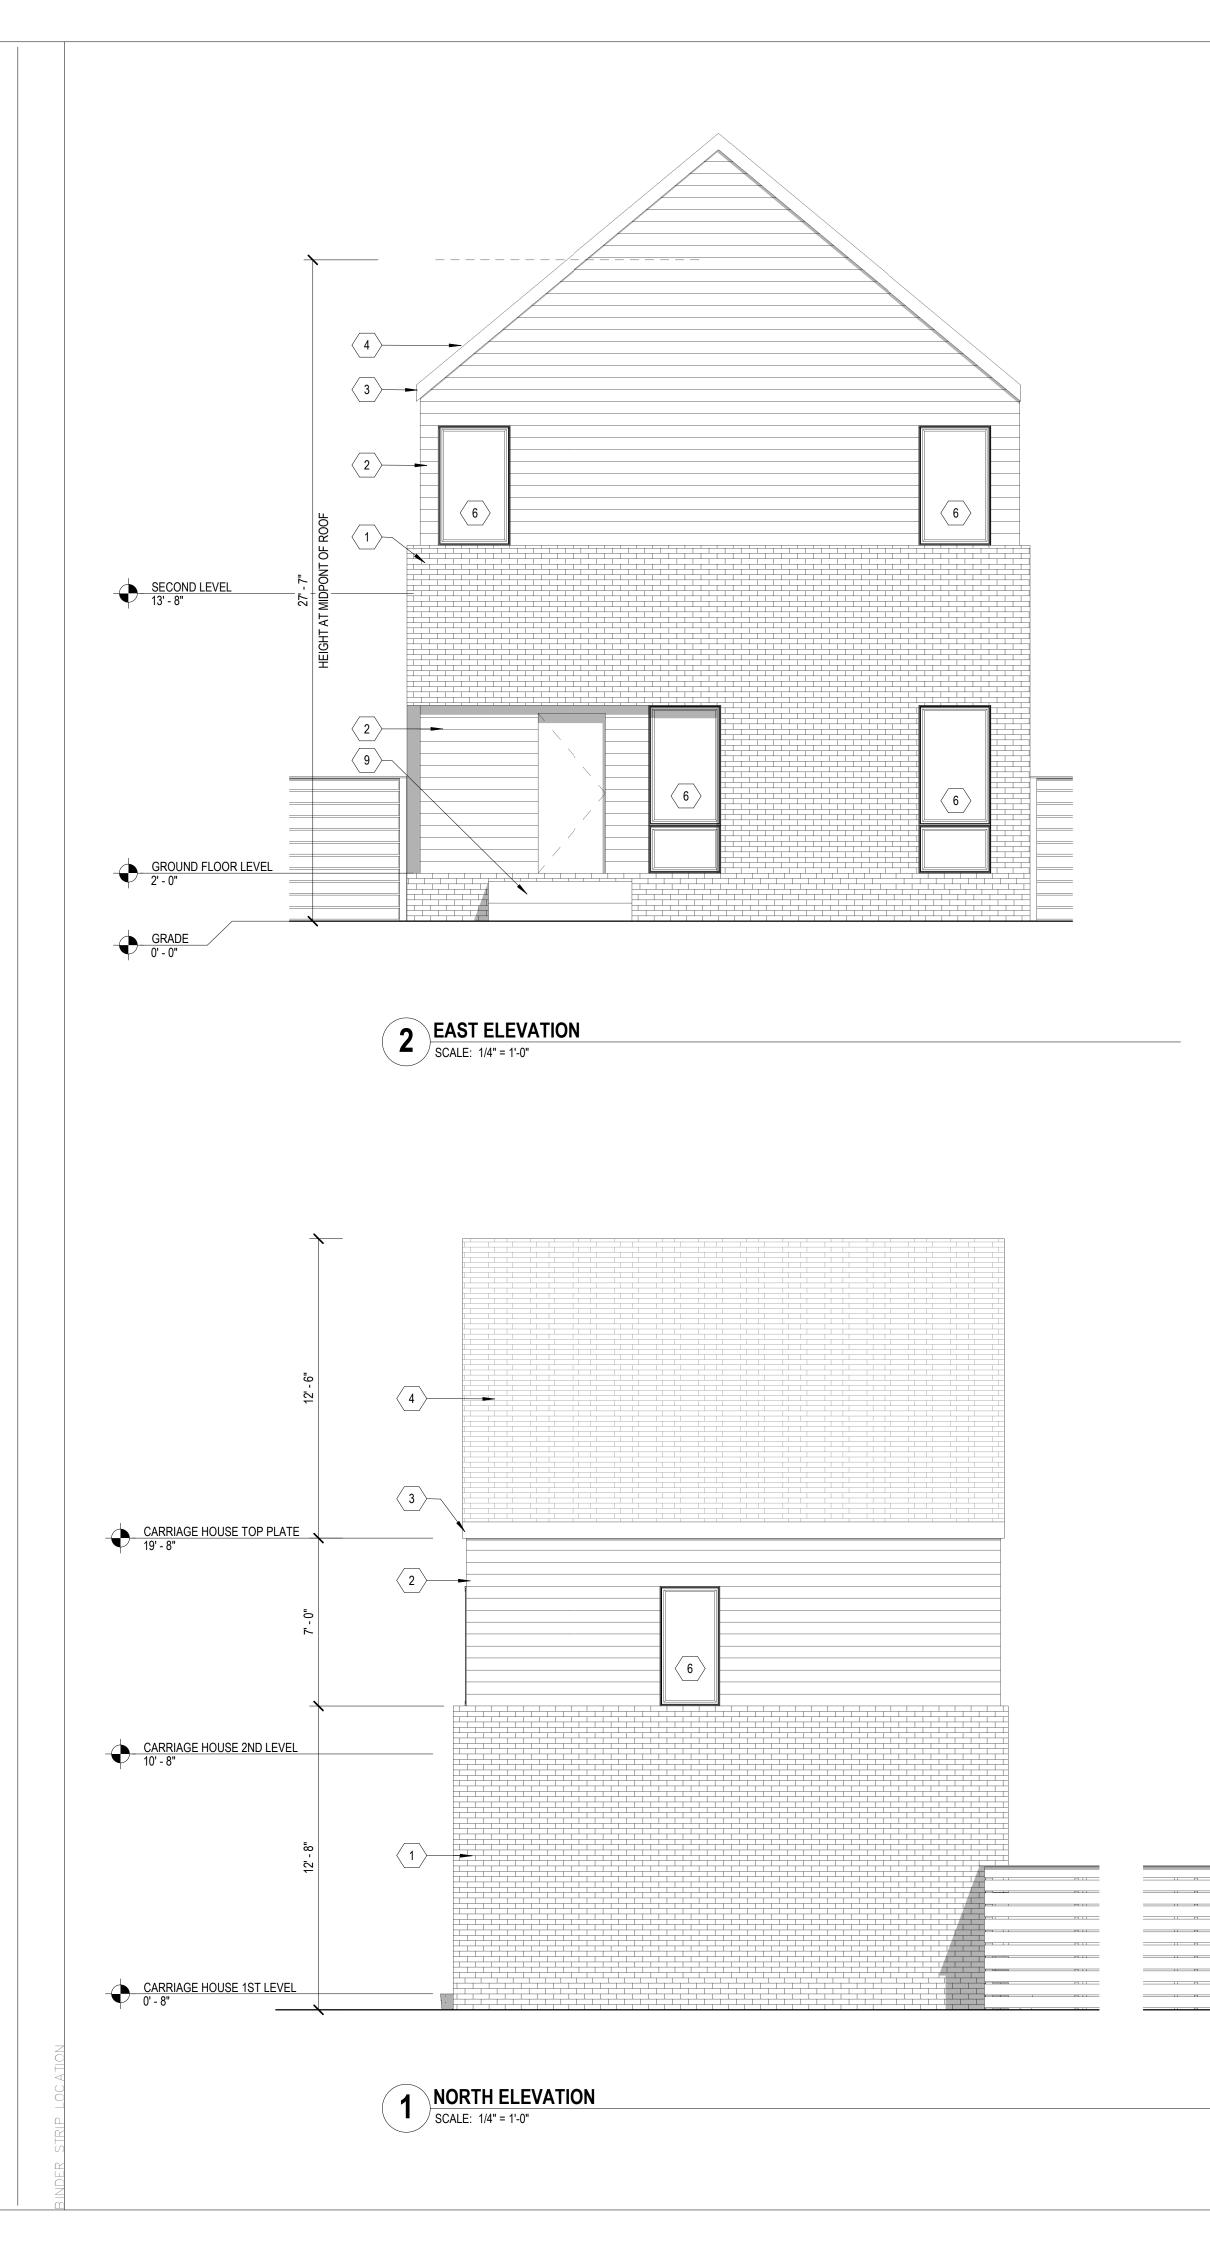
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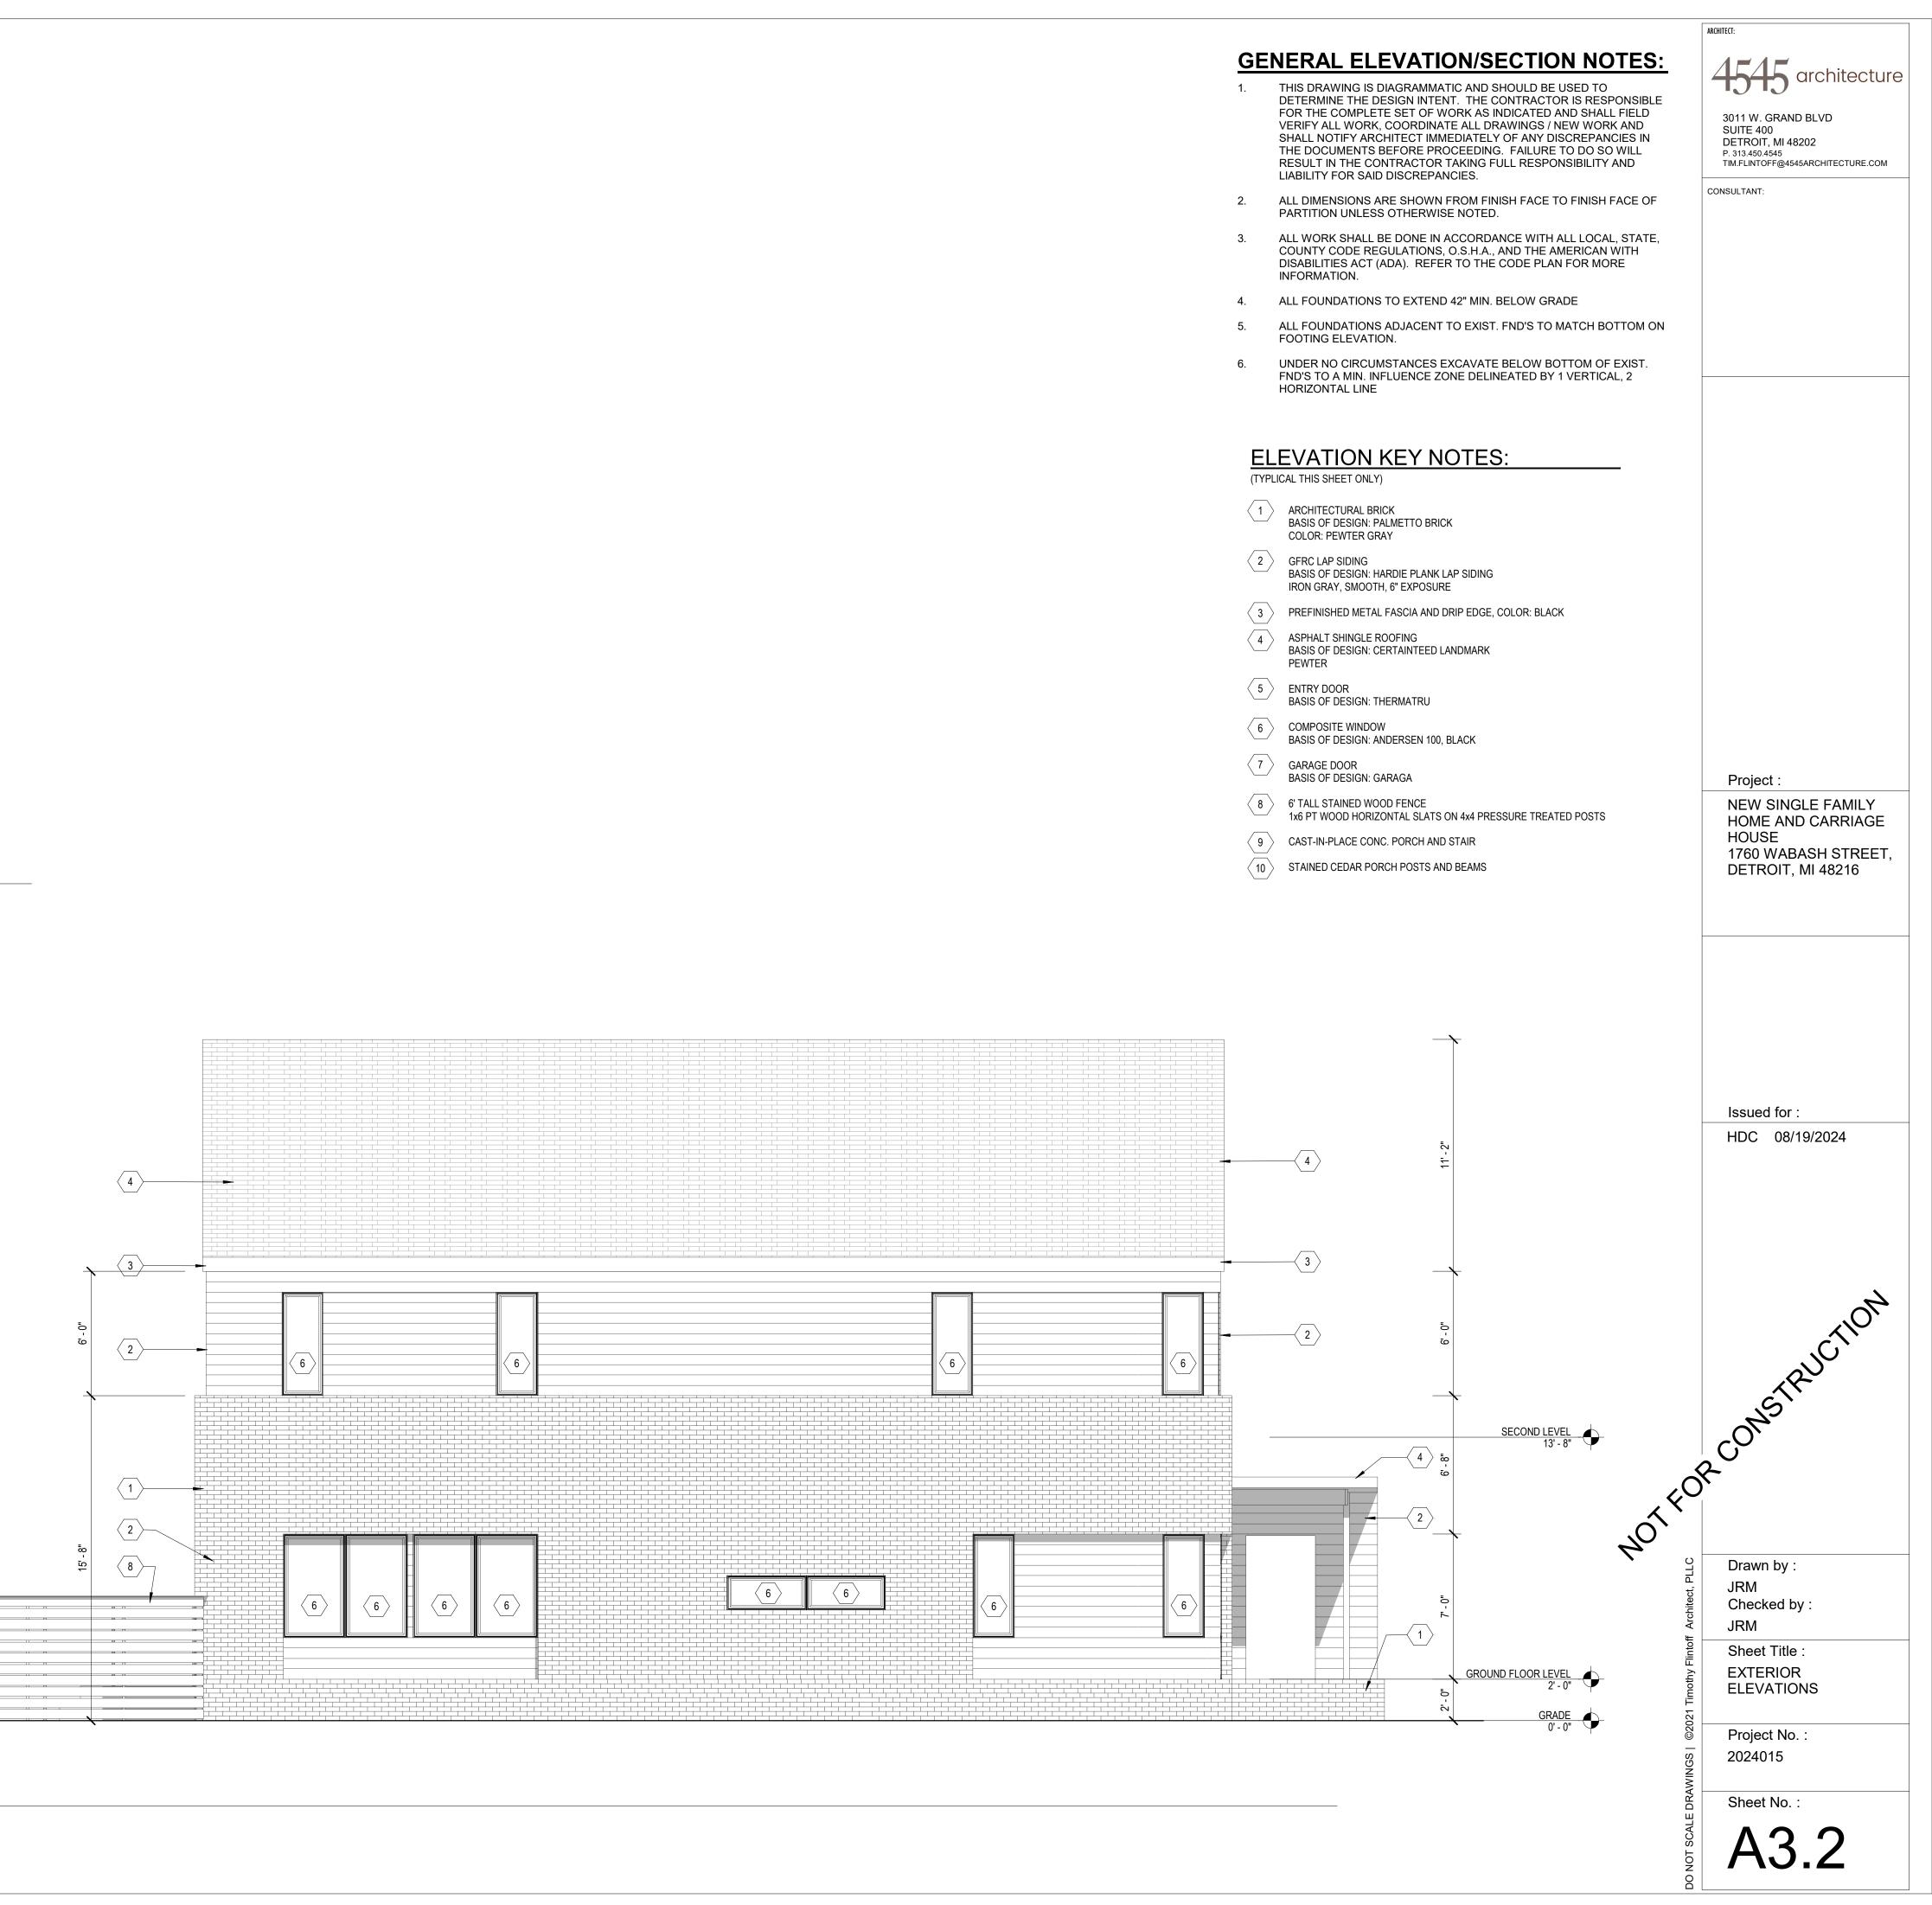
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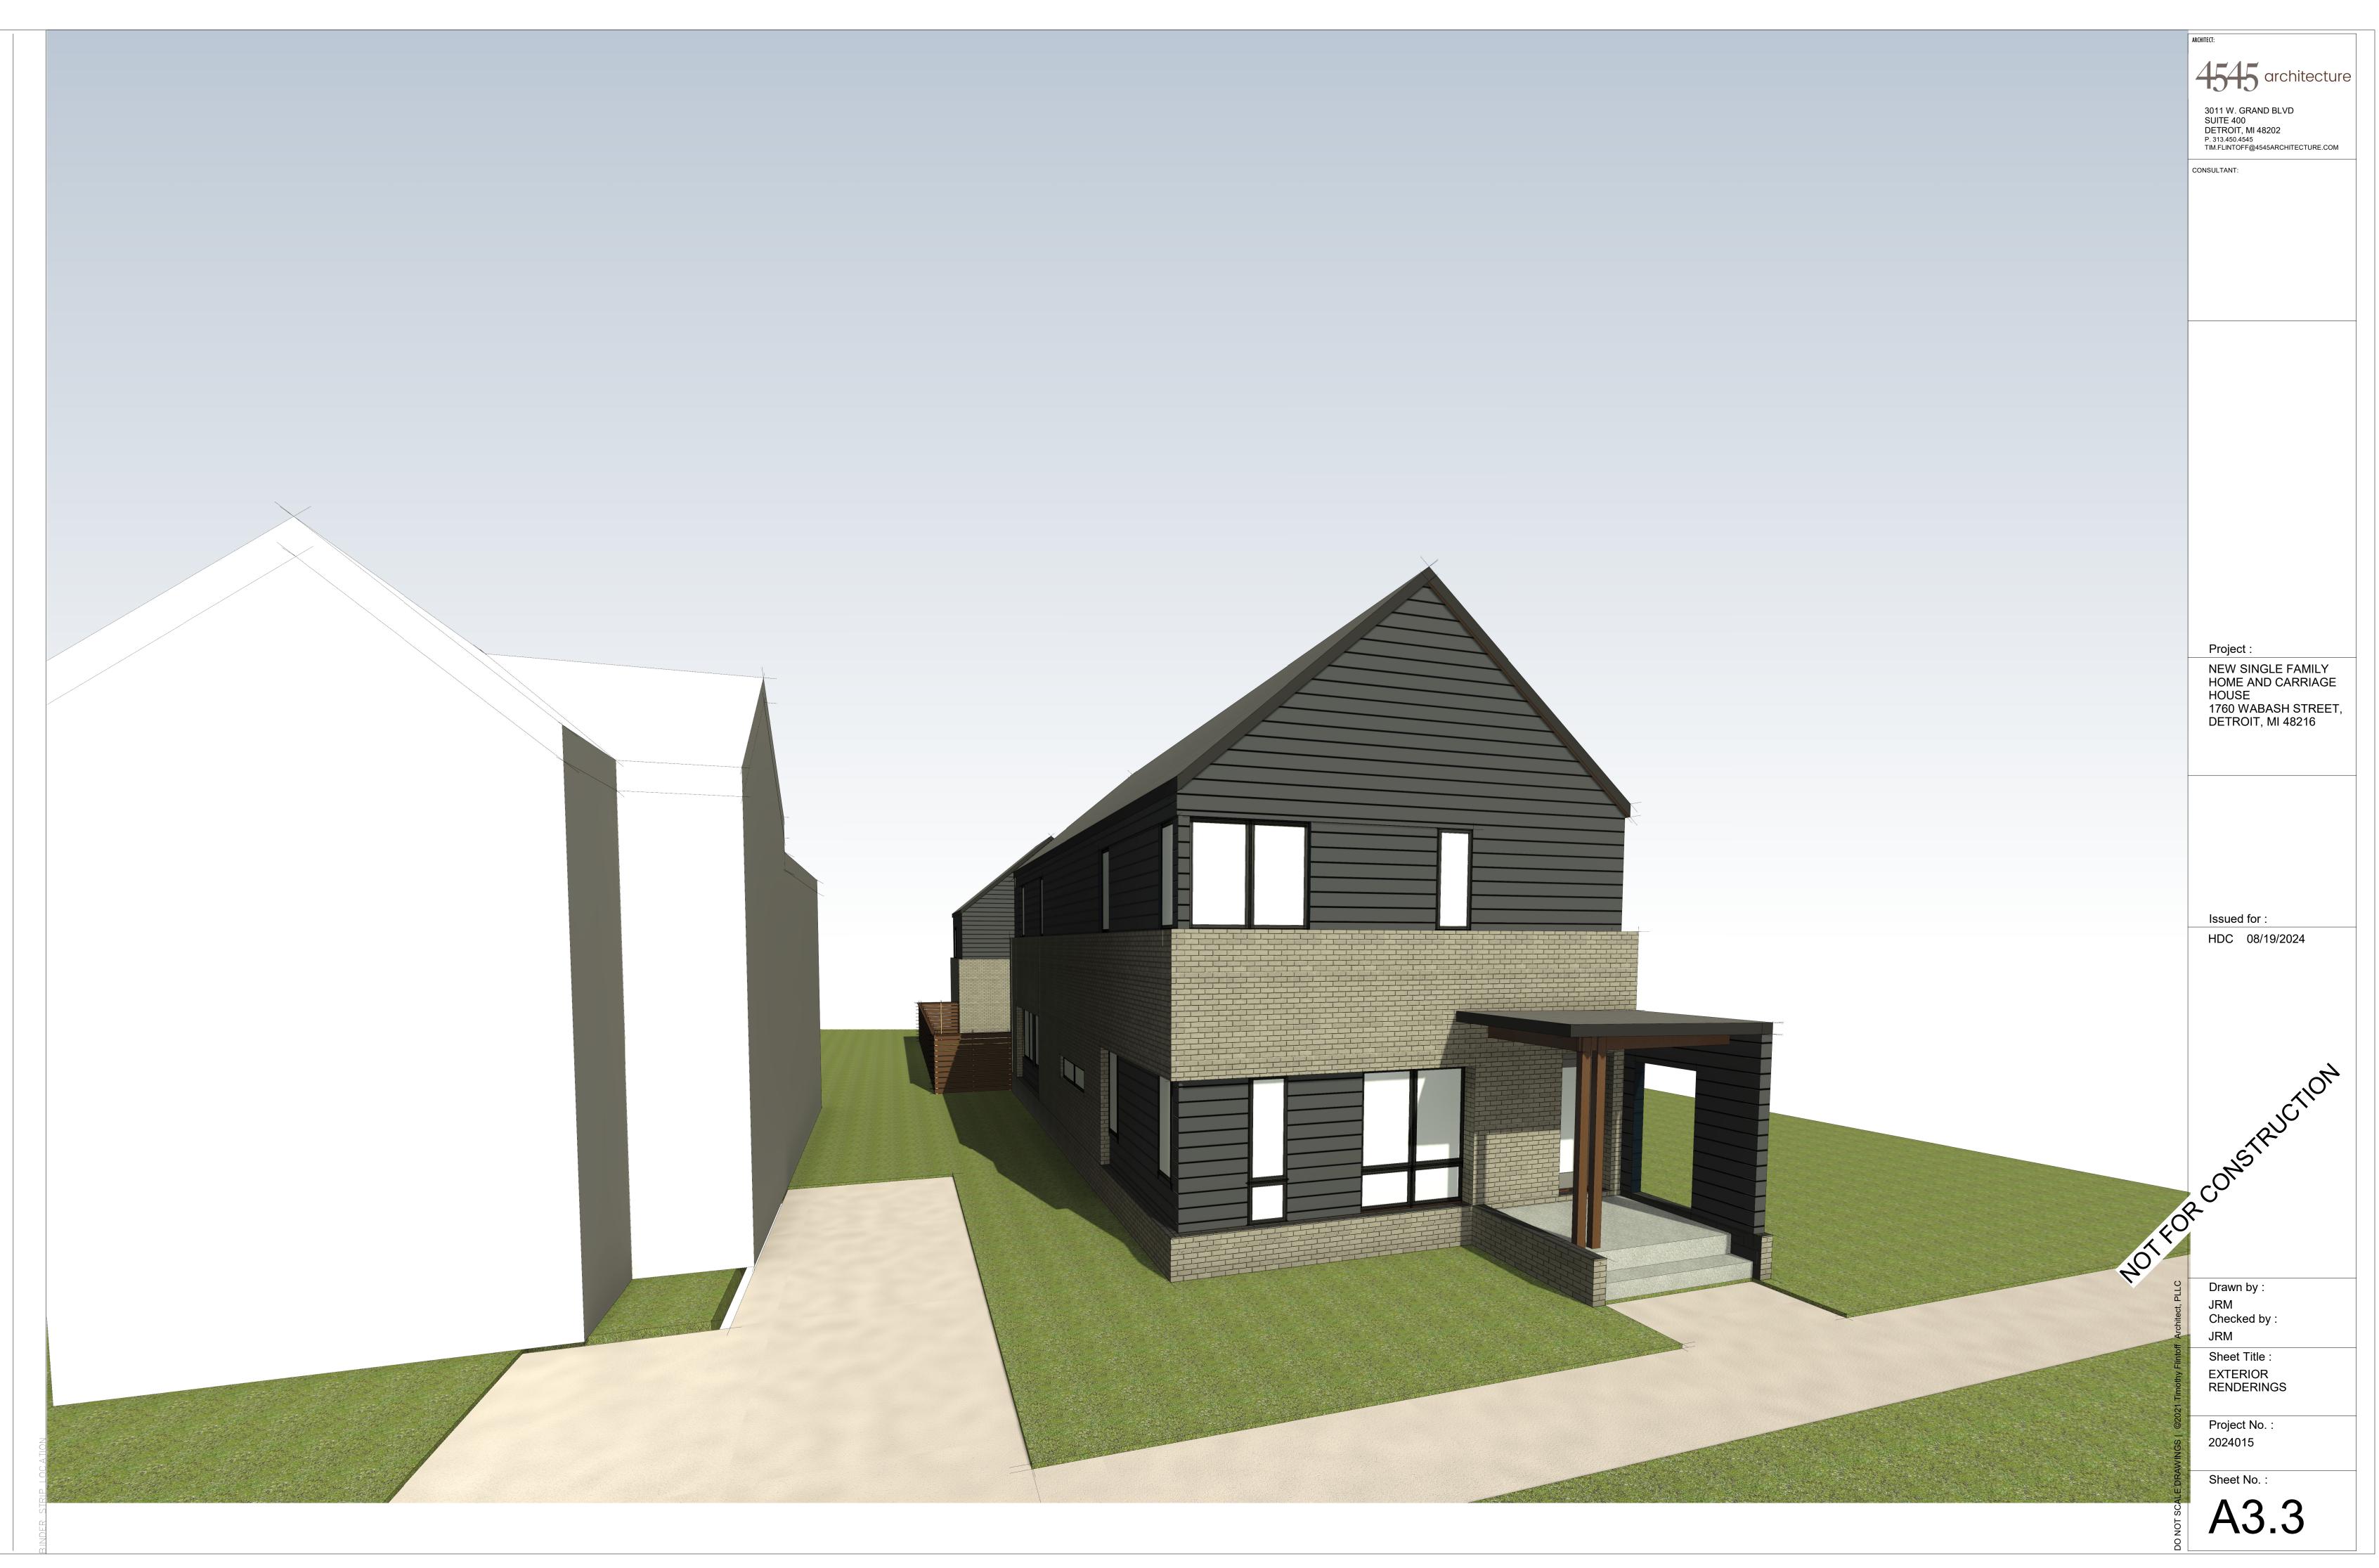








ARCHITECT: 4545 architecture 2761 E. JEFFERSON AVE. SUITE 302 DETROIT, MI 48207 P. 313.450.4545 TIM.FLINTOFF@4545ARCHITECTURE.COM CONSULTANT: Project : NEW SINGLE FAMILY HOME AND CARRIAGE HOUSE 1760 WABASH STREET, DETROIT, MI 48216 Issued for : HDC 08/19/2024 NOT FOR CONSTRUCTION Drawn by : JRM Checked by : JRM Sheet Title : EXTERIOR RENDERINGS Project No. : 2024015 Sheet No. : A3.4

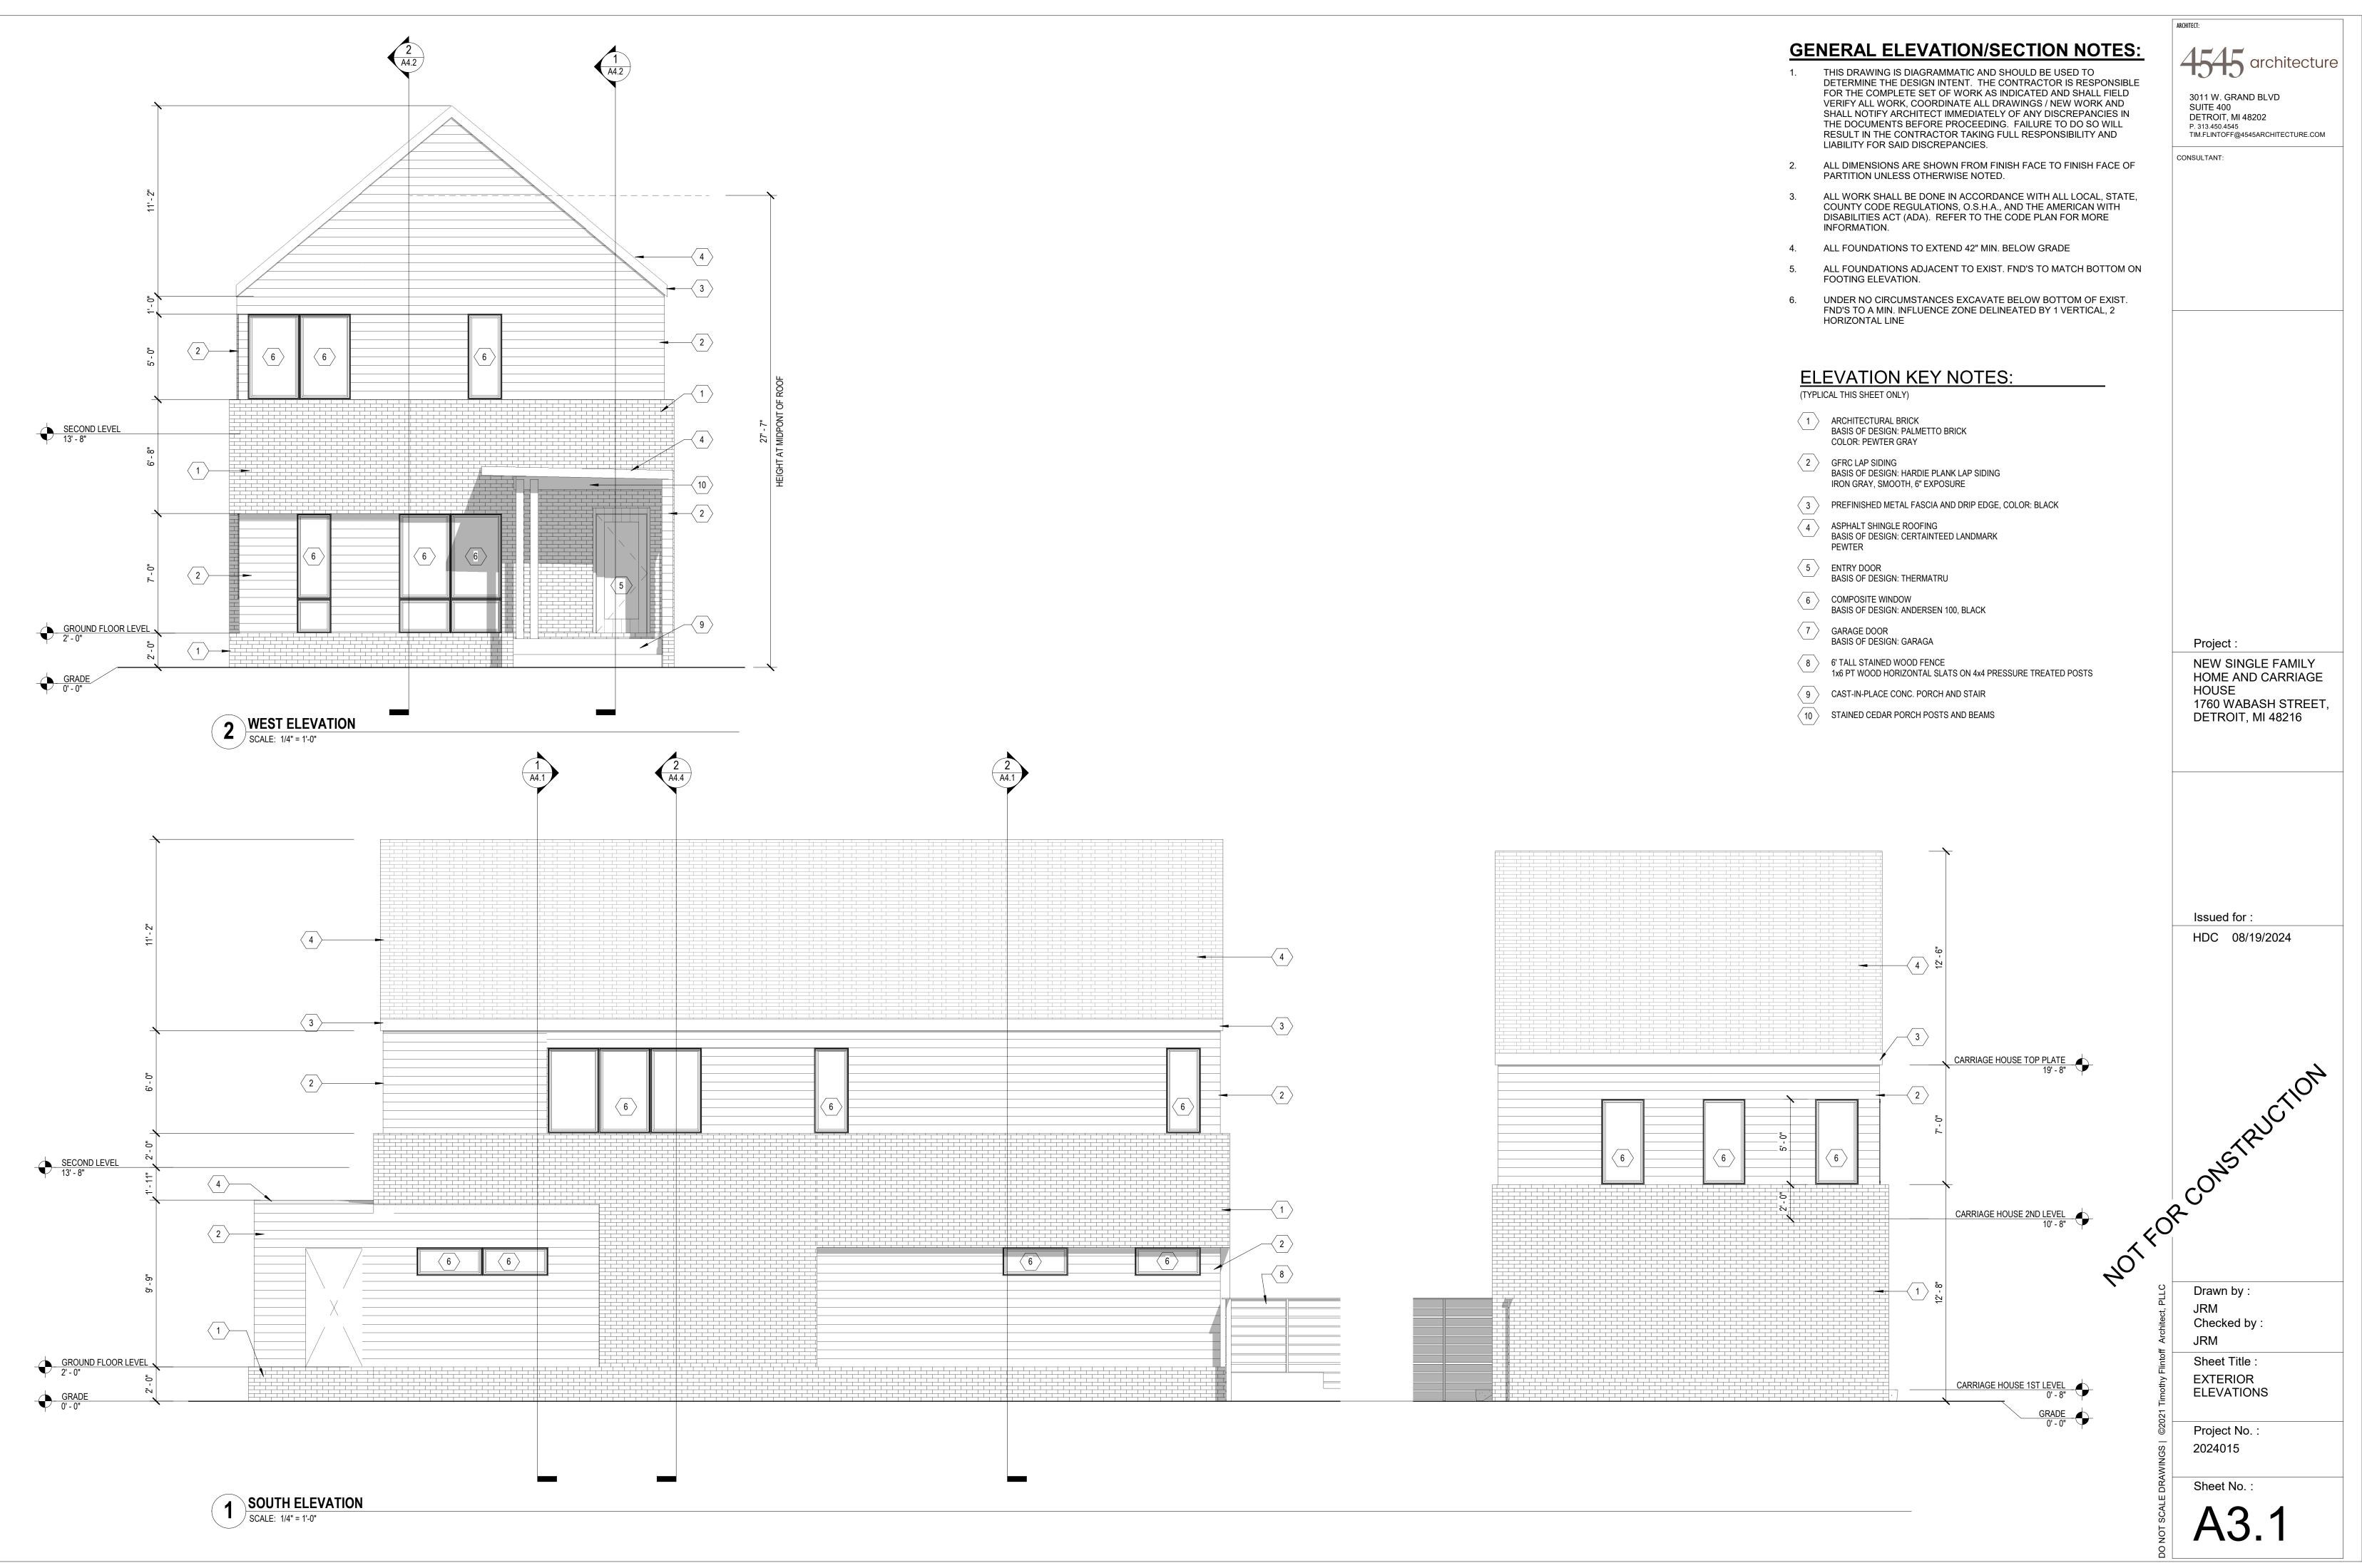



Sharif Affas 1760 Wabash Street Detroit, MI 48216

RE: 1760 Wabash St - New Construction Historic District Commission Submission

1760 Wabash is a mid-block lot on the east side of Wabash. Originally, this address consisted of a double-wide lot with an existing historic-aged home situated in the north half of the lot. The property has since been split, with the existing home on one parcel, and this project is proposed for the newly created lot to the south. The proposed project consists of a new single family home with a detached garage at the rear of the property. The detached garage is proposed to include an accessory dwelling unit on the second floor.

The home has a traditional gable end with a covered porch entry. New materials will include Hardie siding with colors as noted on the plans. New materials have been listed on the attached elevations and will consist of a mixture of Brick and pre-finished Hardie lap siding.

1. Height:

The proposed structure is a two-story structure, with a total height of approximately 27'-7" above grade to the mid-point of the main gable. This height is constant with the adjacent properties.

2. Proportion of Front Façade:

The front façade of the proposed structure is approximately 26'-0" wide, making it slightly taller than it is wide, giving the home a vertical orientation.

3. Proportion of Openings:

The windows proposed for the structure are generally casement style. Individual windows are taller than they are wide and grouped together to form larger areas of glazing.

4. Rhythm of Solid to Void:

Openings in the facades of the proposed structure are regular and ordered, like the existing worker cottage style homes in the neighborhood. Individual windows and groups of windows are placed to be considerate of adjacency between new façade and existing.

- Rhythm of Spacing of Buildings: The lot width and building width are both consistent with the overall neighborhood.
- Rhythm of Entrance and/or front porch projections: The proposed structure features an existing asymmetric front porch entry pushed to one side. This is consistent with similar small front porches in the neighborhood.
- 7. Materials:

The proposed structure is comprised of wood framing with a concrete foundation, an asphalt shingle roof, majority brick on the first floor, and Hardie lap siding on the second floor.

8. Textures:

Texture is at play in the relationship between the lap siding, ship-lap wood siding and brick.

9. Colors:

The color palette of the proposed structure has been kept neutral and natural in order to blend in with the existing homes on the block. The brick, roof, and siding are all within a gray-scale pallet.

10. Architectural Details:

The architectural details of the proposed structure are very simple in order to complement the existing modest homes on the block. The overall massing and roof shape are similar to adjacent historic homes, while the clean simplified detailing is more contemporary. In order to match the level of detail and visual interest of the existing homes, a concept of layering and texture is used to create depth and hierarchy in the facades. The goal is to establish the existing structure as the primary focus and allow the addition to have a supporting role.

11. Roof Shapes:

Similar to many existing homes on the block, the proposed structure features a simple roof line with a single ridge running down the center of the structure, and front-facing gables.

12. Wall of Continuity (setbacks):

The front setback of the proposed structure is similar to adjacent homes.

13. Landscape Features:

The front lawn of the proposed structure is grass turf, consistent with adjacent properties. More decorative bushes and flowering plants will be included along the perimeter of the home.

14. Open space:

The front lawn is intended to be kept open, as well as the yard space between the home and garage/ADU.

15. Scale of Facades/Façade Elements:

The overall structure is a similar scale to the existing homes on the block. The front elevation is fairly simple with few façade elements. Window groupings are always in the same plane as the overall façade. Window groupings are generally 2 windows wide and consistent in shape between the new and existing facades, and account for approximately one-quarter of the overall façade width. Solid walls have been used where we are in close proximity to adjacent parcels.

16. Directional Expression of Front Elevation:

The directional expression of the front elevation is generally vertical. The south portion of the front façade has the covered entry and is clad in siding. The remaining portion of the façade is clad in brick and horizontally oriented siding. This composition breaks down the scale of the building by incorporating vertical and horizontal elements.

17. Rhythm of Setbacks:

The front setback is consistent with adjacent properties.

18. Lot Coverage:

- a. Lot Size: 3383 Square Feet
- b. Building Footprint: 1112
- c. Percentage of lot Coverage: 32.9%

19. Degree of Complexity in Façade:

The proposed structure is very simple in massing and façade complexity. The façade uses a simple palate of 4 materials, organized in a way to provide hierarchy, depth and interest without relying on additional detail and applied architectural elements.

20. Orientation/Vistas/Views:

The long axis of the proposed structure is oriented east-west with the front of the structure facing Wabash street. Bedrooms are placed at the rear of the building, while the living space is organized to the front of the home, because most of the green space for the lot is located in the front yard the home has a focus on connecting living space with that are for its primary exterior use and connection to the neighborhood.

21. Symmetric or asymmetric appearance:

The appearance of the proposed structure is asymmetric to complement existing asymmetric homes on the block. Windows on the front façade are aligned in stacking groups. The front porch is offset to one side. These balanced elements are unified by the centered forward facing gable.

22. General Character:

Corktown is made up of modestly detailed small-scaled homes on narrow lots creating a dense walkable neighborhood. The proposed structure follows the simple massing and closely spaced arrangement precedent set by the existing adjacent homes. The materials used for the proposed structure speak to the textural quality of the existing homes with the use of horizontal siding and brick. More contemporary expression and detailing speak to the longevity of the neighborhood and the notion that Corktown houses are built to last. The homes in Corktown were built over various periods of time, and are examples of many architectural styles. What makes the neighborhood cohesive is the attention to scale, proportion, and quality in each home regardless of style. While the proposed structure utilizes some contemporary elements, the overall scale, massing, and textural quality are inspired by and designed to complement the overall Corktown character



Sharif Affas 1760 Wabash Street Detroit, MI 48216

RE: 1760 Wabash St – New Construction Historic District Commission Submission

1760 Wabash is a mid-block lot on the east side of Wabash. Originally, this address consisted of a double-wide lot with an existing historic-aged home situated in the north half of the lot. The property has since been split, with the existing home on one parcel, and this project is proposed for the newly created lot to the south. The proposed project consists of a new single family home with a detached garage at the rear of the property. The detached garage is proposed to include an accessory dwelling unit on the second floor.

Scope of Work

Demolition Work:

• Demolish existing chain link fence at perimeter of property

New Construction of Single-Family residence

- New electrical service and wiring in house complete*
- New interior finishes: including kitchen and two bathrooms *
- New hot water heater*
- New plumbing/sanitary complete from incoming services*
- New HVAC forced air system with central air*
- New 2x6 wood construction with R-38 in ceiling and R-19 in walls and new Tyvek house wrap*
- New asphalt shingle roofing
- New windows: Andersen 100
- New brick and lap siding
- New gutters and down spouts

•

New Construction of Garage/ADU

- New interior finishes: including kitchen and 1 bathroom*
- New hot water heater*
- New plumbing/sanitary complete
- New HVAC forced air system with central air*
- New 2x6 wood construction with R-38 in ceiling and R-19 in walls and new Tyvek house wrap*
- New asphalt shingle roofing
- New windows: Andersen 100
- New brick and lap siding
- New gutters and down spouts

Site:

- New horizontal slat wood fence in between house and garage
- New landscape area and planter beds in front of house
- Replace sod as required due to construction damage
- New concrete walkway from front of house to public sidewalk




SUMMARY OF YOUR GARAGE DOOR PROJECT


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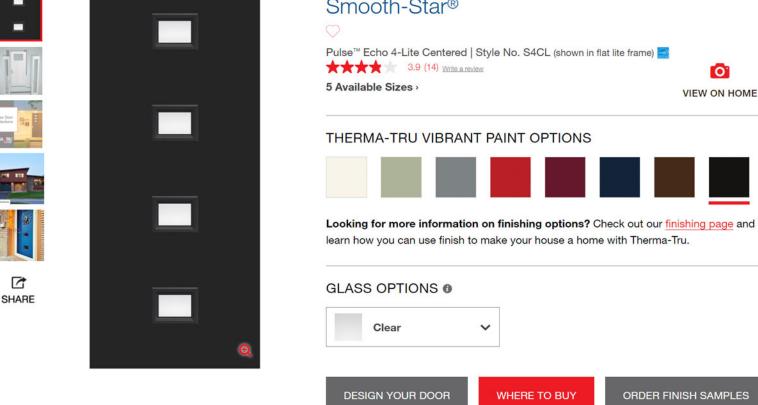
Regal N24, Flush
1
16' 0" x 7' 0" (width x height)
2"-thick galvanized steel, non-insulated
24-gauge galvanized steel, woodgrain finish; 2" tongue and groove joint between sections.
Black Ice

Please note that colors shown on your screen may vary based on your screen or printer settings. To have a precise view of colors, contacts a Garaga dealer for samples.



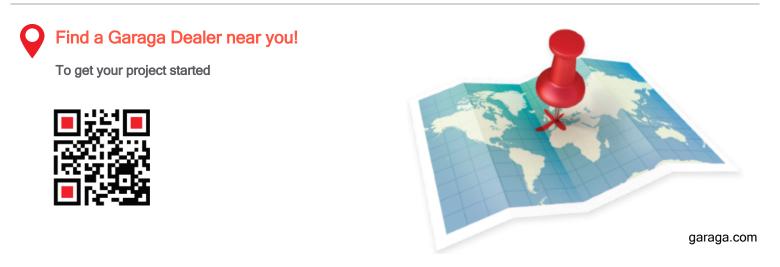




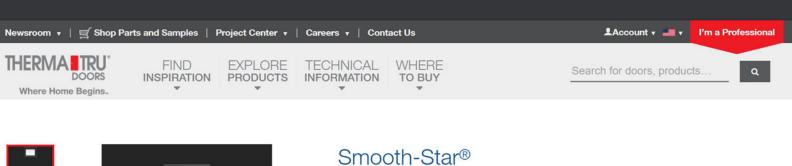

Where Home Begins with Therma-Tru doors.





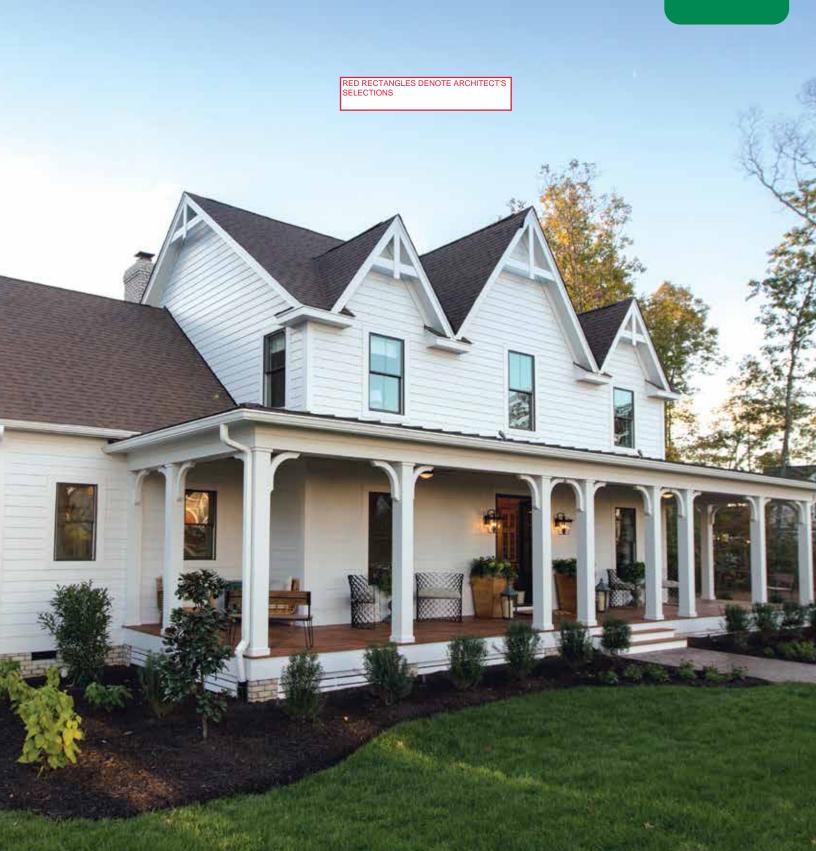

Discover a whole new **SIDE OF HOME.**



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Manager III (Margarette

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Build confidently BY DESIGN.



Installed on over 8 million homes* from coast to coast, James Hardie® fiber cement siding products are designed to resist the most extreme conditions while delivering long term beauty and lower maintenance. Enjoy the warm, natural look of wood with unprecedented peace of mind. It's easy to see what makes James Hardie the market leader.



*Estimate based on total James Hardie siding sales through 2016 and average housing unit size.

CONTENTS

- HardieZone® System 4 Unique Formulation 6 8 Finishing Technology James Hardie Complete Exterior™ 10 12 HardiePlank® Lap Siding 14 HardiePanel[®] Vertical Siding 16 HardieShingle® Siding HardieTrim® Boards 18 20 HardieSoffit® Panels Statement Collection[™] Products 22 24 **Color Inspiration** 26 HardieWrap® Weather Barrier Finishing Touches 27 The James Hardie Difference 28 30
 - Warranty and Endorsements

HardieZone® System

Only James Hardie[®] fiber cement products are Engineered for Climate[®]. In the northern U.S. and Canada, HZ5[®] products resist shrinking, swelling and cracking even after years of wet or freezing conditions. HZ10[®] products help protect homes from hot, humid conditions, blistering sun and more.

With James Hardie[®] siding and trim, homeowners have an exterior that's tougher than the elements and easy on the eyes.

NO MATTER WHAT NATURE BRINGS





HardieTrim® Boards Timber Bark

TOUGHER THAN THE ELEMENTS



Stands up to storms and harsh weather



Water resistant to protect against swelling, warping and cracking



Won't be eaten by animals or insects



Fire resistant



Helps reduce time and money spent on maintenance

Resist the elements WITH IRRESISTIBLE BEAUTY.

HardiePlank[®] Lap Siding Khaki Brown

Unique Formulation HZ5[®] Substrate


Not all fiber cement is the same. The James Hardie HZ5 product formulation contains the highest quality raw materials. Proprietary additives, combined with an innovative manufacturing process and product design, create a substrate specifically engineered to reduce moisture and resist damage from wet or freezing conditions.

PROPRIETARY ENHANCEMENTS CREATE DURABLE JAMES HARDIE[®] SIDING



Perfect balance of strength and workability

Our balance of high-quality Portland cement, sand and cellulose fiber delivers the best combination of strength and workability.

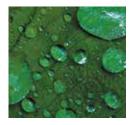

Enhanced moisture resistance for unmatched durability

Patented and proprietary additives are chemically bonded within the HZ5[®] substrate matrix to provide durable moisture resistance.



Increased dimensional stability

Our siding is engineered at the microscopic level to create a fiber cement composite with superior dimensional stability that helps protect against shrinking and splitting.






Integrity is ingrained IN EVERYTHING WE DO.



The advanced design of $HZ5^{\circ}$ lap siding improves drainage from top to bottom.

In addition to the enhanced moisture resistance of our product formulation, HardiePlank® HZ5® lap siding features a modified profile with a sloped top and bullnose drip edge for improved drainage over the entire outer face of the board.

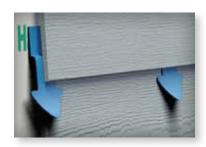

Sloped Top

HardiePlank Lap Siding Evening Blue

Positive slope at top drains moisture to outer face of lap



Profiled Drip Edge

Bottom bullnose drip edge allows moisture to drain away from lap

Finishing Technology

Primer

A quality primer is the first step to ensuring that the paint color you select beautifully expresses a home's true character now – and for years to come. Our distinctive primer is climate-tested and engineered to enhance the performance of paint on James Hardie[®] fiber cement siding products. It helps to provide consistent, long-lasting paint adhesion, even in the most demanding conditions.

ColorPlus® Technology

Our advanced ColorPlus[®] Technology finishes deliver the ultimate in aesthetics and performance. Our products aren't simply painted at the factory. Our proprietary coatings are baked onto the board, creating a vibrant, consistent finish that performs better, lasts longer and looks brighter on your homes.



Exceptional finish adhesion

Our proprietary coating is engineered for exceptional adhesion to our substrate and applied to the surface, edges and features for durable performance.



Superior color retention

Finish is cured onto boards for a stronger bond, which allows for exceptional resistance to cracking, peeling and chipping.



Superior UV resistance

ColorPlus[®] Technology finishes retain vibrancy longer when compared to vinyl siding and typical field paints on other siding products.





lardieShingle Straight Edge HardiePlank[®] Lap Siding HardieTrim® Boards Arctic White Lasting beauty

BEGINS WITH THE FINISH.

Our finishes help eliminate stress and reduce costly weather delays when

it's too cold or damp to paint for extended periods. Now there's no reason to question whether or not sub-optimal painting conditions will negatively affect your paint job. In fact, there's no longer any need to paint on-site during installation.

ColorPlus[®] Technology finishes are fully cured in a controlled environment and arrive on your job site ready for year-round installation.



ColorPlus® Technology Iron Gray ColorPlus[®] Technology Pearl Gray

For complete confidence wrap your **ENTIRE EXTERIOR WITH JAMES HARDIE.**



James Hardie Complete Exterior[™]

Top to bottom, our exterior product line is defined by excellent performance, aesthetics and design options.

Provide protection from the elements, showcase a homeowner's individual style and install peace of mind with exceptional warranties through a single, trusted manufacturer.





HardieShingle[®] Siding

HardiePanel® Vertical Siding & HardieTrim® Batten Boards





HardieTrim® Boards



HardieSoffit® Panels

Lap Siding



HardiePlank[®]

Sleek and strong, HardiePlank® lap siding is not just our best-selling product – it's the most popular brand of siding in America.

With a full spectrum of colors and textures, homeowners can enjoy protection from the elements and the versatility to make their dream home a reality. From Victorians to Colonials, HardiePlank lap siding sets the standard in exterior cladding.



HardieTrim[®] Boards Arctic White

> HardiePlank[®] Lap Siding Select Cedarmill[®] Khaki Brown

A classic look for **THE HOME OF THEIR DREAMS.**

Thickness 5/16 in Length 12 ft planks Witth Exposure ColorPlus Psc/Pallet 360 5.25 in 5.16 6.25 in 6.10 7.25 in 7.25 in 7.2	Hardie Plank [®]		SELECT C	EDARMILL [®] &	SMOOTH		
Length 12 ft planks Prime Pos/Pailet 30 51 0 in 1 0 in		Width	5.25 in	6.25 in	7.25 in	8.25 in	9.25 in*
ColorPlus Pes/Fall 324 280 252 210 - Pes/Sq 25.0 20.0 16.7 14.3 12.5 SELECT CEDARMIL* Vidth 5.25 in 6.25 in 7.25 in 8.25 in 9.25 in* DREAM ✓ ✓ ✓ ✓ ✓ ✓ ✓ SMOOTH DREAM ✓ ✓ ✓ ✓ ✓ ✓ SMOOTH StateMent Collection* ✓ ✓ ✓ ✓ ✓ SMOOTH StateMent Collection* ✓ ✓ ✓ ✓ ✓ ✓ ✓ SMOOTH DREAM Collection* Ø ✓		Exposure	4 in	5 in	6 in	7 in	8 in
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Width 8.25 in Exposure 7 in ColorPlus 210 Pcs/Sq 14.3 STATEMENT DREAM COLLECTION" ✓							
Exposure 7 in ColorPlus 210 Pcs/Sq 14.3 STATEMENT COLLECTION™ ✓ BEADED SMOOTH					& BEADED SN	100TH	
ColorPlus Pcs/Pallet 210 Pcs/Sq 14.3 STATEMENT COLLECTION" DREAM COLLECTION" BEADED SMOOTH							
Pcs/Pallet ²¹⁰ Pcs/Sq 14.3 STATEMENT COLLECTION [™] DREAM COLLECTION [™] ↓			/ IN				
BEADED SMOOTH STATEMENT COLLECTION [™] DREAM COLLECTION [™]			210				
COLLECTION [™] DREAM COLLECTION [™] BEADED SMOOTH		Pcs/Sq	14.3				
COLLECTION [™]							
PRIME PRIME			\checkmark				
	BEADED SMOOTH	PRIME					

HardiePanel[®]

HardiePanel[®] vertical siding delivers style and substance. When combined with HardieTrim[®] boards, it achieves the rustic board-and-batten look that defines cottage charm. The covered seams contribute to a well-insulated home.

Its crisp, clean lines make HardiePanel vertical siding a smart choice for strong, contemporary designs.



hickness 5/16 in		4 ft x 8 ft	
	Prime Pcs/Pallet		50
Colo	rPlus Pcs/Pallet Pcs/Sq		50 2.5
ELECT CEDARMILL [®]	1 00/04	5.2	2.0
	Size	4 ft x 8 ft	4 ft x 10 ft
	STATEMENT	THE A UTL	4 ICX 10 IC
	COLLECTION™		v
All the second	DREAM COLLECTION TM	\checkmark	\checkmark
			\checkmark
	PRIME	v	v
моотн			
	Size	4 ft x 8 ft	4 ft x 10 ft
	STATEMENT		\checkmark
	COLLECTION [™] DREAM		
		\checkmark	\checkmark
	PRIME	\checkmark	\checkmark
TUCCO			
	01	1 ft v 0 ft	1 ft v 10 ft
	SIZE	4 IL X Ö I [4 ft x 10 ft
	COLLECTION [™]		
	DREAM	\checkmark	\checkmark
		\checkmark	\checkmark
	COLLECTION [™] PRIME	\checkmark	\checkmark
		\checkmark	✓
IERRA 8		\checkmark	
IERRA 8		\checkmark	✓
IERRA 8	PRIME	✓ 4 ft x 8 ft	✓ 4 ft x 10 ft
IERRA 8	PRIME Size STATEMENT	✓ 4 ft x 8 ft	
IERRA 8	PRIME Size STATEMENT COLLECTION*	✓ 4 ft x 8 ft	
IERRA 8	PRIME Size STATEMENT	✓ 4 ft x 8 ft	

HardieShingle®

Restore the look of a grand Cape Cod or add distinction to a handsome bungalow. HardieShingle[®] siding embodies the enchanting look of cedar shingles with lower maintenance.

Better than the real thing, HardieShingle siding resists rotting, curling, warping and splitting.






Thickness 1/4 in





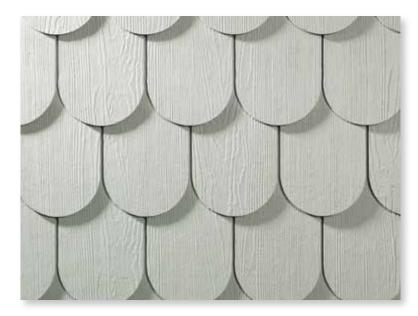

STAGGERED EDGE PANEL

Length	48 in
Height	15.25 in
Exposure	6 in
ColorPlus Pcs/Pallet	100
Sq/Pallet	2
Pcs/Sq	50.0
STATEMENT COLLECTION [™]	
DREAM COLLECTION [™]	\checkmark
PRIME	

STRAIGHT EDGE PANEL

Length	48 in	48 in
Height	14 in	15.25 in
Exposure	5 in	7 in
ColorPlus Pcs/Pallet	120	86
Sq/Pallet	2	2
Pcs/Sq	60.0	43.0
STATEMENT COLLECTION [™]	\checkmark	\checkmark
DREAM	\checkmark	\checkmark

HALF ROUNDS

Length	48 in
Height	15.25 in
Exposure	7 in
Prime Pcs/Pallet	86
Sq/Pallet	2
Pcs/Sq	43.0
STATEMENT COLLECTION [™]	
DREAM COLLECTION™	
PRIME	\checkmark

HardieTrim®

Boards

naki Brown

Hardie Trim[®]

Form meets function at every angle with HardieTrim[®] boards. With an authentic look, HardieTrim boards provide design flexibility for columns, friezes, doors, windows and other accent areas.

Better than wood, it will complement your long-lasting, lower maintenance James Hardie[®] siding – adding punctuation to your design statement.

The performance you require. THE DISTINCTIVENESS YOU DESIRE.

HardiePlank[®] Lap Siding Navajo Beige

HardieTrim[®]

Length 12 ft boards

NT3® BOARDS SMOOTH



4/4 SM00TH Thickness .75 in Width 3.5 in 5.5 in 7.25 in 9.25 in 11.25 in ColorPlus Pcs/Pallet 312 208 156 104 104 STATEMENT \checkmark \checkmark \checkmark \checkmark **COLLECTION**[™] DREAM \checkmark \checkmark \checkmark \checkmark \checkmark **COLLECTION**[™] PRIME 5/4 SM00TH Thickness 1 in Width 3.5 in 4.5 in 5.5 in 7.25 in 9.25 in 11.25 in ColorPlus Pcs/Pallet 240 200 160 120 80 80 **STATEMENT** \checkmark \checkmark \checkmark \checkmark \checkmark **COLLECTION™** DREAM \checkmark \checkmark \checkmark \checkmark \checkmark \checkmark **COLLECTION™** PRIME

BATTEN BOARDS

SMOOTH **RUSTIC GRAIN**° **SMOOTH & RUSTIC GRAIN°** Thickness .75 in STATEMENT \checkmark **COLLECTION**[™] Width 2.5 in Prime 190 DREAM **Pcs/Pallet COLLECTION**[™] ColorPlus 437 PRIME \checkmark **Pcs/Pallet**

HardieSoffit[®]

A home is only as strong as its weakest point. HardieSoffit[®] panels reinforce your work by protecting the vulnerable gap between eaves and exterior walls.

Available in vented, non-vented and a range of pre-cut sizes, these panels complete your design and help protect it from moisture and pests.

VENTILATION BENEFITS

Using vented soffit improves ventilation in the attic space and reduces the chance of water vapor condensation that can lead to issues such as mold and mildew growth, stained ceilings and damage to the framing of the house.

In warm climates, HardieSoffit panels allow hot, humid air to escape, which not only helps prevent condensation in the attic, but can also help reduce air conditioning costs.

In cool climates, HardieSoffit panels help prevent condensation from forming on the interior side of the roof sheathing and reduce the chances of roof-damaging ice dams.



HardieSoffit [®]		VENTED SMO	OTH & SELECT C	EDARMILL [©]		
Thickness 1/4 in	Length	12 ft	12 ft	8 ft		
	Width	12 in	16 in	24 in		
	Prime Pcs/Pallet	200	150	100		
	ColorPlus Pcs/Pallet	216	156	108		
VENTED SMOOTH						
	Size	12 ft x 12 in	12 ft x 16 in	8 ft x 24 in		
	STATEMENT COLLECTION [™]					
	DREAM COLLECTION [™]	\checkmark	\checkmark	\checkmark		
	PRIME	\checkmark	\checkmark	\checkmark		
VENTED SELECT CEDARMILL°						
	Size	12 ft x 12 in	12 ft x 16 in	8 ft x 24 in		
	STATEMENT Collection™					
	DREAM COLLECTION [™]	\checkmark	\checkmark	\checkmark		
	PRIME					
		NON-VENTED	N-VENTED SMOOTH & SELECT CE			
	Length	12 ft	12 ft	8 ft	8 ft	
	Width	12 in	12 it 16 in	24 in	48 in	
	Prime Pcs/Pallet	200	150	100	40 m 50	
	ColorPlus Pcs/Pallet		150	100	-	
NON-VENTED SMOOTH						
	Size	12 ft x 12 in	12 ft x 16 in	8 ft x 24 in	8 ft x 48	
	STATEMENT COLLECTION [™]					
	DREAM COLLECTION [™]	\checkmark	\checkmark	\checkmark		
	PRIME	\checkmark	\checkmark	\checkmark	\checkmark	
NON-VENTED SELECT CEDARMILL°						
	Size	12 ft x 12 in	12 ft x 16 in	8 ft x 24 in	8 ft x 48	
	STATEMENT COLLECTION TH					
	DREAM COLLECTION [™]	\checkmark	\checkmark	\checkmark		
	PRIME					
BEADED PORCH PANEL		BEADED POR	CH PANEL			
	Thickness	1/4 in	STATEMEN	r		
	Length	8 ft	COLLECTION			
	Length		DREAN			
	Length Width ColorPlus	48 in		1 🗸		

STATEMENT COLLECTION[™]

Make your next home stand out with our Statement Collection™ products. Carefully curated by our design experts specifically for your market, the collection brings together the most popular James Hardie ColorPlus® siding and trim styles, textures, and colors. This stunning selection is locally stocked and designed for simplicity - making it easier than ever to get a beautiful, long-lasting home exterior.

ColorPlus® Technology

Plank, Panel, Shingle and Batten Color Offering



Trim Color Offering



Colors shown are as accurate as printing methods will permit. Please see actual product sample for true color.

HardiePlank[®]

_		
	-	

 Width
 6.25 in
 8.25 in

 Exposure
 5 in
 7 in

SMOOTH



Width	6.25 in	8.25 in
Exposure	5 in	7 in

SELECT CEDARMILL° Size 4 ft x 10 ft SMOOTH Size 4 ft x 10 ft

Hardie Panel[®]

Hardie Shingle®



STRAIGHT EDGE PANEL

 Height
 14 in
 15.25 in

 Exposure
 5 in
 7 in

Hardie Trim[®]

4/4 SMOOTH



3.5 in 5.5 in 7.25 in

12 ft boards

5/4 SM00TH

Length

Width



3.5 in 4.5 in 5.5 in 7.25 in 11.25 in

12 ft boards

BATTEN BOARDS



.75 in

2.5 in

4/4 SMOOTH & RUSTIC GRAIN $^{\circ}$



Length

Width

Selecting a color? Request a product sample at **jameshardiepros.com/samples**

11.25 in

23

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Get Inspired

CRISP & CLEAN LIGHT COLORS


Whites and soft pastels are pure, clean, new and bright. Combine with other hues to add interest, personality and contrast. Works well on houses with Colonial Inspiration. A pastel A-frame cottage can look sweet and charming.




SUBTLE & SOPHISTICATED NEUTRAL COLORS

Neutral rules the suburbs. These shades are safe, but also sophisticated. When accessorized with black or a darker color, a neutral can look fashionably stylish. Play with textures and use different tones for trim.

Cobble Stone

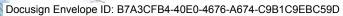

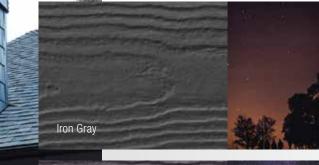





A BOLD CHOICE

Dark grays, blues and greens can feel both intellectual and modern. When used with white trim, they create drama. Works well in old neighborhoods, or urban environments, where there is a mix of old and new.



DREAM COLLECTION™

Looking to further express your sense of style? Look to our Dream Collection[™] products.

- Featuring a color palette of over 700 ColorPlus® Technology finishes
- Made to order in a wide array of James Hardie[®] siding and trim styles
- Matches elevated design flexibility with the uncompromising performance of our fiber cement products

To see what's possible and order Dream Collection product samples visit jameshardiepros.com/dream



HardieWrap®

No exterior cladding can prevent 100% of water intrusion. Your homes should have an additional line of defense. HardieWrap® weather barrier provides a superior balance of water resistance and breathability, keeping the area within the wall drier. This helps prevent moisture accumulation that may lead to mold and mildew growth.

INSTALLATION ADVANTAGES

- Thicker, more durable material for easier, quicker installation
- Superior tear resistance helps prevent water infiltration
- Can be installed with staples in place of cap nails for cost savings
- Provides a higher level of performance, no matter what type of cladding you specify

And a contract of the contract



WEATHER BARRIER

		•			
Thickness	11 mil				Thio
Length	100 ft	100 ft	150 ft	150 ft	Len
Width	3 ft	9 ft	9 ft	10 ft	Wid
PRO-FLAS	HING				SE/

Thickness	20 mil		
Length	75 ft	75 ft	75 ft
Width	4 in	6 in	9 in



ickness	60 mil	
ngth	75 ft	75 f
dth	6 in	9 in

SEAM TAPE

Thickness	3.2 mil
Length	164 ft
Width	1-7/8 in



To learn more about our weather barrier's advantages, visit **jameshardiepros.com**

Install Done Right

Installation Accessories

HARDIEBLADE® SAW BLADES

Manufactured by Diablo, the HardieBlade[®] saw blade is designed specifically to cut fiber cement products, and is the only saw blade James Hardie recommends. The blade creates clean, precise cuts while helping to reduce the amount of airborne dust produced. Specially designed to outlast other fiber cement saw blades by 3X, outlasting carbide blades by 60X.

PACTOOL® GECKO GAUGE

The PacTool[®] Gecko Gauge is designed to improve the installation experience, allowing one person to hang HardiePlank[®] lap siding during installation. Studies suggest the Gecko Gauge can improve the speed of solo installation by 30%.

Finishing Touches

ColorPlus® Technology Accessories

TOUCH-UP KITS

Specially formulated to match ColorPlus Technology finishes, our touch-up kits offer resistance to aging, color change and chalking. Estimated one kit per 4000 sq ft of siding or 1600 sq ft of trim.

COLOR MATCHED CAULK

OSI[®] QUAD[®] MAX sealant offers a high performance sealant solution to color match Statement Collection[™] products.* About 18-20 linear feet per tube. Refer to packaging for manufacturer's recommendations.

*For matching Dream Collection products, contact your local James Hardie representative.

Trim Accessories

FLAT TABS

Eliminate face nails and improve the aesthetic of trim applications around windows, doors and band boards.

CORNER TABS

Use corner tabs to eliminate face nail holes that would detract from the finished look of corner trim installations.

Find useful job-site tips in our industry-leading Best Practices Guide. For the latest installation instructions, visit **jameshardiepros.com**


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As unforgettable AS IT IS UNCOMPROMISING.

HardiePlank[®] Select Cedarmill[®] Timber Bark HardieTrim® Boards Arctic White



See the James Hardie Difference

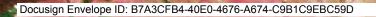

James Hardie invented fiber cement. Over 8 million homes* later, we continue to set the standard in premium, high-performance exterior cladding. Our products deliver uncompromising durability and finish quality for a beautiful, lower maintenance exterior.


Our unrivaled investment in R&D and constant innovations in product design, manufacturing and distribution allow us to remain steps ahead of the competition. With the support of our employees, partners and exceptional warranties, we're committed to protecting your customers' homes while helping your business grow.

*Estimate based on total James Hardie siding sales through 2016 and average housing unit size.

Warranty - for peace of mind

Protect your homes with North America's #1 brand of siding backed by exceptional warranties. Unlike other brands, James Hardie doesn't prorate our siding and trim warranty coverage. We stand behind our siding 100% for 30 years and trim for 15 years.

ColorPlus[®] Technology finishes come with a 15-year limited warranty.

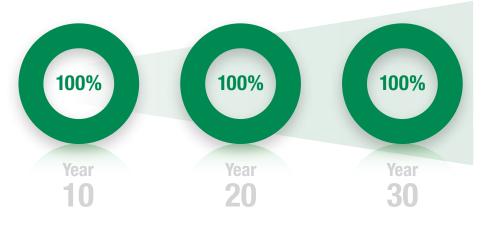

James Hardie Non-Prorated Siding Substrate Warranty Coverage

Endorsements – a reputation built on trust

For decades, our fiber cement products have been used to create better places to live. Each new home stands as a testament to our uncompromising quality. That proven track record has earned the loyalty of millions of homeowners and the endorsements of trusted authorities across the building industry.



Listed as top building materials & products by **Professional Builder 2018**



Chosen by builders as a Brand Leader in Builder magazine for over 20 years



James Hardie[®] siding & trim products have earned the Good Housekeeping Seal

HardieShingle[®] Straight Edge Pearl Gray

HardieTrim[®] Boards Arctic White

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Make every home STAND UP AND STAND OUT.

THE OWNER OF THE OWNER OWNER OF THE OWNER OWNE







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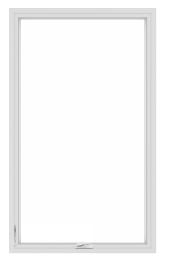


Where Home Begins with Therma-Tru doors.



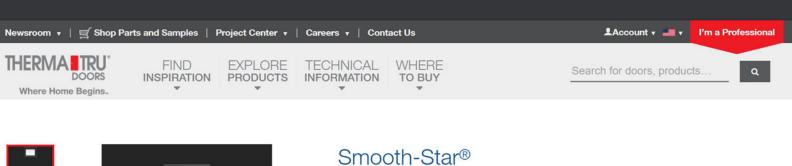

100 SERIES CASEMENT WINDOW

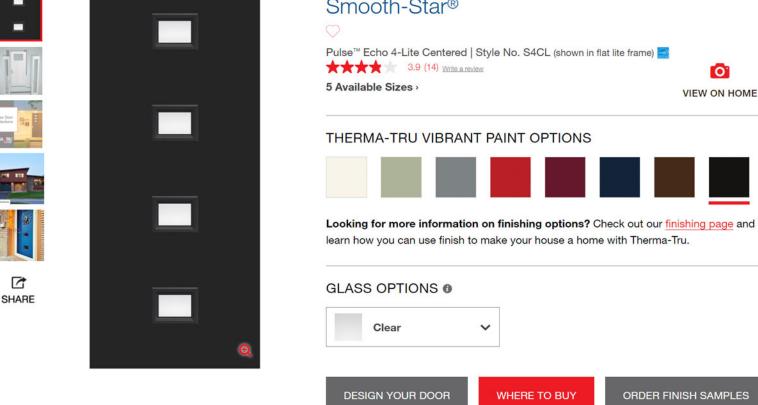

Interior

Exterior

Summary

Product ID#	100C\$3050
Unit Width	35 1/2"
Unit Height	59 1/2"
Interior Color	White
Glass	Low-E Glass
Hardware	Folding Lock and Keeper, White
Grille Pattern	None
Exterior Color	Black

