
1459 Edison St, Detroit, MI 48206

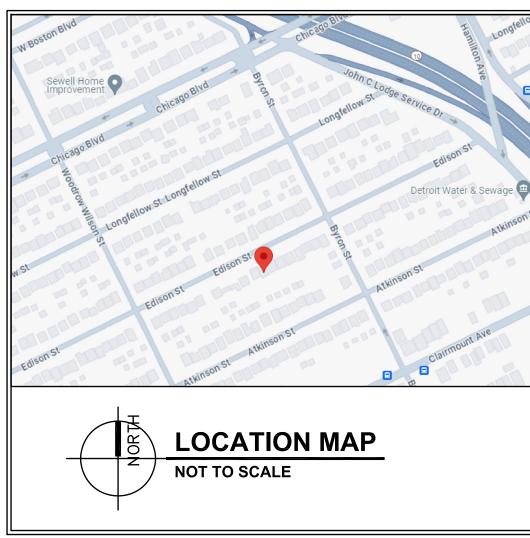

DRAWING LIST

A0.0- COVER SHEET AND PROJECT INFORMATION

A1.0- PROPOSED DECK PLANS, PROPOSED DECK STRUCTURAL FRAMING PLANS AND PROPOSED DECK ELEVATIONS

A2.0- PROPOSED DECK SECTIONS 1, 2 AND DECK LEDGER DETAILS



GENERAL NOTES

- (MICHIGAN RESIDENTIAL CODE 2015)
- THE G.C. IS RESPONSIBLE TO SET UP AND ATTEND A PRE-CONSTRUCTION MEETING WITH THE ARCHITECT AND HOME OWNER TO COVER ALL QUESTIONS, CONCERNS, POTENTIAL DISCREPANCIES AND
- 4. IN EVENT OF ANY DISCREPANCY IN THESE DOCUMENTS, THE CONTRACTOR IS TO STOP WORK IMMEDIATELY
- THE ARCHITECT ASSUMES NO RESPONSIBILITY FOR ANY CHANGE ORDERS OR ADDENDUMS RESULTING FROM CHANGE OF MIND, ERROR'S, OMISSIONS, OR DISCREPANCIES CAUSING ADDITIONAL WORK BY THE CONTRACTOR WITHOUT PROPER NOTIFICATION IN COMPLETE COMPLIANCE WITH THESE DOCUMENTS AND PRIOR WRITTEN CONSENT BY THE ARCHITECT.
- THE ARCHITECT ASSUMES NO RESPONSIBILITY FOR THE ACCURACY AND PROPER ASSEMBLY OF THE STRUCTURE WITHOUT VERIFYING ALL AS-BUILT CONSTRUCTION MEASUREMENTS. THE STRUCTURE MUST MATCH EXACTLY TO THE PROPOSED DRAWING DIMENSIONS. ANY NECESSARY ADJUSTMENTS OR
- COORDINATED WITH THE ARCHITECT.

STRUCTURAL NOTES

- MINIMUM CONCRETE STRENGTH TO BE 4000 P.S.I. @ 28 DAYS, U.N.O.; WITH 6% + 1% ENTRAINED, U.N.O.,
- 2. ALL CONCRETE WORK AND PLACEMENT SHALL CONFORM TO THE LATEST RECOMMENDATIONS OF A.C.I. 3" CONCRETE FOR PATCHING EXISTING SLABS SHALL BE EPOXY BASED HIGH STRENGTH (MIN. 4000 P.S.I.) CONTRACTOR TO SUBMIT PRODUCT DATA FOR REVIEW.

- ALL MASONRY WORK IS TO BE IN ACCORDANCE WITH THE LATEST BUILDING CODE REQUIREMENTS FOR MASONRY STRUCTURES (A.C.I. 530/ASCE 5) AND SPECIFICATIONS FOR MASONRY STRUCTURES (A.C.I. 530.1/ASCE 6) AND N.C.M.A.
- 2. MORTAR SHALL BE TYPE "S" (1800 P.S.I.) CONFORMING TO ASTM C-270., U.N.O. TYPE "N" MORTAR SHALL BE USED FOR TUCK POINTING TO BRICK.
- 3. ALL EXISTING JOINTS REQUIRING TUCK POINTING SHALL BE CUT BACK TO A DEPTH OF 1/2" MINIMUM.
- 4. PRIOR TO TUCK POINTING, ALL MORTAR JOINTS SHALL BE THOROUGHLY BRUSHED OUT REMOVING ALL dust and dirt.
- 5. PREMOISTEN JOINT STRUCTURE AND WHILE THE SURFACE IS STILL DAMP, THE JOINT SHALL BE TUCK POINTED USING A MIXTURE AS SPECIFIED.
- ALL MORTAR SHALL BE PRESSED INTO THE PREPARED JOINT STRUCTURE UNTIL THE JOINT IS PACKED FULL IN MAXIMUM 1/4" LAYERS. JOINT SHAPE SHALL MATCH EXISTING.
- 7. ALL CRACKED AND BROKEN UNITS SHALL BE REMOVED AND REPLACED, WITH NEW JOINTS STRUCK TO


- 1. ALL SHORING SHALL BE PERFORMED BY EXPERIENCED CONTRACTORS.
- 2. SHORE ALL AREAS PRIOR TO REMOVAL OF ANY STRUCTURAL SUPPORT TO INSURE STRUCTURAL
- 3. MAINTAIN SHORING UNTIL NEW PERMANENT STRUCTURE IS IN PLACE AND SECURE TO MAINTAIN STRUCTURAL INTEGRITY.
- 4. REMOVE SHORING AFTER NEW WORK IS IN PLACE AND CONNECTED.

- 1. WOOD CONSTRUCTION SHALL BE PER AMERICAN INSTITUTE OF TIMBER CONSTRUCTION (AITC) STANDARDS AND SPECIFICATIONS, AND NATIONAL DESIGN SPECIFICATION FOR WOOD CONSTRUCTION (NDS) AS PUBLISHED BY NATIONAL FOREST PRODUCTS ASSOCIATION.
- 2. ALL LUMBER FRAMING MEMBERS ARE TO HAVE THE FOLLOWING MINIMUM BASE DESIGN VALUES IN ACCORDANCE WITH THE LATEST ISSUE OF THE NATIONAL DESIGN SPECIFICATION FOR WOOD CONSTRUCTION (NDS) AS PUBLISHED BY THE NATIONAL FOREST PRODUCTS ASSOCIATION (NAPA): Fv = 75 P.S.I.
- E = 1,200,000
- NO. 2 OR BETTER
- 3. PROVIDE DOUBLE STUD AT EACH END OF WOOD HEADERS, TYPICAL, UNLESS NOTED OTHERWISE.
- 4. ALL LAMINATED VENEER LUMBER (L.V.L.) TO HAVE THE FOLLOWING MINIMUM DESIGN PROPERTIES BASED ON AITC GRADING STANDARDS: Fb = 2800 P.S.I.
- Fv = 285 P.S.I.E = 1,800,000
- 5. UNLESS OTHERWISE NOTED, PROVIDE (2) 2 x 8 HEADER FOR OPENINGS IN STUD WALLS FOR SPANS UP TO

<u>S</u>:

SHEET NAME:

COVER SHEET PROJECT INFORMATION

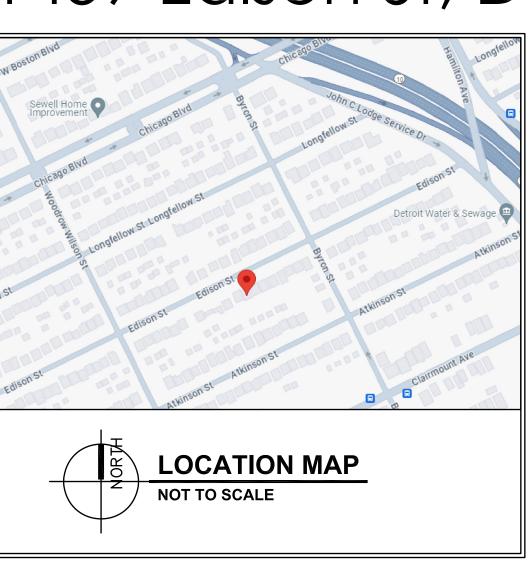

PROJECT DIRECTORY STUDIO515,LLC


248.207.6579

CONTACT:
RED POINT VENTURES LLC. STEVEN LUCARELLI 628 E PARENT AVE, SUITE 104 6 PARKLANE BLVD, SUITE 545 ROYAL OAK, MI 48067 DEARBORN, MI 48126 303.669.1747


- ALL WORK SHALL BE DONE IN ACCORDANCE WITH ALL LOCAL AND STATE CODE AND ORDINANCE
- THE G.C. IS REQUIRED TO FAMILIARIZE HIM / HER SELF WITH THE ENTIRE SET OF CONSTRUCTION DOCUMENTS AND ALL OF THE CONSTRUCTION DETAILS AND METHODOLOGIES PRESENTED PRIOR TO CONSTRUCTION. ANY QUESTIONS AND CONCERNS WILL BE DOCUMENTED AND PRESENTED IN A PRE-CONSTRUCTION

- COORDINATION TO THE STRUCTURE TO DUE DISCREPANCIES IN THE AS-BUILT CONSTRUCTION SHALL BE THE RESPONSIBILITY OF THE SELECTED GENERAL CONTRACTOR.
- THE ARCHITECT WILL NOT BE RESPONSIBLE FOR PROVIDING ANY INFORMATION REGARDING EXISTING OR PROPOSED HVAC, PLUMBING OR ELECTRICAL SYSTEMS OR ENGINEERING. ALL PROPOSED SYSTEMS TO BE




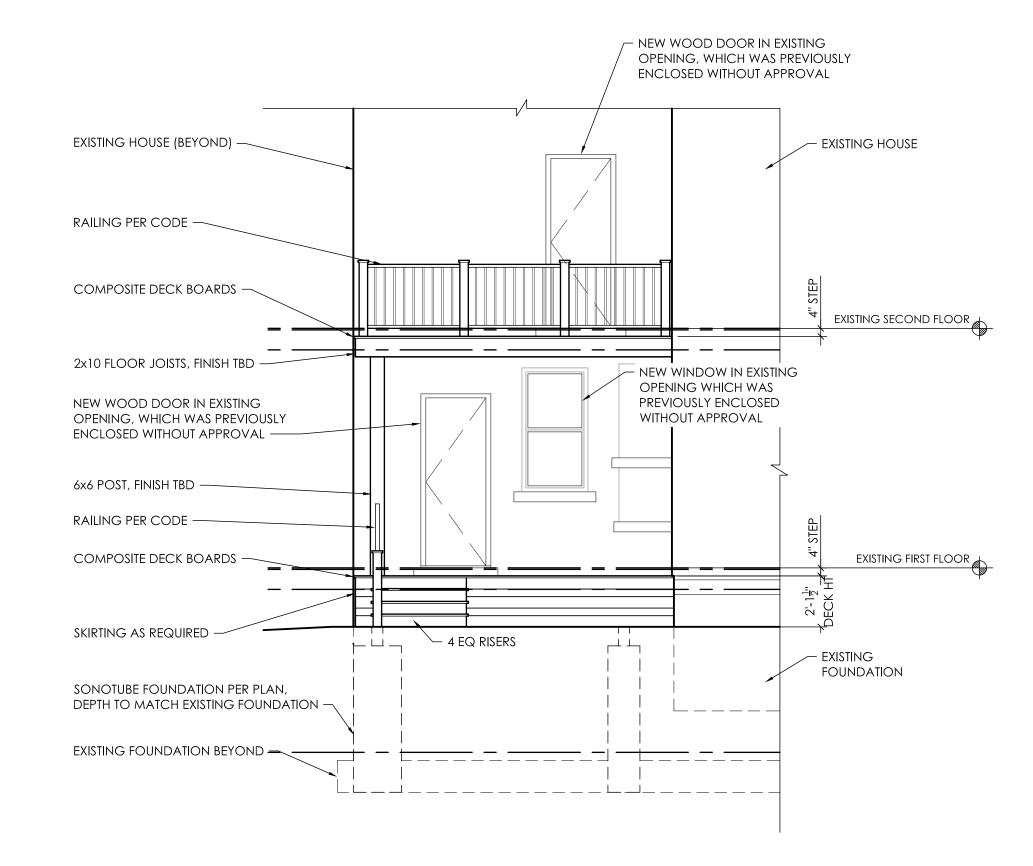




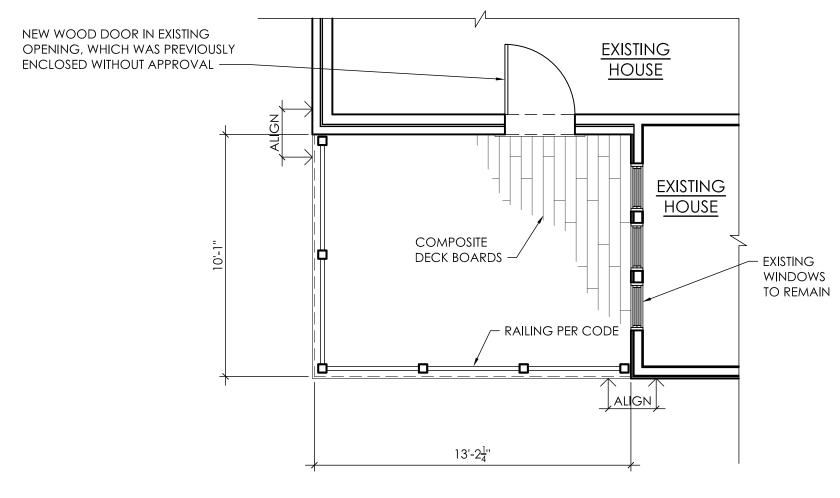

3 PROPOSED SECOND LEVEL DECK PLAN
A1.0 1/4" = 1'-0"

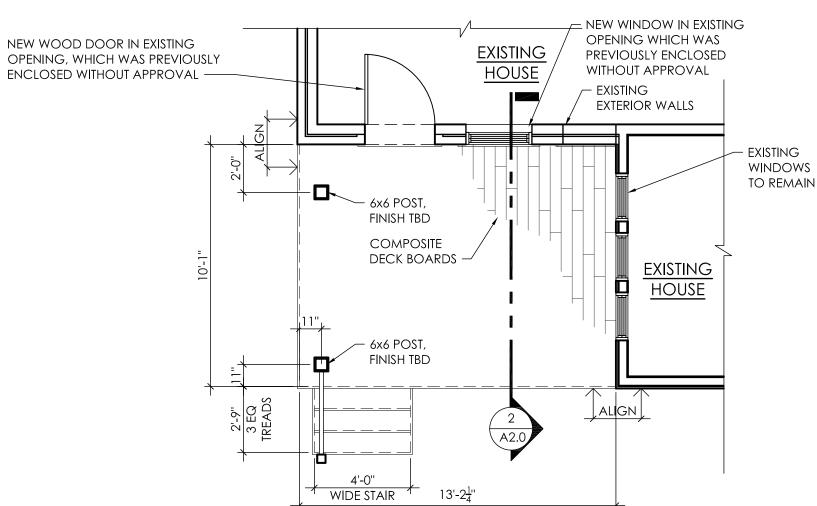

2 PROPOSED FIRST LEVEL DECK PLAN
A1.0 1/4" = 1'-0"

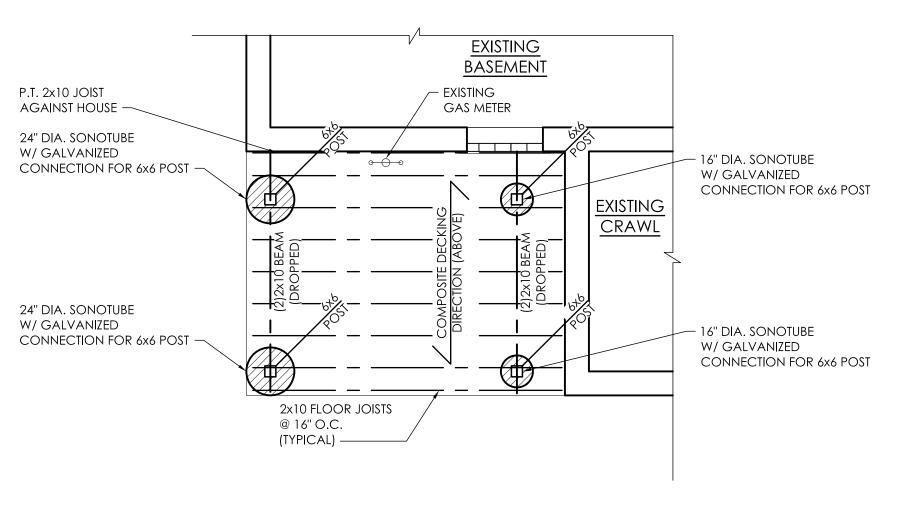

HOUSE

─ 2x10 FLOOR JOISTS @ 16" O.C.,

PROPOSED SECOND LEVEL DECK FRAMING PLAN

A1.0 / 1/4" = 1'-0"

to be hung from existing house,


SEE SECTION DETAILS FOR MORE INFO.

EXISTING

HOUSE

PROPOSED FIRST LEVEL DECK FRAMING PLAN

1/4" = 1'-0"

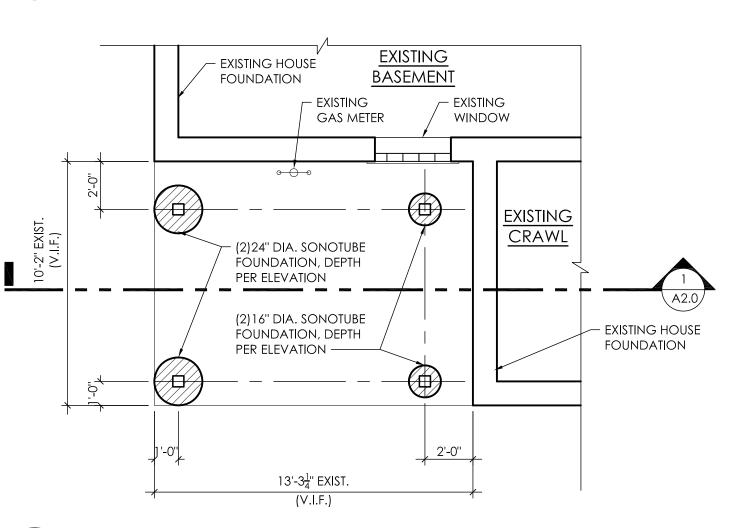

1 PROPOSED DECK FOUNDATION PLAN
A1.0 1/4" = 1'-0"

STUDIO 515, LLC

Residence

Private Reside
1459 Edison St,
Detroit, MI 48206


SHEET NAME:
PROPOSED DECK PLANS

PROPOSED DECK STRUCTURAL FRAMING

PLANS
PROPOSED DECK
ELEVATIONS

SUBMITTAL 06.12.2024

SHEET A 1.(

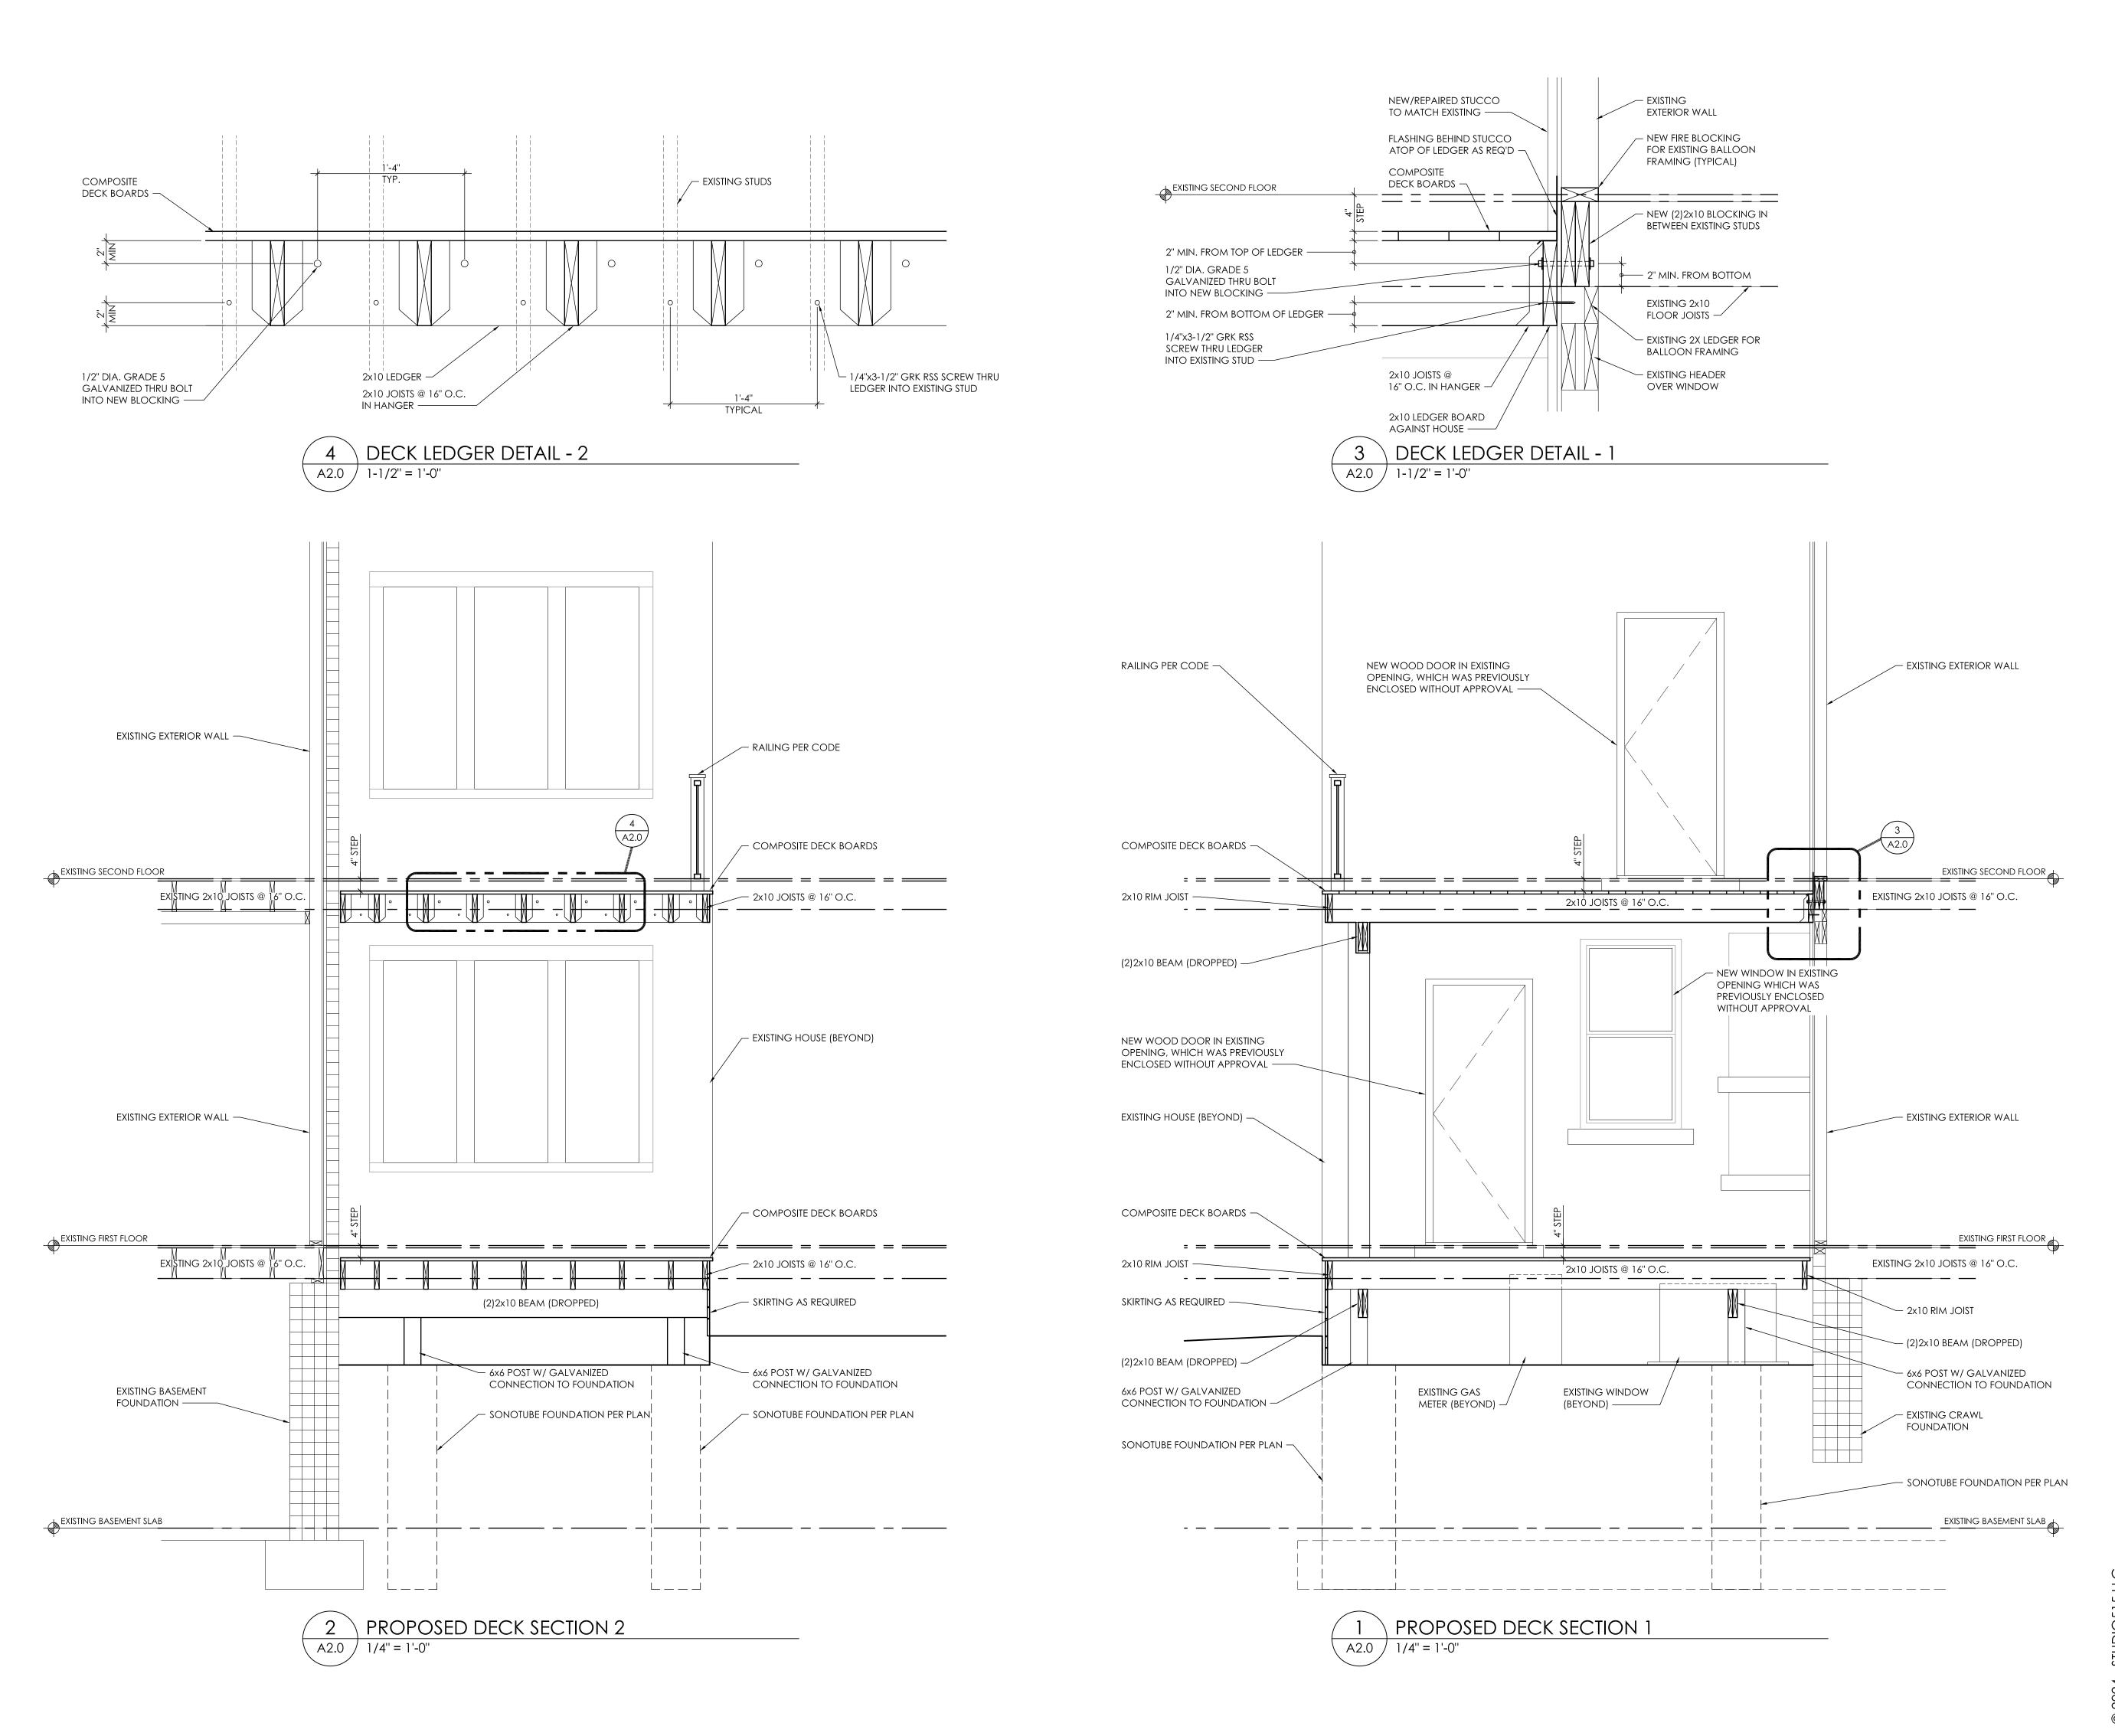

STUDIO**515.** Son St, 1 48206 Design ROYAL OAK, MI 48067 DOCUMENTATION (P)248.207.6579

Private Residen
1459 Edison St,
Detroit, MI 48206

SHEET NAME:

PROPOSED DECK
SECTIONS 1 AND 2

DECK LEDGER DETAILS

DATE: 05.31.2024

3MITTAL 06.12.2024

SHEET
A2.0