





February 6, 2024

City of Detroit – Historic District Commission Planning and Development Department Coleman A. Young Municipal Center 2 Woodward Avenue, Suite 808 Detroit, MI 48226

Re: Paradise Valley Cultural and Entertainment District Conservancy (PVC)

Redevelopment and Upgrade of Beatrice Buck Park (Harmonie Park) and Gratiot Plaza

Historic District Commission – Project Review Request Madison-Harmonie District, Section 21-2-151, Enacted May 16, 1988

To Daniel Rieden, PLA/ASLA

DESCRIPTION OF PROJECT

Paradise Valley Cultural and Entertainment District Conservancy (PVC) has partnered with Progressive AE, Inc. (as Architect and Engineer – Progressive AE) and Premier Group Associates LC (as Construction Manager – PGA) to plan, design, bid, and provide construction oversight for the Redevelopment and Upgrade of Beatrice Buck Park (Park) and Gratiot Plaza (Plaza).

The Park (1475 Randolph Street), located between Grand River Avenue, Center Street, and Randolph Street, is planned to receive repairs, improvements, and upgrades to pavements, lighting, landscaping, irrigation, furniture, equipment, sound system, festoon lighting, and projection lighting. These improvements are to be implemented in a phased approach with elements in Phase I to be completed before the National Football League (NFL) Draft starting on April 25, 2024. The remainder of improvements to be completed after the NFL Draft as Phase II.

The Plaza (**Not included in the Historic District**), located near 1427 Randolph Street and Gratiot Avenue is planned to receive repairs, improvements, and upgrades to pavements, lighting, landscaping, irrigation, restoration and relocation of existing statue, hardscaping, and festoon lighting. These improvements are planned to be implemented in the same timeline as the Park, with the remainder of improvements completed after the NFL Draft as Phase II.

This is a unique project due to the fact that the work to be accomplished lies entirely within City of Detroit (Detroit) public right-of-way, Detroit Parks and Recreation Owned Park Parcel, or within Gratiot Avenue right-of-way under Michigan Department of Transportation (MDOT) jurisdiction.

DESCRIPTION OF EXISTING CONDITIONS AND SCOPE OF WORK

Please refer to:

- Madison-Harmonie Historic District Map (from Final Report, May 16, 1988)
- 2024 01 12 HDC Park and Plaza Signed Application.pdf
- 2024 01 15 Paradise Valley Photos.pdf (Per Itemized list below)
- 2024 02 01 Paradise Valley Presentation Boards.pdf
- 2024 02 06 Paradise Valley Construction Drawings.pdf

Beatrice Buck Park (Harmonie Park) and Gratiot Plaza

- A. Park & Plaza: Perimeter sidewalk: Where cracked, will be removed and replaced. If in good condition, will be power-washed.
- B. **Park & Plaza:** Perimeter Pole Luminaires: Acorn top lights to remain, upgrade to LED fixtures. Ornamental fluted poles and bases to be re-painted. Where fixtures are damaged, will be replaced in kind.
- C. Park Only: Stone Walls: Will be cleaned, mortar replaced, and re-pointed to restore to original condition.
- D. Park & Plaza: Trees and Landscaping: Trees will all remain in place. Ivy to be reduced to trunk of trees
- E. Park Only: Interior Park Pavers: Where cracked, will be replaced and repaired, power-washed to refresh.
- F. **Park Only:** Terrazzo Historic Paver Medallions (Artist Hubert Massey): Featuring historical figures, musicians, and community leaders that influenced the area known as Paradise Valley, are to be cleaned and remain in place.
- G. **Park Only**: Michigan Registered Historic Site Markers "Germantown" and "The Harmonie Club" would remain, as well as Detroit Recreation Departments' "Beatrice M. Buck" Paradise Valley Park marker.
- H. **Park & Plaza:** Stairs and Handrails: To be removed and replaced per Americans with Disabilities Act (ADA) standards. Handrail downlights would illuminate the stairs between dusk and dawn hours.
- I. Park Only: Interior black sawtooth sculpture would be cleaned.
- J. Park & Plaza: Interior uplights in pavers, wall washers, and tree uplights would be removed and replaced with LED fixtures, as well as the light under the concrete stage.
- K. Park Only: Sound speakers would be removed and replaced with new speakers.
- L. **Park Only:** The MoGo electric bike station would remain for mobility purposes.
- M. Park Only: The Existing Furniture and Litter Receptacles would be removed and replaced.
- N. Park Only: The Water Blade Fountain Feature by the concrete stage would remain.
- O. The irrigation system would remain and be updated to serve the new landscaping needs.
- P. **Park Only:** 100W and 300W projection lighting to be installed for Paradise Valley image projections onto nearby buildings at: 267 Grand River Avenue, 1465 Center Street, and sidewalk adjacent and interior to Park (not in roadway).
- Q. Park & Plaza: New Festoon Lighting and Poles.
- R. Park & Plaza: New Planter Pots for landscaping.
- S. Park & Plaza: New Low Maintenance Perennials, Bulbs, and Grasses.
- T. Park & Plaza: New Landscaping Annuals placed for color accents.
- U. Plaza Only: Clean, Repaint, and Relocate Existing Sculpture.
- V. Park & Plaza: Power pedestals to be replaced.
- W. Plaza Only: Concrete Stairs to be removed, increase paver area, and connect concrete retaining wall.


We appreciate the opportunity to meet with you to plan with the City of Detroit for approvals on these improvements.

Sincerely,

Daniel W. Westenburg, PE, LEED AP, CDT Senior Civil Engineer

DWW/ecy

P:\97080001\04 DELIVERABLES\2024 01 15 Historic District Review\1 2024 01 15 Paradise Valley Beatrice Buck Park and Gratiot Plaza Narrative Letter.docx

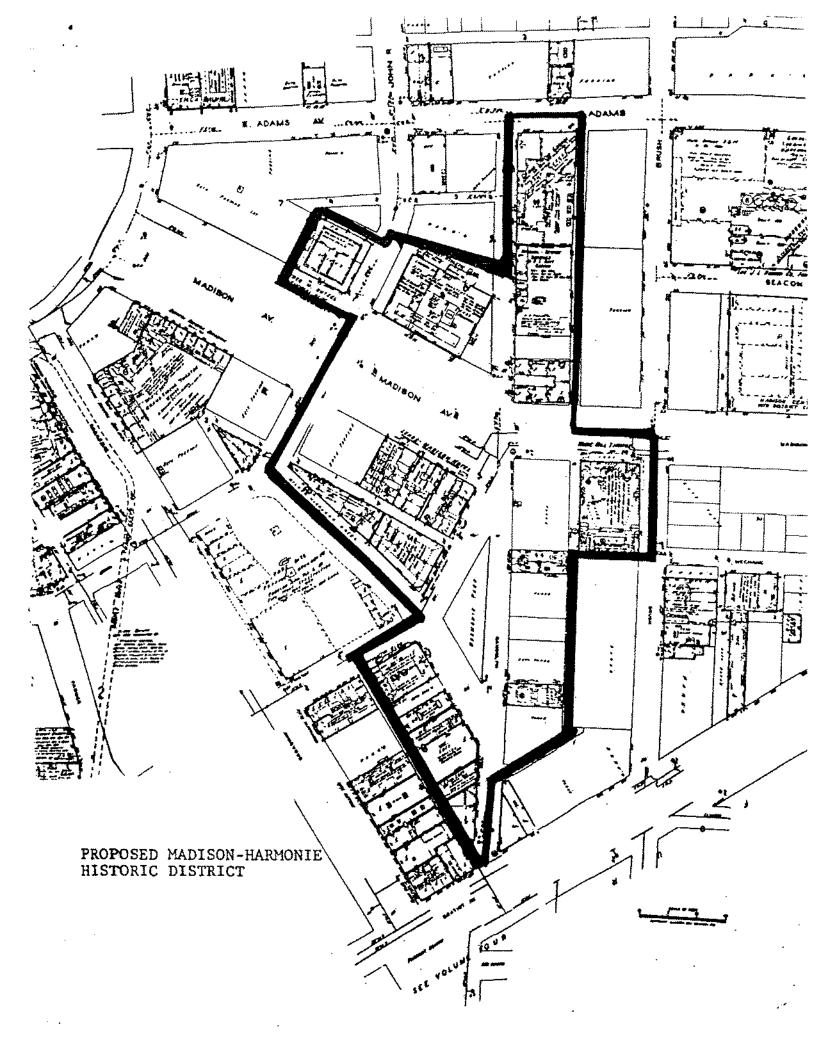

THIS IS A 3-PAGE FORM - ALL INFORMATION IS REQUIRED FOR PROJECT REVIEW

HISTORIC DISTRICT COMMISSION PROJECT REVIEW REQUEST

DATE: 1/12/2024

City of Detroit - Planning & Development Department 2 Woodward Avenue, Suite 808 Detroit, Michigan 48226

PROPERTY INFORMATION	是在10年,10年,10年,10年,10年,10年,10年,10年,10年,10年,	
ADDRESS(ES): 1475 Randolph Street	AKA: Beatrice Buck Park / Gratiot Plaza	
PARCEL ID: 01003945	HISTORIC DISTRICT: B4 & B5	
SCOPE OF WORK: Windows/ Siding Check ALL that apply) Demolition Signage	Painting Roof/Gutters/ Porch/Deck/ Addition New Building (3+ scope items) Site Improvements (/andscape, trees, fences, patios, etc.)	
	ment and Upgrade of Beatrice Buck Park (Harmonie Park)	
APPLICANT IDENTIFICATION		
Property Owner/ Homeowner NAME: Daniel W. Westenburg	Tenant or Business Occupant Architect/Engineer/Consultant COMPANY NAME: Progressive AE	
ADDRESS: 2937 E. Grand Blvd, Ste 505	CITY: Detroit STATE: MI ZIP: 48202	
PHONE: 616.361.2664 MOBILE: 61	6.307.0357 EMAIL: westenbd@progressiveae.@	
PROJECT REVIEW REQUEST CH	ECKLIST	
Please attach the following documentation * PLEASE KEEP FILE SIZE OF ENTIRE SUBMISSIO	INOTE:	
Completed Building Permit Application (highlighted portions only) Based on the scope of work, additional documentation may be required.		
ePLANS Permit Number (only applicable applied for permits through ePLANS)	le if you've already See www.detroitmi.gov/hdc for scope- specific requirements.	
Current Photographs: Including the front of the building & detailed photographs of the area(s) affected by the proposed work. All photographs must be labeled or captioned, e.g. "west wall", "second floor window," etc.		
Description of existing conditions (including materials and design)		
Description of project (if replacing any replacementrather than repairof exist	existing material(s), include an explanation as to why ting and/or construction of new is required)	
Detailed scope of work (formatted as b	ulleted list)	
Brochure/cut sheets for proposed repla	cement material(s) and/or product(s), as applicable	
Upon receipt of this documentation, staff will rev	iew and inform you of the next steps toward obtaining your building	

SUBMIT COMPLETED REQUESTS TO: HDC@DETROITMI.GOV

permit from the Buildings, Safety Engineering and Environmental Department (BSEtED) to perform the work.

P2 - BUILDING PERMIT APPLICATION

					Date: 1/12/2024
PROPERTY INFORMATIO	ON				
Address: 1475 Randolph Street		F	loor: NA	Suite	e#:Stories:
AKA; Beatrice Buck Park / Grati					
Parcel ID#(s): 01003945	Tot	al Acres: 0.235	Lot '	Width: IRF	Lot Depth: IRR
Current Legal Use of Property:					
Are there any existing buildings				Yes	
PROJECT INFORMATION	ı				
Permit Type: New	Alteration	Addition	■ De	emolition	Correct Violations
Foundation Only Chai					
Revision to Original Permit		_	_		s been issued and is active)
Description of Work (Describe			_		
Redevelopment and Upgrades for the Pa					
lighting, electrical, landscaping, furniture, sound sys	stem, festoon lighting, p	rojection lighting, and fa	citizated space	s for food trucks	and venue / operator planned events
		☐ MB	C use ch	ange 🔳	No MBC use change
Included Improvements (Che	ck all applicable;	these trade areas	s require s	eparate per	nit applications)
HVAC/Mechanical	ectrical	Plumbing [Fire S	prinkler Sy	stem Fire Alarm
Structure Type					_
New Building Existing	g Structure	Tenant Spa	се	Garage/	Accessory Building
Other: N/A. Park & Plaza Size	_	_	_		
Construction involves changes t			Yes	■ N	
(e.g. interior demolition or constructio					
Use Group: Typ	pe of Construc	tion (per current	t MI Bldg (Code Table 8	601)
Estimated Cost of Construction				\$	
Structure Use		By Contractor			By Department
Residential-Number of Units:	Office-G	ross Floor Area _		Industri	al-Gross Floor Area
Commercial-Gross Floor Area:					
Proposed No. of Employees:					
PLOT PLAN SHALL BE submitted (must be correct and in detail). St existing and proposed distances	HOW ALL street to lot lines. (Bu	ets abutting lot ilding Permit A	, indicate pplication	front of lo Continues	ot, show all buildings,
		Department l			
ntake By:		Date:	_ Fees	Due:	DngBld? No
Permit Description:					
Current Legal Land Use:		Prop	oosed Us	e:	
Permit#:					
Zoning District:		Zoning G	Grant(s):		
Lots Combined?	☐ No	(attach zoning o	learance)		
Revised Cost (revised permit applic	cations only) Old	d\$		New \$	
Structural:					
Zoning:					
Other:		Date:	No	tes:	

Permit #:

IDENTIFICATION (All Fields Required)	
Property Owner/Homeowner	perty Owner/Homeowner is Permit Applicant
Name:	Company Name:
Address:	City: State: Zip:
Phone:	Mobile:
Driver's License #:	Email:
Contractor is Permit Appl	icant
Representative Name: Brad Byarski	Company Name: Premier Group Associates
Address: 2221 Bellevue	City: Detroit State: MI Zip: 48207 1886 Email: brad@pgalc.com
Phone: 313.963.1700 Mobile: 313.363.	1886 Email: brad@pgalc.com
City of Detroit License #: LIC 2021 - 00	701
TENANT OR BUSINESS OCCUPANT	Tenant is Permit Applicant
	Email:
rnone:	(Critalia)
ARCHITECT/ENGINEER/CONSULTANT	Architect/Engineer/Consultant is Permit Applicant
Name: Daniel W. Westenburg State Reg	pistration#: 6201049263 Expiration Date: 07/22/2024
	City. Detroit State: MI Zip: 48202
Phone: 616.361.2664 Mobile: 616.307.	0357 Email: westenbd@progressiveae.com
HOMEOWNER AFFIDAVIT	ired for residential permits obtained by homeowner.)
	supant of the subject property and the work described
on this permit application shall be completed by requirements of the City of Detroit and take full r	me. I am familiar with the applicable codes and esponsibility for all code compliance, fees and described. I shall neither hire nor sub-contract to any
Print Name: Signa (Homeowner)	ature: Date:
	of20A.DCounty, Michigan
Signature:	My Commission Expires:
(Notary Public)	
PERMIT APPLI	CANT SIGNATURE
restrictions that may apply to this construction at certify that the proposed work is authorized by the to make this application as the property owner(s all applicable laws and ordinances of jurisdiction	he owner of the record and I have been authorized) authorized agent. Further I agree to conform to . I am aware that a permit will expire when no iin 180 days of the date of issuance or the date of
Print Name: Nevan Shokar Signa	iture: Ne Date: 1/12/2024
(Permit Applicant)	04/10/2025
Driver's License #: \$260 626 766 280	Expiration: 04/10/2025
Subscribed and sworn to before me this 2th day of Signature: Nidestra Smalt (Notary Public)	of Anusin 20 ay A.D. Wayne County, Michigan My Commission Expires: 09/22/2027
prohibits a person from conspiring state relating to persons who are	code act of 1972, 1972PA230, MCL 125.1523A, to circumvent the licensing requirements of this to perform work on a residential building or a of Section 23a are subject to civil fines.

This application can also be completed online. Visit detroitmi.gov/bseed/elaps for more information.




P2 - BUILDING PERMIT

Page 2 of 2

HISTORIC DISTRICT COMMISSION REVIEW & PERMIT PROCESS

SUBMIT COMPLETE APPLICATION TO HDC STAFF

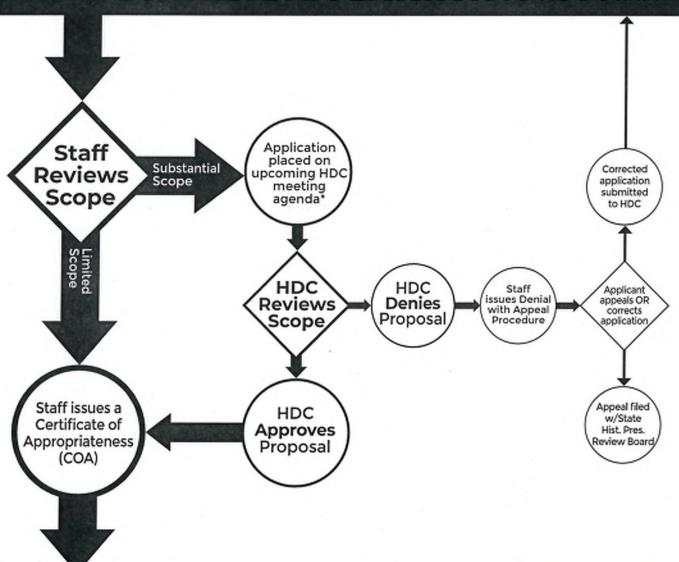

OBTAIN BUILDING PERMIT


FROM BUILDINGS, SAFETY ENGINEERING AND ENVIRONMENTAL DEPT. (BSEED)

FIND OUT MORE AT: WWW.detroitmi.gov/hdc

^{*} THE COMMISSION MEETS REGULARY AT LEAST ONCE PER MONTH, TYPICALLY ON THE SECOND WEDNESDAY OF THE MONTH. (SEE WEBSITE FOR MEETING SCHEDULE/AGENDAS)

PARADISE Valley

HISTORIC DISTRICT COMMISSION PROJECT REVIEW JANUARY 15, 2024

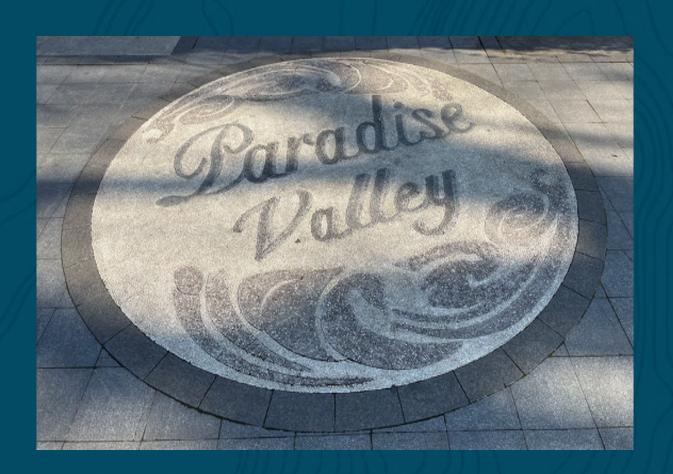

REDEVELOPMENT AND UPGRADE OF BEATRICE BUCK PARK (HARMONIE PARK) AND GRATIOT PLAZA




A. Perimeter sidewalk: Where cracked, will be removed and replaced. If in good condition, will be power-washed.





C. Perimeter Pole Luminaires: Acorn top lights to remain, upgrade to LED fixtures. Ornamental fluted poles and bases to be repainted. Where fixtures are damaged, will be replaced in kind.

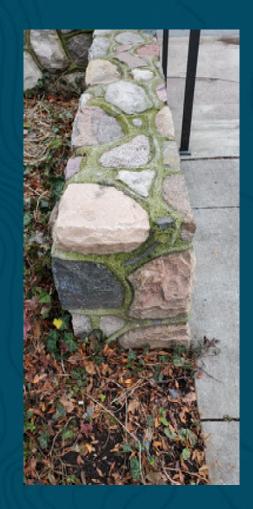





D. Stone Walls: Will be cleaned, mortar replaced and re-pointed to restore to original condition.




E. Trees and Landscaping:

Trees are to be pruned and ivy cut back to trunks and selectively removed from landscaping areas



F. Interior Park Pavers: Where cracked, will be replaced and repaired, power-washed to refresh



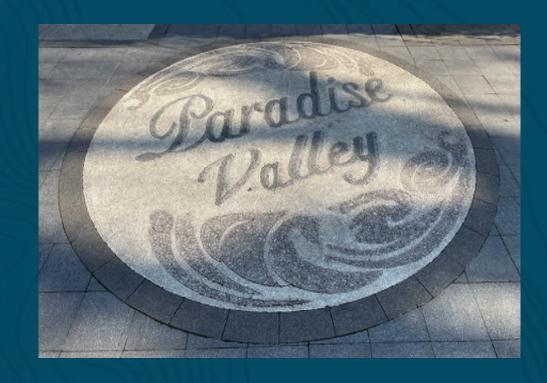


G. 21 Terrazzo Historic Paver Medallions (Artist Hubert Massey): featuring historical figures, musicians, and community leaders that influenced the area known as Paradise Valley, are to be restored and remain in place.






(clockwise from top)
Cab Calloway
Louis Armstrong
Billie Holliday
Charlie Parker

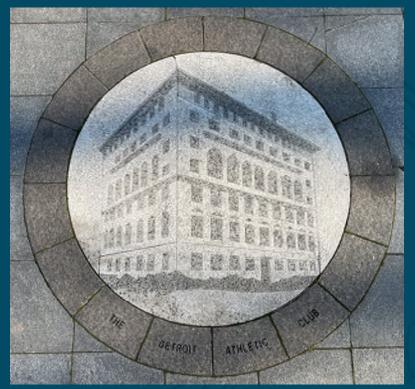

The Detroit Athletic Club

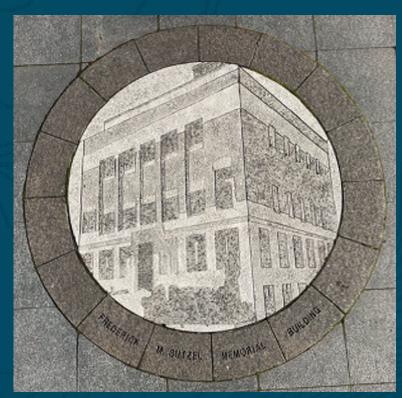


Frederick M. Butzel Memorial Building



Music Hall




The Harmonie Club

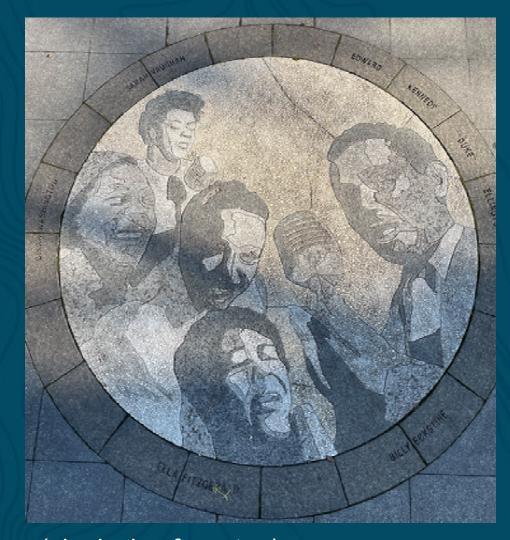

(clockwise from top)
Edward Kennedy "Duke" Ellington
Billy Eckstine
Ella Fitzgerald
Dinah Washington
Sarah Vaughn




Rolovest

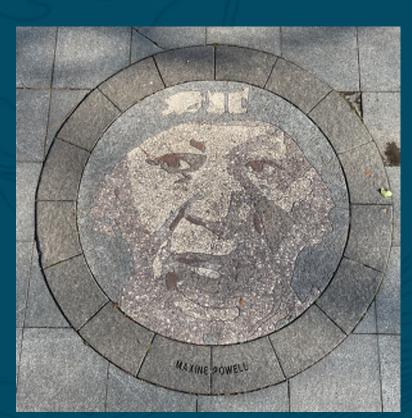

Maxine Powell



Irving Roane & John J. White

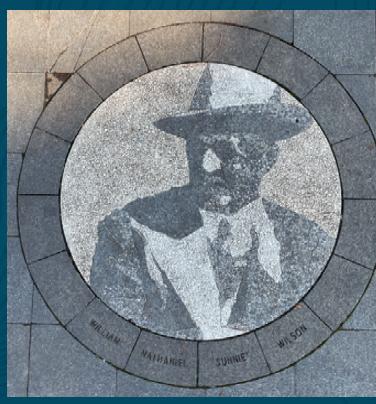

William Nathaniel "Sunnie" Wilson




Joe "Ziggy" Johnson



Richard H. Austin & Sidney Barthwell




Yusef Lateef

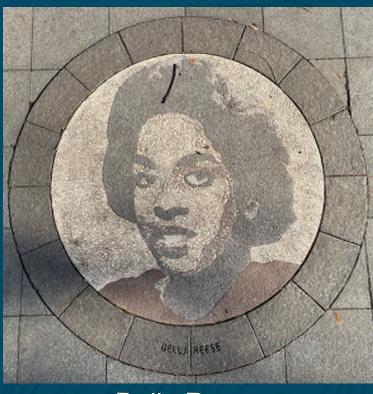

Della Reese




Alberta Adams

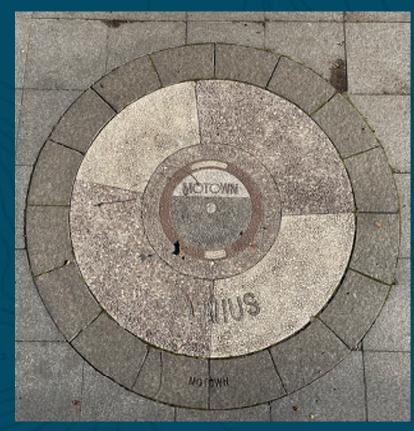

Motown



Paul Robeson

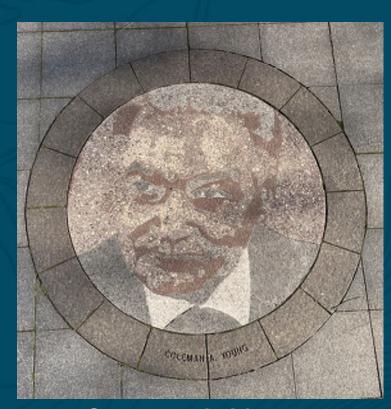

Coleman A. Young




Dudley Randall & Robert Hayden




Joe Louis Barrow



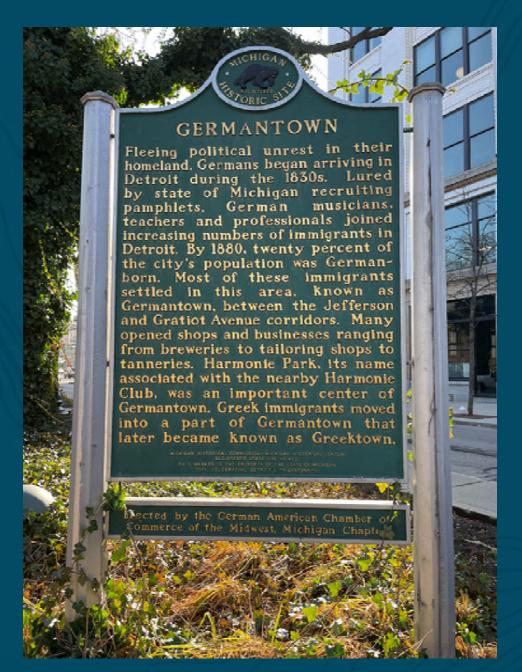




H. Michigan Registered Historic Site Markers "Germantown" and "The Harmonie Club" would remain, as well as Detroit Recreation Departments' "Beatrice M. Buck" Paradise Valley Park marker.

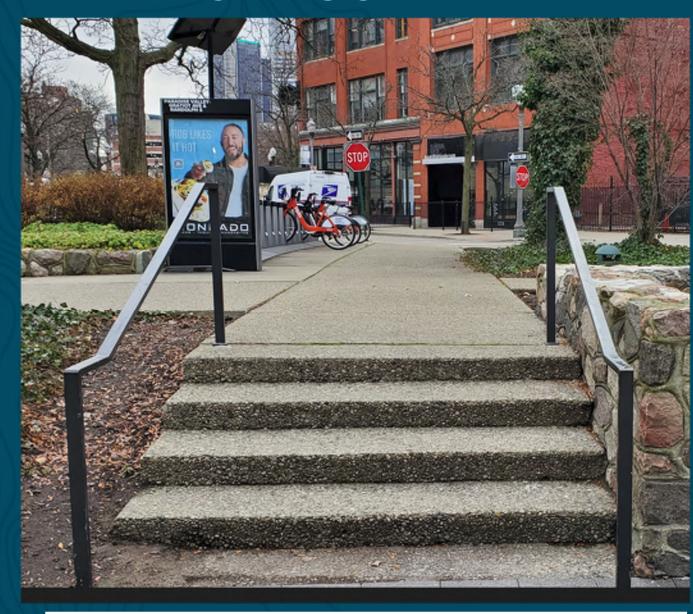



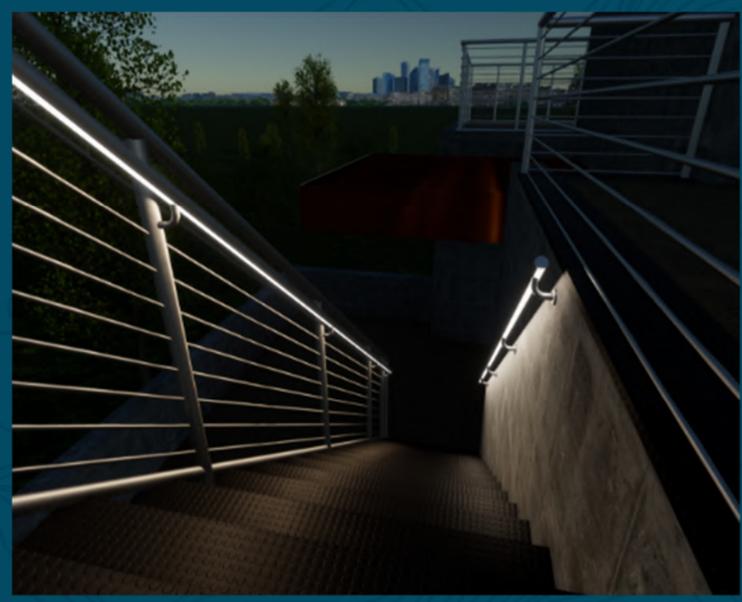

Handrail downlights would illuminate the stairs between dusk and dawn hours.



J. Interior black sawtooth sculpture to be repainted and restored.



- K. Interior uplights in pavers, wall washers, and tree uplights would be removed and replaced with LED fixtures, as well as the light under the concrete stage.
- L. Sound speakers would be removed and replaced.











M. The MoGo electric bike station would remain for mobility purposes



N. The Existing Furniture and Litter Receptacles would be removed and replaced.





O. The Water Blade Fountain Feature by the concrete stage would remain.



P. The irrigation system would remain and heads would be updated to serve the new landscaping needs.



GRATIOT PLAZA




A. Perimeter sidewalk: Where cracked, will be removed and replaced. If in good condition, will be power-washed.





C. Perimeter Pole Luminaires: Acorn top lights to remain, upgrade to LED fixtures. Ornamental fluted poles and bases to be repainted. Where fixtures are damaged, will be replaced in kind.



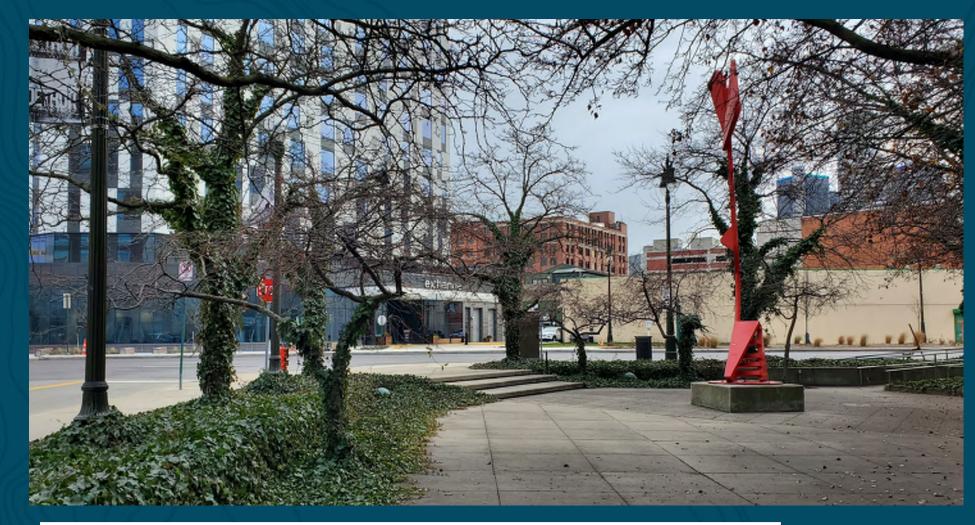

E. Trees are to be pruned and ivy cut back to trunks and selectively removed from landscaping areas




F. Pavers to be replaced with patchwork pavers

• GRATIOT PLAZA





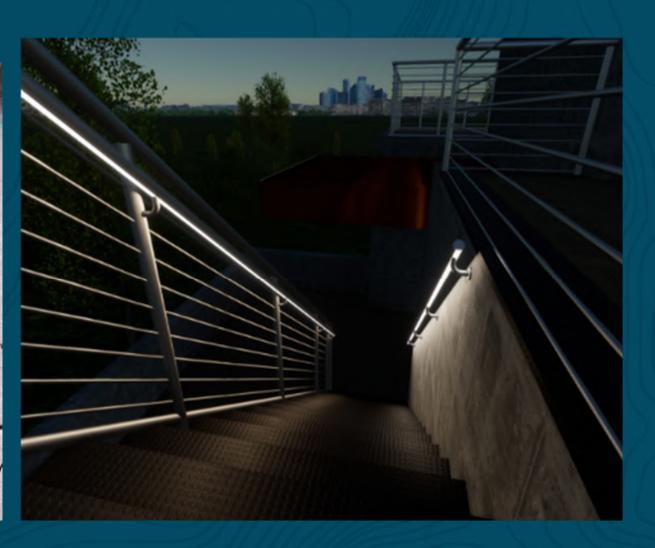

Handrails are to be replaced with downlit handrails. Stairs are to remain in place.

Handrail downlights would illuminate the stairs between dusk and dawn hours.

• GRATIOT PLAZA









GRATIOT PLAZA



Y. Power pedestals to be replaced.





Z. Concrete Stairs to be removed, increase paver area & connect concrete retaining wall

progressive




Paradise Valley Cultural & Entertainment District

Renovations and Upgrades to Beatrice Buck Park and Gratiot Plaza




progressive ae

Date: February 1, 2024

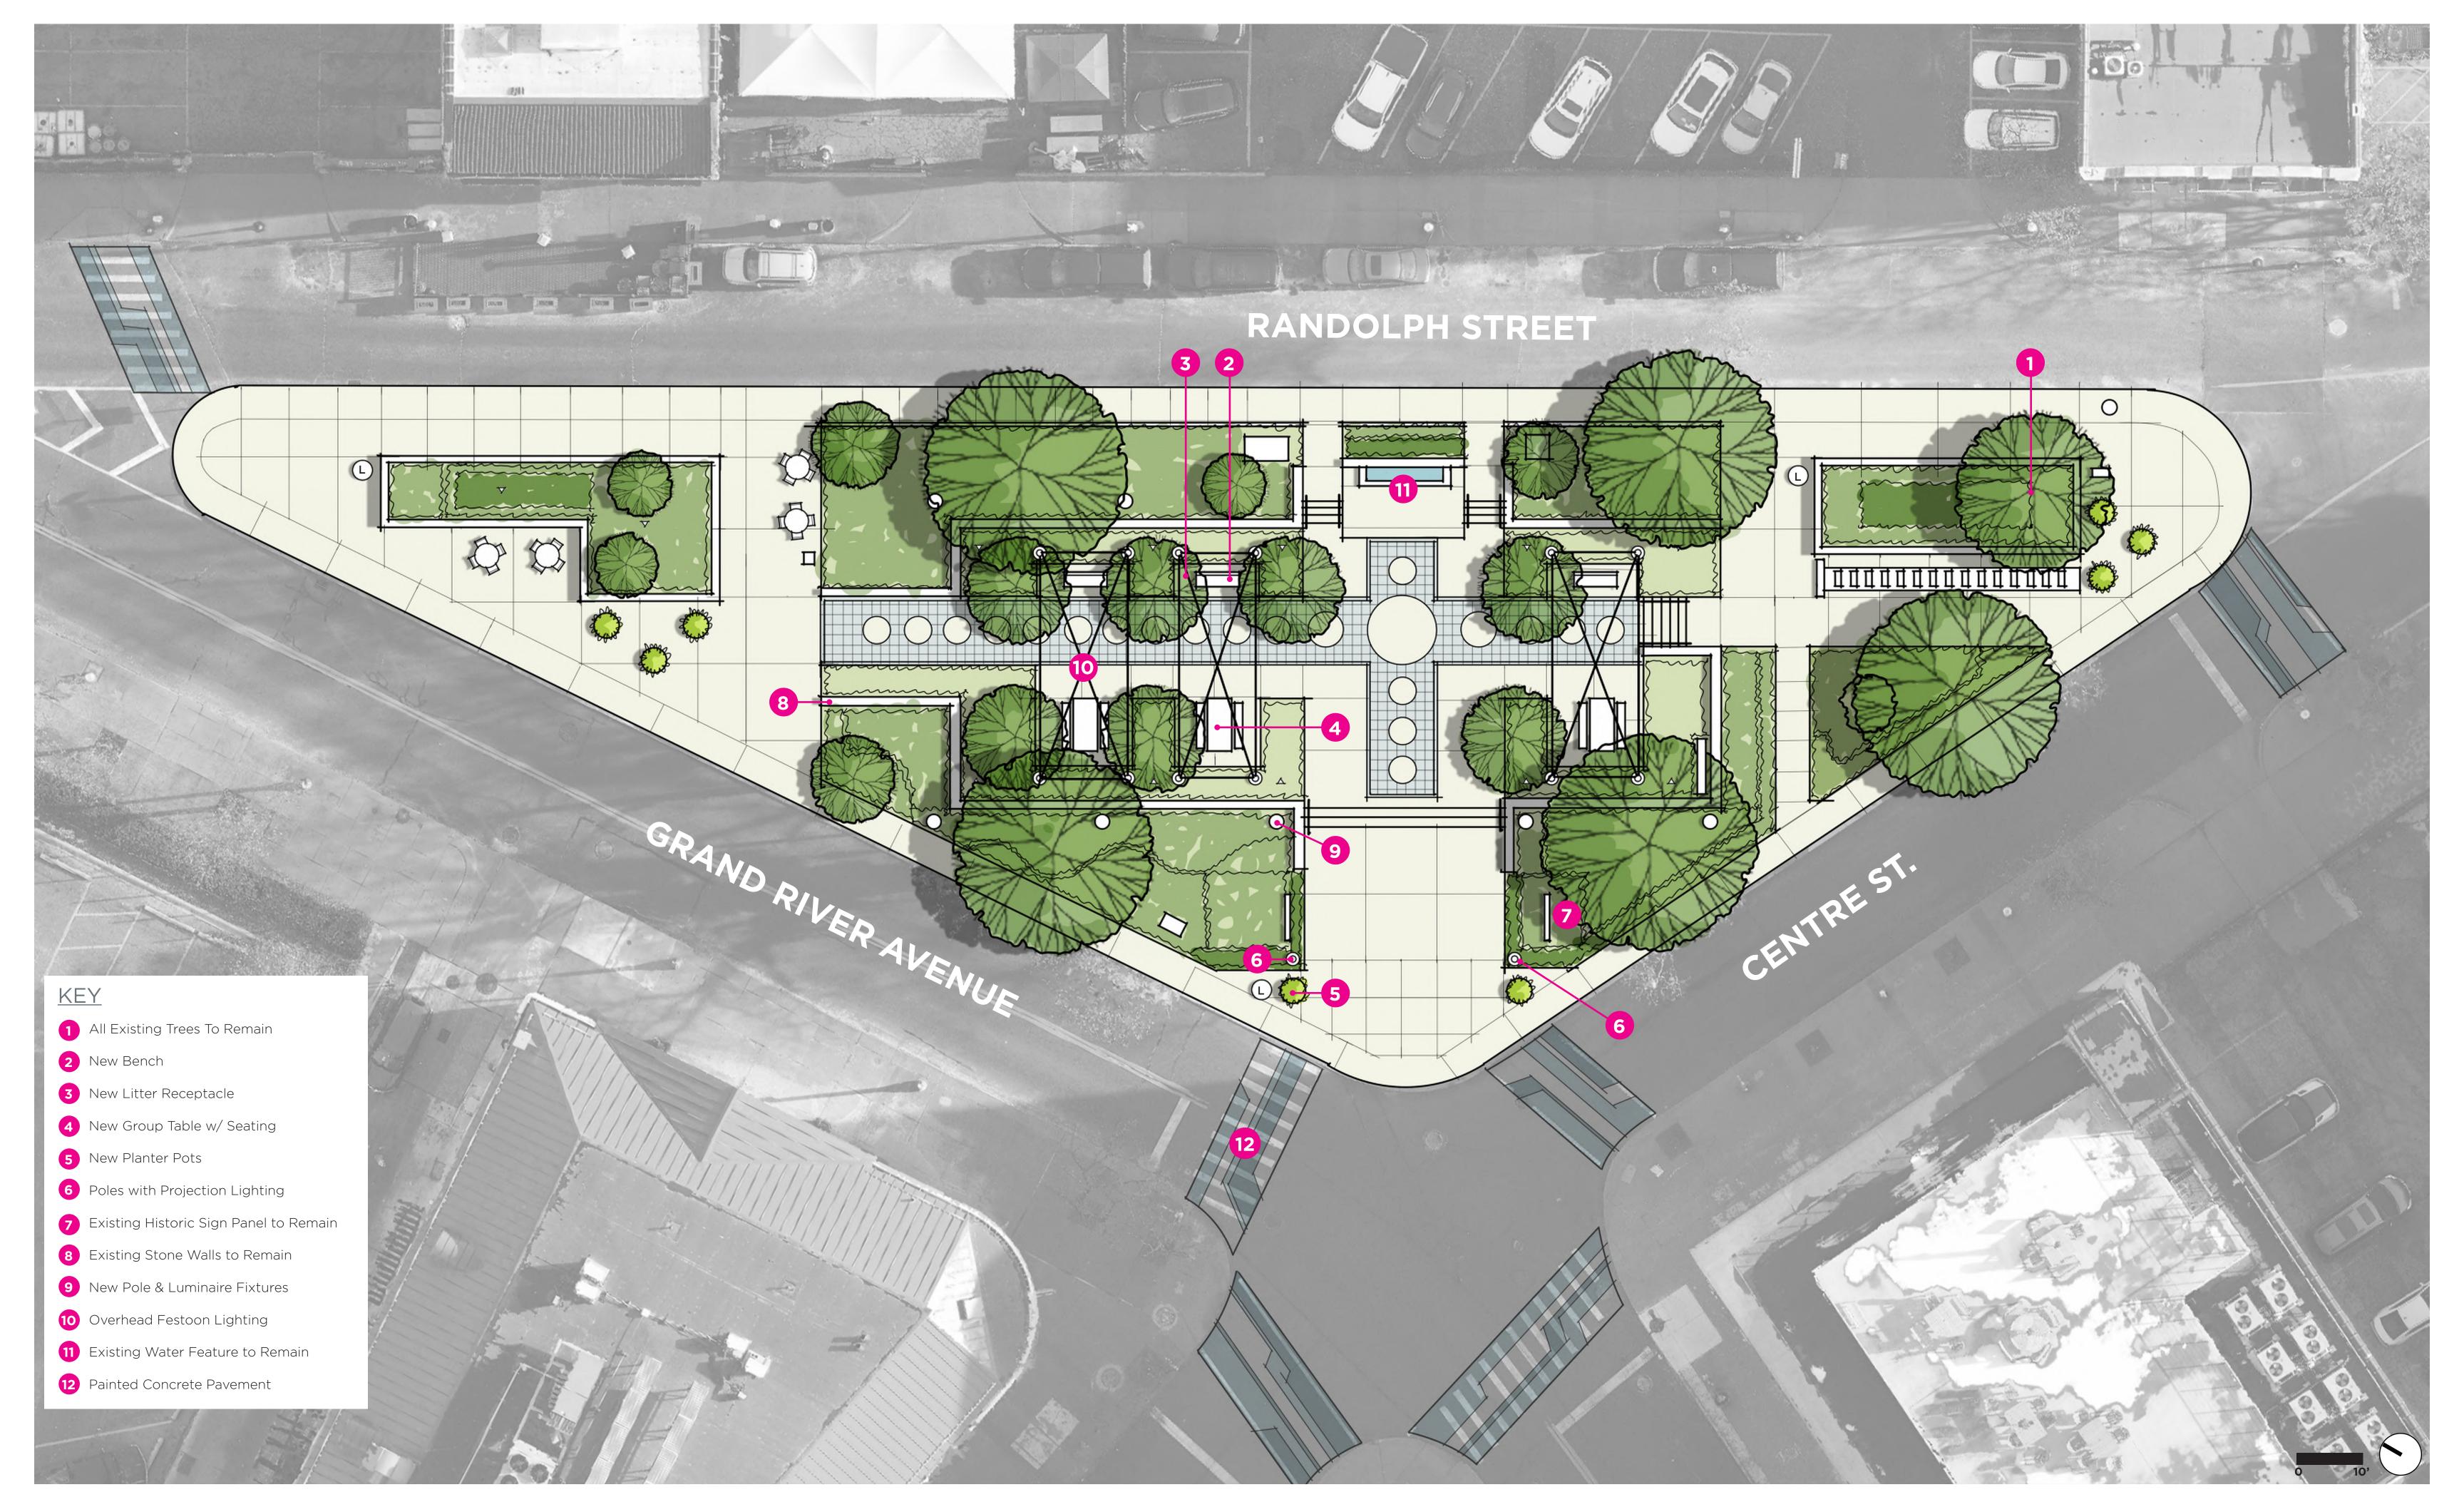




BEATRICE BUCK PARK - CONCEPT IMPROVEMENT PLAN

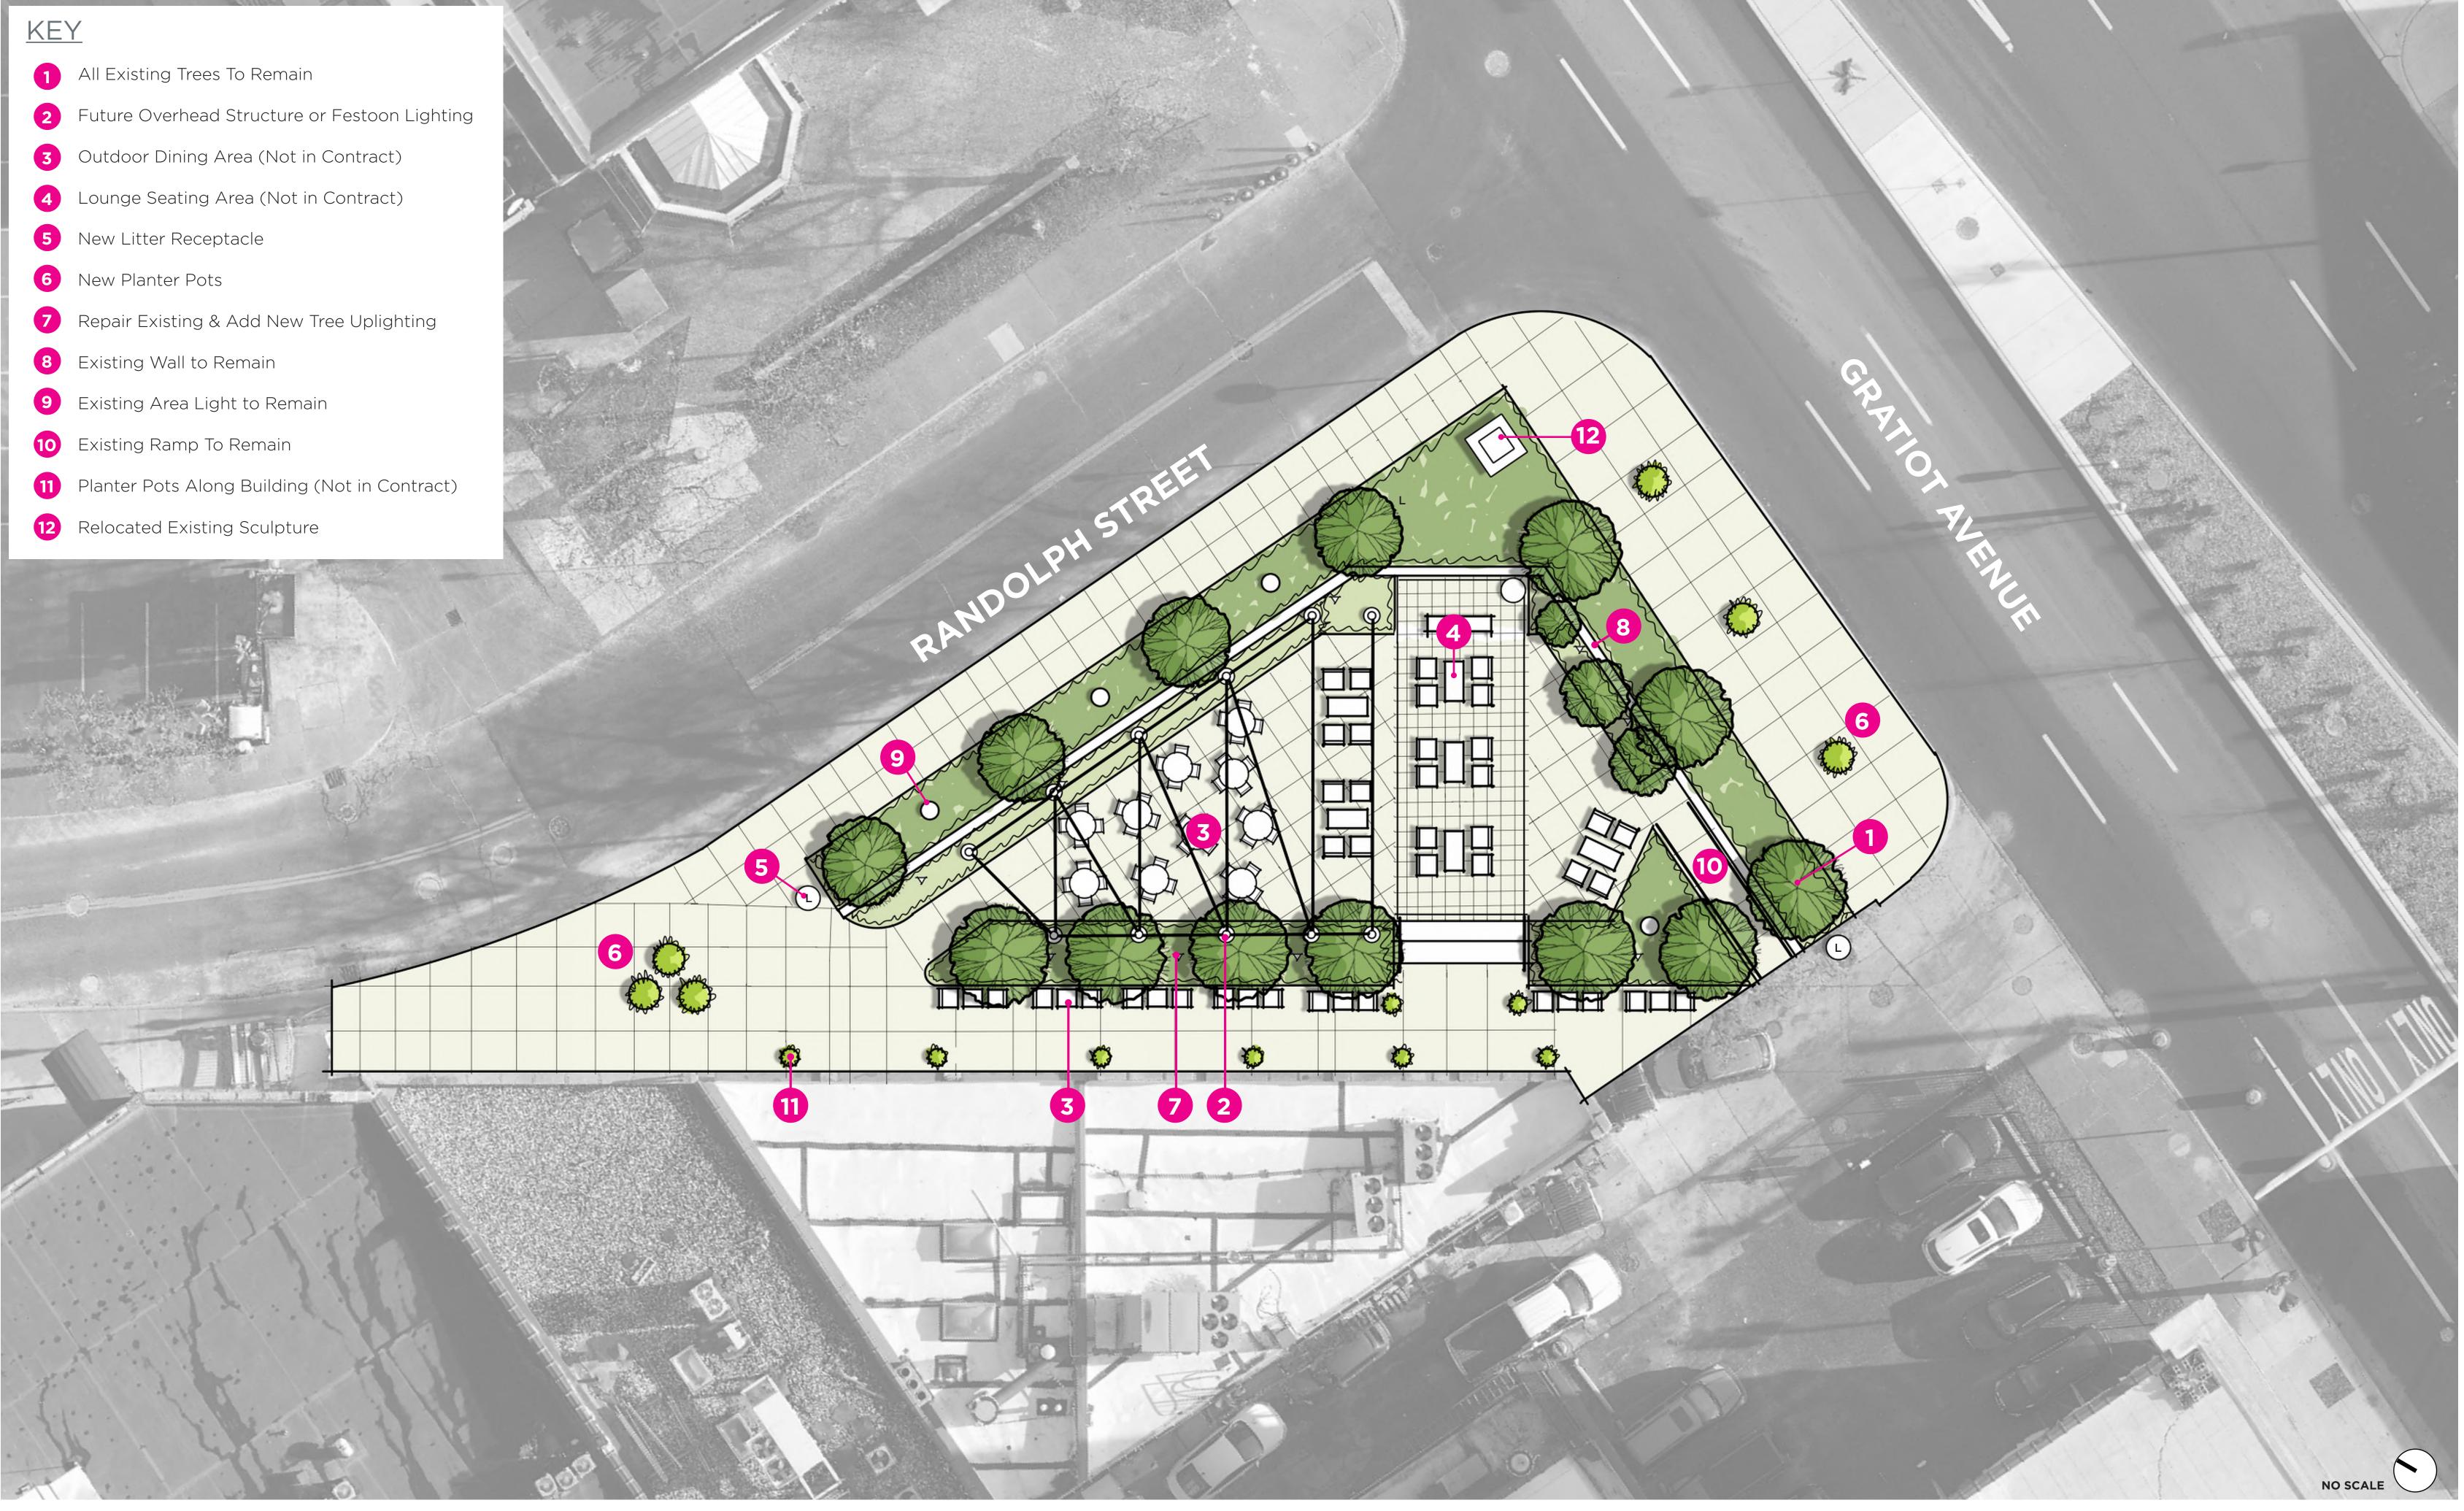



GRATIOT PLAZA - CONCEPT IMPROVEMENT PLAN

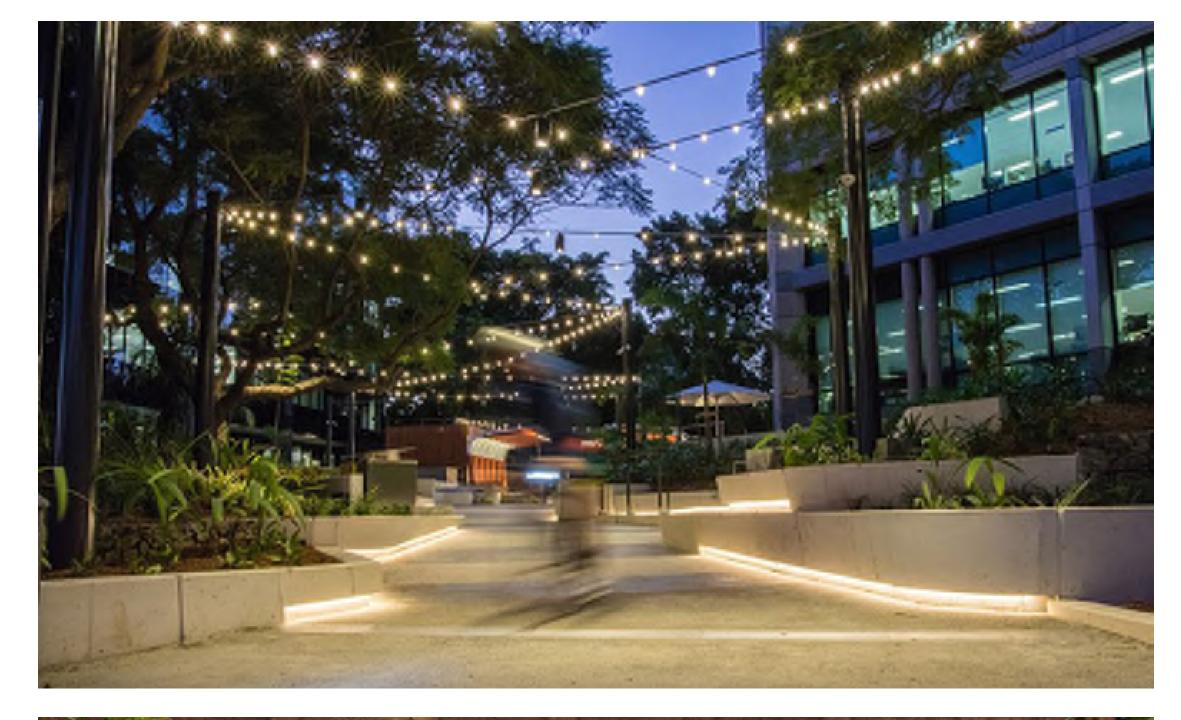












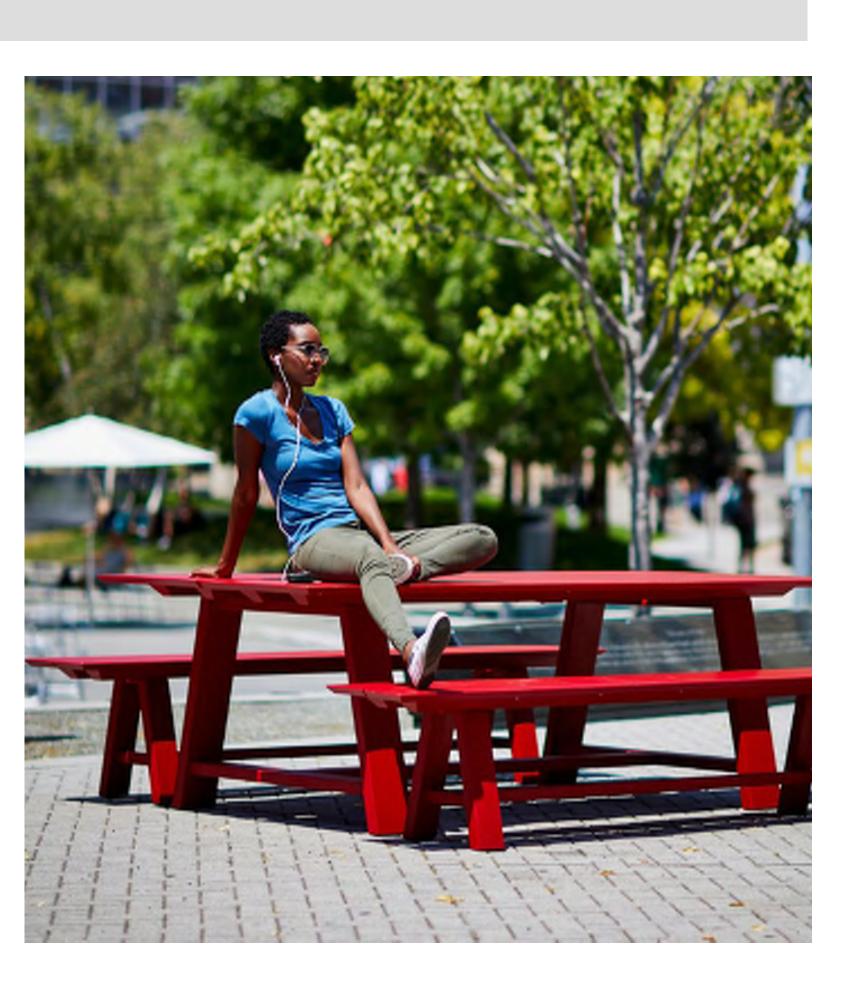





SITE CHARACTER & FURNISHING IMAGERY








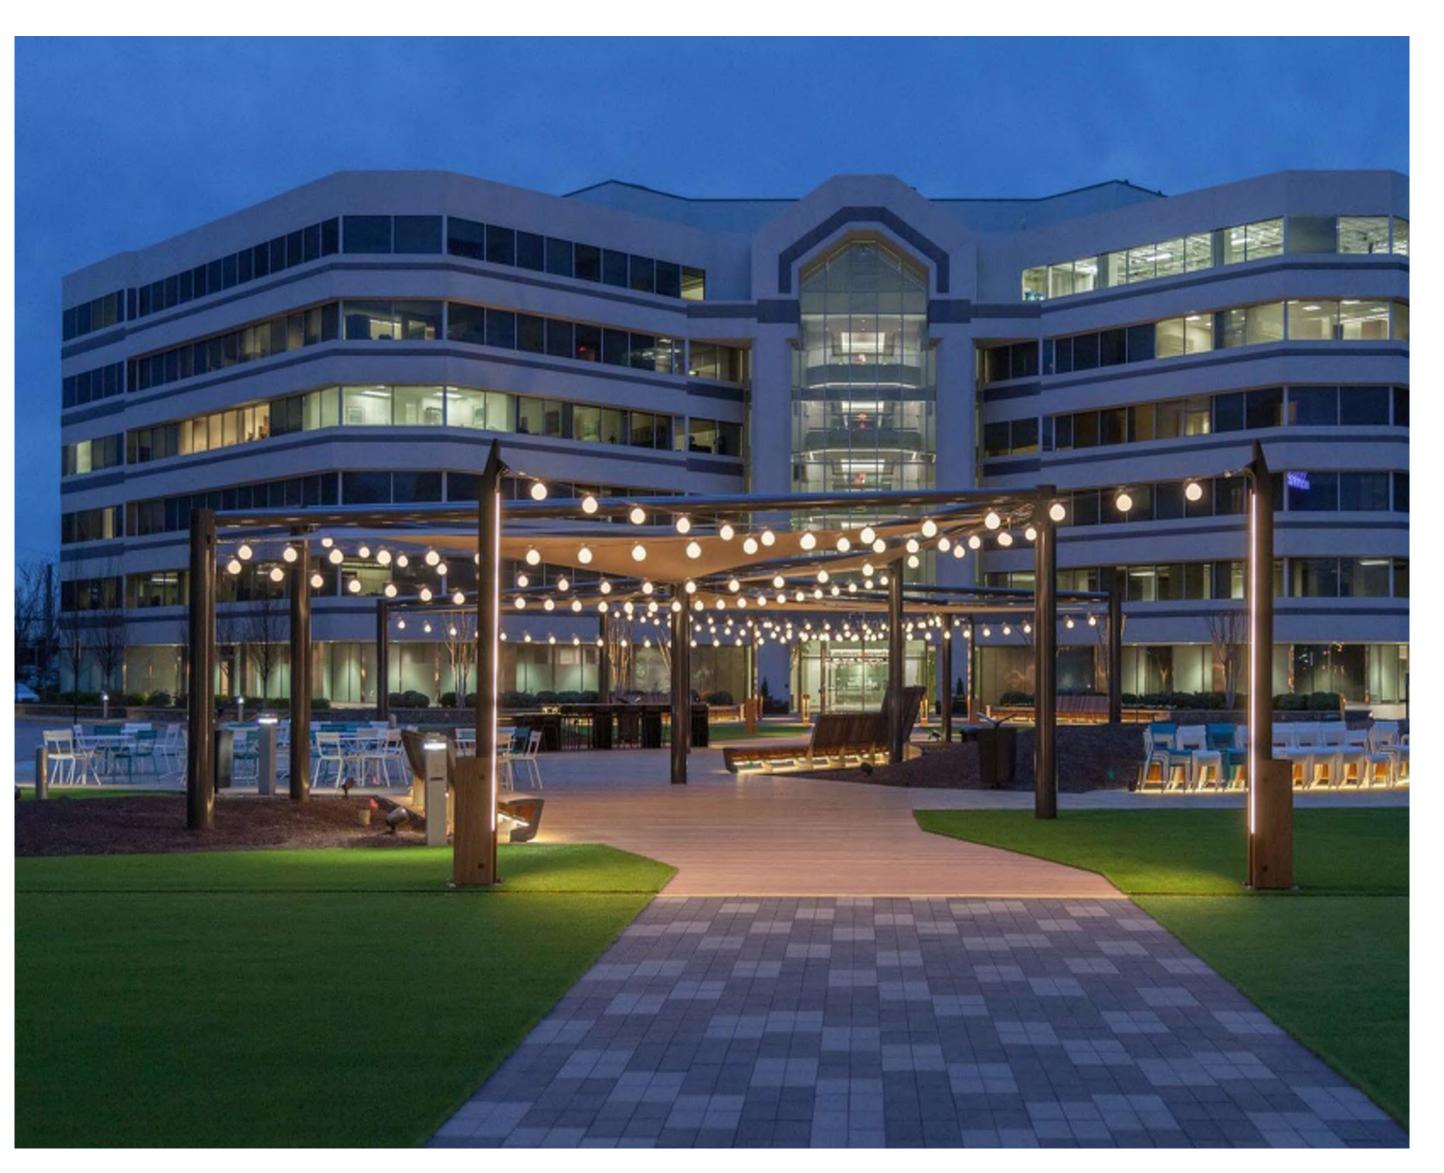

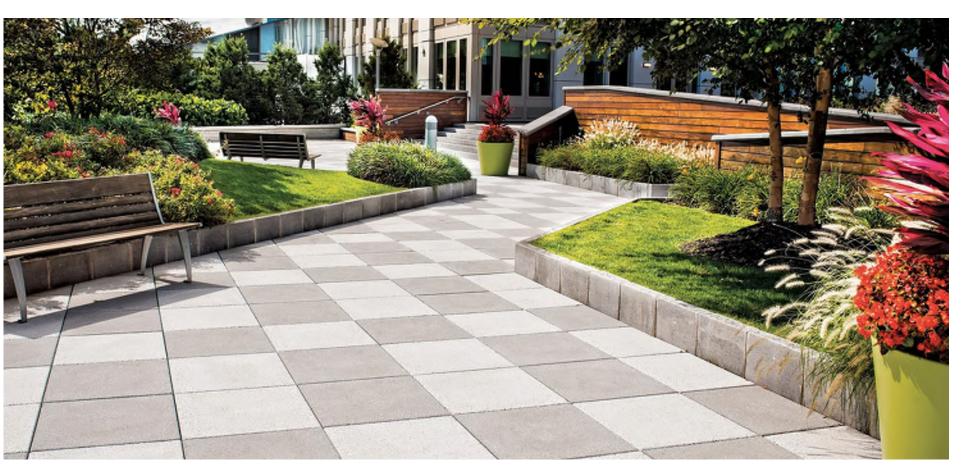

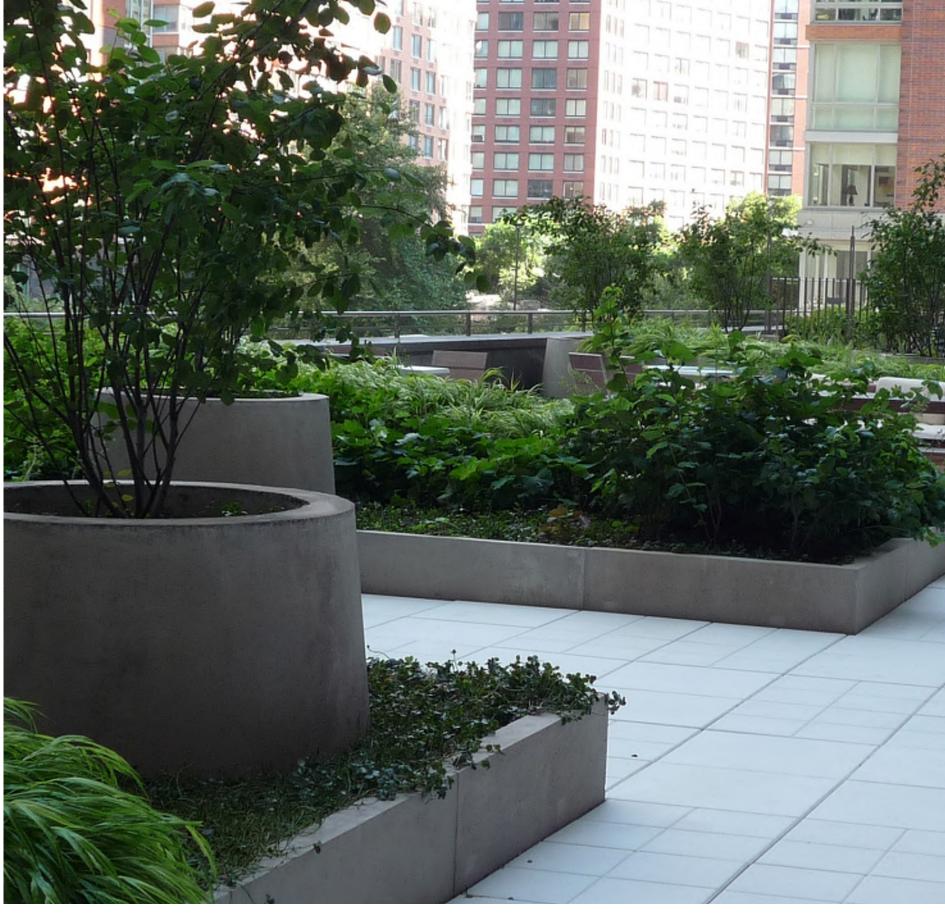



CONTRACTOR TO CONTACT 811
SERVICE AT LEAST 3 WORKING
DAYS PRIOR TO CONSTRUCTION,
TO CONFIRM LOCATION OF

REDEVELOPMENT AND UPGRADE OF

BEATRICE BUCK PARK (HARMONIE PARK)

AND GRATIOT PLAZA


1475 Randolph Street, Detroit, MI 48226

ISSUED FOR: CITY APPROVAL

^e DATE: 02/06/2024





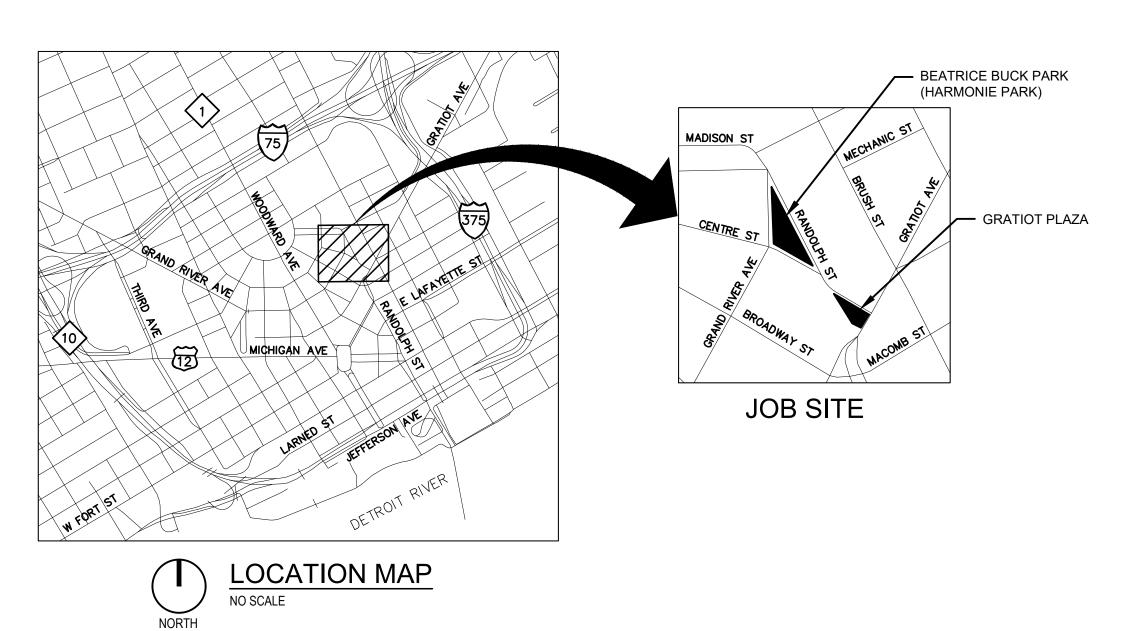

CONTACTS & AGENCIES

PUBLIC	PRIVATE
DETROIT CITY ENGINEERING LAND USE 2 WOODWARD AVE DETROIT, MI 48226	123.NET (FIBER OPTIC) (248) 431-4584
(313) 224-3935	AT&T (TEL/FIBER OPTIC) (616) 881-2268 (TEL/ANTENNA)
DETROIT CITY WATER & SEWERAGE 735 RANDOLPH ST	(800) 252-1133 (FIBER)
DETROIT, MI 48226 (313) 663-0354	COMCAST (CABLE TV) (855) 962-8525
DETROIT PEOPLE MOVER SYSTEM (313) 224-2182	DTE ENERGY (ELECTRIC) (313) 407-5364
DETROIT PUBLIC LIGHTING (ELECTRIC) 1340 THIRD AVE DETROIT, MI 48226	DTE ENERGY (NATURAL GAS) (248) 318-7839
(313) 267-5130 DETROIT THERMAL (STEAM)	EVERSTREAM (FIBER OPTIC) (463) 274-6600
541 MADISON ST DETROIT, MI 48226 (313) 363-8243	EXTENET SYSTEMS (FIBER OPTIC) (616) 648-5309
GREAT LAKES WATER AUTHORITY (313) 799-0289	INTERNATIONAL TRANSMISSION COMPANY (FIBER OPTIC (888) 269-8740
WAYNE COUNTY DPS LAND USE (734) 595-6504	MCI/VERIZON BUSINESS (FIBER OPTIC) (800) 624-9675
	NEXTEL COMMUNICATIONS (FIBER OPTIC) (816) 309-4004

DRAWING INDEX

DRAWING LIST LEGEND

■ - 02/06/24	C001	COVER SHEET
■ - 02/06/24	C100	OVERALL EXISTING CONDITIONS
■ - 02/06/24	C101	ENLARGED EXISTING CONDITIONS (PARK)
■ - 02/06/24	C102	ENLARGED EXISTING CONDITIONS (PLAZA)
■ - 02/06/24	C103	BEATRICE BUCK PARK SITE DEMOLITION
■ - 02/06/24	C104	GRATIOT PLAZA SITE DEMOLITION
■ - 02/06/24	C201	BEATRICE BUCK PARK SITE LAYOUT
■ - 02/06/24 	C202	GRATIOT PLAZA SITE LAYOUT
■ - 02/06/24	C211	BEATRICE BUCK PARK EXISTING SIGNAGE AND STRIPING
■ - 02/06/24	C212	GRATIOT PLAZA EXISTING SIGNAGE AND STRIPING
■ - 02/06/24	C301	BEATRICE BUCK PARK GRADING AND SESC PLAN
■ - 02/06/24	C302	GRATIOT PLAZA GRADING AND SESC PLAN
■ - 02/06/24	C501	SITE DETAILS
■ - 02/06/24	L201	BEATRICE BUCK PARK LANDSCAPING
● - 02/06/24	L202	BEATRICE BUCK PARK LANDSCAPING
● - 02/06/24	L203	SITE LANDSCAPE PLAN (PLAZA)
● - 02/06/24	L701	BEATRICE BUCK PARK SITE FURNISHINGS
■ - 02/06/24	L702	BEATRICE BUCK PARK SITE FURNISHINGS
● - 02/06/24	L703	GRATIOT PLAZA SITE FURNISHINGS
■ - 02/06/24	E001	ELECTRICAL NOTES AND ABBREVIATIONS
□ □ 02/06/24	ES001	OVERALL ELECTRICAL DEMOLITION SITE PLAN
□ □ 02/06/24	ES002	BEATRICE BUCK PARK ELECTRICAL SITE LAYOUT POWER
■ - 02/06/24	ES003	BEATRICE BUCK PARK ELECTRICAL SITE LAYOUT LIGHTING
■ - 02/06/24	ES004	BEATRICE BUCK PARK ELECTRICAL SITE LAYOUT SYSTEMS
■ - 02/06/24	ES005	GRATIOT PLAZA ELECTRICAL SITE LAYOUT POWER
■ - 02/06/24	ES006	GRATIOT PLAZA ELECTRICAL SITE LAYOUT LIGHTING
■ - 02/06/24	ES007	GRATIOT PLAZA ELECTRICAL SITE LAYOUT SYSTEMS
■ - 02/06/24	E601	ELECTRICAL DETAILS
● - 02/06/24	E602	ELECTRICAL SCHEDULES

If this document is sealed and signed in a digit or electronic format and is received from some other than the sealing professional identified in the document, you must contact the sealing professional in writing to validate authenticity of the document. The sealing professional disclaths seal and signature and shall not be liable for the seal and signature and shall not be liable for the seal and signature and shall not be liable for the seal and signature and shall not be liable for the seal and signature and shall not be liable for the seal and signature and shall not be liable for the seal and signature and shall not be liable for the seal and signature and shall not be liable for the seal and signature and shall not be liable for the sealer than the s

ISSUANCE

02/06/2024 CITY APPROVAL

PROJECT NUMBER 97080001 PROJECT MANAGER DWW

PROFESSIONAL DWW DRAWN BY

DDS CHECKED BY

COVER SHEET COOL

now what's below. Call before you dig. www.CALL811.com

CALL 811 NOTE:

CONTRACTOR TO CONTACT 811 SERVICE AT LEAST 3 WORKING DAYS PRIOR TO CONSTRUCTION, TO CONFIRM LOCATION OF EXISTING UTILITIES. DIAL 811.

ZONING NOTES

ZONE DISTRICT: MAJOR BUSINESS DISTRICT (B5) OVERLAY DISTRICTS:

NEIGHBORHOOD: DOWNTOWN CENTRAL BUSINESS DISTRICT

GRAND BOULEVARD OVERLAY AREA OPPORTUNITY ZONE: CENSUS TRACT 5172

MAJOR BUSINESS DISTRICT (B5) GENERAL BUSINESS DISTRICT (B4)

PARCEL SIZE: HARMONIE PARK: 0.235 ACRES GRATIOT PLAZA: LOCATED IN PUBLIC R.O.W.

REQUIRED SETBACKS: NO REQUIRED SETBACKS

PARKING REQUIRED: SCHEDULE C* - INTERIOR ROADWAYS MAY BE USED TO SATISFY PARKING REQUIREMENTS.

*SCHEDULE C: THE OFF-STREET PARKING REQUIREMENT SHALL BE ESTABLISHED BY THE PLANNING AND DEVELOPMENT DEPARTMENT BASED ON ESTIMATES OF PARKING DEMAND, WHICH MAY INCLUDE RECOMMENDATIONS OF THE ITE, DATA COLLECTED FROM USES THAT ARE THE SAME OR COMPARABLE TO THE PROPOSED USE, OR OTHER RELEVANT INFORMATION.

LEGAL DESCRIPTION

W. RANDOLPH ALL THAT PT OF SEC 9 LYG W OF ADJ RANDOLPH ST BETW CENTRE ST & GRAND RIVER PLAT OF SEC 9 GOVERNOR & JUDGES PLAN L34 P552 PLATS, W C R 1/56 262.28 IRREG

BENCHMARKS:

ELEVATION = 601.35

AVENUE ±50' NW OF NW BLDG CORNER TO BUILDING ADDRESS 3N E. GRAND RIVER

ELEVATION = 602.86 TOP OF E. FLANGE BOLT TO HYD UNDER "E" OF MADE S. SIDE OF RANDOLPH

ACROSS OF THE MICHIGAN CHRONICLE BUILDING

TOP OF W. FLANGE BOLT TO HYD UNDER "DI" SW QUADRANT OF GRATIOT AVENUE

SURVEY

11/27/2023 PAE(P) LOG BOOK NO.: 23-00 PAGES: DATUM: GPS GRID NORTH / MI STATE

SURVEY NOTES

UTILITY LOCATIONS PRIOR TO THE START OF CONSTRUCTION. THE CONTRACTOR SHALL PROTECT AND MAINTAIN EXISTING UTILITY SERVICES AT ALL TIMES.

SERVICE PROVIDED IS A TOPOGRAPHIC SURVEY, NOT A BOUNDARY SURVEY. PROPERTY LINES ARE SHOWN IN APPROXIMATE LOCATION

TOP OF SW FLANGE BOLT TO HYD UNDER "J" OF EJIW S. SIDEOF GRAND RIVER

PLANE SOUTH NAD83 / NAVD 88

ELEVATION = 603.72 AND RANDOLPH STREET

EXISTING UTILITIES ARE LOCATED TO THE BEST OF OUR KNOWLEDGE. THE CONTRACTOR WILL BE RESPONSIBLE FOR VERIFYING EXISTING

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COA ARCHITECT

ISSUANCE 02/06/2024

CITY APPROVAL

PROJECT NUMBER 97080001 PROJECT MANAGER DWW PROFESSIONAL DWW

DRAWN BY DDS

CHECKED BY DWW

OVERALL EXISTING CONDITIONS

CALL 811 NOTE:

CONTRACTOR TO CONTACT 811 SERVICE AT LEAST 3 WORKING DAYS PRIOR TO CONSTRUCTION, TO CONFIRM LOCATION OF EXISTING UTILITIES. DIAL 811.

SURVEY LEGEND

	©	MONUMENT
	•	PROPERTY IRON SET
	0	PROPERTY IRON FOUND
	-ф-	TRAFFIC SIGNAL POLE
X.√ Μ=	*	SPEAKER
	\$	LIGHT POLE
	Q.	FLOOD LIGHT
		SIGN
	o FP	FLAG POLE
	о со	CLEANOUT
	-⊙- P.P.	POWER POLE
	-⊙- _{T.P.}	TELEPHONE POLE
_		ELECTRICAL HAND HOLE
	T E C G W	TEL., ELEC., CATV, GAS, WATER RISER
— Э∙	T E G W	TEL., ELEC., GAS, WATER MANHOLE
_		TEL., ELEC., CATV, GAS MARKER
		CATCH BASIN
_	\circ	MANHOLE
_	⊗ SPR	SPRINKLER
	\otimes	VALVE & BOX
_	Q	HYDRANT
_	X 000.0	SPOT ELEVATION
	ooo	MAJOR CONTOUR - 5 FT. INTERVAL
E	001	MINOR CONTOUR - 1 FT. INTERVAL
F		GUARD RAIL
	x	FENCE LINE
		STORM SEWER
		SANITARY SEWER
		WATERMAIN
	G	GAS MAIN
	т	UNDERGROUND TELEPHONE LINE
	FO	UNDERGROUND FIBER OPTIC LINE
	UGE	UNDERGROUND ELECTRIC LINE
		DITCH CENTERLINE, TOE OF SLOPE
	.)	DECIDUOUS TREE
		CONIFEROUS TREE
		TREE & BRUSH LINE
		BUILDING

BENCHMARKS:

ELEVATION = 601.35 TOP OF SW FLANGE BOLT TO HYD UNDER "J" OF EJIW S. SIDEOF GRAND RIVER AVENUE ±50' NW OF NW BLDG CORNER TO BUILDING ADDRESS 3N E. GRAND RIVER

ELEVATION = 602.86 TOP OF E. FLANGE BOLT TO HYD UNDER "E" OF MADE S. SIDE OF RANDOLPH ACROSS OF THE MICHIGAN CHRONICLE BUILDING

ELEVATION = 603.72 TOP OF W. FLANGE BOLT TO HYD UNDER "DI" SW QUADRANT OF GRATIOT AVENUE AND RANDOLPH STREET

SURVEY

PAE(P) LOG BOOK NO.: DATUM:

11/27/2023 23-00 GPS GRID NORTH / MI STATE PLANE SOUTH NAD83 / NAVD 88

SURVEY NOTES

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PARADISE VALLEY CULTURAL AND ENTERTAINMENT DISTRICT CONSER REDEVELOPMENT AND USEATRICE BUCK PARK (HENDEN PARK) AND GRATIOT PLA

COA ARCHITECT

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02/06/2024 CITY APPROVAL


PROJECT NUMBER 97080001 PROJECT MANAGER PROFESSIONAL

DWW DRAWN BY

DDS CHECKED BY

DWW ENLARGED

EXISTING CONDITIONS (PARK) C101

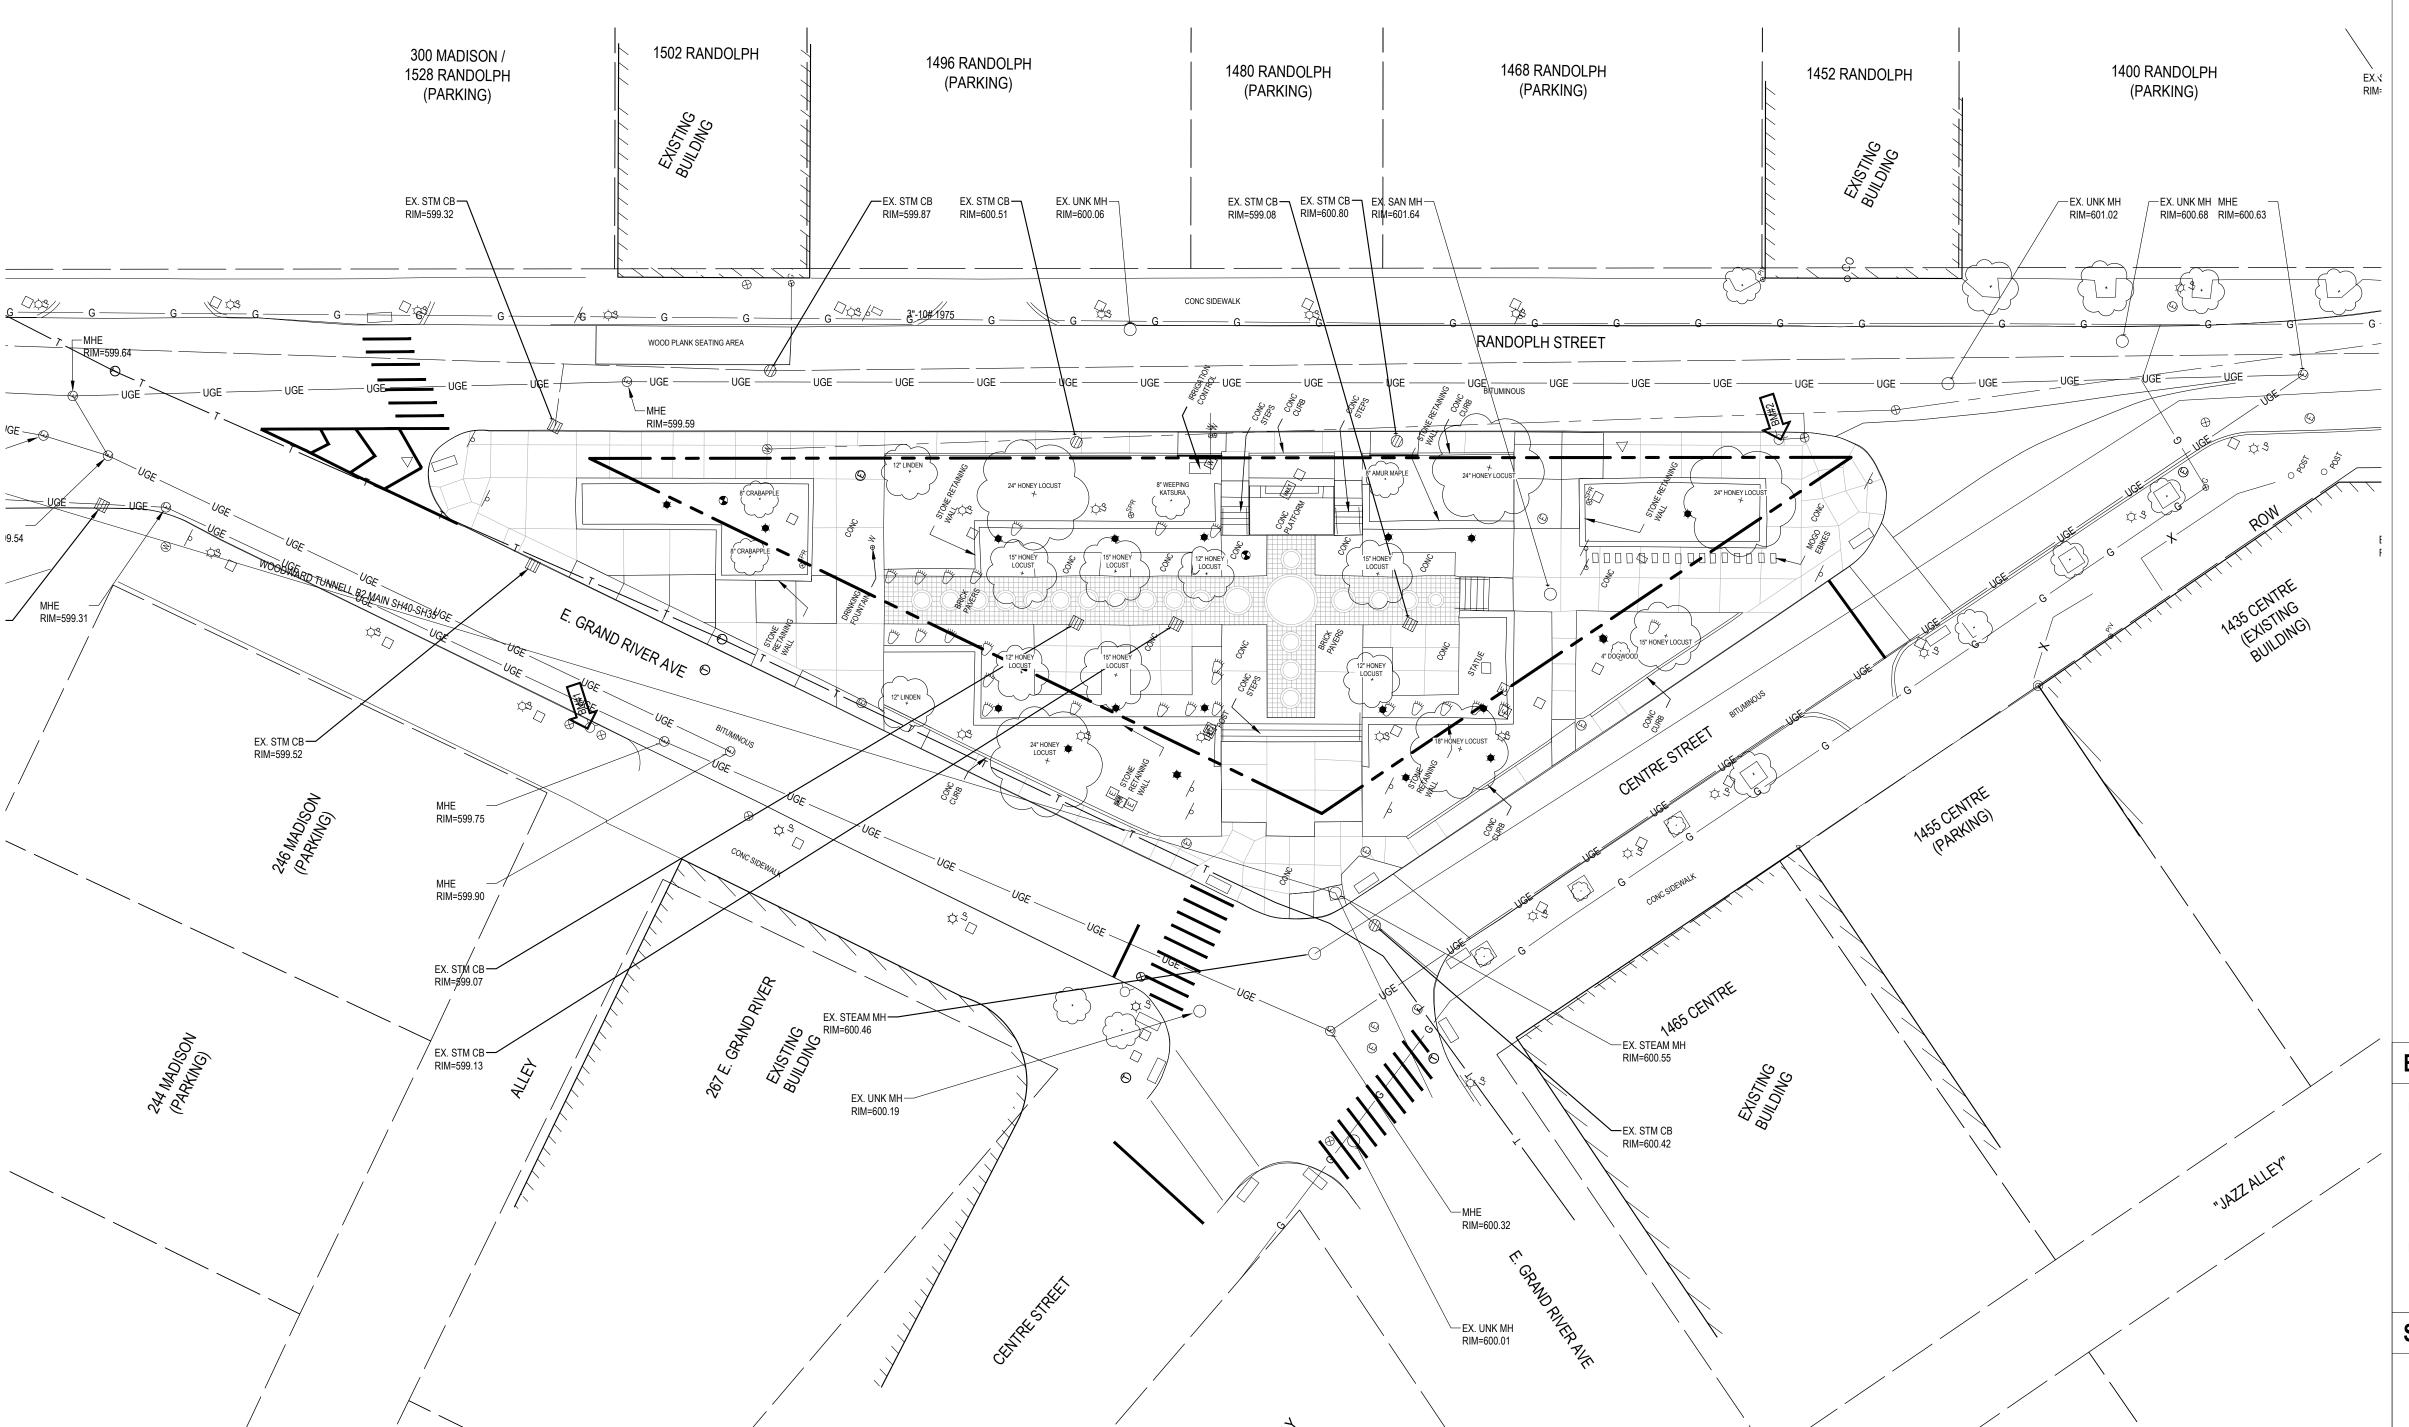

ENLARGED EXISTING CONDITIONS (PARK)

1"= 20' 0 20'

ENLARGED EXISTING CONDITIONS (PLAZA)

1"= 20' 0 20'



CALL 811 NOTE:

CONTRACTOR TO CONTACT 811 SERVICE AT LEAST 3 WORKING DAYS PRIOR TO CONSTRUCTION, TO CONFIRM LOCATION OF EXISTING UTILITIES. DIAL 811.

SURVEY LEGEND

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-⊙- _{T.P.}	TELEPHONE POLE
□ нн	ELECTRICAL HAND HOLE
T E C G W	TEL., ELEC., CATV, GAS, WATER RISEF
TEGW	TEL., ELEC., GAS, WATER MANHOLE
T E C G	TEL., ELEC., CATV, GAS MARKER
	CATCH BASIN
\circ	MANHOLE
⊗ SPR	SPRINKLER
\otimes	VALVE & BOX
Q	HYDRANT
X 000.0	SPOT ELEVATION
000	MAJOR CONTOUR - 5 FT. INTERVAL
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	STORM SEWER
	SANITARY SEWER
	WATERMAIN
G	GAS MAIN
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UGE	UNDERGROUND ELECTRIC LINE
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	BUILDING

BENCHMARKS:

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TOP OF SW FLANGE BOLT TO HYD UNDER "J" OF EJIW S. SIDEOF GRAND RIVER

AVENUE ±50' NW OF NW BLDG CORNER TO BUILDING ADDRESS 3N E. GRAND RIVER

BM #2 ELEVATION = 602.86

TOP OF E. FLANGE BOLT TO HYD UNDER "E" OF MADE S. SIDE OF RANDOLPH
ACROSS OF THE MICHIGAN CHRONICLE BUILDING

BM #3 ELEVATION = 603.72

TOP OF W. FLANGE BOLT TO HYD UNDER "DI" SW QUADRANT OF GRATIOT AVENUE AND RANDOLPH STREET

SURVEY

DATE:	11/27/2023
PAE(P) LOG BOOK NO.:	23-00
PAGÈŚ:	49
DATUM:	GPS GRID NORTH / MI STATE

SURVEY NOTES

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955jVP

PROGRESSIVE AE, INC. 1811 4 Mile Rd NE | Grand Rapids, MI 49525 2937 F. Grand Rlvd Striin 505 I Detroit MI 4

PARADISE VALLEY CULTURAL AND
ENTERTAINMENT DISTRICT CONSERVANCY
REDEVELOPMENT AND UPGRADE
BEATRICE BUCK PARK (HARMON
PARK) AND GRATIOT PLAZA

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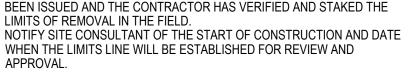
PROJECT NUMBER 97080001 PROJECT MANAGER DWW PROFESSIONAL DWW

DRAWN BY
DDS
CHECKED BY

PLANE SOUTH NAD83 / NAVD 88

CHECKED BY DWW

ENLARGED
EXISTING
CONDITIONS
(PLAZA)
C102



- ALL MATERIALS NOTED TO BE SALVAGED SHALL BE TURNED OVER TO THE OWNER OR REINSTALLED ON SITE AS NOTED.
- NO BURNING OR BURYING OF CLEARED OR DEMOLITION MATERIAL
- CONCRETE SIDEWALK STEPS AND OTHER EXISTING SITE FEATURES AS INDICATED ON THE DRAWINGS. ALSO, REMOVE ALL DEBRIS FROM WITHIN CONSTRUCTION LIMITS ON SITE. ALL DEMOLITION MATERIALS SHALL BE REMOVED FROM THE SITE AND, UNLESS OTHERWISE NOTED, DISPOSED OF IN A MANNER ACCEPTABLE TO LOCAL JURISDICTION HAVING AUTHORITY.
- THE CONTRACTOR SHALL BE LICENSED BY THE STATE OF MICHIGAN FOR DEMOLITION REMOVAL AND HAULING OF MATERIALS.
- THE CONTRACTOR WILL BE RESPONSIBLE FOR VERIFYING EXISTING UTILITY LOCATIONS PRIOR TO THE START OF CONSTRUCTION. THE CONTRACTOR SHALL PROTECT AND MAINTAIN EXISTING UTILITY SERVICES AT ALL TIMES.
- PROTECTION FENCE WHERE SHOWN
- TREE PROTECTION FENCE ORANGE SAFETY FENCE AROUND TREES SUPPORTED BY STEEL T-BAR FENCE POSTS. ZIP TIE FABRIC TO POSTS. INSTALL PRIOR TO ANY CONSTRUCTION ACTIVITY AND MAINTAIN DURING ENTIRE CONSTRUCTION PERIOD.
- 12. CONTRACTOR TO CALL 811 AT LEAST 3 WORKING DAYS PRIOR TO CONSTRUCTION, TO CONFIRM LOCATION OF EXISTING UTILITIES.
- DISTURBED BY CONSTRUCTION.
- 14. ANY AREA DISTURBED BY CONSTRUCTION TO BE RESTORED TO CONDITION EQUAL TO OR BETTER THAN BEFORE CONSTRUCTION BEGAN. PATCH PAVEMENT IN-KIND IF REQUIRED.
- 15. SAWCUT FULL DEPTH ALL EDGES OF PAVEMENT TO BE REMOVED.
- 16. ALL GROUND AREAS DISTURBED BY CONSTRUCTION TO BE TOPSOILED

OTHERWISE ON PLANS.

18. REMOVE AND SALVAGE ALL EXISTING SITE FURNISHINGS AND TRASH RECEPTACLES. PROVIDE TO OWNER.

1400 RANDOLPH

(PARKING)

1452 RANDOLPH

- PROTECT PARADISE

VALLEY SIGN TO REMAIN

REPAINT SCULPTURE -

- REMOVE HANDRAILS

WITHIN PARK LIMITS

(TYP. OF ALL HANDRAILS

► PROTECT HISTORIC MARKER

(TO REMAIN)

PROTECT TREE WITH

BEATRICE BUCK PARK SITE DEMOLITION

TREE PROTECTION

FENCE (TYP.)

CALL 811 NOTE:

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ELEVATION = 601.35 TOP OF SW FLANGE BOLT TO HYD UNDER "J" OF EJIW S. SIDEOF GRAND RIVER AVENUE ±50' NW OF NW BLDG CORNER TO BUILDING ADDRESS 3N E. GRAND RIVER

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TOP OF E. FLANGE BOLT TO HYD UNDER "E" OF MADE S. SIDE OF RANDOLPH ACROSS OF THE MICHIGAN CHRONICLE BUILDING

ELEVATION = 603.72 TOP OF W. FLANGE BOLT TO HYD UNDER "DI" SW QUADRANT OF GRATIOT AVENUE

BITUMINOUS PAVEMENT

CONCRETE REMOVAL

REMOVE EXISTING SOIL TO A DEPTH OF 3 INCHES

ABANDON UTILITY LINE

REMOVE UTILITY LINE

SITE CLEARING AND DEMOLITION NOTES

- THE CONTRACTOR SHALL BE RESPONSIBLE FOR VISITING THE SITE AND BECOMING FAMILIAR WITH THE DEMOLITION AND CLEARING
- NO REMOVAL, DEMOLITION, CLEARING OR TOPSOIL REMOVAL SHALL OCCUR ON SITE UNTIL THE SESC AND STORMWATER PERMITS HAVE BEEN ISSUED AND THE CONTRACTOR HAS VERIFIED AND STAKED THE LIMITS OF REMOVAL IN THE FIELD. NOTIFY SITE CONSULTANT OF THE START OF CONSTRUCTION AND DATE

- REMOVE ALL STRUCTURES, FOUNDATIONS, BITUMINOUS PAVEMENT,
- THE CONTRACTOR IS RESPONSIBLE TO OBTAIN ALL PERMITS AND FEES FOR THIS WORK.
- EXISTING UTILITIES ARE LOCATED TO THE BEST OF OUR KNOWLEDGE.
- ALL EXCESS OR UNSUITABLE TOPSOIL OR SUBSOIL TO BECOME THE PROPERTY OF THE CONTRACTOR AND REMOVED OFFSITE.
- 10. PROTECT EXISTING TREES UNLESS OTHERWISE NOTED. NO PARKING OR STORAGE OF MATERIALS WITHIN TREE ROOT ZONE. PLACE TREE

- 13. CONTRACTOR MUST RESTORE AND REPAIR ANY EXISTING CONDITIONS

- AND SEEDED PER THE SITE LANDSCAPE PLAN UNLESS SHOWN
- 17. REPAIR OR REPLACE ALL PAVERS IMPACTED BY CONSTRUCTION AS

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PROJECT NUMBER 97080001 PROJECT MANAGER

DWW PROFESSIONAL

DWW DRAWN BY DDS

CHECKED BY DWW

BEATRICE BUCK PARK SITE DEMOLITION

- CLEAN AND PERFORM MASONRY MORTAR RE-POINTING FOR ALL JOINTS IN STONE WALLS TO ORIGINAL CONDITIONS. 1200 SQFT

OF WALL TO RESTORE. ___















REMOVE AND SALVAGE EXISTING PAVERS —

REMOVE AND REPLACE ALL FLOOD LIGHT

FIXTURES (SEE ELECTRICAL DEMOLITION PLANS)

1502 RANDOLPH

1496 RANDOLPH

(PARKING)

1468 RANDOLPH

(PARKING)

RANDOPLH STREET

1480 RANDOLPH

(PARKING)

ALL TREES TO REMAIN. IVY TO REMAIN.

CONTRACTOR TO PRUNE TREES AS NEEDED

BEDS AS DIRECTED BY ENGINEER AND

EXISTING TREES TO REMAIN

REMOVE ALL IVY UNDERBRUSH FROM PLANTER

REMOVE HANDRAILS

300 MADISON /

(PARKING)

EX. STM CB —

EX. STM CB — RIM=599.52

1528 RANDOLPH



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BENCHMARKS:

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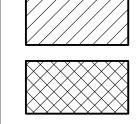
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DEMOLITION LEGEND

AND RANDOLPH STREET



BITUMINOUS PAVEMENT

CONCRETE REMOVAL

REMOVE EXISTING SOIL TO A DEPTH OF 24 INCHES

• | | • | | • | | •

ABANDON UTILITY LINE

 \cdot X X \cdot X X X X X \cdot

REMOVE UTILITY LINE

ALL ITEMS IN BOLD TO BE REMOVED UNLESS OTHERWISE NOTED.

SITE CLEARING AND DEMOLITION NOTES

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- 15. SAWCUT FULL DEPTH ALL EDGES OF PAVEMENT TO BE REMOVED.
- 16. ALL GROUND AREAS DISTURBED BY CONSTRUCTION TO BE TOPSOILED AND SEEDED PER THE SITE LANDSCAPE PLAN UNLESS SHOWN OTHERWISE ON PLANS.
- 17. REPAIR OR REPLACE ALL PAVERS IMPACTED BY CONSTRUCTION AS
- 18. REMOVE AND SALVAGE ALL EXISTING SITE FURNISHINGS AND TRASH RECEPTACLES. PROVIDE TO OWNER.

PARADISE VALLEY CULTURAL AND
ENTERTAINMENT DISTRICT CONSE
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PARK) AND GRATIOT PLA

COA ARCHITECT

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PROJECT NUMBER 97080001

PROJECT MANAGER DWW

PROFESSIONAL DWW DRAWN BY

DDS CHECKED BY DWW

GRATIOT PLAZA SITE DEMOLITION

BITUMINOUS PAVEMENT

CONCRETE SIDEWALK, 4 INCH

(HAND PATCHING)

(3-INCH DEPTH)

CALL 811 NOTE:

HEAVY DUTY CONCRETE, 6 INCH BRICK PAVERS

NEW PLANTING SOIL

GENERAL SITE LAYOUT NOTES

- 1. ALL WORKMANSHIP AND MATERIALS SHALL BE ACCORDING TO THE CURRENT MICHIGAN DEPARTMENT OF TRANSPORTATION (M.D.O.T) STANDARD SPECIFICATIONS FOR CONSTRUCTION.
- CONTACT "MISS DIG" TOLL FREE AT 1-800-482-7171 THREE (3) DAYS PRIOR TO THE START OF CONSTRUCTION, EXCLUDING SATURDAYS, SUNDAYS, AND HOLIDAYS.
- NO DIMENSION MAY BE SCALED. REFER UNCLEAR ITEMS TO THE ENGINEER FOR INTERPRETATION.
- 4. DIMENSIONS SHOWN ARE TO FACE OF CURB UNLESS OTHERWISE NOTED AS B-B (BACK TO BACK) OR E-E (EDGE OF METAL TO EDGE OF METAL).
- 5. UPON REQUEST, ELECTRONIC INFORMATION WILL BE PROVIDED FOR SITE LAYOUT PURPOSES. CONTRACTOR SHALL REQUEST ALL INFORMATION IN WRITING THROUGH PROGRESSIVE AE. LAYOUT OF ALL NEW CONSTRUCTION SHALL BE DONE BY A LICENSED SURVEYOR.
- 6. ALL CONCRETE JOINTS SHALL BE TOOLED PER SPECIFICATIONS.
- 7. CONTRACTOR MUST RESTORE AND REPAIR ANY EXISTING CONDITIONS DISTURBED BY CONSTRUCTION. THIS IS TO INCLUDE BURIED UTILITIES, LIGHTING, LANDSCAPING, SPRINKLING, ETC.
- ANY AREA DISTURBED BY CONSTRUCTION TO BE RESTORED TO CONDITION EQUAL TO OR BETTER THAN BEFORE CONSTRUCTION BEGAN.
 - ALL PAVEMENT, CURB & GUTTER, SIDEWALK AND UTILITIES WITHIN PUBLIC RIGHT OF WAY SHALL MEET CITY OF DETROIT STANDARDS.
- 10. CONTRACTOR TO PROTECT EXISTING IRRIGATION SYSTEM AS MUCH AS POSSIBLE. REPAIR DAMAGE TO EXISTING IRRIGATION SYSTEM AND RECONFIGURE SPRINKLER LAYOUT TO ACCOMMODATE THE NEW IMPROVEMENTS.
- 11. ALL SIDEWALK TO BE POWER-WASHED.
- 12. REPAIR STONE WALLS AND MORTAR AS NEEDED. RE-POINT MORTAR TO MATCH EXISTING.

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PARADISE VALLEY CULTURAL AND
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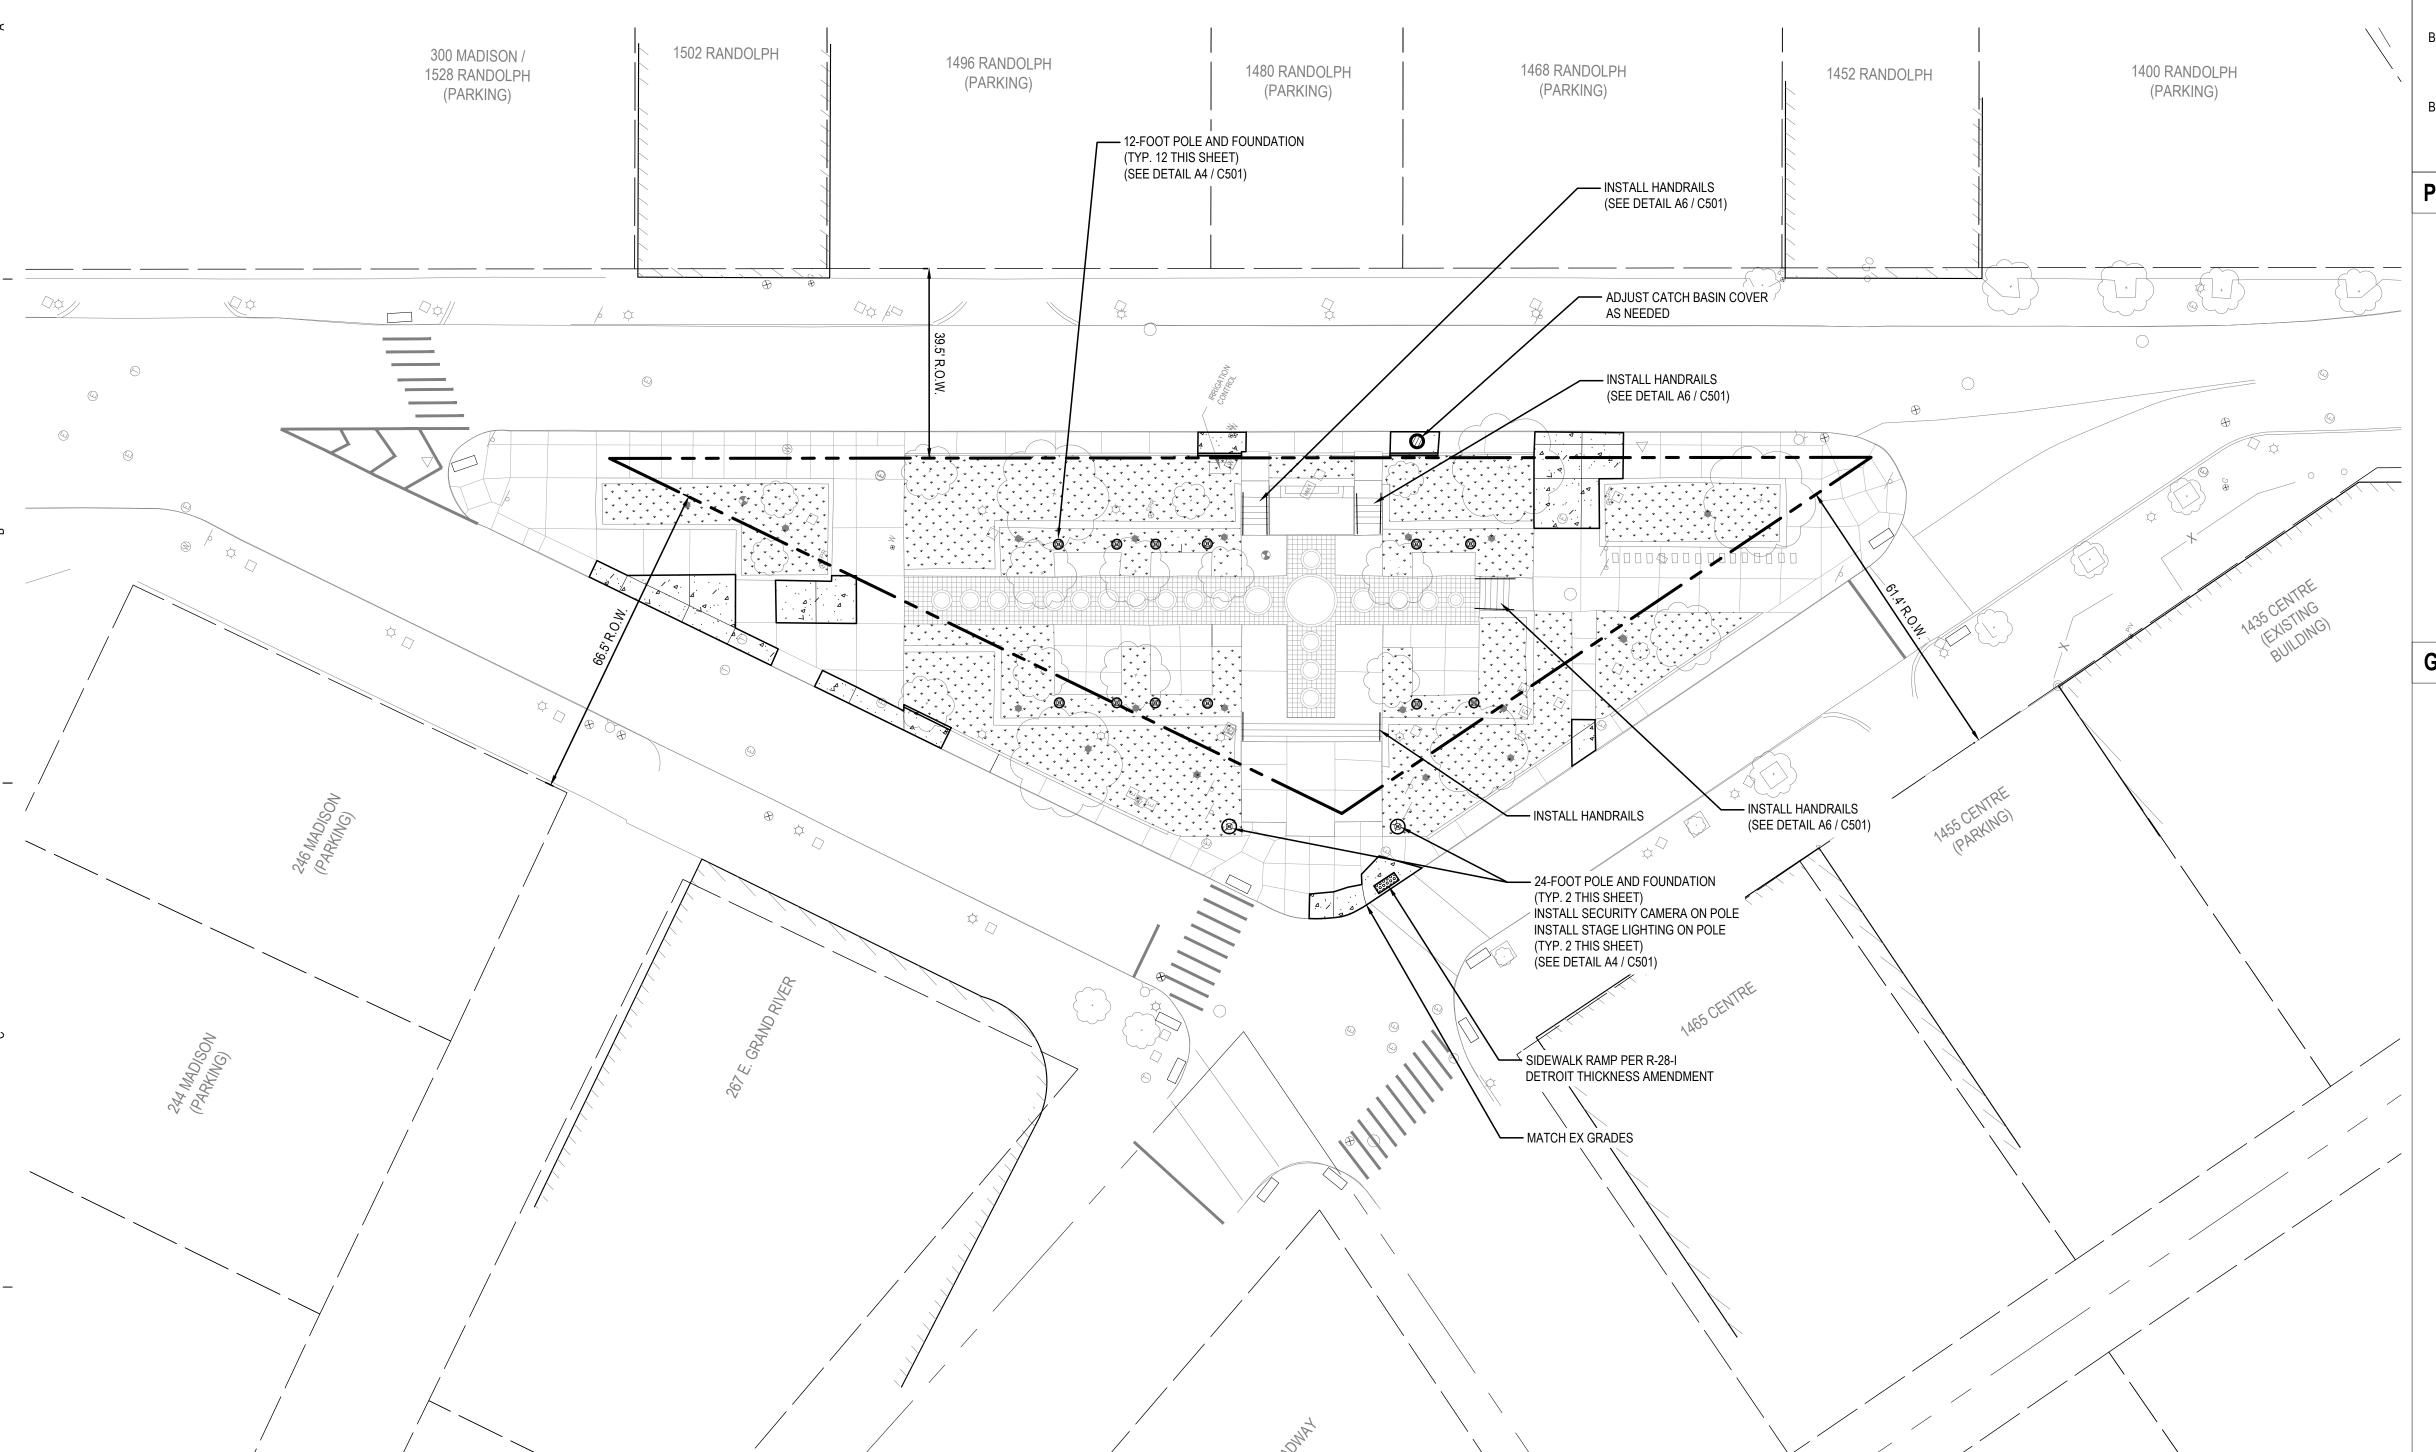
CITY APPROVAL

PROJECT NUMBER 97080001 PROJECT MANAGER DWW PROFESSIONAL

DWW DRAWN BY

DDS CHECKED BY DWW

BEATRICE BUCK PARK SITE LAYOUT







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BENCHMARKS:

ELEVATION = 601.35 TOP OF SW FLANGE BOLT TO HYD UNDER "J" OF EJIW S. SIDEOF GRAND RIVER AVENUE ±50' NW OF NW BLDG CORNER TO BUILDING ADDRESS 3N E. GRAND RIVER

ELEVATION = 602.86

TOP OF E. FLANGE BOLT TO HYD UNDER "E" OF MADE S. SIDE OF RANDOLPH ACROSS OF THE MICHIGAN CHRONICLE BUILDING

ELEVATION = 603.72 TOP OF W. FLANGE BOLT TO HYD UNDER "DI" SW QUADRANT OF GRATIOT AVENUE

PAVEMENT LEGEND


AND RANDOLPH STREET




BITUMINOUS PAVEMENT (HAND PATCHING)



CONCRETE SIDEWALK, 4 INCH

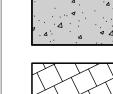

HEAVY DUTY CONCRETE, 6 INCH

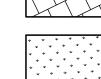

BRICK PAVERS

NEW PLANTING SOIL (3-INCH DEPTH)

GENERAL SITE LAYOUT NOTES

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- NO DIMENSION MAY BE SCALED. REFER UNCLEAR ITEMS TO THE ENGINEER FOR INTERPRETATION.
- 4. DIMENSIONS SHOWN ARE TO FACE OF CURB UNLESS OTHERWISE NOTED AS B-B (BACK TO BACK) OR E-E (EDGE OF METAL TO EDGE OF METAL).
- 5. CONTRACTOR TO PAINT STRIPE ALL PARKING SPACES SHOWN. PAINT COLOR TO BE YELLOW.
- 6. UPON REQUEST, ELECTRONIC INFORMATION WILL BE PROVIDED FOR SITE LAYOUT PURPOSES. CONTRACTOR SHALL REQUEST ALL INFORMATION IN WRITING THROUGH PROGRESSIVE AE. LAYOUT OF ALL NEW CONSTRUCTION SHALL BE DONE BY A LICENSED SURVEYOR.
- 7. ALL CONCRETE JOINTS SHALL BE TOOLED PER SPECIFICATIONS.
- 8. CONTRACTOR MUST RESTORE AND REPAIR ANY EXISTING CONDITIONS DISTURBED BY CONSTRUCTION. THIS IS TO INCLUDE BURIED UTILITIES, LIGHTING, LANDSCAPING, SPRINKLING, ETC.
- 9. ANY AREA DISTURBED BY CONSTRUCTION TO BE RESTORED TO CONDITION EQUAL TO OR BETTER THAN BEFORE CONSTRUCTION BEGAN.
- 10. ALL PAVEMENT, CURB & GUTTER, SIDEWALK AND UTILITIES WITHIN PUBLIC RIGHT OF WAY SHALL MEET CITY OF DETROIT STANDARDS.
- 11. CONTRACTOR TO PROTECT EXISTING IRRIGATION SYSTEM AS MUCH AS POSSIBLE. REPAIR DAMAGE TO EXISTING IRRIGATION SYSTEM AND RECONFIGURE SPRINKLER LAYOUT TO ACCOMMODATE THE NEW IMPROVEMENTS.
- 12. ALL SIDEWALK TO BE POWER-WASHED.
- 13. REPAIR STONE WALLS AND MORTAR AS NEEDED. RE-POINT MORTAR TO MATCH EXISTING.

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PARADISE VALLEY CULTURAL AND
ENTERTAINMENT DISTRICT CONSE
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BEATRICE BUCK PARK (I

COA ARCHITECT

ISSUANCE 02/06/2024

CITY APPROVAL

PROJECT NUMBER 97080001 PROJECT MANAGER DWW PROFESSIONAL

DWW DRAWN BY DDS

CHECKED BY DWW

GRATIOT PLAZA SITE LAYOUT C202


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BEATRICE BUCK PARK EXISTING SIGNAGE AND

STRIPING C211



Know what's below. Call before you dig.

BENCHMARKS:

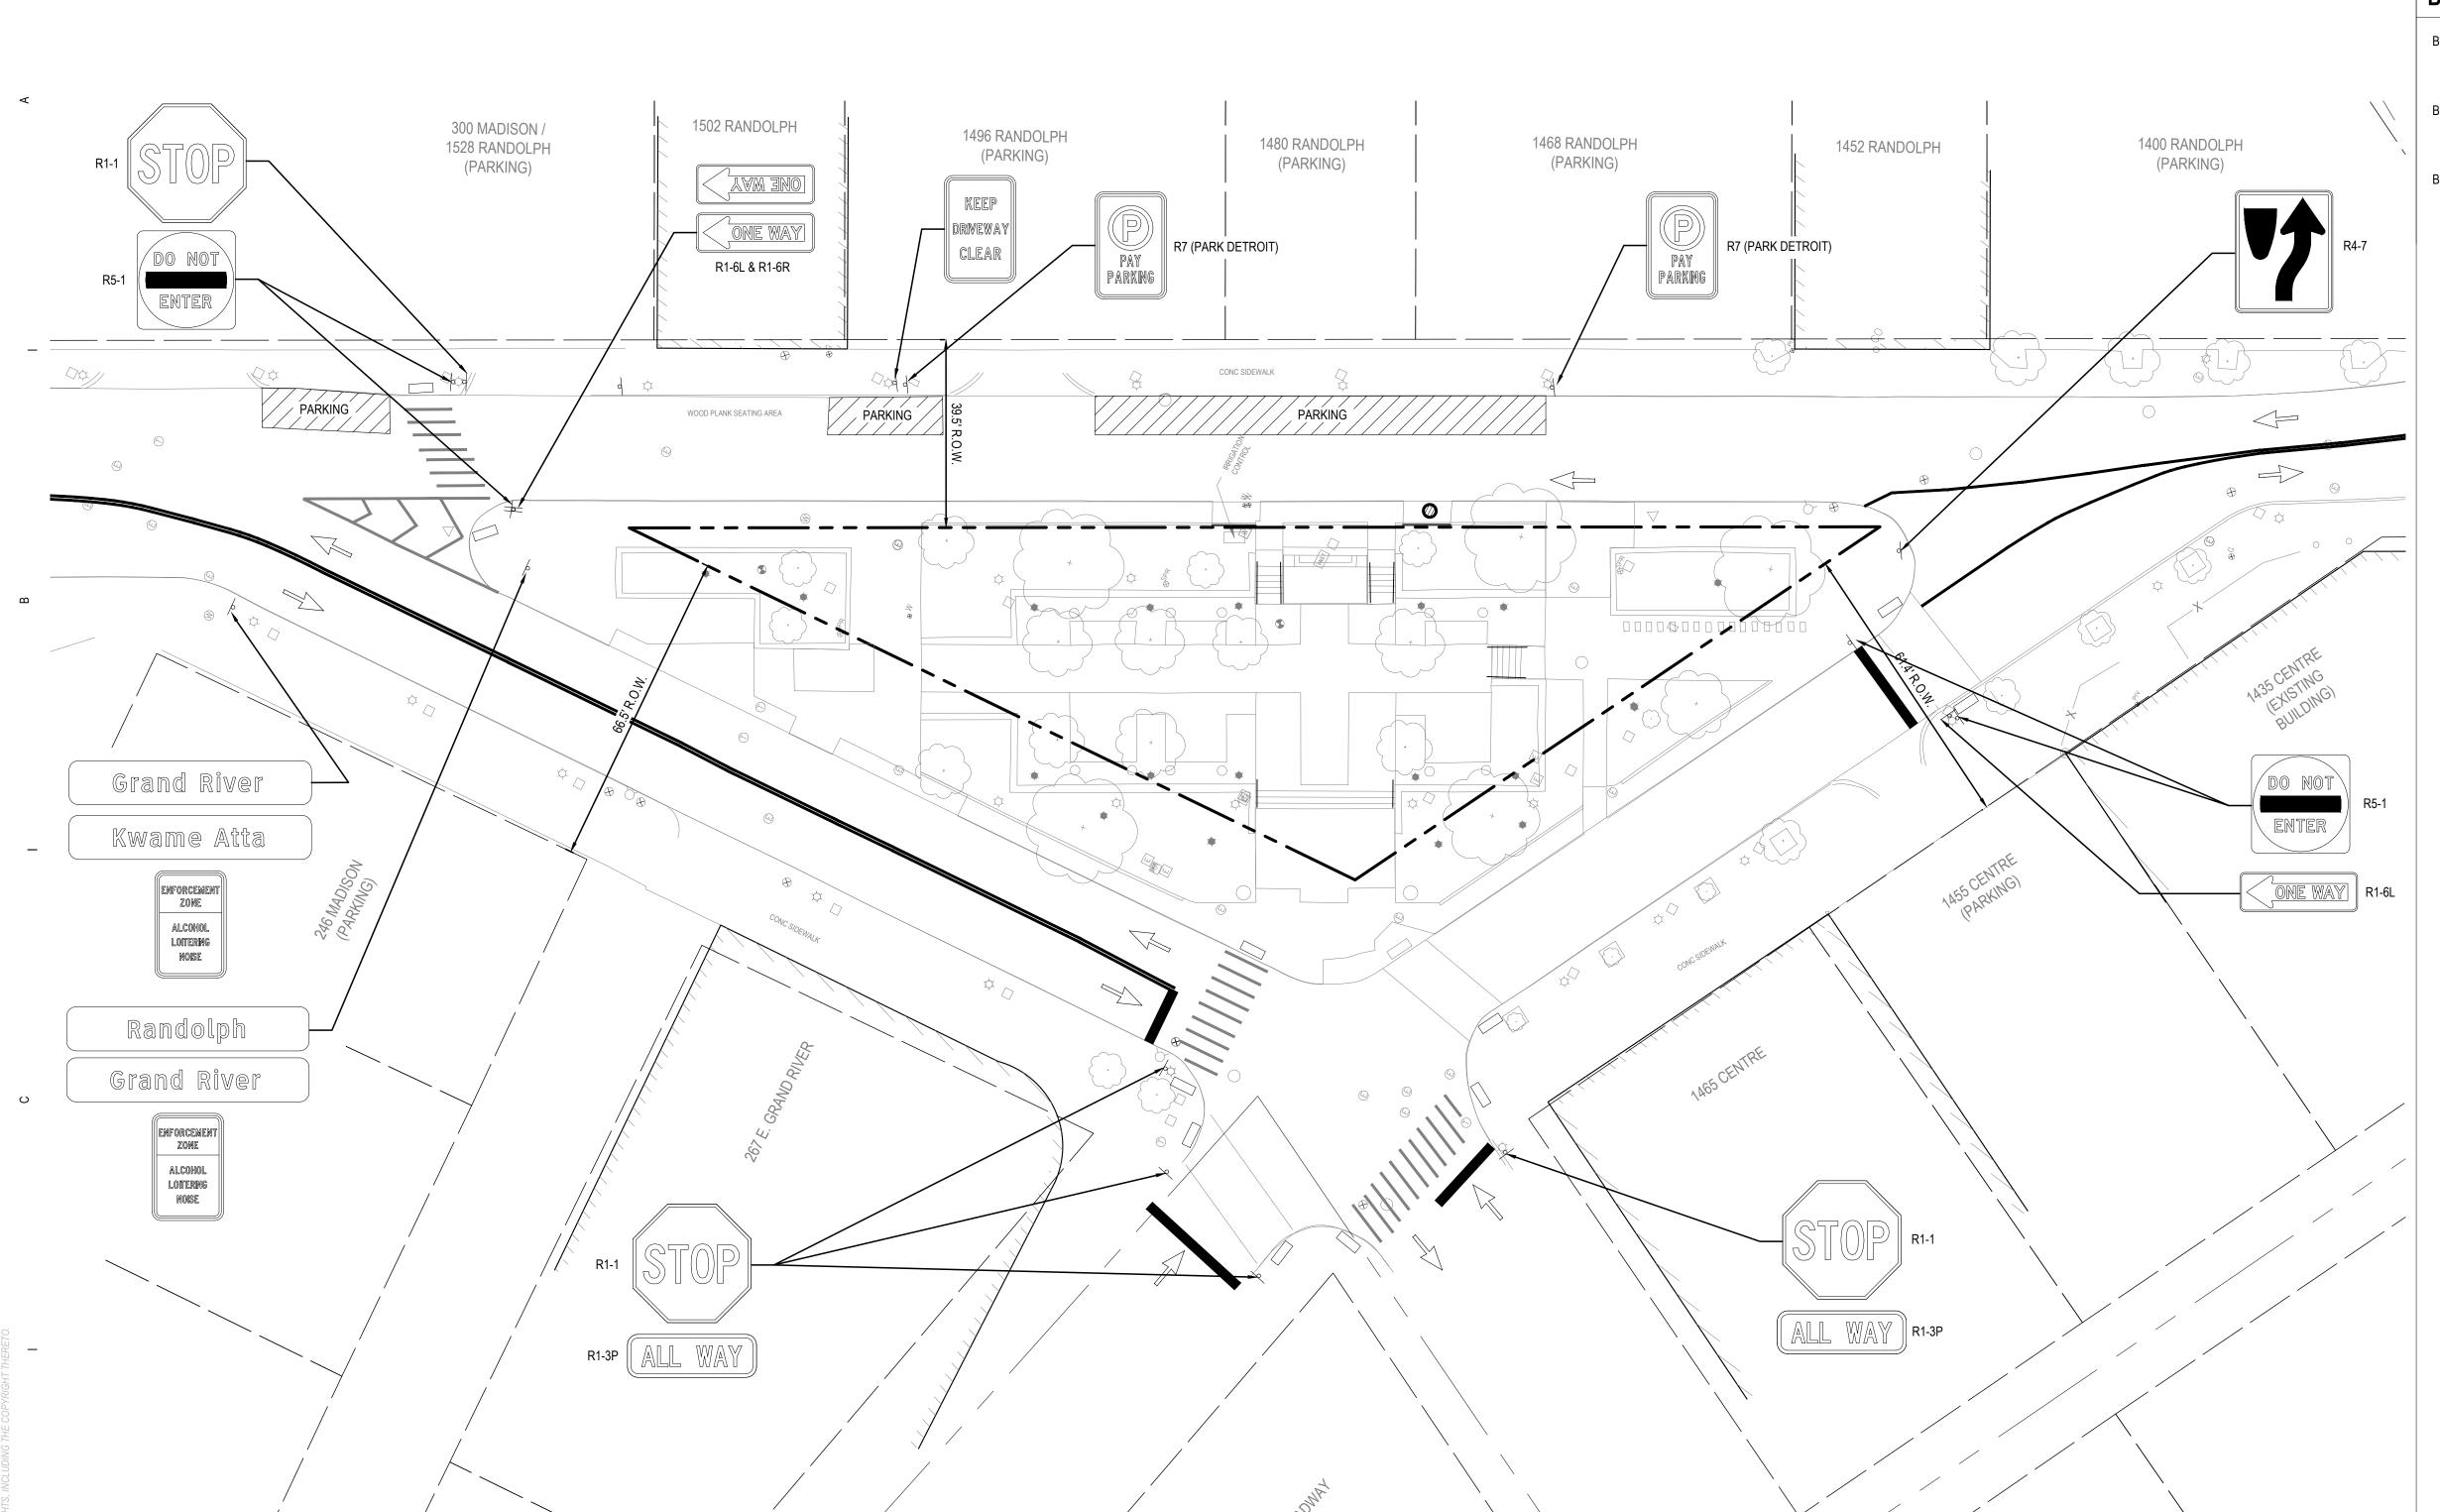BEATRICE BUCK PARK EXISTING SIGNAGE AND STRIPING

1"= 20' 0 20'

ELEVATION = 601.35 TOP OF SW FLANGE BOLT TO HYD UNDER "J" OF EJIW S. SIDEOF GRAND RIVER AVENUE ±50' NW OF NW BLDG CORNER TO BUILDING ADDRESS 3N E. GRAND RIVER

ELEVATION = 602.86 TOP OF E. FLANGE BOLT TO HYD UNDER "E" OF MADE S. SIDE OF RANDOLPH

CALL 811 NOTE:

CONTRACTOR TO CONTACT 811 SERVICE AT LEAST 3 WORKING DAYS PRIOR TO CONSTRUCTION,

TO CONFIRM LOCATION OF EXISTING UTILITIES. DIAL 811.

ACROSS OF THE MICHIGAN CHRONICLE BUILDING ELEVATION = 603.72

TOP OF W. FLANGE BOLT TO HYD UNDER "DI" SW QUADRANT OF GRATIOT AVENUE AND RANDOLPH STREET

BENCHMARKS:

TOP OF SW FLANGE BOLT TO HYD UNDER "J" OF EJIW S. SIDEOF GRAND RIVER AVENUE ±50' NW OF NW BLDG CORNER TO BUILDING ADDRESS 3N E. GRAND RIVER

TOP OF E. FLANGE BOLT TO HYD UNDER "E" OF MADE S. SIDE OF RANDOLPH ACROSS OF THE MICHIGAN CHRONICLE BUILDING

TOP OF W. FLANGE BOLT TO HYD UNDER "DI" SW QUADRANT OF GRATIOT AVENUE AND RANDOLPH STREET


ISSUANCE

02/06/2024 CITY APPROVAL

PROJECT NUMBER 97080001 PROJECT MANAGER PROFESSIONAL

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GRATIOT PLAZA EXISTING SIGNAGE AND STRIPING C212



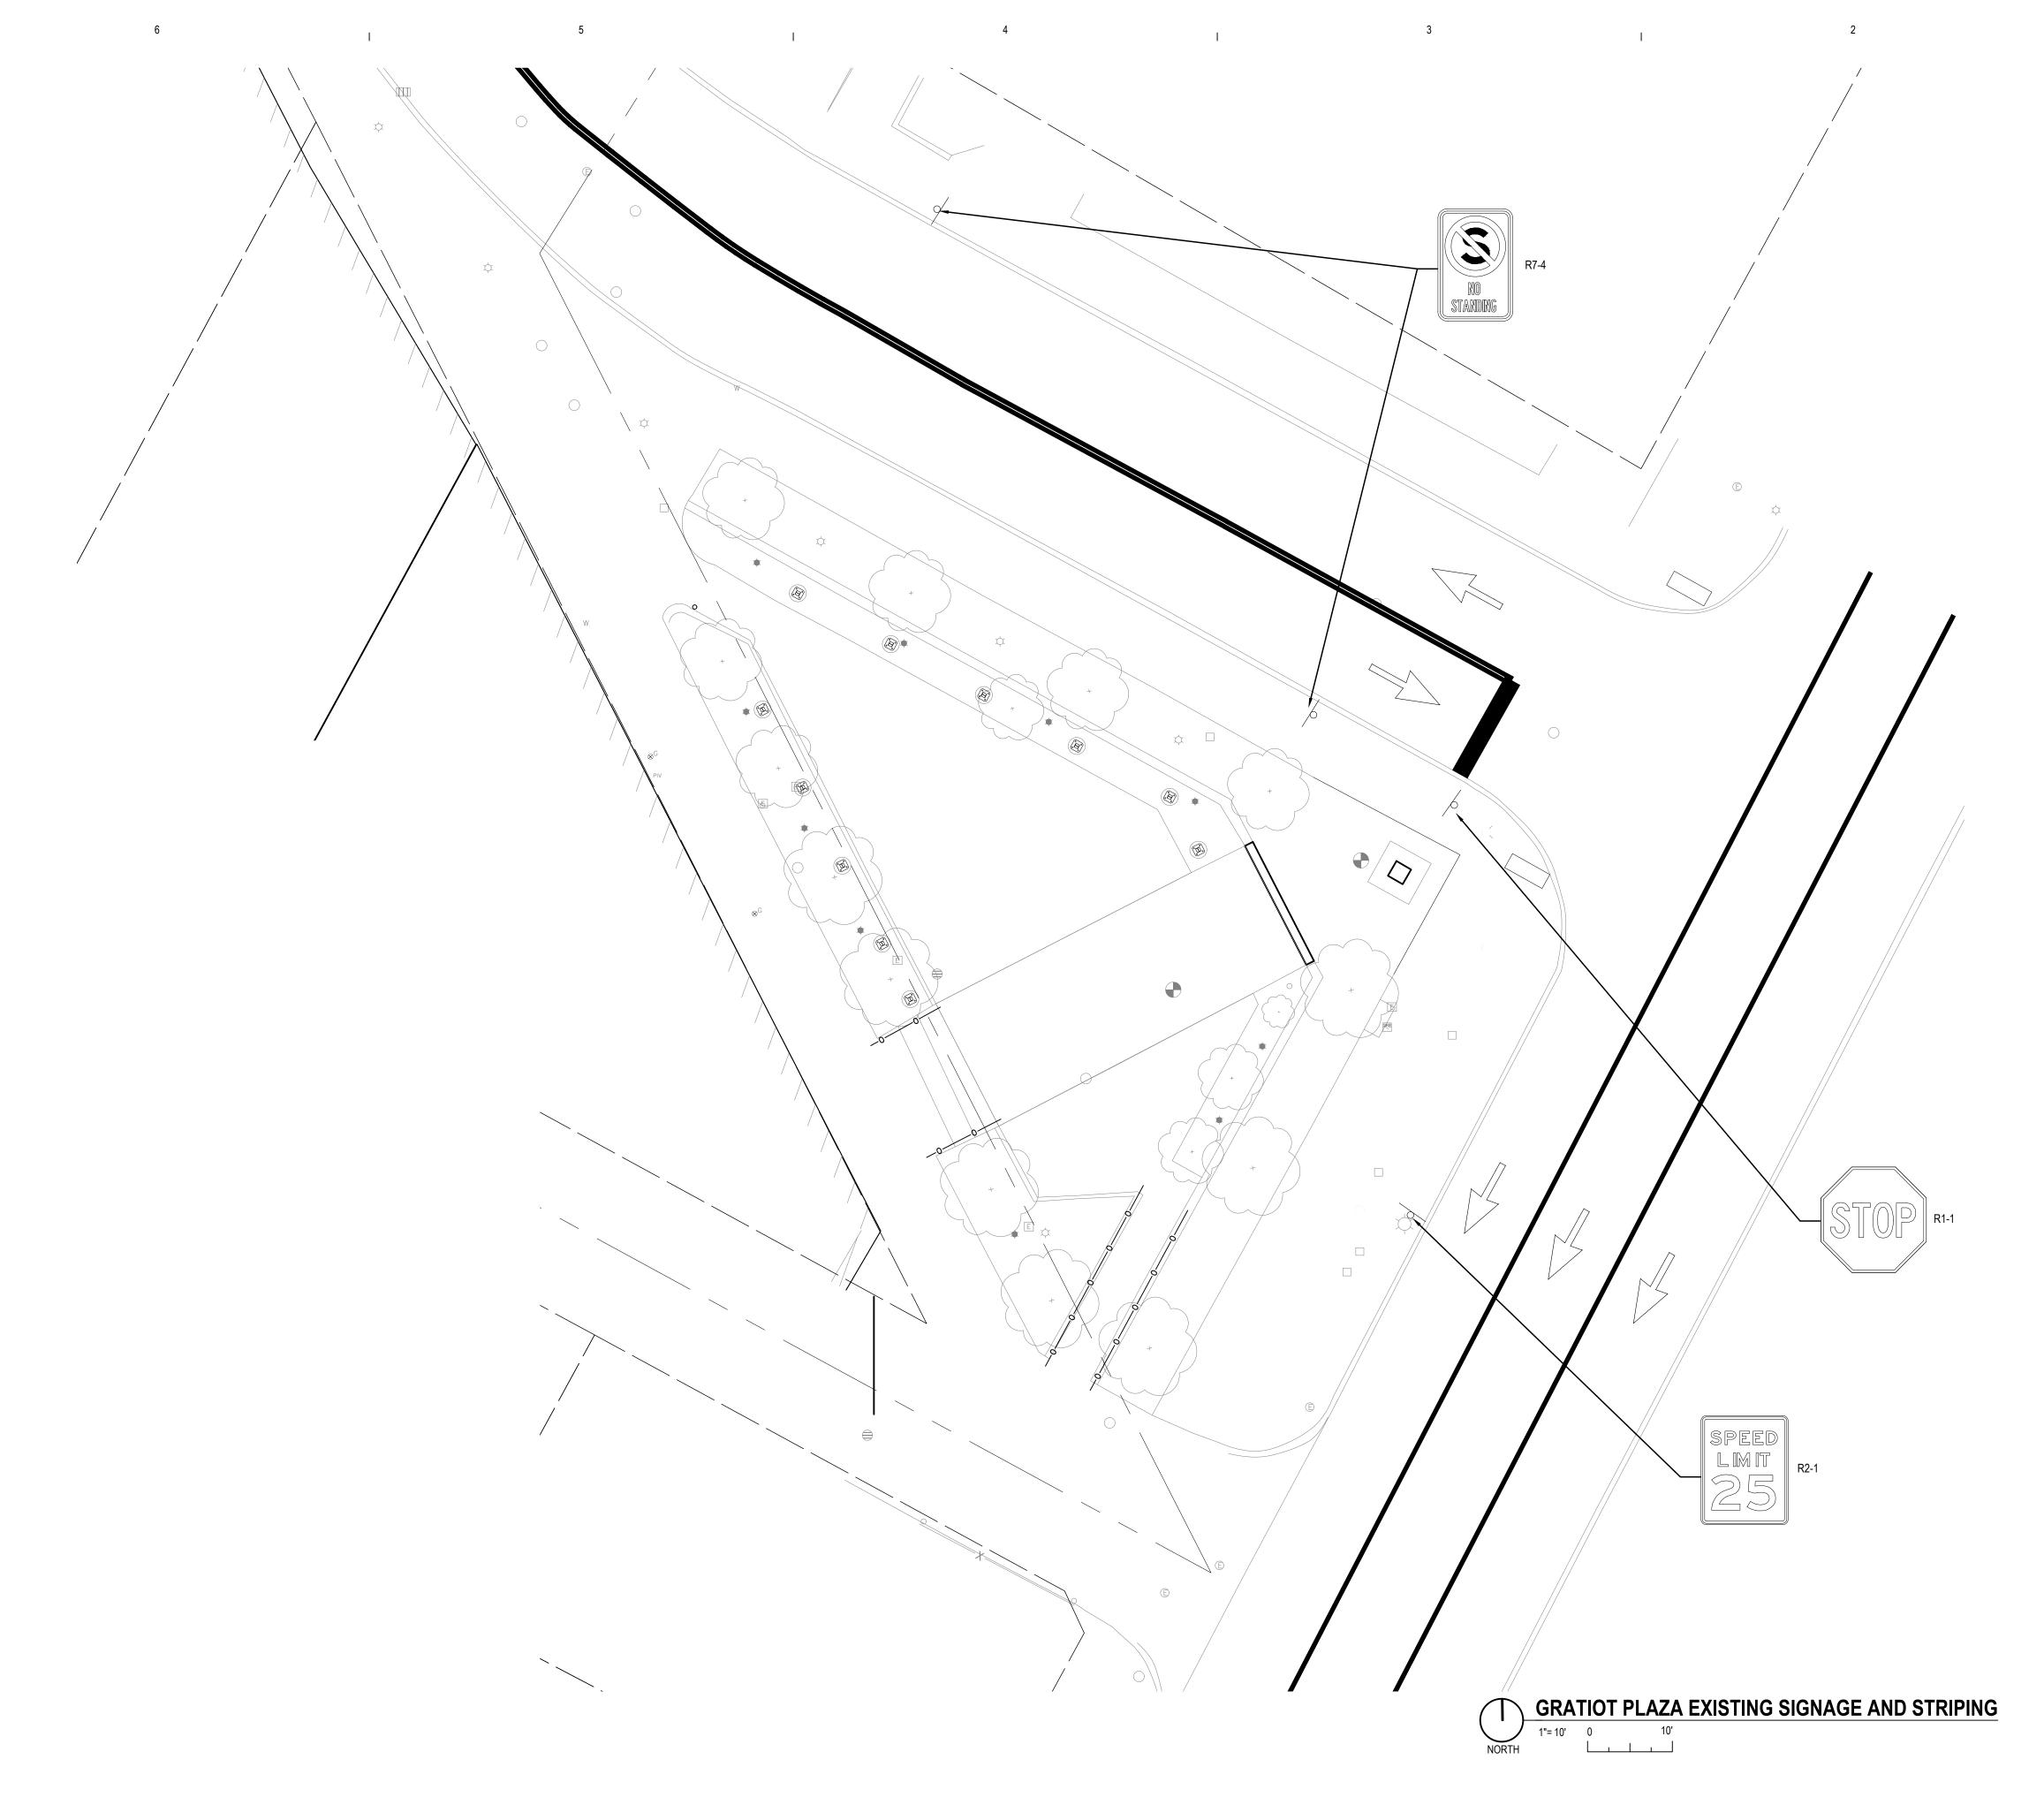

CONTRACTOR TO CONTACT 811 SERVICE AT LEAST 3 WORKING DAYS PRIOR TO CONSTRUCTION, TO CONFIRM LOCATION OF EXISTING UTILITIES. DIAL 811.

WHERE USED

construction sites.

ELEVATION = 601.35 TOP OF SW FLANGE BOLT TO HYD UNDER "J" OF EJIW S. SIDEOF GRAND RIVER AVENUE ±50' NW OF NW BLDG CORNER TO BUILDING ADDRESS 3N E. GRAND RIVER

TOP OF E. FLANGE BOLT TO HYD UNDER "E" OF MADE S. SIDE OF RANDOLPH ACROSS OF THE MICHIGAN CHRONICLE BUILDING

ELEVATION = 603.72 TOP OF W. FLANGE BOLT TO HYD UNDER "DI" SW QUADRANT OF GRATIOT AVENUE AND RANDOLPH STREET

GRADING LEGEND

_	-	FLOW ARROW
_	TP	TOP OF PAVEMENT
-	TC	TOP OF CURB
	TW	TOP OF WALL
	BW	BOTTOM OF WALL
	GR	GROUND
=	GP	GUTTER PAN
_	FF	FINISH FLOOR ELEVATION
-	EX	EXISTING ELEVATION
	HP	HIGH POINT
	LP	LOW POINT
	L	LANDING
	R	RAMP

ERO	SION CONTROLS		
E 5	DUST CONTROL		For use on construction sites, unpaved road etc. to reduce dust and sedimentation from wind and construction activities.
(E8)	PERMANENT SEEDING & MULCH BLANKETS	A TOTAL MANAGEMENT OF THE STATE	Stabilization method utilized on sites where earth change has been completed (final grad attained).
(551)	SILT FENCE		Use adjacent to critical areas, to prevent sediment laden sheet flow from entering the areas.

*DUST CONTROL TO BE MAINTAINED ON ENTIRE PROJECT

**SILT FENCE AS NEEDED ON PROJECT AS DIRECTED BY FIELD ENGINEER

PARADISE VALLEY CULTURAL AND ENTERTAINMENT DISTRICT CONSER REDEVELOPMENT AND USEATRICE BUCK PARK (FOR PARK) AND GRATIOT PLA

ISSUANCE

02/06/2024 CITY APPROVAL

PROJECT NUMBER 97080001 PROJECT MANAGER PROFESSIONAL

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BEATRICE BUCK PARK GRADING AND SESC PLAN
C301

Know what's below. Call before you dig. **BENCHMARKS**:

ELEVATION = 602.86

-	FLOW ARROW
TP	TOP OF PAVEMENT
TC	TOP OF CURB
TW	TOP OF WALL
BW	BOTTOM OF WALL
GR	GROUND
GP	GUTTER PAN
FF	FINISH FLOOR ELEVATION
EX	EXISTING ELEVATION
HP	HIGH POINT
LP	LOW POINT
L	LANDING
R	RAMP
	TC TW BW GR GP FF EX HP LP

S-E-S-C KEYING SYSTEM

ERO	SION CONTROLS		
E 5	DUST CONTROL		For use on construction sites, unpaved road etc. to reduce dust and sedimentation from wind and construction activities.
E8)	PERMANENT SEEDING & MULCH BLANKETS	xill something the same of the	Stabilization method utilized on sites where earth change has been completed (final graattained).
(551)	SILT FENCE		Use adjacent to critical areas, to prevent sediment laden sheet flow from entering the areas.
(CEO)	INLET PROTECTION		Use at stormwater inlets, especially at

CONTRACTOR TO CONTACT 811
SERVICE AT LEAST 3 WORKING
DAYS PRIOR TO CONSTRUCTION,
TO CONFIRM LOCATION OF
EXISTING UTILITIES. DIAL 811.

ELEVATION = 601.35 TOP OF SW FLANGE BOLT TO HYD UNDER "J" OF EJIW S. SIDEOF GRAND RIVER AVENUE $\pm 50^\circ$ NW OF NW BLDG CORNER TO BUILDING ADDRESS 3N E. GRAND RIVER

ELEVATION = 602.86 TOP OF E. FLANGE BOLT TO HYD UNDER "E" OF MADE S. SIDE OF RANDOLPH ACROSS OF THE MICHIGAN CHRONICLE BUILDING

ELEVATION = 603.72 TOP OF W. FLANGE BOLT TO HYD UNDER "DI" SW QUADRANT OF GRATIOT AVENUE

-	FLOW ARROW
TP	TOP OF PAVEMENT
TC	TOP OF CURB
TW	TOP OF WALL
BW	BOTTOM OF WALL
GR	GROUND
GP	GUTTER PAN
FF	FINISH FLOOR ELEVATION
EX	EXISTING ELEVATION
HP	HIGH POINT
LP	LOW POINT
L	LANDING
R	RAMP

S-E-S-C KEYING SYSTEM

KEY BEST MANAGEMENT PRACTICES

EROS	SION CONTROLS	
E5	DUST CONTROL	For use on construction sites, unpaved roads, etc. to reduce dust and sedimentation from wind and construction activities.
	PERMANENT SEEDING & MULCH BLANKETS	Stabilization method utilized on sites where earth change has been completed (final grading attained).
(551)	SILT FENCE	Use adjacent to critical areas, to prevent sediment laden sheet flow from entering these areas.
(\$58)	INLET PROTECTION FABRIC DROP	Use at stormwater inlets, especially at construction sites.

WHERE USED

*DUST CONTROL TO BE MAINTAINED ON ENTIRE PROJECT

(\$51) **SILT FENCE AS NEEDED ON PROJECT AS DIRECTED BY FIELD ENGINEER

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BEATRICE BUCK PARK (HARMONIE

PARADISE VALLEY CULTURAL AND

REDEVELOPMENT AND UPGRADE OF

BEATRICE BUCK PARK (HARMONIE

PARK) AND GRATIOT PLAZA

DETROIT, MICHIGAN


ISSUANCE


02/06/2024 CITY APPROVAL


PROJECT NUMBER 97080001 PROJECT MANAGER PROFESSIONAL DWW DRAWN BY DDS

CHECKED BY

GRATIOT PLAZA GRADING AND SESC PLAN
C302

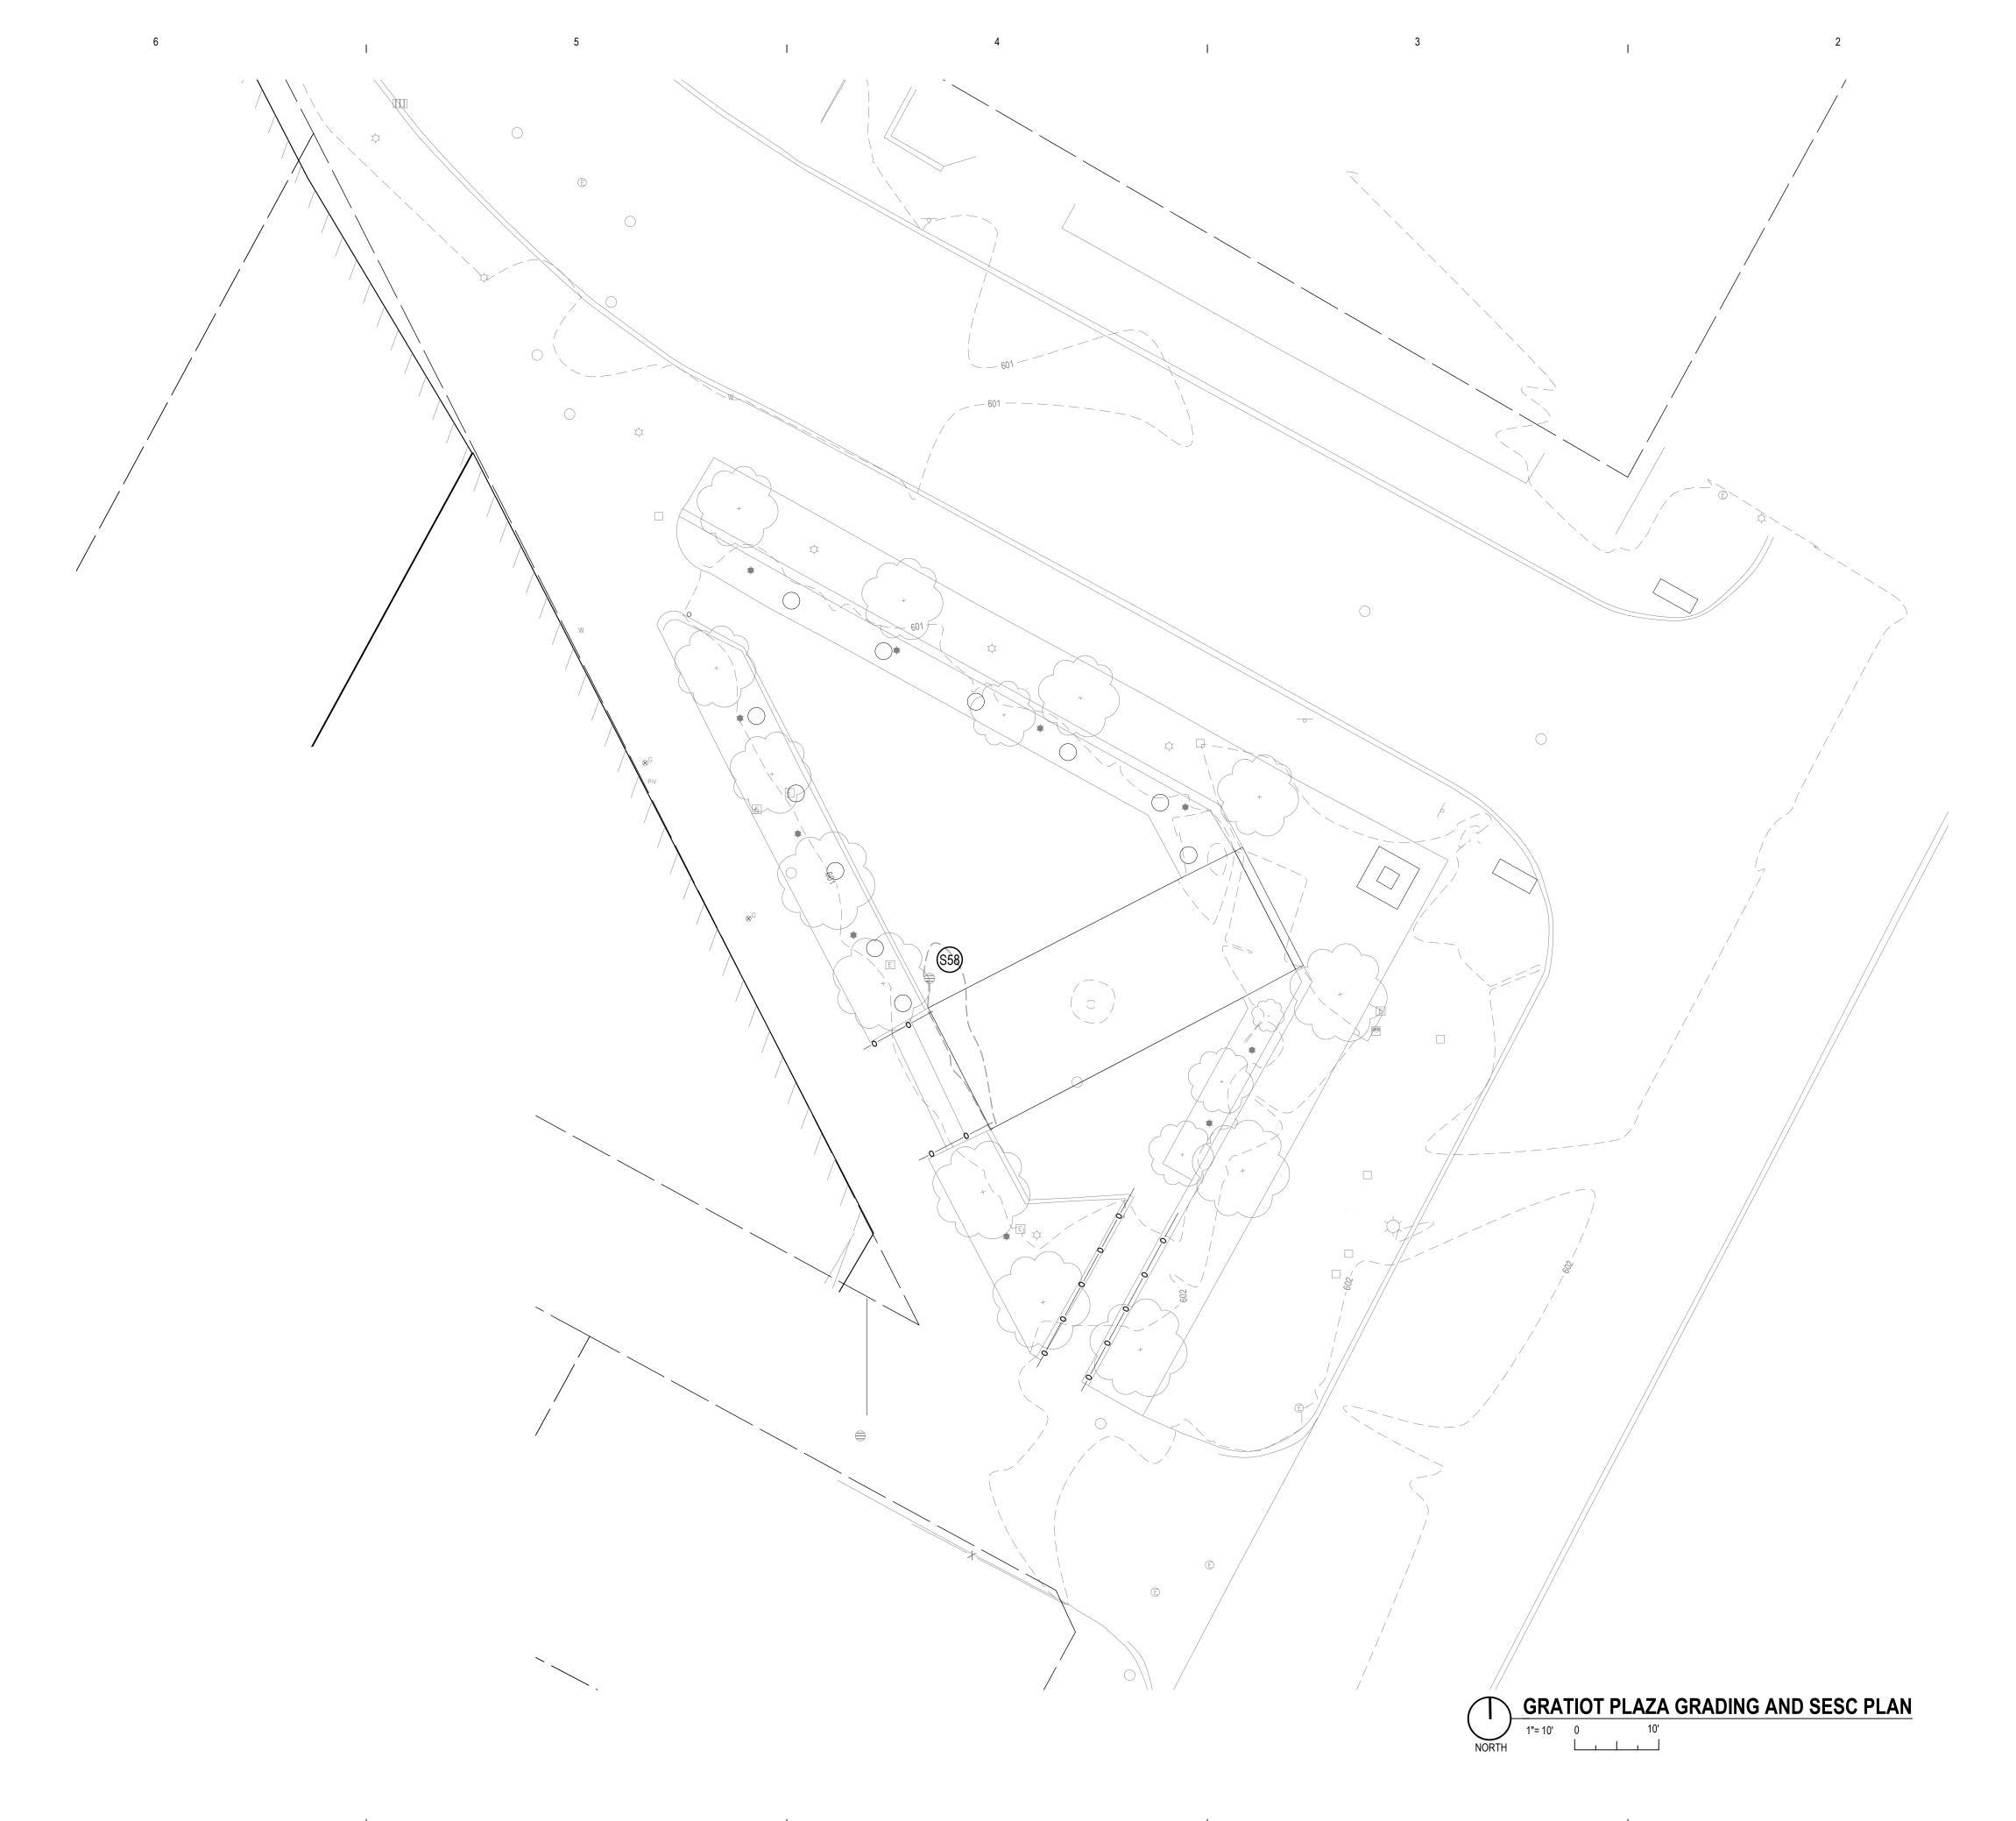

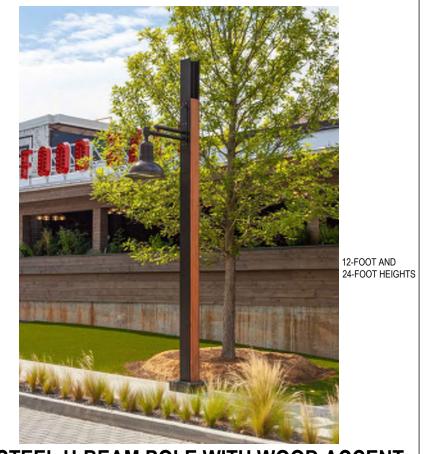

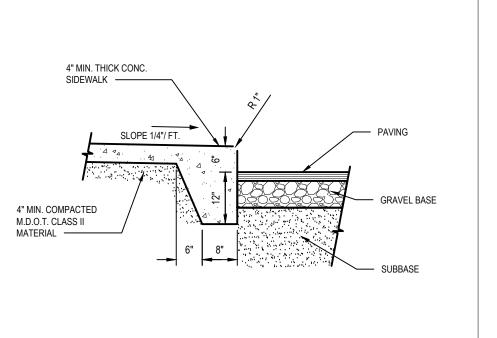

STEEL H-BEAM POLE WITH WOOD ACCENT

NOT TO SCALE

STEEL H-BEAM POLE WITH WOOD ACCENT

NOT TO SCALE

BANK HARM THEN HIS SPACE SLEEF IS 2.0% IN EACH DIRECTION OF TRAVEL. MINIMAR DEVENSIONS S' x 5'. SEE MOTES. TO MAXIMAN RIAM CHESS SERVE IS 2.0%, WINNING SERVE SE - 7%, 18.33 MAXIMAN . SEE MOTES. SIDEWALK RAMP TYPE R SIDEWALK RAMP TYPE P C 104/6418 04660 000 A00 DEPARTMENT OF PUBLIC WORKS, CITY ENGINEERING DIVISION SIDEWALK RAMP AND DETECTABLE WARNING DETAILS R-28-I WITH CITY OF DETROIT THICKNESS AMENDMENT CITY OF DETROIT SHEET 1 OF 7

C6 SIDEWALK RAMP DETAIL

NOT TO SCALE

PARADISE VALLEY
ENTERTAINMENT D
REDEVELOPN
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PARK) AND G
DETROIT, MICHIGAN COA ARCHITECT

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PROFESSIONAL DWW DRAWN BY

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DWW

SITE DETAILS C501

PLAN REMOVED FROM DOCUMENT SET, SEE GENERAL LANDSCAPE NOTES



CALL 811 NOTE:

CONTRACTOR TO CONTACT 811 SERVICE AT LEAST 3 WORKING DAYS PRIOR TO CONSTRUCTION, TO CONFIRM LOCATION OF EXISTING UTILITIES. DIAL 811.

GENERAL LANDSCAPE NOTES

- 1. IT HAS BEEN DETERMINED THAT THE EXISTING TREES ON SITE WILL BE SAVED. THE CONTRACTOR WILL BE RESPONSIBLE FOR REMOVING THE EXISTING IVY FITTHE UPPER TREE BRANCHES DOWN TO THE POINT WHERE MULTIPLE BRANCHE BEGIN TO FORM THE UPPER CANOPY. PRUNE OUT ALL DEAD WOOD, BROKEN BRANCHES, AND LIMBS AS REQUIRED. THE CONTRACTOR WILL ALSO BE RESPONSIBLE FOR CONSULTING WITH A CERTIFIED ARBORIST TO DETERMINE CONDITION OF THE TREES, AS WELL AS AN APPROPRIATE FERTILIZATION PROGRAM TO ENSURE THE VIABILITY OF THE PLANT MATERIAL.
- 2. ALL IVY BEYOND THE BASE OF THE TRUNK OF EACH TREE WILL BE REMOVED AN DISPOSED OF OFF-SITE. THIS REMOVAL ALSO INCLUDES THE IVY ON EXISTING STONE WALLS, LIGHTS, SIGNS, AND ANY OTHER VERTICAL ELEMENTS.
- 3. IT WILL BE THE RESPONSIBILITY OF THE CONTRACTOR TO DETERMINE THE LOCATION AND CONDITION OF THE EXISTING PLANT MATERIAL WHICH INCLUDES TREES, SHRUBS, PERENNIALS, AND GROUNDCOVER. ANY INFILL PLANTINGS WOULD BE SELECTED AND INSTALLED BY THE CONTRACTOR. THEY WOULD BE RESPONSIBLE FOR DETERMINING THE APPROPRIATE PLANT MATERIAL, SIZE, AN INSTALLATION DETAILS. ANY PLANT MATERIAL REQUIRING REPLACEMENT WOUL BE THE RESPONSIBILITY OF THE CONTRACTOR, PER THE STANDARD TERMS OF THE SPECIFICATIONS.
- 4. ANY PLANTING AREAS WILL BE COVERED WITH A MINIMUM OF 4" OF SHREDDED HARDWOOD BARK MULCH.
- 5. THE LOCATION OF ANY ANNUAL PLANTINGS WILL BE THE RESPONSIBILITY OF THE CONTRACTOR, AS WELL AS THE COORDINATION WITH THE CITY OF DETROIT PARKS DEPARTMENT.

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PROJECT NUMBER 97080001 PROJECT MANAGER DWW PROFESSIONAL

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BEATRICE BUCK PARK LANDSCAPING L201

PLAN REMOVED FROM DOCUMENT SET, SEE GENERAL LANDSCAPE NOTES



CALL 811 NOTE:

SERVICE AT LEAST 3 WORKING TO CONFIRM LOCATION OF EXISTING UTILITIES. DIAL 811.

GENERAL LANDSCAPE NOTES

- 4. ANY PLANTING AREAS WILL BE COVERED WITH A MINIMUM OF 4" OF SHREDDED HARDWOOD BARK MULCH.
- THE LOCATION OF ANY ANNUAL PLANTINGS WILL BE THE RESPONSIBILITY OF THE CONTRACTOR, AS WELL AS THE COORDINATION WITH THE CITY OF DETROIT

ISSUANCE

02/06/2024 CITY APPROVAL

PROJECT NUMBER 97080001 PROJECT MANAGER PROFESSIONAL

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BEATRICE BUCK PARK LANDSCAPING L202

PLAN REMOVED FROM DOCUMENT SET, SEE GENERAL LANDSCAPE NOTES



CALL 811 NOTE:

CONTRACTOR TO CONTACT 811 SERVICE AT LEAST 3 WORKING DAYS PRIOR TO CONSTRUCTION, TO CONFIRM LOCATION OF EXISTING UTILITIES. DIAL 811.

GENERAL LANDSCAPE NOTES

- 1. IT HAS BEEN DETERMINED THAT THE EXISTING TREES ON SITE WILL BE SAVED. THE CONTRACTOR WILL BE RESPONSIBLE FOR REMOVING THE EXISTING IVY FITTHE UPPER TREE BRANCHES DOWN TO THE POINT WHERE MULTIPLE BRANCHE BEGIN TO FORM THE UPPER CANOPY. PRUNE OUT ALL DEAD WOOD, BROKEN BRANCHES, AND LIMBS AS REQUIRED. THE CONTRACTOR WILL ALSO BE RESPONSIBLE FOR CONSULTING WITH A CERTIFIED ARBORIST TO DETERMINE CONDITION OF THE TREES, AS WELL AS AN APPROPRIATE FERTILIZATION PROGRAM TO ENSURE THE VIABILITY OF THE PLANT MATERIAL.
- 2. ALL IVY BEYOND THE BASE OF THE TRUNK OF EACH TREE WILL BE REMOVED AN DISPOSED OF OFF-SITE. THIS REMOVAL ALSO INCLUDES THE IVY ON EXISTING STONE WALLS, LIGHTS, SIGNS, AND ANY OTHER VERTICAL ELEMENTS.
- 3. IT WILL BE THE RESPONSIBILITY OF THE CONTRACTOR TO DETERMINE THE LOCATION AND CONDITION OF THE EXISTING PLANT MATERIAL WHICH INCLUDES TREES, SHRUBS, PERENNIALS, AND GROUNDCOVER. ANY INFILL PLANTINGS WOULD BE SELECTED AND INSTALLED BY THE CONTRACTOR. THEY WOULD BE RESPONSIBLE FOR DETERMINING THE APPROPRIATE PLANT MATERIAL, SIZE, AN INSTALLATION DETAILS. ANY PLANT MATERIAL REQUIRING REPLACEMENT WOUL BE THE RESPONSIBILITY OF THE CONTRACTOR, PER THE STANDARD TERMS OF THE SPECIFICATIONS.
- 4. ANY PLANTING AREAS WILL BE COVERED WITH A MINIMUM OF 4" OF SHREDDED HARDWOOD BARK MULCH.
- 5. THE LOCATION OF ANY ANNUAL PLANTINGS WILL BE THE RESPONSIBILITY OF THE CONTRACTOR, AS WELL AS THE COORDINATION WITH THE CITY OF DETROIT PARKS DEPARTMENT.

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PROGRESSIVE AE, I 1811 4 Mile Rd NE | Grand 2937 E. Grand Bivd., Suite

BEATRICE BUCK PARK (HARM PARK) AND GRATIOT PLAZA

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GRATIOT PLAZA LANDSCAPING L203

ADDITIONAL ART INSTALLATIONS./

13. COLOR AND FINISH OF FURNISHINGS TO BE SELECTED BY OWNER.



LITTER RECEPTACLE

OUTDOOR DINING TABLE WITH SEATING

BEATRICE BUCK PARK SITE FURNISHINGS

1"= 10' 0 10'

2-FOOT DIAMETER PLANTER POT

OVERHEAD FESTOON LIGHTING

CLEAN AND PREPARE SURFACE FOR PAINT APPLICATION (BY OTHERS)

CALL 811 NOTE:

CONTRACTOR TO CONTACT 811

- 10. ALL PAVEMENT, CURB & GUTTER, SIDEWALK AND UTILITIES WITHIN PUBLIC RIGHT OF WAY SHALL MEET CITY OF DETROIT STANDARDS.
- 11. CONTRACTOR TO PROTECT EXISTING IRRIGATION SYSTEM AS MUCH AS POSSIBLE. REPAIR DAMAGE TO EXISTING IRRIGATION SYSTEM AND RECONFIGURE SPRINKLER LAYOUT TO ACCOMMODATE THE NEW IMPROVEMENTS.
- 12. CLIENT AND CONTRACTOR TO DISCUSS THE POTENTIAL LOCATION OF

BENCH

FOUNTAIN

GROUP TABLE WITH SEATING

3-FOOT DIAMETER PLANTER POT

PARADISE VALLEY CULTURAL AND
ENTERTAINMENT DISTRICT CONSERVANCY

REDEVELOPMENT AND UPGRADE OF

BEATRICE BUCK PARK (HARMONIE
PARK) AND GRATIOT PLAZA

DETROIT, MICHIGAN

ISSUANCE

02/06/2024 CITY APPROVAL

PROJECT NUMBER 97080001 PROJECT MANAGER PROFESSIONAL

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BEATRICE BUCK

PARK SITE FURNISHINGS L701



BEATRICE BUCK PARK SITE FURNISHINGS

1"= 10' 0 10'



CALL 811 NOTE:

CONTRACTOR TO CONTACT 811 SERVICE AT LEAST 3 WORKING DAYS PRIOR TO CONSTRUCTION, TO CONFIRM LOCATION OF EXISTING UTILITIES. DIAL 811.

BENCHMARKS:

AND RANDOLPH STREET

ELEVATION = 601.35 TOP OF SW FLANGE BOLT TO HYD UNDER "J" OF EJIW S. SIDEOF GRAND RIVER AVENUE ±50' NW OF NW BLDG CORNER TO BUILDING ADDRESS 3N E. GRAND RIVER

ELEVATION = 602.86 TOP OF E. FLANGE BOLT TO HYD UNDER "E" OF MADE S. SIDE OF RANDOLPH

ACROSS OF THE MICHIGAN CHRONICLE BUILDING ELEVATION = 603.72 TOP OF W. FLANGE BOLT TO HYD UNDER "DI" SW QUADRANT OF GRATIOT AVENUE

GENERAL SITE LAYOUT NOTES

- 1. ALL WORKMANSHIP AND MATERIALS SHALL BE ACCORDING TO THE CURRENT MICHIGAN DEPARTMENT OF TRANSPORTATION (M.D.O.T) STANDARD SPECIFICATIONS FOR CONSTRUCTION.
- 2. CONTACT "MISS DIG" TOLL FREE AT 1-800-482-7171 THREE (3) DAYS PRIOR TO THE START OF CONSTRUCTION, EXCLUDING SATURDAYS, SUNDAYS,
- NO DIMENSION MAY BE SCALED. REFER UNCLEAR ITEMS TO THE ENGINEER FOR INTERPRETATION.
- DIMENSIONS SHOWN ARE TO FACE OF CURB UNLESS OTHERWISE NOTED AS B-B (BACK TO BACK) OR E-E (EDGE OF METAL TO EDGE OF METAL).
- CONTRACTOR TO PAINT STRIPE ALL PARKING SPACES SHOWN. PAINT COLOR TO BE YELLOW.
- 6. UPON REQUEST, ELECTRONIC INFORMATION WILL BE PROVIDED FOR SITE LAYOUT PURPOSES. CONTRACTOR SHALL REQUEST ALL INFORMATION IN WRITING THROUGH PROGRESSIVE AE. LAYOUT OF ALL NEW CONSTRUCTION SHALL BE DONE BY A LICENSED SURVEYOR.
- 7. ALL CONCRETE JOINTS SHALL BE TOOLED PER SPECIFICATIONS.
- 8. CONTRACTOR MUST RESTORE AND REPAIR ANY EXISTING CONDITIONS DISTURBED BY CONSTRUCTION. THIS IS TO INCLUDE BURIED UTILITIES, LIGHTING, LANDSCAPING, SPRINKLING, ETC.
- 9. ANY AREA DISTURBED BY CONSTRUCTION TO BE RESTORED TO CONDITION EQUAL TO OR BETTER THAN BEFORE CONSTRUCTION BEGAN.
- 10. ALL PAVEMENT, CURB & GUTTER, SIDEWALK AND UTILITIES WITHIN PUBLIC RIGHT OF WAY SHALL MEET CITY OF DETROIT STANDARDS.
- 11. CONTRACTOR TO PROTECT EXISTING IRRIGATION SYSTEM AS MUCH AS POSSIBLE. REPAIR DAMAGE TO EXISTING IRRIGATION SYSTEM AND RECONFIGURE SPRINKLER LAYOUT TO ACCOMMODATE THE NEW IMPROVEMENTS.
- 12. CLIENT AND CONTRACTOR TO DISCUSS THE POTENTIAL LOCATION OF ADDITIONAL ART INSTALLATIONS./
- 13. COLOR AND FINISH OF FURNISHINGS TO BE SELECTED BY OWNER.

SITE FURNISHING GRAPHIC KEY

BENCH

LITTER RECEPTACLE

GROUP TABLE WITH SEATING

OUTDOOR DINING TABLE WITH SEATING

3-FOOT DIAMETER PLANTER POT

2-FOOT DIAMETER PLANTER POT

OVERHEAD FESTOON LIGHTING

CLEAN AND PREPARE SURFACE FOR PAINT APPLICATION (BY OTHERS)

HIGH GRASS CORTEN STEEL PILLARS FOR IVY GROWTH

PARADISE VALLEY CULTURAL AND
ENTERTAINMENT DISTRICT CONSERVANCY

REDEVELOPMENT AND UPGRADE OF

BEATRICE BUCK PARK (HARMONIE
PARK) AND GRATIOT PLAZA

DETROIT, MICHIGAN COA ARCHITECT

ISSUANCE 02/06/2024

CITY APPROVAL

PROJECT NUMBER 97080001 PROJECT MANAGER PROFESSIONAL

DWW DRAWN BY DDS

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BEATRICE BUCK PARK SITE FURNISHINGS L702

CONTRACTOR TO CONTACT 811 SERVICE AT LEAST 3 WORKING DAYS PRIOR TO CONSTRUCTION, TO CONFIRM LOCATION OF EXISTING UTILITIES. DIAL 811.

ELEVATION = 601.35 TOP OF SW FLANGE BOLT TO HYD UNDER "J" OF EJIW S. SIDEOF GRAND RIVER AVENUE ±50' NW OF NW BLDG CORNER TO BUILDING ADDRESS 3N E. GRAND RIVER

ELEVATION = 602.86

TOP OF E. FLANGE BOLT TO HYD UNDER "E" OF MADE S. SIDE OF RANDOLPH ACROSS OF THE MICHIGAN CHRONICLE BUILDING

ELEVATION = 603.72 TOP OF W. FLANGE BOLT TO HYD UNDER "DI" SW QUADRANT OF GRATIOT AVENUE

GENERAL SITE LAYOUT NOTES

- 1. ALL WORKMANSHIP AND MATERIALS SHALL BE ACCORDING TO THE CURRENT MICHIGAN DEPARTMENT OF TRANSPORTATION (M.D.O.T) STANDARD SPECIFICATIONS FOR CONSTRUCTION.
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- CONTRACTOR TO PAINT STRIPE ALL PARKING SPACES SHOWN. PAINT COLOR TO BE YELLOW.
- UPON REQUEST, ELECTRONIC INFORMATION WILL BE PROVIDED FOR SITE LAYOUT PURPOSES. CONTRACTOR SHALL REQUEST ALL INFORMATION IN WRITING THROUGH PROGRESSIVE AE. LAYOUT OF ALL NEW CONSTRUCTION SHALL BE DONE BY A LICENSED SURVEYOR.
- 7. ALL CONCRETE JOINTS SHALL BE TOOLED PER SPECIFICATIONS.
- 8. CONTRACTOR MUST RESTORE AND REPAIR ANY EXISTING CONDITIONS DISTURBED BY CONSTRUCTION. THIS IS TO INCLUDE BURIED UTILITIES, LIGHTING, LANDSCAPING, SPRINKLING, ETC.
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- 12. CLIENT AND CONTRACTOR TO DISCUSS THE POTENTIAL LOCATION OF ADDITIONAL ART INSTALLATIONS./
- 13. COLOR AND FINISH OF FURNISHINGS TO BE SELECTED BY OWNER.

SEATING NOT IN CONTRACT

SITE FURNISHING GRAPHIC KEY

BENCH

LITTER RECEPTACLE

GROUP TABLE WITH SEATING

OUTDOOR DINING TABLE WITH SEATING

3-FOOT DIAMETER PLANTER POT

2-FOOT DIAMETER PLANTER POT

OVERHEAD FESTOON LIGHTING

PARADISE VALLEY CULTURAL AND
ENTERTAINMENT DISTRICT CONSERVANCY

REDEVELOPMENT AND UPGRADE OF

BEATRICE BUCK PARK (HARMONIE
PARK) AND GRATIOT PLAZA

DETROIT, MICHIGAN

COA ARCHITECT

ISSUANCE 02/06/2024 CITY APPROVAL

PROJECT NUMBER 97080001 PROJECT MANAGER DWW PROFESSIONAL

DWW DRAWN BY DDS CHECKED BY

GRATIOT PLAZA SITE FURNISHINGS L703



KILOVOLT-AMPERES

KILOWATT-HOURS

LEADERSHIP IN ENERGY AND ENVIRONMENTAL

KILOWATTS

DESIGN

LIGHTING

LOW VOLTAGE

MECHANICAL

MAIN LUGS ONLY

MAIN SWITCH BOARD

MOTOR, MOTORIZED

ASSOCIATION

NIGHT-LIGHT

OVERHEAD

POWER POLE

RECEPTACLE

TELEPHONE

TELEVISION

UNDERGROUND

VOLT-AMPERES

WATER HEATER

TRANSFORMER

TRANSFER

UNIT HEATER

VOLTS

WATTS

PHASE

ROOFTOP UNIT

TAMPER RESISTANT

UNDERGROUND ELECTRICAL

VARIABLE FREQUENCY DRIVE

POLYVINYL CHLORIDE

PRIMARY

POWER

PUMP

PHASE

PANEL

OVERHEAD DOOR

MANUAL TRANSFER SWITCH

MANHOLE

MOUNT

MECHANICAL CONTRACTOR

MINIMUM CIRCUIT AMPS

MAIN CIRCUIT BREAKER

MOTORIZED DAMPER

MOTOR CONTROL CENTER

MAIN DISTRIBUTION PANEL

MAIN FUSED DISCONNECT SWITCH

MAXIMUM OVERCURRENT PROTECTION

NATIONAL ELECTRICAL MANUFACTURER'S

ISOLATED GROUND INTERMEDIATE METAL CONDUIT JBOX JUNCTION BOX

KVA

KW

KWH

LEED

LTG

LV

MC

MCA

MCB

MCC

MDP

MECH

MFDS

MH

MLO

MSBD

ΜT

MTR

MTS

OHD

PVC

PWR

RTU

VFD

XFER

XFMR

RECEPT

APPROX APPROXIMATE ATS AUTOMATIC TRANSFER SWITCH AUX AUXILARY AMERICAN WIRE GAUGE **BOILER**

AIR CONDITIONING UNIT

AUTHORITY HAVING JURISDICTION

ABOVE FINISH GRADE

AIR HANDLING UNIT

AWG BUILDING AUTOMATION SYSTEM BARRIER FREE

AMPERES

ALUMINUM

ACCESS PANEL

ACU

AHJ

AHU

BFG BELOW FINISHED GRADE BMS BUILDING MANAGEMENT SYSTEM BOD BOTTOM OF DEVICE **BSMT** BASEMENT CONDUIT COMMUNITY ANTENNA TELEVISION

CATV CB CIRCUIT BREAKER CCTV CLOSED-CIRCUIT TELEVISION CF **CEILING FAN** CABINET HEATER CENTERLINE CLEAR, CLEARANCE

CLR CMPR COMPRESSOR CONV CONVECTOR CIRCULATING PUMP CARD READER **COOLING TOWER** CU COPPER

DEPT DEPARTMENT DET DETAIL DISC DISCONNECT DIST DISTRIBUTION DISHWASHER DW DWH DOMESTIC WATER HEATER EXHAUST FAN **ELEC** ELECTRIC, ELECTRICAL **ELEV ELEVATOR**

EM **EMERGENCY** ENERGY MANAGEMENT SYSTEM EMT ELECTRICAL METALLIC TUBING **EWC** ELECTRIC WATER COOLER ELECTRIC WATER HEATER

FAHRENHEIT FIRE ALARM FACP FIRE ALARM CONTROL PANEL FBO FURNISHED BY OTHERS FLEXIBLE CONNECTION FDS FUSED DISCONNECT SWITCH FIXT FIXTURE

FLUORESCENT FULL LOAD AMPS FLEX **FLEXIBLE** FMC FLEXIBLE METAL CONDUIT **FURN** FURNISH, FURNISHED GALV GALVANIZED

GEN GENERATOR GFI GROUND FAULT CIRCUIT INTERRUPTOR

	SITE SYMBOL LEGEND										
SYMBOL	DESCRIPTION										
• •	LINEAR LIGHT (TYPE DENOTED)										
\oslash	IN-GRADE LIGHT (TYPE DENOTED)										
•-	POLE TOP MOUNTED LIGHT (TYPE DENOTED)										
Ø	FESTOON LIGHT (TYPE DENOTED)										
	GOBO LIGHT (TYPE DEMOTED)										
	JUNCTION BOX (IN-GRADE)										
	POWER PEDESTAL										
М	UTILITY METER										
	CIRCUIT BREAKER PANEL										
	CEILING CCTV CAMERA										
<u>\$</u>	SPEAKER (WALL OR CEILING MT.)										

NOTE: SYMBOLS REPRESENT EQUIPMENT SPECIFIED BYOTHERS, THE SCOPE OF WORK REPRESENTED IN THESE DRAWINGS INCLUDES DEVICE BACKBOX AND CONDUIT FROM BACKBOX TO ABOVE ACCESSIBLE CEILING TERMINATED WITH INSULATED BUSHING (UNLESS NOTED OTHERWISE).

GENERAL ELECTRICAL NOTES

- 1. ALL WORK TO COMPLY WITH ALL APPLICABLE CODES AND REGULATIONS ADOPTED BY THE AHJ FOR THE PROJECT LOCATION, INCLUDING (NOT NOT LIMITED TO) ELECTRICAL CODES, BUILDING CODES, ENERGY CODES, ETC.
- 2. COORDINATE INSTALLATION WITH ARCHITECTURAL PLANS, ELEVATIONS, AND REFLECTED CEILING PLANS FOR DEVICE AND FIXTURE PLACEMENT, AS WELL AS FIRE RATED PARTITIONS, EXPANSION JOINTS, ETC.
- 3. COORDINATE INSTALLATION WITH VENDOR/ CONTRACTOR SHOP DRAWINGS WHERE APPROPRIATE.
- 4. FIELD COORDINATE INSTALLATION WITH THE INSTALLATION OF OTHER TRADES TO AVOID CLASHES AND CONFLICTS.
- 5. WHERE MOUNTING HEIGHTS ARE SHOWN, THEY ARE TO BE CONSIDERED TO BE TO THE CENTER OF THE DEVICE, UNLESS NOTED OTHERWISE.
- 6. ALL CONDUCTORS OPERATING AT 50 VOLTS OR GREATER SHALL BE IN RACEWAY OR PART OF A LISTED CABLE ASSEMBLY SUITABLE FOR THE INSTALLED PURPOSE AND LOCATION, AND ALLOWED BY PROJECT SPECIFICATIONS.
- 7. ALL CABLES AND CONDUCTORS OPERATING AT LESS THAN 50 VOLTS SHALL BE IN RACEWAY WHERE INSTALLED WITHIN WALLS OR INACCESSIBLE SPACES. CABLES ABOVE ACCESSIBLE CEILINGS MAY BE ROUTED IN CABLE SUPPORT HOOKS/RINGS. CABLES TO BE ROUTED IN CABLE TRAY WHERE SHOWN.
- 8. FOR 20 AMPERE, 120 VOLT BRANCH CIRCUITS, USE #10 AWG CONDUCTORS FOR BRANCH CIRCUITS LONGER THAN 75 FEET AND #8 AWG CONDUCTORS FOR BRANCH CIRCUITS LONGER THAN 150 FEET, UNO. THIS SHALL BE REQUIRED FOR THE ENTIRE LENGTH OF THE CIRCUIT.
- 9. FOR 20 AMPERE, 277 VOLT BRANCH CIRCUITS, USE #10 AWG CONDUCTORS FOR BRANCH CIRCUITS LONGER THAN 150 FEET, UNO. THIS SHALL BE REQUIRED FOR THE ENTIRE LENGTH OF THE CIRCUIT.
- 10. WHERE CONFLICTS EXIST IN DRAWINGS OR BETWEEN DRAWINGS AND SPECIFICATIONS, ISSUE REQUEST FOR INTERPRETATION TO DESIGN TEAM FOR CLARIFICATION PRIOR TO INSTALLATION.

DEVELOPMENT AND UPGRADE BEATRICE PARK (HARMONIE RK) AND GRATIOT PLAZA

COA ARCHITECT

ISSUANCE 02/02/2024 CITY APPROVAL

PROJECT NUMBER 97080001 PROJECT MANAGER D. WESTENBURG S. GENGELBACH DRAWN BY K. WOOD CHECKED BY

S. GENGELBACH

ELECTRICAL NOTES AND **ABBREVIATIONS**

E001

OVERALL ELECTRICAL DEMOLITION SITE PLAN

SITE DEMOLITION GENERAL NOTES

- A. REFERENCE CIVIL AND LANDSCAPE DOCUMENTS FOR PHASES OF DEMOLITION AND CONSTRUCTION. COORDINATE THE GENERAL CONSTRUCTION.
- B. DISCONNECT AND REMOVE ALL ELECTRICAL EQUIPMENT, DEVICES, AND LUMINAIRES IN DEMOLITION AREA UNLESS NOTED OTHERWISE.
- C. COORDINATE AND VERIFY REQUIREMENTS WITH NEW WORK TO BE CONSTRUCTED IN THE AREA.
- D. MAINTAIN ELECTRICAL AND DATA/COMMUNICATIONS SERVICE TO EQUIPMENT, DEVICES, AND LUMINAIRES LOCATED OUTSIDE OF DEMOLITION AREA BUT MAY BE AFFECTED BY WORK WITHIN DEMOLITION AREA. PROVIDE CONDUCTORS AND RACEWAY AS REQUIRED.

SITE DEMOLITION KEYNOTES

- 1. REMOVE ALL EXISTING IN-GRADE FIXTURES AND WIRING BACK TO SOURCE.
- 2. REMOVE EXISTING SURFACE MOUNTED LIGHTING FIXTURE, WIRING AND ANY ASSOCIATED CONDUIT BACK TO SOURCE.
- 3. REMOVE ALL EXISTING SPEAKERS, WIRE AND CONDUIT BACK TO SOURCE.
- 4. REMOVE EXISTING POWER PEDESTALS, CONDUIT AND WIRE BACK TO SOURCE.
- 5. REMOVE EXISTING POWER AND LIGHTING CONTROLS AND PANELS BACK TO UTILITY

REDEVELOPMENT AND UPGRADE OF BEATRICE PARK (HARMONIE PARK) AND GRATIOT PLAZA DETROIT, MICHIGAN

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CHECKED BY S. GENGELBACH

OVERALL ELECTRICAL DEMOLITION SITE PLAN

PP-PARK-4 PP-PARK-1 PP-PARK-6 PP-PARK-7 PP-PARK-8

- 1. PROVIDE 16", 1-GANG, LEGRAND 30A POWER PEDESTALS #XPP1G16-BK IN LOCATIONS INDICATED FOR FOOD TRUCKS DURING EVENTS. PROVIDE WEATHERPROOF FLIP LID LEGRAND #XPP1G16C-BK AND LEGRAND 1-GANG DEVICE PLATE #XPP1GP-BK. COORDINATE WITH CIVIL, LANDSCAPE ARCHITECT AND IRRIGATION CONTRACTOR FOR EXACT LOCATIONS.
- 2. PROVIDE 30", 2-GANG, LEGRAND 20A POWER PEDESTALS #XPP2G30-BK WITH (4) USB AND (2) 20A DUPLEX . PROVIDE WEATHERPROOF FLIP LID LEGRAND #XPP2G30C-BK AND LEGRAND 1-GANG DEVICE PLATE #XPP2GP-BK. COORDINATE WITH CIVIL, LANDSCAPE ARCHITECT AND IRRIGATION CONTRACTOR FOR EXACT LOCATIONS.
- 3. PROVIDE HUBBELL WIEGMANN S5040218 STAINLESS STEEL ENCLOSURE 36x24x8 N4X, 304 STAINLESS STEEL ELECTRICAL PANEL. EXTEND EXISTING FEEDER FROM EXISTING METER WHICH SHALL REMAIN.
- PROVIDE IN-GRADE JUNCTION BOX FOR ELECTRICAL CONNECTION TO HANDRAILS. REFER TO SHEETS ES003 FOR HANDRAIL LOCATION AND SHEET E602 FOR LIGHTING FIXTURE SCHEDULE. COORDINATE WITH CIVIL / LANDSCAPE TRADES.
- 5. PROVIDE HUBBELL #WRD723630SSFSN4, 72x36x30 NEMA 4X 304 STAINLESS STEEL ENCLOSURE WITH COOLING FOR SOUND SYSTEM, AV, RGBW CONTROLLERS AND REMOTE LED DRIVERS. COORDINATE WITH CIVIL / LANDSCAPE AND SOUND EQUIPMENT TRADES. PROVIDE 8" CONCRETE PAD FOR NEMA 4X WEATHERPROOF CABINET WITH (6) 2" CONDUIT STUB-UPS FOR DMX CABLING, POWER, SPEAKER AND AMP CABLING. REFER TO SHEET E601 FOR PAD BASE DETAIL.

REDEVELOPMENT AND UPGRADE OF BEATRICE PARK (HARMONIE PARK) AND GRATIOT PLAZA DETROIT, MICHIGAN

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BEATRICE BUCK PARK ELECTRICAL SITE LAYOUT

ES002

BEATRICE BUCK PARK ELECTRICAL SITE LAYOUT POWER

BEATRICE BUCK PARK ELECTRICAL SITE LAYOUT LIGHTING

SITE GENERAL NOTES

- A. ALL LIGHTING AND POWER CONDUCTORS SHALL BE INSTALLED BETWEEN 24" (MINIMUM) AND 36" (MAXIMUM) BELOW FINISHED GRADE.
- B. ALL COMMUNICATIONS CONDUIT AND CABLES SHALL BE INSTALLED 36" (MINIMUM) BELOW FINISHED GRADE.
- C. ALL CONDUCTORS FOR EXTERIOR LIGHTING AND POWER CIRCUITS SHALL BE #8 AWG
- D. ROUTE ALL UNDERGROUND CONDUITS OR UNDERGROUND CABLING PARALLEL TO ONE ANOTHER. DIRECTIONAL BORE UNDER EXISTING CONCRETE AND PAVERS.

○ SITE PLAN KEYNOTES

- 1. GENERAL PARK AND PLAZA LIGHTING SHALL BE CONTROLLED VIA PHOTOCELL AND TIMECLOCK, WITH DMX AND TIMECLOCK OVERRIDE WITH 2, 4, 6 HOUR OVERRIDE CAPABILITIES FOR EVENTS. THE PARK AND PLAZA SHALL BE CONTROLLED SEPARATELY FROM ONE ANOTHER.
- 2. EXISTING POLE AND FIXTURE SHALL REMAIN. RELAMP WITH 3000K LED REPLACEMENT LAMP, CURRENT LIGHTING #93303384.
- 3. PROVIDE NEW POLE BASE, POLE AND LUMINAIRE. REFER TO LUMINAIRE SCHEDULE ON SHEET E602 AND BASE DETAIL ON SHEET E601. VERIFY POLE HEIGHT PRIOR TO ORDERING.
- 4. PROVIDE DMX CONTROLLERS FOR RBGW FIXTURES IN NEMA 4 EXTERIOR WEATHERPROOF BOX. TIE ALL CONTROLLERS INTO ONE MAIN DMX PROGRAMMING STATION FOR SCENE PROGRAMMING. CONNECT SOUND EQUIPMENT AMPLIFIER INTO MAIN DMX CONTROLLER. REFER TO SHEET ES002.
- 5. PROVIDE 120V BRANCH CIRCUITING FROM PANEL PP-PARK TO DMX CONTROLLERS AS NECESSARY FOR A FULLY OPERATIONAL SYSTEM. REFER TO PANEL SCHEDULE PP-PARK ON SHEET E602 FOR BRANCH CIRCUITING. PROVIDE DMX CONTROL CABLING FROM DMX CONTROLLERS LOCATED IN NEMA 4X ENCLOSURE. REFER TO MANUFACTURERS INSTALLATION INSTRUCTIONS.
- 6. PROVIDE IN-GRADE JUNCTION BOX FOR ELECTRICAL CONNECTION TO HANDRAILS. REFER TO SHEETS ES002 FOR JUNCTION BOX LOCATION AND SHEET E602 FOR LIGHTING FIXTURE SCHEDULE. REFER TO MANUFACTURERS INSTALLATION INSTRUCTIONS. COORDINATE WITH CIVIL / LANDSCAPE TRADES.
- 7. COORDINATE AIMING OF GOBO FIXTURES WITH PARK COMMITTEE PRIOR TO INSTALLATION.

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BEATRICE BUCK PARK ELECTRICAL SITE LAYOUT LIGHTING

BEATRICE BUCK PARK ELECTRICAL SITE LAYOUT SYSTEMS

SITE GENERAL NOTES

- A. ALL LIGHTING AND POWER CONDUCTORS SHALL BE INSTALLED BETWEEN 24" (MINIMUM) AND 36" (MAXIMUM) BELOW FINISHED GRADE.
- B. ALL COMMUNICATIONS CONDUIT AND CABLES SHALL BE INSTALLED 36" (MINIMUM) BELOW FINISHED GRADE.
- C. ALL CONDUCTORS FOR EXTERIOR LIGHTING AND POWER CIRCUITS SHALL BE #8 AWG
- D. ROUTE ALL UNDERGROUND CONDUITS OR UNDERGROUND CABLING PARALLEL TO ONE ANOTHER. DIRECTIONAL BORE UNDER EXISTING CONCRETE AND PAVERS.

- 1. CAMERAS SHALL BE AXIS M4308-PLE PANORAMIC CAMERA WITH AXIS T94T02D PENDANT KIT AND AXIS T91B67 POLE MOUNT. (OR EQUIVALENT)
- 2. SOUND SHALL BE ATLAS SOUND GSS-G 70V ALL WEATHER LANDSCAPE LOUDSPEAKER WITH DOUBLE 8" COAXIAL SPEAKERS WITH 360-DEGREE HORIZONTAL DISPERSION PATTERN. (OR EQUIVALENT) REMOVE AND REPLACE EXISTING SPEAKERS, UTILIZE EXISTING UNDERGROUND CABLING AND CONDUIT.
- 3. SOUND AND CAMERA EQUIPMENT SHALL BE MOUNTED IN NEMA 4X WEATHERPROOF CABINET. REFER TO SHEET ES002. WALL MOUNTED EQUIPMENT CABINET, 24X24X24, 19-IN EIA RAILS, DUAL-HINGED AND LOCKING DOOR, VENTED FOR DATA SWITCH AND AMPLIFIER / MIXER. TWO (2) DEDICATED 20A, 120V RECEPTACLES AND (1) 2000 VA UPS WITH MINIMUM (8) 20A, 120V RECEPTACLES BY APC OR EQUIVALENT. PROVIDE (1) RACK UNIT FOR CAMERA. THE PARK AND PLAZA SHALL BE CONTROLLED SEPARATELY FROM ONE ANOTHER. PROVIDE 8" CONCRETE PAD FOR NEMA 4X WEATHERPROOF CABINET. REFER TO SHEET E601 FOR PAD BASE DETAIL.

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REDEVELOPMENT AND UPGRADE OF BEATRICE PARK (HARMONIE PARK) AND GRATIOT PLAZA DETROIT, MICHIGAN

COA ARCHITECT COA ENGINEER

ISSUANCE 02/02/2024

CITY APPROVAL

PROJECT NUMBER
97080001
PROJECT MANAGER
D. WESTENBURG
PROFESSIONAL
S. GENGELBACH
DRAWN BY

S. GENGELBACH

DRAWN BY

K. WOOD

CHECKED BY

S. GENGELBACH

BEATRICE BUCK PARK ELECTRICAL SITE LAYOUT SYSTEMS

SITE GENERAL NOTES

- A. ALL LIGHTING AND POWER CONDUCTORS SHALL BE INSTALLED BETWEEN 24" (MINIMUM) AND 36" (MAXIMUM) BELOW FINISHED GRADE.
- B. ALL COMMUNICATIONS CONDUIT AND CABLES SHALL BE INSTALLED 36" (MINIMUM) BELOW FINISHED GRADE.

C. ALL CONDUCTORS FOR EXTERIOR LIGHTING AND POWER CIRCUITS SHALL BE #8 AWG

D. ROUTE ALL UNDERGROUND CONDUITS OR UNDERGROUND CABLING PARALLEL TO ONE ANOTHER. DIRECTIONAL BORE UNDER EXISTING CONCRETE AND PAVERS.

○ SITE PLAN KEYNOTES

- PROVIDE 16", 1-GANG, LEGRAND 30A POWER PEDESTALS #XPP1G16-BK IN LOCATIONS INDICATED FOR FOOD TRUCKS DURING EVENTS. PROVIDE WEATHERPROOF FLIP LID LEGRAND #XPP1G16C-BK AND LEGRAND 1-GANG DEVICE PLATE #XPP1GP-BK. COORDINATE WITH CIVIL, LANDSCAPE ARCHITECT AND IRRIGATION CONTRACTOR FOR EXACT LOCATIONS.
- 2. PROVIDE 30", 2-GANG, LEGRAND 20A POWER PEDESTALS #XPP2G30-BK WITH (4) USB AND (2) 20A DUPLEX . PROVIDE WEATHERPROOF FLIP LID LEGRAND #XPP2G30C-BK AND LEGRAND 1-GANG DEVICE PLATE #XPP2GP-BK. COORDINATE WITH CIVIL, LANDSCAPE ARCHITECT AND IRRIGATION CONTRACTOR FOR EXACT LOCATIONS.
- 3. PROVIDE HUBBELL WIEGMANN S5040218 STAINLESS STEEL ENCLOSURE 36x24x8 N4X, 304 STAINLESS STEEL ELECTRICAL PANEL. EXTEND EXISTING FEEDER FROM EXISTING METER WHICH SHALL REMAIN.
- 4. PROVIDE IN-GRADE JUNCTION BOX FOR ELECTRICAL CONNECTION TO HANDRAILS. REFER TO SHEETS ES003 FOR HANDRAIL LOCATION AND SHEET E602 FOR LIGHTING FIXTURE SCHEDULE. COORDINATE WITH CIVIL / LANDSCAPE TRADES.
- 5. PROVIDE HUBBELL #WRD723630SSFSN4, 72x36x30 NEMA 4X 304 STAINLESS STEEL ENCLOSURE WITH COOLING FOR RBGW CONTROLLERS, REMOTE LED DRIVERS AND FUTURE SOUND AND AV. COORDINATE WITH CIVIL / LANDSCAPE AND SOUND EQUIPMENT TRADES. PROVIDE 8" CONCRETE PAD FOR NEMA 4X WEATHERPROOF CABINET WITH (6) 2" CONDUIT STUB-UPS FOR DMX CABLING, POWER, SPEAKER AND AMP CABLING. REFER TO SHEET E601 FOR PAD BASE DETAIL.

REDEVELOPMENT AND UPGRADE OF BEATRICE PARK (HARMONIE PARK) AND GRATIOT PLAZA DETROIT, MICHIGAN

COA ARCHITECT

ISSUANCE 02/02/2024 CITY APPROVAL

PROJECT NUMBER 97080001 PROJECT MANAGER D. WESTENBURG S. GENGELBACH

K. WOOD CHECKED BY S. GENGELBACH

GRATIOT PLAZA ELECTRICAL SITE LAYOUT POWER

SITE GENERAL NOTES

- A. ALL LIGHTING AND POWER CONDUCTORS SHALL BE INSTALLED BETWEEN 24" (MINIMUM) AND 36" (MAXIMUM) BELOW FINISHED GRADE.
- B. ALL COMMUNICATIONS CONDUIT AND CABLES SHALL BE INSTALLED 36" (MINIMUM) BELOW FINISHED GRADE.

C. ALL CONDUCTORS FOR EXTERIOR LIGHTING AND POWER CIRCUITS SHALL BE #8 AWG

D. ROUTE ALL UNDERGROUND CONDUITS OR UNDERGROUND CABLING PARALLEL TO ONE ANOTHER. DIRECTIONAL BORE UNDER EXISTING CONCRETE AND PAVERS.

○ SITE PLAN KEYNOTES

- 1. GENERAL PARK AND PLAZA LIGHTING SHALL BE CONTROLLED VIA PHOTOCELL AND TIMECLOCK, WITH DMX AND TIMECLOCK OVERRIDE WITH 2, 4, 6 HOUR OVERRIDE CAPABILITIES FOR EVENTS. THE PARK AND PLAZA SHALL BE CONTROLLED SEPARATELY FROM ONE ANOTHER.
- 2. EXISTING POLE AND FIXTURE SHALL REMAIN. RELAMP WITH 3000K LED REPLACEMENT LAMP, CURRENT LIGHTING #93303384.
- 3. PROVIDE NEW POLE BASE, POLE AND LUMINAIRE. REFER TO LUMINAIRE SCHEDULE ON SHEET E602 AND BASE DETAIL ON SHEET E601. VERIFY POLE HEIGHT PRIOR TO
- 4. PROVIDE DMX CONTROLLERS FOR RBGW FIXTURES IN NEMA 4 EXTERIOR WEATHERPROOF BOX. TIE ALL CONTROLLERS INTO ONE MAIN DMX PROGRAMMING STATION FOR SCENE PROGRAMMING. CONNECT SOUND EQUIPMENT AMPLIFIER INTO MAIN DMX CONTROLLER. REFER TO SHEET ES002.
- 5. PROVIDE 120V BRANCH CIRCUITING FROM PANEL PP-PLAZA TO DMX CONTROLLERS AS NECESSARY FOR A FULLY OPERATIONAL SYSTEM. REFER TO PANEL SCHEDULE PP-PARK ON SHEET E602 FOR BRANCH CIRCUITING. PROVIDE DMX CONTROL CABLING FROM DMX CONTROLLERS LOCATED IN NEMA 4X ENCLOSURE. REFER TO MANUFACTURERS INSTALLATION INSTRUCTIONS.
- 6. PROVIDE IN-GRADE JUNCTION BOX FOR ELECTRICAL CONNECTION TO HANDRAILS. REFER TO SHEETS ES005 FOR JUNCTION BOX LOCATION AND SHEET E602 FOR LIGHTING FIXTURE SCHEDULE. REFER TO MANUFACTURERS INSTALLATION INSTRUCTIONS. COORDINATE WITH CIVIL / ARCHITECTURAL TRADES.

REDEVELOPMENT AND UPGRADE OF BEATRICE PARK (HARMONIE PARK) AND GRATIOT PLAZA DETROIT, MICHIGAN COA ARCHITECT COA ENGINEER

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GRATIOT PLAZA ELECTRICAL SITE LAYOUT LIGHTING

SITE GENERAL NOTES

- A. ALL LIGHTING AND POWER CONDUCTORS SHALL BE INSTALLED BETWEEN 24" (MINIMUM) AND 36" (MAXIMUM) BELOW FINISHED GRADE.
- B. ALL COMMUNICATIONS CONDUIT AND CABLES SHALL BE INSTALLED 36" (MINIMUM) BELOW FINISHED GRADE.

C. ALL CONDUCTORS FOR EXTERIOR LIGHTING AND POWER CIRCUITS SHALL BE #8 AWG

D. ROUTE ALL UNDERGROUND CONDUITS OR UNDERGROUND CABLING PARALLEL TO ONE ANOTHER. DIRECTIONAL BORE UNDER EXISTING CONCRETE AND PAVERS.

- 1. CAMERAS SHALL BE AXIS M4308-PLE PANORAMIC CAMERA WITH AXIS T94T02D PENDANT KIT AND AXIS T91B67 POLE MOUNT. (OR EQUIVALENT)
- 2. SOUND SHALL BE ATLAS SOUND GSS-G 70V ALL WEATHER LANDSCAPE LOUDSPEAKER WITH DOUBLE 8" COAXIAL SPEAKERS WITH 360-DEGREE HORIZONTAL DISPERSION PATTERN. (OR EQUIVALENT) REMOVE AND REPLACE EXISTING SPEAKERS, UTILIZE EXISTING CABLING AND CONDUIT.
- 3. SOUND AND CAMERA EQUIPMENT SHALL BE MOUNTED IN EXISTING BUILDING. WALL MOUNTED EQUIPMENT CABINET, 24X24X24, 19-IN EIA RAILS, DUAL-HINGED AND LOCKING DOOR, VENTED FOR DATA SWITCH AND AMPLIFIER / MIXER. TWO (2) DEDICATED 20A, 120V RECEPTACLES AND (1) 2000 VA UPS WITH MINIMUM (8) 20A, 120V RECEPTACLES BY APC OR EQUIVALENT. PROVIDE (1) RACK UNIT FOR CAMERA. THE PARK AND PLAZA SHALL BE CONTROLLED SEPARATELY FROM ONE ANOTHER.

ALL SYSTEMS WORK FOR GRATIOT PLAZA SHALL BE COMPLETED IN FUTURE PHASE. DO NOT BID AT THIS TIME.

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PROGRESSIVE AE, INC. 1811 4 Mile Rd NE I Grand F

REDEVELOPMENT AND UPGRADE OF BEATRICE PARK (HARMONIE PARK) AND GRATIOT PLAZA DETROIT, MICHIGAN

....

ISSUANCE

CITY APPROVAL

PROJECT NUMBER
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PROJECT MANAGER
D. WESTENBURG
PROFESSIONAL
S. GENGELBACH
DRAWN BY

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DRAWN BY

K. WOOD


CHECKED BY

S. GENGELBACH

GRATIOT PLAZA
ELECTRICAL SITE LAYOUT
SYSTEMS

POLE BASE DETAIL

NOT TO SCALE

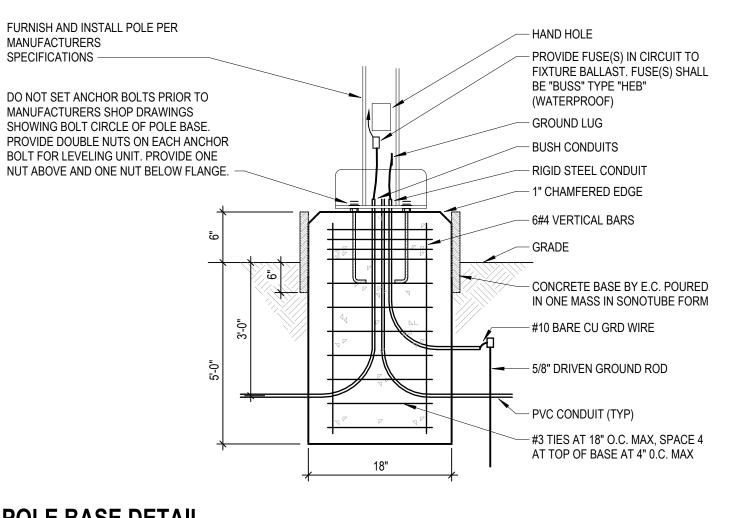


- FLOODLIGHT FIXTURE

FINISHED GRADE

3" PEA GRAVEL


TYPICAL CONDUIT

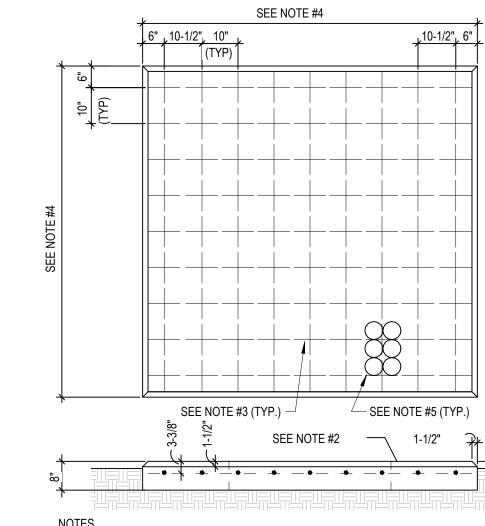

- 1. CONCRETE TO BE PLACED ON 1' OF PACKED WASHED GRAVEL OR PEA STONE ONLY IF LOCATED ON IMPERMEABLE SOIL SUCH AS CLAY.
- 2. CLASS OF CONCRETE- 3000PSI COMPRESSIVE STRENGTH @ 28 DAYS.
- 3. GRADE OF REINFORCING RODS-#5, ASTM A615, GRADE
- 4. SIZE PAD DIMENSIONS PER MANUFACTURERS SHOP DRAWING. EXTEND PAD MINIMUM OF 3" BEYOND EQUIPMENT.
- 5. VERIFY STUB UP LOCATION OF CONDUITS WITH MANUFACTURER SHOP DRAWINGS. STUB MAXIMUM 1" ABOVE PAD SURFACE.

YPAD BASE DETAIL

2 IN-GRADE FIXTURE INSTALLATION DETAIL NOT TO SCALE

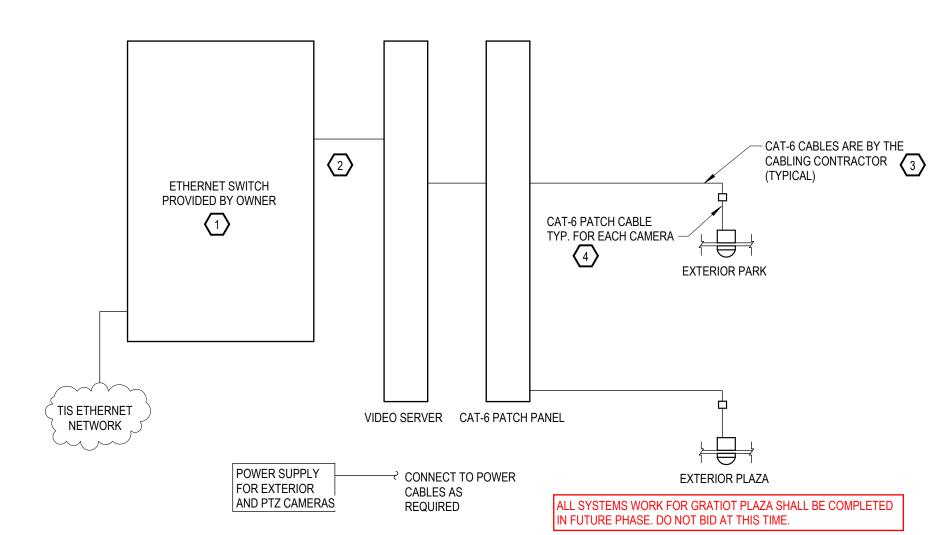

VIDEO SECURITY DIAGRAM

SECURITY NOTES:

- 1. CAT-6 CABLES FROM COMM ROOM TO THE CAMERA LOCATION ARE BY OTHERS, PROVIDE AND INSTALL ALL PATCH CABLES REQUIRED FOR COMPLETE CONNECTIVITY.
- 2. THE CONTRACTOR SHALL SUPPLY ANY AND ALL BALUNS, COUPLERS ADAPTERS AND CONVERTERS THAT ARE REQUIRED FOR THE INTERCONNECTION OF ALL THE SECURITY COMPONENTS.
- 3. THE CAMERA CABLES SHALL TRANSPORT ALL VIDEO SIGNALS &
- CONTROL SIGNALS AND POWER SIGNALS. 4. CONTRACTOR SHALL PROVIDE AN APPROPRIATE CAMERA MOUNT BASED ON CAMERA LOCATION AND STRUCTURE AVAILABLE.
- 5. CONNECT EACH EXTERIOR CAMERA TO A POWER SUPPLY. SIZE THE POWER SUPPLIES PER CAMERA REQUIREMENTS.
- 6. WHERE THE CAMERA IS NOT INSTALLED WITHIN A DROP CEILING THE CONTRACTOR SHALL PROVIDE A MOUNT AND HOUSING. PROVIDE WEATHERPROOF MOUNTS ON EXTERIOR CAMERAS. 7. POWER FOR EXTERIOR CAMERAS SHALL BE FROM A CENTRAL POWER SUPPLY.
- 8. CENTRALIZED POWER SUPPLIES SHALL BE MOUNTED IN COMMUNICATIONS ROOMS. COORDINATE THE LOCATION WITH OTHER TRADES PRIOR TO INSTALLATION.
- 9. CONTRACTOR SHALL PROVIDE THE CORRECT LENS TO EACH CAMERA BASED ON THE INSTALLED LOCATION AND THE OWNERS REQUIREMENTS FOR THE FIELD OF VIEW. COORDINATE WITH THE OWNER DURING INSTALLATION.
- 10. ALL CAMERAS SHALL CONNECT TO THE IP NETWORK SWITCH IN THE COMMUNICATIONS ROOM. CONTRACTOR SHALL
- COORDINATE ETHERNET SWITCH CONFIGURATION WITH OWNER. 11. THE NETWORK VIDEO RECORDER IS EXISTING AND IS LARGE ENOUGH TO SUPPORT THESE NEW CAMERAS. CONTRACTOR SHALL PROVIDE ALL LICENSES FOR CAMERAS.

KEYED NOTES:

- 1. THE DATA NETWORK AND ALL ETHERNET SWITCHES WILL BE PROVIDED BY THE OWNER. THE CONTRACTOR SHALL MEET WITH THE OWNER TO CONFIRM ALL NETWORK SPECIFICATION REQUIREMENTS FOR A VLAN OR OTHER QUALITY OF SERVICE
- SETTINGS. 2. CONTRACTOR SHALL INSTALL PATCH CABLES FROM PATCH PANEL TO ETHERNET SWITCH.
- 3. CAT-6 CABLES FROM COMM ROOM TO CAMERA LOCATION. 4. CONTRACTOR SHALL INSTALL PATCH CABLES FROM OUTLET TO CAMERA.

02/02/2024

ISSUANCE

CITY APPROVAL

REDEVELOPMENT AND UPGRADE OF BEATRICE PARK (HARMONIE PARK) AND GRATIOT PLAZA

COA ARCHITECT

PROJECT NUMBER 97080001 PROJECT MANAGER D. WESTENBURG PROFESSIONAL S. GENGELBACH DRAWN BY K. WOOD

CHECKED BY S. GENGELBACH

ELECTRICAL DETAILS E601

				. •	J 0.		1710711101			- 11171		
CONTROL MODULE	CONTROLLER LOCATION	ZONE	TYPE	LOAD	OPERATION	CONTROL	SENSOR	PHOTOCELL	CLOCK	INTEGRATION	WARNING	CIRCUIT
			,									
120V	WEATHERPROOF BOX	PARK	OA	16 W	5	NO	No	Yes	Yes	Yes	No	NO
120-277V	WEATHERPROOF BOX	PARK	OB	450 W	1, 2, 4	NO	No	Yes	Yes	No	No	NO
24V	WEATHERPROOF BOX	PARK	OC	218 W	1, 2, 4	NO	No	Yes	Yes	No	No	NO
120V	WEATHERPROOF BOX	PARK	OD	4860 W	5	NO	No	Yes	Yes	Yes	No	NO
120V	WEATHERPROOF BOX	PARK	OE	140 W	1, 2, 4	NO	No	Yes	Yes	No	No	NO
120V	REMOTE CONTROL	PARK	OGA	200 W	6	NO	No	Yes	Yes	No	No	NO
120V	REMOTE CONTROL	PARK	OGB	600 W	6	NO	No	Yes	Yes	No	No	NO
24V	WEATHERPROOF BOX	PARK	OH	252 W	1, 2, 4	NO	No	Yes	Yes	No	No	NO
120V	WEATHERPROOF BOX	PARK	OW	910 W	5	NO	No	Yes	Yes	Yes	No	NO
120V	WEATHERPROOF BOX	PLAZA	OB	360 W	1, 2, 4	NO	No	Yes	Yes	No	No	NO
12V	WEATHERPROOF BOX	PLAZA	OC	166 W	1, 2, 4	NO	No	Yes	Yes	No	No	NO
120V	WEATHERPROOF BOX	PLAZA	OD	2520 W	5	NO	No	Yes	Yes	Yes	No	NO
120V	WEATHERPROOF BOX	PLAZA	OE	84 W	1, 2, 4	NO	No	Yes	Yes	No	No	NO
24V	WEATHERPROOF BOX	PLAZA	OH	252 W	1, 2, 4	NO	No	Yes	Yes	No	No	NO

GENERAL NOTES:

A. GENERAL LIGHTING BRANCH CIRCUITING AND CONTROLS SHALL BE MOUNTED ALONG SOUTH WEST RETAINING WALL NEAR EXISTING METER / POWER LOCATION.

SCHEDULE NOTES:

- 1. AUTO ON WHEN NO DAYLIGHT IS AVAILABLE.
- AUTO OFF WHEN DAYLIGHT IS AVAILABLE. REDUCE LIGHTING TO 20% NO LATER THAN MIDNIGHT TO 6 AM OR WHEN NO ACTIVITY HAS BEEN DETECTED FOR > 15 MINUTES.
- TIME CLOCK OVERRIDE 2, 4, 6, HOUR INTERVALS FOR SPECIAL EVENTS.
- SPECIALTY LIGHTING SHALL BE CONTROLLED BY DMX CONTROLS LOCATED IN EXISTING BUILDING. PROGRAMMED TO AUTO ON TO 3000K WARM WHITE WHEN NO DAYLIGHT IS AVAILABLE AND OFF WHEN DAYLIGHT IS AVAILABLE.

6	. SPECIALTY	' LIGHTING SHALI	∟ BE CONTROI	LED BY RE	EMOTE CONT	ROL FOR SPE	ECIAL EVENTS

	(CONDUI	T AND WI	RE SCHE	DULE	
FEEDER	COPPER CC	NDUCTORS		CONDU	JIT SIZE	
TYPE	Ø&N	GND	2Ø+N+GND	3Ø+GND	3Ø+N+GND	3Ø+2N+2GND
20	#12	#12	(1/2")	(1/2")	(1/2")	(3/4")
30	#10	#10	(1/2")	(1/2")	(3/4")	(3/4")
40	#8	#10	(3/4")	(3/4")	(1")	(1")
55	#6	#10	(1")	(1")	(1")	(1")
70	#4	#8	(1 1/4")	(1 1/4")	(1 1/4")	(1 1/4")
85	#3	#8	(1 1/4")	(1 1/4")	(1 1/4")	(1 1/2")
95	#2	#8	(1 1/4")	(1 1/4")	(1 1/2")	(1 1/2")
110	#1	#6	(1 1/2")	(1 1/2")	(1 1/2")	(2")
150	#1/0	#6	(1 1/2")	(1 1/2")	(2")	(2")
175	#2/0	#6	(2")	(2")	(2")	(2 1/2")
200	#3/0	#6	(2")	(2")	(2")	(2 1/2")
230	#4/0	#4	(2")	(2")	(2 1/2")	(2 1/2")
255	250 kCM	#4	(2 1/2")	(2 1/2")	(2 1/2")	(3")
285	300 kCM	#4	(2 1/2")	(3")	(3")	(3")
310	350 kCM	#3	(3")	(3")	(3")	(3 1/2")
335	400 kCM	#3	(3")	(3")	(3")	(3 1/2")
380	500 kCM	#3	(3")	(3")	(3 1/2")	(4")
510	(2) 250 kCM	(2) #1	(2) (2 1/2")	(2) (2 1/2")	(2) (3")	(2) (3")
570	(2) 300 kCM	(2) #1	(2) (2 1/2")	(2) (2 1/2")	(2) (3")	(2) (3 1/2")
620	(2) 350 kCM	(2) #1	(2) (3")	(2) (3")	(2) (3")	(2) (3 1/2")
760	(2) 500 kCM	(2) #1/0	(2) (3")	(2) (3")	(2) (3 1/2")	(2) (4")
1005	(3) 400 kCM	(3) #2/0	(3) (3")	(3) (3")	(3) (3")	(3) (3 1/2")
1240	(4) 350 kCM	(4) #3/0	(4) (3")	(4) (3")	(4) (3")	(4) (3 1/2")
1260	(3) 600 kCM	(3) #3/0	(3) (3 1/2")	(3) (3 1/2")	(3) (4")	(3) (5")
1675	(5) 400 kCM	(5) #4/0	(5) (3")	(5) (3")	(5) (3 1/2")	(5) (4")
1680	(4) 600 kCM	(4) #4/0	(4) (3 1/2")	(4) (3 1/2")	(4) (4")	(4) (5")
2010	(6) 400 kCM	(6) 250 kCM	(6) (3")	(6) (3")	(6) (3 1/2")	(6) (4")
2100	(5) 600 kCM	(5) 250 kCM	(5) (3 1/2")	(5) (3 1/2")	(5) (4")	(5) (5")
2520	(6) 600 kCM	(6) 350 kCM	(6) (3 1/2")	(6) (3 1/2")	(6) (4")	(6) (5")
2660	(7) 500 kCM	(7) 350 kCM	(7) (3 1/2")	(7) (3 1/2")	(7) (3 1/2")	(7) (5")
3040	(8) 500 kCM	(8) 400 kCM	(8) (3 1/2")	(8) (3 1/2")	(8) (3 1/2")	(8) (5")
4275	(8) 750 kCM	(8) 500 kCM	(8) (4")	(8) (4")	(8) (5")	(8) (5")
EQ	EQUIPMENT	FEEDER - REF	ER TO ELECTRICA	L EQUIPMENT SCH	EDULE	•
GENERAL	NOTES:					

- A. THE ABOVE FEEDER SCHEDULE IS A SCHEDULE OF TYPICAL FEEDERS AND SOME SIZES MAY NOT BE UTILIZED.
- B. ALL CONDUCTOR AMPACITIES ARE BASED ON TABLE 310.15(B)(16) OF THE NEC FOR COPPER CONDUCTOR TYPE THW/THWN.
- C. FEEDER SIZES SHOWN ON THE RISER DIAGRAM INDICATE FEEDER AMPACITIES AND DO NOT NECESSARILY CORRESPOND TO CIRCUIT BREAKER AMPACITIES. CERTAIN FEEDERS MAY BE SIZED FOR THE DERATION FACTORS REQUIRED BY CODE AND/OR ARE OVERSIZED FOR VOLTAGE DROP.
- D. WHERE MULTIPLE CONDUITS AND CONDUCTORS ARE INDICATED FOR A SINGLE FEEDER, EACH CONDUIT SHALL CONTAIN 1 PARALLEL PHASE, NEUTRAL, AND GROUND CONDUCTORS INDICATED.
- E. CONDUITS SIZED LARGER THAN INDICATED SHALL BE PERMITTED FOR RUNS WITH UP TO (4) 90° ELBOWS, OR FOR PULLING LONGER RUNS.

PANELBOARD: PP-PARK

APPROVED

EQUAL

NOTE

PROVIDE ANOLIS E-BOX

CONTROLLER, EMINERE

LEADER CABLE FOR

POWER AND DMX

CONTROL, JUMPERS AND CONNECTORS.

PROVIDE ANOLIS E-BOX

CONTROLLER, EMINERE

LEADER CABLE FOR POWER AND DMX

CONTROL, JUMPERS AND

CONNECTORS.

LOGO DESIGNS BY

OWNER

LOGO DESIGNS BY

OWNER

PROVIDE ANOLIS E-BOX

CONTROLLER,

ARCSOURCE INGROUND

24MC LEADER CABLE FOR

POWER AND DMX CONTROL, JUMPERS AND

CONNECTORS.

CATALOG NUMBER

EMI 4 RGBW K30 WSH E2E

E-BOX RI 9011

93303384

E-BOX 120-277V

IG16-L12-SR-T30

IP-OD100

IP-HW300

AS24 INGR RGBW A-SKID 33

ANOLIS EMG 4 RGBW K30 A-SKID wWSH

LOCATION: MOUNTING: SURFACE NEMA 4 FED FROM: FEEDER: SEE ONE-LINE DIAGRAM

LUMINAIRE SCHEDULE

POLE MOUNTED | LED | 120 V | 45 W | GE LAMPS

LED | 120 V | 90 W |

LED | 120 V | 14 W | LITON

120 V | 65 W |

120 V 4 W

LAMP

POLE MOUNT TO OSHRAM 120 V 100 W

POLE MOUNT TO | OSHRAM | 120 V | 300 W |

121

LED

MOUNTING

GRADE

CABLE

IN-GRADE

LANDSCAPE POLE 121

MOUNTED INTEGRAL LED

LANDSCAPE POLE

TO HAND RAIL

| VOLT | WATT | MANUFACTURER |

ANOLIS

PROJECTORS

PROJECTORS

ANOLIS

120 V 18 W COLE LIGHTING LR5P-LED-AL/1.9-INT-RE-3K-BP

120 V 1 W PRIMUS LIGHTING DSW-24-120-S14-27/150-STK

DESCRIPTION

LED, WITH GLARE SHIELD, 3000K, IP68 RATED,

REQUIRED, DMX RDM CONTROL PROTOCOL,

FESTOON LED LIGHTING, CLEAR SHATTER PROOF

RECESSED LINEAR INGRADE RGBW LED, 3000K,

E-BOX CONTROLLER, E-BOX INTERFACE WITH

DMX512 CONTROL PROTOCOL, ASYMETRICAL

| WIDE WALL WASH, 48" IN LENGTH, END FEED, INTEGRAL ANTI-SKID GLASS, INGROUND

MOUNTING SLEEVE, INGROUND CONTINUOUS

IMPACT AND CORROSION RESISTANT HOUSING,

GLASS TEMPERED SLIP RESISTANT SILICONE GASKETED GLASS LENS, 3000K, 40 DEGREE

OUTDOOR WATERPROOF 100W LOGO GOBO

PROJECTOR WITH, (2) FULL COLOR GOBOS

OUTDOOR WATERPROOF 300W LOGO GOBO

PROJECTOR WITH, (2) FULL COLOR GOBOS

| HANDRAIL, SYMETRICAL BEAM ANGLE, IP67

RATED, 3000K, EXTRUDED ALUMINUM HOUSING, LISTED FOR WET LOCATIONS, LED 24V NON-DIMMING DRIVER INTEGRAL TO HANDRAIL 12" ADJUSTABLE RGBW LED IN-GRADE FIXTURE,

IMPACT AND CORROSION RESISTANT HOUSING

MULTI-VOLT INTEGRAL DRIVER, STAINLESS STEEL,

33 DEGREE BEAM ANGLE, 3000K DEFAULT COLOR,

FLAT CLEAR ANTI-SLIP LENS, USITT DMX 512

INTERFACE PROTOCOL, IP68 RATED.

24V LINEAR LED MOUNTED INTEGRAL TO

DIE CAST ALUMINUM WITH POWDER COAT FINISH HOUSING, STAINLESS STEEL FACEPLATE, CLEAR

GRAPHITE BLACK, E-BOX CONTROLLER

G45 ROUND GLOBES, 2700K, IP44 RATED WATERPROOF IN-LINE FESTOON CABLE, BLACK

FINISH, 18" SPACING, NON-DIMMABLE.

COVER PLATE, US WCA CABLE. OE 6" LED IN-GRADE FIXTURE, INTEGRAL DRIVER,

FLOOD BEAM SPREAD.

RIGHT SIDE INPUT.

OB LED REPLLACEMENT LAMP

|LINEAR GRADE MOUNTED WALL WASHER RGBW | SURFACE MOUNT ON | LED

PANEL TYPE: **VOLTAGE**: 208Y/120V / 3 ø / 4W BUS AMPS: 200 AMPS MAIN DEVICE: 200 A MAIN CB A.I.C. RATING: 14,000 AMPS SYMMETRICAL SPECIAL:

LOAD DESCRIPTION	LOAD TYPE	Р	TRIP	СКТ		4		В				СС		TRIP	Р	LOAD TYPE	LOAD DESCRIPTION	
LOAD DESCRIPTION	LOAD TIPE	<u> </u>	IRIP	CKI	•	•				C CKI		С СКТ		IRIP		LOAD TIPE	LOAD DESCRIPTION	
FOOD TRUCK PEDESTAL	RCPT	1	30 A	1	2800	2800					2	30 A	1	RCPT	FOOD TRUCK PEDESTAL			
FOOD TRUCK PEDESTAL	RCPT	1	30 A	3			2800	2800			4	30 A	1	RCPT	FOOD TRUCK PEDESTAL			
FOOD TRUCK PEDESTAL	RCPT	1	30 A	5					2800	1800	6	20 A	1	RCPT	PEDESTRIAN CHARGING STATION			
PEDESTRIAN CHARGING STATION	RCPT	1	20 A	7	1800	1800					8	20 A	1	RCPT	PEDESTRIAN CHARGING STATION			
PEDESTRIAN CHARGING STATION	RCPT	1	20 A	9			1800	140			10	20 A	1	LTS	IN-GROUND LIGHTING			
POLE LIGHTING	LTS	1	20 A	11					450	218	12	20 A	1	LTS	FESTOON LIGHTING			
GOBO SPECIALTY LIGHTING	LTS	1	20 A	13	800	180					14	20 A	1	LTS	HANDRAIL LIGHTING			
STAGE RGBW LIGHTING	LTS	1	20 A	15			16	1260			16	20 A	1	LTS	WALLWASH RBGW LIGHTING			
DECORATIVE POLE RGBW LTG	LTS	1	20 A	17					910	1710	18	20 A	1	LTS	WALLWASH RGGW LIGHTING			
WALLWASH RGBW LIGHTING	LTS	1	20 A	19	1890	0					20	20 A	1		SPARE			
AMP / MIXER		1	20 A	21			180	0			22	20 A	1		SPARE			
SPARE		1	20 A	23					0	0	24	20 A	1		SPARE			
SPACE		1		25							26		1		SPACE			
SPACE		1		27							28		1		SPACE			
SPACE		1		29							30		1		SPACE			

Load Classification		CONNECTED LOAD	DEMAND FACTOR	ESTIMATED DEMAND	DANEL	TOTALS
Lighting		7574 VA	125.00%	9468 VA	PANEL	IOTALS
Receptacle		21200 VA	73.58%	15600 VA	CONNECTED LOAD:	28954 VA
Spare		180 VA	100.00%	180 VA	EST. DEMAND LOAD:	25248 VA
					CONNECTED CURRENT:	80 A
					EST. DEMAND CURRENT:	70 A
NOTES:	1		4		1	2
5	•		4		•	3

PANELBOARD: PP-PLAZA

LOCATION: **MOUNTING:** SURFACE NEMA 1 FED FROM: FEEDER: SEE ONE-LINE DIAGRAM

PANEL TYPE: **VOLTAGE**: 208Y/120V / 3 ø / 4W BUS AMPS: 100 AMPS MAIN DEVICE: 100 A MAIN CB

A.I.C. RATING: 14,000 AMPS SYMMETRICAL SPECIAL:

LOAD DESCRIPTION	LOAD TYPE	Р	TRIP	СКТ	A	4	ı	В	ď	3	СКТ	TRIP	Р	LOAD TYPE	LOAD DESCRIPTION
FOOD TRUCK PEDESTAL	RCPT	1	30 A	1	2800	2800					2	30 A	1	RCPT	FOOD TRUCK PEDESTAL
FOOD TRUCK PEDESTAL	RCPT	1	30 A	3			2800	1800			4	20 A	1	RCPT	PEDESTRIAN CHARGING STATION
PEDESTRIAN CHARGING STATION	RCPT	1	20 A	5					1800	1800	6	20 A	1	RCPT	PEDESTRIAN CHARGING STATION
DECORATIVE POLE RBGW	LTS	1	20 A	7	715	166					8	20 A	1	LTS	FESTOON LIGHTING
TREE LIGHTING	LTS	1	20 A	9			56	2520			10	20 A	1	LTS	WALLWASH RBGW LIGHTING
HANDRAIL LIGHTING	LTS	1	20 A	11					252	180	12	20 A	1	LTS	POLE LIGHTING
SCULPTURE LIGHTING	LTS	1	20 A	13	28	180					14	20 A	1	LTS	POLE LIGHTING
SPARE		1	20 A	15			0	0			16	20 A	1		SPARE
SPARE		1	20 A	17					0	0	18	20 A	1		SPARE
-		1	•	•											

_oad Classification	CONNECTED LOAD	DEMAND FACTOR	ESTIMATED DEMAND	DANEL TOTA
_ighting	4097 VA	125.00%	5121 VA	PANEL TOTA
Receptacle	13800 VA	86.23%	11900 VA	CONNECTED LOAD: 1789
				EST. DEMAND LOAD: 1702
				CONNECTED CURRENT: 50 A
				EST. DEMAND CURRENT: 47 A
NOTES:				

ISSUANCE 02/02/2024 CITY APPROVAL

COA ARCHITECT

O UPGRADE IARMONIE

PROJECT NUMBER 97080001 PROJECT MANAGER D. WESTENBURG PROFESSIONAL S. GENGELBACH DRAWN BY

K. WOOD CHECKED BY S. GENGELBACH

ELECTRICAL SCHEDULES E602