PROJECT LOCATION:


OWNER:

ARCHITECT OF RECORD:

206 E. GRAND RIVER DETROIT MI

METHOD DEVELOPMENT 6540 ST. ANTOINE STREET DETROIT, MI 48226

KRAEMER DESIGN GROUP, LLC ROBERT J. KRAEMER, RA, NCARB, IIDA STATE OF MICHIGAN CERTIFICATE NO. 1301040246 1420 BROADWAY DETROIT, MI 48226 www.thekraemeredge.com (313) 965-3399

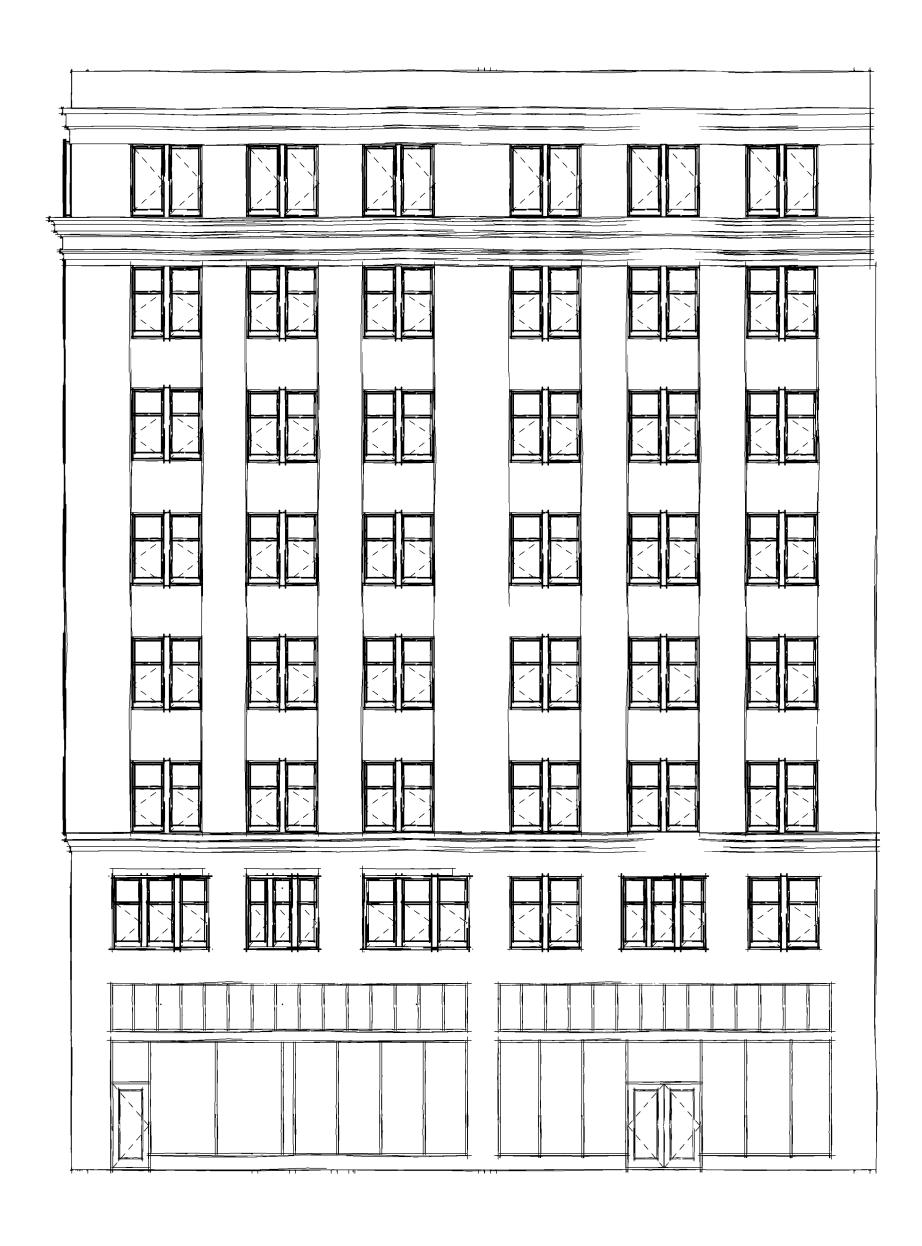

MERCHANTS BUILDING

HDC APPLICATION 4-17-23

STRUCTURAL ENGINEER:

RESURGET ENGINEERING PLC MARC STEINHOBEL LICENSE #62010-51104 4219 WOODWARD AVE, SUITE 306 DETROIT, MI 48201

CONSTRUCTION MANAGER/ GENERAL CONTRACTOR:

PCI CONTRACTING KYLE KNOLL 21717 REPUBLIC STREET OAK PARK, MI 48237 (248) 255-3316

CODE SUMMARY PROJECT DESCRIPTION: BRIEF DESCRIPTION INCLUDING # STORIES, CHANGE IN OCCUPANCY, ADDITION/ALTERATION, NEW CONSTRUCTION, ETC. B5 OCCUPANCY CLASSIFICATION: A, B, 4-2 CONSTRUCTION TYPE: (IIIB, SPRINKLERED, FIRE ALARM SYSTEM) # PERSONS BUILDING: MICHIGAN REHABILITATION CODE FOR EXISTING BUILDINGS (MRCEB) 2015 - CHAPTER 14 PERFORMANCE AND COMPLIANCE METHODS BUILDING CODE (MBC) 2015, AS REFERENCED BY MRCEB 2015 MECHANICAL: MICHIGAN MECHANICAL CODE (MMC) 2015

PLUMBING: MICHIGAN PLUMBING CODE (MPC) 2018

ELECTRICAL: MICHIGAN/NATIONAL ELECTRICAL CODE (NEC) 2017 WITH PART 8 AMENDMENTS

LIFE SAFETY: MICHIGAN BUILDING CODE (MBC) 2015 NFPA 101 2013

ZONING:

OCCUPANT LOAD:

APPLICABLE CODES:

DETROIT FIRE CODE

ENERGY: MICHIGAN UNIFORM ENERGY CODE (MUEC) 2015 A BUILDING THAT HAS BEEN SPECIFICALLY DESIGNATED AS HISTORICALLY SIGNIFICANT BY THE ADOPTING AUTHORITY OR IS LISTED IN THE NATIONAL REGISTER OF HISTORIC PLACES OR HAS BEEN DETERMINED TO BE ELIGIBLE FOR LISTING BY THE U.S. SECRETARY OF THE INTERIOR NEED NOT COMPLY WITH THE PROVISIONS OF SECTIONS 5, 6, 7, 8, 9, AND 10 OF THE ASHRAE 90.1 STANDARD. (ASHRAE 90.1, EXCEPTION 1 TO PARAGRAPH 4.2.1.3, REFERENCED BY MUEC C503.1)

ACCESSIBILITY: MICHIGAN REHABILITATION CODE FOR EXISTING BUILDINGS (MRCEB) 2015 SECTION 410 ICC/ANSI A117.1 2009 AS REFERENCED BY MRCEB WITH SECTIONS 611 AND 707 EXEMPTED MICHIGAN BUILDING CODE (MBC) 2015 AS REFERENCED ADA ACCESSIBILITY GUIDELINES (ADAAG) 2010 ELEVATOR: DETROIT ELEVATOR CODE 2019

ASME A17.1-2010 FOR NEW ELEVATORS AS REFERENCED ASME A17.3-2011 FOR EXISTING ELEVATORS AS REFERENCED ASME A18.1-2008 FOR PLATFORM AND STAIRWAY LIFTS AS REFERENCED

	SHEET INDEX	
#	SHEET TITLE	HDC APPLICATION 4-17-23
-	COVER	
AD201	DEMOLITION ELEVATIONS	
AD202	DEMOLITION ELEVATIONS	
AD203	DEMOLITION ELEVATIONS	
A201	EXTERIOR ELEVATIONS	
A202	EXTERIOR ELEVATIONS	
A203	EXTERIOR ELEVATIONS	
A401	COMMERCIAL RESTROOMS	
A621	WINDOW ELEVATIONS AND SCHEDULE	
A622	WINDOW DETAILS	

EXISTING STRUCTURE

THIS BUILDING IS REVIEWED UNDER THE 2015 MICHIGAN REHABILITATION CODE FOR EXISTING BUILDINGS, CHAPTER 14 PERFORMANCE COMPLIANCE METHODS.

1401.2.2 PARTIAL CHANGE IN OCCUPANCY. WHERE A PORTION OF THIS BUILDING IS CHANGED TO A NEW OCCUPANCY CLASSIFICATION AND THAT PORTION IS SEPARATED FROM THE REMAINDER OF THE BUILDING WITH FIRE BARRIER OR HORIZONTAL ASSEMBLIES HAVING A FIRE-RESISTANCE RATING AS REQUIRED BY TABLE 508.4 OF THE INTERNATIONAL BUILDING CODE FOR THE SEPARATE OCCUPANCIES, OR WITH APPROVED COMPLIANCE ALTERNATIVES, THE PORTION CHANGED HAS BEEN BE MADE TO CONFORM TO THE PROVISIONS OF THIS SECTION. WHERE A PORTION OF THE BUILDING IS CHANGED TO A NEW OCCUPANCY CLASSIFICATION AND THAT PORTION IS NOT SEPARATED FROM THE REMAINDER OF THE BUILDING WITH FIRE BARRIERS OR HORIZONTAL ASSEMBLIES HAVING A FIRE-RESISTANCE RATING AS REQUIRED BY TABLE 508.4 OF THE INTERNATIONAL BUILDING CODE FOR THE SEPARATE OCCUPANCIES, OR WITH APPROVED COMPLIANCE ALTERNATIVES, THE PROVISIONS OF THIS ECTION WHICH APPLY TO EACH OCCUPANCY APPLY TO THE ENTIRE BUILDING. WHERE THERE ARE CONFLICTING PROVISIONS, THOSE REQUIREMENTS WHICH SECURE THE GREATER PUBLIC SAFETY SHALL APPLY TO THE ENTIRE BUILDING OR STRUCTURE.

PREVIOUS USE GROUP(S)/NAME OF AREA: <u>GROUP B, R-2</u> PROPOSED USE GROUP(S)/NAME OF AREA: GROUP A, B, R-2 SEPARATED = 1 HR

1401.2.4 ALTERATIONS AND REPAIRS. THE EXISTING BUILDING OR PORTION THEREOF THAT DOES NOT COMPLY WITH THE REQUIREMENTS OF THIS CODE FOR NEW CONSTRUCTION HAS NOT BE ALTERED OR REPAIRED IN SUCH A MANNER THAT RESULTS IN THE BUILDING BEING LESS SAFE OR SANITARY THAN SUCH BUILDING IS CURRENTLY. IF IN THE ALTERATION OR REPAIR, THE CURRENT LEVEL OF SAFETY OR SANITATION IS TO BE REDUCED, THE PORTION ALTERED OR REPAIRED CONFORMS TO THE REQUIREMENTS OF CHAPTERS 2 THROUGH 12 AND CHAPTERS 14 THROUGH 33 OF THE INTERNATIONAL BUILDING CODE.

1401.2.5 ACCESSIBILITY REQUIREMENTS. ALL PORTIONS OF THE BUILDINGS PROPOSED FOR CHANGE OF OCCUPANCY SHALL CONFORM TO THE ACCESSIBILITY PROVISIONS OF SECTION 410.

SEE SHEET G102 CODE SUMMARY FOR FURTHER INFORMATION

BID ALTERNATES

TO BE DETERMINED


DEFERRED SUBMITTALS


NOTE: THESE CONSTRUCTION DOCUMENTS WERE PREPARED FOR COMPLIANCE WITH THE LOCAL CONSTRUCTION CODES IN EFFECT AT TIME OF PERMIT SUBMITTAL, ALL ENGINEERS, CONTRACTORS AND SUPPLIERS INVOLVED WITH THIS PROJECT SHALL COMPLY WITH THE SAME CODES, ISSUED AND APPROVED CODE MODIFICATIONS AND/OR LOCAL CONSTRUCTION BOARDS OF APPEALS RULINGS AND WHENEVER REQUIRED SHALL PROVIDE SHOP DRAWINGS AND SUBMITTALS CLEARLY DESCRIBING COMPLIANCE TO THE REGISTERED DESIGN PROFESSIONAL IN RESPONSIBLE CHARGE FOR REVIEW AND APPROVAL.

THE FOLLOWING SUBMITTALS SHALL BE PREPARED BY OTHERS AND INCLUDED AS PART OF THE CONSTRUCTION DOCUMENTS AS THEY BECOME AVAILABLE: (PER SECTION 107.3.4.2)

- AUXILIARY POWER SYSTEMS - EMERGENCY CALL SYSTEMS
- EXIT ILLUMINATION - FIRE ALARM SYSTEMS
- FIRE STOPPING SYSTEMS - FIRE SUPPRESSION SYSTEMS
- GUARD RAILS / HAND RAILS

- INTERCOM SYSTEMS - MATERIAL SAFETY AND DATA SHEETS (MSDS) FOR INTERIOR FINISHES - PREFABRICATED STAIRS - SHELVING/RACK SYSTEMS - SIGNAGE

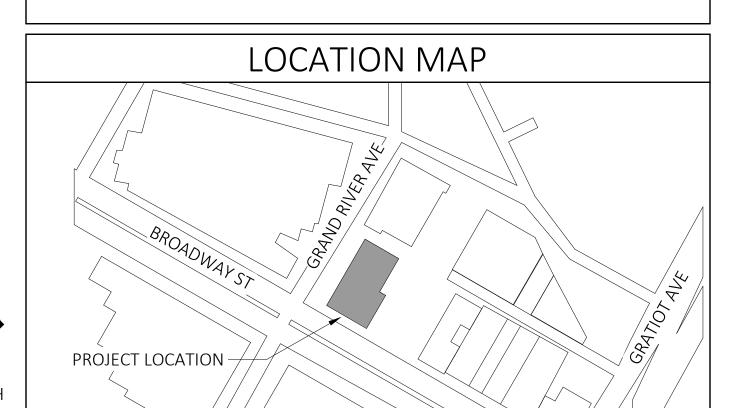

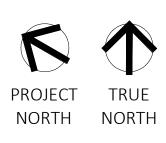



Consultant METHOD EVELOPMENT Ш О Owner **BUILDING** D RIVER


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NORTH DEMO ELEVATION

SCALE: 1/8" = 1'-0"

GENERAL DEMOLITION NOTES

A CONTRACTOR TO CONDUCT WALK-THROUGH OF ENTIRE BUILDING TO GAIN UNDERSTANDING OF COMPLETE SCOPE OF DEMOLITION. PREMISES WILL BE ACCEPTED IN AN "AS-IS" CONDITION AND "WHERE IS."

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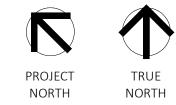
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- C PROVIDE AND MAINTAIN BARRICADES, LIGHTING AND GUARDRAILS AS REQUIRED BY APPLICABLE CODES AND REGULATIONS TO PROTECT OCCUPANTS OF BUILDING AND WORKERS
- D ERECT AND MAINTAIN DUSTPROOF PARTITIONS AS REQUIRED TO PREVENT SPREAD OF DUST,
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- CONSTRUCTION.
- G CONDUCT DEMOLITION OPERATIONS TO PREVENT INJURY TO PEOPLE AND DAMAGE TO ADJACENT BUILDINGS AND FACILITIES TO REMAIN.
- H SAW CUT THROUGH EXISTING MATERIALS TO PROVIDE A SMOOTH, STRAIGHT EDGE (CLEAN EDGE) FROM WHICH TO REMOVE EXISTING MATERIALS.
- I LIMIT THE SPREAD OF DUST, DIRT AND DEBRIS. BROOM CLEAN ALL WORK AREAS ON A DAILY BASIS. J CONTRACTOR TO LEGALLY DISPOSE OF DEMOLISHED ITEMS AND MATERIALS PROMPTLY. DO NOT ALLOW DEMOLISHED MATERIALS TO ACCUMULATE ON SITE.
- K UNLESS NOTED OTHERWISE, FIREPROOFING TO REMAIN. L UNLESS NOTED OTHERWISE, REMOVE ALL INTERIOR PARTITIONS WITH THE EXCEPTION OF STAIR SHAFTS AND ELEVATOR SHAFTS

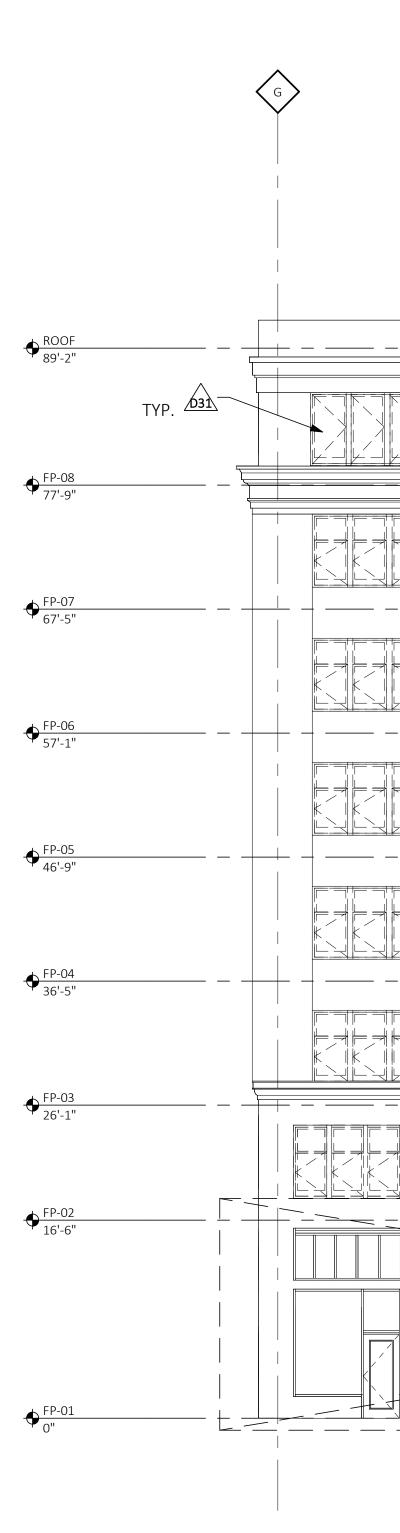D31 REMOVE WINDOW ASSEMBLIES. COORDINATE DEMO OF STOPS, HARDWARE, FRAMES, FASTENERS, GROUT, ETC WITH REPLACEMENT WINDOW INSTALLATION SUBMITTALS.

CONSTRUCTION KEYNOTES

DEMOLITION LEGEND

PARTITION TO REMAIN





0 2' 4' 8' SCALE: 1/8" = 1'-0"

DOOR AND FRAME TO

MERCHANTS BUILDIN 206 E. GRAND RIVER DETROIT MI
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DEMOLITION ELEVATIONS
Sheet Number
AD201

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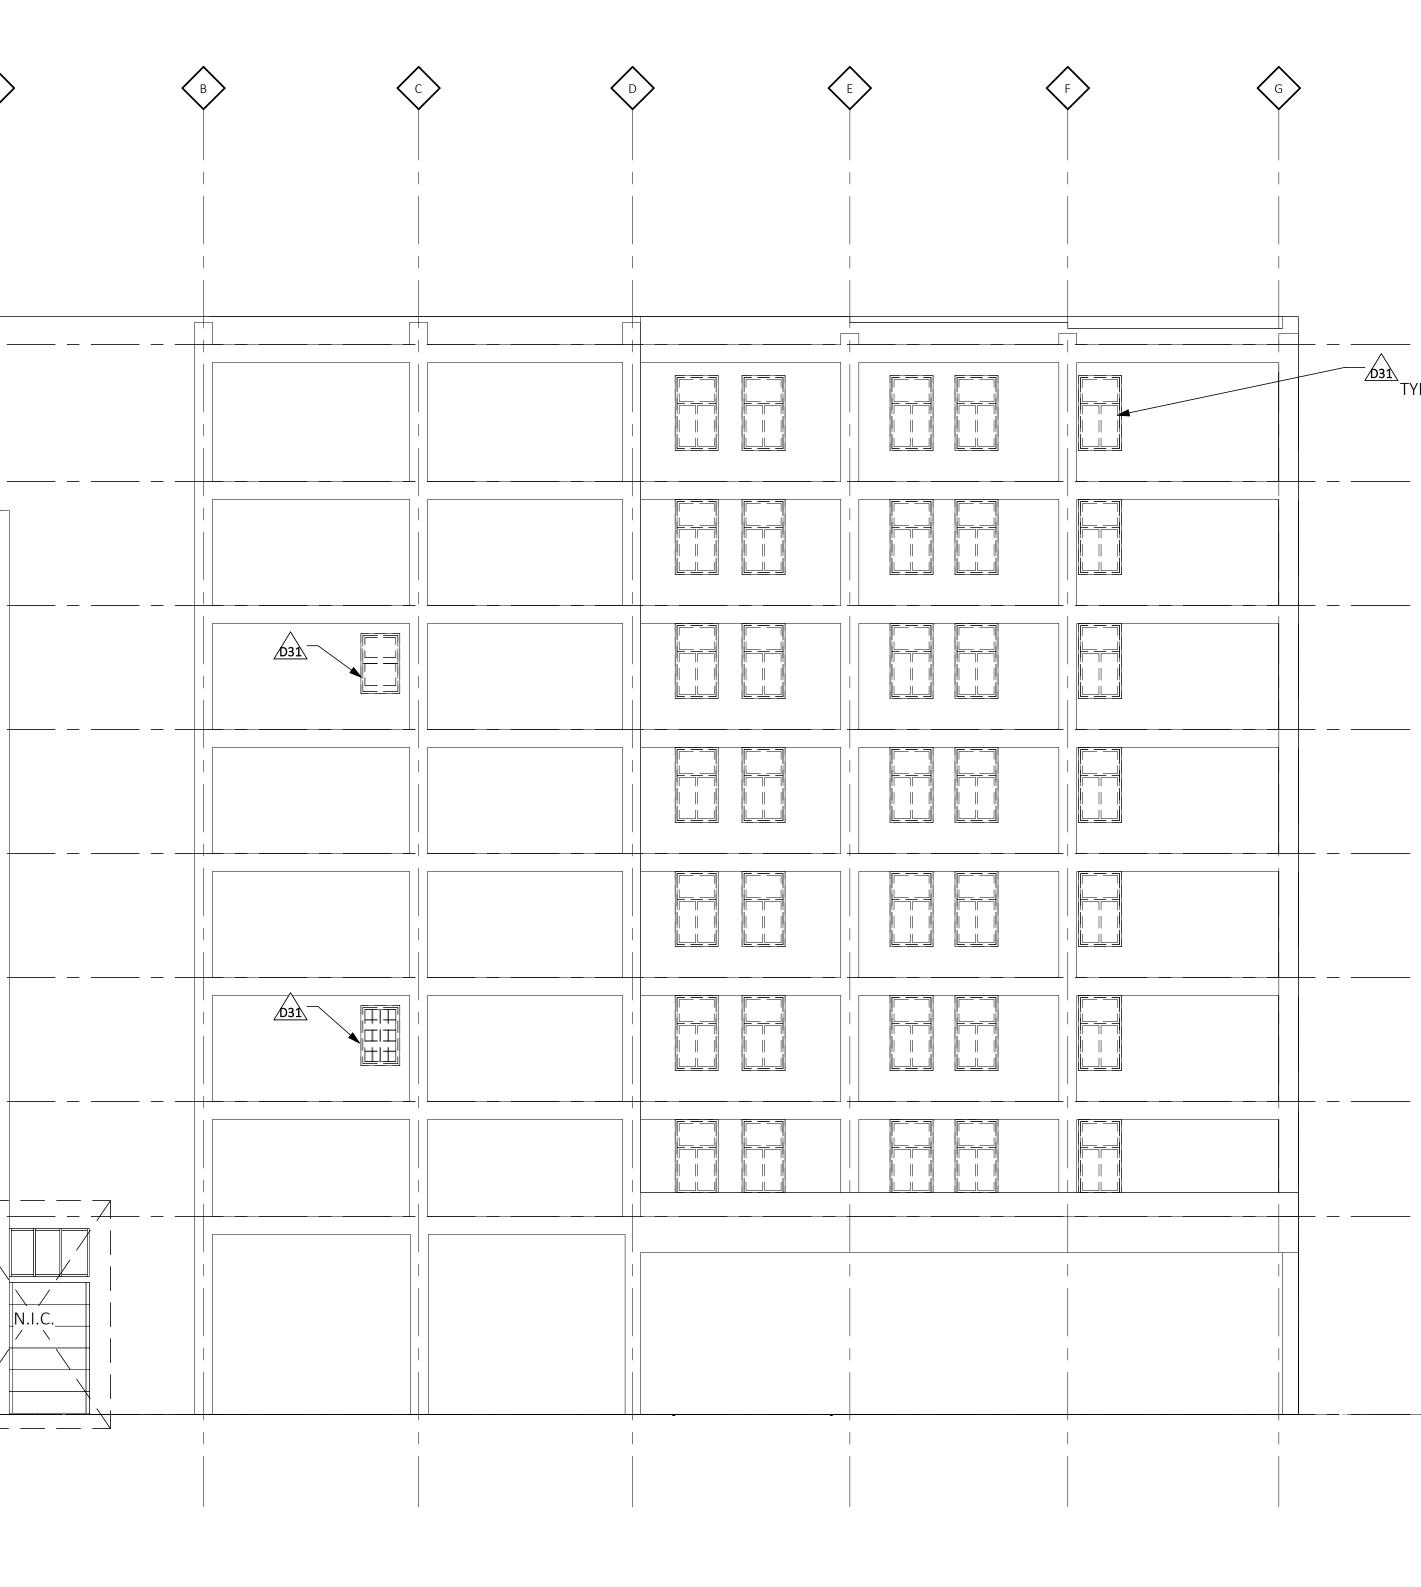
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• ROOF 89'-2" • FP-08 77'-9" — — — — — — ||+ • FP-06 57'-1" _____ • FP-05 46'-9" • FP-04 36'-5" • FP-03 26'-1" • FP-02 16'-6" ____ _ _ / $\Phi_{0''}^{\text{FP-0}}$



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SOUTH DEMO ELEVATION

SCALE: 1/8" = 1'-0"

GENERAL DEMOLITION NOTES

A CONTRACTOR TO CONDUCT WALK-THROUGH OF ENTIRE BUILDING TO GAIN UNDERSTANDING OF COMPLETE SCOPE OF DEMOLITION. PREMISES WILL BE ACCEPTED IN AN "AS-IS" CONDITION AND

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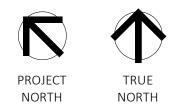
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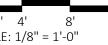
DEMOLITION LEGEND

PARTITION TO REMAIN

DOOR AND FRAME TO







0 2' 4' 8' SCALE: 1/8" = 1'-0"

TYP.

K UNLESS NOTED OTHERWISE, FIREPROOFING TO REMAIN.

"WHERE IS."

CODES AND REGULATIONS TO PROTECT OCCUPANTS OF BUILDING AND WORKERS

H SAW CUT THROUGH EXISTING MATERIALS TO PROVIDE A SMOOTH, STRAIGHT EDGE (CLEAN EDGE)

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GENERAL DEMOLITION NOTES

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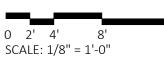


- D31 REMOVE WINDOW ASSEMBLIES. COORDINATE DEMO OF STOPS, HARDWARE, FRAMES, FASTENERS, GROUT, ETC WITH REPLACEMENT WINDOW INSTALLATION SUBMITTALS.
- D32 REMOVE NON-HISTORIC STOREFRONT ASSEMBLIES. COORDINATE DEMO WITH REPLACEMENT WINDOW INSTALLATION SUBMITTALS.
- D51 REMOVE FIRE ESCAPE

CONSTRUCTION KEYNOTES

DEMOLITION LEGEND

DOOR AND FRAME TO PARTITION TO REMAIN







Sheet Number
DEMOLITION ELEVATIONS
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HDC APPLICATION 4-17-23
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MERCHANTS BUILDING 206 E. GRAND RIVER DETROIT MI

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NORTH ELEVATION

SCALE: 1/8" = 1'-0"

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GENERAL NOTES

- A REFER TO A600 SERIES FOR WINDOW AND DOOR SCHEDULE AND DETAILS.
- B REFER TO REFLECTED CEILING PLANS FOR EXTERIOR SOFFIT INFORMATION.C REFER TO ROOF PLAN FOR PARAPET AND OVERHANG INFORMATION.
- D SEE ELECTRICAL DRAWINGS FOR ADDITIONAL LIGHTING REQUIREMENTS AND FIXTURE TYPES.
 E SEE ELEVATIONS AND STRUCTURAL DRAWINGS FOR LOCATIONS OF EXPANSION AND CONTROL JOINTS. CONTRACTOR SHALL PROVIDE ADDITIONAL INTERIOR CONTROL JOINTS AS REQUIRED TO COMPLY WITH MAXIMUM SPACING REQUIREMENTS IN SPECIFICATIONS AND NATIONAL MASONRY INSTITUTE. PROVIDE CONTROL JOINTS AT ALL MASONRY REENTRANT CORNERS.
- F PROVIDE BACKING AND/OR STRUCTURAL SUPPORT AS REQUIRED FOR SIGNAGE AND LIGHTING.
 G EXPOSED STRUCTURAL STEEL SHALL BE GALVANIZED AND PAINTED UNLESS NOTED OTHERWISE.
 H APPLY SEALANT WHENEVER DISSIMILAR MATERIALS MEET.

RESTORATION GENERAL NOTES

- A. MASONRY/STONE RESTORATION CONTRACTOR ("SUBCONTRACTOR") TO PROVIDE ALL LABOR, MATERIAL, EQUIPMENT, SUPERVISION, PERMITS AND ANY OTHER COSTS OR EXPENSES NECESSARY TO COMPLETE THE WORK. SUBCONTRACTOR JOB MOBILIZATION SHALL INCLUDE, BUT NOT BE LIMITED TO, ANY NECESSARY WORKSTATION AND JOB TRAILER, MAST CLIMBING PLATFORMS, AERIAL LIFTS, SWING STAGES, BARRICADES AND WALK THRU SCAFFOLD AS NEEDED.
- B. BUILDING RESTORATION TO INCLUDE ALL TERMS, CONDITIONS AND SPECIFICATIONS OF ORIGINAL CONTRACT AND ANY ADDITIONAL WORK NECESSARY TO MEET THE SECRETARY OF THE INTERIOR STANDARDS FOR THE REHABILITATION OF HISTORIC PROPERTIES. THIS INCLUDES ALL WORK NECESSARY OVER AND ABOVE THAT SPECIFIED IN THE ARCHITECTURAL DRAWINGS AND OTHER CONSTRUCTION DOCUMENTS, INCLUDING ALL NOTES REGARDLESS OF TIME AND MATERIAL NECESSARY TO EXECUTE THIS WORK. ANY AREAS INDICATED WITHIN DRAWINGS ARE ONLY SUGGESTIVE IN NATURE. MASON TO MEET WITH ARCHITECT AND OWNER TO CONFIRM THE SCOPE OF WORK.
- C. RESTORATION CONTRACTOR SHALL INSPECT ALL EXISTING MASONRY, INCLUDING BOTH SIDES OF PARAPET FULL HEIGHT, FOR STRUCTURAL STABILITY PRIOR TO BID. REINSPECT AFTER INITIAL CLEANING OF MASONRY.
- D. ALL ELEVATIONS SHALL UNDERGO COMPLETE BRICK, STONE, AND TERRA COTTA CLEANING FROM PARAPET TO GRADE. SEE MASONRY CLEANING SPECIFICATION SECTIONS FOR DETAILS ON APPROVED CLEANING PROCEDURES, PRODUCTS, AND MANUFACTURERS.
- E. CLEAN FACADE USING GENTLEST MEANS POSSIBLE TO ACHIEVE SATISFACTORY RESULTS WITHOUT CHANGING THE SURFACE OF THE MASONRY. PAY SPECIAL ATTENTION TO AREAS OF EXCESSIVE SOILING. CONTRACTOR SHALL CONDUCT TEST PATCHES TO ENSURE THE BEST AND MOST ECONOMICAL MEANS OF CLEANING. ALL MASONRY AND TERRA COTTA CLEANING SHALL MEET THE SECRETARY OF INTERIOR STANDARDS FOR REHABILITATION AS WELL AS ALL APPLICABLE NATIONAL PARK SERVICE TECHNICAL BRIEFS.
- F. SURFACES TO BE PRE-WET WITH CLEAN WATER. CLEANING SOLUTIONS TO NOT REMAIN ON SURFACES FOR MORE THAN 5 MINUTES FOLLOWED IMMEDIATELY BY LOW-PRESSURE FLOOD RINSE, UNLESS NOTED OTHERWISE IN MASONRY CLEANING SPECIFICATION. CLEANING IS TO BRING MASONRY / STONE UNIT AS CLOSE AS POSSIBLE TO ORIGINAL COLOR WITHOUT BURNING OR ABRASION.
- G CLEAN ALL STONE THAT IS TO REMAIN & LET WEATHER FOR TWO WEEKS BEFORE ANY REPLACEMENT OR PATCHING IS TO OCCUR - REPLACEMENT STONE & PATCHED AREAS TO MATCH EXIST 'CLEANED' COLOR
- H. 100% OF MORTAR JOINTS TO BE VISUALLY INSPECTED. ALL MORTAR JOINTS DETERIORATED IN EXCESS OF 3/8 INCH BEYOND FACE OF MASONRY/STONE UNIT, OR EVIDENCING UNSOUNDNESS OF CRACKING WHETHER STRUCTURAL OR OTHERWISE SHALL BE REMOVED TO A DEPTH OF 1/2" MINIMUM. WRITTEN APPROVAL BY OWNER SHALL BE REQUIRED PRIOR TO COMMENCEMENT OF REPAIR BY SATISFACTORY SUBMISSION OF MOCK-UP OF PROPOSED MORTAR JOINT.
- I. NEW MORTAR APPLIED TO ALL OPEN JOINTS SHALL BE OF NO GREATER STRENGTH THAN ORIGINAL MORTAR OR MASONRY UNITS. MORTAR COLOR, TEXTURE, CONSISTENCY AND JOINT PROFILE WILL MATCH EXISTING AS CLOSE AS POSSIBLE.
- J APPLY NEW, TWO COMPONENT URETHANE SEALANT AT ALL JOINTS WHERE DISSIMILAR MATERIALS MEET, AND ALL SKYWARD FACING JOINTS. BACKER ROD TO BE INSTALLED IN OPEN JOINT PRIOR TO SEALANT APPLICATION.
- K. NO ACCELERATORS OR OTHER ADMIXTURES SHALL BE USED WITHOUT PRIOR WRITTEN OWNER APPROVAL. ENCLOSURES AND HEAT SUFFICIENT TO PROTECT MORTAR FROM FREEZING PRIOR TO SET SHALL BE THE SOLE RESPONSIBILITY OF SUBCONTRACTOR.
- L. REPLACE/RESET LOOSE MASONRY UNITS AND REPOINT DAMAGED MORTAR JOINTS AS REQUIRED. IF NECESSARY, RECOMMEND FURTHER REHABILITATION TO ENSURE STABILITY OF EXTERIOR WALL AND PARAPET CONSTRUCTION. SEE MASONRY RESTORATION SPECIFICATIONS FOR DETAILS ON APPROVED RESTORATION PROCEDURES, PRODUCTS, AND MANUFACTURERS. ALL MASONRY RESTORATION WORK SHALL MEET THE SECRETARY OF INTERIOR STANDARDS FOR REHABILITATION AS WELL AS ALL APPLICABLE NATIONAL PARK SERVICE TECHNICAL BRIEFS.
- M. ALL MASONRY/ STONE UNIT SHALL BE REPLACED WITH OWNER APPROVED MATERIAL WHEREIN SPALLING OR OTHER DETERIORATION ELIMINATED MORE THAN 5% OF THE MASONRY/ STONE UNIT (MEASURED BY ORIGINAL BRICK OR STONE FACE AREA).
- N. INSPECT ALL TERRA COTTA UNITS FOR DAMAGE, SPALLING OR CRAZING.
- O. WHERE TERRA COTTA GLAZING HAS SPALLED AND THE CLAY SUBSTRATE IS IN GOOD CONDITION, COAT RAW CLAY WITH APPROVED BREATHABLE SEALER TO MATCH COLOR OF EXISTING GLAZING.
 P. WHERE TERRA COTTA UNITS HAVE SPALLED SIGNIFICANTLY, PATCH DAMAGED AREAS WITH APPROVED MASONRY REPAIR MORTAR AS REQUIRED BY DEPTH OF DAMAGED AREA. COAT
- PATCHED AREA WITH APPROVED BREATHABLE SEALER TO MATCH COLOR OF EXISTING GLAZING.Q. WHERE TERRA COTTA HAS DETERIORATED BEYOND REPAIR, REMOVE AFFECTED TERRA COTTA
- UNITS AND PROVIDE NEW TERRA COTTA UNITS TO MATCH EXISTING PROFILE, COLOR AND FINISH.
 R. SEE TERRA COTTA RESTORATION SPECIFICATIONS FOR APPROVED RESTORATION PROCEDURES, PRODUCTS, AND MANUFACTURERS. ALL TERRA COTTA RESTORATION WORK SHALL MEET THE SECRETARY OF INTERIOR STANDARDS FOR REHABILITATION AS WELL AS ALL APPLICABLE NATIONAL PARK SERVICE TECHNICAL BRIEFS.

CONSTRUCTION KEYNOTES (###)

EXTERIOR ELEVATION MATERIAL LEGEND

TC-1	TERRACOTTA - EXISTING
BRK-1	
	RED BRICK - EXISTING
CON-1	CONCRETE STRUCTURE - EXISTING
MTL-1	METAL - EXISTING





0 2' 4' 8' SCALE: 1/8" = 1'-0"





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____ __ __ __ __ BRK-1 EXIST MASONRY TO BE CLEANED, TYP.

EXIST CANVAS BILLBOARD LOCATION -

(R3)-

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◆ ROOF 89'-2"


+ FP-08 77'-9"

€ FP-07 67'-5"

◆ FP-06 57'-1"

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SOUTH ELEVATION

SCALE: 1/8" = 1'-0"

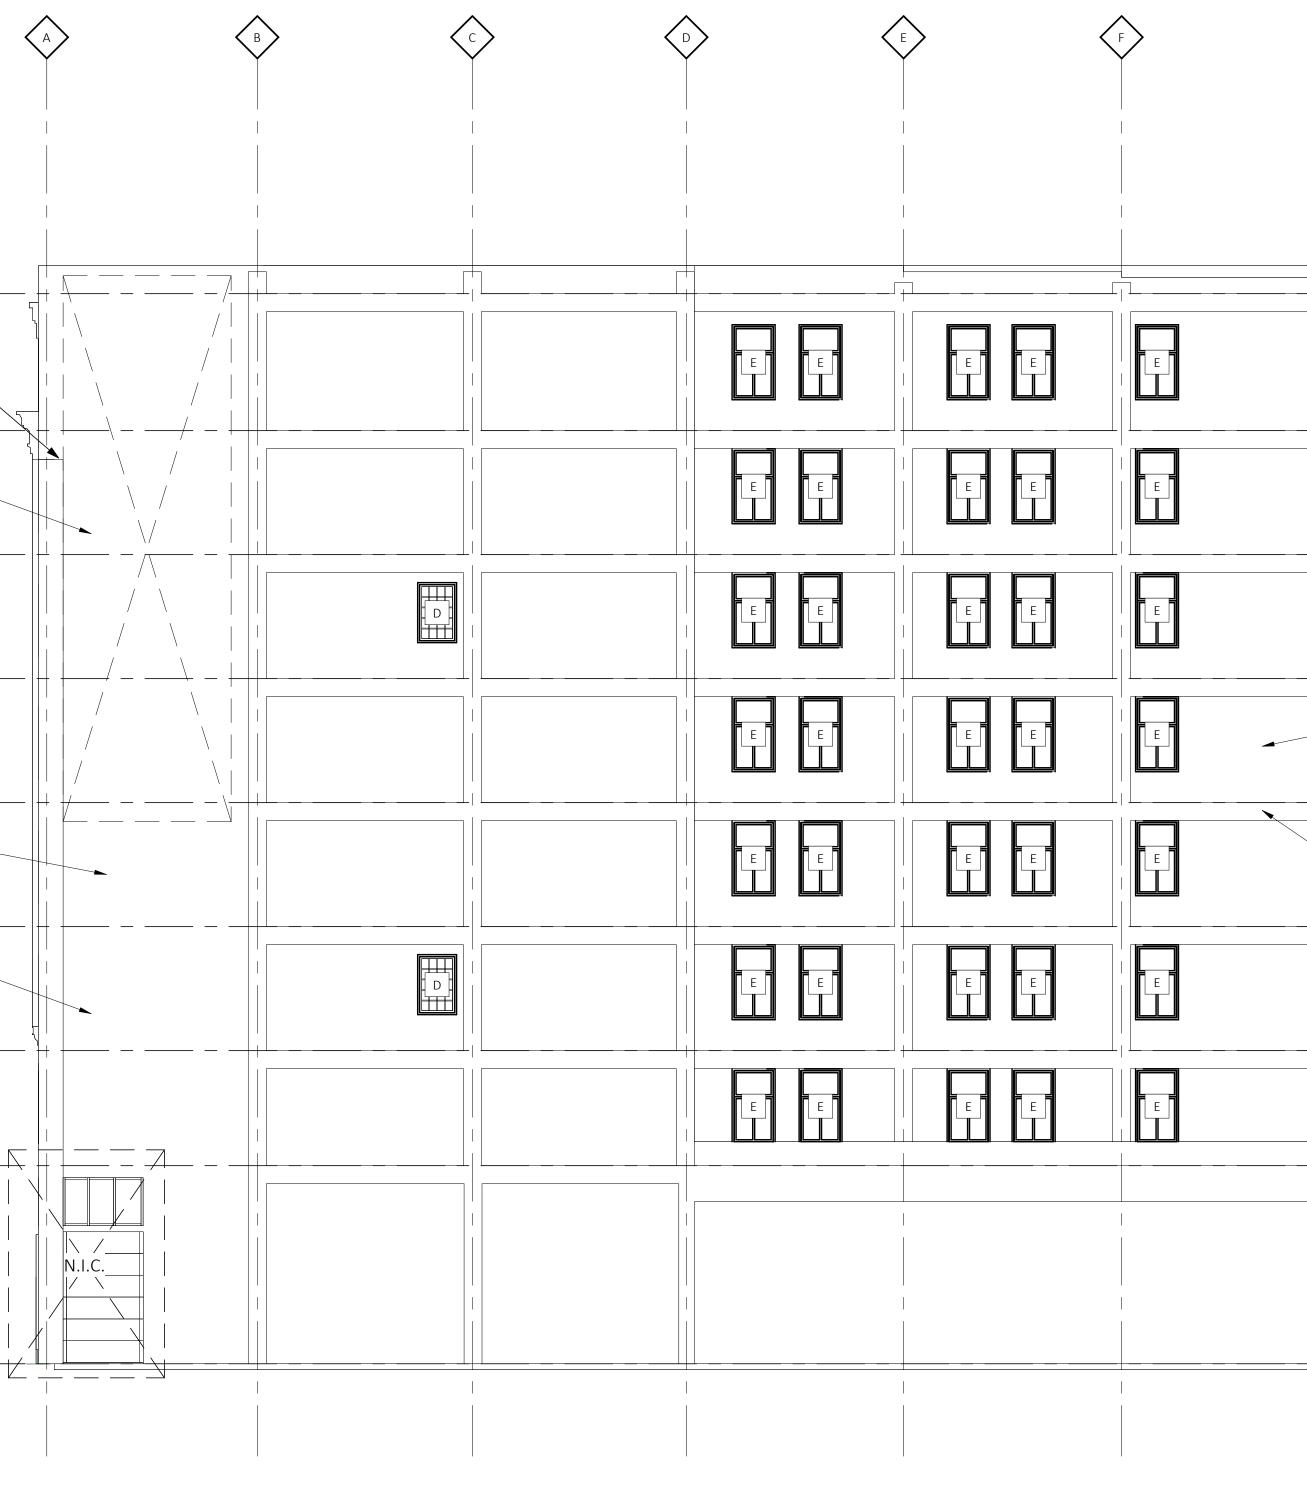GENERAL NOTES

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CONSTRUCTION KEYNOTES (###)


R3 EXTERIOR SIGNAGE

EXTERIOR ELEVATION MATERIAL LEGEND

1		
	TC-1	TERRACOTTA - EXISTING

- BRK-1 RED BRICK EXISTING
- CON-1 CONCRETE STRUCTURE EXISTING

MTL-1 METAL - EXISTING

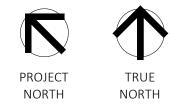



SCALE: 1/8" = 1'-0"

BRK-1

CON-1





С

D

WEST ELEVATION SCALE: 1/8" = 1'-0"

3

EAST ELEVATION SCALE: 1/8" = 1'-0"

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CONSTRUCTION KEYNOTES (###)

278 NEW FIRE ESCAPE TO MATCH EXISTING - SEE STRUCTURAL

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TC-1	TERRACOTTA - EXISTII

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- CON-1 CONCRETE STRUCTURE EXISTING

MTL-1 METAL - EXISTING





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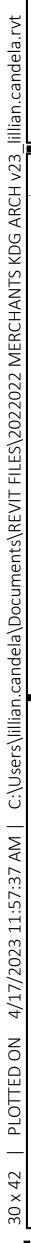
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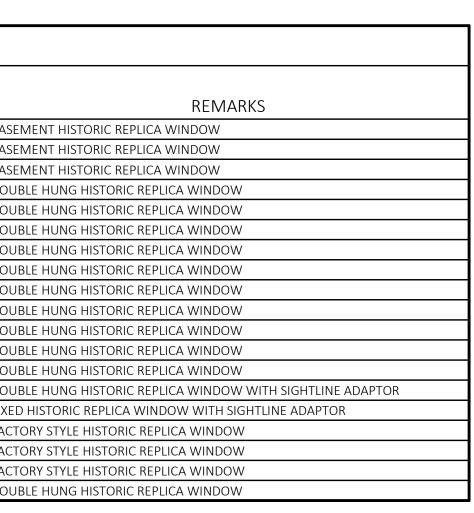
A600 - WINDOW SCHEDULE


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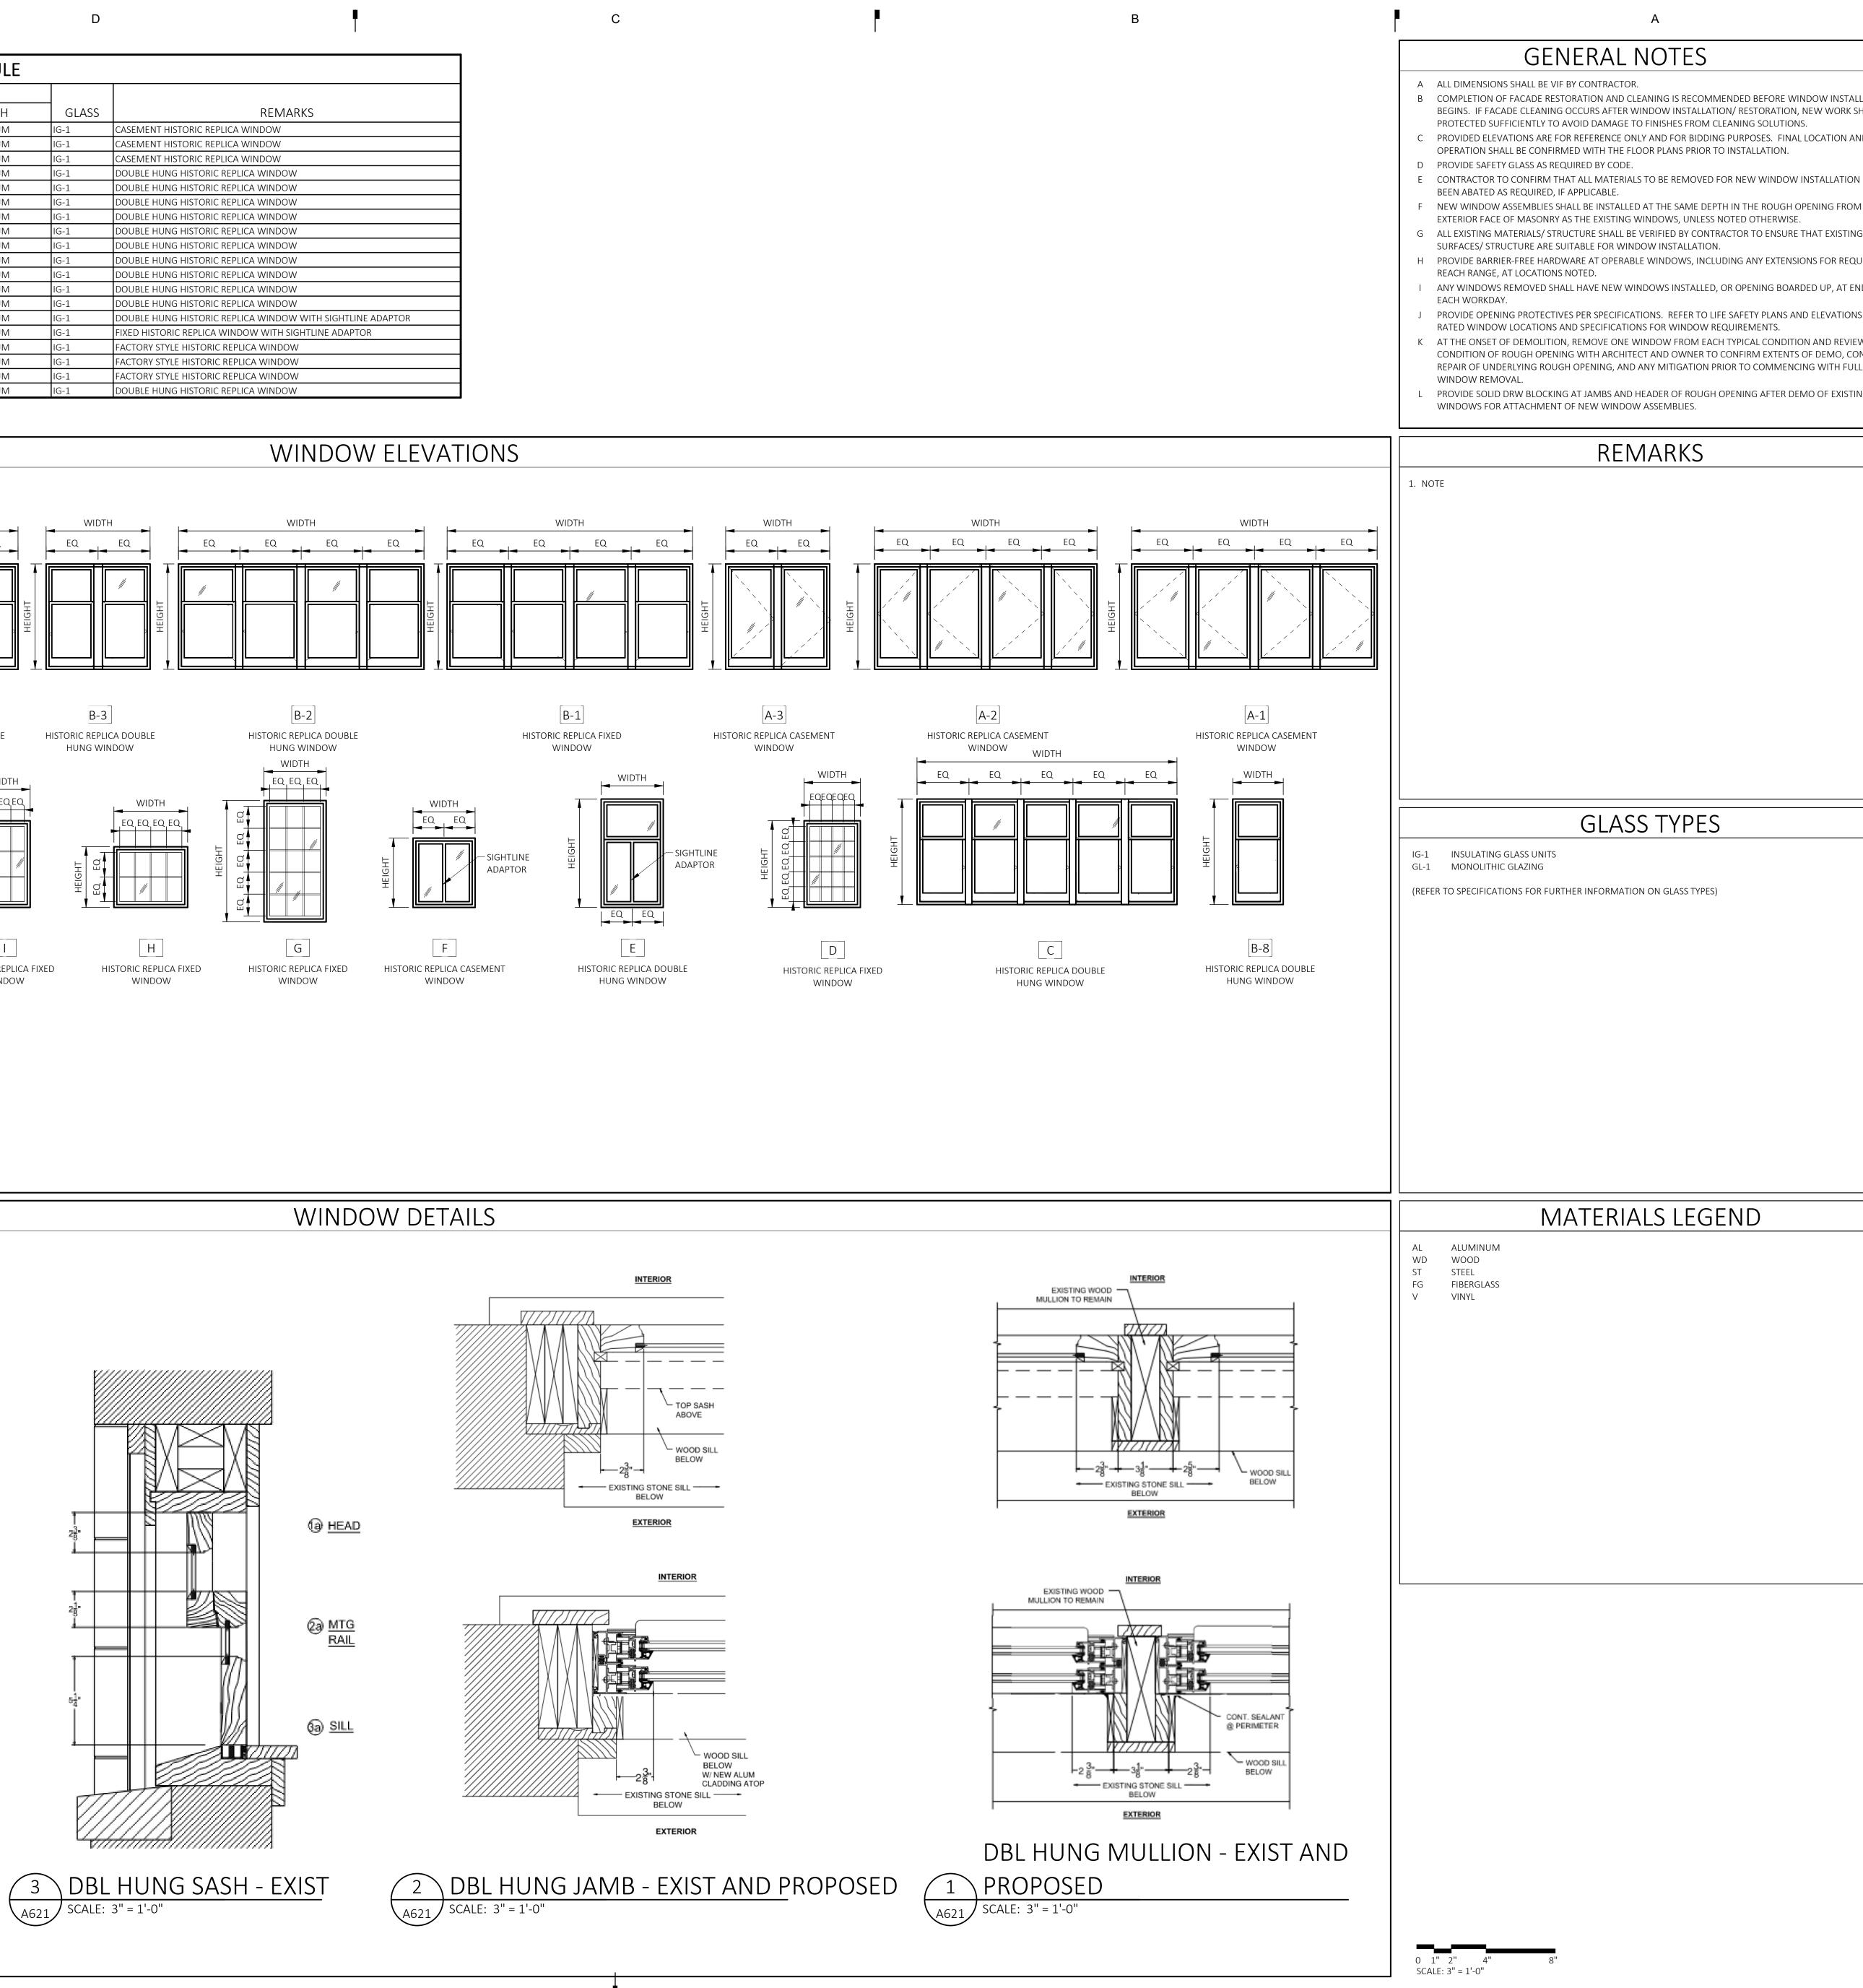
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		6'-1" 6'-1"		BLACK ALUMINUM BLACK ALUMINUM		BLACK ALUMINUM BLACK ALUMINUM	BLACK ALUMINUM BLACK ALUMINUM	IG-1 IG-1	DOU DOU
				BLACK ALUMINUM		BLACK ALUMINUM	BLACK ALUMINUM	IG-1	DOU
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4 DBL HUNG SASH- PROPOSED A621 SCALE: 3" = 1'-0"








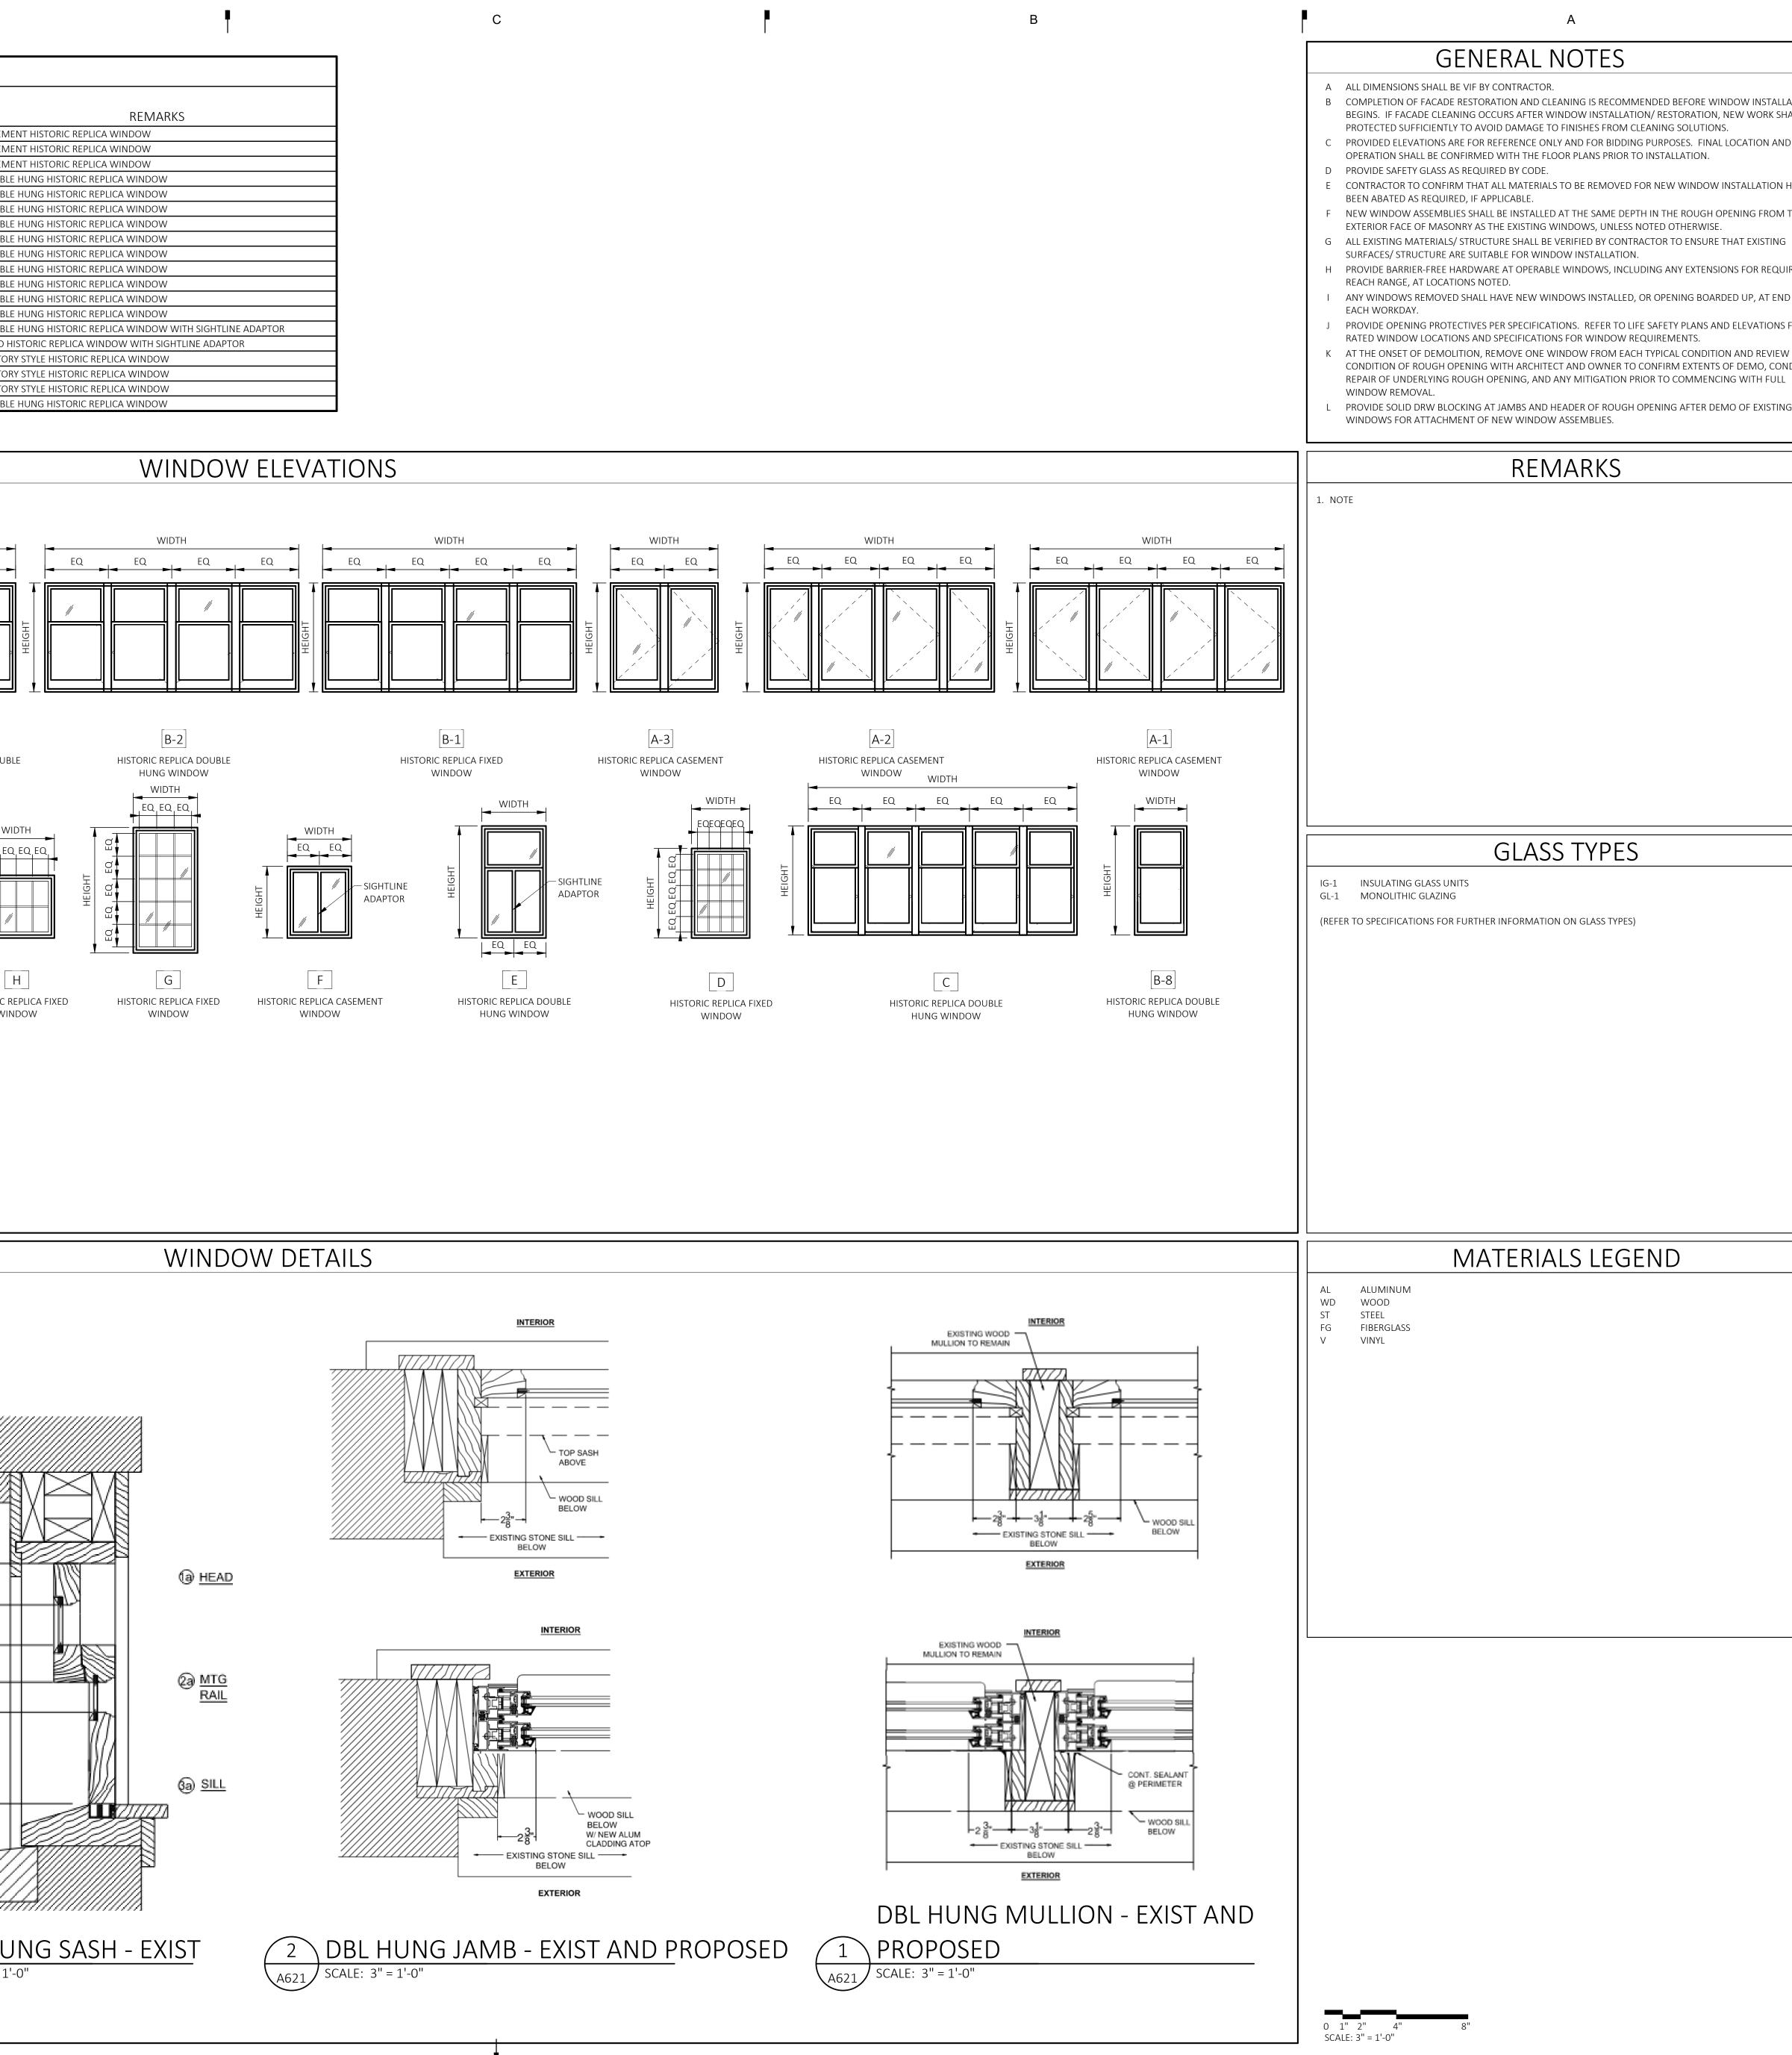

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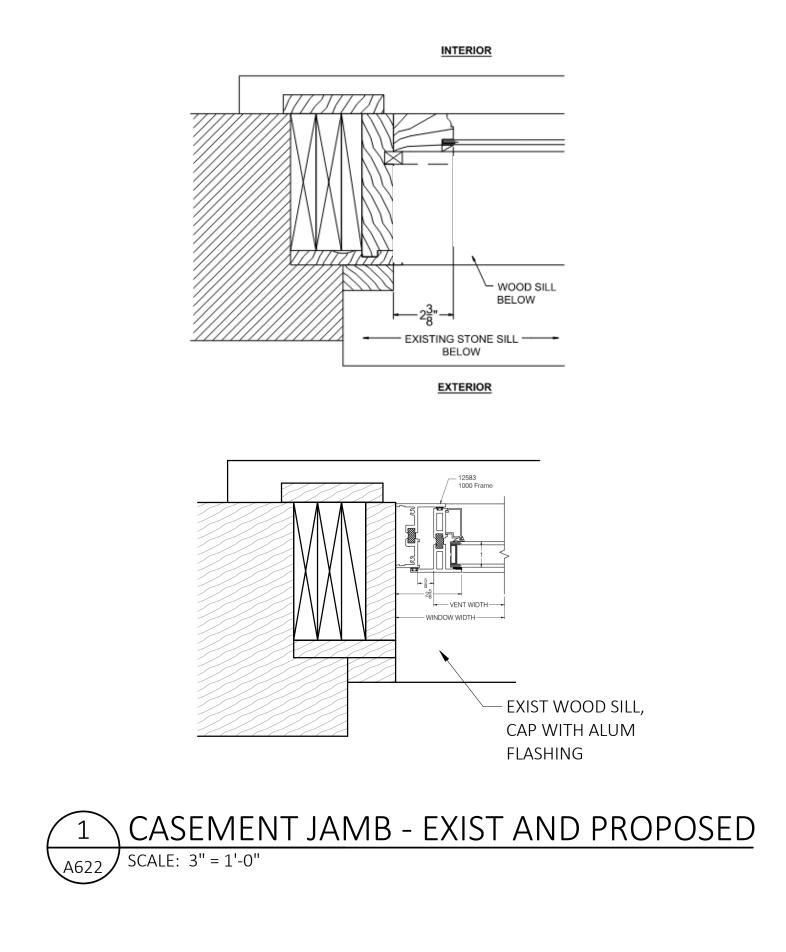

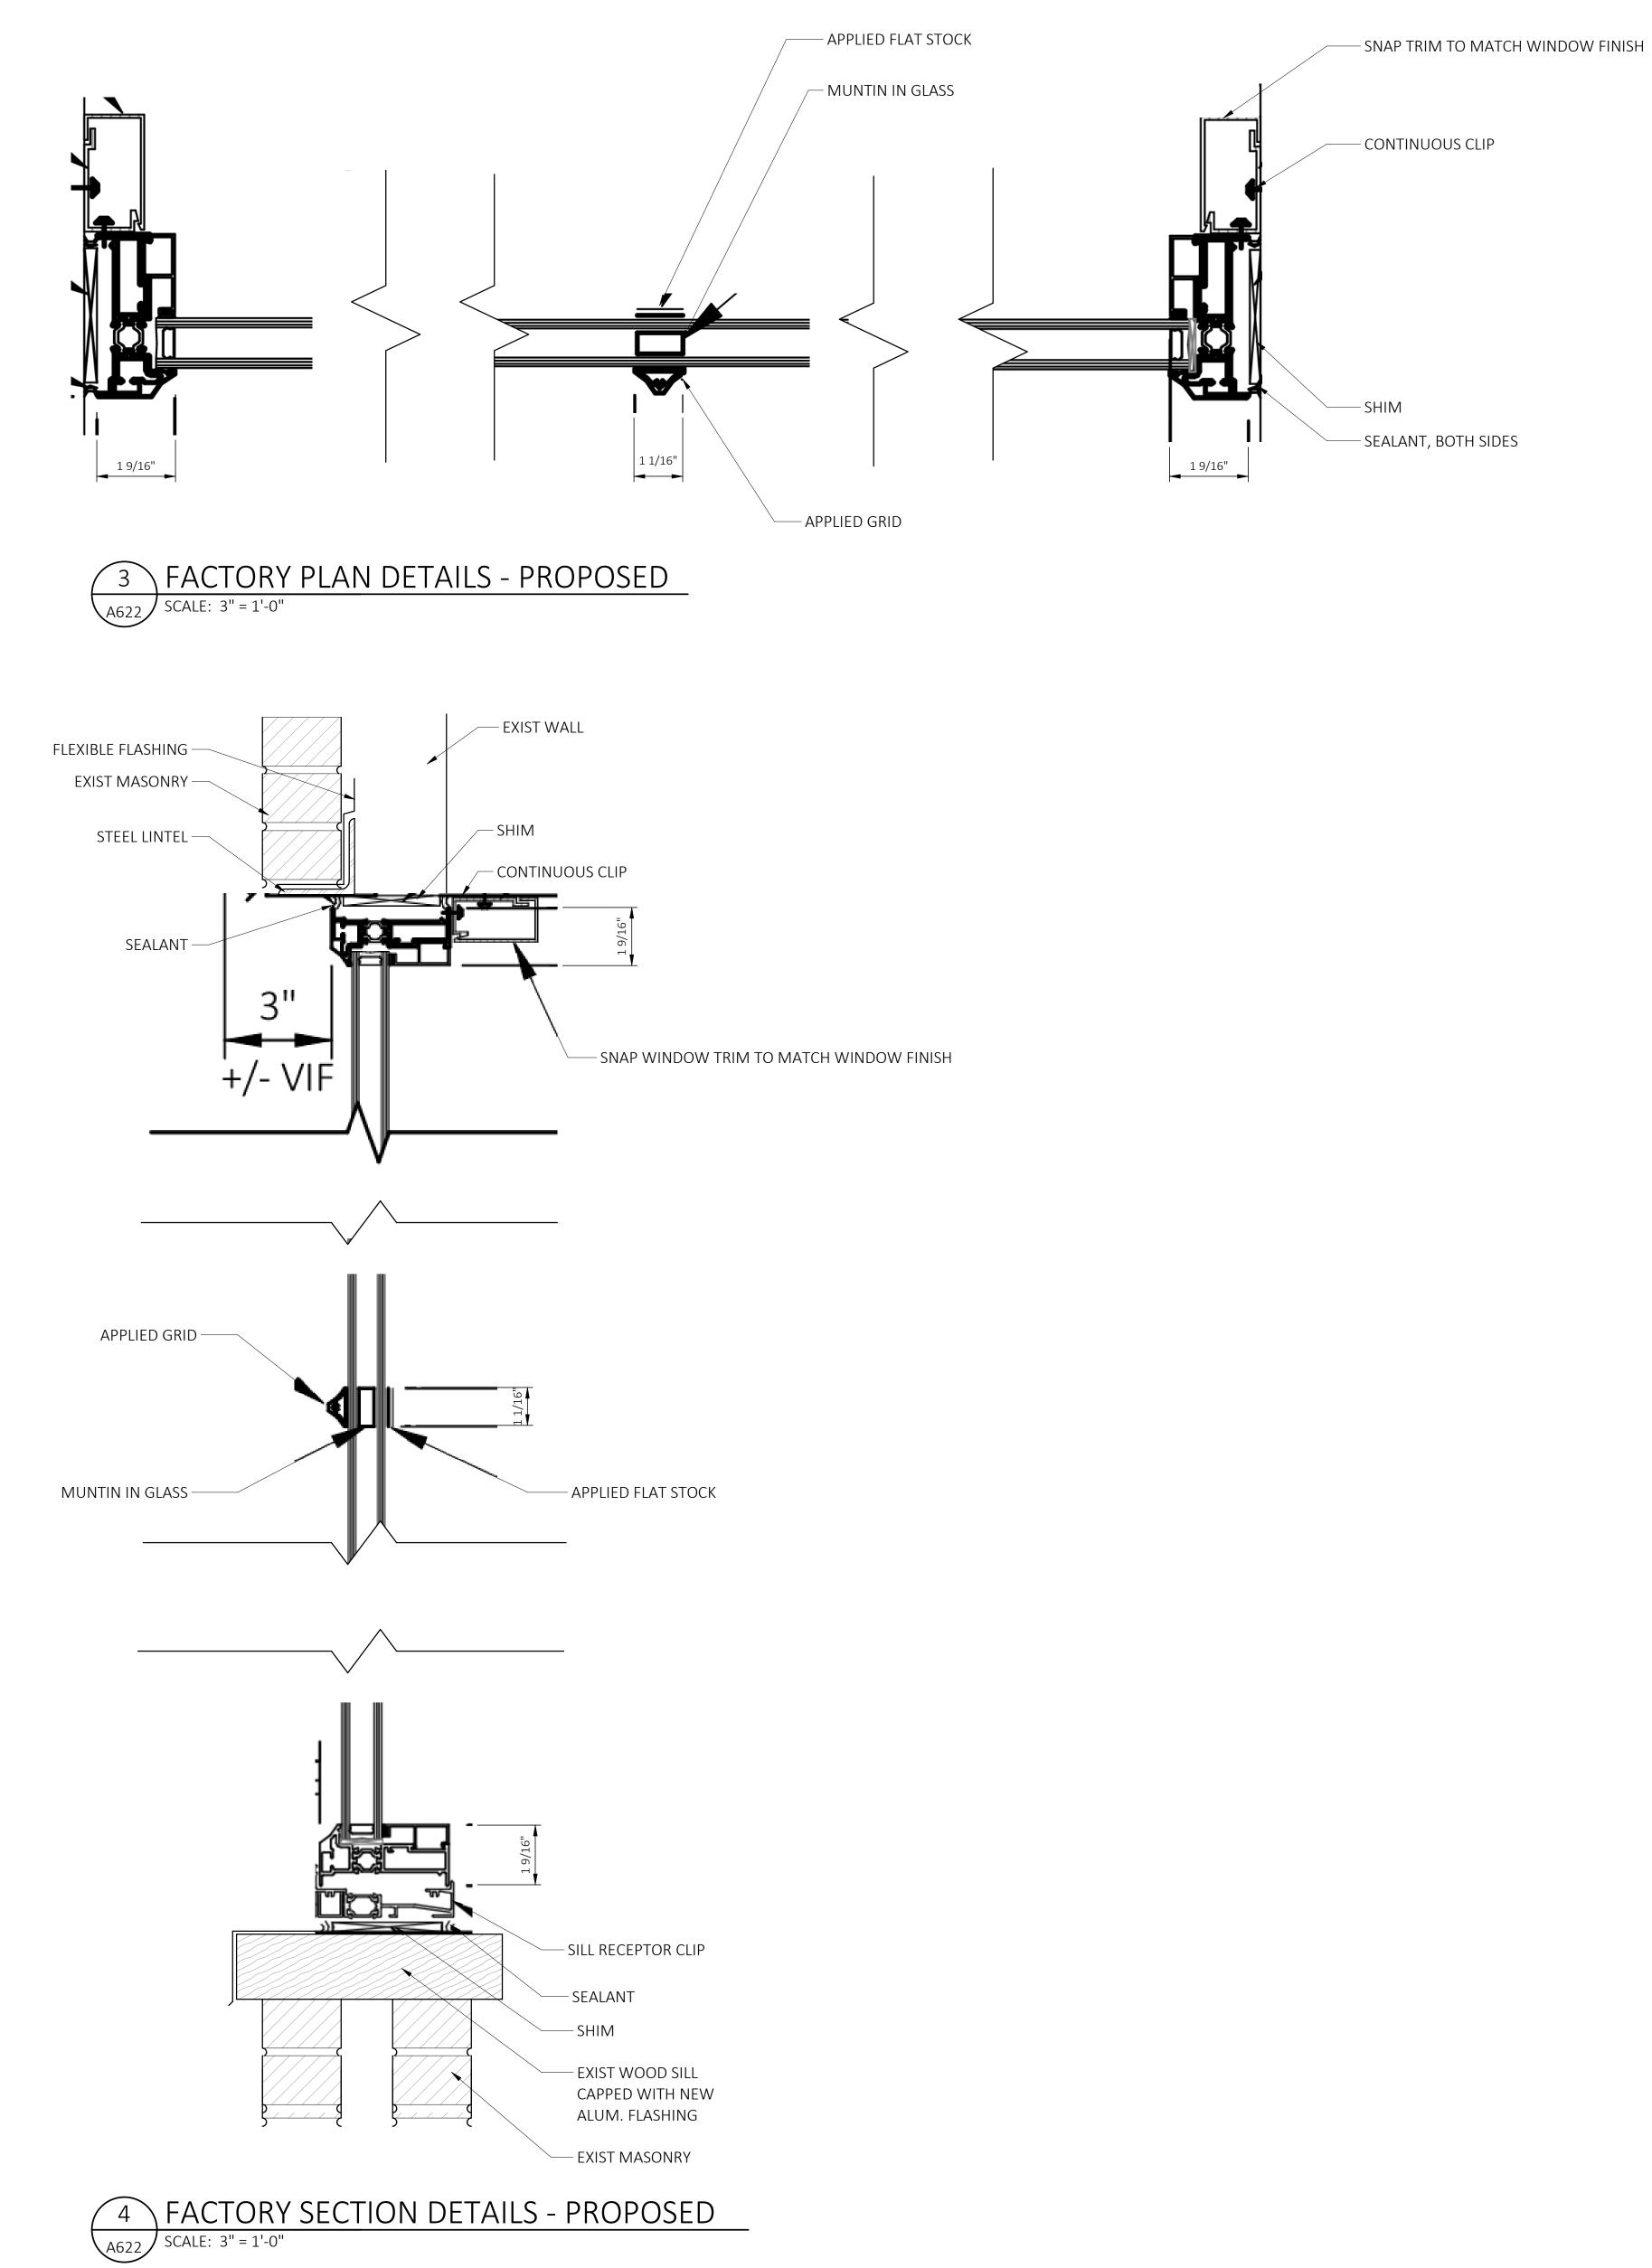
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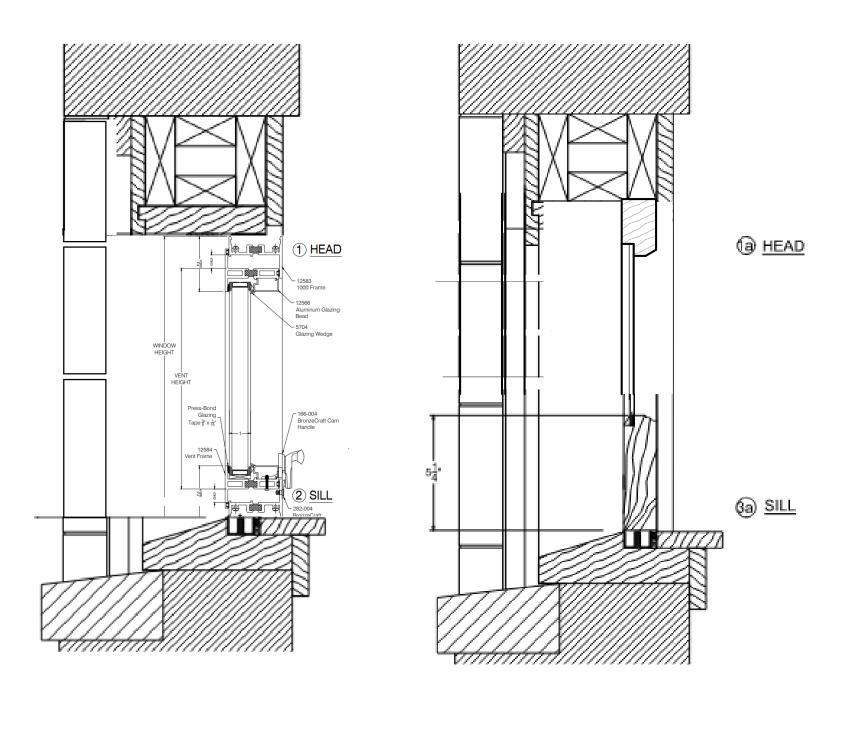
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2 CASEMENT SASH - EXIST AND PROPOSED A622 SCALE: 3" = 1'-0"

Consultant
Owner Owner
MERCHANTS BUILDING 206 E. GRAND RIVER DETROIT MI
Project
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KraemerDesignGroup

Architect