

54048 Mound Road Shelby Township Michigan 48316

February 24, 2023

Historic District Commission Review
761 Whitmore
Rosemor Apartment Window Replacement

#### **Description of Existing Conditions**

The Rosemor Apartments building was constructed in 1948 and designed by Wiedmaier & Gay Architects. Wiedmaier & Gay, who had once designed many of the eclectic apartment buildings of the 1920s in Palmer Park, later designed Modernistic buildings including the Rosemor Apartments. It is a two and one-half story, hip roof, buff brick, irregular shaped, garden court apartment building. This thirty-unit apartment building is at the corner of Whitmore and Third and has one entrance that opens onto Whitmore (761 Whitmore Road) and two entrances that open onto the court (17450 and 17452 Third Avenue).

The building has received a Certificate of Appropriateness (COA 19-6423) on September 4, 2019, for brick and roof repair. This work was permitted, work completed, inspected, and approved by the building department. New replacement windows were installed in the Summer of 2020 when the work noted above was being performed.

#### **Description of Project**

A prior application was heard at the February 8, 2023 HDC meeting and was given a denial by the commission. However, during the discussions, we suggested some possible modifications to the current window installation. This was met positively by commission members. With this current submittal, the applicant is seeking the board's approval for the installed windows with new modifications.

#### **Detailed Scope of Work:**

• The windows as installed are double-hung, composite vinyl replacement windows. A window schedule with sizes and quantities are provide on Sheet A200 provided with this submittal. There are 179 windows installed. All windows are Earthtone color and have a 2/2 horizontal muntin bar pattern internal to the glass panes. Of these, 169 windows have brake metal installed around windows. There are 19 windows that were installed in the rebuilt sections of the building and do not need brick moulds or window stools to be installed.

#### MUNTINS

We propose to add a 7/8" wide external simulated divided lite to the exterior panes matching the current 2/2 horizontal muntin bar pattern. The current internal muntin is 5/8" wide and will be obscured by the new external muntin. The color will match the current window manufacturer color of Eatrhtone. The muntin profile will be secured to the glass with an adhesive tape supplied by the window manufacture. Adding an exterior applied SDL muntin will give the 3d visual division of the glass pane matching the prior window look. A profile detail of the muntin is provided with the attached plans. This will be typical for all 466 window panes.

• BRICK MOULDS AND STOOL (CURRENT WIDNWO CONDITION) We propose to remove the current brake metal brick mould around each window that have them. We selected one window and removed the metal surround and found that the original wood brick mould and window stool remained. With this discovery, we plan on scraping the existing paint, repairing any blemishes, and repainting the wood. For any pieces that need to be replaced, we will source or have milled replacement pieces. Each window will Inspected and, if required, readjusted within the opening. A flat stock filler of 1" x 1/2" wood will need to be installed between the back side of the brick mould and the window frame. This will be painted to match as well. The windows will then be recaulked with a matching color.

#### WINDOWS AT REBUILT AREAS

There are 19 windows that were installed in the rebuilt sections of the building and do not need brick moulds or window stools to be installed. The new brick work was installed to the size of the new window openings. A flat stock filler of 1 1/2" x 1/2" wood will need to be installed between the back side of the brick and the window frame. This will be painted to match as well. The windows will then be caulked with a matching color.


 All existing brick rowlock and stone sills will be stripped of the paint to their original color.

#### **Product Data**

See attached brochure and cut sheet for additional information.

- Windows: Manchester Series by Quaker, Color: Earthtone
- Drawings with Photos and



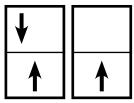

Manchester Series
Manchester R-40/R-35

3 ¼" Frame Depth Double Hung/Single Hung

### MANCHESTER SERIES DOUBLE HUNG/SINGLE HUNG

The Quaker Manchester Series Double Hung/Single Hung window is ideal for a variety of applications including - Energy Efficient, Apartments, Assisted Living and Housing Authority.

#### **FEATURES**

#### **♦ Commercial Framing System**

- 3 ¼" main frame
- 0.060" wall thickness of frame, 0.070" wall thickness of sash

#### **♦** Enhanced Design

• Mitered and welded corners

#### **♦** Glazing

• ¾" insulated glass

#### **♦** Hardware

• Block and tackle balancers

#### **♦** Screen

Roll form aluminum screen frame with BetterVue<sup>™</sup> mesh

#### **BENEFITS**

- ♦ The capacity to match exterior colors for unique project facades
- ♦ The ability to facilitate large sizes for taller and wider window openings

#### **OPTIONS**

#### **◊** Available Configurations

- Double Hung
- Single Hung
- Geometric shapes

#### **♦ Muntin Choices**

- Internal or simulated divided lites available
- **♦ Limited travel Hardware**
- **♦** Nailing Fin
- **♦** Screen
  - Roll form aluminum screen frame with aluminum wire mesh
  - Roll form aluminum screen frame with sunscreen mesh
  - Roll form aluminum screen frame with stainless steel 0.009" thickness mesh

#### **♦** Glazing

- Capillary tubes
- Argon gas
- Wide variety of glazing, tinting and thickness options

#### **◊** Panning & Trim Choices

• Wide variety of panning, receptor and trim available

#### ♦ Mulling

• Wide variety of structural mulls

#### **PERFORMANCE**

♦ Structural & Thermal (test reports or thermal simulations available upon request)


Model	Double Hung	Single Hung
AAMA/WDMA/CSA 101/I.S.2/A440-08 Rating	R-40	R-35
Structural Load P.S.F.	60.15	52.63
Air at 50 MPH (cfm/ft²)	0.16	0.1
Water (No Penetration) P.S.F.	7.52	5.43
U-Value (with Low-E and Argon)	0.25-0.29	0.25-0.29
SHGC (with Low-E and Argon)	0.14-0.32	0.14-0.33
Window Test Size	40" × 63"	40" × 63"

and certified by Association, ad the Window

6/2019 - V3





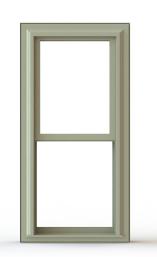



#### VINYL COLORS AND ARCHITECTURAL EXTERIOR PAINT COATINGS AND FINISHES

Solid Vinyl Colors (interior & exterior)






White Sandstone

Beige

Optional Faux Wood Grain (interior only)

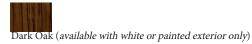

Optional Painted Colors (exterior only)



Optional Unlimited Custom Painted Colors (exterior only)



\* Printed colors shown here may not accurately depict actual vinyl or painted colors. Color samples are available upon request.













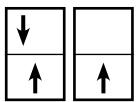

# Manchester Series Manchester R-40/R-35

## 3 ¼" Frame Depth Double Hung/Single Hung

## MANCHESTER DOUBLE HUNG

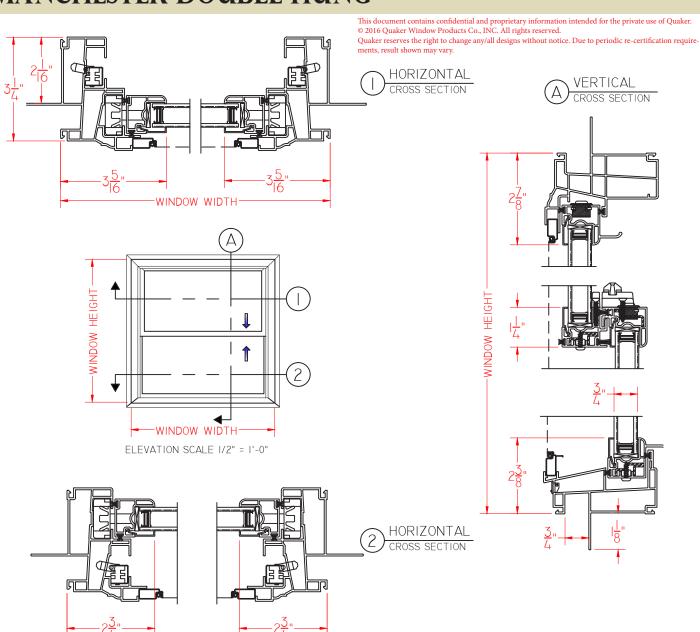

SCALE 1:3

Our products are tested to the standards of and certified by the American Architectural Manufacturer's Association, the National Fenestration Rating Council and the Window & Door Manufacturers Association.




-WINDOW WIDTH:







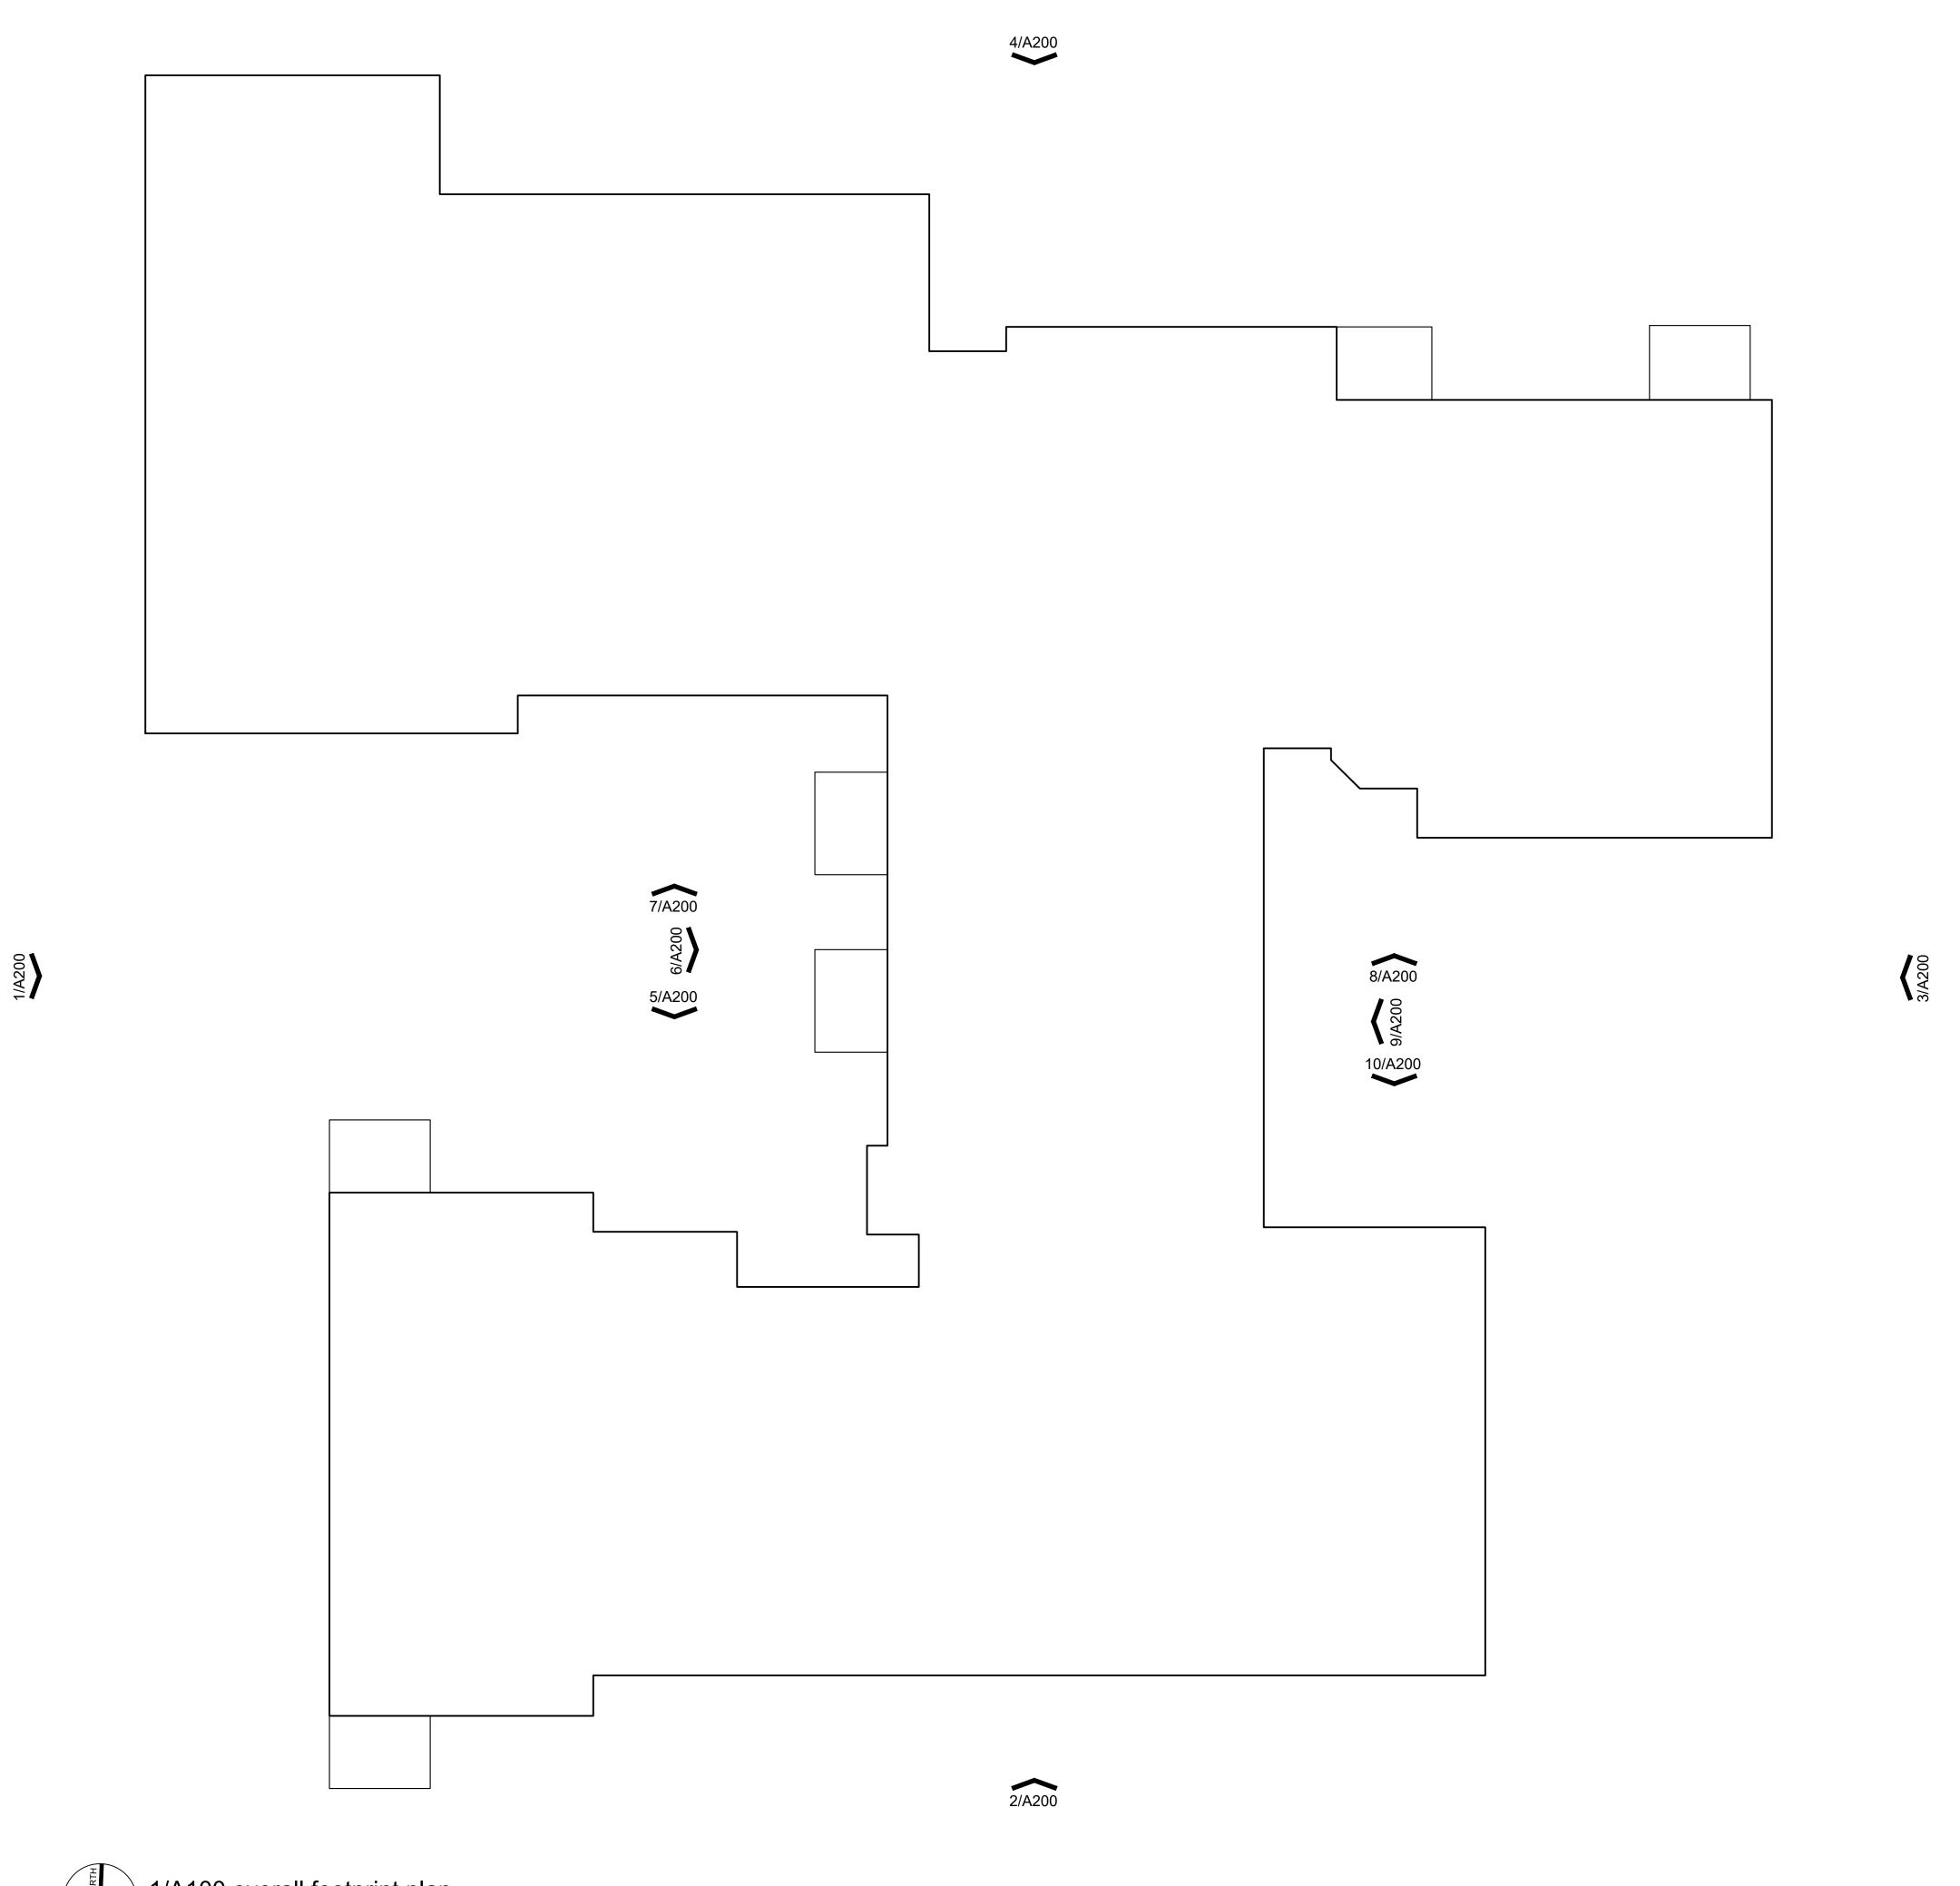

Bmk DESIGN+PLANNING LLC

Bmk DESIGN+PLANNING

DESIGN+PLANNING

O 9 8

Bmk DESIGN + PLANNING, LLC 54048 Mound Road - Shelby Township - Michigan - 48316 Ph 248.303.1446

ECT:

Window Replacement Alterations 761 Whimore Road Detroit, MI 48203

RCI-761 Whitmore, LLC

10 E. Main Street Suite 201 Bridgeport, CT 06608

HDC PROJECT REVIEW-REV
02/22/2023
HDC PROJECT REVIEW
10/10/2022
DESCRIPTION
DATE

SHEET TITLE:

SHEET TITLE:

OVERALL FOOTPRINT PLAN

PROJECT NUMBER: 2020-122

DRAWN BY:


SHEET NUMBER:

CHECKED BY:

A100

Permit No.:

SCALE: 1/8" = 1'-0"

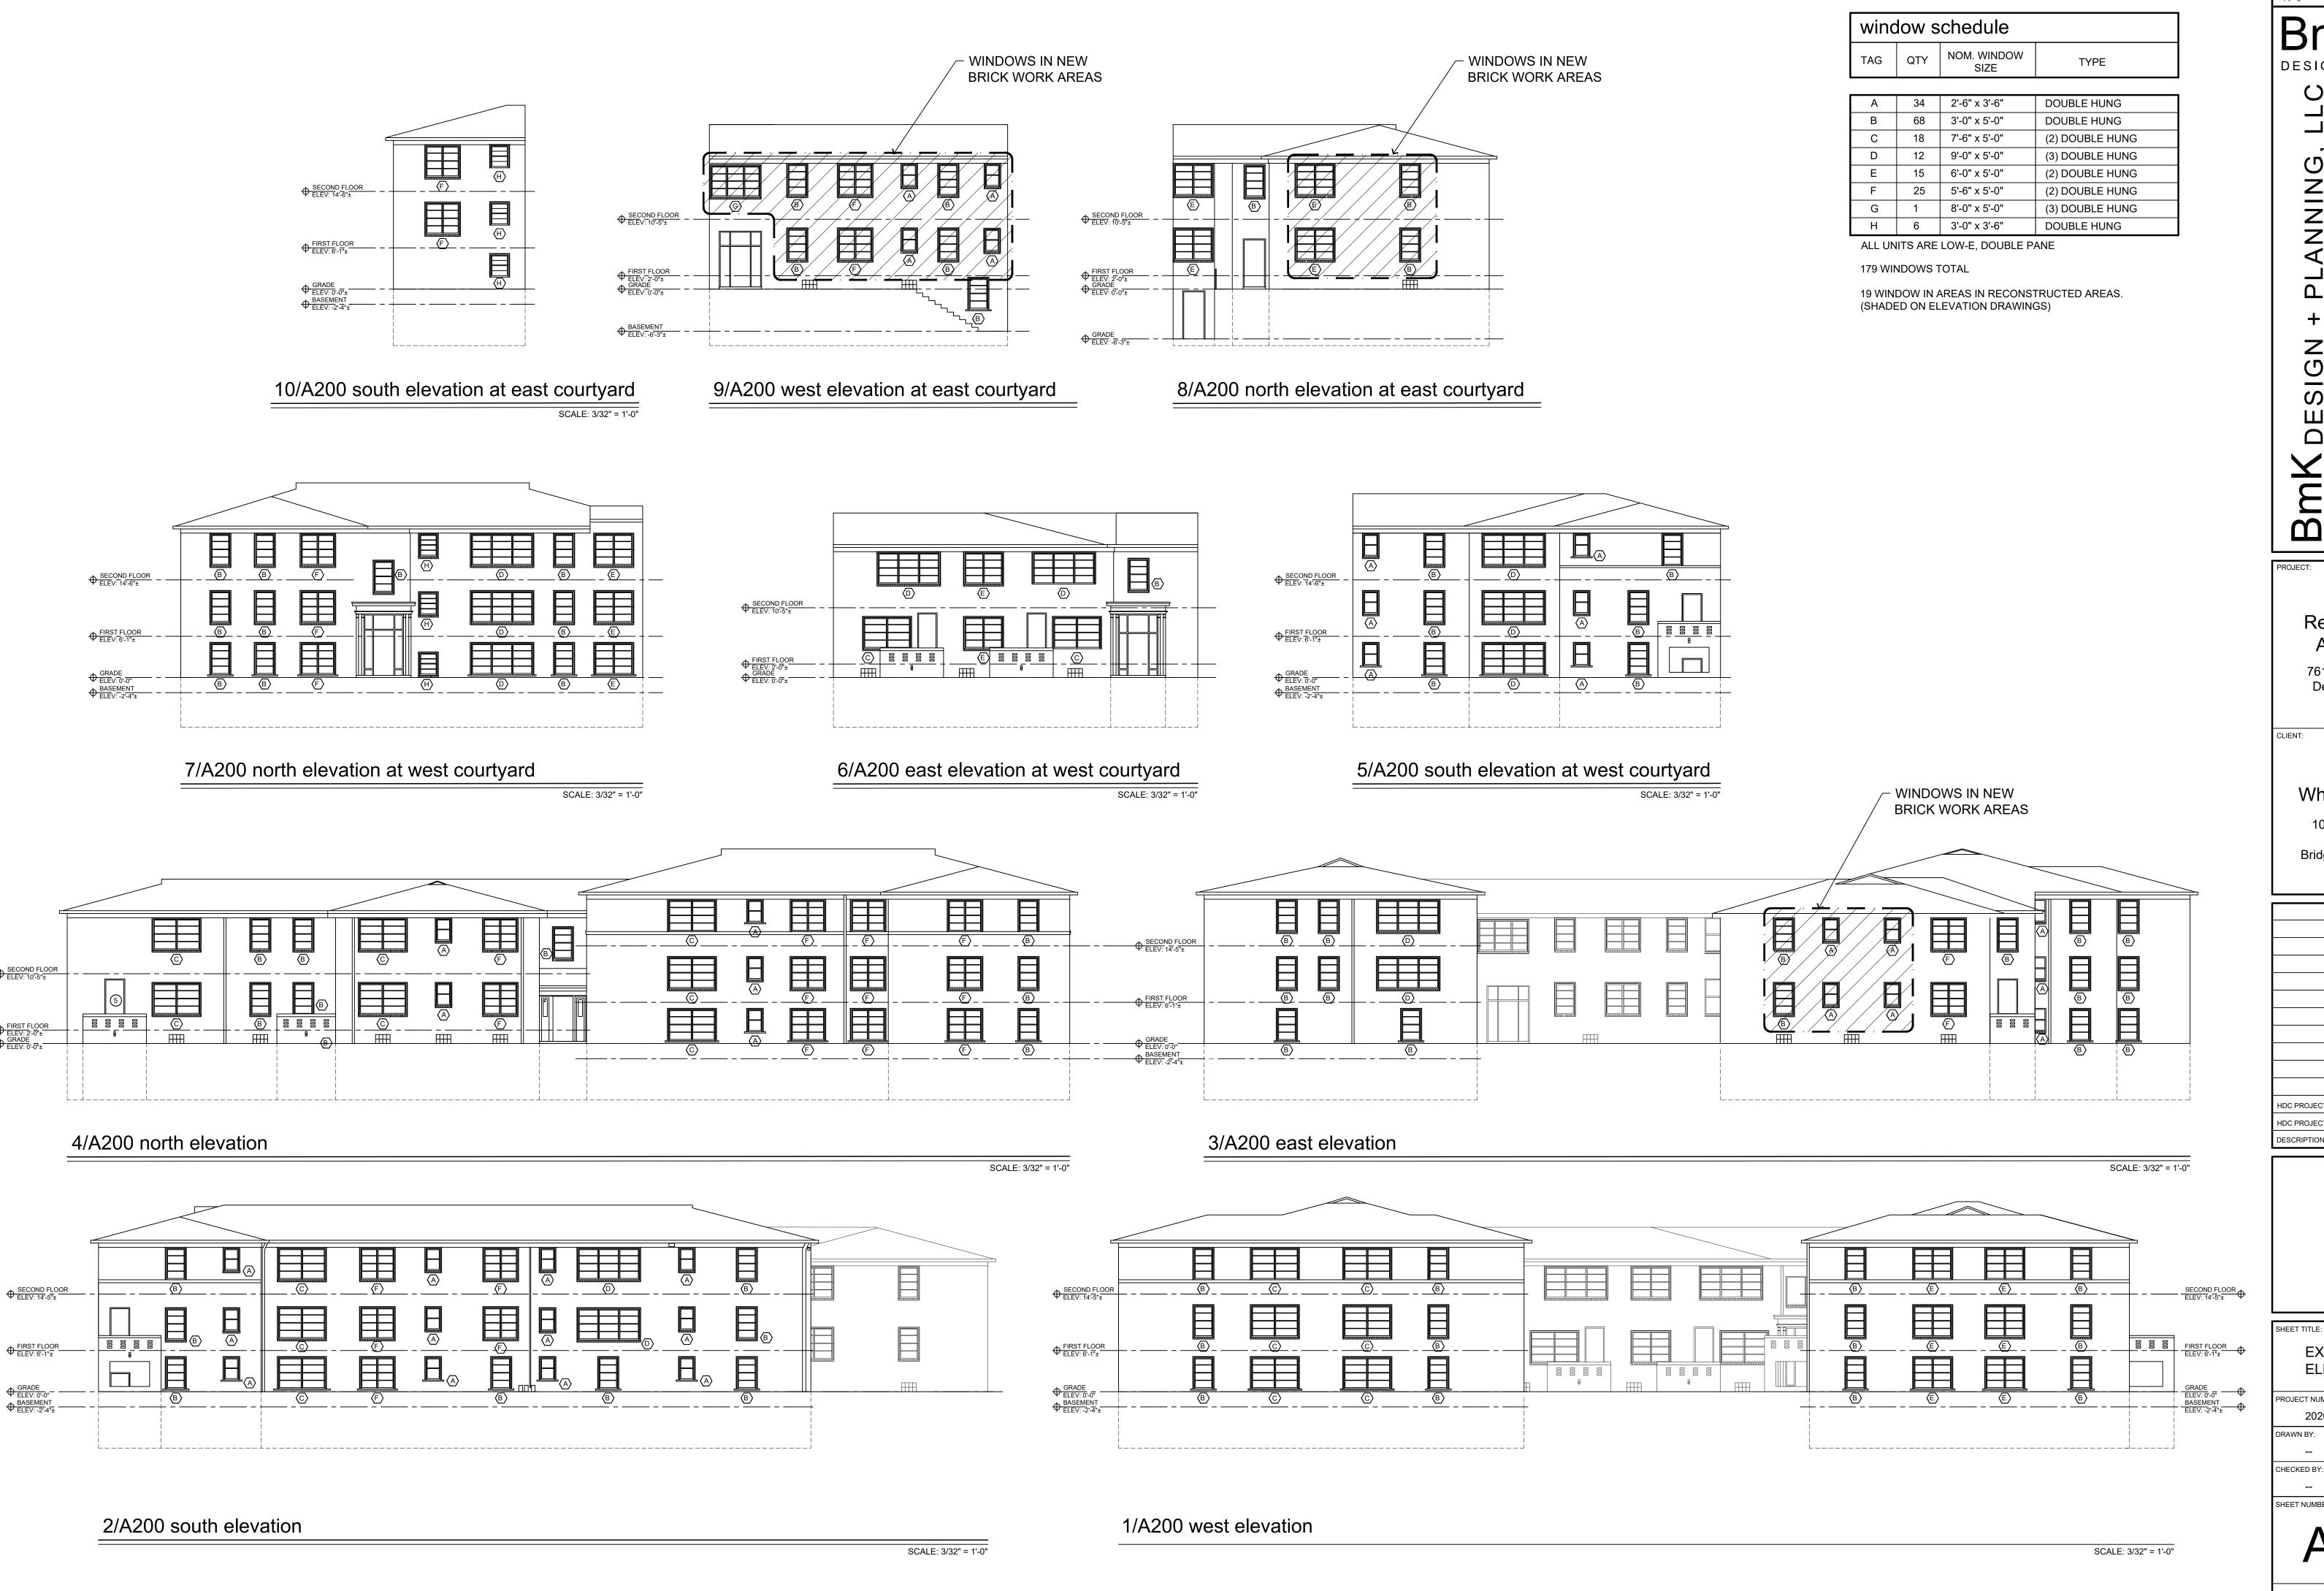

K DESIGN + PLANNING, LLC SIGN + PLANNING, LLC SIGN

Window Replacement Alterations

761 Whimore Road Detroit, MI 48203

RCI-761

Whitmore, LLC

10 E. Main Street
Suite 201
Bridgeport, CT 06608

HDC PROJECT REVIEW-REV
02/22/2023
HDC PROJECT REVIEW
10/10/2022
DESCRIPTION
DATE

SHEET TITLE:

EXTERIOR

ELEVATIONS


EXTERIOR ELEVATIONS

PROJECT NUMBER:
2020-122

DRAWN BY:
-CHECKED BY:

A200

Permit No.:

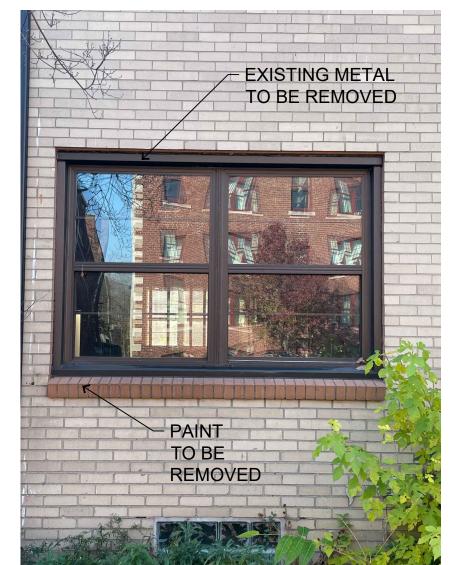

current window condition (typical for 160 windows)



(typical for 19 windows) NO BRICK MOULDS REQUIRED

- ALL CAULKING

(TYPICAL)

PAINT TO BE REMOVED



window with metal removed (bottom right view)

NOTE:

ALL WINDOWS WILL BE

**INSPECTED AND READJUSTED** 

WITHIN THE WINDOW FRAME.



- APPLY 7/8" WIDE MUNTIN

COLOR TO MATCH WINDOW

window with metal removed - PAINT TO BE REMOVED (bottom stool view)



window with metal removed (top head view)

INSTALL


1"x1/2" FLAT

STOCK


MATCH

WINDOW


SCRAPE & REPAIR EXISTING. REPAIR
OR REPLACE AS
NEEDED. PAINT TO MATCH WINDOW COLOR

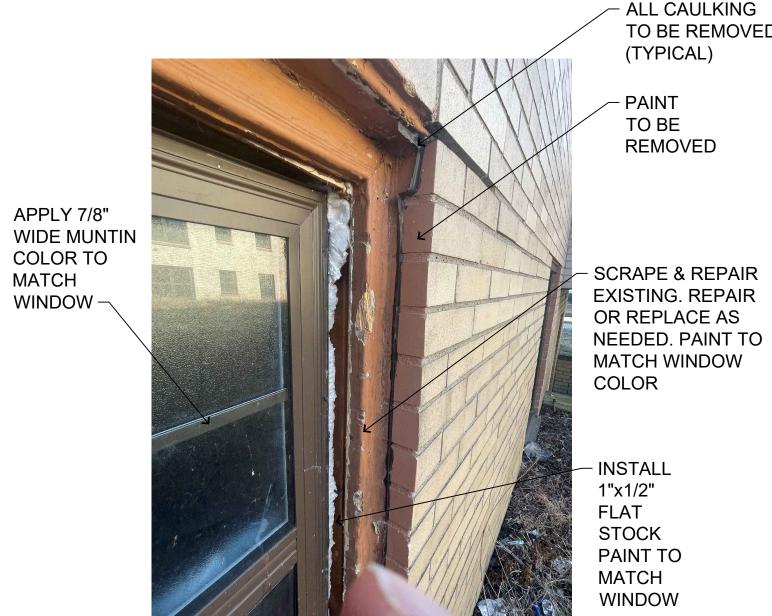

window with metal removed (top right view)

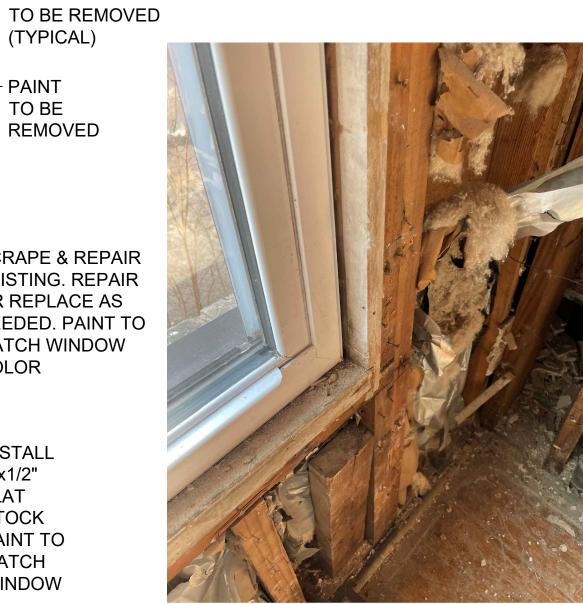

window interior view

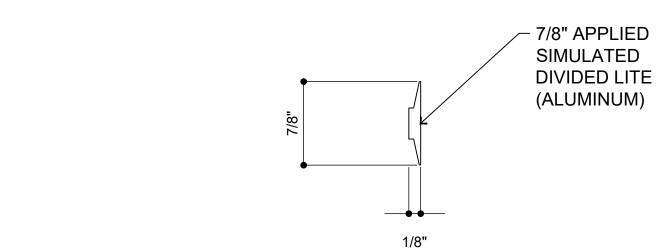



HORIZONTAL MUNTIN PROFILE **COLOR: EARTHTONE** TO MATCH INSTALLED WINDOW COLOR





NEW PAINT / MUNTIN **COLOR: EARTHTONE** TO MATCH INSTALLED WINDOW COLOR


## 2/A700 photo documentation of windows

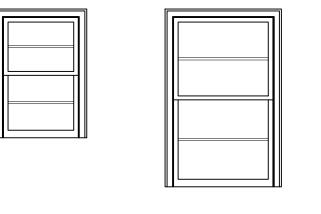


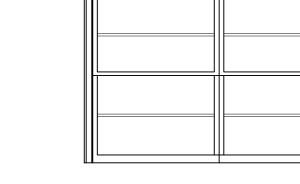


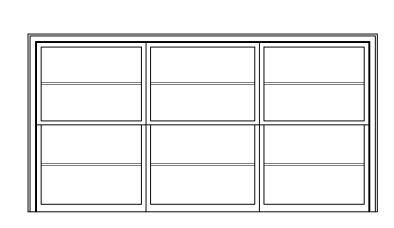

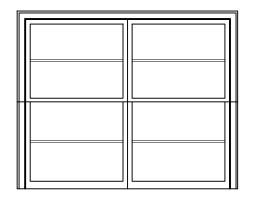

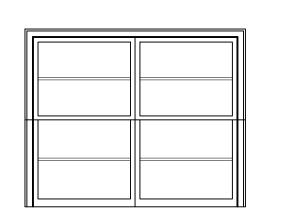

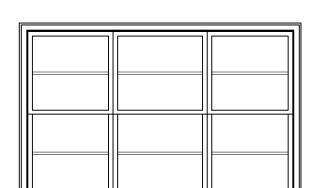

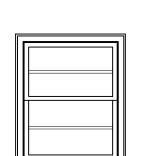


 $\langle A \rangle$ 










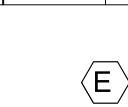



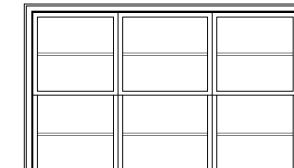



 $\langle H \rangle$ 

pyright 2023 - BmK DESIGN+PLANNING LL DESIGN+PLANNING

LLC 48316 dp.com

PLANNING, SIGN -DE Road 446 BmK


Window Replacement **Alterations** 

761 Whimore Road Detroit, MI 48203

**RCI-761** Whitmore, LLC

10 E. Main Street Suite 201 Bridgeport, CT 06608

HDC PROJECT REVIEW-REV	02/22/20
HDC PROJECT REVIEW	10/10/20
DESCRIPTION	DATE

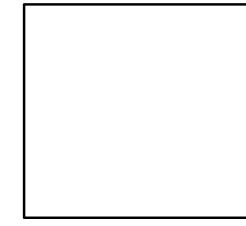

SHEET TITLE:
PROJECT NUMBER:
2020-122
DRAWN BY:

CHECKED BY:

Permit No.: