

2020 ANCHOR CONSTRUCTION DRAWINGS

SITE NAME:

SWEETEST HEART OF MARY

SITE NUMBER:

DE04229B

STREET ADDRESS:

4440 E. CANFIELD D/B/A 4440 RUSSELL ST.

DETROIT, MICHIGAN 48207

FROM T-MOBILE OFFICE HEAD NORTH ON MERRIMAN ROAD TO I-96; TURN EAST ON I-96 AND CONTINUE TO I-75; TURN SOUTH ON I-75 AND PROCEED TO WARREN AVENUE; TURN EAST ON WARREN AVENUE AND CONTINUE TO RUSSELL STREET; TURN SOUTH ON RUSSELL STREET AND PROCEED TO CANFIELD STREET: SITE IS LOCATED AT THE NORTHEAST CORNER OF RUSSELL STREET AND CANFIELD STREET.

DRIVING DIRECTIONS



FAA INFORMATION

ADDLICANT/LESSEE



UTILITY NOTICE

TITLE

LOCATION MAP

Know what's **below**. **Call** before you dig.

AFFLICANI	/LLOOLL
NAME:	T-MOBILE
ADDRESS:	28505 SCHOOLCRAFT ROAD, BLDG #
	LIVONIA, MI 48150
CONTACT:	KEN KALOUSEK
PHONE:	(734) 444-0181
PHONE:	(734) 444-0181

PROPERTY INFORMATION CATHOLIC ARCHDIOCESE OF DETROIT 12 STATE STREET

LATITUDE:

LONGITUDE:

AREA OF CONSTRUCTION: 165 SQ. FT PRESENT OCCUPANCY TYPE: ASSEMBLY PROPOSED OCCUPANCY TYPE: ASSEMBLY

CURRENT ZONING:

PARCEL NUMBER: WARD 7 ITFM 001241

HANDICAP REQUIREMENTS:

FACILITY IS UNMANNED AND NOT FOR HUMAN HARITATION HANDICAPPED

CIVIL ENGINEER & SURVEYOR:

LANDTECH PROFESSIONAL SURVEYING & ENGINEERING NAME 1275 McGREGOR WAY GRAWN, MI 49637

MATTHEW MOKANYK, P.S., P.E. (231) 943-0050 CONTACT

PROJECT SUMMARY

THESE DRAWINGS ARE PREPARED BASED ON RFDS DATED: 06/03/20

GENERAL CONTRACTOR TO CHECK WITH CONSTRUCTION TO VERIFY THAT THE RFDS IS CORRECT.

RFDS DESIGN

OPERATIONS		
RF ENGINEER		
ZONING ADMINISTRATOR		
CONSTRUCTION MANAGER		
POWER APPROVAL		
FIBER/AAV APPROVAL		
T-MOE	BILE APPROVALS	

THE UTILITIES SHOWN ON THESE DRAWINGS ARE FOR THE

ASSUMES NO RESPONSIBILITY FOR THE LOCATIONS OF THE

UTILITIES. THE CONTRACTOR SHALL BE RESPONSIBLE FOR

DAMAGE MADE TO EXISTING UTILITIES BY THE CONTRACTOR

SHALL BE THE SOLE RESPONSIBILITY OF THE CONTRACTOR.

CONVENIENCE OF THE CONTRACTOR ONLY. OTHER UTILITIES

VERIFYING ALL UTILITIES WITHIN THE LIMITS OF THE WORK. ALL

THIS SEAL CERTIFIES ONLY THE CIVIL ENGINEERING DESIGN AND RELATED DETAILS SHOWN ON THESE PLANS. THIS SEAL DOES

STRUCTURAL DESIGN, AND RELATED DETAILS INCLUDED IN THESE

NOT CERTIFY ANY ARCHITECTURAL, ELECTRICAL, MECHANICAL

THAT ARE NOT SHOWN MAY BE PRESENT AT THE SITE. LANDTECH

SIGNATURE	DATE

NO CHANGES CHANGES NEEDED SEE COMMENTS

LESSOR APPROVAL

PRINTED NAME

DESCRIPTION SHEET TITLE SHEET

SITE PLAN C-1 C-1.1 SITE PLAN

EQUIPMENT ROOM

C-2.1 FLOOR PLANS

C-3 **EXISTING ANTENNA PLAN**

PROPOSED ANTENNA PLAN

ELEVATION VIEW

PICTORIAL VIEWS PICTORIAL VIEWS

EQUIPMENT DETAILS

EQUIPMENT DETAILS C-6.1

C-6.2 ANTENNA DETAILS

MOUNTING DETAILS

PLATFORM STRUCTURAL PLAN

ANTENNA STRUCTURAL DETAIL SK-3 PLATFORM STRUCTURAL DETAIL

CONDUIT CABLE SCHEMATIC

CABLE DETAILS F-1 1 ELECTRIC DETAILS

F-12 **ONE-LINE DIAGRAM**

GROUNDING PLAN E-3

E-3.1 **GROUNDING DETAILS**

GROUNDING SCHEMATIC

HVAC DETAILS

HVAC GENERAL NOTES

EXHAUST FAN & LOUVER SCHEDULE M-1.2

GENERAL NOTES N-1

GENERAL NOTES

SHEET INDEX

ALL WORK AND MATERIALS SHALL BE PERFORMED AND INSTALLED IN ACCORDANCE WITH THE CURRENT EDITIONS OF THE FOLLOWING CODES AS ADOPTED BY THE LOCAL GOVERNING AUTHORITIES. NOTHING IN THESE PLANS IS TO BE CONSTRUED TO PERMIT WORK NOT CONFORMING TO THE LATEST EDITIONS OF THE FOLLOWING CODES:

7. 2015 MICHIGAN PLUMBING CODE

11. NFPA-101 LIFE SAFETY CODE

8. INTERNATIONAL FIRE CODE 9. 2015 MICHIGAN UNIFORM ENERGY CODE

10. MIOSHA RULES AND REGULATIONS

1. 2015 MICHIGAN BUILDING CODE

2. 2015 MICHIGAN MECHANICAL CODE 3. ANSI / TIA-222-H

. NATIONAL ELECTRIC CODE 2017

5. LOCAL BUILDING CODE

CITY OF DETROIT HAD ADOPTED MICHIGAN BUILDING CODE 2015 AND MICHIGAN REHABILITION, PL FOLLOW

USE GROUP:

CONSTRUCTION TYPE: 1A

CODE COMPLIANCE



LIVONIA, MICHIGAN 48150 Phone: 734.367.7200

Fax: 734.367.7242 CONTACT: KEN KALOUSEK

(734) 444-0181

LANDTECH PROJECT NUMBER 2039803 DATE DESCRIPTION 07/09/20 PRELIMINARY RELEASE ADD'D ANT. COVER NOTE RELOC PROP ANTENNAS 03/30/22

2020 ANCHOR CONSTRUCTION **DRAWINGS**

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SITE ADDRESS:


4440 E. CANFIELD D/B/A 4440 RUSSELL ST **DETROIT, MICHIGAN 48207**


Sheet Title:

TITLE SHEET

Sheet Number:

T-1

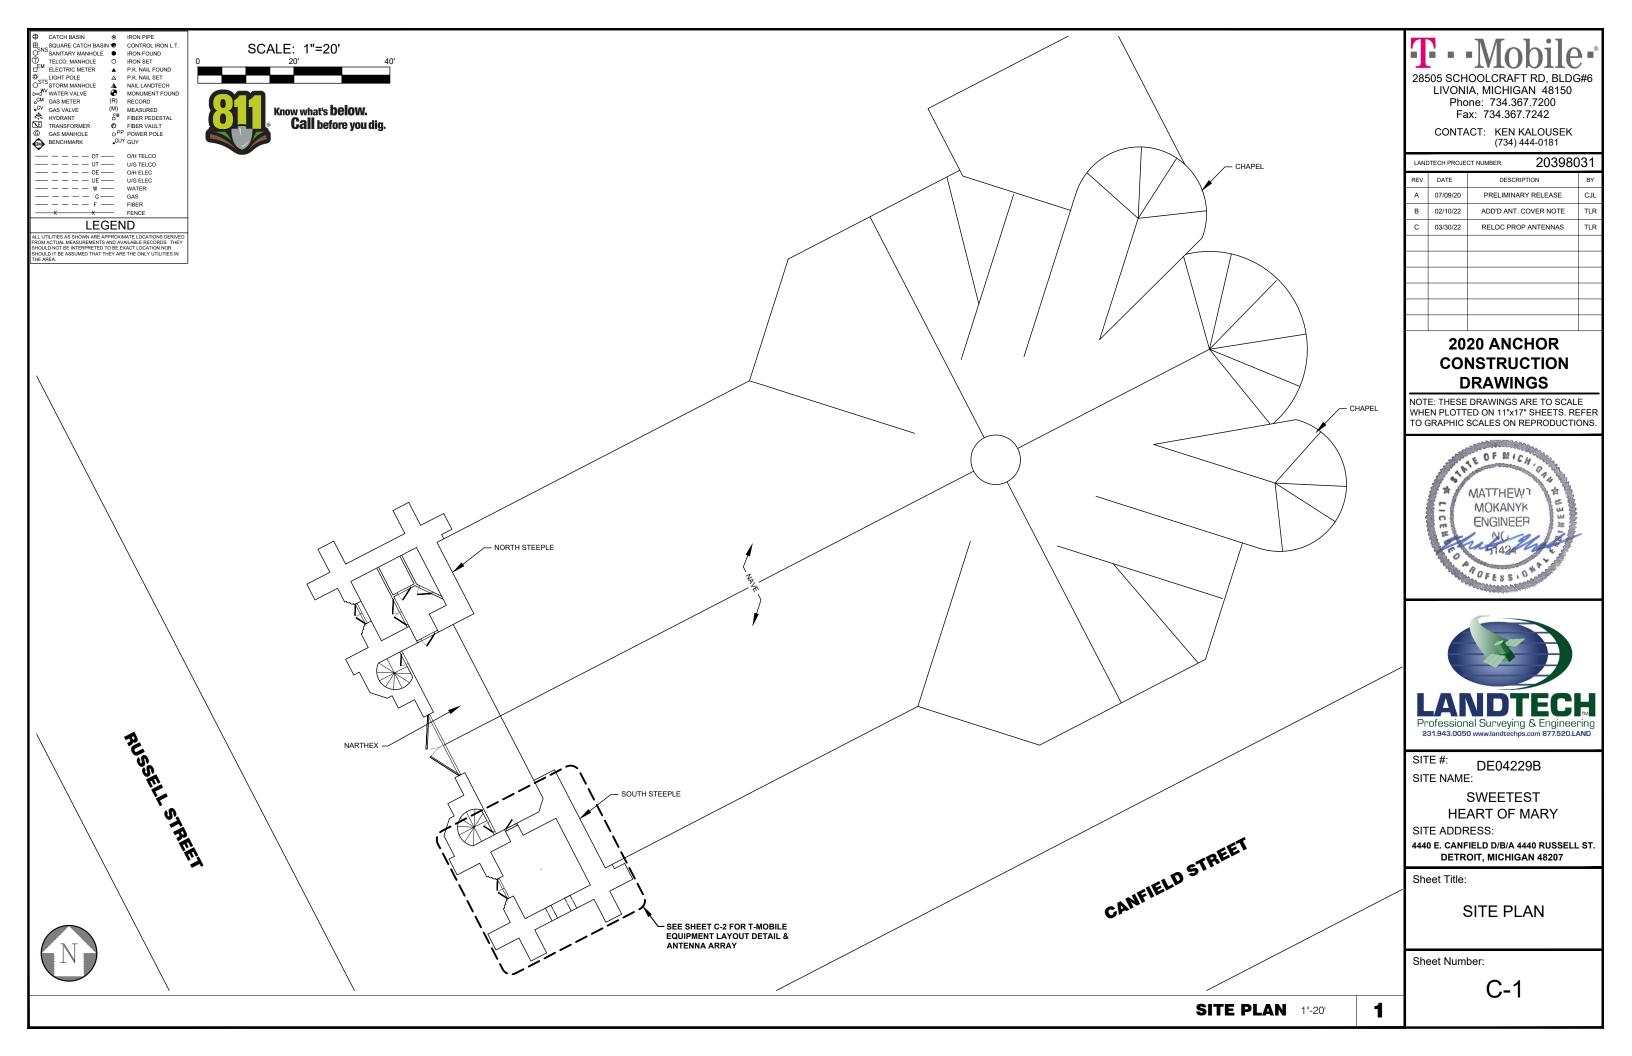

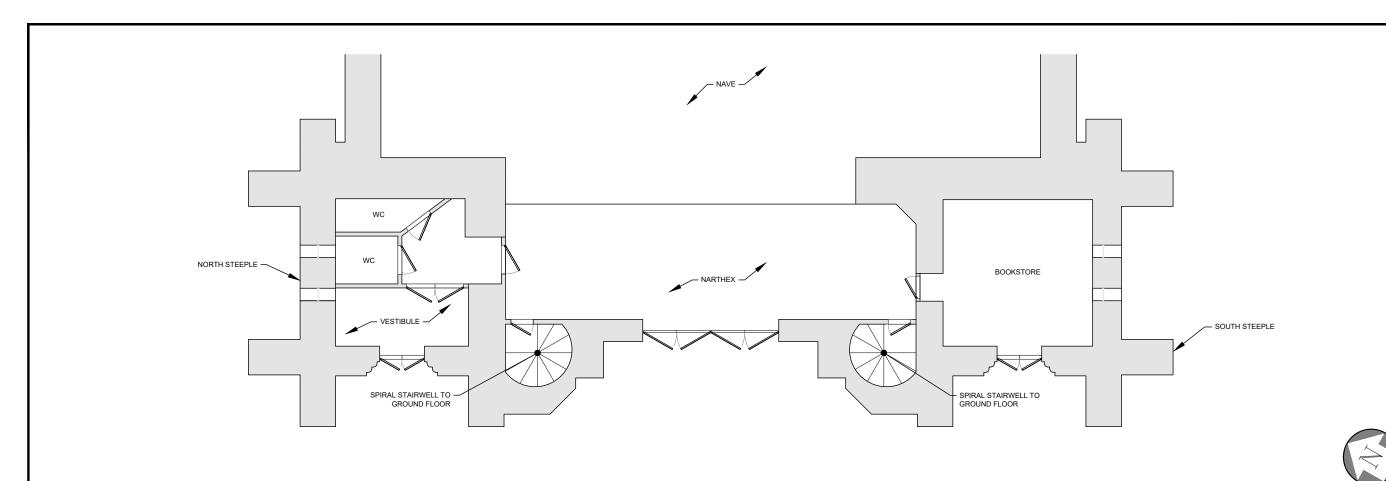

CATCH BASIN ●
SQUARE CATCH BASIN ●

SANITARY MANHOLE

LEGEND

TELCO. MANHOLE ELECTRIC METER

LIGHT POLE

STS LIGHT POLE
OSTS STORM MANHOLE
WWATER VALVE
GM GAS METER
GV GAS VALVE
HYDRANT
TRANSFORMER

IRON PIPE CONTROL IRON L.T.

IRON FOUND

P.K. NAIL FOUND

P.K. NAIL SET

MEASURED FIBER PEDESTA © FIBER VAULT OPP POWER POLE •GUY GUY

RECORD

O/H ELEC U/G ELEC WATER GAS FIBER

Know what's **below**.

Call before you dig.




LIVONIA, MICHIGAN 48150 Phone: 734.367.7200

Fax: 734.367.7242 CONTACT: KEN KALOUSEK (734) 444-0181

LANE	TECH PROJE	CT NUMBER: 203	980	31
REV.	DATE	DESCRIPTION		BY
Α	07/09/20	PRELIMINARY RELEASE	Ξ	CJL
В	02/10/22	ADD'D ANT. COVER NOT	Έ	TLR
С	03/30/22	RELOC PROP ANTENNA	S	TLR

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GROUND FLOOR 1"=10'

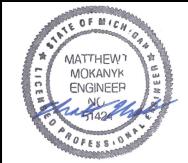

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4440 E. CANFIELD D/B/A 4440 RUSSELL ST. **DETROIT, MICHIGAN 48207**

Sheet Title:

SITE PLAN

Sheet Number:


SCALE: 1"=10'

- SEE SHEET C-2 FOR T-MOBILE

EQUIPMENT LAYOUT DETAIL & ANTENNA ARRAY


SECOND FLOOR LOFT AND STEEPLE PLAN 1"=10"


C-1.1

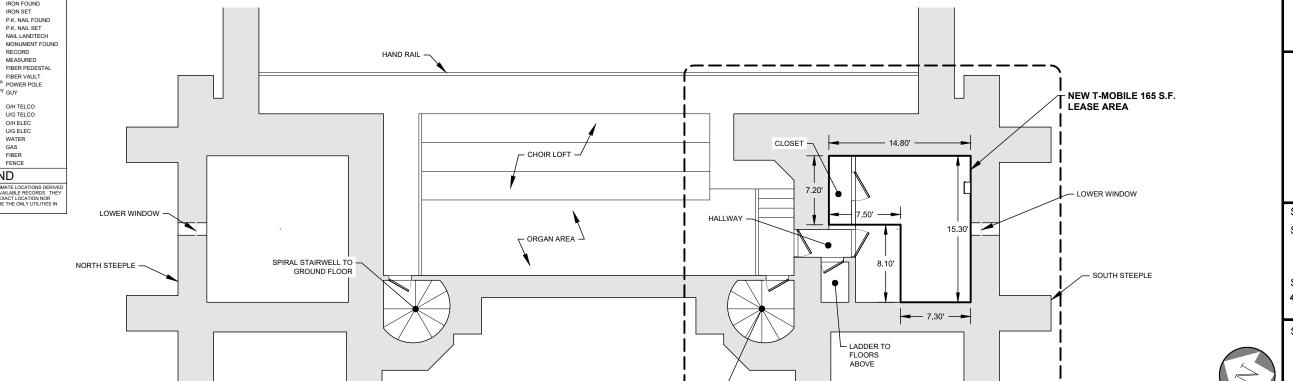


SPIRAL STAIRWELL TO —

GROUND FLOOR

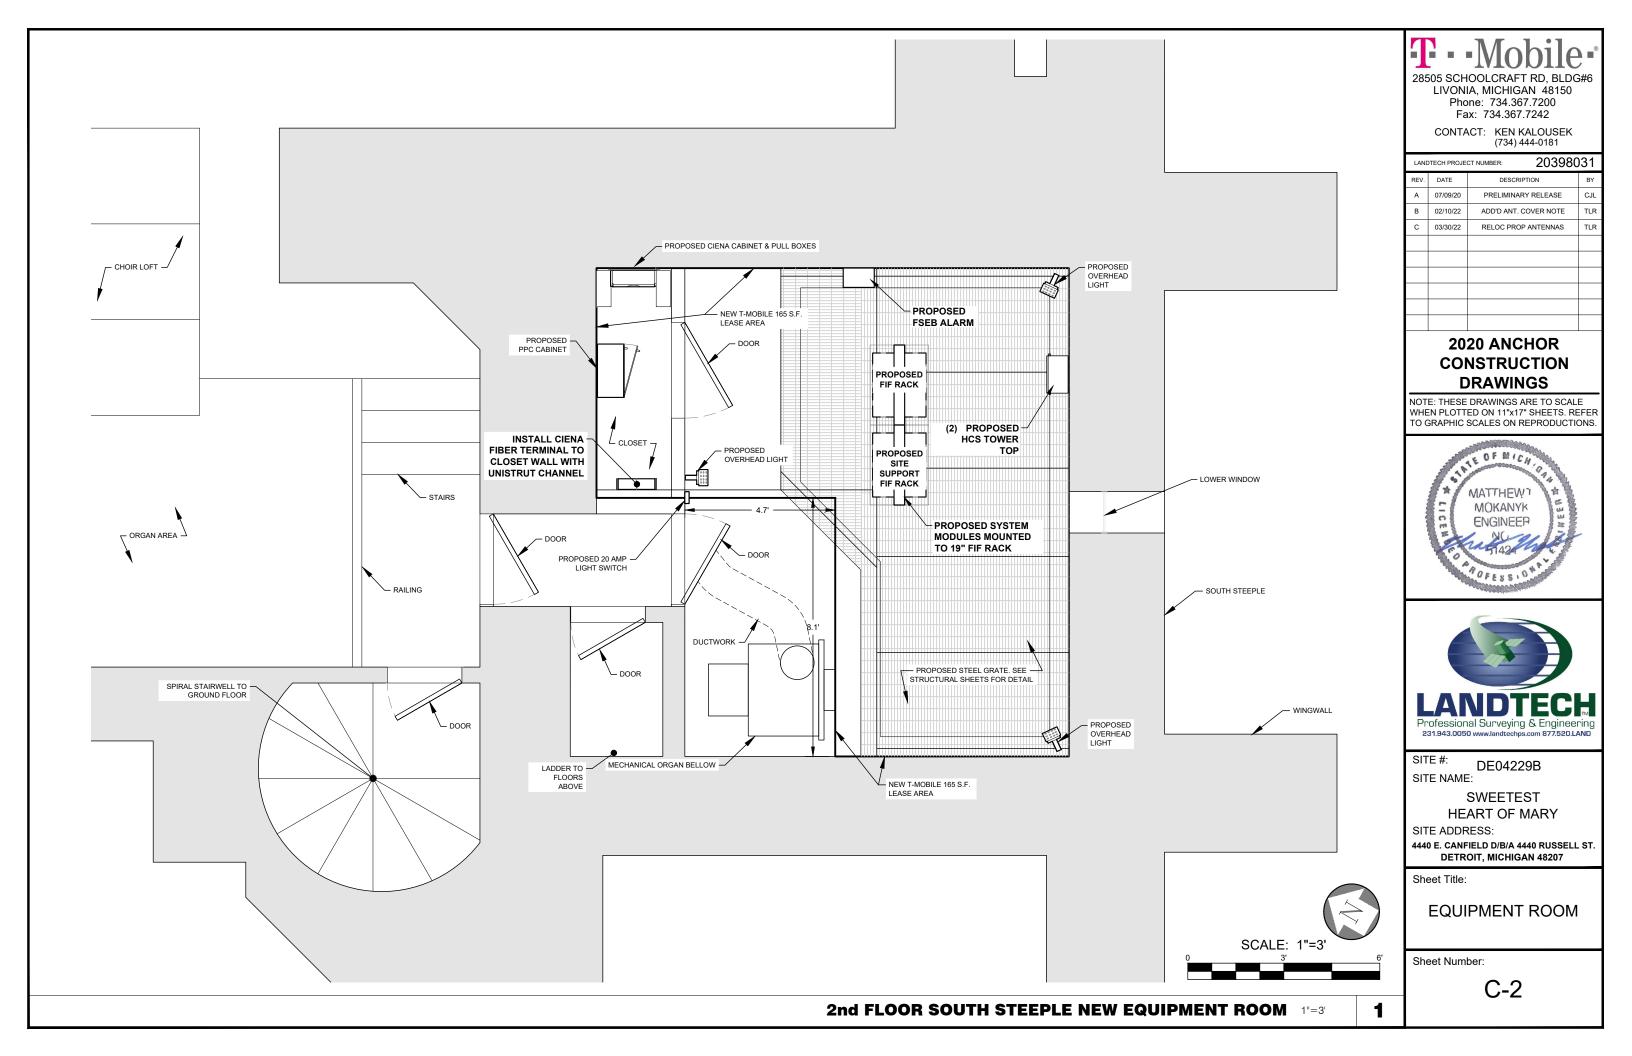

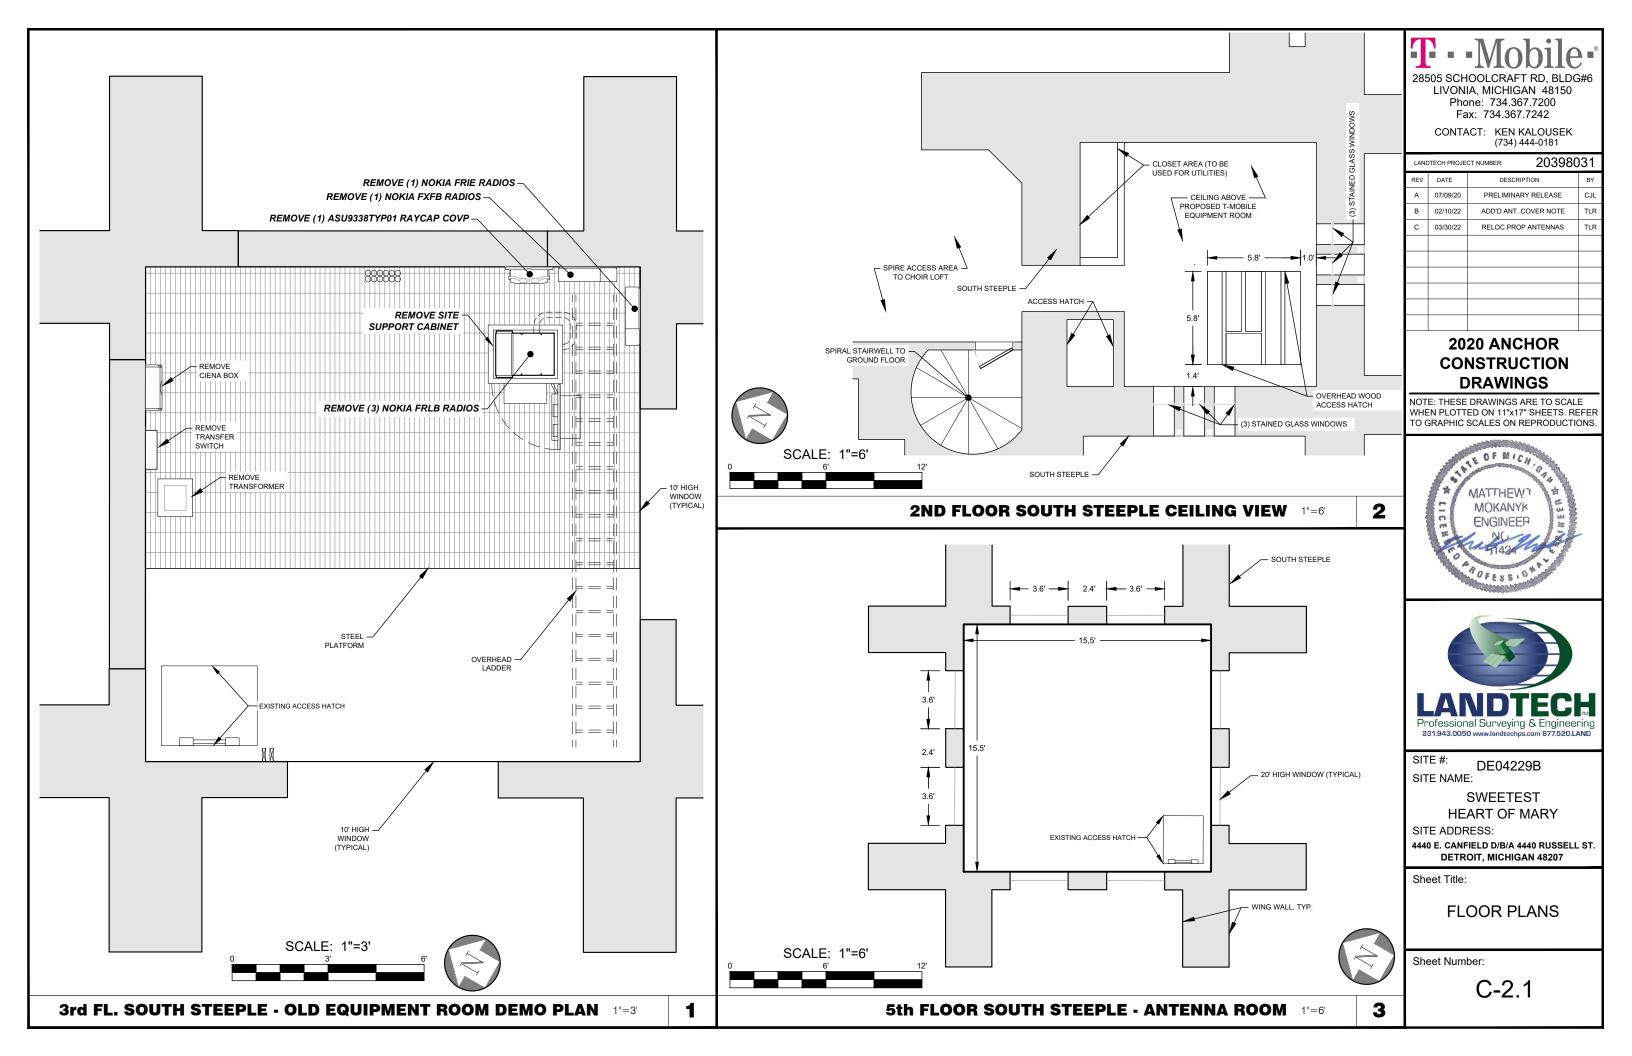

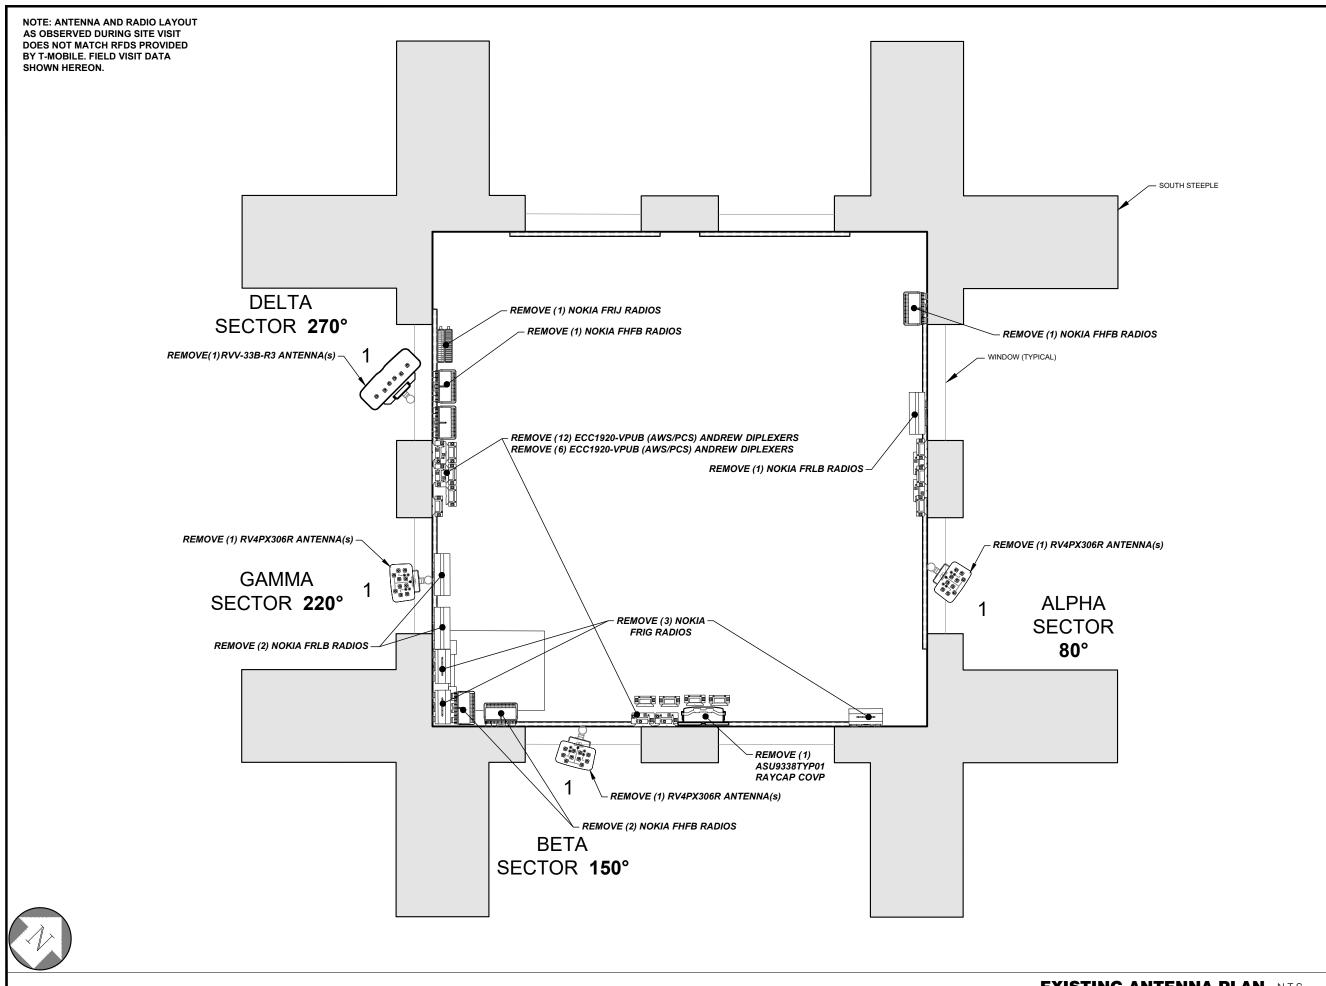

T - Mobile -

28505 SCHOOLCRAFT RD, BLDG LIVONIA, MICHIGAN 48150 Phone: 734.367.7200

Fax: 734.367.7242 CONTACT: KEN KALOUSEK (734) 444-0181

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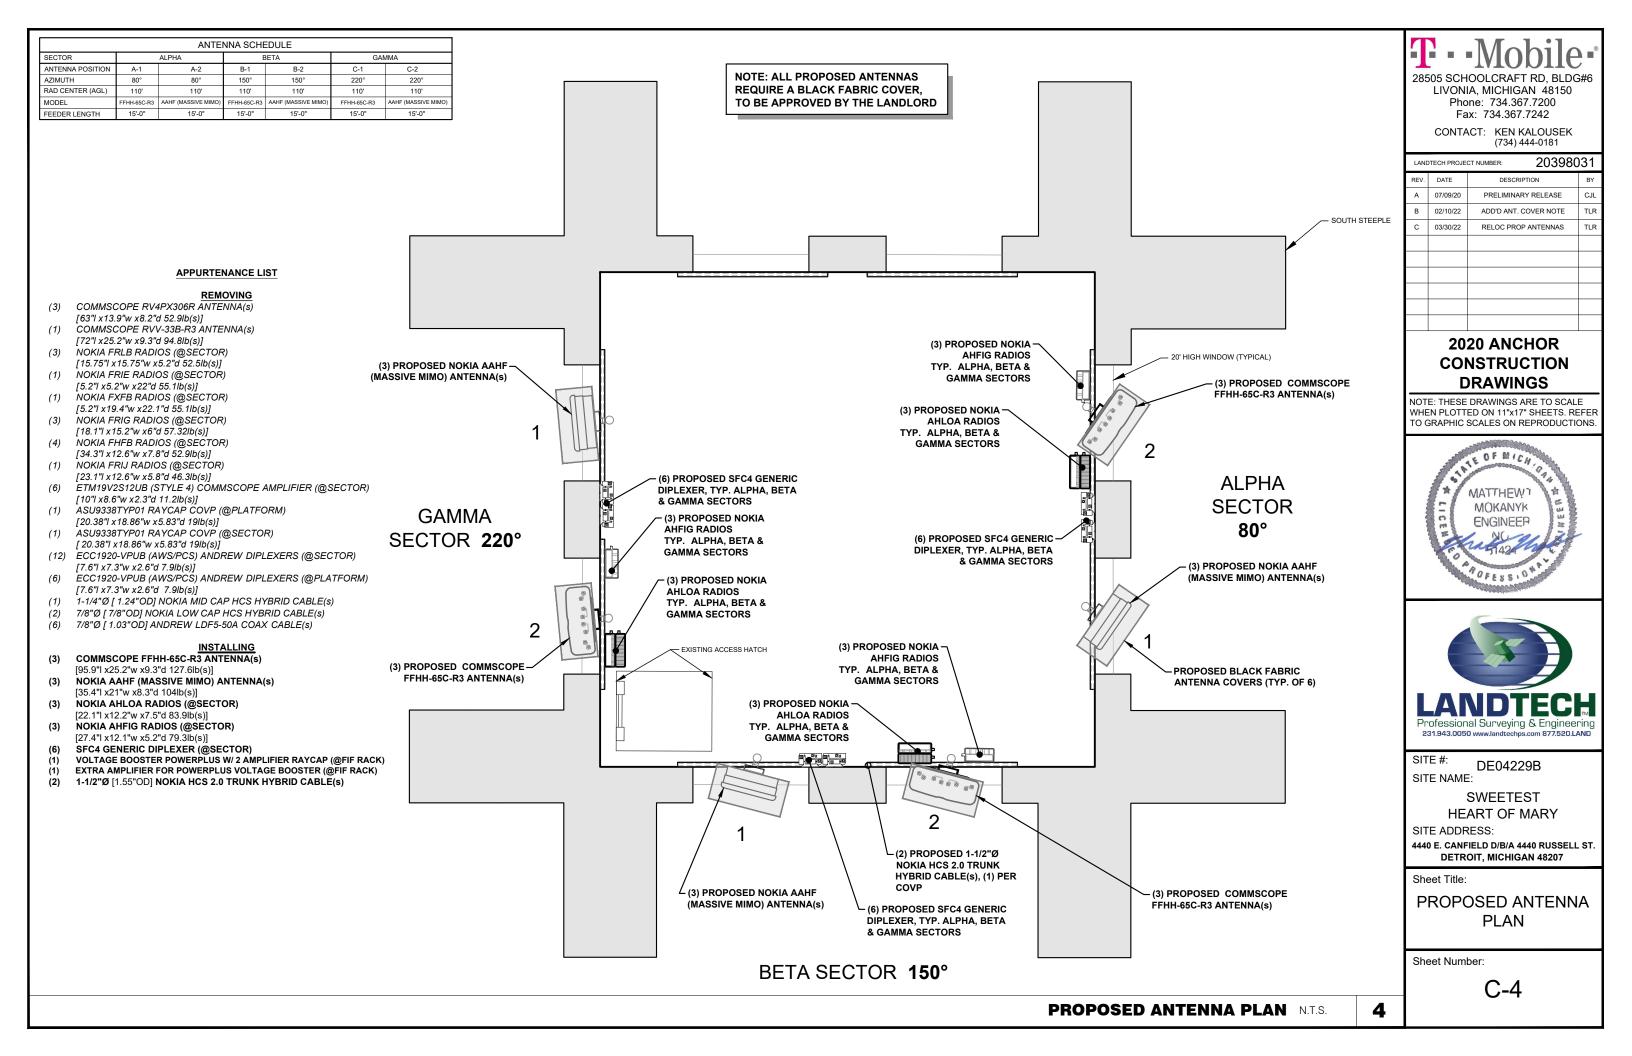
4440 E. CANFIELD D/B/A 4440 RUSSELL ST. DETROIT, MICHIGAN 48207


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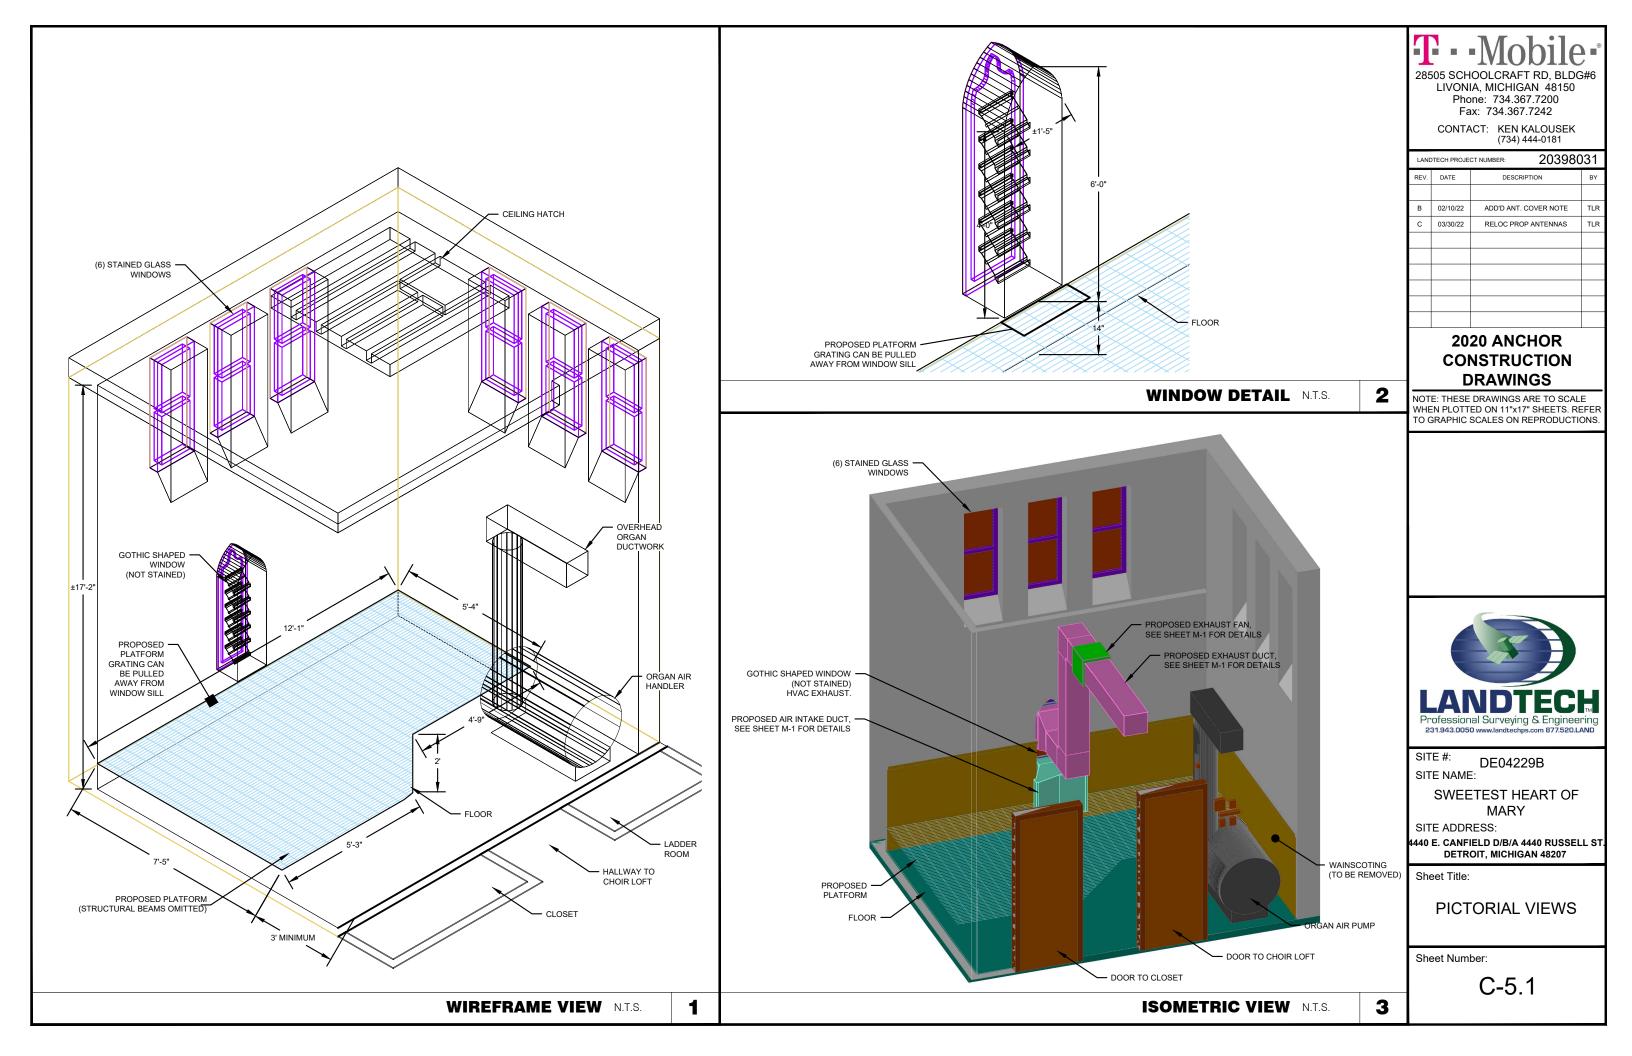
EXISTING ANTENNA PLAN


Sheet Number:

C-3







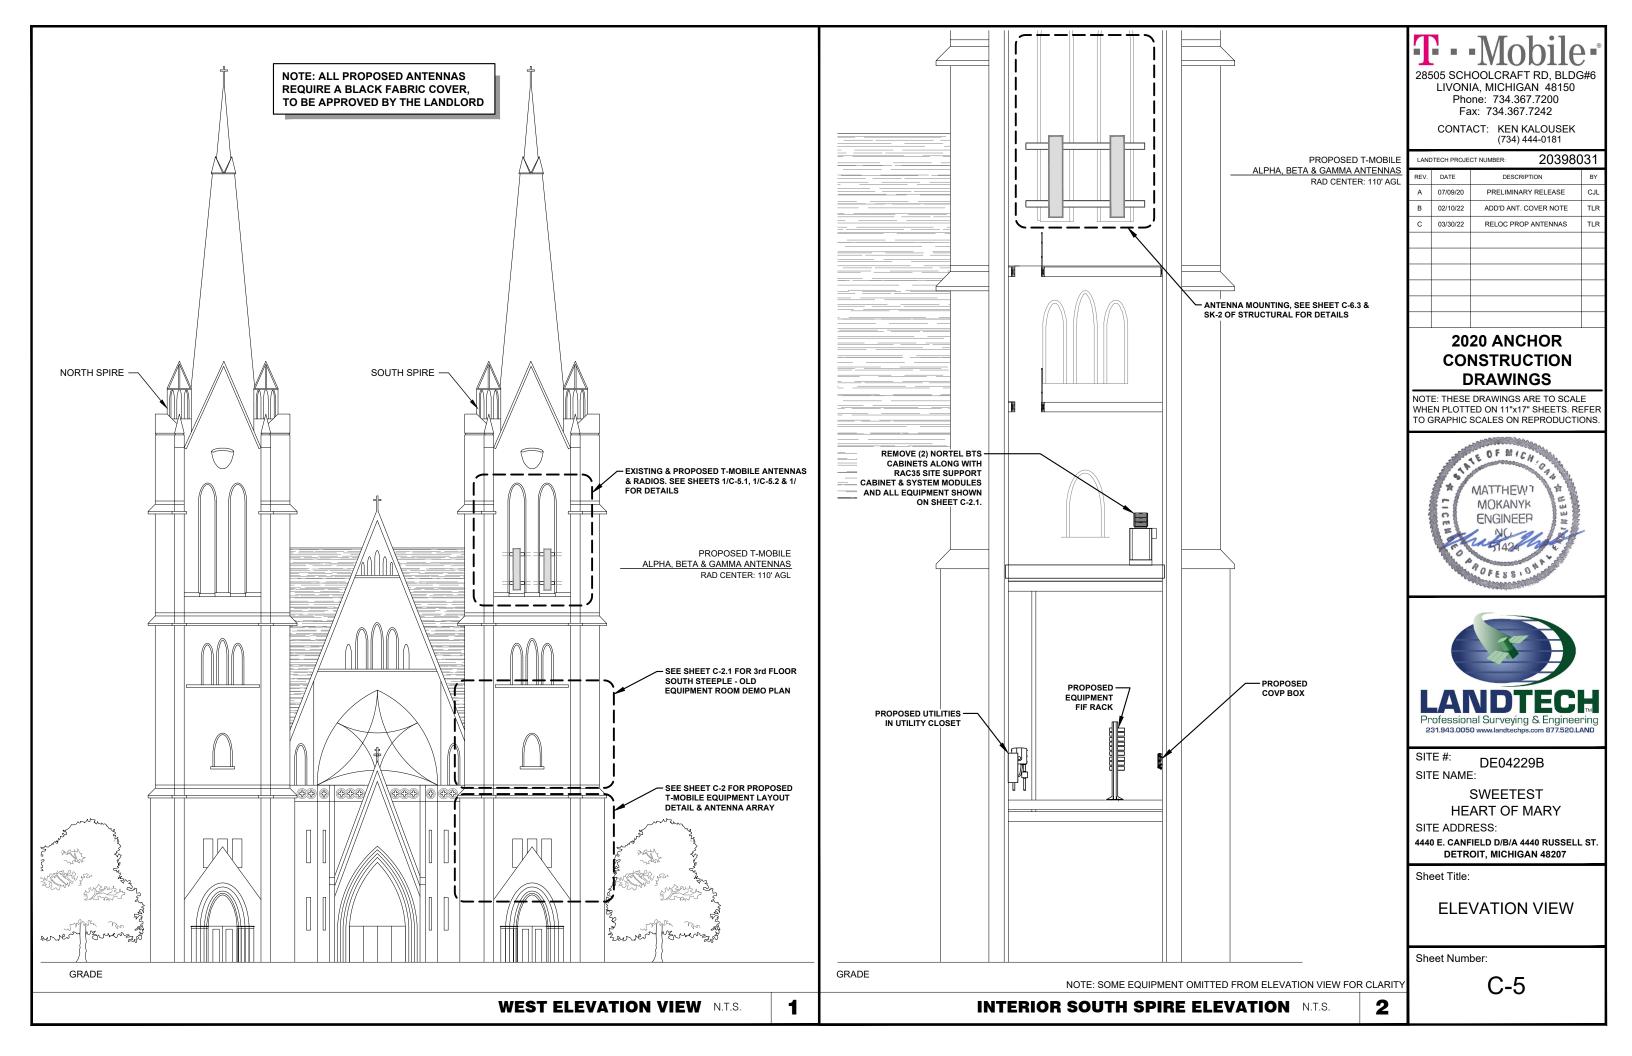

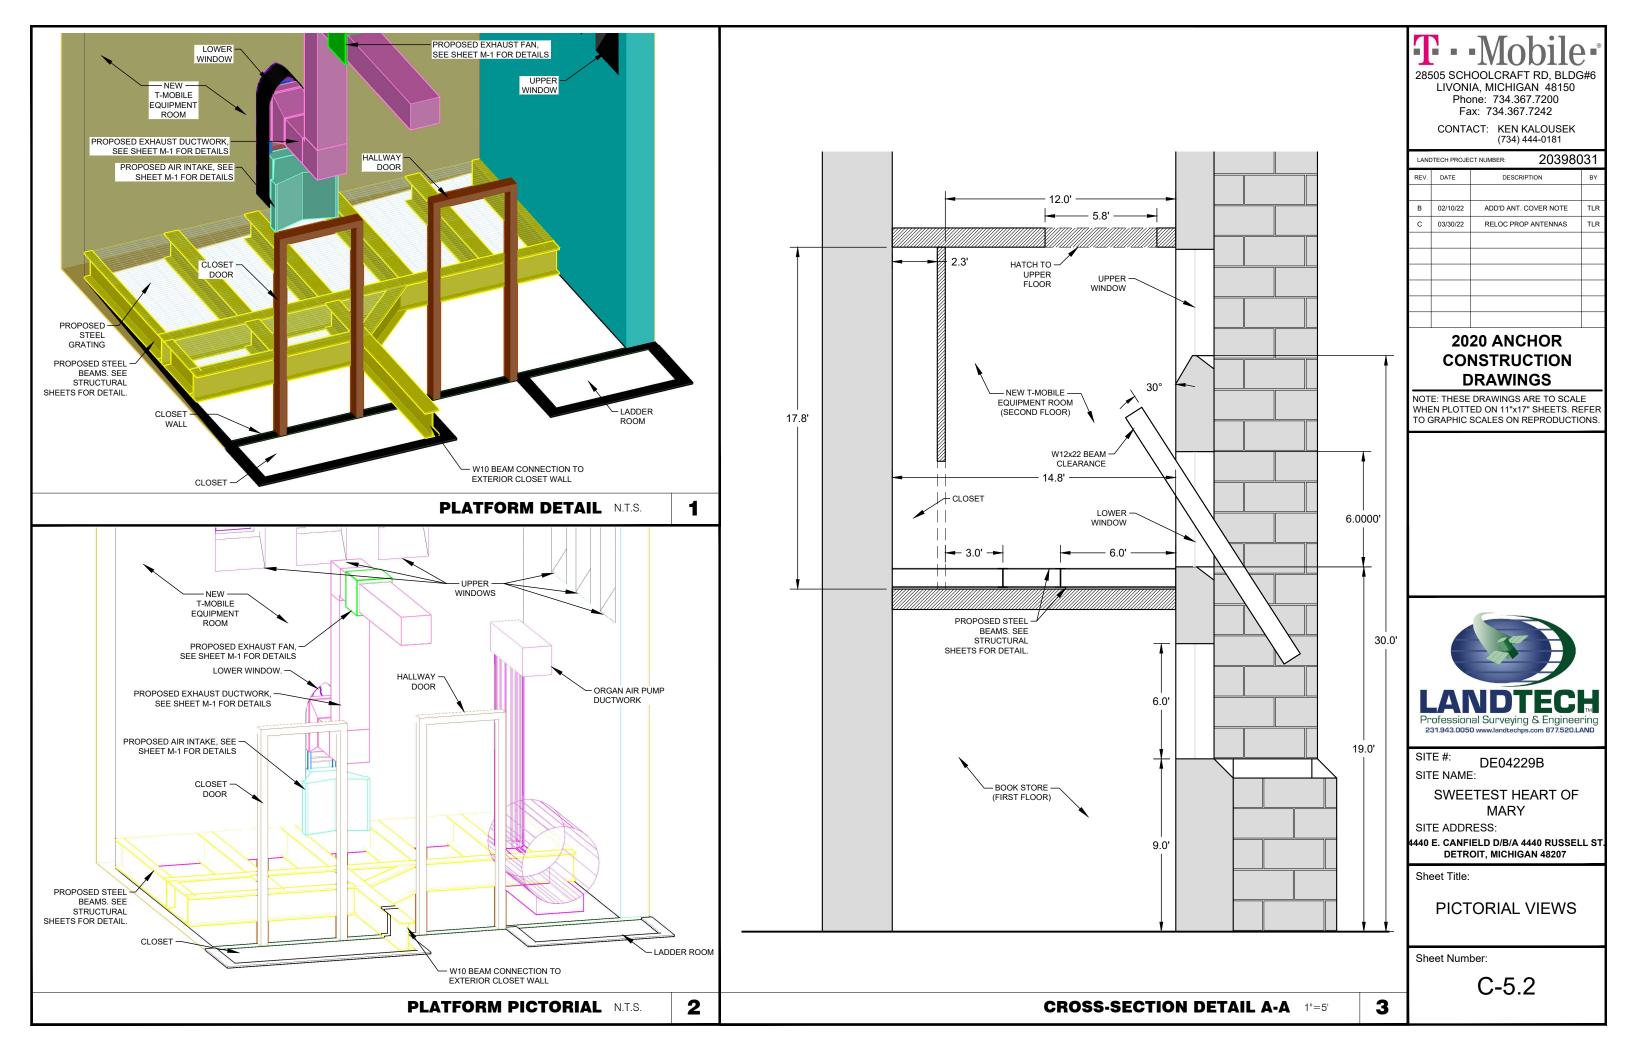

NOTE: GROUND ALL EQUIPMENT ON RACK TO RACK GROUND BAR PER MANUFACTURER'S REQUIREMENTS. MINIMUM 6 AWG SOLID TINNED CU

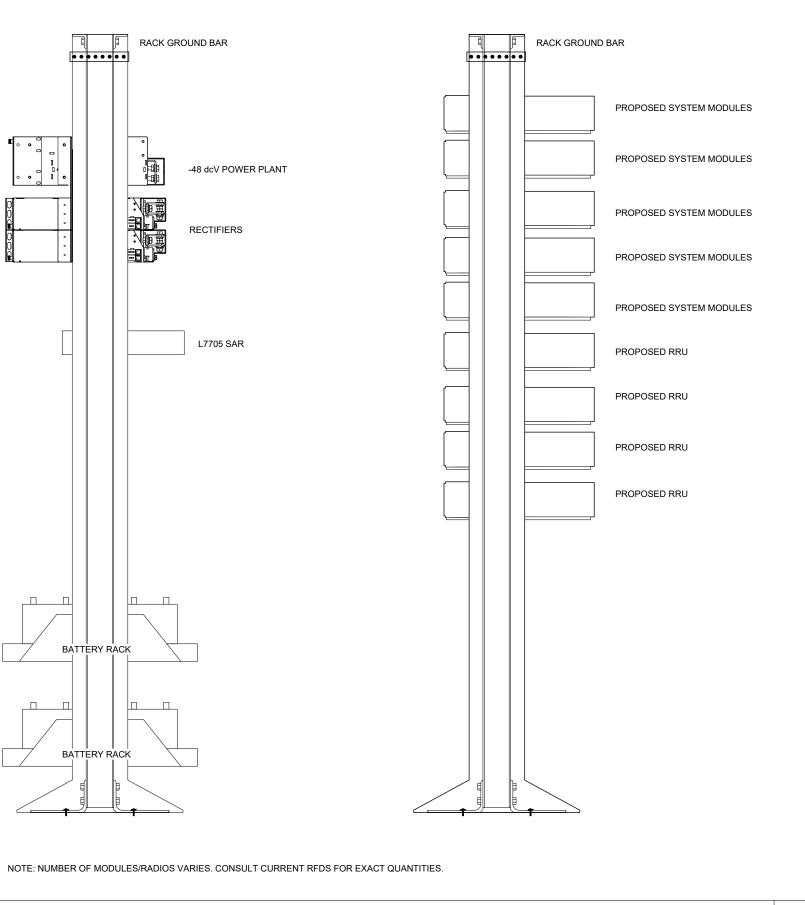

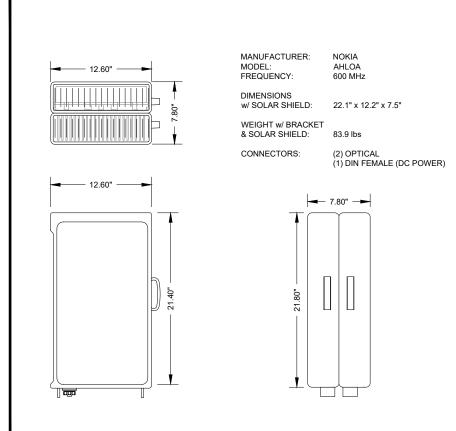

T · · Mobile ·

28505 SCHOOLCRAFT RD, BLDG# LIVONIA, MICHIGAN 48150 Phone: 734.367.7200 Fax: 734.367.7242

> CONTACT: KEN KALOUSEK (734) 444-0181

LANDTECH PROJECT NUMBER: 20398				
REV.	DATE	DESCRIPTION	BY	
Α	07/09/20	PRELIMINARY RELEASE	CJL	
В	02/10/22	ADD'D ANT. COVER NOTE	TLR	
С	03/30/22	RELOC PROP ANTENNAS	TLR	

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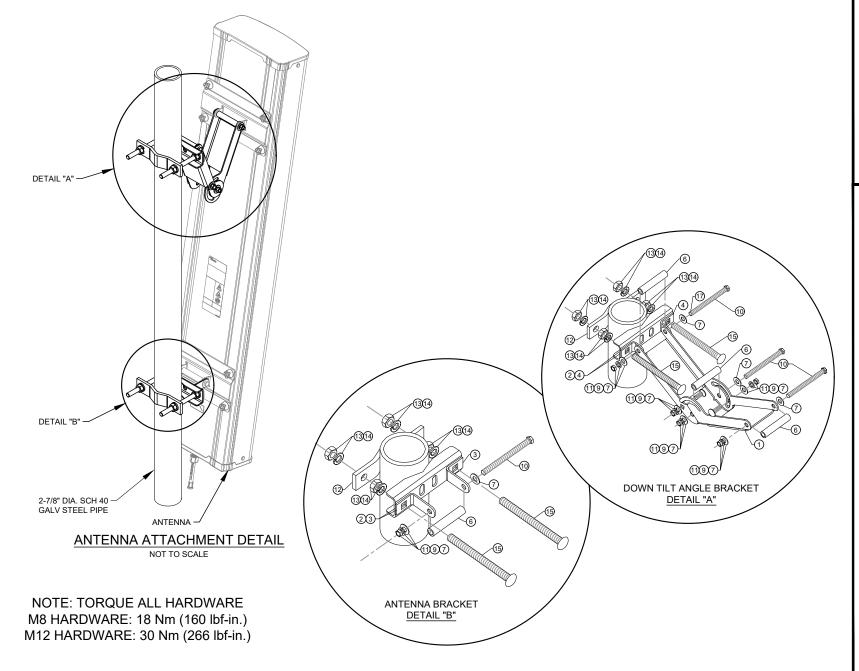
EQUIPMENT DETAILS


Sheet Number:

C-6

19" WIDE FIF RACK DETAIL N.T.S. 1 AHLOA RADIO UNIT N.T.S.

	PARTS LIST				
ITEM #	QUANTITY	PART NUMBER	DESCRIPTION		
1	2	601257	ANGLE ARM		
2	2	601256	MOUNTING CLAMP		
3	2	601235-1	BRACKET		
4	2	601235-2	BRACKET		
5	1	601258	LABEL, ANGLE		
6	4	600679-3	SPACER TUBE		
7	14	100525-24	ME FLAT WASHER (STAINLESS STEEL)		
8	2	600419-8	M8x1.25x25mm LARGE CARRIAGE BOLT (STAINLESS STEEL)		
9	6	6/1/7395	M8 LOCK WASHER (STAINLESS STEEL)		
10	4	600419-10	M8x1.25x110mm LARGE HEX HEAD SCREW (STAINLESS STEEL)		
11	6	204001-15	M8x1.25 HEX NUT (STAINLESS STEEL)		
12	2	225244	CLAMP PLATE		
13	8	600419-24	LARGE LOCK WASHER (STAINLESS STEEL)		
14	8	204001-21	M12x1.75 HEX NUT (STAINLESS STEEL)		
15	4	600419-12	M12x1.75x150mm LARGE CARRIAGE BOLT (STAINLESS STEEL)		
17	1	601584	MOLYBDENUM DISULFIDE GREASE		



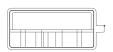


PLAN VIEW

MANUFACTURER: MODEL: BANDWITH: DIMENSIONS: WEIGHT: NO. OF PORTS: FIBER PORTS: RF CONNECTORS:

AHFIG 65 MHz & 80 MHz 79.3 lbs 4T4R


NOKIA

27.4" x 12.1" x 5.2" 2 X 9.8 Gbps CPRI 4.3-10+

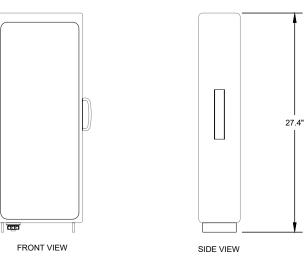

NOKIA AHFIG RADIO

NOT TO SCALE

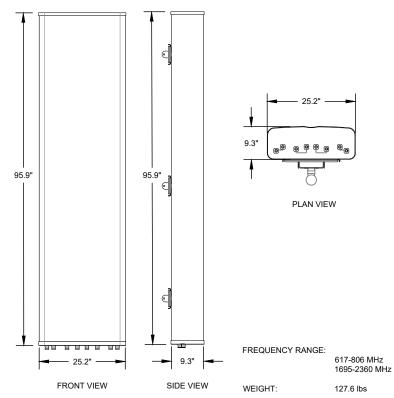

COMMSCOPE FFHH-65C-R3 ANTENNA

NOT TO SCALE

LIVONIA, MICHIGAN 48150 Phone: 734.367.7200 Fax: 734.367.7242

CONTACT: KEN KALOUSEK (734) 444-0181

LANDTECH PROJECT NUMBER:			203980)31
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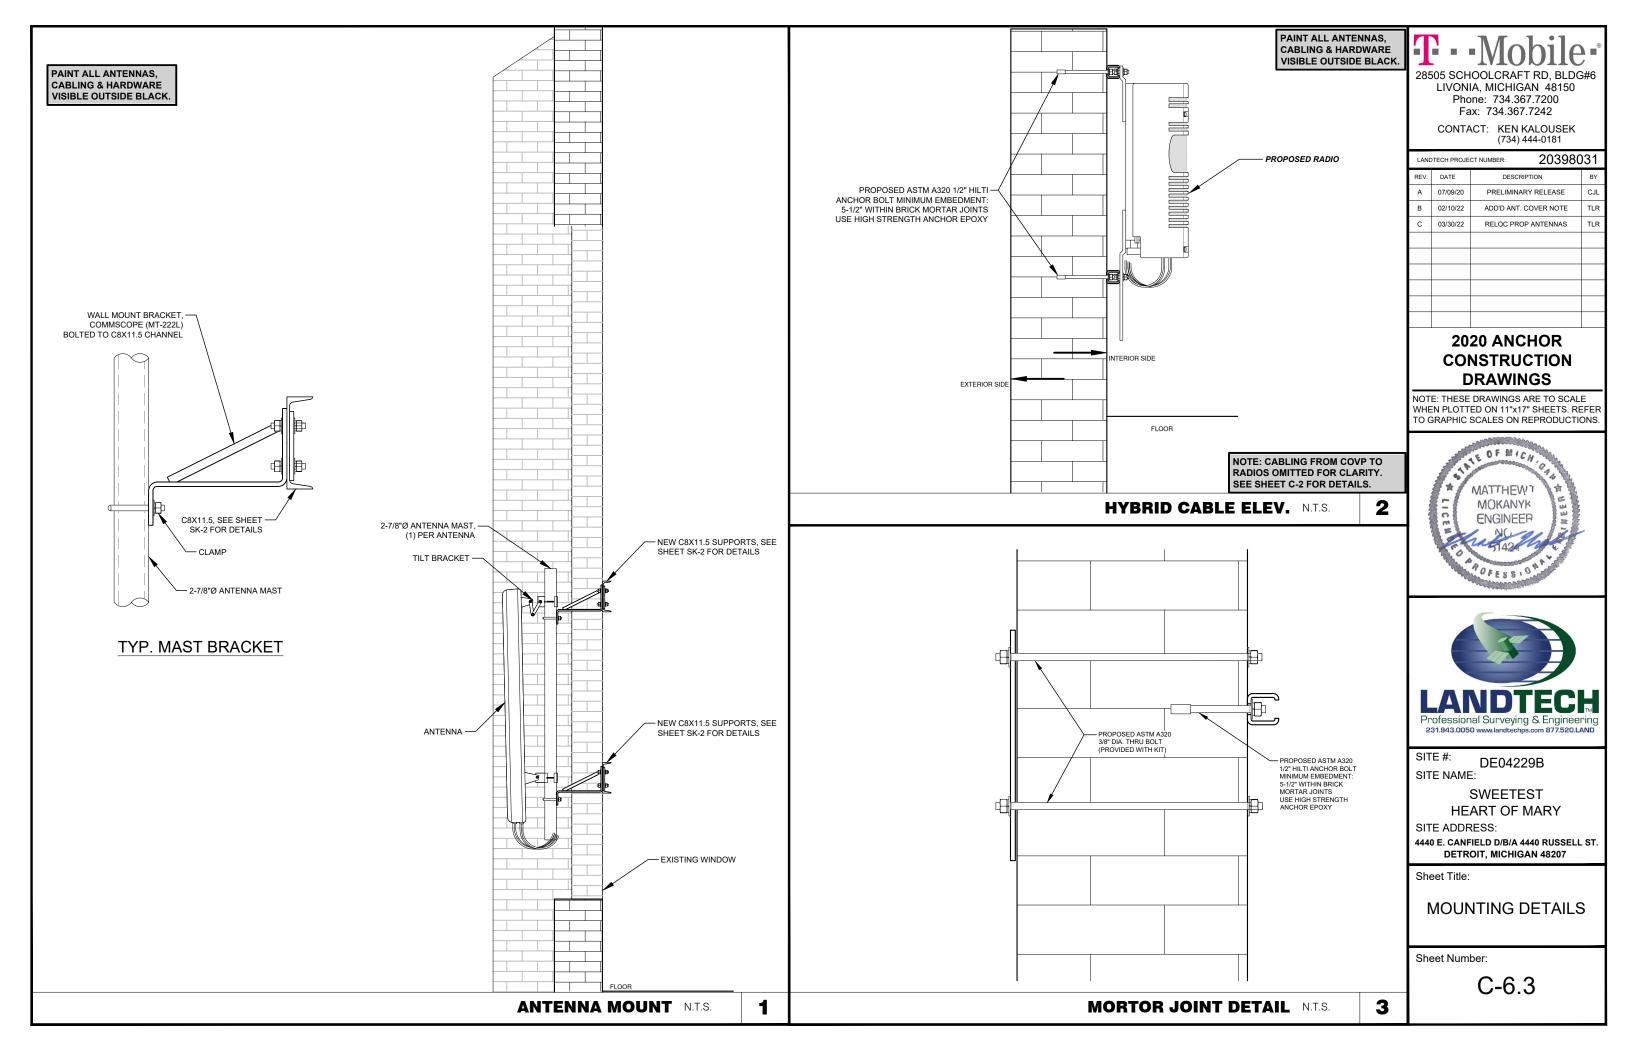
4440 E. CANFIELD D/B/A 4440 RUSSELL ST. DETROIT, MICHIGAN 48207


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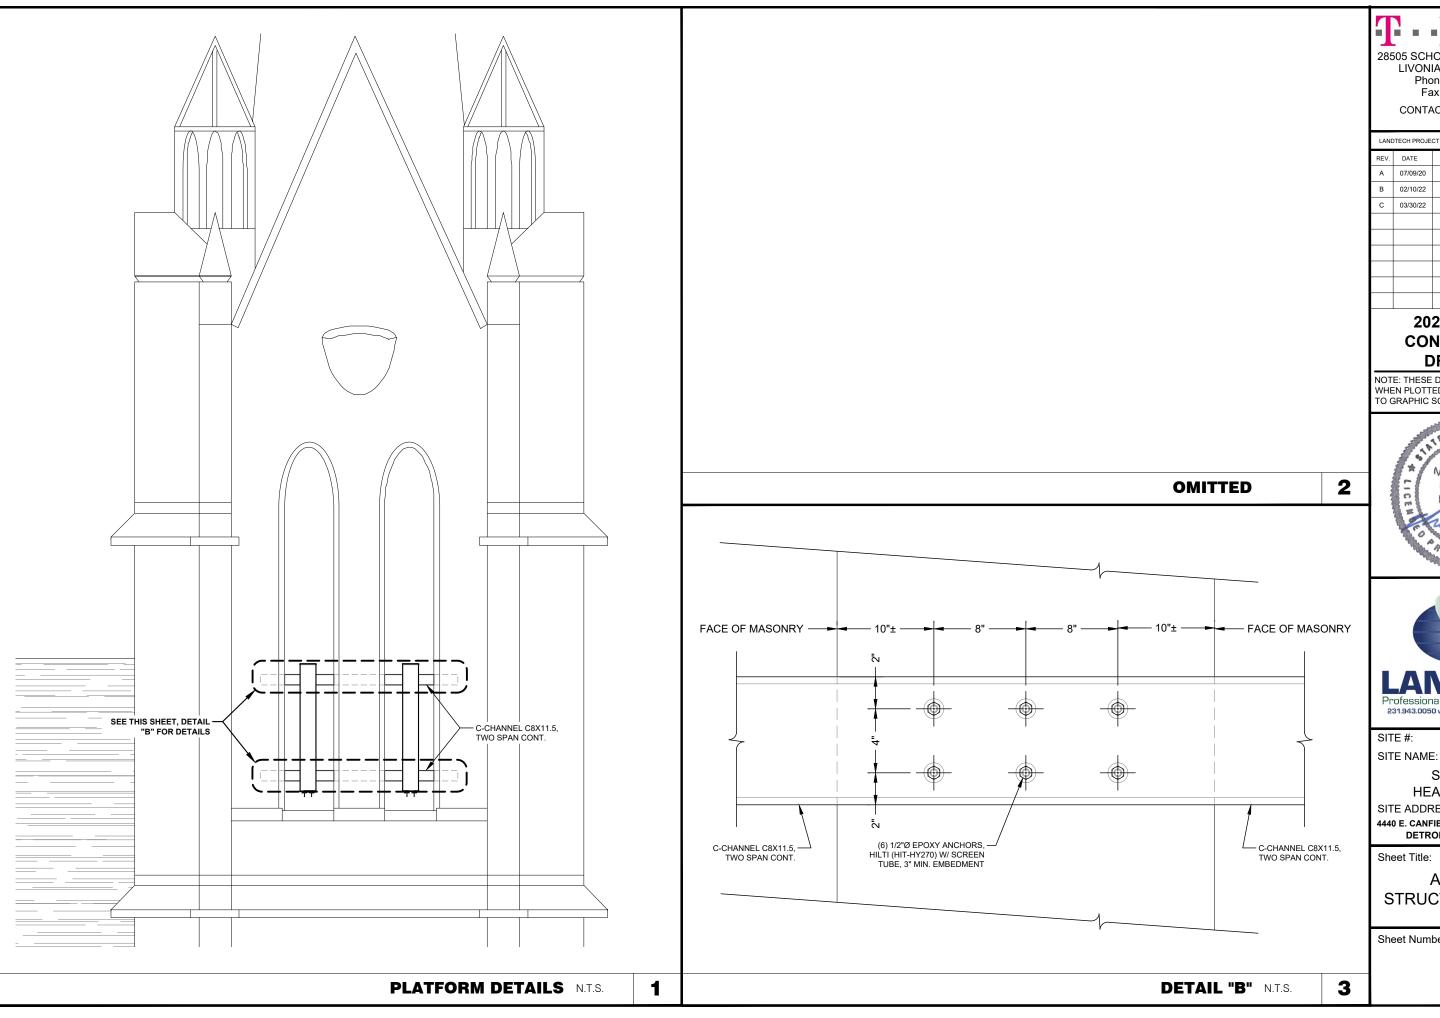
ANTENNA DETAILS

Sheet Number:

C-6.2





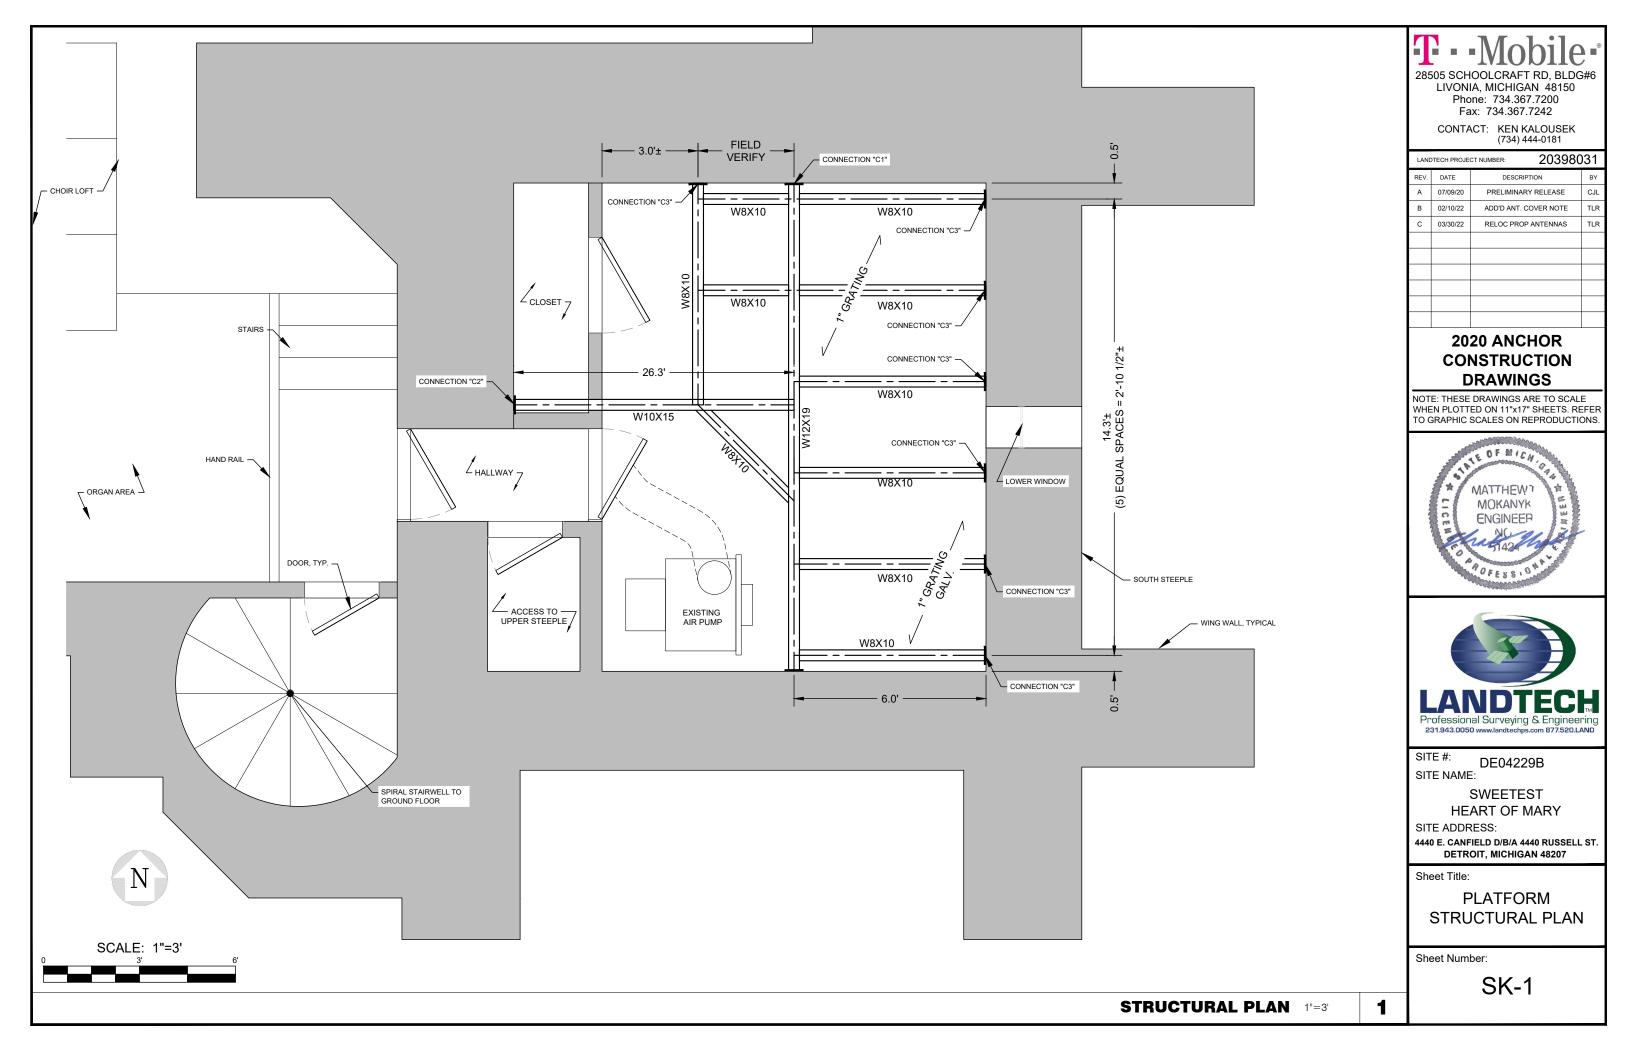

LIVONIA, MICHIGAN 48150 Phone: 734.367.7200 Fax: 734.367.7242

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LANE	OTECH PROJE	CT NUMBER: 203980	31
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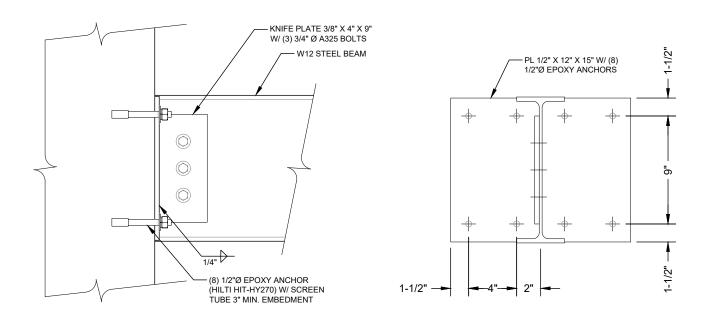
4440 E. CANFIELD D/B/A 4440 RUSSELL ST. DETROIT, MICHIGAN 48207

Sheet Title:

ANTENNA STRUCTURAL DETAIL

Sheet Number:

SK-2



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SITE NAME:

2

DE04229B

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4440 E. CANFIELD D/B/A 4440 RUSSELL ST. DETROIT, MICHIGAN 48207

Sheet Title:

PLATFORM STRUCTURAL DETAIL

Sheet Number:

SK-3

CONNECTION "C1" N.T.S


- KNIFE PLATE 3/8" X 4" X 9" W/ (3) 3/4" Ø A325 BOLTS - W12 STEEL BEAM 1-1/2" --(4) 1/2"Ø EPOXY ANCHOR (HILTI HIT-HY270) W/ SCREEN TUBE 3" MIN. EMBEDMENT PL 1/2" X 7" X 10" W/ (4) — 1/2"Ø EPOXY ANCHORS

CONNECTION "C2" N.T.S

- KNIFE PLATE 3/8" X 4" X 6" W/ (3) 3/4" Ø A325 BOLTS - W8 STEEL BEAM 1-1/2" --(4) 1/2"Ø EPOXY ANCHOR (HILTI HIT-HY270) W/ SCREEN TUBE 3" MIN. EMBEDMENT PL 1/2" X 7" X 8" W/ (4) — 1/2"Ø EPOXY ANCHORS

3

CONNECTION "C3" N.T.S

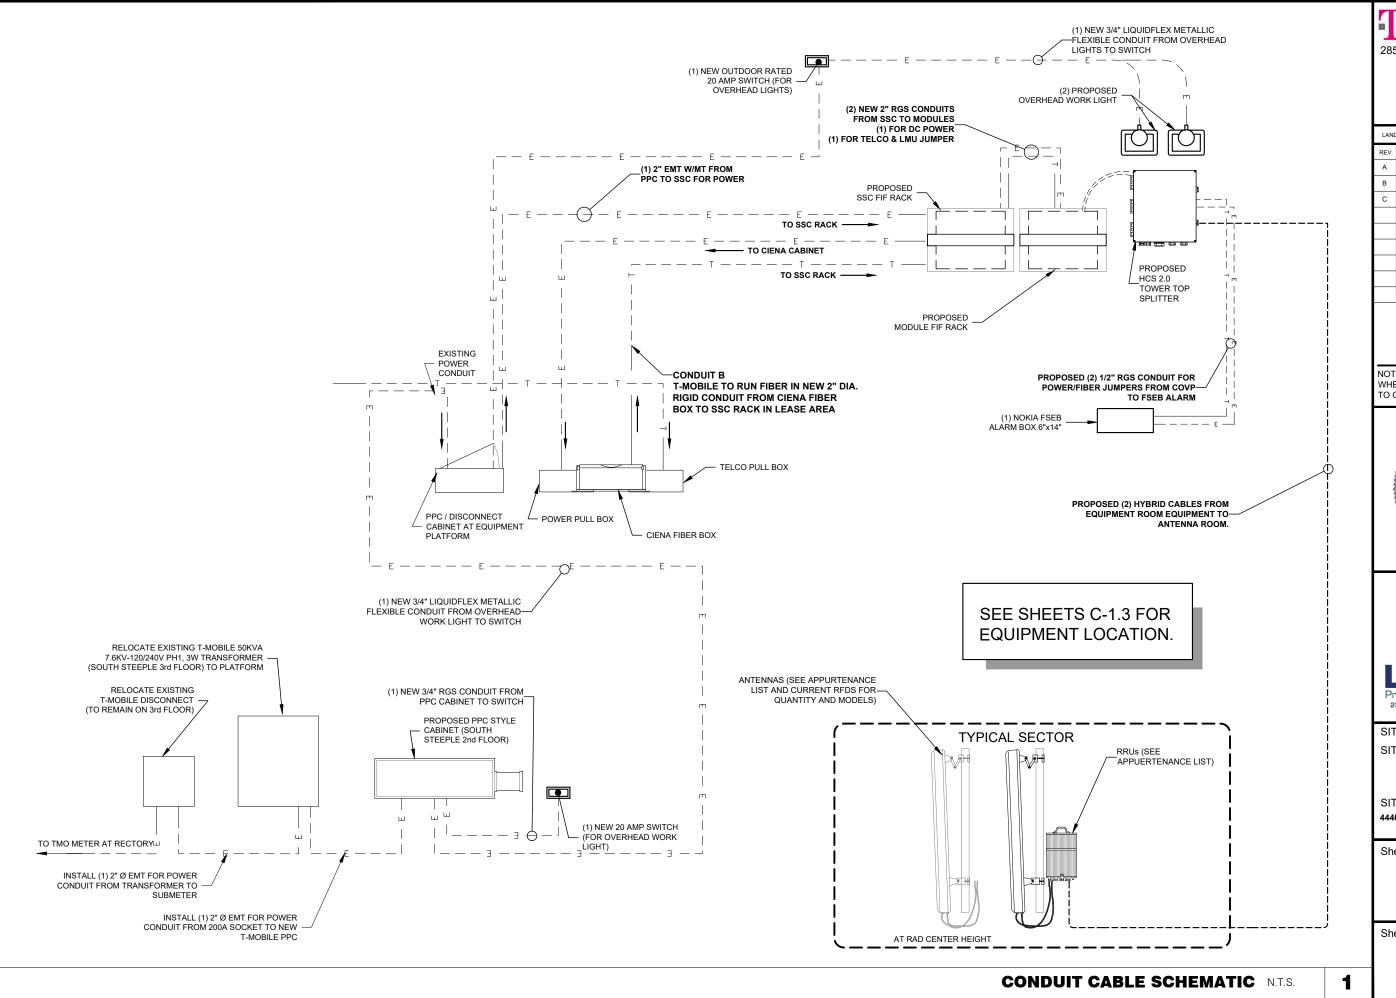

T··Mobile

28505 SCHOOLCRAFT RD, BLDC LIVONIA, MICHIGAN 48150 Phone: 734.367.7200

Fax: 734.367.7242 CONTACT: KEN KALOUSEK (734) 444-0181

LANDTECH PROJECT NUMBER: 203980			31	
REV.	DATE	DESCRIP	TION	BY
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DE04229B ME:

SWEETEST HEART OF MARY

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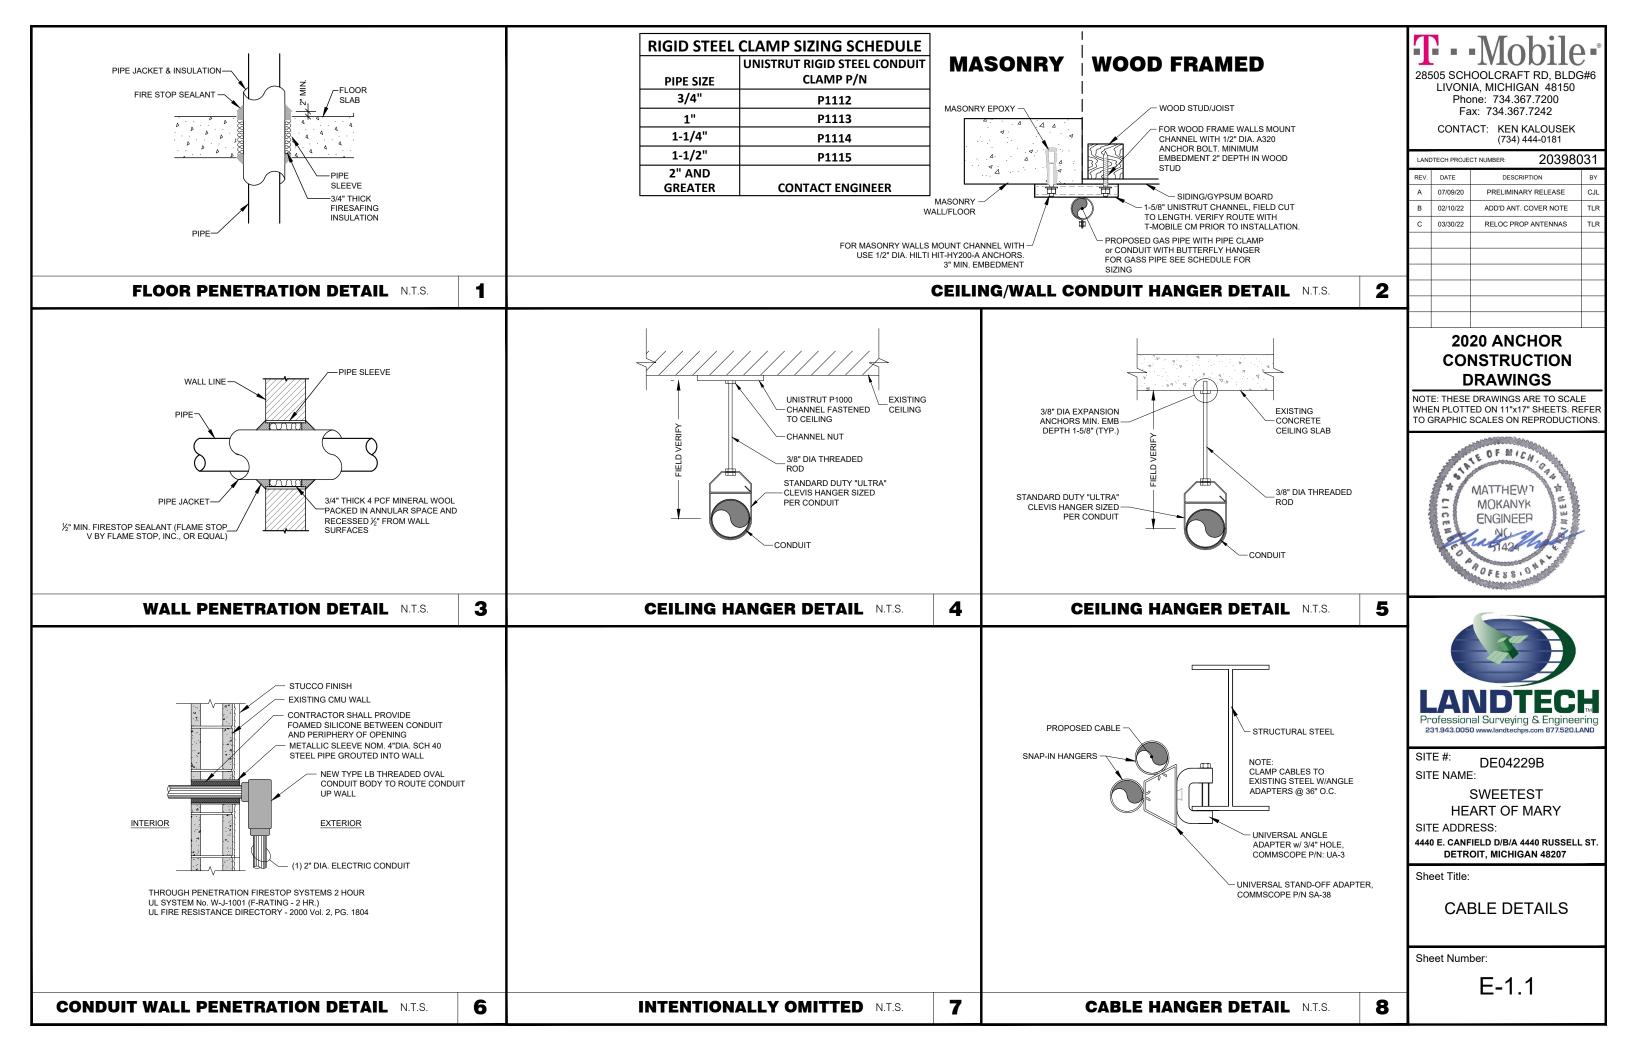
4440 E. CANFIELD D/B/A 4440 RUSSELL ST. DETROIT, MICHIGAN 48207


Sheet Title:

CONDUIT CABLE SCHEMATIC


Sheet Number:

E-1



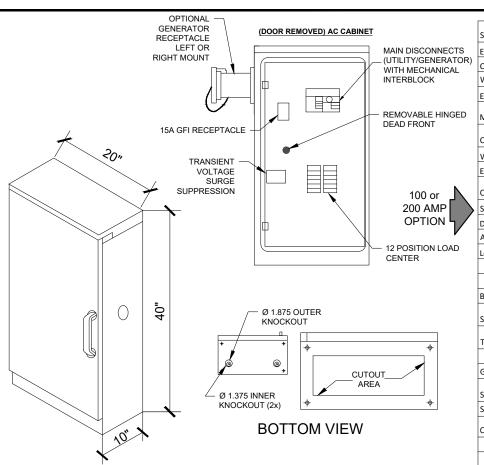

Specifications – CAC Model	
Enclosure	AC Cabinet
Cabinet Dimensions	39.00" H x 20.00" W x 10.00" D
Weight Approx.	75 lbs.
External Material	0.1" thick aluminum
Mounting	Wall or pad-mount (with optional pad-mounting base)
Cabinet Enclosure Type	One AC Power TVSS cabinet (NEMA 3R type enclosure)
Weather Protection	Rain/drip hood, rain tested per UL 891
Electrical	
Operating Voltage	120/240 VAC, single phase, 3 wire and ground
Service	100 Amp or 200 Amp. utility/standby
Disconnect	Slide bar mechanical interlock
AIC Rating	10kAIC, 22kAIC, 65kAIC
Load	Center 200 Amp, 24 position
	1-30 Amp double pole (AC TVSS)
	1-15 Amp single pole (GFI receptacles)
Bonding Jumper	Optional N-G bonding jumper
Standby Power Receptacle	Appleton AR20044RS Standard (100A or 200A), 10kAIC
TVSS with Indicator Lights	Metal Oxide Varistors (MOV) (160kA/Phase)
	Remote alarm contacts
Grounding	
Security (padlockable)	3-point door closure with 1/4 turn handle, SS hinge
Safety Compliance	UL 891, dead front switchboards
Options	10,000 or 22,000, 65,000 AIC series rated
	Pad-mounting base (8" thick)
	Various generator receptacles

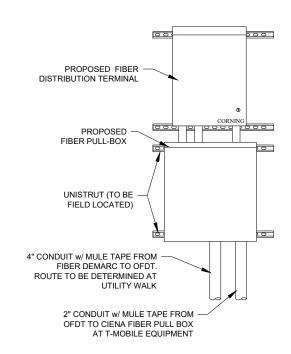

FIBER DEMARCATION DETAIL N.T.S.

2020 ANCHOR CONSTRUCTION DRAWINGS

LIVONIA, MICHIGAN 48150

Phone: 734.367.7200 Fax: 734.367.7242 CONTACT: KEN KALOUSEK (734) 444-0181

DESCRIPTION

PRELIMINARY RELEASE

ADD'D ANT. COVER NOTE

RELOC PROP ANTENNAS

LANDTECH PROJECT NUMBER:

A 07/09/20

03/30/22

20398031

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Sheet Title:

ELECTRIC DETAILS

Sheet Number:

E-1.2


POWER PEDESTAL CABINET N.T.S.

1


1. FROM TAP BOX: THE TWO (2) FOUR-INCH (4") CONDUIT WILL RETURN TO THE LOCATION DETERMINED BY "DTE" AND EXTEND OUT OF THE FINISHED GRADE 12" AND 36" RESPECTIVELY (SEE DETAIL). BOTH CONDUITS SHALL BE INSTALLED WITH PULL-STRINGS AND WATERPROOF CAPS.

2. CABINET AND CONDUCTORS FURNISHED & INSTALLED BY CUSTOMER, 350 KCMIL SERVICE CONDUCTORS FURNISHED & INSTALLED BY UTILITY.

- 3. EQUIPMENT ASSEMBLY DRAWINGS AND RISER DIAGRAMS MUST BE SUBMITTED TO A UTILITY PLANNER FOR ACCEPTANCE PRIOR TO INSTALLATION.
- 4. CABINETS AND CONDUITS SHOWN SHALL CONTAIN ONLY UNMETERED LINE CONDUCTORS. CABINET SHALL BE SEALABLE WITH ACCEPTABLE SEALING HASP.
- 5. TRANSMISSION TOWER SERVICES WILL UTILIZE A STANDARD 200 AMP SERVICE W/ CONTINUOUS CONDUIT TO THE SOURCE.
- 6. SUBSTATION CELLULAR SERVICES WILL BE A SINGLE 200-AMP SERVICE OR BUILT TO THIS SPECIFICATION. NO SERVICE SHALL BE TAKEN OUT OF THE SUBSTATION HOUSE SERVICE.
- 7. ALL CONDUIT AND NIPPLE ENTRIES TO CABINET AND METER BOXES WILL BE MADE WITH WEATHERPROOF HUBS, CONNECTORS OR LOCKNUTS LISTED FOR THE APPLICATIONS. NON-METALLIC BUSHINGS.
- 8. FOR INACCESSIBLE LOCATIONS CONSULT WITH METER ENGINEERING FOR POSSIBLE ERT METER INSTALLATION.
- 9. ONLY ONE SERVICE ALLOWED PER LUG. ALL GROUNDING AND BONDING MUST COMPLY WITH NEC 250 REQUIRED

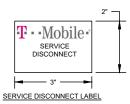


- THE LFMC SHALL BE CONNECTED TO THE ICE BRIDGE WITH MANUFACTURER APPROVED METALLIC PIPE STRAPS OR "MINIS" USING STAINLESS STEEL BANDING, OUTDOOR RATED METALLIC PIPE CLAMPS, AND/OR MANUFACTURER APPROVED OUTDOOR RATED ROUTING PRODUCTS.
- THE LIGHT SWITCH AND ANY JUNCTION BOXES SHALL BE DIE-CAST METALLIC WEATHER RATED BOXES AND MOUNTED WITH 100% WEATHERPROOF INSTALLATION METHODS. THE MOUNTING CLIPS SHALL BE USED AND NO BOXES SHALL BE DRILLED WITH SELF-TAPPING SCREWS FOR INSTALLATION.
- EACH LIGHT SHALL BE AN LED FLOOD LIGHT (NOT SPOT) RATED AT A MINIMUM OF 1,200 LUMEN BRIGHTNESS FACTOR AND SHALL BE OUTDOOR RATED TO A MINIMUM OF -30 DEGREES FAHRENHEIT (BELOW ZERO) OPERATING RANGE.

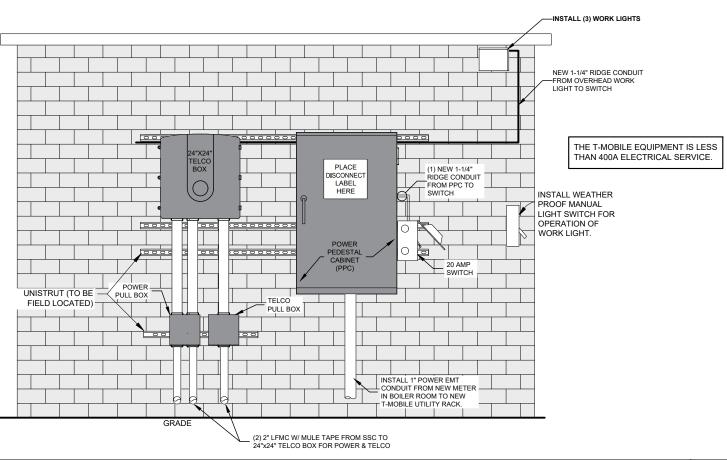

2

THE T-MOBILE EQUIPMENT IS LESS THAN 400A ELECTRICAL SERVICE.

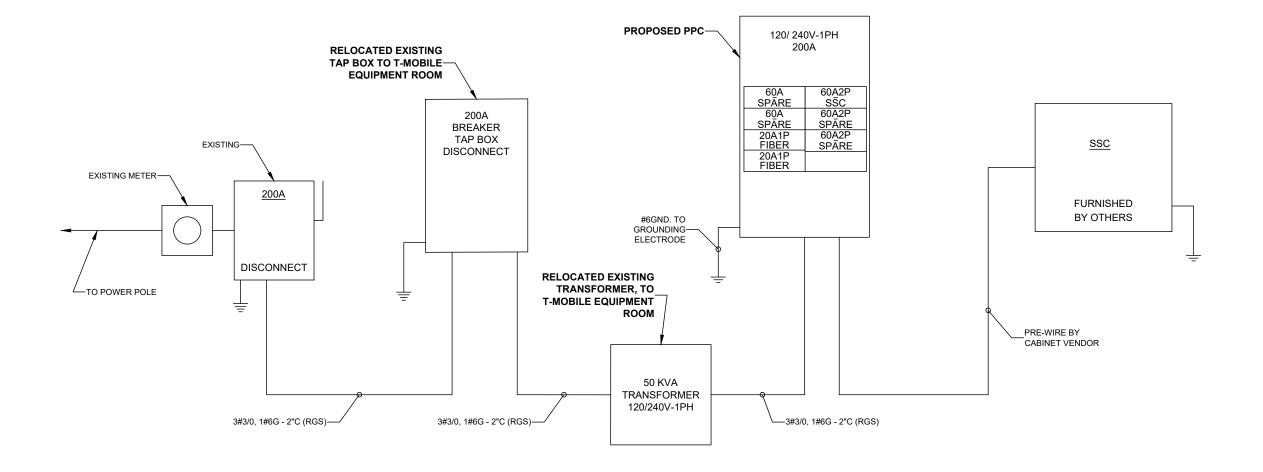

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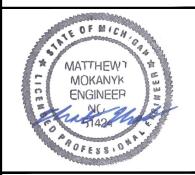
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CONTACT: KEN KALOUSEK (734) 444-0181

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В	02/10/22	ADD'D ANT. COVER NOTE		TLR			
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2020 ANCHOR CONSTRUCTION DRAWINGS

NOTE: THESE DRAWINGS ARE TO SCALE
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SITE #: DE04229B SITE NAME:

SWEETEST HEART OF MARY

SITE ADDRESS:


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ONE-LINE DIAGRAM


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E-2



IMPORTANT GROUNDING / CABLE NOTES:

- T-MOBILE IS ELIMINATING THE HOME RUN GROUND WIRE FROM TOP BUSS BAR AND THE BOTTOM BUSS BAR ON TOWER SITES. ROOFTOPS ARE STILL REQUIRED TO HAVE SECTORIZED GROUND AND #2 INSULTED GROUND WIRE. FROM SECTOR GROUNDS TO MAIN BUSS BARS AND BUILDING STEEL. 4 GROUND BARS, 3 ISOLATED ONE FOR EACH SECTOR, ONE AS COLLECTION POINT MOUNTED WITHOUT CHERRIES.
- 2. REMOVE INSULATORS (CHERRIES) FROM THE BUSS BARS AND GROUND TO TOWER, TOP AND BOTTOM ON TOWER SITES ONLY.
- 3. ALL EXPOSED GROUNDS TO BE DRESSED WITH SEAL TIGHT. (ONLY AT GRADE)
- 4. THE DISTANCE BETWEEN BUTTERFLIES AND CABLE STAND OFFS IS 36".
- THE DISTANCE BETWEEN CONVENTIONAL AND/OR SNAP-HANGERS ON 1/2" JUMPERS SHALL BE NO MORE THAN 3 FEET AT THE TOP AND 2 FEET ON THE BOTTOM JUMPERS PER MANUFACTURER'S
- 6. NO HYBRID CABLES SHOULD TOUCH METAL OR STEEL. THE USE OF STANDOFF BRACKETS ARE REQUIRED. USE OF GROMMETS AS SUPPLIED BY T-MOBILE. (EXCEPT 1-5/8" SNAP-IN FOR CABLE
- 7. HYBRID AND JUMPER LINES SHOULD BE DRESSED IN ON THE SIDE OR BOTTOM OF SECTOR FRAMES / MONOPOLES. NEVER ON TOP WERE SOMEONE WOULD WALK.
- 8. PARALLEL #2 TINNED PATH RUNS, WIDTH, DEPTH, BACKFILL, COMPACTION SPECS.
- 9. ALL MECHANICAL GROUND CONNECTIONS NEED TO BE SCRAPED IF PAINTED TO BARE METAL AND NO-OX APPLIED ON ALL CONNECTIONS ABOVE GROUND.
- 10. GROUND BARS NEED TO BE COPPER.
- 11. GROUNDING HARDWARE NEEDS TO BE STAINLESS STEEL

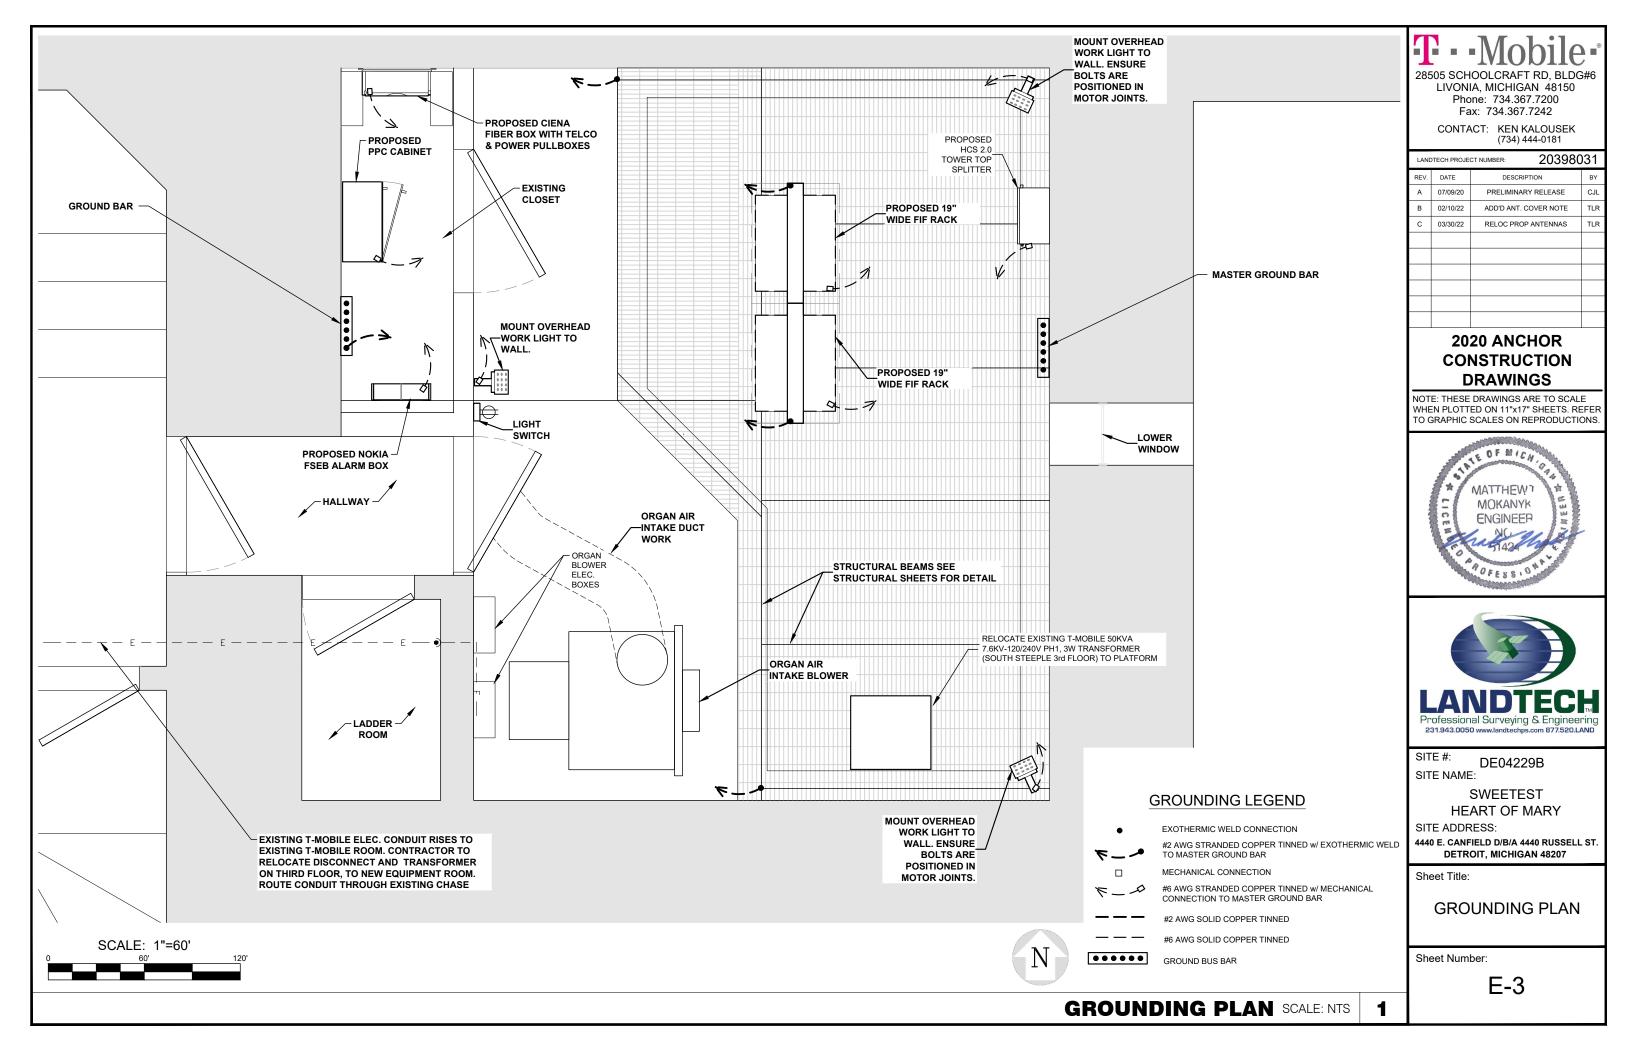

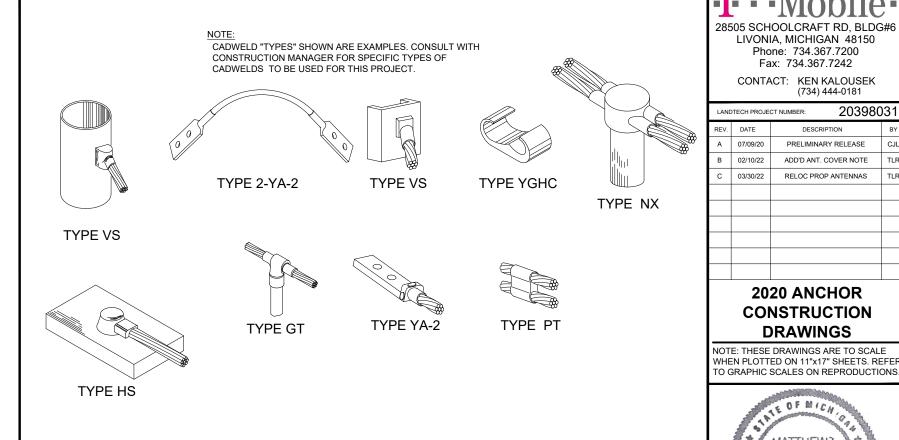CADWELD CONNECTION TYPES

2

LE OF MICH MATTHEW MOKANYK ENGINEER

2020 ANCHOR

CONSTRUCTION

DRAWINGS

LIVONIA, MICHIGAN 48150

Phone: 734.367.7200

Fax: 734.367.7242

CONTACT: KEN KALOUSEK (734) 444-0181

07/09/20

03/30/22

DESCRIPTION

PRELIMINARY RELEASE ADD'D ANT. COVER NOTE

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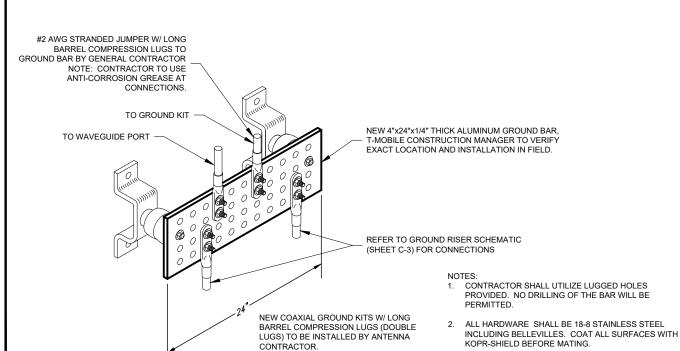
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GROUNDING DETAILS

Sheet Number:


E-3.1



3. FOR GROUND BOND TO STEEL ONLY: INSERT A

DRAGON TOOTH WASHER BETWEEN LUG AND STEEL. COAT ALL SURFACES WITH KOPR-SHIELD.

3

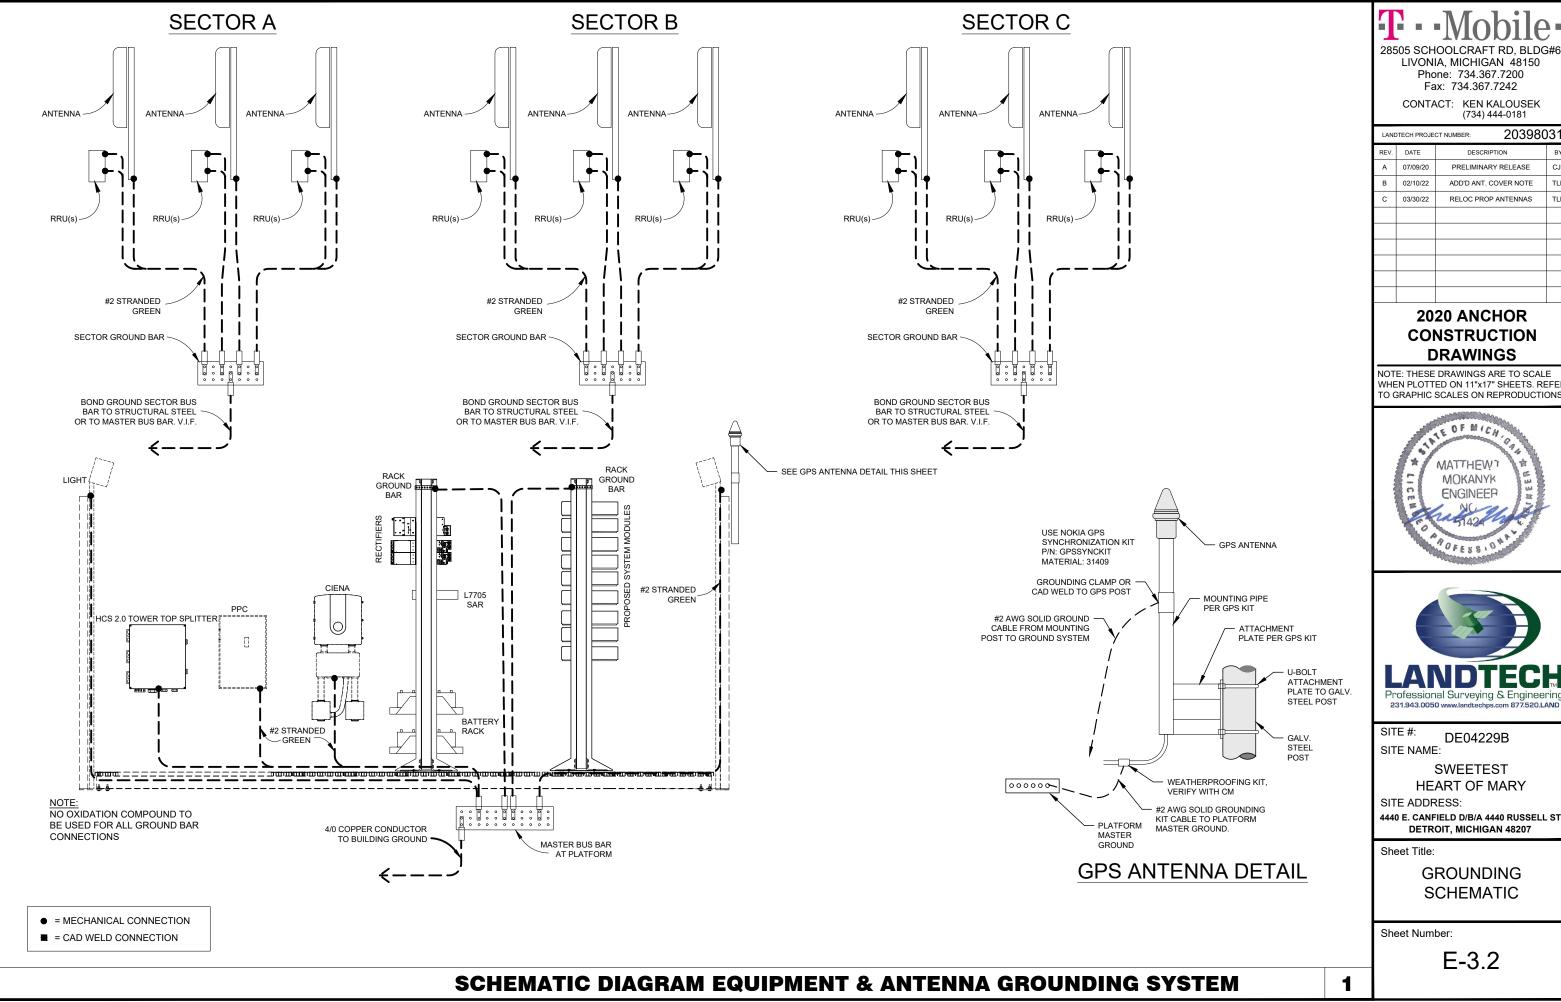

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2020 ANCHOR CONSTRUCTION DRAWINGS

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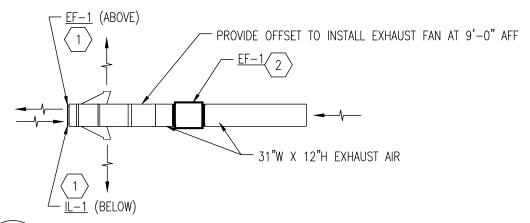


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HEART OF MARY


DETROIT, MICHIGAN 48207

GROUNDING SCHEMATIC



\FLOOR PLAN - HVAC

M-1 /SCALE: NOT TO SCALE

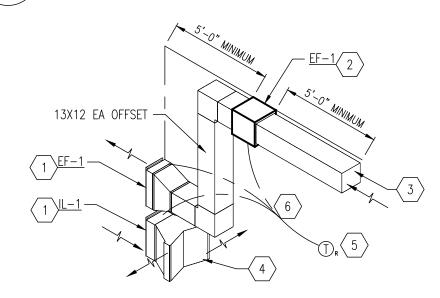

\ISOMETRIC DETAIL - HVAC

20° MAX

AIR FLOW

20° MAX

30° MAX

15° MAX

DUCT TRANSITION W/EQUIPMENT

SCALE: NOT TO SCALE

DUCT TRANSITION


NOTES:

1. UNLESS OTHERWISE INDICATED ON PLANS, MAXIMUM ANGLES SHOWN SHALL APPLY.

3 TYPICAL DUCT TRANSITION DETAIL
M-1 SCALE: NOT TO SCALE

$^{\#} angle$ hvac key notes

- 1. PROVIDE INTAKE OR EXHAUST LOUVER WITH FACTORY OPTIONS/FINISH AS SCHEDULED.
- 2. PROVIDE EXHAUST FAN WITH FACTORY OPTIONS AS SCHEDULED. INSTALL AT 9'-0" ABOVE FINISH FLOOR.
- 3. EXTEND 13" WIDE X 12" HIGH EXHAUST DUCT 10'-0" INTO THE ROOM AND TERMINATE WITH GALVANIZED 16-GAUAGE 1x1 WIRE MESH GRILLE ON END.
- 4. PROVIDE A FIELD FABRICATED FITTING TO TRANSITION FROM THE INTAKE LOUVER TO TWO 22x4 OPENINGS TO DIRECT AIR INTO THE SPACE AT A 90° ANGLE.
- 5. PROVIDE A 120V REVERSE ACTING THERMOSTAT, INSTALL AT 4'-0" ABOVE FINISH FLOOR BETWEEN THE TWO DOORS.
- 6. INTERLOCK THE EXHAUST FAN WITH THE NORMALLY CLOSED INTAKE AND NORMALLY CLOSED EXHAUST LOUVER TO OPEN WHEN THE EXHAUST FAN IS ON.

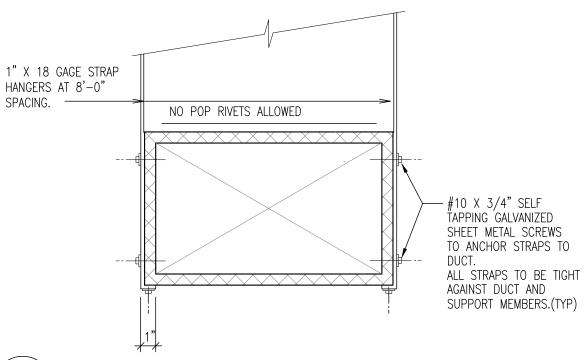

TYPICAL DUCT STRAP HANGER DETAIL

-1 /SCALE: NOT TO SCALE

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SITE #: DE04229B SITE NAME:

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Sheet Title:

HVAC DETAILS

Sheet Number:

M-1

SECTION 23 0000 - HVAC

THE REQUIREMENTS OF THE "GENERAL CONDITIONS" AND "DIVISION 1" SECTIONS OF THE SPECIFICATIONS SHALL APPLY TO THIS SECTION OF THE SPECIFICATIONS.

PART 1 - GENERAL

1.01 SUMMARY

- A. THE CONTRACTOR SHALL PROVIDE A COMPLETE AND OPERATIONAL HVAC SYSTEM AS SHOWN ON THE DRAWINGS INCLUDING EQUIPMENT, MATERIAL, LABOR, DUCTWORK, PIPING, DIFFUSERS, GRILLES AND REQUIRED ELECTRICAL. THE CONTRACTOR SHALL PROVIDE OPERATING AND MAINTENANCE INSTRUCTIONS TO THE OWNER FOR ALL EQUIPMENT. ALL COMPRESSORS SHALL BE PROVIDED WITH A FIVE (5) YEAR EXTENDED WRITTEN WARRANTY ON PARTS AND, WHERE APPLICABLE, ALL GAS FIRED HEAT EXCHANGERS SHALL BE PROVIDED WITH AN EXTENDED TEN (10) YEAR PARTS WARRANTY. THE CONTRACTOR SHALL PROVIDE AN UNCONDITIONAL WARRANTY OF ONE YEAR FOR ALL OTHER ASSOCIATED EQUIPMENT AND DEVICES.
- B. ALL WORK SHALL BE PERFORMED IN COMPLIANCE WITH THE LOCAL BUILDING, MECHANICAL, AND ENERGY CODES ASHRAE, SMACNA, AND ALL OTHER APPLICABLE STATE AND FEDERAL CODES
- C. THE CONTRACTOR SHALL OBTAIN AND PAY FOR ALL PERMITS AND INSPECTIONS REQUIRED FOR THE EXECUTION OF THIS WORK.
- D. ALL EQUIPMENT AND MATERIALS SHALL BE NEW AND SHALL DISPLAY A UL LABEL WHERE APPLICABLE.
- E. ALL INTERIOR INSULATION MATERIALS, JACKETS, COVERINGS, SEALS AND MASTICS SHALL HAVE A FLAME SPREAD INDEX OF 25 OR LESS AND SMOKE DEVELOPED INDEX OF 50 OR LESS PER ASTM E84 (NFPA 255).

1.02 SUBMITTALS

A. PRODUCT DATA: INCLUDE MANUFACTURER'S TECHNICAL DATA FOR EACH MODEL INDICATED, INCLUDING RATED CAPACITIES, DIMENSIONS, REQUIRED CLEARANCES, CHARACTERISTICS, FURNISHED SPECIALTIES. ACCESSORIES. AND OPERATION AND MAINTENANCE DATA.

1.03 QUALITY ASSURANCE

A. ELECTRICAL COMPONENTS, DEVICES, AND ACCESSORIES: LISTED AND LABELED AS DEFINED IN NFPA 70, ARTICLE 100, BY A TESTING AGENCY ACCEPTABLE TO AUTHORITIES HAVING JURISDICTION, AND MARKED FOR INTENDED USE.

PART 2 - PRODUCTS

2.01 DUCTWORK AND SPECIALTIES

A. ALL DUCTWORK SHALL BE GALVANIZED SHEET METAL OF GAUGES AND JOINT TYPES AS SPECIFIED IN THE SMACNA MANUAL FOR THE APPLICABLE SIZES. VOLUME DAMPERS SHALL BE MANUAL LOCKING, BLADE—TYPE, TWO GAUGES HEAVIER THAN DUCT. DUCTWORK SHALL BE CONSTRUCTED IN ACCORDANCE WITH SMACNA STANDARDS FOR TWO—INCH STATIC PRESSURE. ALL DUCTWORK SHALL BE SEALED WITH MASTIC. ACCESS DOORS SHALL BE PROVIDED IN DUCTWORK AT FIRE DAMPERS OR OTHER CONTROL DEVICES AS REQUIRED FOR MAINTENANCE. DOUBLE—THICKNESS TURNING VANES SHALL BE PROVIDED AT ALL RECTANGULAR ELBOWS. FLEXIBLE CONNECTIONS TO AIR HANDLING UNITS SHALL BE PROVIDED.

2.02 INSULATION

A. ALL DUCTWORK SHALL BE WRAPPED WITH INSULATION WITH A MINIMUM R VALUE OF R-3.5.

2.03 EXHAUST FAN

- A. EXHAUST FAN TO BE SUPPLIED AS INDICATED ON THE DRAWINGS.
- B. FAN SPEED CONTROLLER INSTALLATION LOCATION SHALL BE COORDINATED WITH ELECTRICAL CONTRACTOR AND BE INSTALLED AT OR BY THE FAN FOR ADJUSTMENT BY BALANCE CONTRACTOR.

PART 3 - EXECUTION

3.01 INSTALLATION

- A. INSTALL UNITS LEVEL AND PLUMB, MAINTAINING MANUFACTURER'S RECOMMENDED CLEARANCES. INSTALL ACCORDING TO ARI GUIDELINE B.
- B. ALL DUCTWORK AND EXHAUST FANS SHALL BE SUPPORTED PROPERLY FROM THE TOP CHORD OF ROOF JOISTS. NO DUCTWORK OR DEVICES SHALL BE ATTACHED DIRECTLY TO ROOF DECK.
- C. THE HVAC SYSTEM SHALL OPERATE WITHOUT OBJECTIONABLE VIBRATION, PULSATION, OR RATTLE. MOTORS SHALL BE MOUNTED ON RUBBER VIBRATION ISOLATORS OR THE COMPLETE UNIT SHALL BE ISOLATED FROM THE BUILDING WITH ISOLATION PADS. ALL DAMPERS, GRILLES, AND ACCESSORIES SHALL HAVE NO MOVEMENT UNDER OPERATING CONDITIONS AND SHALL OPERATE WITHOUT NOISE. ALL DUCTWORK INSTALLED EXTERNAL TO THE BUILDING SHALL BE COMPLETELY WEATHERPROOF AND INSULATED.

3.04 CONNECTIONS

- A. ELECTRICAL SYSTEM CONNECTIONS: COMPLY WITH APPLICABLE REQUIREMENTS IN DIVISION 16 SECTIONS FOR POWER WIRING, SWITCHES, AND MOTOR CONTROLS.
- B. GROUND EQUIPMENT ACCORDING TO DIVISION 16 SECTIONS "GROUNDING AND BONDING".
- C. TIGHTEN ELECTRICAL CONNECTORS AND TERMINALS ACCORDING TO MANUFACTURER'S PUBLISHED TORQUE—TIGHTENING VALUES. IF MANUFACTURER'S TORQUE VALUES ARE NOT INDICATED, USE THOSE SPECIFIED IN UL 486A AND UL 486B.

3.05 TESTING ADJUSTING AND BALANCING

- A. TEST, ADJUST, AND BALANCE THE EXHAUST AIR SYSTEMS:.
- B. MAKE ADJUSTMENTS AND RE-TEST SYSTEM TO ACHIEVE THE REQUIRED FLOW WITHIN 10% OF SPECIFIED FLOW FOR AIR SYSTEMS.
- C. WHEN DEFICIENCIES ARE IDENTIFIED, RE—TEST AND ADJUST FLOWS AFTER CORRECTIVE MEASURES ARE TAKEN.
- D. PERMANENTLY IDENTIFY POSITION OF SPEED CONTROLLER AND DAMPERS FOR FUTURE REFERENCE

END OF SECTION 23 0000

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Sheet Title:

HVAC GENERAL NOTES

Sheet Number:

M-1.1

EXHAUST FAN SCHEDULE														
TAG	BASIS OF	DESIGN	FLOW RATE	E.S.P.	FAN SPEED	DRIVE TYPE	BLADE TYPE	WEIGHT (LBS)	SONES	ELECTRICAL DATA		DISCONNECT DATA		NOTES
IAG	MANUFACTURER	MODEL	(CFM)	E.3.P.	(RPM)					HP	VOLTAGE	M.T.C.	E.T.C.	NOTES
EF-1	GREENHECK	SQ-95-G	530	0.25	1,300	DIRECT	BACKWARDS INCLINED	49	6.4	1 / 15	115 / 1 / 60	1		123

- ① SUSPEND FROM STRUCTURE WITH UNISTRUT AND HANGING SPRING ISOLATORS
- 2) PROVIDE WITH 120V REVERSE-ACTING THERMOSTAT, COORDINATE SET POINT WITH OWNER
- ③ INTERLOCK WITH LOUVERS, COORDINATE WITH LOUVER SCHEDULE AND FLOOR PLAN

	LOUVER SCHEDULE													
TAG	BASIS OF DE	SIGN	SERVICE	FLOW RATE	LOUVER	LOUVER	LOUVER	FREE AREA	VELOCITY	ELECTRIC AC	UTATOR	DISCONN	ECT DATA	NOTES
IAG	MANUFACTURER	MODEL	SERVICE	(CFM)	WIDTH	HEIGHT	DEPTH	(FT ²)	(FPM)	TYPE	VOLTAGE	M.T.C.	E.T.C.	NOTES
IL-1	GREENHECK	EAD-635	INTAKE LOUVER	530	13"	22"	6"	0.8	782	NORMALLY CLOSED	115 / 1 / 60	٧		123
EL-1	GREENHECK	EAD-635	INTAKE LOUVER	530	13"	22"	6"	0.8	782	NORMALLY CLOSED	115 / 1 / 60	٧		123

- 1 PROVIDE WITH FACTORY GREENHECK 70% KYNAR 500 / HYLAR 5000 IN SIERRA TAN (COLOR CODE GF118)
- 2 PROVIDE WITH FACTORY INSECT SCREEN
- ③ INTERLOCK TO OPEN WHEN THE EXHAUST FAN IS RUNNING



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Sheet Title:

EXHAUST FAN & LOUVER SCHEDULE

Sheet Number:

M-1.2

DIVISION 1 - GENERAL REQUIREMENTS

PART 1 - GENERAL

11 Intent

- A. These specifications and construction drawings accompanying them describe the work to be done and the materials to be furnished for the construction of this project.
 B. The drawings and specifications are intended to be fully explanatory and supplementary.
- However, should anything be shown, indicated or specified on one and not the other, it shall be done the same as if shown, indicated or specified in both.

 C. The intention of the documents is to include all labor and materials reasonably necessary for the
- proper execution and completion of the work as stipulated in the contract.

 D. The purpose of the specifications is to interpret the intent of the drawings and to designate the method of the procedure, type and quality of material required to complete the work.
- memon or the procedure, type and quality or material required to complete the work.

 E. Minor deviations from the design layout are anticipated and shall be considered as part of the work. No changes that alter the character of the work will be made or permitted by the Owner without issuing a change order.

Conflicts

- A. The Contractor shall be responsible for verification of all measurements at the site before ordering any materials or doing any work. No extra charge or compensation shall be allowed due to difference between actual dimensions and dimensions indicated on the construction drawings. Any such discrepancy in dimension which may be found shall be submitted to the Owner for consideration before the Contractor proceeds with the work in the affected areas.
- B. The Bidder, if awarded the contract, will not be allowed any extra compensation by reason of any matter or thing concerning the work which the Bidder might have fully discovered prior to the bidding.
- C. No plea of ignorance of conditions that exist, or of difficulties or conditions that may be encountered or of any other related matter concerning the work to be performed in the execution of the work will be accepted as an excuse for any failure or omission on the part of the Contractor to fulfill every detail of all the requirements.

Contracts and Warranties

- A. Each Contractor is responsible for obtaining the building permit at the local jurisdiction as the Contractor of record, and provide local jurisdiction with all proof required to operate as a Contractor in that jurisdiction. The Contractor shall be reimbursed only the amount of any fee paid as follows:
- Plan review fee
- Building permit fee.
- Connections and inspections fee.
- B. Contractor is responsible for application and payment of Contractor licenses and bonds.

All materials must be stored in a level and dry fashion in a manner that does not necessarily obstruct the flow of other work. Any storage method must meet all recommendations of the associate manufacturer

The Contractor shall at all times keep the site free from accumulation of waste, material or rubbish at the work site and, at completion of the work, shall remove all rubbish from and about the building area, including all tools, equipment, and surplus materials and shall leave the work area clean and ready for

1.6 Change Order Procedure

Change order may be initiated by the Owner and/or the Contractor involved. The Contractor, upon verbal request from the Owner shall prepare a written proposal describing the change in work or materials and any changes in the contract amount and present to the Owner for approval. Submit requests or substitutions in the form and in accordance with procedures required for change order proposals. Any changes in scope of work or materials which are performed by the Contractor without a written change order as described and approved by the Owner shall place full responsibility of these actions on the Contractor.

Related Documents And Coordination

General Carpentry, electrical, and antenna drawings are interrelated. In performance of the work, the Contractor must refer to all drawings. All coordination to be the responsibility of the Contractor.

Products And Substitutions

- A. Submit 3 copies of each request for substitution. In each request identify the product or fabrication or installation method to be replaced by the substitution. Include related specification section and drawing numbers and complete documentation showing compliance with the requirements
- B. Submit all necessary product data and cut sheets which properly indicate and describe the items. products, and materials being installed. The Contractor shall, if deemed necessary by the Owner, submit actual samples to the Owner for approval in lieu of cut sheets.

Quality Assurance

All work shall be in accordance with applicable local, state and federal regulations. These shall include but not be limited to the latest version of the following:

ANSI/EIA - 222 - E

International Building Code

National Electrical Code (NEC) with local Amendments
UnderWriter Laboratories Approved Electrical Products
American Institute of Steel Construction Specifications (AISC)

Life Safety Code NFPA - 101

Minimum design criteria for steel antenna towers and supporting structures will be TIA / EIA - 222 - F

1.10 Administration

- A. Prior to the commencement of any work, the Contractor will assign a Project Manager who will act as a single point of Contact for all personnel involved in this project. This Project Manager will develop a master schedule for the project which will be submitted to the Owner prior to the commencement of
- B. Submit a bar chart type progress not more than 3 days after the date established for commencement of the work on the schedule. Indicate a time bar for each major category or unit of work to be performed at site, property sequenced and coordinated with other elements of work. Show completion of the work sufficiently in advance of the date established for substantial completion of the
- C. Prior to commencing construction, the Owner will schedule an "on-site" meeting with all major parties. This would include (though not limited to) the Owner, local telephone company, Tower Erection foreman (if subcontracted).
- D. Contractor shall be equipped with some means of constant communications, such as a mobile phone or a pager. This equipment will NOT be supplied or paid for by the Owner nor will cellular service be arranged.
- E. During construction, Contractor must ensure that employees and Subcontractors wear OSHA Level D personal protective equipment at all times. The Contractor must comply with all applicable OSHA requirements

- D. Contractor shall be equipped with some means of constant communications, such as a mobile phone or a pager. This equipment will NOT be supplied or paid for by the Owner nor will cellular
- E. During construction, Contractor must ensure that employees and Subcontractors wear OSHA Level D personal protective equipment at all times. The Contractor must comply with all applicable
- F. Contractor shall provide DAILY updates on site progress, either verbal or written
- G. A complete inventory of construction materials and equipment is required prior to start of

Insurance And Bonds

A. Contractor shall at his own expense carry and maintain for the duration of the project all insurance as required and shall not commence with his work until he has presented a certificate of insurance stating all coverage to the Contractor who shall, in turn, forward a copy of all certificates to the Owner.

DIVISION 2 - SITE WORK

PART 1 - GENERAL 11 Work Included

Refer to the survey and architectural site plan for work included

Related Work

- A. Installation of antenna system
 B. Erection of fence
- C. Access road
- D. Parking area

1.3 Descriptions

Access road, turnaround areas, and sites are constructed to provide a well drained, easily maintained, even surface for material and equipment deliveries and maintenance personnel access

References

ASTM - American Society of Testing Materials, latest edition

Quality Assurances

- A. Contractor shall apply soil sterilizer in accordance with manufacturer's recommendations, as
- B. Vegetation and landscaping, if required within the contract, shall be placed and maintained as

Sequencing

- A. Contractor shall confirm survey stakes and set elevation, stakes prior to any construction The complete road and site area shall be cleared of heavy growth of grass, trees, shrub and topsoil prior to foundation construction or placement of backfill or subbase material.
- Construct temporary construction zone along access drive.

 The site area shall be brought to subbase course elevation and the access road to base course.
- elevation prior to forming foundations.
- E. Contractor shall apply soil herbicide prior to placing base materials.

 F. If required, grade, seed, fertilize and mulch disturbed area immediately after bringing the site and access road to base course elevation. Water to ensure growth. Remove gravel from temporary construction zone
- After applications of final surfaces, soil herbicide shall be applied to the stone surfaces.

Submittals

- Prior to Construction
 If landscaping is applicable to the contract, submit two copies of the landscaping plan under nursery letterhead. If a landscape allowance was included in the contract, submit an itemized listing of proposed costs under nursery letterhead (Refer to site plan for landscaping requirement).

 2. Submit for approval 1/2 cubic feet of the proposed surface course material.
- Manufacturer's description of product and warranty statement on soil herbicide treatment Manufacturer's description of product on grass seed and fertilizer, if needed.
- Landscaping warranty statement, if required.

1.8 Warranty

- A. In addition to the warranty on all construction covered in the contract documents, the Contractor shall repair all damage of surrounding property caused by construction.

 B. Soil herbicide application will guarantee vegetation free road and site area for one year from the
- Disturbed areas shall reflect growth of new grass cover prior to final inspection.

 Landscaping, if included within the scope of the contract, shall be guaranteed for one year from

PART 2 - PRODUCTS

2.1 Material

- Subbase: Granular material
- Aggregate Base Course:
- For bases to be surfaced with concrete or bituminous mixtures, use Aggregate 22A unless
- For bases to be surfaced with aggregate, use Aggregate 6A or 3-4" crushed concrete (no rerod). C. Aggregate Surface Course: Use Aggregate 21AA when the Aggregate surface course is to be constructed without a bituminous surface.

Equipment

- A. Compaction shall be accomplished by mechanical means.
- Larger areas shall be compacted by sheeps foot, vibratory or rubber tired rollers weighing at least 2. Smaller areas shall be compacted by power-driver, hand held tampers.

PART 3 - EXECUTION

3.1 Preparation

- A. Clear trees, brush and debris from site area and access road right of way (if required)
- B. Prior to other excavation and construction efforts clear site of organic material to a minimum of six
- C. Unless otherwise instructed by the Owner, remove trees, brush, and debris from the property to
- D. Prior to placement of fill or base materials, proof roll the soil.
- E. Where unstable soil conditions are encountered, cover cleared areas with stabilizer mat prior to

3.2 Installation

- A. The site and turnaround area shall be at the subbase course elevation prior to forming foundations. Grade or fill the site and access road as required such that there is an even distribution of spoils resulting from foundation excavations. The resulting grade shall correspond with said subbase course; elevations shall be calculated from finished grades or slopes indicated.
- B. Excess spoils, if any, shall be cleared from job site and not spread beyond the limits of Owner/leased property unless authorized by project manager.
- C. The access road shall be brought to base course elevation prior to foundation construction to permit use. Compaction shall be performed during construction of the site.
- D. Avoid creating depressions where water may pond
- E. The Contract shall be assumed to include grading, banking, ditching and unless otherwise indicated, covering with two inches of surface course all roads or routes utilized for access to the Owner site, commencing at the point of intersection with the nearest public thoroughfare.
- F. When improving an existing access road, the existing road shall be graded to remove any organic matter and smooth the surface before placing fill or stone.
- G. Fill material or stone shall be placed in six-inch maximum lifts and compacted as described in Section 2.10 prior to placement of next lift.
- H. The finish grade, including top surface course, shall extend a minimum of three feet beyond the

- Construction method: Place in layers not exceeding 15 inches loose measure. Spread evenly and compact to not less than ninety-five percent (95%) maximum density
- J. Aggregate Base Course:
 - Thickness: Compacted in place in two (2) equal courses
- Aggregate Surface Course:
 Thickness: Compacted in place in two (2) equal courses.
- O. Riprap shall be applied to the side slopes of all fenced site areas, parking areas and to all other
- P. Riprap shall be applied to the side of ditches or drainage swales
- Q. Riprap entire ditch for six feet in all directions at culvert openings
- R. Seed, fertilizer and straw cover shall be applied to all other disturbed areas and ditches, drainage,
- S. Under no circumstances will ditches, swales or culverts be placed such that they direct water ds, or permit standing water immediately adjacent to the site. If Owner designs or eleva conflict with this guidance the Owner should be advised immediately.
- T. If any ditch lies with slopes greater than ten percent, mound diversionary headwalls in the ditch at the culvert entrances 45 degrees off the ditch line. Riprap the upstream side of the headwall as well as the ditch for six feet above the culvert entrance.
- U. Seed and fertilizer shall be applied to surface conditions that will encourage rooting. Rake areas to be seeded to even the surface and loosen the soil.
- V. Saw seed in two directions in twice the quantity recommended by the seed producer
- Contractor is responsible for the growth of seeded and landscaped areas by watering up to the point of release from the Contract. Continue to rework bare areas until complete coverage is obtained

DIVISION 3 - CONCRETE PART 1 - GENERAL

Inspections 1 1

A. LOCAL BUILDING INSPECTION SHALL RECEIVE ADEQUATE NOTIFICATION IN ADVANCE OF CONCRETE POURS.

Summary

A. The work includes all cast-in-place concrete.

1.3 References

- ASTM American Society Testing Materials, latest edition. ACI American Concrete Institute, latest
- ACI 318. Building Code Requirements for Reinforced Concrete

ACI 301. Specifications for Structural Concrete for Buildings

1.4 Submittals

- A. Proposed mix design prepared by an approved independent testing firm for each class of concrete. Select proportions according to ACI 301-05. Section 3.8. Method 1 or Method 2.
- B. Shop drawings showing fabrication dimensions and locations for placing the reinforcing steel and accessories. Details of reinforcement and accessories shall be in accordance with ACI 315
- C. Certifications for the following:
- Cement.
- Aggregates.
 Admixtures.
- 4. Reinforcement

PART 2 - PRODUCTS

- 2.1 Materials
- A. Concrete:1. Cement: ASTM C150 or ASTM C595 (maximum fly ash content shall be 20% by weight). All cement used in exposed concrete shall be of the same brand from the same mil 2. Course aggregates: ASTM C33.
- 3. Fine aggregate: ASTM C33. 4. Mixing water: Clean, fresh, and potable

and configuration of reinforcement bars

- 5. Admixtures: Air-entraining: ASTM C260. Water-reducing, retarding, and accelerating: ASTM C494. Calcium chloride will not be permitted as an admixture. Pozzolanic admixtures: ASTM C618. Type F
- B. Reinforcement: Refer to tower foundation design or tower manufacturer for type for material type
- C. Curing Compound, if needed: ASTM C309

2.15 Field Quality Control

- A. Compaction shall be at least 95% of maximum density and within 2% of optimum moisture content in accordance with ASTM D-1557. Areas of settlement shall be excavated and refilled at Contractor's expense.
- All trees placed in conjunction with a landscape contract will be wrapped, tied with hose protected wire and secured to 2- inch x 2-inch x 4-inch wooden stakes extending two feet into the ground on four sides of the tree.
- C. All exposed areas shall be protected against washouts and soil erosion. Straw bales will be placed at the inlet approach to all new or existing culverts. Where the site or road areas have been elevated immediately adjacent to a rail line, erosion control, fabric will be staked full ength in the swale between the site and the rail bed to prevent contamination of the ra
- D. Field inspection and testing is to be performed by a firm appointed and paid for by the Owner. When additional testing of materials or concrete is necessary because of their failure by test or inspection to meet specification requirements, the cost of the additional testing shall be paid for by the Contractor. Additional testing for early form removal shall also be paid for by
- Acceptance Testing: If initial testing indicates failed or non-conformance to specification, perform additional test. If further testing verifies non-conformance, additional testing shall be paid by CONTRACTOR. Replace non-conforming material at no additional cost to OWNER.

 - A. Sampling and Analysis: Michigan Testing Methods, Series 100.
 B. Exception: Provide certification of approved stockpiled material

2.2 Proportioning Concrete

A. Proportions and Materials: Permissible Cement Types: I, IP, I-A, IP-A

Minimum Cement Content: 5.5 sacks/cu.yd. for 3500 psi, 6.0 sacks/cu.yd. for 4000 psi. Maximum Water-Cement Ratio: 5.0 gal./sack

Entrained Air Content: five percent (5%) to eight percent (8%).

Maximum Slump:3½-inch for floors and slabs on grade, 4 inches otherwise (individual batches may be ±½ inch as long as the average of all batches is at or below maximum).

Minimum Compressive Strength, fc' (28 day) 4000 psi floors and slabs on grade, all other 3500 psi.

- B. Admixtures: Approval of ENGINEER required. Use in accordance with the manufacturer'
- C. If the CONTRACTOR intends to place concrete by pumping, the mix design shall be prepared in accordance with these specifications and the recommendations of ACI 304

2.3 Fabricating Reinforcement

Reinforcing splices: Class B unless otherwise shown

Fabricate in accordance with approved shop drawings and ACI 315.

PART 3 - EXECUTION

3.1 Performance

In accordance with the requirements of ACI 301, Chapters 4 through 13, 17 and 18

Concrete Work For Drilled Piers All concrete piers shall be drilled and poured on the same day to prevent any migration of water into the hole and to prevent debris from collecting in the hole.

3.3 Field Quality Control A. Provide access to all portions of the work and any necessary assistance in obtaining and handling samples at the project or other material sources. Three concrete test cylinders will be taken for every 50 cubic yards, or fraction thereof, for each class of concrete place in any one day. One additional cylinder will be taken during cold weather concreting and be cured on the project site under the same conditions as the concrete it represents. One slump test will be taken for each set of

NOTE: THESE NOTES ARE OF A GENERAL NATURE AND

ARE NOT SITE-SPECIFIC. SOME NOTES MAY NOT APPLY

TO THIS SITE. CROSS-REFERENCE NOTES WITH OTHER

SHEETS AND T-MOBILE SCOPE OF WORK TO VERIFY

WORK TO BE COMPLETED.

LIVONIA, MICHIGAN 48150

Phone: 734.367.7200 Fax: 734.367.7242 CONTACT: KEN KALOUSEK

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LANDTECH PROJECT NUMBER 20398031 DESCRIPTION DATE 07/09/20 PRELIMINARY RELEASE CJL ADD'D ANT. COVER NOTE RELOC PROP ANTENNAS 03/30/22

2020 ANCHOR CONSTRUCTION DRAWINGS

NOTE: THESE DRAWINGS ARE TO SCALE WHEN PLOTTED ON 11"x17" SHEETS. REFE TO GRAPHIC SCALES ON REPRODUCTIONS





SITE #: DE04229B SITE NAME:

HEART OF MARY SITE ADDRESS:

4440 E. CANFIELD D/B/A 4440 RUSSELL ST. **DETROIT, MICHIGAN 48207**

SWEETEST

Sheet Title:

GENERAL NOTES

Sheet Number

N-1

Division 15 - MECHANICAL PART 1 - GENERAL

- 1. Included Work of this section generally includes provisions of labor, materials, equipment. accessories, necessary for installation of mechanical systems shown on the contract drawings and specified in the General Notes. Intent of construction documents is to provide the Owner with a omplete and operating facility, and any minor items omitted but obviously necessary to accomplish ntent shall be provided whether or not shown or specified
- 2. Related The General Requirements division of the General Notes is hereby made a part of the work of this specification. The requirements of this specification apply to the work of all sections of
- A. Work performed by others includes installation of electrical equipment, except as noted otherwise
- B. Electrical division 16

- A. All work shall be executed and inspected in accordance with all underwriter's, public utilities, local and state codes and regulations applicable to the trade affected. Recommendations of AFA, NFPA, OSHA and ASHRAE and applicable state energy code compliance shall be rigidly followed.

 B. Should any change in the plans and specifications be required to comply with these regulations, the
- contractor shall notify the Owner before submitting his bid. After entering into contract with the Owner the contractor will be held accountable to complete all work necessary to meet these requirements a his own expense.
- . Where the work required by the drawings and specifications is above the standard required, it shall
- 4 Permits The contractor shall arrange and pay for all permits in connection with the work hereinafter specified and at completion of the work furnish the Owner with the final certificate of inspection
- 5. Drawings The drawings indicate the general arrangement of the proposed work. Details of d departures due to actual field conditions or other causes shall be provided for. No extras will be paid for correcting faulty, poorly arranged, or poorly coordinated work.
- 6. Site Examination The contractor shall visit the premises so as to ascertain the existing conditions before submitting his bid. No extras will be allowed for his lack of knowledge of these conditions.
- Complete Installation The contractor shall furnish and install all incidental parts, valves, fittings, pumps, control valves and control wiring required for the proper function of all component parts. The complete installation shall function smoothly and noiselessly to the full extent of the plans and specifications. The contractor shall complete his installation as rapidly as general construction permits. All filters, strainers, and safety devices shall be properly installed before starting equipment. The Owner shall be left with a new set of filters at final acceptance.
- 8. Coordination Before any equipment is purchased or fabricated and before running and/or fabricating any lines of piping or ductwork, the mechanical contractor and his subcontractors shall assure themselves that they can be run as contemplated. Because of the small scale of the drawings, it is not possible to indicate all offsets, fittings and accessories that may be required. The mechanical contractor and his subcontractors shall carefully investigate all other mechanical, and electrical and structural drawings and finish conditions affecting all of their work accordingly, furnishing such fittings, valves, duct transitions, offsets and accessories as may be required to meet such conditions, at no
- 9. Temporary Heat Arrangements for usage of system for temporary heat shall be coordinated with peneral contractor. System shall not be used for temporary heat unless all temporary filters are installed. Temporary filters and operation of units shall be provided by the general contractor.
- 10. Submittals Within 5 days after proposal acceptance the contractor shall submit to the Owner for approval two (2) copies of shop drawings on each item of equipment whether as specified or substituted. Shop drawings shall give overall dimensions, weights, metal gauges, materials, certified capacities, brake HP, motor HP, tube diameters friction drop and nameplate data. The contractor shall be responsible for checking shop drawings before submitting for approval. The Owner's check shall be general and does not relieve the contractor of final responsibility for a complete job to the intent of plans and specifications. All control diagrams and equipment should be assembled in one submittal.

11. Substitution of Equipment

- A. Bids shall be based on providing all equipment mentioned by brand name in plans and specifications. No substitutions shall be considered before bidding.
- B. The contractor shall attach a list of proposed substitutions, giving the amount to be added or deducted to contract price for each item. Complete engineering data shall be submitted on each request for substitution item. Substitute items shall be equal or better than items mentioned in regard to all accessories, capacities, durability and appearance. Contractor shall pay all costs incurred to make substitute items fit required space with maintenance clearances - piping, sheet metal, electrical or building alteration shall be included in said costs.
- C. All standard accessories as well as specified extras shall be provided with equipment
- 12. Guarantee All material and workmanship installed and/or furnished under this section of work shall be guaranteed against defects for a period of one year from date of acceptance by Owner. Any ects or faulty workmanship shall be the contractor's responsibility and shall be corrected entirely at

PART 2 - PRODUCTS

- 1. Approved manufacturers approval by name listed in this specification does not imply that the manufacturer standard product meets the intent of the drawings and specification. It is the contractors responsibility to provide all necessary alterations, materials, labor, etc., as approved by the Owner to meet the full intent of the drawings and specifications. This is to include, but not necessarily be limited to electrical, structural, mechanical, and architectural alterations and revisions necessary to provide a complete and operating facility at no additional costs to the Owner.
- 2. Materials Materials throughout shall be new and of the best grades specified. They shall be standard catalog items and manufactured by nationally known manufacturers of the items specified. Contractor shall receive and be responsible for all Owner furnished equipment and provide rough-in and final connections for all mechanical equipment furnished under this contract or by others. The contractors shall provide a suitable shed for the storage of all materials during progress of the job
- 3. Solder All solder used on sweat fittings shall be 95-5 hard solder unless brazing or silver solder is
- 4. Floor, Ceiling Plates, Flanges Provide tight fitting floor and ceiling plates on pipes passing through walls, ceillings, floors, nickel or chrome plate in finished areas. Provide wall and ceiling flanges fo ducts in finished areas.
- 5. Pipe Hangers, Supports Provide hangers, supports, braces by Grinnell, Fee and Mason, Grabler, Elcen, Unistrut, Basin Engineers, Inc. to prevent undue strain, stresses, noise, vibration.

PART 3 - EXECUTION

- A. Work throughout shall be performed by men skilled in the installation of the various trades of the
- B. All piping and ductwork shall be run concealed in finished areas except where noted otherwise or as chrome plated plumbing fixture connections.

 2. Curbs, Bases, Supports - Major curbs, openings, and equipment supports will be provided under the
- general section of this contract only where shown on engineering or structural plans. All other supports, anchors, and bases shall be provided by mechanical contractor for all mechanical equipment. Equipment shall be supported per manufacturer's written recommendations for noise-free installation. 3. Removal of Existing Work - All existing mechanical equipment, piping, etc., removed by the
- contractor shall be the property of the building. Such items will be disposed of at the building owner's
- Removal of Rubbish On completion of his work, the contractor shall remove all of his tools
- scaffolding, debris, etc., from the grounds and leave the premises perfectly clean.

 5. Operating and Maintenance Instructions Upon completion, the contractors shall make up a set of operating and maintenance instructions covering all mechanical equipment with moving or moveable parts including general operating or heating, plumbing and cooling systems and shall give the Owner four (4) copies of these instructions. Manufacturer's printed operations and maintenance instructions
- shall also be provided for each piece of equipment. A. Name, address, and telephone number of party to be contacted for 24 hour service for each item of
- B. Starting, stopping, lubrication, and adjustment shall be clearly indicated for each piece of
- C. Prepare 8-1/2"x11" blueprints with binding edge of appropriate scale to indicate all equipment, respective switches, and valve locations. Bind in instruction book

DIVISION 5 - FENCE

PART 1 - GENERAL

Work Included

A. Refer to the site plans for size and location of fence and gates to be installed.

Related Work

- Coordinate fence grounding with Electrical Contractor.
- Refer to Fence Detail Plan concrete for specification of concrete and grout. C. Refer to Fence Detail Plan for applicable locations of access road gates

A. A security fence is provided in order to inhibit unauthorized access to the site area

3 4 Quality Assurance

Refer to Fence Detail Plan

Sequencing

A. If the site area has been brought up to surface course elevation prior to fence construction, fence post excavation spoils must be controlled to preclude contamination of surface course.

Submittals

- Manufacturer's descriptive literature.
 Certificate of compliance that specifications have been met.

Fence Material

Refer to Fence Detail Plan.

DIVISION 7 - ANTENNA SYSTEM

PART 1 - GENERAL

1.1 Work Included

- A. Erect furnished tower as indicated in the drawings.
- Install antennas as indicated on drawings and Owner specifications Install antenna platform as indicated on drawings.
- Install furnished galvanized steel waveguide ladder.
 Install waveguide bridge as indicated on drawings.
- Install coax cable, connectors, jumpers, grounding kits as indicated in drawings.
- Sweep test result.

1.2 Requirements of Regulatory Agencies

- A. Furnish U.L. listed equipment were such label is available, install in conformance with U.L.
- B. Install antenna, antenna cables, grounding system in accordance with drawings and specification in effect at project location and recommendations of state and local building codes, special codes having jurisdiction over specific portions of work. This includes, but is not limited to, the following:
- 1. FIA Electrical Industries Association RE 222, structural standards for steel, antenna towers and antenna supporting structures.

 2. FAA - Federal Aviation Administration advisory circular AC 70/7460-IH, obstruction marking and
- lighting.

 3. FCC Federal Communications Commission rules and regulations form 715 "obstruction marking".
- and lighting specifications for antenna structures", and form 715A, "high intensity obstruction lighting specification for antenna structures".

 4. DISC American Institute of Steel Construction specifications for structural joints using ASST. A325
- NECK National Electrical Code on tower lighting kits.

- UL Underwriter's Laboratories approved.
 In all cases part 77 or the FAA rules and parts 17 and 22 of the FCC rules are applicable and in the

DIVISION 16 - GENERAL ELECTRIC PART 1 - GENERAL ELECTRICAL PROVISION

- Submittal of bid indicates Contractor is cognizant of all job site conditions and work to be performed under this contract.
- 2. Contractor shall perform all verification, observations, tests, and examination work prior to the ordering of the electrical equipment and the actual construction. Contractor shall issue a written notice of all findings to the architect listing all malfunctions, faulty equipment and discrepancies.

- Heights shall be verified with Owner prior to installa These plans are diagrammatic only. Electrical Service 120/240 V.A.C. single phase 3-wire 100 AMP service. Contractor shall provide all labor, materials, insurance, equipment, installation, construction tools, transportation, etc. for a complete and properly operative system energized throughout and as
- indicated on drawings, as specified herein and/or as otherwise required Contractor shall carry out all work in accordance with all governing state, county, and local codes
- Contractor shall secure all necessary building permits and pay all required fees
- Complete job shall be guaranteed by the Contractor for a period of one (1) year after the date of
 job acceptance by Owner. Any work, material, or equipment found to be faulty during that period shall be corrected at once, upon written notification, at the expense of the Contractor.
- Provide project manager with one set of complete electrical "as installed" drawings at th completion of the job, showing actual dimensions, routings and circuits.
- The entire electrical installation shall be grounded as required by all applicable codes.
 Upon completion of work, conduct continuity, short circuit and fall potential ground tests for approval. Submit test reports to project manager. Clean premises or all debris resulting from work and leave work in a complete and undamaged condition

PART 2 - PRODUCTS

- A. All materials and equipment shall be new and in perfect condition when installed and shall be of the best grade and of the same manufacturer throughout for each class or group of equipment.

 Material shall be listed "J" where subject to such approval. Materials shall meet with approval of the division of industrial safety and all governing bodies having jurisdiction. Materials shall be manufactured in accordance with applicable standards established by ANSI, NEMA and NBFU.
- All conduit only (C.O.) shall have a pull wire or rope.
- All conductors shall be copper.
- D. All circuit breakers, fuses and electrical equipment shall have an interrupting short circuit to which they may be subjected, and a minimum of 10,000 A.I.C.

 E. Wire and cable conductors shall be copper 12 AWG Minimum unless specifically noted otherwise
- Grounding conductors shall be solid tinned copper and annealed +2
- Meter socket amperes, voltage, number of phases shall be as noted on the drawings, matcharder by Square D Company or approved equal.
 All material shall be U.L. listed.

- All underground conduit shall be PVC schedule 40 (unless noted otherwise) at a minimum depth of
- . All ground cable shall be standard TND solid bare copper plate and of size indicated on drawings When the direction of the conductor must change it shall be done gradually. The curvature of the turn shall be done in accordance with the following table:

Grounding Conductor Size

Min Bending Radius to Inside Edge

No. 6 awg. to no. 4 awg o. 6 awg to no. 1/0 awg No. 2/0 awg. to 750 mcrn No Restrictions

PART 3 - UNDERGROUND ELECTRICAL SERVICE

- Coordinate the electrical service with the utility company.
 Contractor to coordinate with utility company connection of temporary and permanent power to the site. The temporary power and all hookup costs to be paid by contractor.
- C. The service shall be installed in accordance with all applicable codes and standards to be
- stable to the governing authorities exercising legal jurisdiction over electrical installat

PART 4 - GROUNDING CONNECTIONS

All external grounding connections shall be made by the "cadweld" process. Connections shall include all cable to cable splices, Tees, Xs, etc. All cable to ground rods, ground rod splices and lightning protection system as indicated. All materials used (molds, welding, metal, tools, etc.) shall be by "cadweld" and installed per manufacturer's recommendation and procedures. 2. All interior grounding and bonding conductors shall be connected by two holes crimp type (compression) connections (except for the ACEG and ground rod) mechanical connections, fitting or connections that depend solely on solder shall not be used.

All ground rods shall be 5/8" diameter x 10'-0" long "Copperweld" or approved equal of the number and at locations indicated. Ground rods shall be driven full length vertical in undisturbed earth. All ground rods to be 10' apart unless otherwise

C Ground Bars

All ground bars shall be 1/4" thick bare copper plate and of size indicated on drawings

- The ground ring encircling the building shall be minimum size of no. 2 awg bare copper conductor in direct contact with the earth at a depth of not less than 42 inches (min) conductor bends shall have a minimum radius of 8 inches
- 2. All external ground rings shall be joined together and all connections shall be "cadweld". NO LUGS OR CLAMPS WILL BE ACCEPTED.
- E. Fence/Gate All sections of fence and gate shall be grounded as indicated on drawings. Ground each gate post and corner post. All other connections for the ground grid system shall be made by the "cadweld" process, and installed per manufacturer's recommendations and procedures.
- F. Ground test pit A ground test pit shall consist of 6" diameter SCH 40 PVC with 6" cleanout plug & cleanout adapter fitting. Plug threads shall be coated with anti-seize lubricant prior to installation. 6" PVC will be 18" long, buried 12" underground with 6" above finished grade. Top of Ground rod elded to ground ring will be 12" from top of cleanout adapter

PART 5 - ASTM Fall Potential Tests

- A. Ground tests shall be performed as indicated on drawings. A biddle ground ohm meter or the method of using two auxiliary ground rods (as described in I.E.E.E. standard no. 81-1983, part 1) may be used. The I.E.E.E. method requires the use of an a.c. test current. The auxiliary test rods must be sufficiently far away from the rod under test so that the regions in which their resistance is localized do
- Contractor to conduct ground resistance test in the format as follows:
- Equipment Building
 First test shall be with four ground rods installed, one at each corner of the building but not connected to the main grounding bus. Furnish wire to connect (temporary clamp) all four ground rods together to make a system test after each rod is individually tested. If any individual rod tests 25 OHMS or more, the electrical contractor and owner's representative should be notified so that the rod can be driven deeper until all four rods have a resistance of 10 OHMS or less on a dry day. B. Second test - shall be with the ground rods connected with dry soil and when no standing water has been present for the past ten days. The maximum allowable reading is 5 OHMS to ground. If the resistance of the entire system exceeds 5 OHMS, the electrical contractor and owner's representative should be notified so that either additional and/or deeper rods can be installed.
- A. First test shall be with nine (9) ground rods installed (min.) equally spaced around the tower foundation, but not connected to the equipment building external ground ring. Furnish wire to connect (temporary clamp) all three ground rods together to make a system test after each rod is OHMS or more, the electrical engineer and the owner's representative should be notified so that the rod can be driven deeper until all three rods have a resistance of 10 OHMS or less on a dry day.

 B. Second test - shall be with the grounds connected, with dry soil and when no standing water has
- been present for the past ten days, the maximum allowable reading is 5 OHMS to ground. If the resistance of the entire system exceeds 5 OHMS the electrical contractor and owner's represental should be notified so that either additional and/or deeper rods can be installed. Equipment Building and Tower A. After the equipment building and tower ground resistance test is completed, electrical contractor shall tie equipment building external ground ring together. After first and second test, all connections
- shall be "cadweld". No lugs or clamps will be accepted. B. After all the external ground rings are tied together but before the equipment building is tied down, a megger check of the ground system should be done. The maximum allowable reading is 5 OHMS to
- Ground Resistance Test Report
- Upon completion of the testing for each site, Contractor shall submit a test report showing resistance in OHMS with auxiliary potential electrodes at 5-foot and 10-foot intervals until the average resistance starts increasing; 10-15 photos must be taken to proof entire external ground ring system before backfill or project manager must be notified no less than 48 hours in advance of backfill. Testing shall be pleted by general contractor and two (2) sets of test documents are to be bound and submitted

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ARE NOT SITE-SPECIFIC. SOME NOTES MAY NOT APPLY TO THIS SITE. CROSS-REFERENCE NOTES WITH OTHER SHEETS AND T-MOBILE SCOPE OF WORK TO VERIFY

WORK TO BE COMPLETED.

LIVONIA, MICHIGAN 48150 Phone: 734.367.7200


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LANDTECH PROJECT NUMBER 20398031 DATE DESCRIPTION 07/09/20 PRELIMINARY RELEASE CJL ADD'D ANT. COVER NOTE 03/30/22 RELOC PROP ANTENNAS

2020 ANCHOR CONSTRUCTION **DRAWINGS**

NOTE: THESE DRAWINGS ARE TO SCALE WHEN PLOTTED ON 11"x17" SHEETS. REFE TO GRAPHIC SCALES ON REPRODUCTIONS



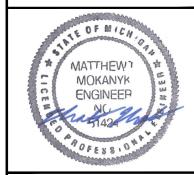

DE04229B SITE NAME:

SWEETEST HEART OF MARY

SITE ADDRESS:

4440 E. CANFIELD D/B/A 4440 RUSSELL ST. **DETROIT, MICHIGAN 48207**

Sheet Title:

GENERAL NOTES

Sheet Number:

N-2