EXISTING STRUCTURE

THIS BUILDING IS REVIEWED UNDER THE 2015 MICHIGAN REHABILITATION CODE FOR EXISTING BUILDINGS, CHAPTER 7: ALTERATION LEVEL 1 AND CHAPTER 8: ALTERATION LEVEL 2.

503.1 SCOPE. LEVEL 1 ALTERATIONS INCLUDE THE REMOVAL AND REPLACEMENT OR THE COVERING OF EXISTING MATERIALS, ELEMENTS, EQUIPMENT, OR FIXTURES USING NEW MATERIALS, ELEMENTS, EQUIPMENT, OR FIXTURES THAT SERVE THE SAME PURPOSE.

503.2 APPLICATION. LEVEL 1 ALTERATIONS SHALL COMPLY WITH THE PROVISIONS OF CHAPTER 7.

SECTION 504 ALTERATION-LEVEL 2

504.1 SCOPE. LEVEL 2 ALTERATIONS INCLUDE THE RECONFIGURATION OF SPACE, THE ADDITION OR ELIMINATION OF ANY DOOR OR WINDOW, THE RECONFIGURATION OR EXTENSION OF ANY SYSTEM, OR THE INSTALLATION OF ANY ADDITIONAL EQUIPMENT.

504.2 APPLICATION. LEVEL 2 ALTERATIONS SHALL COMPLY WITH THE PROVISIONS OF CHAPTER 7 FOR LEVEL 1 ALTERATIONS AS WELL AS THE PROVISIONS OF CHAPTER 8.

SECTION 508 HISTORIC BUILDINGS

508.1 SCOPE. HISTORIC BUILDING PROVISIONS SHALL APPLY TO BUILDINGS CLASSIFIED AS HISTORIC AS DEFINED IN CHAPTER 2.

508.2 APPLICATION. EXCEPT AS SPECIFICALLY PROVIDED FOR IN CHAPTER 12, HISTORIC BUILDINGS SHALL COMPLY WITH APPLICABLE PROVISIONS OF THIS CODE FOR THE TYPE OF WORK BEING PERFORMED.

705.1 GENERAL. A BUILDING, FACILITY, OR ELEMENT THAT IS ACCESSIBLE SHALL REMAIN ACCESSIBLE IN ACCORDANCE WITH THE REQUIREMENTS OF THE UTILIZATION OF PUBLIC FACILITIES BY PHYSICALLY LIMITED, 1966 PA 1, MCL 125.1351 TO 125.1356, AND THE MICHIGAN BUILDING CODE, R 408.30401 TO R 408.30499. R 408.30574

SECTION 806 ACCESSIBILITY

806.1 GENERAL. A BUILDING, FACILITY, OR ELEMENT THAT IS ALTERED SHALL COMPLY WITH THIS SECTION AND SECTION 410. R 408.30577

410.9 HISTORIC BUILDINGS.

THESE PROVISIONS SHALL APPLY TO FACILITIES DESIGNATED AS HISTORIC STRUCTURES THAT UNDERGO ALTERATIONS OR A CHANGE OF OCCUPANCY, UNLESS TECHNICALLY INFEASIBLE.

WHERE COMPLIANCE WITH THE REQUIREMENTS FOR ACCESSIBLE ROUTES, ENTRANCES OR TOILET ROOMS WOULD THREATEN OR DESTROY THE HISTORIC SIGNIFICANCE OF THE FACILITY, AS DETERMINED BY THE APPLICABLE GOVERNING AUTHORITY, THE ALTERNATIVE REQUIREMENTS OF SECTIONS 410.9.1 THROUGH 410.9.4 FOR THAT ELEMENT SHALL BE PERMITTED.

EXCEPTION: TYPE B DWELLING OR SLEEPING UNITS REQUIRED BY SECTION 1107 OF THE INTERNATIONAL BUILDING CODE ARE NOT REQUIRED TO BE PROVIDED IN HISTORICAL BUILDINGS. 410.9.1 SITE ARRIVAL POINTS. AT LEAST ONE ACCESSIBLE ROUTE FROM A SITE ARRIVAL POINT TO AN ACCESSIBLE ENTRANCE SHALL BE PROVIDED.

410.9.2 MULTILEVEL BUILDINGS AND FACILITIES. AN ACCESSIBLE ROUTE FROM AN ACCESSIBLE ENTRANCE TO PUBLIC SPACES ON THE LEVEL OF THE ACCESSIBLE ENTRANCE SHALL BE PROVIDED.

410.9.3 ENTRANCES. AT LEAST ONE MAIN ENTRANCE SHALL BE ACCESSIBLE. **EXCEPTIONS:**

1. IF A MAIN ENTRANCE CANNOT BE MADE ACCESSIBLE, AN ACCESSIBLE NONPUBLIC ENTRANCE THAT IS UNLOCKED WHILE THE BUILDING IS OCCUPIED SHALL BE PROVIDED;

2. IF A MAIN ENTRANCE CANNOT BE MADE ACCESSIBLE, A LOCKED ACCESSIBLE ENTRANCE WITH A NOTIFICATION SYSTEM OR REMOTE MONITORING SHALL BE PROVIDED. SIGNS COMPLYING WITH SECTION 1111 OF THE INTERNATIONAL BUILDING CODE SHALL BE PROVIDED AT THE PRIMARY ENTRANCE AND THE ACCESSIBLE ENTRANCE.

410.9.4 TOILET AND BATHING FACILITIES. WHERE TOILET ROOMS ARE PROVIDED, AT LEAST ONE ACCESSIBLE FAMILY OR ASSISTED-USE TOILET ROOM COMPLYING WITH SECTION 1109.2.1 OF THE INTERNATIONAL BUILDING CODE SHALL BE PROVIDED.

WORK DOES NOT INCLUDE A CHANGE IN USE OR OCCUPANCY TO THE BUILDING.

WORK DOES NOT INCLUDE AN ADDITION TO THE EXISTING BUILDING

SEE SHEET G102 CODE SUMMARY FOR FURTHER INFORMATION.

3	AREA TA	BULATION
	NUMBER OF 1 BEDROOM	REFER TO SHEET G102
	NUMBER OF 2 BEDROOM	REFER TO SHEET G102
	NUMBER OF 3 BEDROOM	REFER TO SHEET G102
	NUMBER OF PARKING SPACES, OPEN AND	48/13



MIDTOWN SQUARE

93 SEWARD AVENUE PROJECT LOCATION: **CONSULTING ARCHITECT:** DETROIT, MI 48202

MIDTOWN SQUARE II LDHA LP

93 SEWARD AVENUE

DETROIT, MI 48202

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KATERRA

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CODE SUMMARY

ALTERATIONS TYPE 1 AND 2 TO AN EXISTING 8-STORY R-2 PROJECT DESCRIPTION: APARTMENT BUILDING COMPRISING 73 APARTMENTS. NO

INCREASE IN HEIGHT OR AREA.

ZONING:

OCCUPANCY CLASSIFICATION:

CONSTRUCTION TYPE: TYPE 1B, SPRINKLERED, FIRE ALARM SYSTEM

OCCUPANT LOAD: 422 PERSONS

APPLICABLE CODES: MICHIGAN REHABILITATION CODE FOR EXISTING BUILDINGS BUILDING: (MRCEB) 2015, CHAPTER 5

MICHIGAN MECHANICAL CODE (MMC) 2015

MICHIGAN PLUMBING CODE (MPC) 2015

WITH PART 8 AMENDMENTS

NFPA 101 2000 / DETROIT FIRE CODE

MICHIGAN UNIFORM ENERGY CODE 2015 A BUILDING THAT HAS BEEN SPECIFICALLY DESIGNATED AS HISTORICALLY SIGNIFICANT BY THE ADOPTING AUTHORITY OR IS LISTED IN THE NATIONAL REGISTER OF HISTORIC PLACES OR HAS BEEN DETERMINED TO BE ELIGIBLE FOR LISTING BY THE U.S. SECRETARY OF THE INTERIOR NEED NOT COMPLY WITH THE PROVISIONS OF

MICHIGAN/NATIONAL ELECTRICAL CODE (NEC) 2014

SECTIONS 5, 6, 7, 8, 9 AND 10 OF THE ASHRAE 90.1 STANDARD. (ASHRAE 90.1, EXCEPTION 1 TO PARAGRAPH 4.2.1.3, REFERENCED BY MEC C503.1)

MICHIGAN REHABILITATION CODE FOR EXISTING BUILDINGS

(MRCEB) 2015, SECTION 410. ALTERATIONS REFERENCE MBC 2015, ICC/ANSI A117.1 2009 EX 611/707. ADA ACCESSIBILITY GUIDELINES (ADAAG)

DETROIT ELEVATOR CODE 1997 REFERENCE ASME A17.1-1993, ASME A18.1-2003

BID ALTERNATE 1:

<u>BID ALTERNATE 2:</u> DEDUCT ALTERNATE:


DEDUCT ALTERNATE

DEFERRED SUBMITTALS

NOTE: THESE CONSTRUCTION DOCUMENTS WERE PREPARED FOR COMPLIANCE WITH THE LOCAL CONSTRUCTION CODES IN EFFECT AT TIME OF PERMIT SUBMITTAL. ALL ENGINEERS, CONTRACTORS AND SUPPLIERS INVOLVED WITH THIS PROJECT SHALL COMPLY WITH THE SAME CODES, ISSUED AND APPROVED CODE MODIFICATIONS AND/OR LOCAL CONSTRUCTION BOARDS OF APPEALS RULINGS AND WHENEVER REQUIRED SHALL PROVIDE SHOP DRAWINGS AND SUBMITTALS CLEARLY DESCRIBING COMPLIANCE TO THE REGISTERED DESIGN PROFESSIONAL IN RESPONSIBLE CHARGE FOR REVIEW AND APPROVAL

THE FOLLOWING SUBMITTALS SHALL BE PREPARED BY OTHERS AND INCLUDED AS PART OF THE CONSTRUCTION DOCUMENTS AS THEY BECOME AVAILABLE: (PER SECTION 107.3.4.2)

- AUXILIARY POWER SYSTEMS AWNINGS
 - PREFABRICATED STAIRS SIGNAGE
- ELECTRICAL SYSTEMS (DESIGN-BUILD)
- EMERGENCY CALL SYSTEMS
- EXIT ILLUMINATION FIRE ALARM SYSTEMS
- FIRE STOPPING SYSTEMS
- FIRE SUPPRESSION SYSTEMS INTERCOM SYSTEMS
- IRRIGATION SYSTEMS MATERIAL SAFETY AND DATA SHEETS
- (MSDS) FOR INTERIOR FINISHES
- PLUMBING SYSTEMS

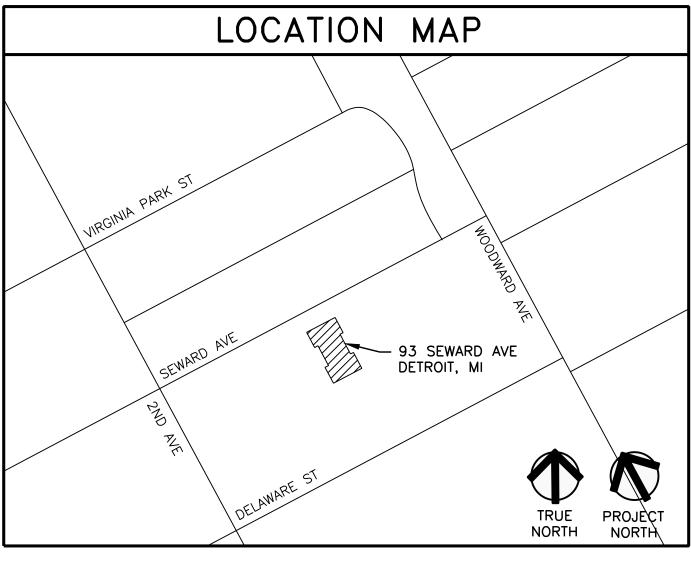

Architect

Consultant

Project / Owner



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2020051 **Project Number**

Sheet Title **COVER**

Sheet Number

CHAPTER 6 - TYPES OF CONSTRUCTION CONSTRUCTION CLASSIFICATION (SECTION 602, TABLE 601): 1B FIRE RESISTANCE RATING FOR INDIVIDUAL STRUCTURAL ELEMENTS (TABLE 601):

SENERAL DESCRIPTION PROJECT NAME: 93 SEWARD STREET, DETROIT AKA MIDTOWN SQUARE PROJECT DESCRIPTION: ALTERATION LEVEL 1 & 2 TO AN EXISTING HISTORIC 8-STORY APARTMENT BUILDING APPLICABLE CODES: MICHIGAN REHABILITATION CODE FOR EXISTING BUILDINGS 2015-CHAPTER 7 AND CHAPTER 8 (MRC) MICHIGAN BUILDING CODE 2015 (MBC), AS REFERENCED BY MRC MICHIGAN PART 9a MECHANICAL CODE 2015 (MMC) COMBUSTIBLE MATERIALS PERMITTED (SECTION 603.1: INCLUDING MILLWORK, WALL & CEILING FINISHES, & <u>CHAPTER 7 - FIRE AND SMOKE PROTECTION FEATURES</u> FREQUENCY TRANSIT CORRIDOR - WOODWARD AVENUE IS CORRIDOR #4). 73 D.U. X 0.75 = 55 PARKING SPACES 1 SPACE AT 12' X 35' FOR TOTAL GFA BTWN 10K & 100K

BUILDING AREA NO CHANGE TO BUILDING AREA, UNLIMITED AREA FOR R-2 IN 1B CONSTR.

ACCESSORY OCCUPANCIES (SECTION 508.2): MECHANICAL AND ELECTRICAL ROOMS ON 1ST FLOOR NON-SEPARATED OCCUPANCIES (SECTION 508.3): INCIDENTAL ELECTRICAL/TELCO CLOSETS ON EACH FLOOR SEPARATION OF MIXED OCCUPANCIES (SECTION 508.4):

VERTICAL SEPARATIONS (SECTIONS 508.4.4, 707.3.9, 711.2.4.1, AND 712.1.13, (TABLE 508.4): BUILDING IS NOT MIXED-USE

HORIZONTAL SEPARATIONS (SECTION 510.2): BUILDING IS NOT MIXED-USE

INCIDENTAL USE AREAS (SECTION 509, TABLE 509): WASTE COLLECTION ROOMS OVER 100 SF: 1 HR FIRE RATING OR AUTOMATIC SPRINKLER SYSTEM LAUNDRY ROOMS OVER 100 SF: 1 HR FIRE RATING OR AUTOMATIC SPRINKLER SYSTEM FURNACE/BOILER ROOMS: 1 HR FIRE RATING OR AUTOMATIC FIRE-EXTINGUISHING SYSTEM

ADDITIONAL EGRESS NOTES • THE MEANS OF EGRESS SHALL BE ILLUMINATED AT ALL TIMES (SEE MRC SECTION 1401.6.15) · ACCESSIBLE MEANS OF EGRESS ARE NOT REQUIRED TO BE PROVIDED IN EXISTING BUILDINGS. (MBC

MAXIMUM ALLOWABLE LENGTH: 250 FT PER YABLE 1017.2 (SEE ALSO MRC CH 14 SUMMARY)

MAXIMUM ALLOWABLE LENGTH: 50 FT PER 1020.4 (SEE ALSO MRC CH 14 SUMMARY)

EXIT ACCESS TRAVEL DISTANCE (SECTION 1017.2, AS REFERENCED BY MRC 1401.6.13):

STRUCTURAL FRAME: 2 HRS

X<5 FT = 1 HT

BLOCKING)

5FT <= X < 10 FT = 1 HR10FT <= X < 30 FT = 1 HR

(SECTIONS 705 AND 716, TABLE 705.8):

HORIZONTAL EXIT (SECTION 1026.2): 2 HRS

SHAFTS LESS THAN FOUR STORIES

CORRIDOR WALLS (TABLE 1020.1):

CHAPTER 8 - INTERIOR FINISHES

ROOMS AND ENCLOSED SPACES:

REQUIRED: FULLY SPRINKLED.

ADDITIONAL FIRE PROTECTION NOTES: NONE

<u>CHAPTER 10 – MEANS OF EGRESS</u>

CORRIDOR WIDTH (SECTIONS 1005 & 1020.2):

MINIMUM REQUIRED AT EACH FLOOR: 44"

MINIMUM PROVIDED AT EACH FLOOR: 33.75"

COMMON PATH OF EGRESS TRAVEL (SECTION 1006.2.1):

MAXIMUM ALLOWABLE LENGTH: 125 FT

MAXIMUM LENGTH PROVIDED: ### FT

MINIMUM PROVIDED: <u>95 FT EXISTING</u>

DEAD END CORRIDORS (SECTION 1401.6.12):

EGRESS DOOR WIDTH (SECTIONS 1005 & 1010.1): MINIMUM REQUIRED AT EACH FLOOR: 32"

MINIMUM PROVIDED AT EACH FLOOR: 59" EXISTING

REQUIRED PER FLOOR: 2

PROVIDED PER FLOOR: 2

STAIRWAY WIDTH (SECTIONS 1005):

MINIMUM REQUIRED: <u>44"</u>

MINIMUM PROVIDED: 44" EXISTING

EXIT SEPARATION DISTANCE (SECTION 1007):

MINIMUM ALLOWABLE: <u>55 FT</u>

MAXIMUM PROVIDED: ### FT

MAXIMUM PROVIDED: ### FT

STANDPIPE SYSTEM (SECTION 905):

CHAPTER 9 - FIRE PROTECTION SYSTEMS

DEFERRED SUBMITTAL: DESIGN/BUILD FIRE SUPPRESSION DRAWINGS

SMOKE DETECTION AND FIRE ALARM SYSTEM (SECTION 907): REQUIRED: <u>AUTOMATIC SMOKE DETECTORS</u>

AUTOMATIC SPRINKLER SYSTEM (SECTIONS 903 AND 904):

REQUIRED: CLASS 1 WET STANDPIPES

HORIZONTAL ASSEMBLIES:

FIRE RESISTANCE RATING FOR ALL SHAFT ENCLOSURES (SECTION 713):

HOISTWAY ENCLOSURES (SECTION 713.14): 2 HRS

FIRE RESISTANCE RATING FOR FIRE PARTITIONS (SECTION 708):

DEMISING WALLS (SECTIONS 420.2 AND 708):

X >= 30 FT = 0 HRS

EXTERIOR BEARING WALLS: 2 HRS

INTERIOR BEARING WALLS: 2 HRS

EXTERIOR NONBEARING WALLS AND PARTITIONS (TABLE 602): <u>SEE BELOW</u>

FLOOR CONSTRUCTION - INCLUDING SUPPORTING BEAMS AND JOISTS: 2 HRS

ROOF CONSTRUCTION - INCLUDING SUPPORTING BEAMS AND JOISTS: 1 HRS

(TABLE 602): FRONT= 0 HRS, EAST SIDE=1HR, WEST SIDE= 0 HRS, REAR = 0 HRS.

FIRE RESISTANCE RATING FOR ALL FIRE WALLS (SECTION 706, TABLE 706.4): 3 HRS

INTERIOR NONBEARING WALLS AND PARTITIONS: <u>O HRS</u>

FIRE-RESISTANCE RATING FOR EXTERIOR WALLS BASED ON FIRE SEPARATION DIST

FIRE RESISTIVE REQUIREMENTS FOR OPENINGS IN FIRE-RATED EXTERIOR WALLS

MAX EXISTING AREA OF OPENINGS/STORY (SECTION 705.8.4):

ALLOWABLE AREA OF OPENINGS PER STORY - EAST WALL (SECTION 705.8):

<u>0% PROTECTED + 15.3% UNPROTECTED</u>

AUTOMATIC SPRINKLER SYSTEM, OPENINGS PROTECTED BY WATER CURTAIN(S)

FIRE RESISTANCE RATINGS FOR ALL VERTICAL/HORIZONTAL FIRE BARRIERS (SECTION 707):

SINGLE OCCUPANCY FIRE AREAS (SECTIONS 707 & 711.2.4.2, TABLE 707.3.10): NOT APPLICABLE

FOUR-STORY (OR GREATER) SHAFTS: <u>2 HRS (OR FLOOR RATING IF GREATER)</u>

EXIT ENCLOSURES (SECTION 1023.2): 2 HRS (4 STORIES OR MORE)

REFUSE CHUTE AND CONNECTED WASTE ROOM (SECTION 713.13): 2 HRS

REQUIRED FINISH LEVEL: (TABLE 803.11): SEE SHEET A501 FOR FINISH DESCRIPTIONS

PROPOSED: SEE ELECTRICAL AND FIRE PROTECTION DRAWINGS FOR ADDITIONAL INFO.

PROPOSED: PROVIDED PER MBC SECTION 905. SEE FIRE PROTECTION DRAWINGS

PROVIDE FIRE DEPARTMENT CONNECTIONS PER APPLICABLE NFPA STANDARD (SECTION 912).

EXTERIOR OPENINGS PROTECTED BY WATER CURTAIN (SECTION 705.8.2): NO

SEE FIRE PROTECTION DRAWINGS FOR ADDITIONAL INFO

FOR OCCUPANT LOADS (SECTION 1004), SEE LIFE SAFETY DIAGRAMS.

NUMBER OF EXITS (SECTION 1006, TABLES 1006.2.1 AND 1006.3.1):

PROPOSED: <u>FULLY SPRINKLED PER MBC SECTION 903. SEE FIRE PROTECTION DRAWINGS</u>

PORTABLE FIRE EXTINGUISHERS (SECTION 906): MAX TRAVEL DISTANCE TO EXTINGUISHER = 75 FEET

EXIT PASSAGEWAYS AND INTERIOR EXIT STAIRWAYS AND RAMPS:

CORRIDORS AND INTERIOR EXIT ACCESS STAIRWAYS AND RAMPS:

FIRE RESISTIVE RATING OF OPENINGS (SECTION 716, TABLE 716.5): 3 HR RATED DOORS

EXCEPTION TO PROTECTED OPENINGS IN EXTERIOR WALLS (SECTION 705.8.2): BUILDING EQUIPPED WITH

1 HR (LESS THAN 4 STORIES)

1 HR (OR FLOOR RATING IF GREATER)

<u>1 HRS</u>

EXIT PASSAGEWAY (SECTION 1024.3): 1 HR MIN (NOT LESS THAN ANY CONNECTING EXIT ENCLOSURE)

ELEVATOR LOBBY SEPARATION (SECTION 713.14.1): NO REQ FOR EXISTING BUILDING, SPRINKLERED

<u>0% PROTECTED + 25% UNPROTECTED</u>

SECTION 1009.1, EXCEPTION 1) • AN AREA OF REFUGE IS NOT PROVIDED AT EXIT STAIRWAYS PER MBC SECTION 1009.3 EXCEPTION 5 CHAPTER 11 - ACCESSIBILITY

REQUIRED BARRIER-FREE DWELLING/SLEEPING UNITS 'ACCESSIBLE' UNITS (TABLE 1107.6.1.1) WITHOUT ROLL-IN SHOWERS:

REQUIRED: 3 PROVIDED: 3 WITH ROLL-IN SHOWERS: REQUIRED: 1 PROVIDED: 5 'TYPE A' UNITS (SECTION 1107.6.2.2.1):

REQUIRED: 2

PROVIDED: <u>0 EXISTING</u> 'TYPE B' UNITS: NOT REQUIRED PER MRC SECTION 410.9, EXCEPTION FOR HISTORIC BUILDINGS

R-2 DWELLING UNITS WITH COMMUNICATIONS FEATURES: (SECTION 907.5.2.3.3) ALL DWELLING UNITS ARE PROVIDED WITH THE CAPABILITY TO SUPPORT VISIBLE ALARM NOTIFICATION APPLIANCES IN ACCORDANCE WITH CH. 1006 OF ICC A117.1

CHAPTER 12 - INTERIOR ENVIRONMENT

MINIMUM CEILING HEIGHT (SECTION 1208.2): 7'-6" AFF

MINIMUM CEILING HEIGHT IN TOILET ROOMS, KITCHENS, STORAGE ROOMS, AND LAUNDRY (SECTION 1208.2): <u>7'-0" AFF</u>

ROOMS WITH EXISTING NON-COMPLIANT CEILING HEIGHTS (SEE ALSO REFLECTED CEILING PLANS):

TOILET ROOM & BATHROOM FINISH MATERIALS (SECTION 1210):

IN ALL TOILET, BATHING AND SHOWER ROOMS, FLOOR FINISHES AND FINISHES ON WALLS AND PARTITIONS WITHIN 2 FEET OF SERVICE SINKS, URINALS AND WATER CLOSETS SHALL BE HARD AND

CHAPTER 13 - ENERGY EFFICIENCY

HISTORIC BUILDING EXCEPTION (MUEC SECTION 101.4.2): ANY BUILDING OR STRUCTURE THAT IS LISTED IN THE STATE OR NATIONAL REGISTER OF HISTORIC PLACES; DESIGNATED AS A HISTORIC PROPERTY UNDER LOCAL OR STATE DESIGNATION LAW OR SURVEY; CERTIFIED AS A CONTRIBUTING RESOURCE WITH A NATIONAL REGISTER LISTED OR LOCALLY DESIGNATED HISTORIC DISTRICT; OR WITH AN OPINION CERTIFICATION THAT THE PROPERTY IS ELIGIBLE TO BE LISTED ON THE NATIONAL OR STATE REGISTERS OF HISTORIC PLACES EITHER INDIVIDUALLY OR AS A CONTRIBUTING BUILDING TO A HISTORIC DISTRICT BY THE STATE HISTORIC PRESERVATION OFFICER OR THE KEEPER OF THE NATIONAL REGISTER OF HISTORIC PLACES, ARE EXEMPT FROM THIS CODE.

CHAPTER 17 - SPECIAL INSPECTIONS & TEST

SPECIAL INSPECTIONS: ARCHITECTURAL SPECIAL INSPECTIONS: SPRAYED FIRE-RESISTANT MATERIALS (MBC SECTION 1705.14)

MASTIC AND INTUMESCENT FIRE-RESISTANT COATINGS (MBC SECTION 1705.15) FIRE-RESISTANT PENETRATIONS AND JOINTS (MBC SECTION 1705.17)

FOR OTHER SPECIAL INSPECTIONS, SEE STRUCTURAL AND MEP DRAWINGS.

CHAPTER 29 - PLUMBING SYSTEMS

SEE MBC SECTION 1109.5 RE: NUMBER OF ACCESSIBLE FIXTURES REQUIRED.

TOILET FIXTURES REQUIRED (MPC TABLE 403.1): 1 PER DWELLING UNIT TOILET FIXTURES PROVIDED: 1 PER DWELLING UNIT

DRINKING FOUNTAINS (MPC TABLE 403.1, SECTION 410.1; MBC SECTION 1109.5): NONE REQUIRED FOR R-2

SERVICE SINKS (MPC TABLE 403.1):

1 KITCHEN SINK PER DWELLING UNIT REQUIRED. 1 KITCHEN SINK PER DWELLING UNIT PROVIDED.

CHAPTER 30 - ELEVATORS AND CONVEYING SYSTEMS

PROVIDE DESCRIPTION OF ELEVATOR HOISTWAY CONDITION IN EXISTING BUILDINGS. ARE EXISTING SHAFTS BEING UTILIZED AND MODERNIZED? ARE NEW SHAFTS BEING BUILT? EXPLAIN SCOPE OF WORK FOR MODERNIZED CABS/HOISTWAYS. IF MULTIPLE CONDITIONS EXIST, DESCRIBE EACH AND PROVIDE DETAIL IN EACH OF THE SECTIONS NOTED BELOW.

HOISTWAY ENCLOSURE (MBC SECTION 3002):

EXISTING HOISTWAYS: EXISTING HOISTWAY ENCLOSURE, <u>2 HRS</u> RATED PER PRESCRIPTIVE FIRE RESISTANCE RATING MBC TABLE 721.1 (SEE MRC SECTION 1401.6.6)

AMBULANCE STRETCHER CLEARANCE:

EXISTING ELEVATORS: <u>NOT PROVIDED</u> (SEE MRC SECTION 1401.6.14)

EMERGENCY OPERATIONS PHASE I/II RECALL:

EXISTING ELEVATORS: PROVIDED/NOT PROVIDED (SEE MRC SECTION 1401.6.14) PROVIDED/NOT REQUIRED PER MBC SECTION 3003 NEW ELEVATORS:

MACHINE AND CONTROLLER ROOMS (MBC SECTION 3005):


MACHINE ROOM LOCATED IN ELEVATOR PENTHOUSE; CONTROLLER ROOM LOCATED REMOTELY; BOTH ARE PROVIDED WITH DEDICATED AIR CONDITIONING ON EMERGENCY POWER TO PREVENT ELECTRICAL EQUIPMENT FROM OVERHEATING.

ELEVATOR LOBBIES AND HOISTWAY OPENING PROTECTION (SECTION 3006):

EXISTING ELEVATORS: LOBBIES DO NOT EXIST IN EXISTING BUILDING AND ARE NOT PROVIDED

FIRE SERVICE ACCESS ELEVATORS (SECTION 3007):

EXISTING ELEVATORS: PROVIDED/NOT PROVIDED (SEE MRC SECTION 1401.6.14) NEW ELEVATORS PROVIDED/NOT REQUIRED PER MBC SECTION 403

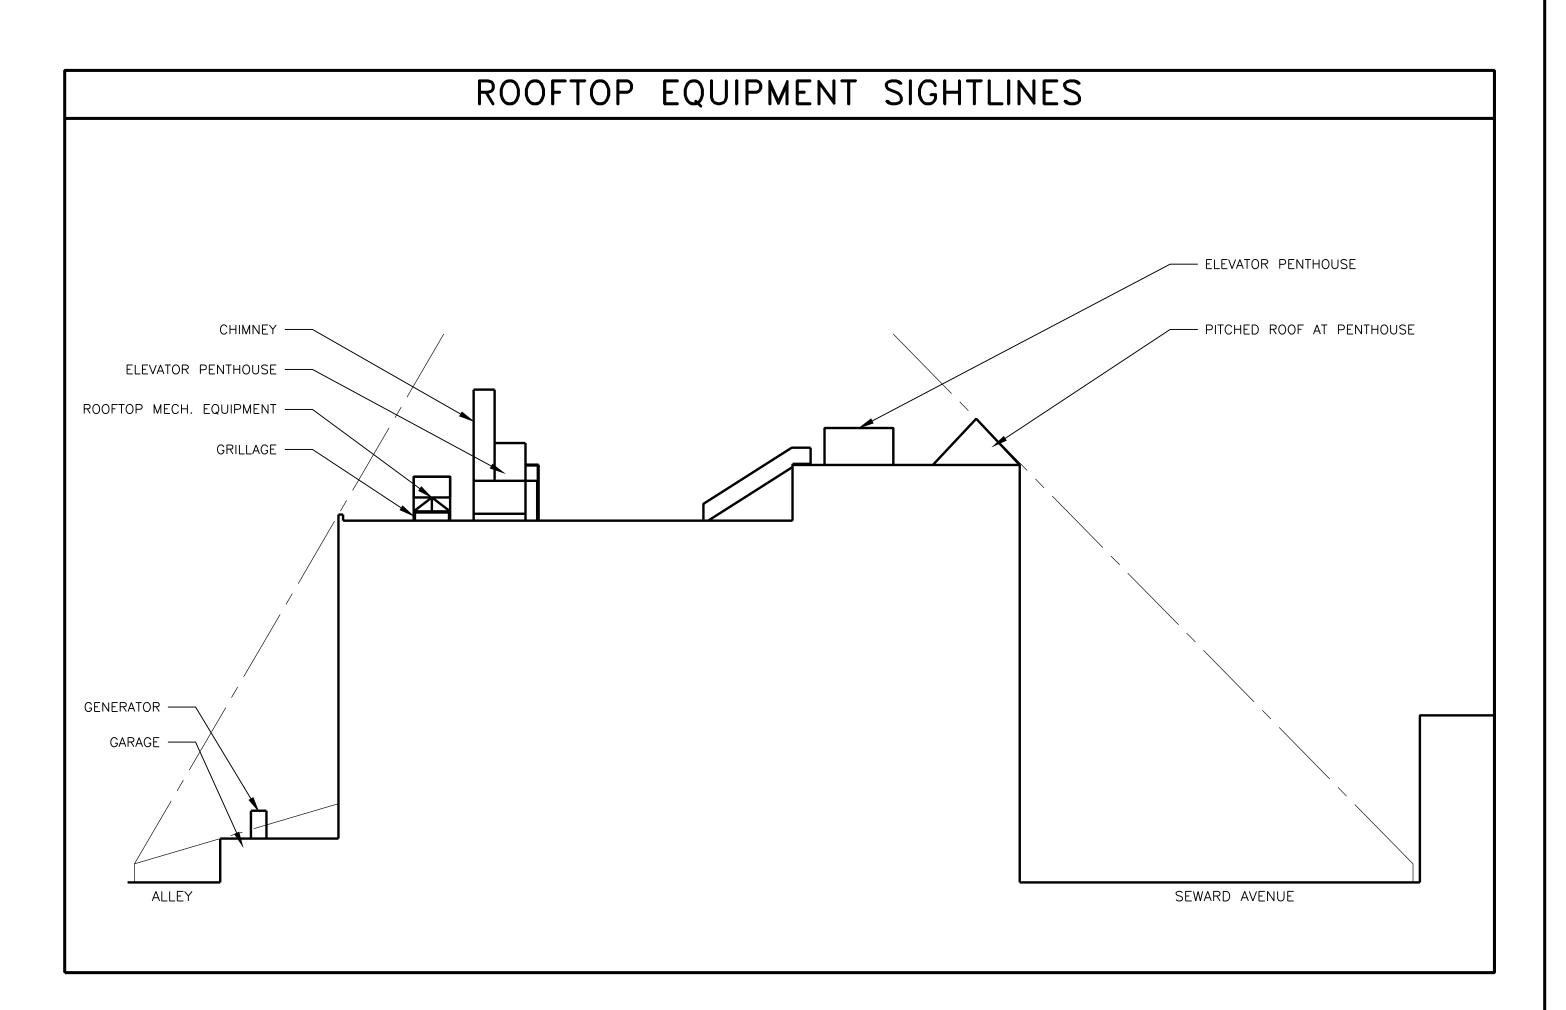

Architect

Consultant

Project / Owner

Q

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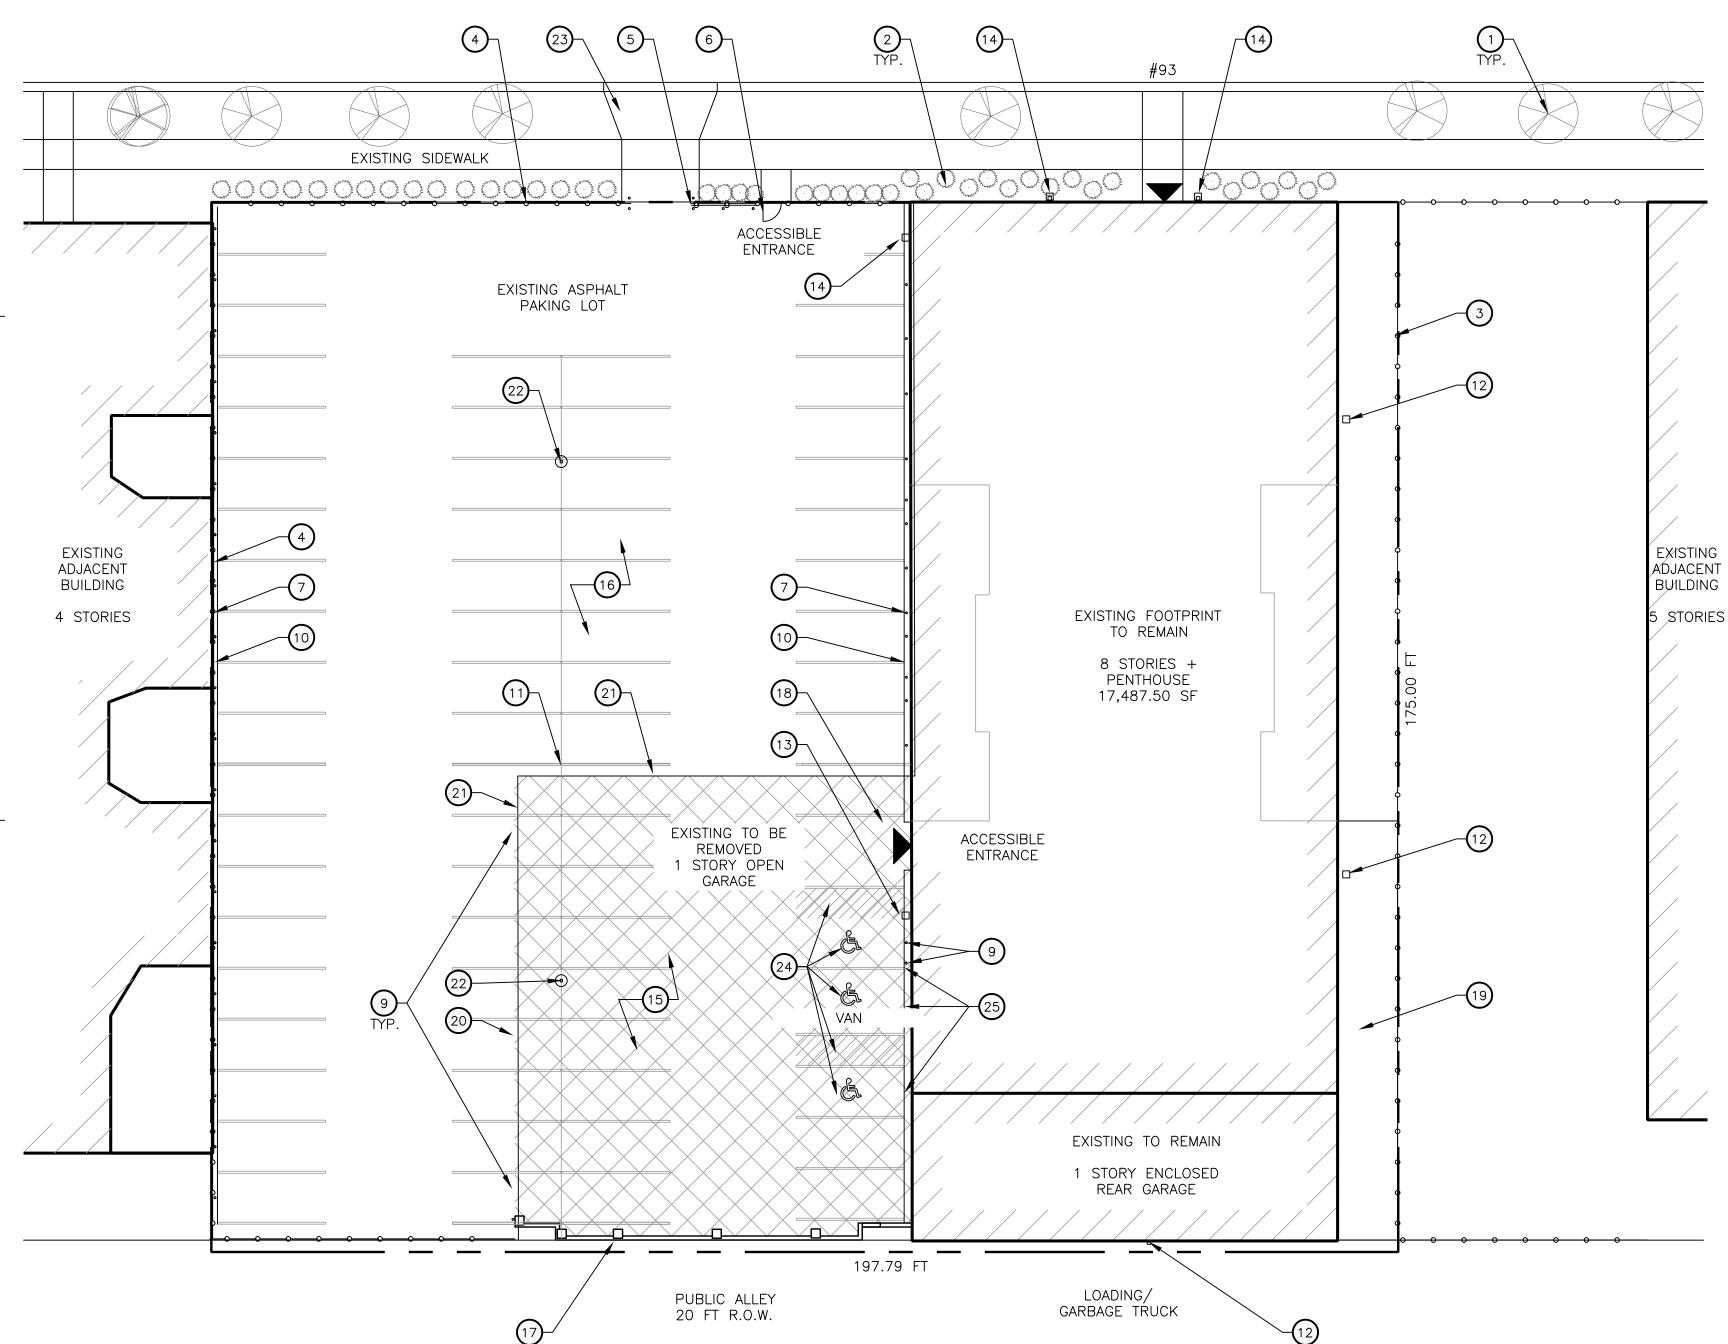
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2020051

Project Number

Sheet Title **CODE SUMMARY**

Sheet Number



ARCHITECTURAL SITE PLAN SCALE: 1/16" = 1'-0"

SITE PLAN KEYNOTES

1 EXISTING STREET TREES.

(2) EXISTING PLANTINGS.

(3) EXISTING 6FT HIGH CHAIN LINK FENCE.

(5) REPLACE VEHICLE GATE - ALUMINUM PICKET, BLACK. + CARD READER

(6) NEW PEDESTRIAN GATE. W/ CARD READER

(7) EXISTING BOLLARDS.

 $m{(8)}$ NEW BOLLARDS — MATCH HEIGHT OF EXISTING. YELLOW PAINT.

(4) REPLACE FENCE - 7 FT HIGH ALUMINUM PICKET, BLACK PAINT.

(9) REMOVE EXISTING BOLLARD, TYPICAL.

(10) EXISTING CURB.

(11) REMOVE EXISTING POLE LIGHT FIXTURE

(12) REPLACE WALL-MOUNTED SITE LIGHTING.

(13) NEW WALL-MOUNTED SITE LIGHTING. (14) REPLACE WALL—MOUNTED FACADE LIGHTING.

(15) REMOVE ONE—STORY GARAGE.

 $oxed{(}16oxed{)}$ REPAVE ASPHALT PARKING LOT INCLUDING AREA OF FORMER GARAGE. (17) rear wall of garage to be removed down to 48" above grade. PROVIDE NEW CONCRETE COPING, MATCH COLOR OF COPING ON

BUILDING ROOF DECKS. (18) NEW AWNING - ALUMINUM FRAME WITH CANVAS. SEE PROFILE IN DETAIL.

(19) EXISTING PAVED SERVICE AREA. (20) remove existing curb. Sawcut where necessary.

(21) REMOVE EXISTING WALL

(22) NEW POLE LIGHT FIXTURE.

ADJACENT (23) EXISTING CURB CUT AND DRIVEWAY - NO CHANGE.

BUILDING (24) BARRIER FREE PAVEMENT MARKINGS

STORIES (25) BARRIER FREE PARKING SIGNAGE.

GENERAL SITE NOTES

- ALL WORK PERFORMED AND MATERIALS SUPPLIED SHALL CONFORM TO THE PLANS AND/OR PROJECT SPECIFICATIONS. ANY WORK NOT COVERED SHALL CONFORM TO THE CITY'S STANDARD SPECIFICATIONS FOR THE CONSTRUCTION OF PUBLIC IMPROVEMENTS OR THE "STANDARD SPECIFICATIONS FOR HIGHWAY CONSTRUCTION, MICHIGAN DEPARTMENT OF TRANSPORTATION, LATEST EDITION AND SUPPLEMENTALS.
- THE CONTRACTOR SHALL BE RESPONSIBLE FOR NOTIFYING ALL UTILITY COMPANIES AND GOVERNMENTAL AGENCIES WHO MIGHT HAVE UTILITY LINES ON OR ABOUT THE PREMISES, OR WHO MIGHT BE AFFECTED BY THE CONSTRUCTION. THE CONTRACTOR SHALL ALSO COORDINATE WITH THE UTILITY COMPANIES TO ENSURE COMPLIANCE TO THE PROJECT SCHEDULE ESTABLISHED BY THE GENERAL CONTRACTOR. THE CONTRACTOR SHALL MAKE EVERY EFFORT TO PROTECT EXISTING UTILITY LINES AND SHALL REPAIR ANY DAMAGES AT HIS OWN EXPENSE.
- ALL SIGNS, PAVEMENT MARKINGS, AND OTHER TRAFFIC CONTROL DEVICES SHALL CONFORM TO THE MANUAL OF UNIFORM TRAFFIC CONTROL DEVICES, LATEST EDITION. ALL PAVEMENT STRIPING SHALL BE FOUR (4) INCHES WIDE, UNLESS SHOWN OTHERWISE ON THE PLANS.
- THE CONTRACTOR SHALL PROVIDE A MEDIUM BROOM ON ALL CONCRETE WALKS, RAMPS, AND PAVING SURFACES.
- MAINTENANCE OF SEEDED AND SODDED AREAS SHALL INCLUDE ALL NECESSARY FERTILIZATION AND WATERING UNTIL SUCH TIME AS PROPER VEGETATION AND ROOT GROWTH IS ESTABLISHED.
- THE CONTRACTOR SHALL BE RESPONSIBLE FOR ERECTING AND MAINTAINING BARRICADES AND OTHER TRAFFIC CONTROL DEVICES AS NECESSARY AROUND THE PERIMETER,
- THE CONTRACTOR IS RESPONSIBLE FOR ENSURING THAT ALL SIDEWALKS AND ACCESSIBLE RAMPS ARE IN COMPLIANCE WITH THE ADAAG REGULATIONS. THE CONTRACTOR SHALL NOTIFY THE ARCHITECT OF ANY DISCREPANCIES BETWEEN THE DESIGN INFORMATION AND ADAAG REGULATIONS PRIOR TO CONSTRUCTION.
- B. CONTRACTOR SHALL SATISFY HERSELF/HIMSELF AS TO EARTHWORK QUANTITIES PRIOR TO BIDDING.

PROPERTY DESCRIPTION

(PER WAYNE CO RECORDS)

93 SEWARD AVENUE

FEET OF LOT 11

WARD 02, ITEM 001189 THE WEST 16.11 FEET OF LOT 13 AND ALL OF LOT 12 AND THE EAST 7

SCHMIDT'S SUBDIVISION L.19, P.66 PLATS, WAYNE CO RECORDS.

109 SEWARD AVENUE WARD 02, ITEM 001190

THE WEST 51.33 FEET OF LOT 11 AND THE EAST 8.73 FEET OF LOT 10 SCHMIDT'S SUBDIVISION L.19, P.66 PLATS, WAYNE CO RECORDS.

117 SEWARD AVENUE WARD 02, ITEM 001191

THE WEST 46.29 FEET OF LOT 10

DEVELOPMENT DATA

PARKING:

SITE DATA: ZONING MAP: 7

ZONING DISTRICT: R5-H LOT AREA: 0.795 ACRES

BUILDING DATA: SEE CODE SUMMARY SHEET FOR BUILDING DATA

EXISTING # OF PARKING SPACES: 61: 48 OPEN / 13 COVERED PROPOSED # OF PARKING SPACES: 71 REQUIRED # OF PARKING SPACES: 55

PROPOSED # OF ACCESSIBLE SPACES: 3 LOADING DOCK: EXISTING REAR GARAGE AND EXISTING PAVED SERVICE AREA

SITE PLAN LEGEND

__OHCS | HANDICAP PARKING SIGN BOLLARD CATCH BASIN GROUND LIGHT — REFER TO ELECTRICAL LIGHT POLE

UTILITY POLE FLAG POLE

FIRE HYDRANT BUILDING ENTRANCE LANDSCAPING

EXTERIOR LIGHTING - BASIS OF DESIGN




RSX3 LED Area Luminaire





(ft2@0°):

33.8" (85.9 cm) (SPA mount) 16.1" (40.9 cm) 3.0" (7.6 cm) Main Body 7.2" (18.3 cm) Arm

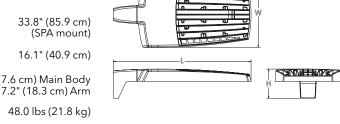



d"series

Specifications

Overall Height

3-1/8"

7.2 lbs (3.3 kg)

D-Series Size 1LED Flood Luminaire



Project Number

Sheet Title

ARCHITECTURAL SITE

Sheet Number

SCALE : 1/8" = 1'-0"

PROJECT NORTH

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Architect

Consultant

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Project / Owner

LDH, COUTH GRANGELI

Date

2020051

PLAN

AS100

1ST FLOOR DEMOLITION PLAN SCALE: 1/8" = 1'-0"

GENERAL NOTES

- A. CONTRACTOR TO CONDUCT WALK-THROUGH OF ENTIRE BUILDING TO GAIN UNDERSTANDING OF COMPLETE SCOPE OF DEMOLITION. PREMISES WILL BE ACCEPTED IN AN "AS-IS" CONDITION AND "WHERE IS."
- B. COMPLY WITH APPLICABLE LOCAL, STATE AND FEDERAL CODES AND REGULATIONS PERTAINING TO SAFETY OF PERSONS, PROPERTY AND ENVIRONMENTAL PROTECTION.
- C. PROVIDE AND MAINTAIN BARRICADES, LIGHTING AND GUARDRAILS AS REQUIRED BY APPLICABLE CODES AND REGULATIONS TO PROTECT OCCUPANTS OF BUILDING AND WORKERS.
- D. ERECT AND MAINTAIN DUSTPROOF PARTITIONS AS REQUIRED TO PREVENT SPREAD OF DUST, FUMES AND SMOKE, ETC. TO OTHER PARTS OF THE
- E. CONTRACTOR TO PROVIDE AND MAINTAIN FIRE EXTINGUISHERS AS NECESSARY TO PROVIDE FOR ADEQUATE FIRE PROTECTION AND FIRE
- F. CONTRACTOR TO MAINTAIN REQUIRED MEANS OF EGRESS DURING DEMOLITION AND CONSTRUCTION.
- G. CONDUCT DEMOLITION OPERATIONS TO PREVENT INJURY TO PEOPLE AND DAMAGE TO ADJACENT BUILDINGS AND FACILITIES TO REMAIN.
- H. SAW CUT THROUGH EXISTING MATERIALS TO PROVIDE A SMOOTH, STRAIGHT EDGE (CLEAN EDGE) FROM WHICH TO REMOVE EXISTING MATERIALS.
- I. LIMIT THE SPREAD OF DUST, DIRT AND DEBRIS. BROOM CLEAN ALL WORK AREAS ON A DAILY BASIS.
- J. CONTRACTOR TO LEGALLY DISPOSE OF DEMOLISHED ITEMS AND MATERIALS PROMPTLY. DO NOT ALLOW DEMOLISHED MATERIALS TO ACCUMULATE ON
- K. UNLESS NOTED OTHERWISE, FIREPROOFING TO REMAIN.
- L. UNLESS NOTED OTHERWISE, REMOVE ALL INTERIOR PARTITIONS WITH THE EXCEPTION OF STAIR SHAFTS AND ELEVATOR SHAFTS.

ITEMS TO BE SALVAGED

SALVAGED ITEMS SHALL BE REMOVED AND RELOCATED TO AREA IN BUILDING AS DIRECTED BY THE OWNER UNLESS NOTED OTHERWISE. AFTER RELOCATION, CONTRACTOR SHALL PROVIDE PHOTOGRAPHIC EVIDENCE OF PLACEMENT ALONG WITH AN INVENTORY OF ITEMS. ITEMS SHALL BE LABELED AND PROTECTED. CONTRACTOR SHALL CONSULT WITH OWNER PRIOR TO REMOVAL OF ANY REMAINING ARTIFACTS.

- A. EXTERIOR SIGNAGE
- WALL-MOUNTED FIRE EXTINGUISHERS
- C. FIRE EXTINGUISHER CABINETS D. MARBLE THRESHOLDS

ITEMS TO REMAIN


ANY MATERIALS THAT ARE UNCOVERED WHICH APPEAR ORIGINAL OR SIGNIFICANT ARE TO REMAIN FOR EVALUATION, CONTACT THE ARCHITECT FOR EVALUATION BEFORE ANY WORK CONTINUES. PROTECT FROM DAMAGE THROUGHOUT CONSTRUCTION OR REMOVE AND PROTECT FOR RE-INSTALLATION. UNLESS NOTED OTHERWISE IN THE DRAWINGS THE FOLLOWING ITEMS SHALL REMAIN.

- A. ROOF SUMPS, CONDUCTORS, AND ASSOCIATED PIPING AND HANGERS
- SYSTEM SHALL REMAIN OPERATIONAL B. PLATFORMS AND STRUCTURAL SUPPORT FOR ROOFTOP MECHANICAL
- EQUIPMENT.
- C. FIREPROOFING ON STRUCTURAL MEMBERS
- WALL-MOUNTED FIRE EXTINGUISHERS
- FIRE EXTINGUISHER CABINETS MARBLE FLOORING
- WOOD WALL BASE
- STONE WALL BASE CEILING PLASTER CROWN MOLDINGS
- DOORS, FRAMES WITHIN APARTMENTS EXCEPT WHERE DAMAGED K. APARTMENT ENTRANCE DOOR FRAMES EXCEPT WHERE DAMAGED
- ELEVATOR DOORS M. ELEVATOR FRAMES
- N. STAIR SYSTEMS INCLUDING TREADS, STRINGER, LANDING, GUARDRAIL AND HANDRAILS
- O. GUARDRAILS AND HANDRAILS
- P. COLUMNS: FIREPROOFING, PLASTER FINISH, PLASTER OVERHEAD BRACKETS AND WOOD BASE
- Q. PERIMETER WALLS PLASTER FINISH R. CEILING MEDALLIONS

DEMOLITION LEGEND

____ PARTITION TO BE DEMOLISHED

PARTITION TO REMAIN

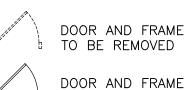

b TO REMAIN

SCALE : 1/8" = 1'-0"

Sheet Number

AD101

Architect

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Sheet Title FIRST FLOOR **DEMOLITION PLAN**

REMOVE SLAB, CURBS, FLOOR DRAIN AND REPAVE GARAGE AREA ALONG WITH PARKING LOT PER CIVIL. $\sqrt{25}$ remove wall and columns down to 48" above grade. 26 PROVIDE LINTEL AND SAW CUT NEW OPENING FOR EXIT DOOR. 27 REMOVE WOOD STAIR AND LANDING

17 REMOVE ROOF MECHANICAL EQUIPMENT FOR REPLACEMENT $\angle{18}$ remove lighting fixtures for replacement $\frac{19}{2}$ REMOVE STAIRS FOR REPLACEMENT 20 REMOVE FENCE AND GATE FOR REPLACEMENT 21 REMOVE WALL 22 REMOVE COLUMN 23 REMOVE STRUCTURE AND ROOF

- (4) DEMISING WALL
- (5) WALK-OFF MAT -
- (6) FLOORING TRANSITION
- (7) THRESHOLD
- (8) EXISTING STEPS TO REMAIN
- (9) EXISTING STAIR TO REMAIN
- (10) EXISTING RAMP TO REMAIN
- EXISTING ELEVATOR REFER TO SPECS FOR NEW FINISHES AND REPAIRS
- (12) EXISTING GUARDRAIL -

(13) DECORATIVE METAL RAILING -

- (14) PARTITION
- (15) INFILL OPENING

- REPLACE VEHICLE GATE, SEE SITE PLAN
- MULLION
- SHELVING -
- ROD AND SHELF -
- DIRECTORY/INTERCOM -
- 25 PARCEL STORAGE LOCKERS SEE
- ENLARGED PLAN (26) REPLACE MAILBOXES
- 27 LAUNDRY EQUIPMENT SEE ENLARGED
- (28) REPLACE UTILITY SINK SEE PLUMBING
- (29) FIRE EXTINGUISHER FIRE EXTINGUISHER CABINET -
- SEMI-RECESSED FIRE EXTINGUISHER

- (37) FIRE CONTROL PANEL CORNER GUARD -
- REINFORCED CMU BLOCK WALL, PAINTED
- REPLACE KITCHEN CABINETS,
- APPLIANCES AND FIXTURES, TYP. REPLACE PLUMBING FIXTURES, VANITY
- AND ACCESSORIES, TYP. (42) REPLACE DOOR AND HARDWARE, TYP.
- REPLACE HARDWARE, TYP.
- ADD NEW CLOSET SYSTEMS TO ALL APARTMENT CLOSETS, TYP.
- PROVIDE NEW CANE RAIL AT FIRE

- PROVIDE CARBON MOIN EACH APARTMENT
- (49) REPAIR PARTITIONS AS NEEDED
- 50) DOOR BELL AT PEDESTRIAN GATE

- A. FIRESTOPPING: PROVIDE FIRESTOPPING ASSEMBLIES AT ALL PENETRATIONS AND INTERRUPTIONS TO FIRE RATED ASSEMBLIES WHICH PROVIDE THE SPECIFIED FIRE RATING FOR PARTITION OR FLOOR. SEE SPECIFICATIONS.
- B. FIRE RATED PARTITIONS SHALL BE CONTINUOUS FROM FLOOR TO STRUCTURE ABOVE AND SHALL BE FIRE STOPPED TIGHTLY TO STRUCTURE
- C. PARTITIONS ARE DIMENSIONED FROM FINISH FACE TO FINISH FACE, UNLESS
- D. COORDINATE AND PROVIDE BACKING FOR MILLWORK AND ITEMS ATTACHED OR MOUNTED TO WALLS OR CEILINGS.
- E. CONTRACTOR TO PROVIDE BLOCKING AS REQUIRED. COORDINATE LOCATIONS AND EXTENTS OF BLOCKING WITH PRODUCT MANUFACTURERS AND SHOP DRAWINGS.
- F. LOCATE DOOR FRAMES 6" FROM INSIDE CORNER TO DOOR OPENING,
- BE CLEAR LAMINATED SAFETY GLASS OR CLEAR TEMPERED SAFETY
- H. CONTRACTOR SHALL PROVIDE AND INSTALL CORNER GUARDS (CG) AS IDENTIFIED ON PLANS. CG SHALL BE FULL HEIGHT FROM TOP OF BASE
- RECESSED ITEMS (GREATER THAN 16 SQ. IN.) IN RATED AND/OR SMOKE WALLS, INCLUDING ELEC PANELS, ELEC DUCTS, MED GAS VALVE BOXES, FIRE EXT CABINETS, ETC. SHALL BE BACKED WITH 5/8" TYPE 'X' GYPSUM
- J. SEMI-RECESSED FIRE EXTINGUISHER (FE) ARE SHOWN ON PLAN REFER TO SHEET A501 FOR TYPICAL DETAILS. FINAL LOCATION OF FIRE EXTINGUISHERS SHALL BE REVIEWED IN FIELD WITH BUILDING OFFICIAL
- K. COORDINATE TELECOMMUNICATIONS, A/V, DATA AND SECURITY SYSTEMS INSTALLATIONS. PROVIDE AND INSTALL TELEPHONE AND ELECTRICAL PANEL BOARDS, PANEL BOARDS SHALL BE 4' X 8' X 3/4" THICK, PLYWOOD,

- N. SEE PARTITION NOTES ON SHEET A501 FOR ADDITIONAL REQUIREMENTS.
- P. WHERE NEW OR INFILL PARTITION ABUTS EXISTING PARTITION, FACE OF PARTITIONS SHALL ALIGN, UNLESS NOTED OTHERWISE.
- Q. PARTITIONS WITH EXISTING FRAMING MAY REQUIRE REWORK TO ACCOMMODATE NEW OPENINGS, ETC.

REVIEW SHALL NOT CONSTITUTE A CLAIM FOR DELAY.

- PARTITIONS IN THE FIELD. S. ALTERNATE PARTITION ASSEMBLIES THAT VARY FROM THE ASSEMBLIES PROVIDED IN THE PARTITION SCHEDULE TO BE SUBMITTED BY THE CONTRACTOR TO THE ARCHITECT FOR CONSIDERATION. ALTERNATE ASSEMBLIES MAY REQUIRE REVIEW BY THE LOCAL JURISDICTION. ANY
- U. PROVIDE NEW STRUCTURAL LINTELS AT ALL MASONRY WALLS WHERE PREVIOUS OPENING DOES NOT HAVE A LINTEL AND AT NEW OPENINGS. LINTEL SHALL EXTEND MINIMUM 8" EITHER SIDE OF OPENING, UNLESS NOTED OTHERWISE. SEE STRUCTURAL.

GENERAL NOTES

THICKNESS OF FINISHES.

- PER CODE (U.L. SYSTEM). SEE A501 FOR ADDITIONAL REQUIREMENTS.
- NOTED OTHERWISE. MAINTAIN DIMENSIONS MARKED 'CLEAR'. ALLOW FOR
- UNLESS NOTED OTHERWISE.
- G. ALL INTERIOR GLAZING INCL DOORS, SIDELITES, & BORROWED LITES SHALL GLAZING. UNLESS NOTED OTHERWISE.
- TO CEILING. TYP. EXCEPT AT WWC INSTALL FROM TOP OF WWC TO CLG.
- BOARD TO MAINTAIN RATING AT FIRE WALL.
- PRIOR TO INSTALLATION ROUGH-IN.
- FIRE RETARDANT TREATED.
- L. COORDINATE WITH ROOM FINISH AND MATERIAL SCHEDULE.
- M. COORDINATE WITH ENLARGED ROOM PLAN FOR ADDITIONAL REQUIREMENTS.
- WORK IN EXISTING STRUCTURES
- O. WHERE NEW GYPSUM BOARD PARTITIONS ARE A CONTINUATION OF AN EXISTING PARTITION OR COLUMN ENCASEMENT, THE FACE OF THE NEW GYPSUM BOARD SHALL BE ALIGNED WITH THE FACE OF THE EXISTING SURFACE. WHERE NEW GYPSUM BOARD PARTITION IS SHOWN INTERSECTING A COLUMN ENCASEMENT THE CENTERLINE OF THE WALL SHALL BE CENTERED ON THE COLUMN ENCASEMENT.

- R. WHERE EXISTING FIRE-RESISTANCE RATED PARTITIONS ARE DAMAGED OR HAVE EXISTING OPENINGS, PARTITION TO BE PATCHED AND REPAIRED WITH MATERIALS MATCHING THE EXISTING ASSEMBLY TO MEET THE REQUIRED FIRE RESISTANCE RATING. CONTRACTOR TO REVIEW THE CONDITION OF ALL
- T. WHERE FINISHES ARE SPECIFIED ON THE FINISH PLAN REMOVE ALL EXISTING FINISHES. PATCH AND REPAIR WALLS AND FLOOR TO ENSURE EVEN SURFACE. PREPARE THEM TO ACCEPT NEW SCHEDULED FINISH PER MANUFACTURER'S INSTRUCTIONS. SEE SPECIFICATIONS FOR ADDITIONAL REQUIREMENTS.
- V. WHERE EXISTING ACCESS PANELS CONFLICT WITH CONSTRUCTION, RELOCATE PANELS TO ALIGN WITH AND FIT WITHIN NEW CONSTRUCTION.
- W. PROVIDE TEMPORARY DUSTPROOF PARTITIONS AS REQUIRED TO PROTECT ALL EXISTING AREAS FROM DAMAGE.

Consultant

QU LP OWN

Project / Owner



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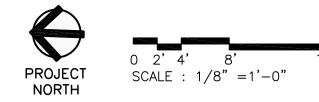
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Date 2020051 Project Number

FIRST FLOOR PLAN

Sheet Number



6TH - 8TH FLOOR PLAN

SCALE: 1/8" = 1'-0'

EXISTING

WINDOWS

REPAIR

EXISTING

WINDOWS

CONSTR. KEYNOTES

NOTE: NOT ALL NOTES ARE APPLICABLE TO THIS SHEET.

1 REPLACE KITCHEN CABINETS, APPLIANCES, AND FIXTURES, TYP.

2 REPLACE BATHROOM FIXTURES, VANITIES, AND ACCESSORIES, TYP.

(3) REPLACE ENTRANCE DOOR, TYP.

(4) REPLACE DOOR AND HARDWARE (5) REPLACE DOOR HARDWARE, TYP.

(6) REPLACE WINDOW TREATMENTS, TYP.

(7) FLOORING TRANSITION

(8) THRESHOLD

(9) STAIR

(10) EXISTING STAIR TO REMAIN

(11) EXISTING ELEVATOR

(12) SHAFT

(13) SHAFT ENCLOSURE (14) ACCESS PANEL

(15) SHELVING -

(16) ROD AND SHELF -

ADD NEW CLOSET SYSTEMS TO ALL APARTMENT CLOSETS, TYP.

PROVIDE SMOKE DETECTOR IN EACH BEDROOM

PROVIDE A CARBON MONOXIDE DETECTOR IN EACH APARTMENT

20 EXISTING FIRE EXTINGUISHER

(21) EXISTING STANDPIPE

PROVIDE NEW CANE RAIL AT FIRE RISERS

GENERAL NOTES

THICKNESS OF FINISHES.

- A. FIRESTOPPING: PROVIDE FIRESTOPPING ASSEMBLIES AT ALL PENETRATIONS AND INTERRUPTIONS TO FIRE RATED ASSEMBLIES WHICH PROVIDE THE SPECIFIED FIRE RATING FOR PARTITION OR FLOOR. SEE SPECIFICATIONS.
- B. FIRE RATED PARTITIONS SHALL BE CONTINUOUS FROM FLOOR TO STRUCTURE ABOVE AND SHALL BE FIRE STOPPED TIGHTLY TO STRUCTURE PER CODE (U.L. SYSTEM). SEE A501 FOR ADDITIONAL REQUIREMENTS.
- C. PARTITIONS ARE DIMENSIONED FROM FINISH FACE TO FINISH FACE, UNLESS NOTED OTHERWISE. MAINTAIN DIMENSIONS MARKED 'CLEAR'. ALLOW FOR
- D. COORDINATE AND PROVIDE BACKING FOR MILLWORK AND ITEMS ATTACHED OR MOUNTED TO WALLS OR CEILINGS.
- E. CONTRACTOR TO PROVIDE BLOCKING AS REQUIRED. COORDINATE LOCATIONS AND EXTENTS OF BLOCKING WITH PRODUCT MANUFACTURERS AND SHOP
- F. LOCATE DOOR FRAMES 6" FROM INSIDE CORNER TO DOOR OPENING, UNLESS NOTED OTHERWISE.
- G. ALL INTERIOR GLAZING INCL DOORS, SIDELITES, & BORROWED LITES SHALL BE CLEAR LAMINATED SAFETY GLASS OR CLEAR TEMPERED SAFETY GLAZING. UNLESS NOTED OTHERWISE.
- H. CONTRACTOR SHALL PROVIDE AND INSTALL CORNER GUARDS (CG) AS IDENTIFIED ON PLANS. CG SHALL BE FULL HEIGHT FROM TOP OF BASE TO CEILING. TYP. EXCEPT AT WWC - INSTALL FROM TOP OF WWC TO CLG.
- RECESSED ITEMS (GREATER THAN 16 SQ. IN.) IN RATED AND/OR SMOKE WALLS, INCLUDING ELEC PANELS, ELEC DUCTS, MED GAS VALVE BOXES, FIRE EXT CABINETS, ETC. SHALL BE BACKED WITH 5/8" TYPE 'X' GYPSUM BOARD TO MAINTAIN RATING AT FIRE WALL.
- SEMI-RECESSED FIRE EXTINGUISHER (FE) ARE SHOWN ON PLAN REFER TO SHEET A501 FOR TYPICAL DETAILS. FINAL LOCATION OF FIRE EXTINGUISHERS SHALL BE REVIEWED IN FIELD WITH BUILDING OFFICIAL PRIOR TO INSTALLATION ROUGH-IN.
- K. COORDINATE TELECOMMUNICATIONS, A/V, DATA AND SECURITY SYSTEMS INSTALLATIONS. PROVIDE AND INSTALL TELEPHONE AND ELECTRICAL PANEL BOARDS, PANEL BOARDS SHALL BE 4' X 8' X 3/4" THICK, PLYWOOD, FIRE RETARDANT TREATED.
- L. COORDINATE WITH ROOM FINISH AND MATERIAL SCHEDULE.
- M. COORDINATE WITH ENLARGED ROOM PLAN FOR ADDITIONAL REQUIREMENTS.
- N. SEE PARTITION NOTES ON SHEET A501 FOR ADDITIONAL REQUIREMENTS.

WORK IN EXISTING STRUCTURES

- O. WHERE NEW GYPSUM BOARD PARTITIONS ARE A CONTINUATION OF AN EXISTING PARTITION OR COLUMN ENCASEMENT, THE FACE OF THE NEW GYPSUM BOARD SHALL BE ALIGNED WITH THE FACE OF THE EXISTING SURFACE. WHERE NEW GYPSUM BOARD PARTITION IS SHOWN INTERSECTING A COLUMN ENCASEMENT THE CENTERLINE OF THE WALL SHALL BE CENTERED ON THE COLUMN ENCASEMENT.
- WHERE NEW OR INFILL PARTITION ABUTS EXISTING PARTITION, FACE OF PARTITIONS SHALL ALIGN, UNLESS NOTED OTHERWISE.
- Q. PARTITIONS WITH EXISTING FRAMING MAY REQUIRE REWORK TO ACCOMMODATE NEW OPENINGS, ETC.
- R. WHERE EXISTING FIRE-RESISTANCE RATED PARTITIONS ARE DAMAGED OR HAVE EXISTING OPENINGS, PARTITION TO BE PATCHED AND REPAIRED WITH MATERIALS MATCHING THE EXISTING ASSEMBLY TO MEET THE REQUIRED FIRE RESISTANCE RATING. CONTRACTOR TO REVIEW THE CONDITION OF ALL PARTITIONS IN THE FIELD.
- S. ALTERNATE PARTITION ASSEMBLIES THAT VARY FROM THE ASSEMBLIES PROVIDED IN THE PARTITION SCHEDULE TO BE SUBMITTED BY THE CONTRACTOR TO THE ARCHITECT FOR CONSIDERATION. ALTERNATE ASSEMBLIES MAY REQUIRE REVIEW BY THE LOCAL JURISDICTION. ANY REVIEW SHALL NOT CONSTITUTE A CLAIM FOR DELAY.
- WHERE FINISHES ARE SPECIFIED ON THE FINISH PLAN REMOVE ALL EXISTING FINISHES. PATCH AND REPAIR WALLS AND FLOOR TO ENSURE EVEN SURFACE. PREPARE THEM TO ACCEPT NEW SCHEDULED FINISH PER MANUFACTURER'S INSTRUCTIONS. SEE SPECIFICATIONS FOR ADDITIONAL REQUIREMENTS.
- U. PROVIDE NEW STRUCTURAL LINTELS AT ALL MASONRY WALLS WHERE PREVIOUS OPENING DOES NOT HAVE A LINTEL AND AT NEW OPENINGS LINTEL SHALL EXTEND MINIMUM 8" EITHER SIDE OF OPENING, UNLESS NOTED OTHERWISE. SEE STRUCTURAL.
- V. WHERE EXISTING ACCESS PANELS CONFLICT WITH CONSTRUCTION, RELOCATE PANELS TO ALIGN WITH AND FIT WITHIN NEW CONSTRUCTION
- W. PROVIDE TEMPORARY DUSTPROOF PARTITIONS AS REQUIRED TO PROTECT ALL EXISTING AREAS FROM DAMAGE.

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Architect

Consultant

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2020051 **Project Number**

Sheet Title

2ND-5TH FLOOR PLAN & 6TH-8TH FLOOR PLAN

Sheet Number



CONSTRUCT. KEYNOTES

NOTE: NOT ALL NOTES ARE APPLICABLE TO THIS SHEET.

(1) EXISTING ROOF HATCH -

(2) ROOF ACCESS THRU WINDOW (BELOW)

(3) REPLACE ROOFING - EPDM

(4) EXISTING STANDING SEAM TO REMAIN

(5) TAPERED ROOF INSULATION

(6) WALK-WAY PAD

(7) EXISTING STONE COPING TO REMAIN

(8) EXISTING WELDED COPPER COPING

(9) REPLACE METAL COPING, MATCH EXIST'G

(10) EXISTING SCUPPER

(11) GUTTER AND DOWNSPOUT - REPAIR

(12) EXISTING ROOF DRAIN

(13) TRASH CHUTE VENT -

(14) GENERATOR - REPLACE EXISTING

(15) ROOFTOP EQPT. - REPLACE - SEE MECH.

(16) REPLACE EXHAUST FAN - SEE MECH. (17) EXISTING VENT

(18) EXISTING GRILLAGE

(19) CURB

(20) EXISTING GUARDRAIL

MECH PH ACCESS STAIRS - REPLACE WOOD STAIRS WITH NEW STEEL STAIRS

(22) FAÇADE LIGHTING – SEE ELECTRICAL

WEATHER PROOF ELECTRICAL OUTLET - SEE ELECTRICAL

REPLACE KITCHEN CABINETS, APPLIANCES, AND FIXTURES, TYP.


REPLACE PLUMBING FIXTURES, VANITY AND ACCESSORIES, TYP.

(26) REPLACE DOOR AND HARDWARE, TYP.

27) REPLACE HARDWARE, TYP.

ADD NEW CLOSET SYSTEMS TO ALL APARTMENT CLOSETS, TYP.

29 EXISTING FIREPLACE - REPAIR, CLEAN AND INSPECT

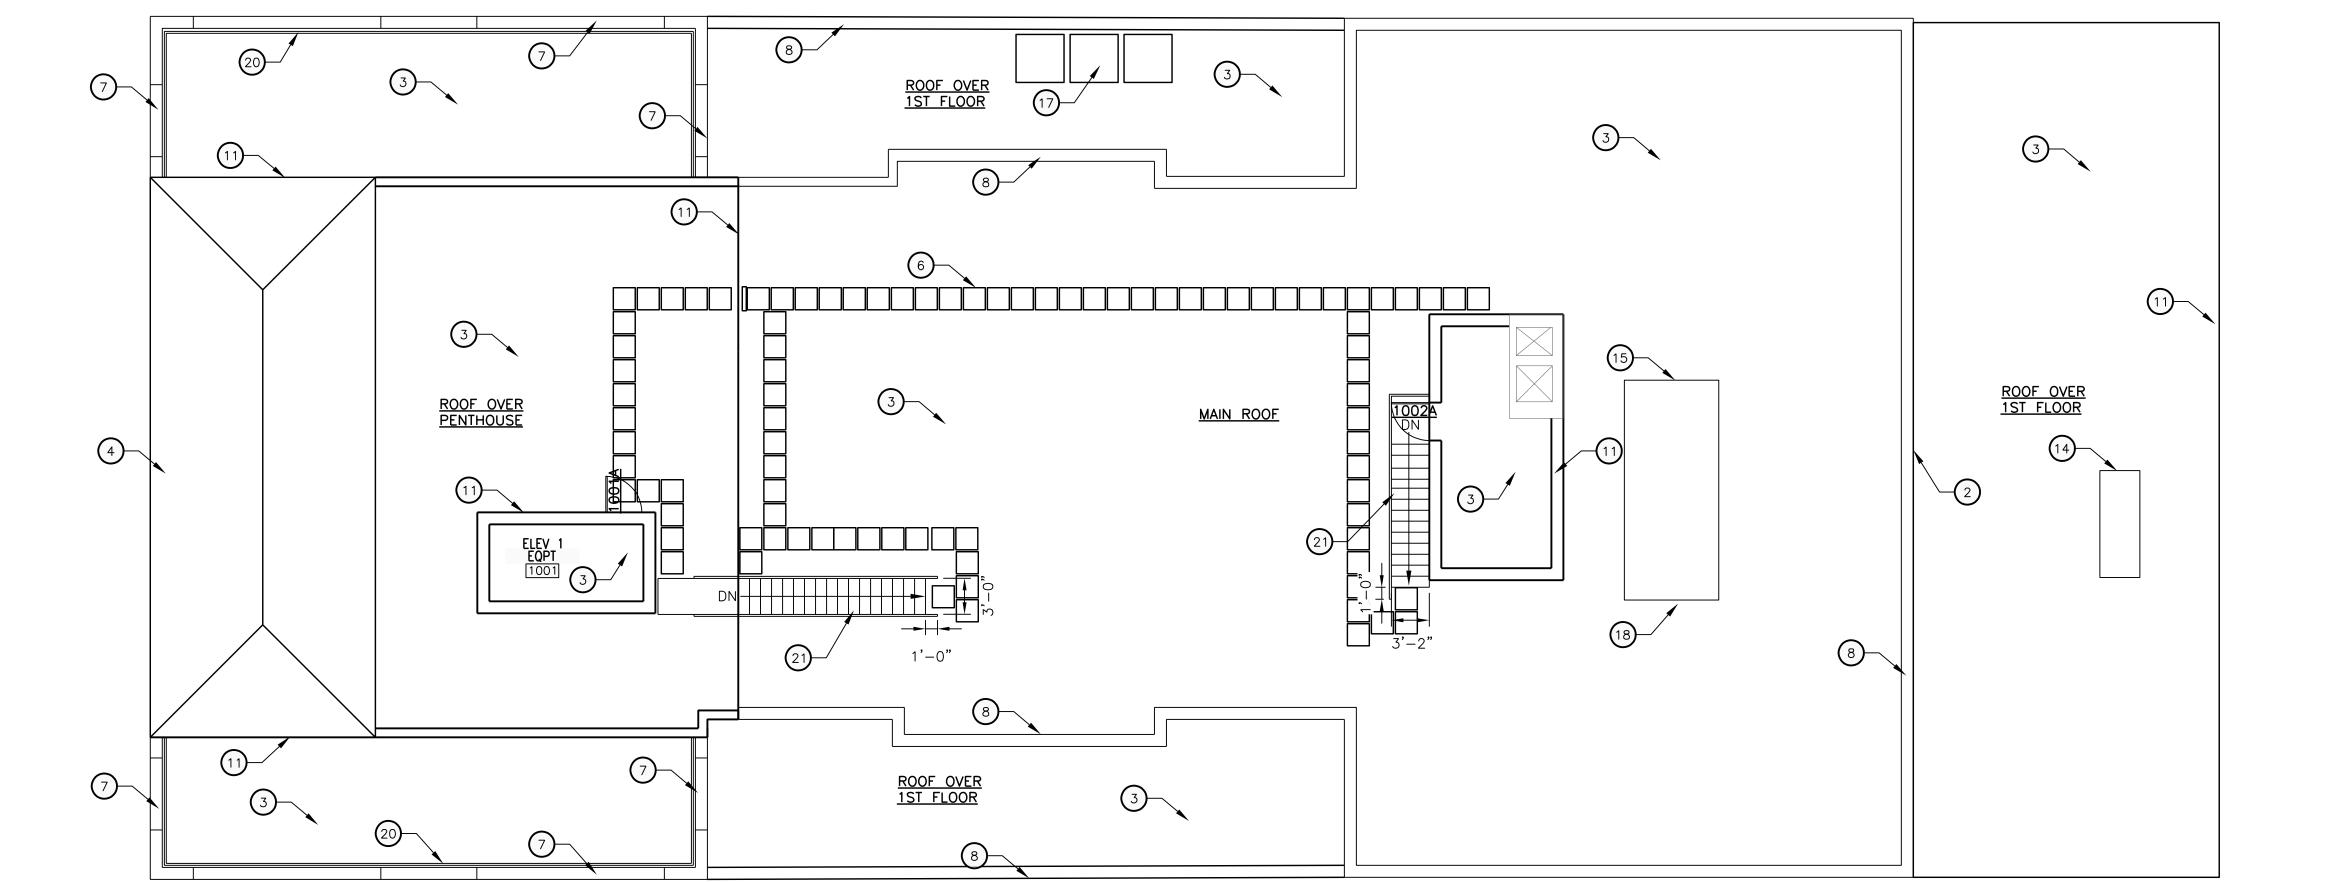

ROOF PLAN

SCALE: 1/8" = 1'-0"

ROOFING GENERAL NOTES

- A. CONTRACTOR SHALL REVIEW AND COORDINATE WITH ARCHITECTURAL, MEP, AND STRUCTURAL PLANS TO ASCERTAIN EXACT CONDITIONS AND COMPONENTS RELATED TO THE WORK DESCRIBED BY THESE DOCUMENTS. ALL WORK SHALL BE IN ACCORDANCE WITH ACCEPTED MANUFACTURER'S PRINTED INSTRUCTIONS AND NRCA STANDARDS.
- B. DIMENSIONS, DETAILS, EQUIPMENT SIZE AND LOCATION SHOWN ON THESE ROOF PLAN AND ROOF DETAILS ARE FOR INFORMATION AND REFERENCE ONLY. EXACT SIZE, LOCATION, TYPE OF MATERIAL AND TYPE OF CONSTRUCTION ARE THE RESPONSIBILITY OF THE CONTRACTOR TO CONFIRM AND COORDINATE.
- C. REFER TO NOMENCLATURE FOR TYPE OF ROOF SYSTEM. AREAS MARKED WITH DESIGNATED LETTER, SEE ROOF PLAN AND NOMENCLATURE.
- D. MINIMUM SLOPE ALLOWABLE ON THE ROOF SHALL BE NO LESS THAN 1/4" PER FOOT. CRICKET THE UP-SLOPE SIDE OF ALL SQUARE CURBS AND PROJECTIONS OVER 20" IN WIDTH.
- E. CONTRACTOR TO ENSURE RUNOFF PITCHES AWAY FROM ROOF EXPANSION JOINTS AND ROOF AREA SEAMS. ELEVATE ROOF EXPANSION JOINTS A MINIMUM OF 8" ABOVE THE ROOF MEMBRANE.
- F. ALL CRICKET AND TAPERED INSULATION SHALL BE INSTALLED WITH A FINISH 1/4" PER FOOT MIN. SLOPE. CRICKET THE UP-SLOPE SIDE OF ALL SQUARE CURBS AND PROJECTIONS.
- G. PROVIDE 22 GAUGE STAINLESS STEEL, 2D FINISH, TREATED WOOD CURB AND BOX HOOD AT ALL GAS LINE AND WATER LINE ROOF PENETRATIONS. SEE A321 FOR TYPICAL ROOF DETAILS.
- H. PROVIDE WALKWAY PROTECTION PADS AROUND ALL ROOF HATCHES, MECHANICAL UNITS, AT ROOF TOP ACCESS DOORS, AND LADDERS (TOP &
- I. CONTRACTOR SHALL EXAMINE AND ENSURE DRAIN LINES, GUTTERS AND DOWNSPOUTS ARE FREE OF DEBRIS AND BLOCKAGE, FLUSH WITH WATER TO ENSURE THAT DRAINS FLOW FREELY, WHERE APPLICABLE.
- J. OVERFLOW DRAINS SHALL BE SET 2" HIGHER THAN MAIN ROOF DRAIN ELEVATIONS UNLESS NOTED OTHERWISE. OVERFLOW DRAINS SHALL NOT
- HAVE STRAINERS UNLESS REQUIRED BY LOCAL CODES. K. AVOID THE USE OF PITCH PANS ON LOW-PITCH ROOFS EXCEPT WHERE
- L. SECURE NAILERS AND CANT STRIPS TO ROOF DECK NOT TO PARAPETS OR ADJACENT WALLS, TYPICAL.
- M. CONTRACTOR SHALL PROVIDE ALL EQUIPMENT CURBS AND STANDS NECESSARY FOR ROOFTOP EQUIPMENT.

REROOFING GENERAL NOTES

NO OTHER SOLUTION CAN BE USED.

- A. THE CONTRACTOR SHALL BE RESPONSIBLE FOR THE SAFETY OF THE BUILDING, OCCUPANTS, AND WORKERS THROUGHOUT CONSTRUCTION. THE CONTRACTOR SHALL TAKE ALL NECESSARY SAFETY PRECAUTIONS AND COMPLY WITH ALL APPLICABLE REGULATIONS INCLUDING OSHA SAFETY REGULATIONS FOR ROOF REPLACEMENT AND DEMOLITION OPERATIONS.
- B. THE CONDITION OF THE EXISTING ROOF ASSEMBLY INCLUDING ROOF COVERING, SUBSTRATE AND DECKING IS UNKNOWN AND MAY BE DAMAGED OR DETERIORATED.
- C. CONTRACTOR SHALL FIELD VERIFY ALL EXISTING DIMENSIONS AND CONDITIONS AND MAKE MINOR ADJUSTMENTS AS NECESSARY. NOTIFY ARCHITECT OF ANY DISCREPANCIES WHICH MAY AFFECT THE OUTCOME OF
- D. THE CONTRACTOR SHALL REMOVE AND REINSTALL ALL EXISTING ROOF OR WALL MOUNTED EQUIPMENT AND ACCESSORIES TO REMAIN IN AREAS OF ROOF REPLACEMENT AS NECESSARY TO COMPLETE THE WORK. ALL CURBED ROOF PENETRATIONS SHALL EXTEND A MIN. OF 12" ABOVE THE FINISHED ROOF SURFACE. PROVIDE OR MODIFY EXISTING CONSTRUCTION WITH NEW TREATED WOOD BLOCKING AS NECESSARY. FIELD VERIFY SIZE, QUANTITY, AND LOCATION OF ALL ROOF PENETRATIONS, EQUIPMENT AND ACCESSORIES. MODIFY/EXTEND EXISTING CONTROL WIRING, CONDUIT, DUCTWORK OR PIPING AS NECESSARY, NOTIFY THE OWNER AND COORDINATE ANY INTERRUPTION IN EQUIPMENT SERVICE PRIOR TO REMOVAL.
- E. PROTECT EXISTING UTILITIES DURING CONSTRUCTION. FLASH ALL UTILITY. CONDUIT, AND PIPING PENETRATIONS IN ACCORDANCE WITH THE ROOF MANUFACTURER'S PUBLISHED INSTRUCTIONS. FIELD VERIFY SIZE, QUANTITY AND LOCATION.
- F. ALL EXISTING FINISHES DISTURBED DURING CONSTRUCTION SHALL BE RESTORED TO A CONDITION AT LEAST EQUAL IN MATERIAL AND APPEARANCE TO THAT WHICH EXISTED BEFORE CONSTRUCTION BEGAN.
- G. CONTRACTOR TO MAINTAIN DRAINAGE FLOWS AT ALL TIMES DURING THE PERFORMANCE OF THE WORK.
- H. CONTRACTOR TO REMOVE EXISTING ROOFING MATERIALS AT PARAPET WALL AND INSPECT CONDITION OF EXISTING PARAPET WALL. CONTRACTOR SHALL REPORT TO ARCHITECT ANY UNSTABLE CONDITIONS REQUIRING REPAIR PRIOR TO PROCEEDING WITH WORK.
- I. CONTRACTOR SHALL PROVIDE PLYWOOD OR COVER BOARD BEHIND MEMBRANE ROOFING AT ALL EXISTING WALL SURFACES TOO ROUGH FOR PROPER INSTALLATION.

Architect

Consultant

QU LP LDH MED

Project / Owner



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2020051

Date

Revision


Project Number

Sheet Title PENTHOUSE PLAN AND ROOF PLAN

Sheet Number

A103

PROJECT SCALE : 1/8" = 1'-0"

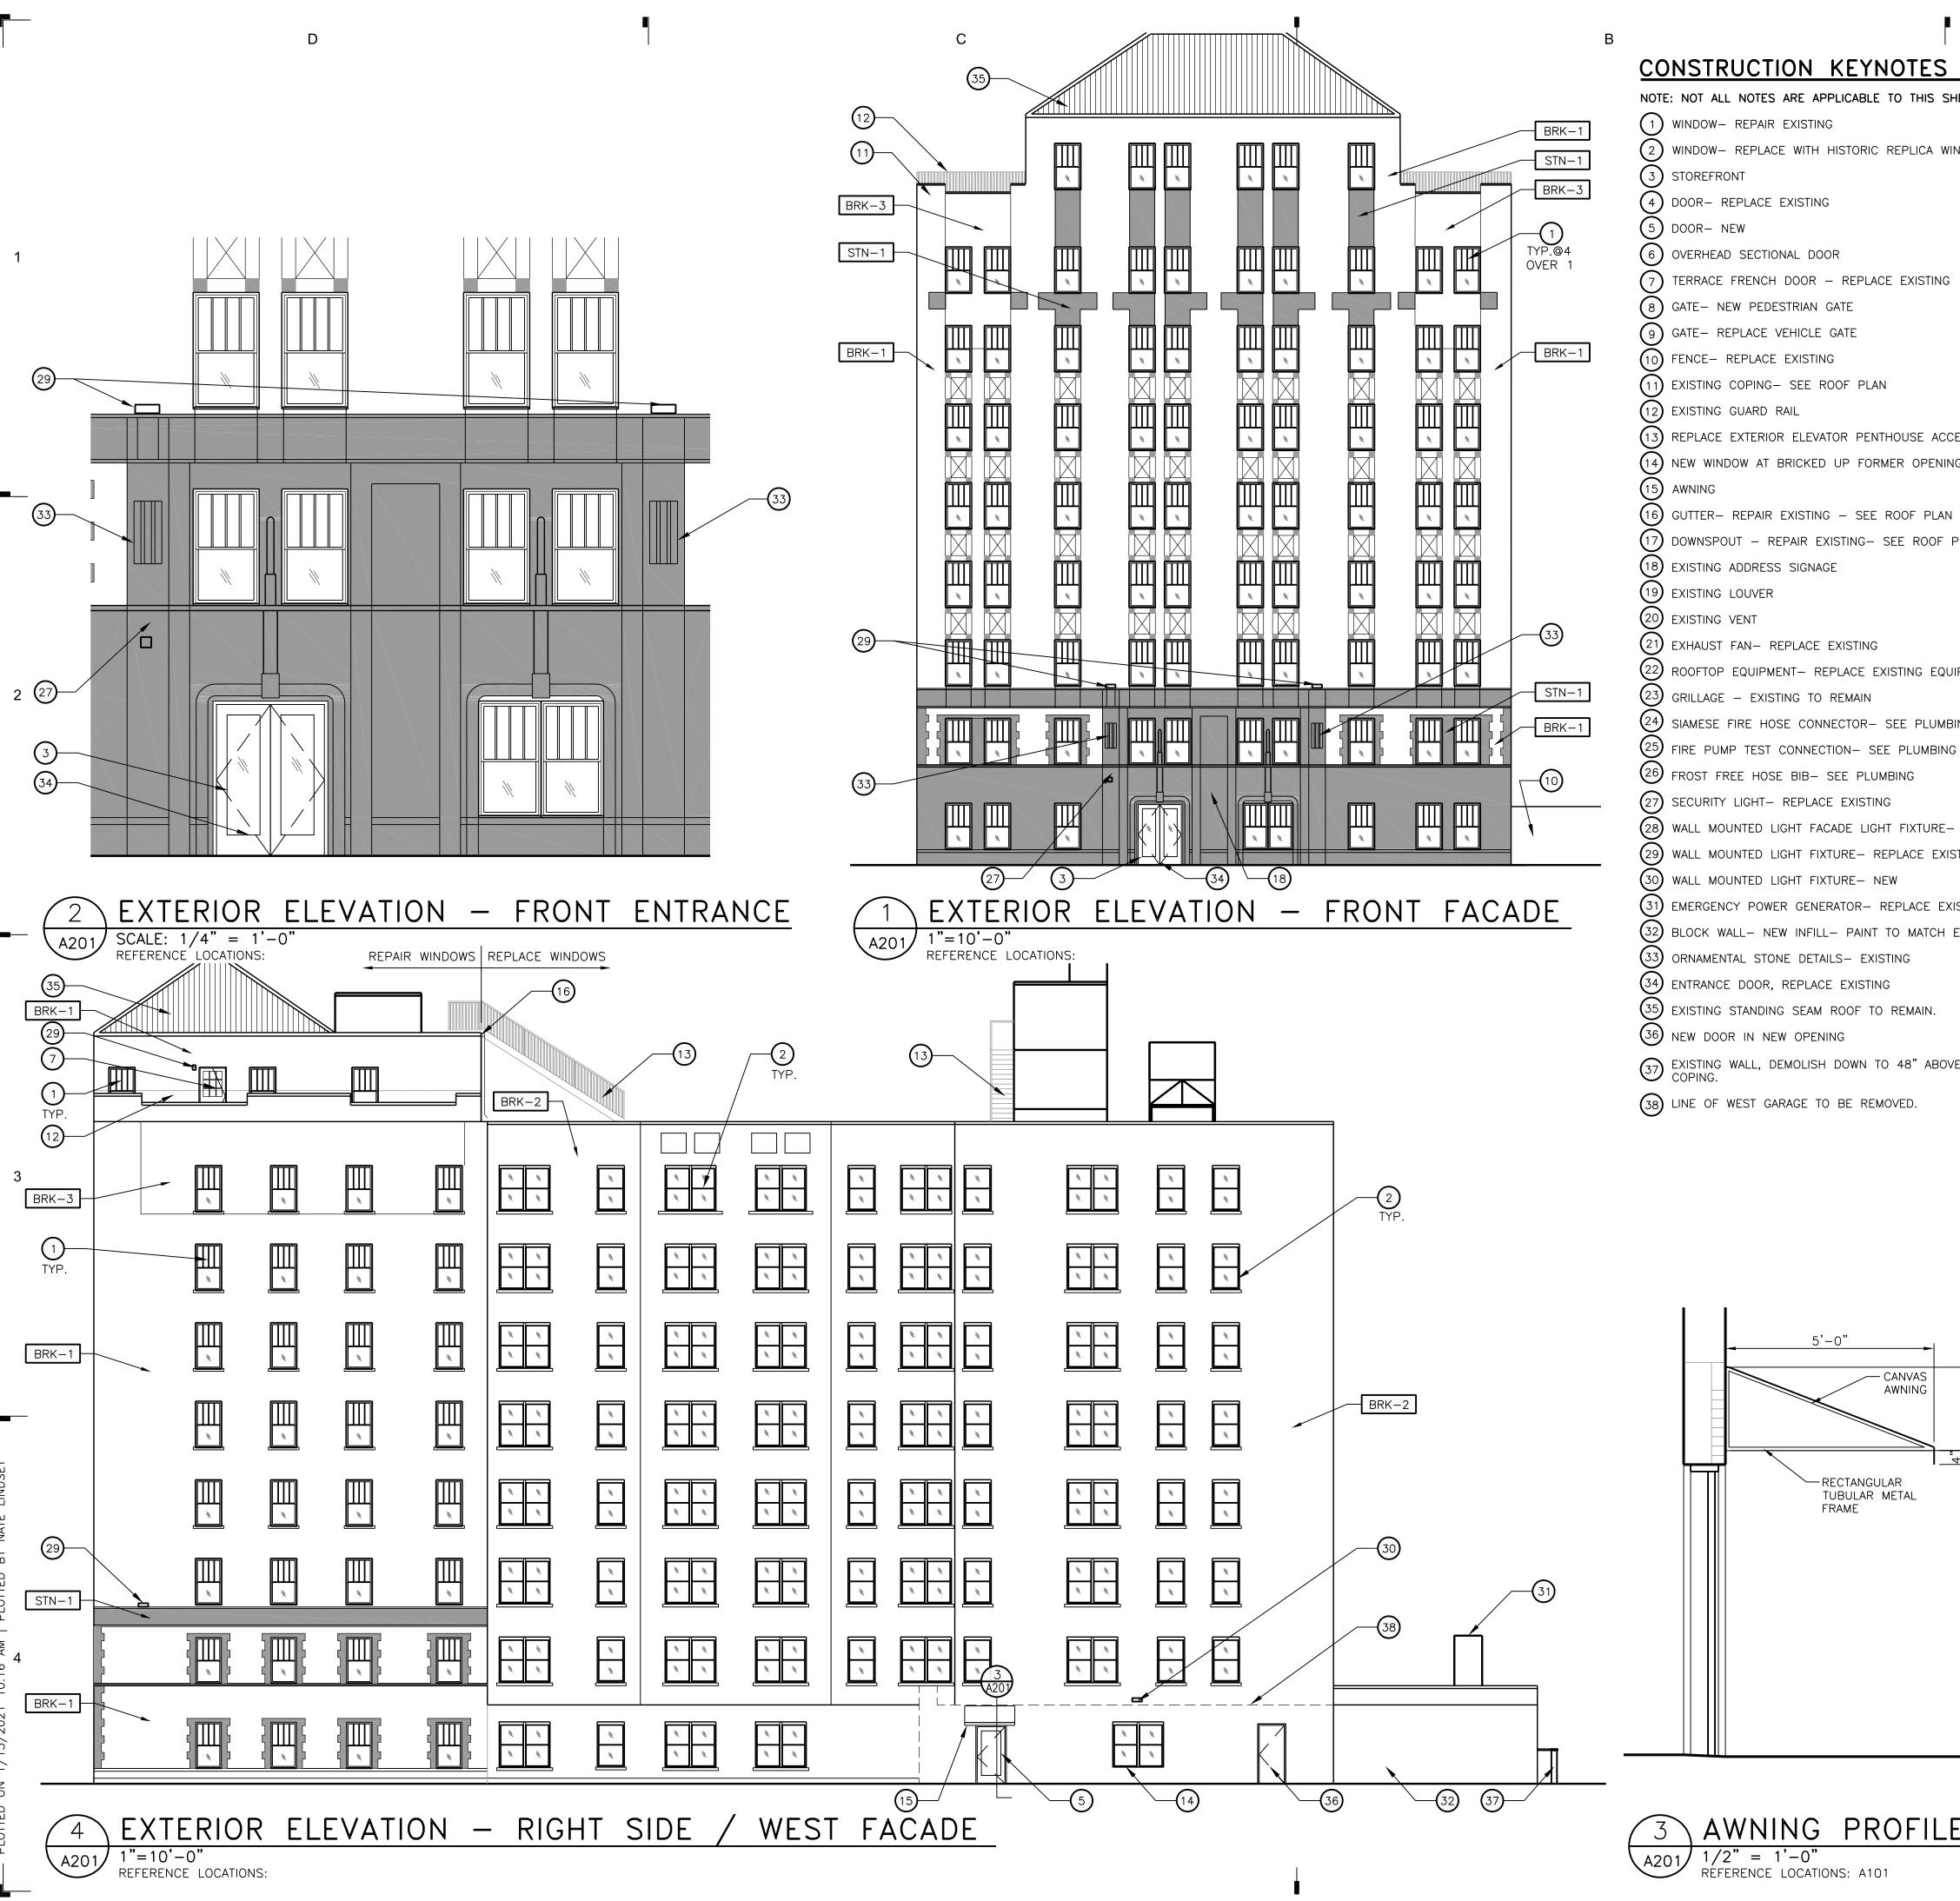

CONSTRUCTION KEYNOTES

NOTE: NOT ALL NOTES ARE APPLICABLE TO THIS SHEET.

(1) WINDOW- REPAIR EXISTING

(2) WINDOW- REPLACE WITH HISTORIC REPLICA WINDOW

(3) STOREFRONT

(4) DOOR- REPLACE EXISTING

(5) DOOR- NEW

(6) OVERHEAD SECTIONAL DOOR

(7) TERRACE FRENCH DOOR - REPLACE EXISTING

(8) GATE- NEW PEDESTRIAN GATE

9 GATE- REPLACE VEHICLE GATE

(11) EXISTING COPING- SEE ROOF PLAN

(12) EXISTING GUARD RAIL

(13) REPLACE EXTERIOR ELEVATOR PENTHOUSE ACCESS STAIR

(14) NEW WINDOW AT BRICKED UP FORMER OPENING

(15) AWNING

(16) GUTTER- REPAIR EXISTING - SEE ROOF PLAN

(17) downspout - repair existing- see roof plan

(18) EXISTING ADDRESS SIGNAGE

(19) EXISTING LOUVER

(20) EXISTING VENT

(21) EXHAUST FAN- REPLACE EXISTING

(22) ROOFTOP EQUIPMENT- REPLACE EXISTING EQUIPMENT

(23) GRILLAGE - EXISTING TO REMAIN

(24) SIAMESE FIRE HOSE CONNECTOR- SEE PLUMBING

(26) FROST FREE HOSE BIB- SEE PLUMBING

(27) SECURITY LIGHT- REPLACE EXISTING

(28) WALL MOUNTED LIGHT FACADE LIGHT FIXTURE— REPLACE EXISTING

(29) WALL MOUNTED LIGHT FIXTURE— REPLACE EXISTING

(30) WALL MOUNTED LIGHT FIXTURE— NEW

(31) EMERGENCY POWER GENERATOR- REPLACE EXISTING - SEE ELECTRICAL

(32) BLOCK WALL- NEW INFILL- PAINT TO MATCH EXISTING PAINTED BRICK.


(33) ORNAMENTAL STONE DETAILS— EXISTING

(34) ENTRANCE DOOR, REPLACE EXISTING big(35) existing standing seam roof to remain.

(36) NEW DOOR IN NEW OPENING

EXISTING WALL, DEMOLISH DOWN TO 48" ABOVE GRADE AND PROVIDE COPING.

(38) LINE OF WEST GARAGE TO BE REMOVED.

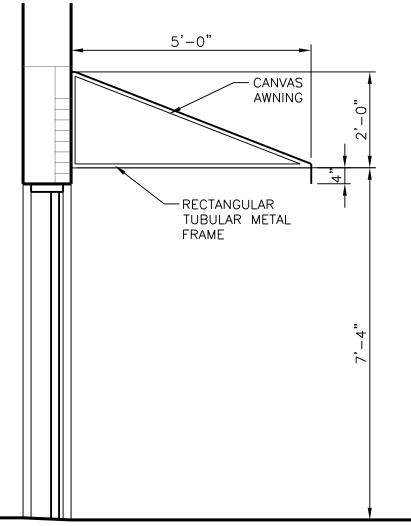

AWNING PROFILE

1/2" = 1'-0" REFERENCE LOCATIONS: A101

GENERAL NOTES

- A. REFER TO A600 SERIES FOR WINDOW AND DOOR SCHEDULE AND DETAILS.
- B. REFER TO ROOF PLAN FOR PARAPET AND OVERHANG
- INFORMATION. C. SEE ELECTRICAL DRAWINGS FOR ADDITIONAL LIGHTING
- REQUIREMENTS AND FIXTURE TYPES.
- D. PROVIDE BACKING AND/OR STRUCTURAL SUPPORT AS REQUIRED FOR SIGNAGÉ AND LIGHTING.
- E. APPLY SEALANT WHENEVER DISSIMILAR MATERIALS MEET

RESTORATION GENERAL NOTES

- A. MASONRY/STONE RESTORATION CONTRACTOR ("SUBCONTRACTOR") TO PROVIDE ALL LABOR, MATERIAL, EQUIPMENT, SUPERVISION, PERMITS, AND ANY OTHER COSTS OR EXPENSES NECESSARY TO COMPLETE THE WORK SUBCONTRACTOR JOB MOBILIZATION SHALL INCLUDE, BUT NOT BE LIMITED TO, ANY NECESSARY WORK STATION AND JOB TRAILER, MAST CLIMBING PLATFORMS, AERIAL LIFTS, SWING STAGES, BARRICADES AND WALK THRU SCAFFOLD AS NEEDED.
- BUILDING RESTORATION TO INCLUDE ALL TERMS, CONDITIONS AND SPECIFICATIONS OF ORIGINAL CONTRACT AND ANY ADDITIONAL WORK NECESSARY TO MEET THE SECRETARY OF THE INTERIOR STANDARDS FOR THE REHABILITATION OF HISTORIC PROPERTIES. THIS INCLUDES ALL WORK NECESSARY OVER AND ABOVE THAT SPECIFIED IN THE ARCHITECTURAL DRAWINGS AND OTHER CONSTRUCTION DOCUMENTS, INCLUDING ALL NOTES, REGARDLESS OF TIME AND MATERIAL NECESSARY TO EXECUTE THIS WORK. ANY AREAS INDICATED WITHIN DRAWINGS ARE ONLY SUGGESTIVE IN NATURE. MASON TO MEET WITH ARCHITECT AND OWNER TO CONFIRM THE SCOPE OF WORK.
- C. RESTORATION CONTRACTOR SHALL INSPECT ALL EXISTING MASONRY, INCLUDING BOTH SIDES OF PARAPET FULL HEIGHT FOR STRUCTURAL STABILITY PRIOR TO BID. REINSPECT AFTER INITIAL CLEANING OF MASONRY.
- D. ALL ELEVATIONS SHALL UNDERGO COMPLETE BRICK, STONE AND TERRA COTTA CLEANING FROM PARAPET TO GRADE. SEE MASONRY CLEANING SPECIFICATION SECTIONS FOR DETAILS ON APPROVED CLEANING PROCEDURES, PRODUCTS, AND MANUFACTURERS.
- E. CLEAN FACADE USING GENTLEST MEANS POSSIBLE TO ACHIEVE SATISFACTORY RESULTS WITHOUT CHANGING THE SURFACE OF THE MASONRY. PAY SPECIAL ATTENTION TO AREAS OF EXCESSIVE SOILING. CONTRACTOR SHALL CONDUCT TEST PATCHES TO ENSURE THE BEST AND MOST ECONOMICAL MEANS OF CLEANING. ALL MASONRY AND TERRA COTTA CLEANING SHALL MEET THE SECRETARY OF INTERIOR STANDARDS FOR REHABILITATION AS WELL AS ALL APPLICABLE NATIONAL PARK SERVICE TECHNICAL BRIEFS.
- SURFACES TO BE PRE-WET WITH CLEAN WATER. CLEANING SOLUTIONS TO NOT REMAIN ON SURFACES FOR MORE THAN 5 MINUTES FOLLOWED IMMEDIATELY BY LOW-PRESSURE FLOOD RINSE, UNLESS NOTED OTHERWISE IN MASONRY CLEANING SPECIFICATION. CLEANING IS TO BRING MASONRY/STONE UNIT AS CLOSE AS POSSIBLE TO ORIGINAL COLOR WITHOUT BURNING OR ABRASION.
- G. CLEAN ALL STONE THAT IS TO REMAIN & LET WEATHER FOR TWO WEEKS BEFORE ANY REPLACEMENT OR PATCHING IS TO OCCUR - REPLACEMENT STONE & PATCHED AREAS TO MATCH EXIST 'CLEANED' COLOR.
- H. 100% OF MORTAR JOINTS TO BE VISUALLY INSPECTED. ALL MORTAR JOINTS DETERIORATED IN EXCESS OF 3/8 INCH BEYOND FACE OF MASONRY/STONE UNIT, OR EVIDENCING UNSOUNDNESS OR CRACKING WHETHER STRUCTURAL OR OTHERWISE SHALL BE REMOVED TO A DEPTH OF 1/2" MINIMUM. WRITTEN APPROVAL BY OWNER SHALL BE REQUIRED PRIOR TO COMMENCEMENT OF REPAIR BY STAISFACTORY SUBMISSION OF MOCK-UP OF PROPOSED MORTAR JOINT.
- I. NEW MORTAR APPLIED TO ALL OPEN JOINTS SHALL BE OF NO GREATER STRENGTH THAN ORIGINAL MORTAR OR MASONRY UNITS. MORTAR COLOR, TEXTURE, CONSISTENCY AND JOINT PROFILE WILL MATCH EXISTING AS CLOSE AS POSSIBLE.
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M. ANY MASONRY/STONE UNIT SHALL BE REPLACED WITH OWNER APPROVED MATERIAL WHEREIN SPALLING OR OTHER DETERIORATION ELIMINATED MORE THAN 5% OF THE MASONRY/STONE UNIT (MEASURED BY ORIGINAL BRICK OR STONE FACE AREA.)

EXTERIOR ELEVATION MATERIAL LEGEND

STN-1 GRAY LIMESTONE - EXISTING - CLEAN AND REPAIR

BRICK, DARK RED - EXISTING ORIGINAL - CLEAN AND REPAIR

BRICK, LIGHT TAUPE PAINTED- EXISTING - CLEAN AND REPAIR

BRICK, RED, FROM PRIOR REPAIR WORK - CLEAN AND REPAIR

SCALE : 1/8" = 1'-0"

Consultant

QU. LP OWN

Project / Owner



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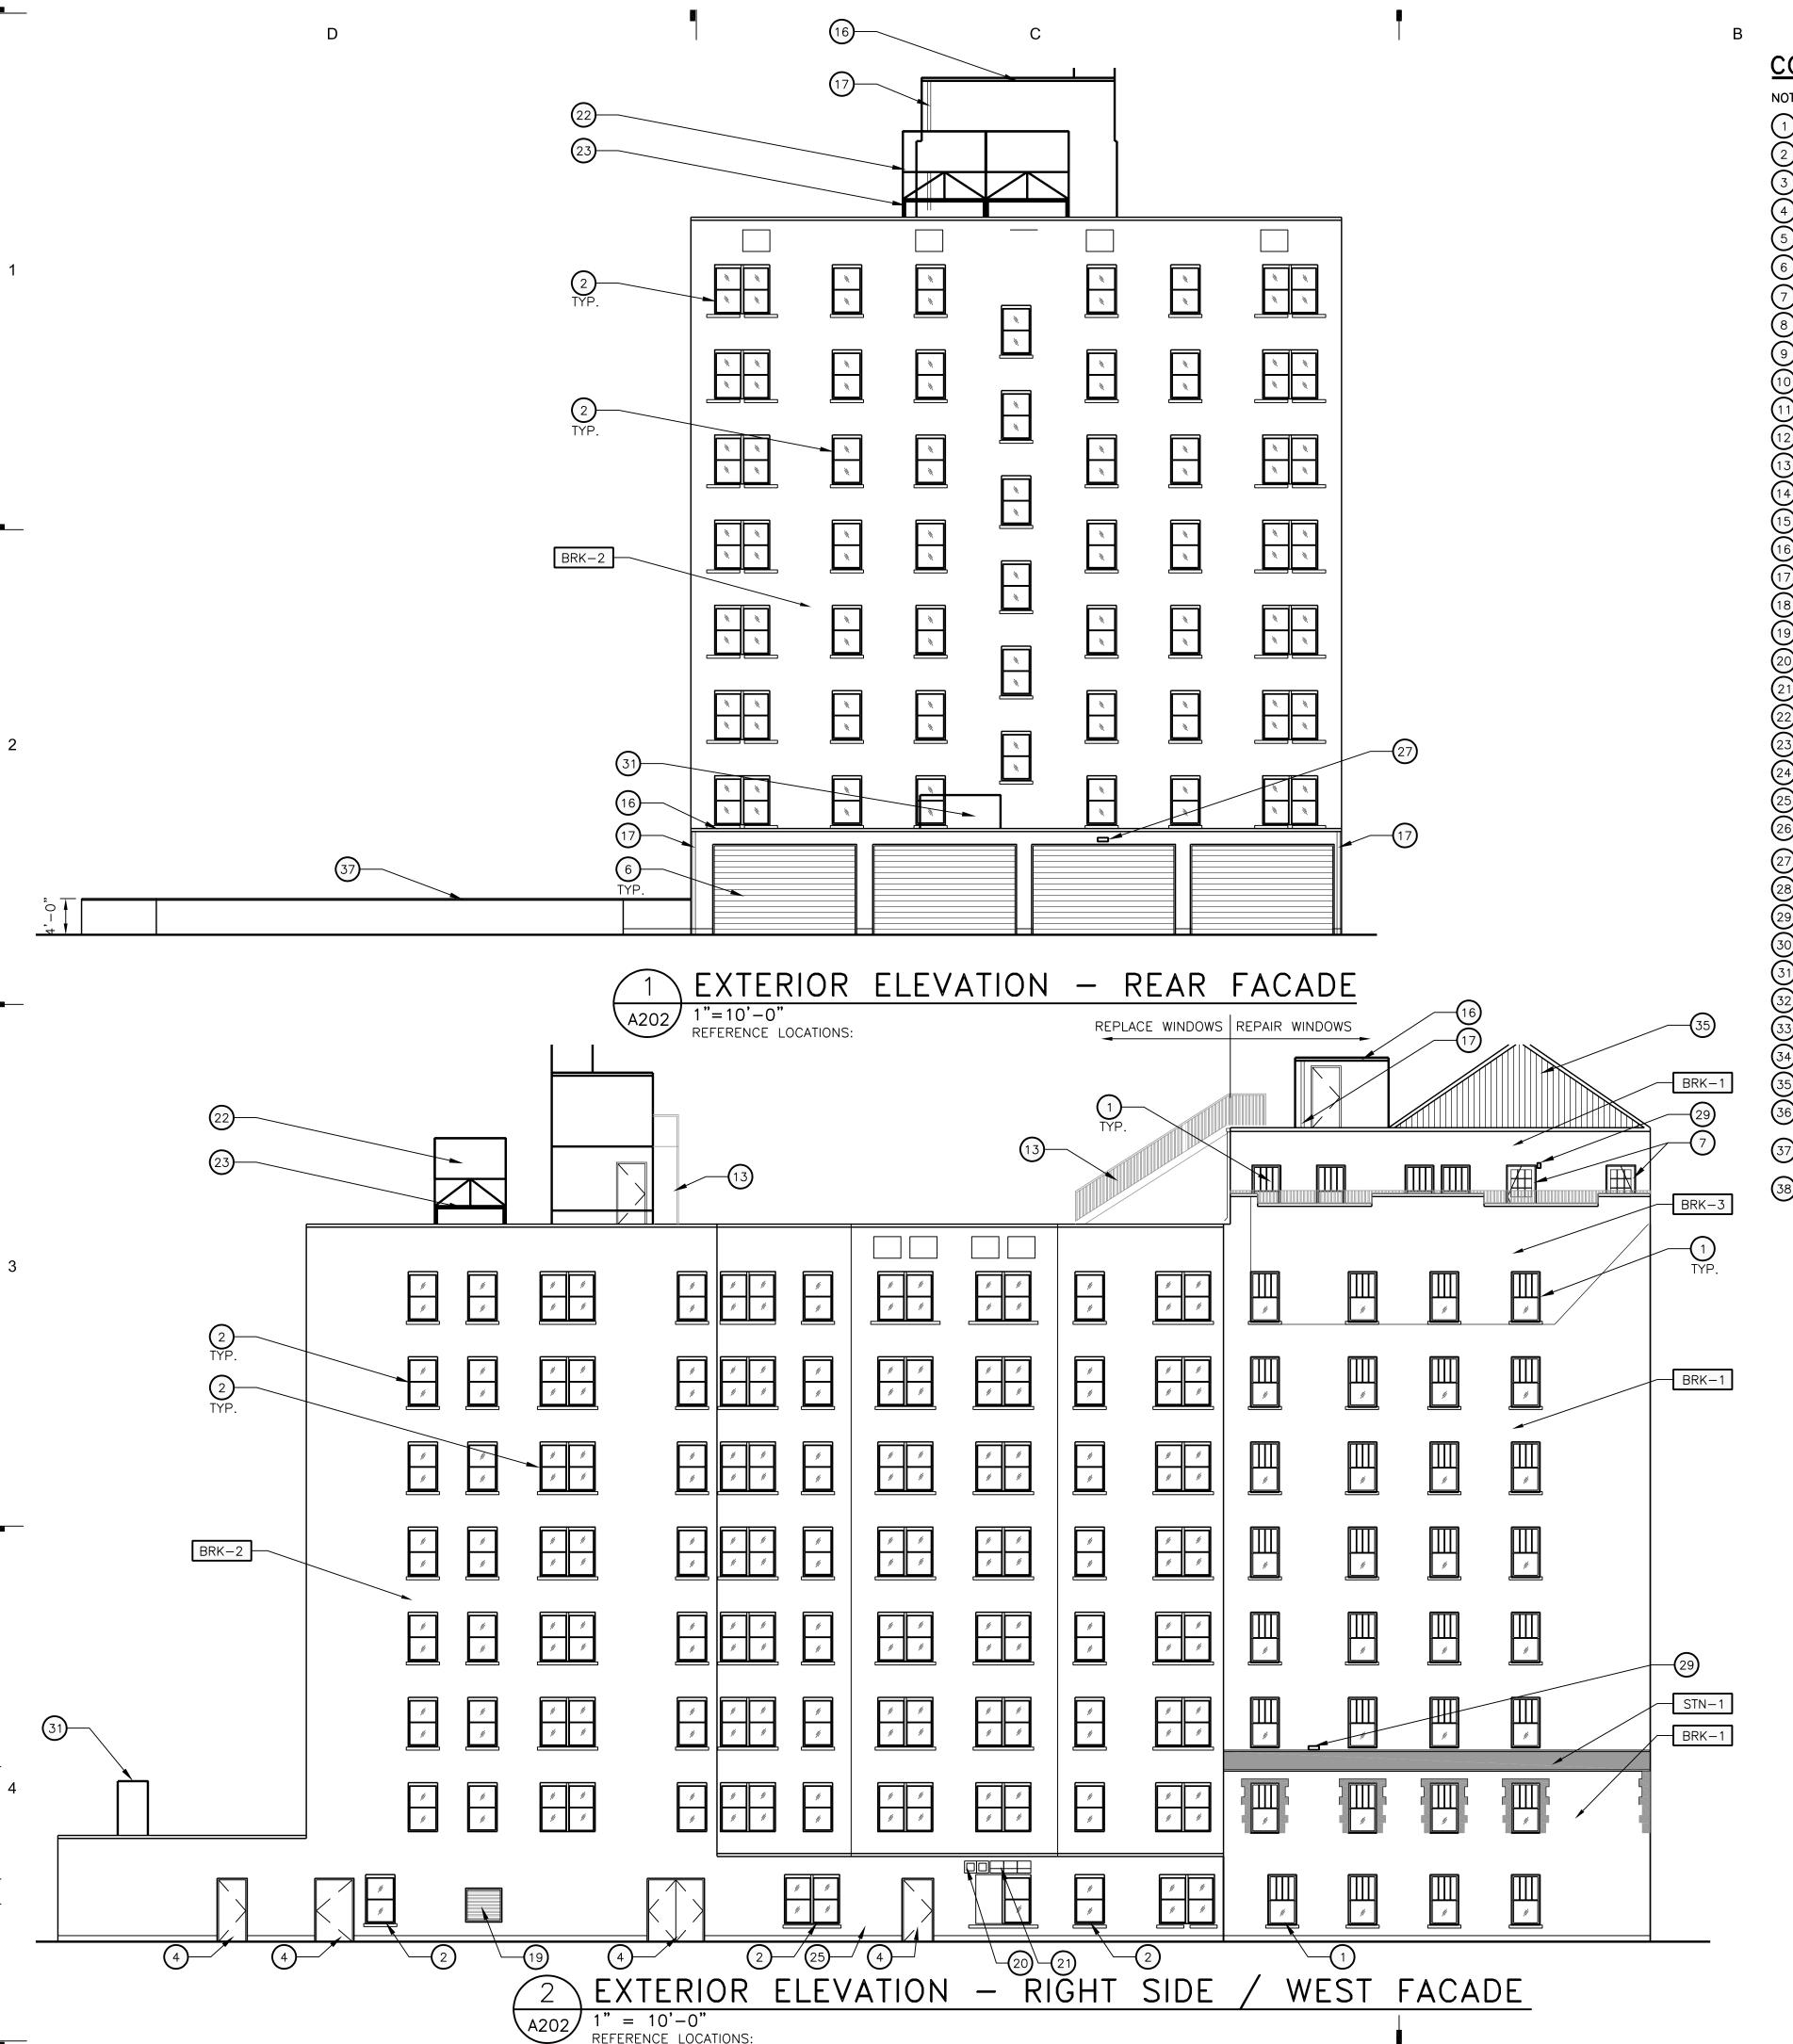
issued for date Date Revision

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Sheet Number

Sheet Title



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38 LINE OF WEST GARAGE TO BE REMOVED.

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EXTERIOR ELEVATION MATERIAL LEGEND

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BRK-1 BRICK, DARK RED - EXISTING ORIGINAL - CLEAN AND REPAIR

BRK-2 BRICK, LIGHT TAUPE PAINTED- EXISTING - CLEAN AND REPAIR

BRICK, RED, FROM PRIOR REPAIR WORK — CLEAN AND REPAIR

0 2' 4' 8' SCALE : 1/8" =1'-0" KraemerDesignGroup

Architect

Consultant

IDTOWN SQUARE II
LDHA LP

Project / Owner



Seal

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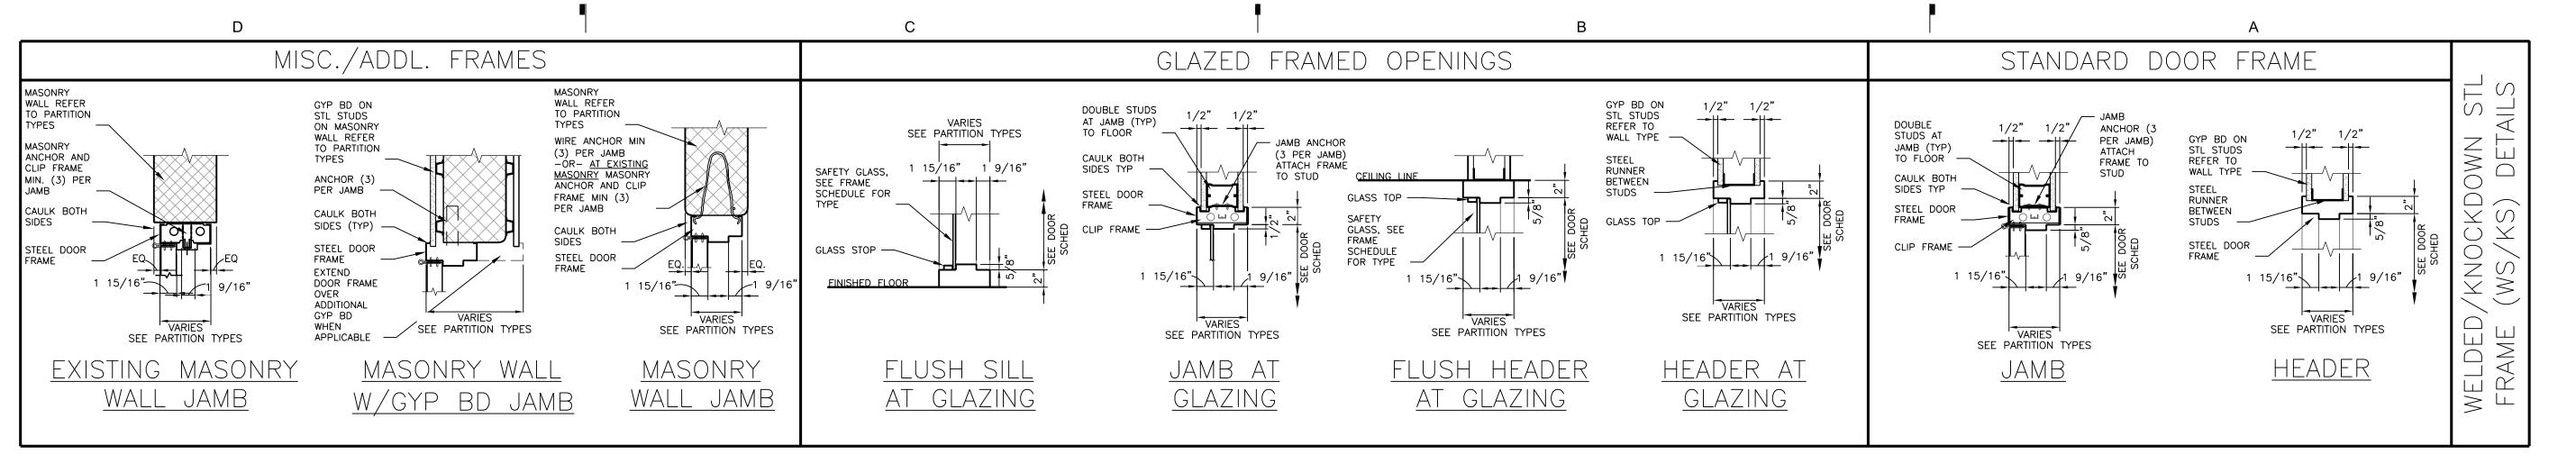
HDC 01-15-21
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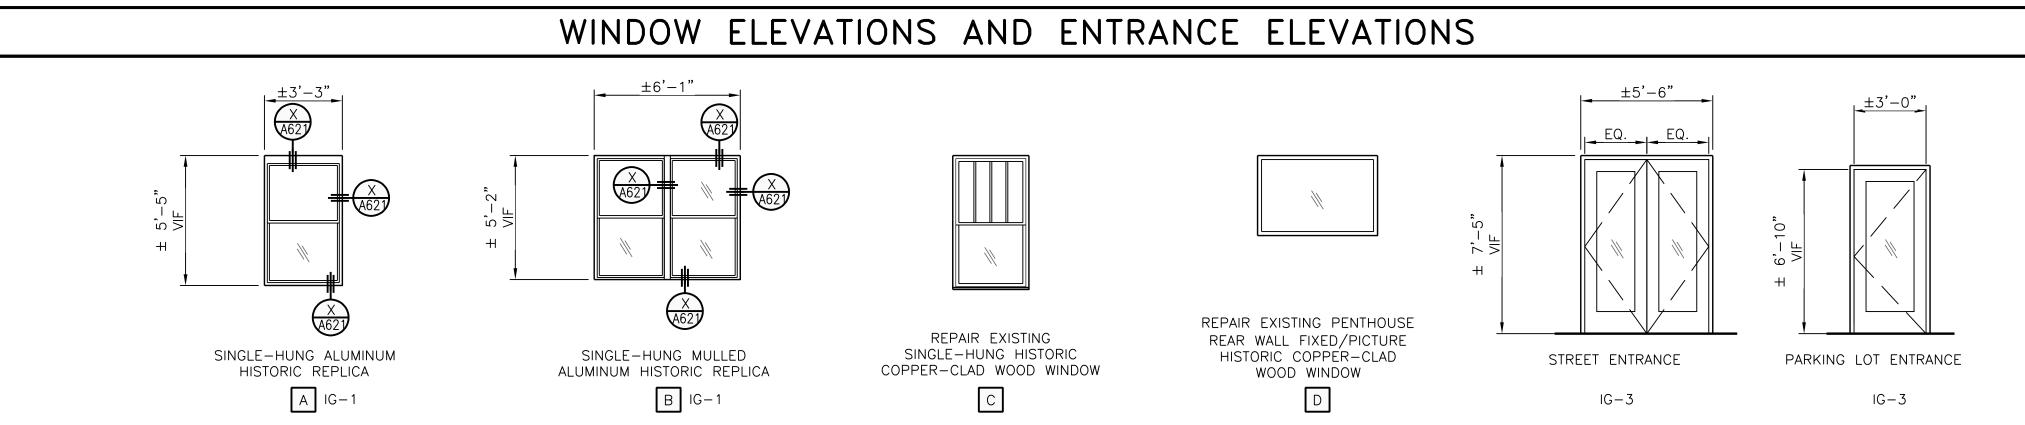
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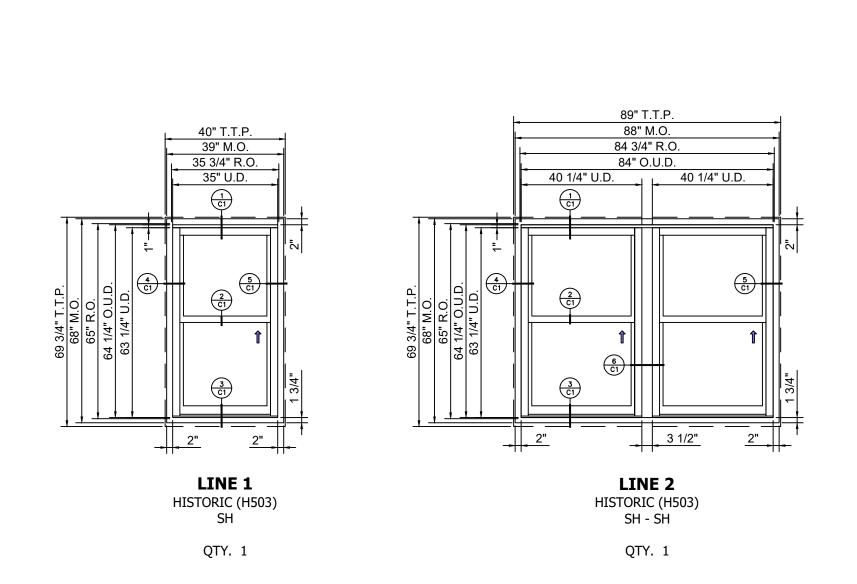
GENERAL WINDOW NOTES


- A. WINDOWS AT APARTMENTS TO HAVE OPERABLE SASHES.
 PROVIDE RESTRICTORS FOR ALL WINDOWS. ALLOW 4" OPENING
 ON WINDOWS.
- B. WINDOWS AT COMMUNITY ROOM TO HAVE RESTRICTORS THAT DO NOT ALLOW THE SASH TO OPEN.


GLASS TYPES

IG-1 INSULATED GLASSIG-3 INSULATED SAFETY GLASS

WINDOW DETAILS - BASIS OF DESIGN



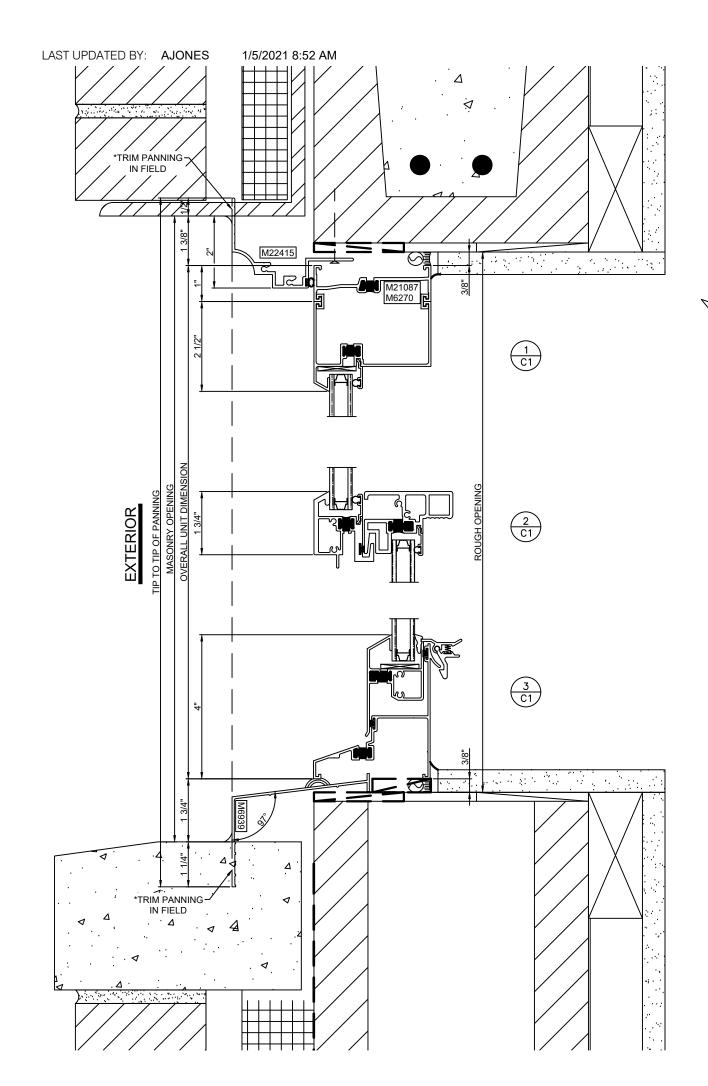

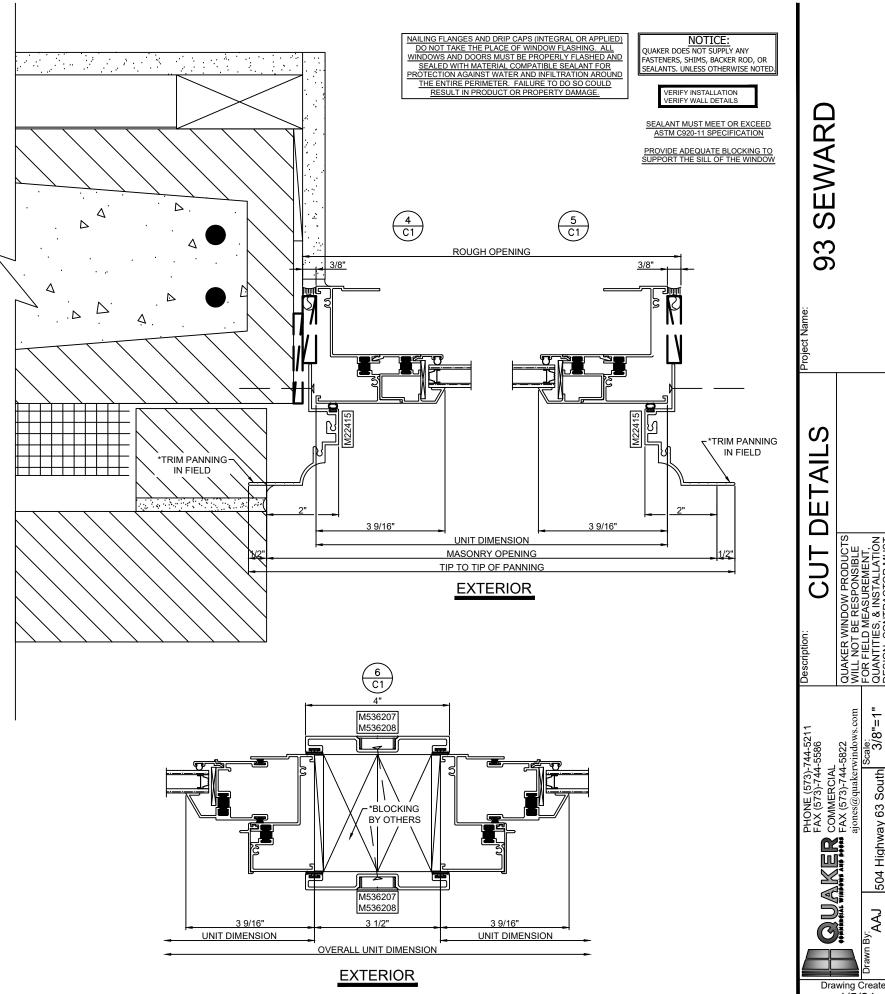

Consultant

aemer**Design**Group

MIDTOWN SQUARE
93 SEWARD ST
DETROIT, MICHIGAN
MIDTOWN SQUARE II
LDHA LP
300 SOUTH GRAND AVE, 14TH FLR
LOS ANGELES, CA 90071

Project / Owner

PRELIMINARY NOT FOR CONSTRUCTION

Seal

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Date

Project Number 20200 Sheet Title

DOOR AND WINDOW DETAILS

Sheet Number

Revision