EDISON PORCH RENOVATION



	PHASE 1 PRICING SET AUGUST 07, 2020
# DRAWING NAME	P A
T-000 TITLE, DEMO, & SITE PLANS	•
G-001 GENERAL NOTES	•
A-100 FLOOR PLANS	•
A-101 FOUNDATION, FRAMING PLANS & ELEVATIONS	•
A-300 ELEVATION	•
A-400 SECTION	•

PROJECT INFORMATION

OWNER: MARK HUDSON & AMANDA LEWAN

ADDRESS: 2044 EDISON STREET, DETROIT, MI, 48209

PARCEL ID NUMBER: 08002876.

REGULATING BODY: CITY OF DETROIT

CODE: 2015 MICHIGAN RESIDENTIAL CODE ZONING: R1 - LOW DENSITY RESIDENTIAL USE: SINGLE-FAMILY RESIDENTIAL

HISTORIC DISTRICT: **BOSTON EDISON** JOY FARM

MIN. LOT WIDTH: MIN. LOT AREA: 50'-0" 5000 SF FRONT YARD SETBACK

BACK YARD SETBACK

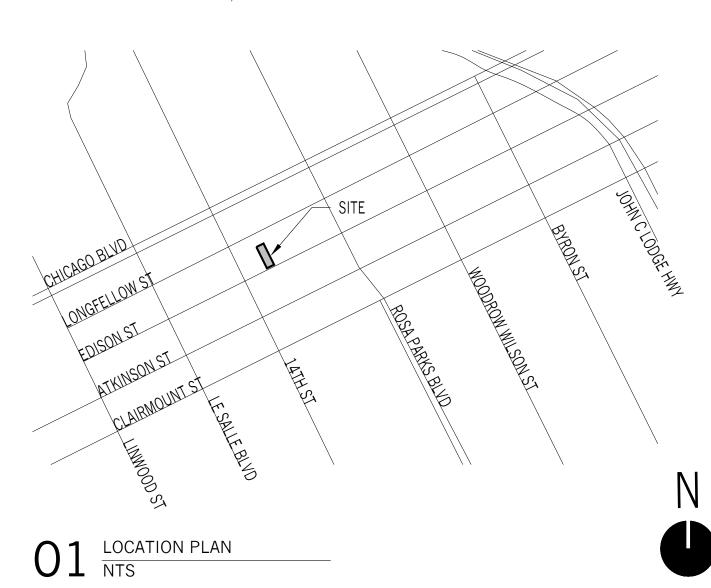
3' MINIMUM / 11'-6" COMBINED* SIDE YARD SETBACK SECTION 61.13.14 (1)

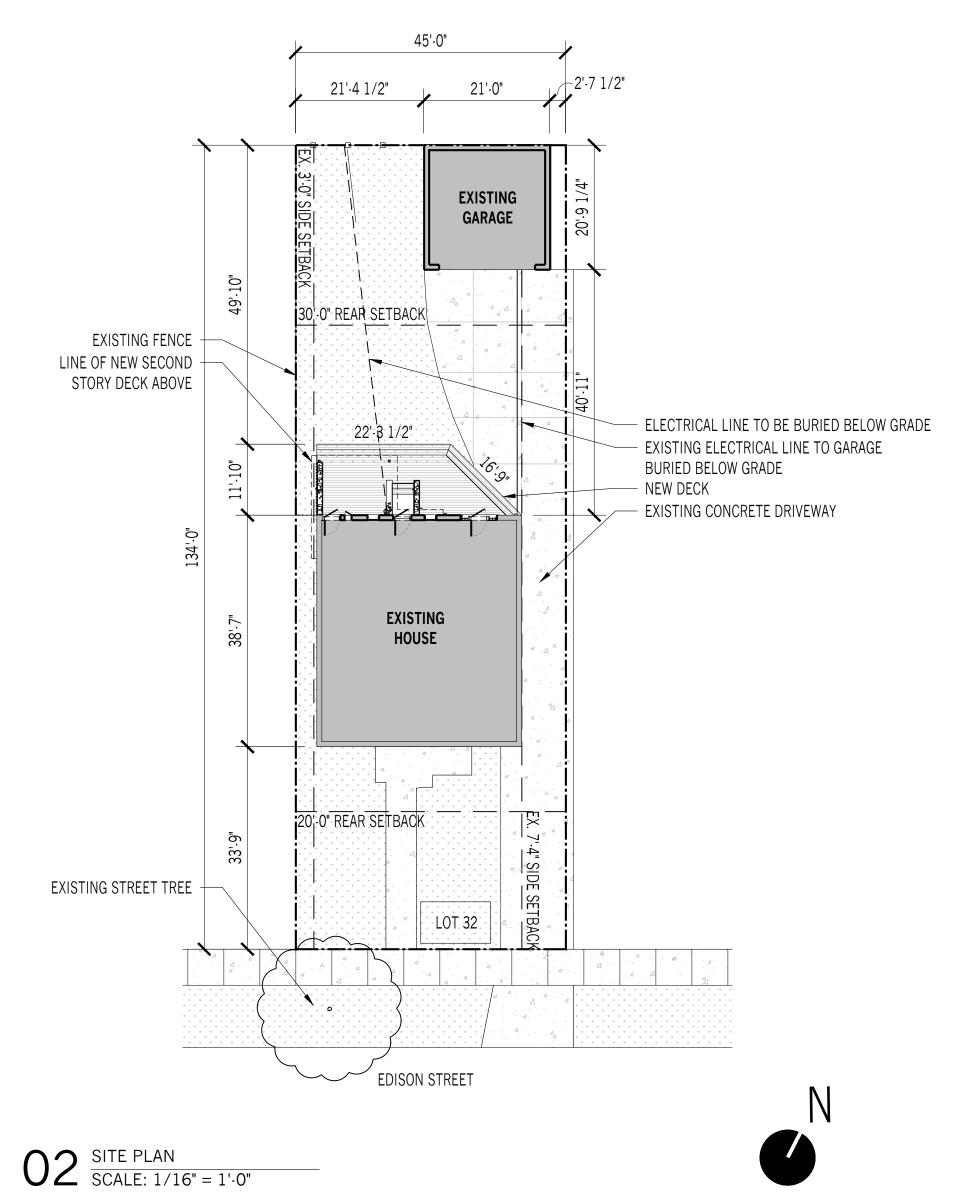
EXISTING LOT SIZE: 6,075 SF LOT WIDTH: 45'-0" LOT DEPTH: 135'-0" 1,593 SF EX.HOUSE FOOTPRINT: 1,770 SF EX. HOUSE AREA

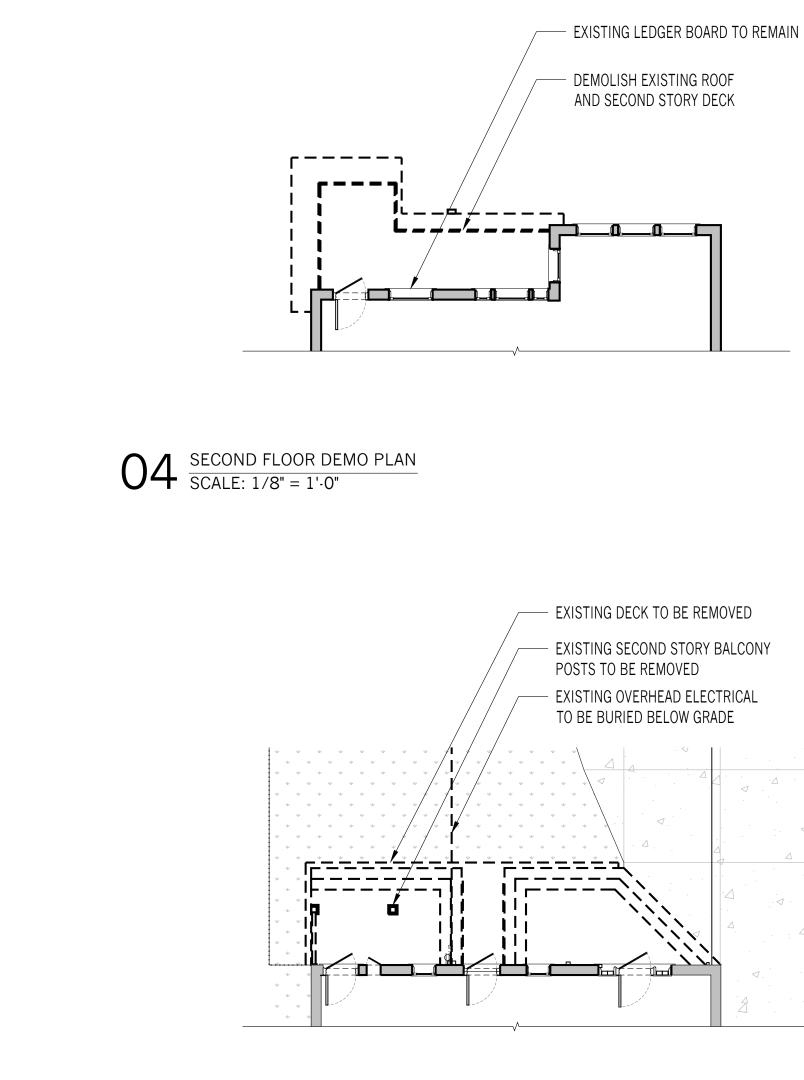
PROPOSED USE:

SINGLE FAMILY RESIDENTIAL 1,665 SF HOUSE FOOTPRINT:

1,334 SF HOUSE AREA







 $03 \frac{\text{FIRST FLOOR DEMO PLAN}}{\text{SCALE: } 1/8" = 1'-0"}$







TITLE & **GENERAL NOTES**

T-000

GENERAL NOTES

- 1. THIS APPLICATION IS BEING FILED FOR A PORCH ADDITION AND RENOVATION ON THE SITE OF AN EXISTING HOUSE
- 2. ALL WORK SHALL BE DONE IN ACCORDANCE WITH THE REQUIREMENTS OF THE 2015 MICHIGAN RESIDENTIAL CODE AND ALL OTHER APPLICABLE LAWS, INCLUDING FIRE DEPARTMENT REGULATIONS, UTILITY COMPANY REQUIREMENTS, AND BEST TRADE PRACTICES.
- 3. BEFORE COMMENCING WORK, THE CONTRACTOR SHALL FILE ALL REQUIRED CERTIFICATES OF INSURANCE WITH THE BUILDING DEPARTMENT, OBTAIN ALL REQUIRED PERMITS, AND PAY ALL FEES REQUIRED BY GOVERNING AGENCIES.
- 4. CONTRACTOR SHALL VERIFY ALL EXISTING CONDITIONS AND DIMENSIONS SHOWN ON PLANS AT THE JOB SITE BEFORE COMMENCING ANY WORK, AND SHALL REPORT ANY DISCREPANCIES BETWEEN DRAWINGS AND FIELD CONDITIONS TO THE ARCHITECT.
- 5. THE CONTRACTOR SHALL LAY OUT HIS OWN WORK, AND SHALL PROVIDE ALL DIMENSIONS REQUIRED FOR OTHER TRADES (MECHANICAL, ELECTRICAL, PLUMBING, ETC).
- 6. THE CONTRACTOR IS NOT TO SCALE DRAWINGS OR DETAILS, ONLY WRITTEN DIMENSIONS SHALL BE USED. WHERE REQUIRED DIMENSIONS ARE MISSING, NOTIFY ARCHITECT FOR CLARIFICATION.
- 7. ALL DIMENSIONS ARE TAKEN TO FINISHED FACE OR SURFACES, UNLESS OTHERWISE NOTED.

PLAN NOTES

1. ALL NEW WALLS TO BE 2X4 CONSTRUCTION @ 16" O.C. W/ ONE (1) LAYER 1/2"GYP BOARD EACH SIDE, UNLESS OTHERWISE NOTED

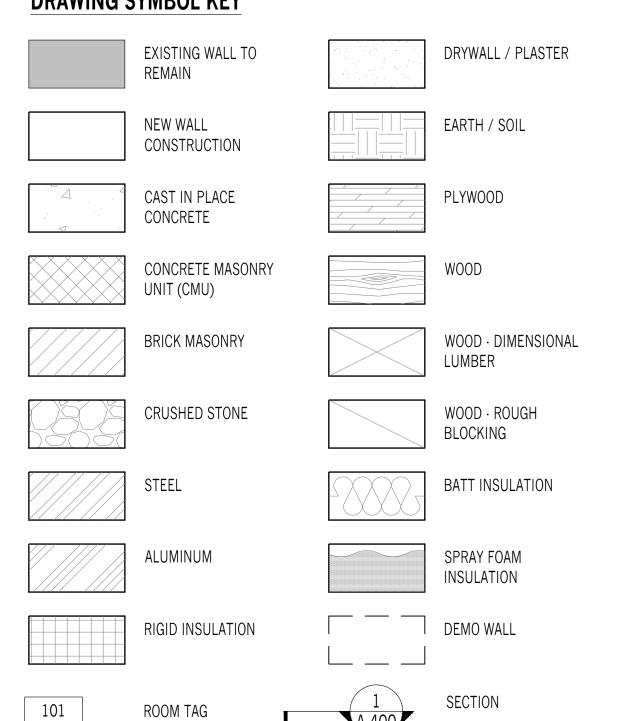
DEMO PLAN NOTES

- 1. ALL EXISTING WALLS, GLAZING, AND OTHER WORK TO REMAIN SHALL BE FULLY PROTECTED FROM DAMAGE. THE CONTRACTOR SHALL ASSUME FULL RESPONSIBILITY FOR DAMAGE AND SHALL MAKE REQUIRED REPAIRS WITHOUT ADDITIONAL COST TO THE OWNER.
- 2. SAVE AND STORE ALL REMOVED DOORS AND WINDOWS FOR REUSE.

POWER, LIGHTING, & RCP NOTES

- 1. UNLESS OTHERWISE NOTED, ALL RECEPTACLES & LIGHT FIXTURES SHALL BE CENTERED ON WALL OR BETWEEN OR BENEATH THE WINDOWS, DOORS, OTHER WORK, OR OTHER FIXTURES THEY ARE LOCATED IN RELATION TO.
- 2. RECEPTACLES SHOULD BE MOUNTED TO MATCH THE HEIGHT AND ORIENTATION OF EXISTING RECEPTACLES IN ROOM. SWITCHES TO BE MOUNTED TO MATCH THE HEIGHT OF EXISTING SWITCHES IN ROOM. IF NO REFERENCE EXISTS, ALL RECEPTACLES & LIGHT FIXTURES SHALL BE MOUNTED AT THE HEIGHTS SPECIFIED IN THE TYPICAL MOUNTING HEIGHTS DIAGRAM, UNLESS OTHERWISE NOTED.
- 3. SWITCHES, FIXTURES, AND RECEPTACLES SHOWN ADJACENT ON PLAN WITH DIMENSION ONLY TO ONE OF THEM SHOULD BE COMBINED IN BANKS OR STACKED VERTICALLY.
- 4. ALL APPLIANCE-SPECIFIC OUTLETS TO BE COORDINATED WITH APPLIANCE SELECTION.

DRAWING SYMBOL KEY



F FLOOR

| W | WALL

BA BASE

TR TRIM

CR CROWN

MW MILLWORK

—— – – LOT LINE

____ SETBACK

1 --- STRUCTURAL GRID LINE

FLOOR DRAIN

HORZ HORIZONTAL

C CEILING

DWG NUMBER


FINISH TAG

SHEET NUMBER

POWER, DATA, & LIGHTING KEY

DESCRIPTION	SYMBOL	DESCRIPTION
DUPLEX	\$	SWITCH
DUPLEX - SPECIFIC MOUNTING HT.	\$□	DIMMER SWITCH
DUPLEX - GFI	\$3	THREE-WAY SWITCH
QUADPLEX	\$ 3D	THREE-WAY DIMMER SWITCH
DUPLEX IN FLOOR	\$ J	JAMB SWITCH
SMOKE DETECTOR	Y	TELEPHONE
CARBON MONOXIDE DETECTOR	Y	INTERNET
SPEAKER LOCATION	₩	TELEVISION
SPEAKER INPUT	\oplus	PENDANT FIXTURE
RECESSED FIXTURE	\Phi	FLUSH MOUNT FIXTURE
WALL MOUNTED SCONCE		LED STRIP LIGHT
DENOTES WET-RATED FIXTURE		VENTILATION FAN
TRACK LIGHTING	ØØ	EXISTING FIXTURES
	DUPLEX - SPECIFIC MOUNTING HT. DUPLEX - GFI QUADPLEX DUPLEX IN FLOOR SMOKE DETECTOR CARBON MONOXIDE DETECTOR SPEAKER LOCATION SPEAKER INPUT RECESSED FIXTURE WALL MOUNTED SCONCE DENOTES WET-RATED FIXTURE	DUPLEX \$ DUPLEX · SPECIFIC MOUNTING HT. \$ DUPLEX · GFI \$ QUADPLEX \$ DUPLEX IN FLOOR \$ SMOKE DETECTOR Y CARBON MONOXIDE DETECTOR Y SPEAKER LOCATION \$ SPEAKER INPUT \$ RECESSED FIXTURE \$ WALL MOUNTED SCONCE —

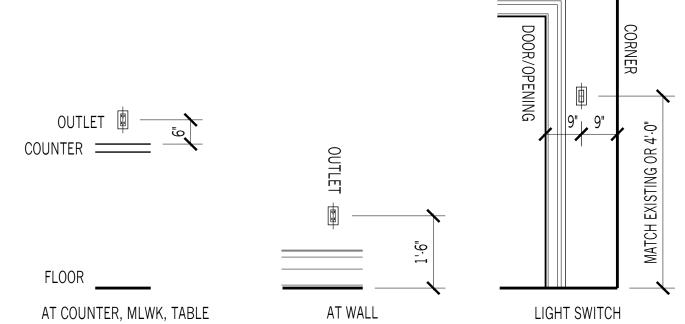TYPICAL MOUNTING HEIGHTS



OUTLET TO TOUT TO THE COUNTER TO THE	1'6"	BNINBAC B B B B B B B B B B B B B B B B B B B
FLOOR		
AT COUNTER, MLWK, TABLE	AT WALL	LIGHT SWITCH

PLUM PLUMBING

ABBREVIATIONS

CPT

CARPET

FAB FABRICATE

ROOM NAME

1.01

(01)

232

6<(A-802)>4

DOOR TAG

WINDOW TAG

WALL TYPE

ELEVATION MARKER

EXTERIOR ELEVATION

DWG NUMBER

INTERIOR ELEVATION(S)

REVISION TAG

SHEET NUMBER

ABV	ABOVE	CTR	CENTER	FB0	FURNISH BY OWNER	HR	HOUR	MDF	MEDIUM DENSITY FIBER	PLY	PLYWOOD	STL	STEEL
ACOUS	ACOUSTICAL	CW	COLD WATER	FLDR	FLOOR DRAIN	HT	HEIGHT		BOARD	PNT	PAINT	STR	STAIR
ADA	AMERICANS WITH			FIN	FINISH(ED)	HVAC	HEATING, VENTILATION &	MECH	MECHANICAL	POL	POLISHED	STRUC	STRUCTURE
	DISABILITIES ACT	DBL	DOUBLE	FLG	FLOORING		AIR CONDITIONING	MEMB	MEMBRANE	PRTN	PARTITION	SUP	SUPPLY
ADD	ADDITIONAL	DEMO	DEMOLITION	FLR	FLOOR	HW	HOT WATER	MFTD	MANUFACTURED	PSF	POUNDS PER SQUARE	SUSP	SUSPENDED
ADJ	ADJACENT	DIA	DIAMETER	FLUOR	FLUORESCENT	HWH	HOT WATER HEATER	MFTR	MANUFACTURER		FOOT	SYM	SYMMETRICAL
AFF	ABOVE FINISHED FLOOR	DEG	DEGREE	FND	FOUNDATION	ID	INSIDE DIAMETER	MH	MANHOLE	PT	PRESSURE TREATED	SYST	SYSTEM
ALT	ALTERNATE	DIM	DIMENSION	FP	FIRE PROOFING	IN	INCH	MIN	MINIMUM	PTD	PAINTED		
ALW	ALLOW	DW	DRYWALL	FO	FACE OF	INCAD	INCANDESCENT	MIR	MIRROR			UL	UNDERWRITERS
ALWB	ALLOWABLE	DISP	DISPENSER	FT	FOOT/FEET	INSUL	INSULATION	MISC	MISCELLANEOUS	QUAL	QUALITY		LABORATORY
ALUM	ALUMINUM	DN	DOWN	FTG	FOOTING	INT	INTERIOR	MMR	MOISTURE & MOLD	QTY	QUANTITY	UON	UNLESS OTHERWISE
ANOD	ANODIZED	DR	DOOR						RESISTANT	R	RISER		NOTED
ARCH	ARCHITECT	DSPT	DOWNSPOUT	GA	GAUGE	JBOX	JUNCTION BOX	MO	MASONRY OPENING	RAD	RADIUS		
ASMB	ASSEMBLY	DTL	DETAIL	GALV	GALVANIZED	JC	JANITORS CLOSET	MTL	METAL	RD	ROOF DRAIN	VNL	VINYL
		DWG	DRAWING	GAR	GARAGE	JST	JOIST	MUL	MULLION	RECT	RECTANGULAR	VERT	VERTICAL
BLDG	BUILDING			GC	GENERAL CONTRACTOR	JNT	JOINT			REF	REFERENCE	VEST	VESTIBULE
BLT-IN	BUILT-IN	EA	EACH	GFRC	GLASS FIBER REINFORCED			NFC	NOT FOR CONSTRUCTION	REINF	REINFORCED	VIF	VERIFY IN FIELD
		EC	ELECTRICAL CONTRACTOR		CONCRETE	KIT	KITCHEN	NIC	NOT IN CONTRACT	REQD	REQUIRED		
CAB	CABINET	EL	ELEVATION	GLZ	GLAZING			NO	NUMBER	REV	REVISION	W	WIDTH
CEM	CEMENT	ELEC	ELECTRICAL	GR	GRADE	L	LENGTH	NOM	NOMINAL	RF	ROOF	W/	WITH
CIP	CAST IN PLACE	ELEV	ELEVATOR	GUT	GUTTER	LAM	LAMINATE	NTS	NOT TO SCALE	RM	ROOM	W/O	WITHOUT
CL	CENTER LINE	ENCL	ENCLOSURE	GWB	GYPSUM WALL BOARD	LAV	LAVATORY			RO	ROUGH OPENING	WAT	WATER
CLG	CEILING	ENG	ENGINEER			LBS	POUNDS	OC	ON CENTER				
CLO	CLOSET	EQ	EQUAL	H/C	HANDICAPPED	LF	LINEAR FEET	OD	OUTSIDE DIAMETER	SAN	SANITARY	WC	WATER CLOSET
CMU	CONCRETE MASONRY	EQUIP	EQUIPMENT	HALG	HALOGEN	LN	LINEAR	OPNG	OPENING	SCHED	SCHEDULE	WD	WOOD
	UNIT	EST	ESTIMATE(D)	HB	HOSE BIB	LT	LIGHT	OPP	OPPOSITE	SECT	SECTION	WP	WATERPROOFING
COL	COLUMN	EXH	EXHAUST	HC	HOLLOW CORE			OPT	OPTION(AL)	SF	SQUARE FOOT	WPT	WORKING POINT
CONC	CONCRETE	EXP JT	EXPANSION JOINT	HD	HEAD	MACH	MACHINE	OZ	OUNCE `	SHT	SHEET	WT	WEIGHT
CONST	CONSTRUCTION	EXIST	EXISTING	HDF	HIGH DENSITY FIBER	MAS	MASONRY			SIM	SIMILAR		
CONT	CONTINUOUS	EXT	EXTERIOR		BOARD	MAX	MAXIMUM	PH	PENTHOUSE	SPEC	SPECIFICATION	&, +	AND
COORD	COORDINATE			HDWR	HARDWARE	MC	MECHANICAL	PL	PROPERTY LINE	SQ	SQUARE	@	AT
CORR	CORRIDOR	F&I	FURNISH AND INSTALL	НМ	HOLLOW METAL		CONTRACTOR	PLAS	PLASTIC	SS	STAINLESS STEEL	-	



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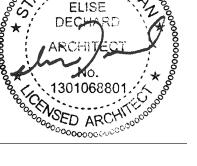
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RENOVATION ECK AND 2044 Edison Street Detroit, MI 48206 **EDISON PORCH**

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OF MICHION

NO. ISSUE/REV.

PERMIT SET 08/07/2020



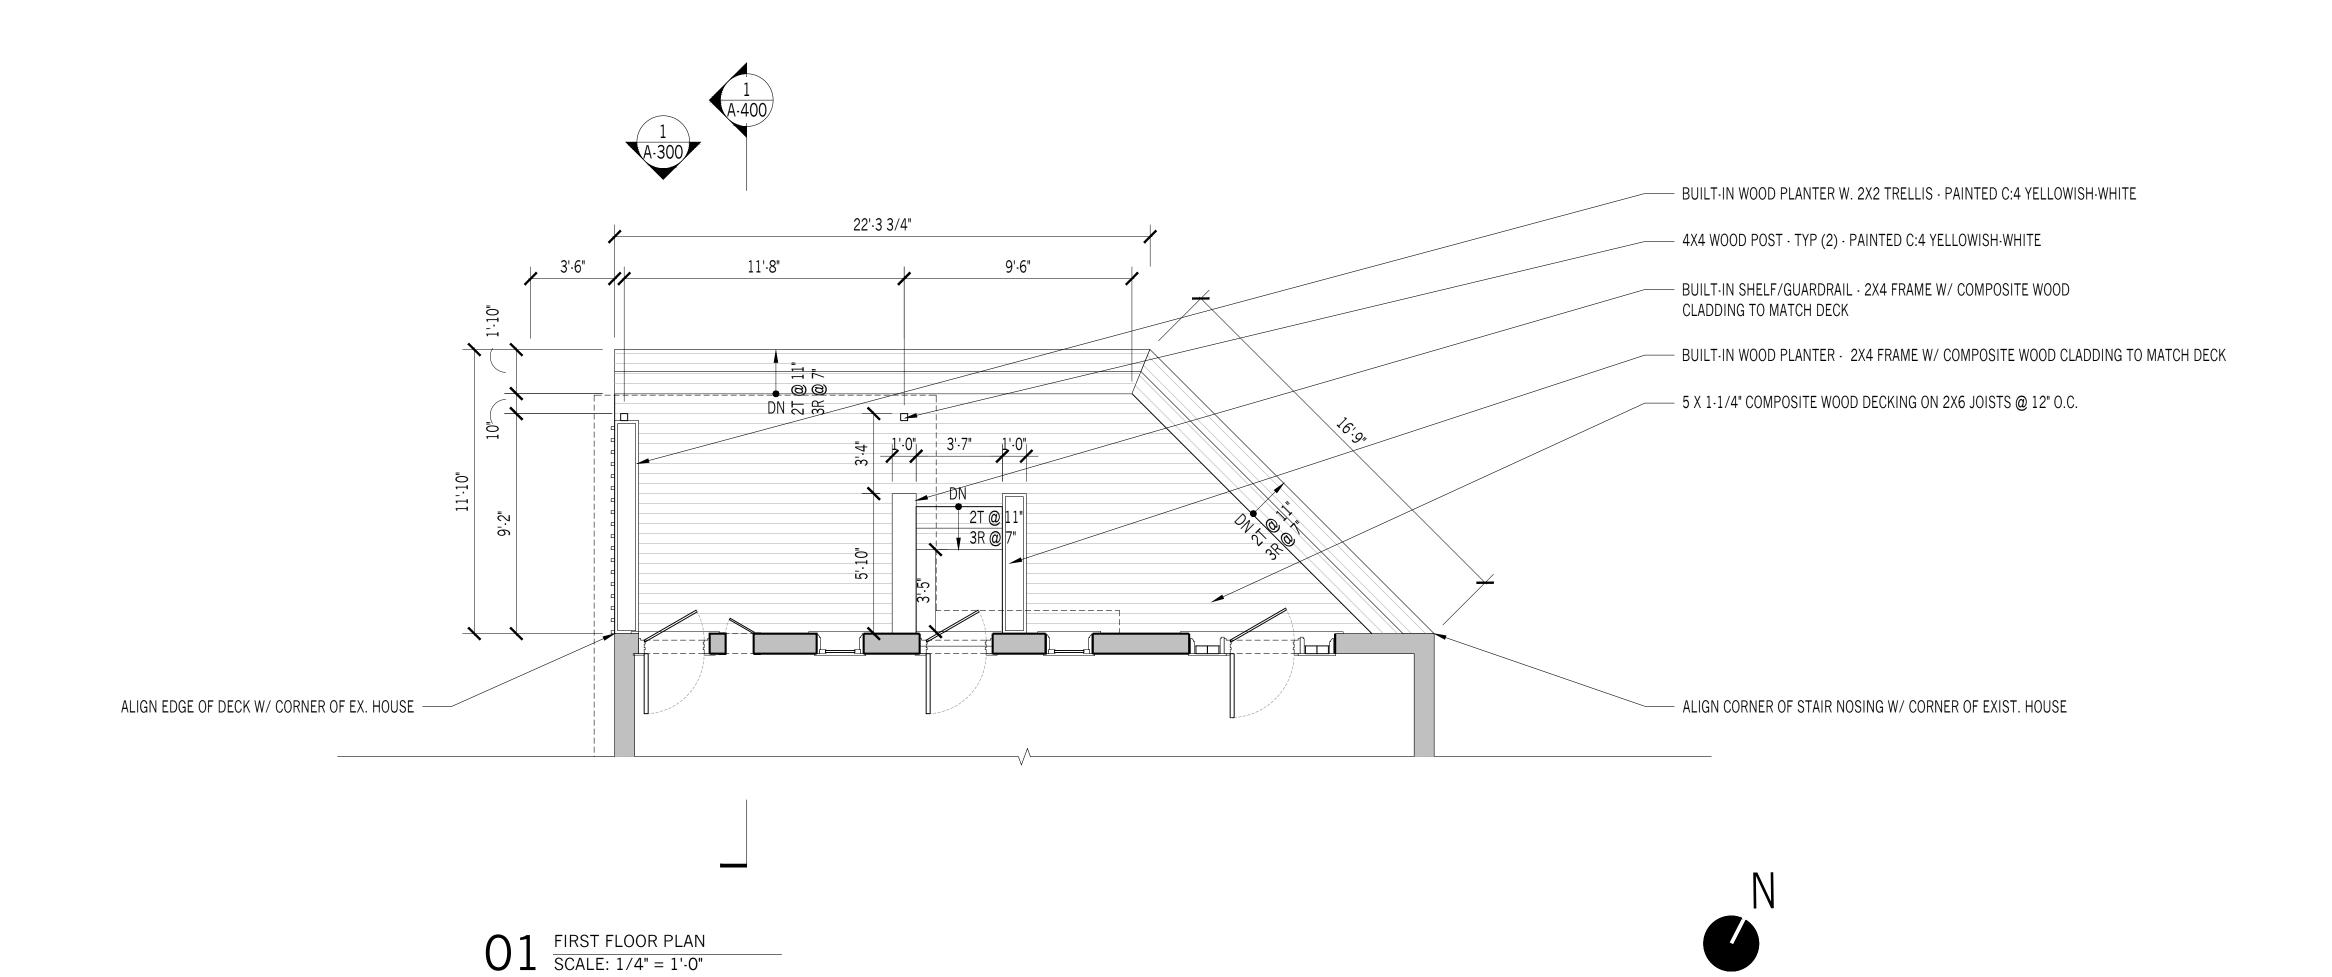
GENERAL NOTES

G-001

STANDARD

STD

 $02 \frac{\text{SECOND FLOOR PLAN}}{\text{SCALE: } 1/4" = 1'-0"}$



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EDISON PORCH AND DECK RENOVATION
2044 Edison Street
Detroit, MI 48206

NO. ISSUE/REV. DATE

--- PERMIT SET 08/07/2020

ELISE DECHARD ARCHITECT AND ARCHITECT ARCHITEC

FLOOR PLANS

A-100

H AND DECK RENOVATION

EDISON PORCH AND E 2044 Edison Street Detroit, MI 48206

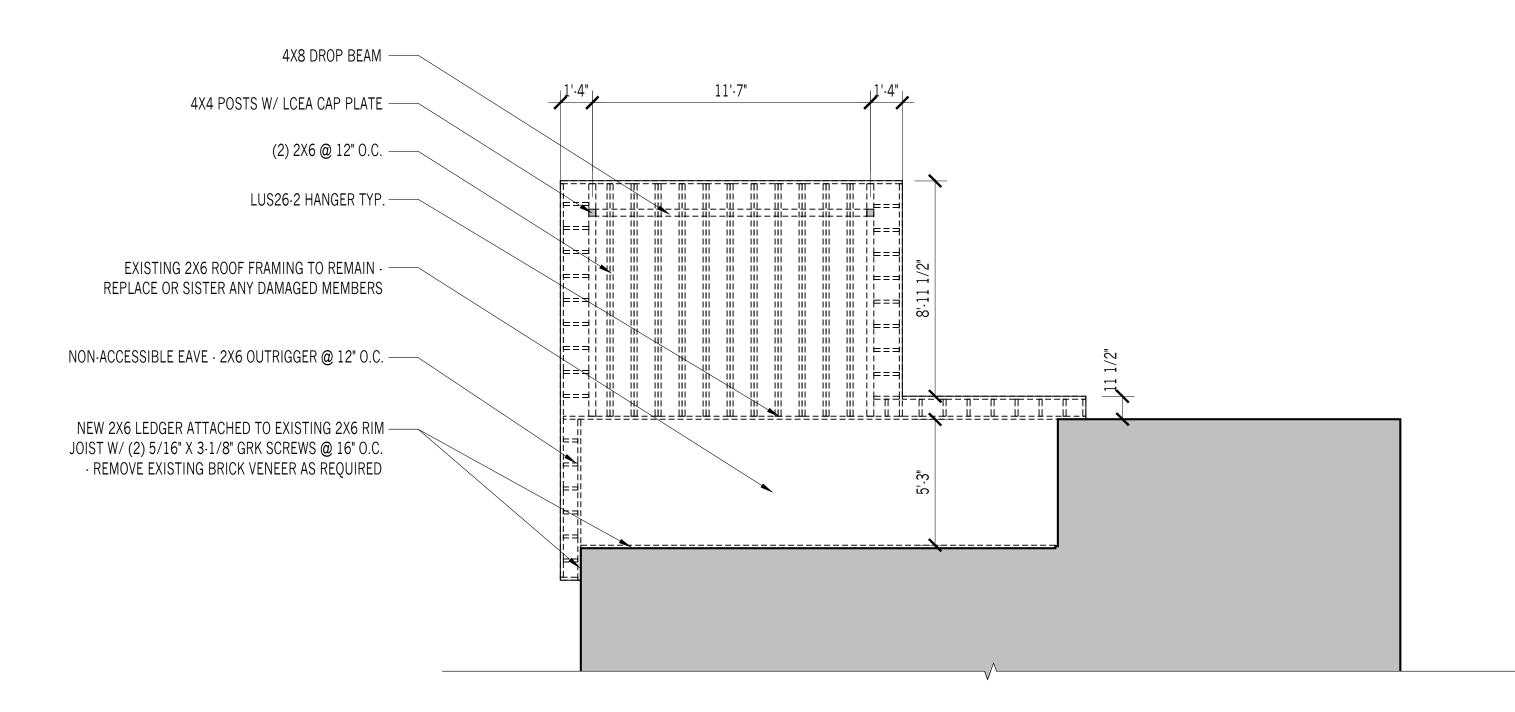
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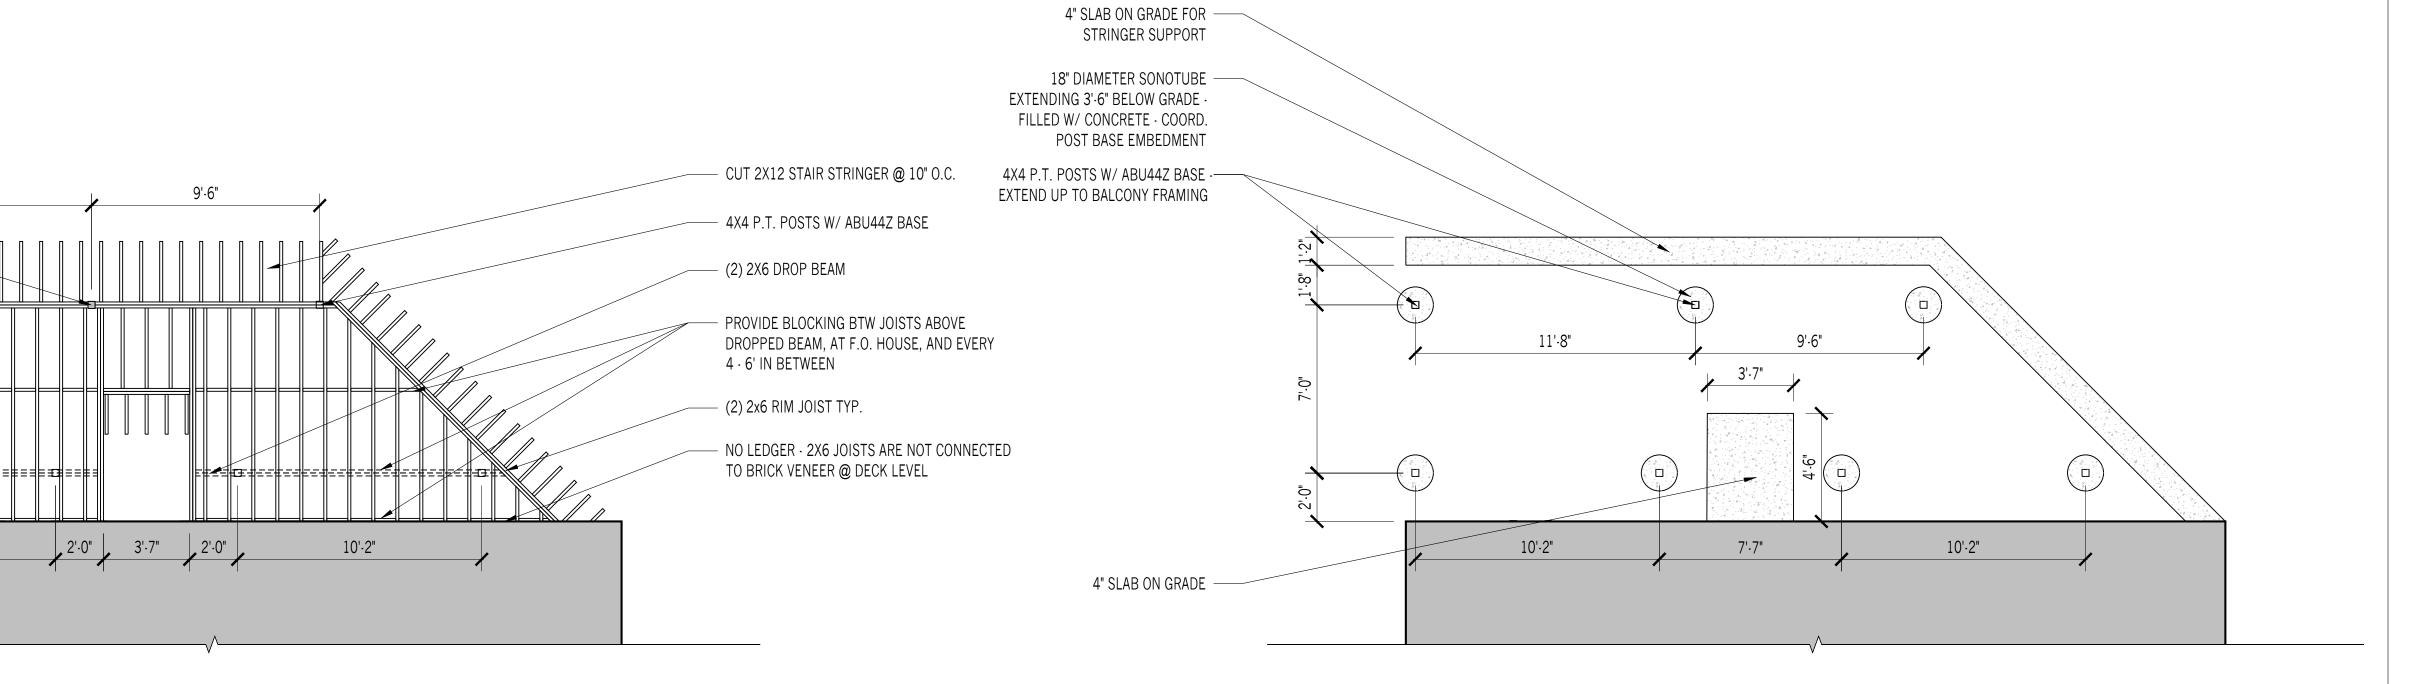


FOUNDATION & FRAMING PLANS

A-101



 $03 \frac{\text{SECOND FLOOR FRAMING PLAN}}{\text{SCALE: } 1/4" = 1' \cdot 0"}$



 $02^{\frac{\text{FIRST FLOOR FRAMING PLAN}}{\text{SCALE: } 1/4" = 1'-0"}}$

11'-8"

10'-2"

4X4 P.T. POSTS W/ ABU44Z BASE -

2X6 @ 12" O.C. —

EXTEND UP TO BALCONY FRAMING

 $O1 \frac{\text{FOUNDATION PLAN}}{\text{SCALE: } 1/4" = 1'-0"}$

 $O_{\frac{1}{\text{SCALE: 1/4"} = 1'-0"}}$

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ELISE DECHARD ARCHITECT AND AND ARCHITECT ARCHIT

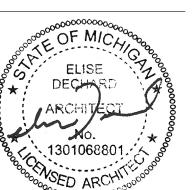
ELEVATION

A-300

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SECTION