


PROPOSED GARAGE

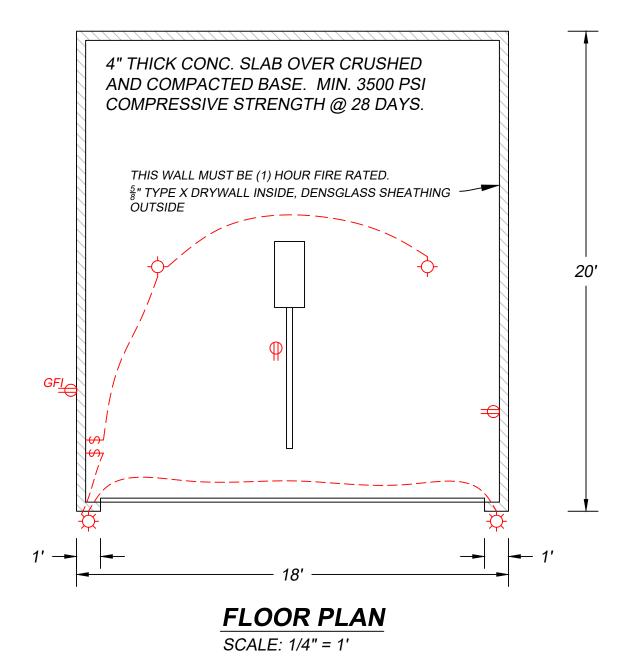




_____40.0'____ ADD TO EXISTING RATWALL. _____ PIN WITH STEEL RODS. <mark>- ↓ 18' → →</mark> 3' -20' PROPOSED GAR. - 19'-6" ------- SAW CUT CLEAN AND PIN TO EXISTING CONC. 12'-6" - 24'-6" /-33'-6" EXIST. /CÓNC./ B.P. EXIST. RES. 25'-6" 76'-6" -- 5' F.P. 30' _____ _ _ _ _ _ _ _ _ _ _

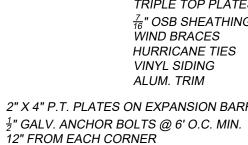


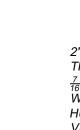



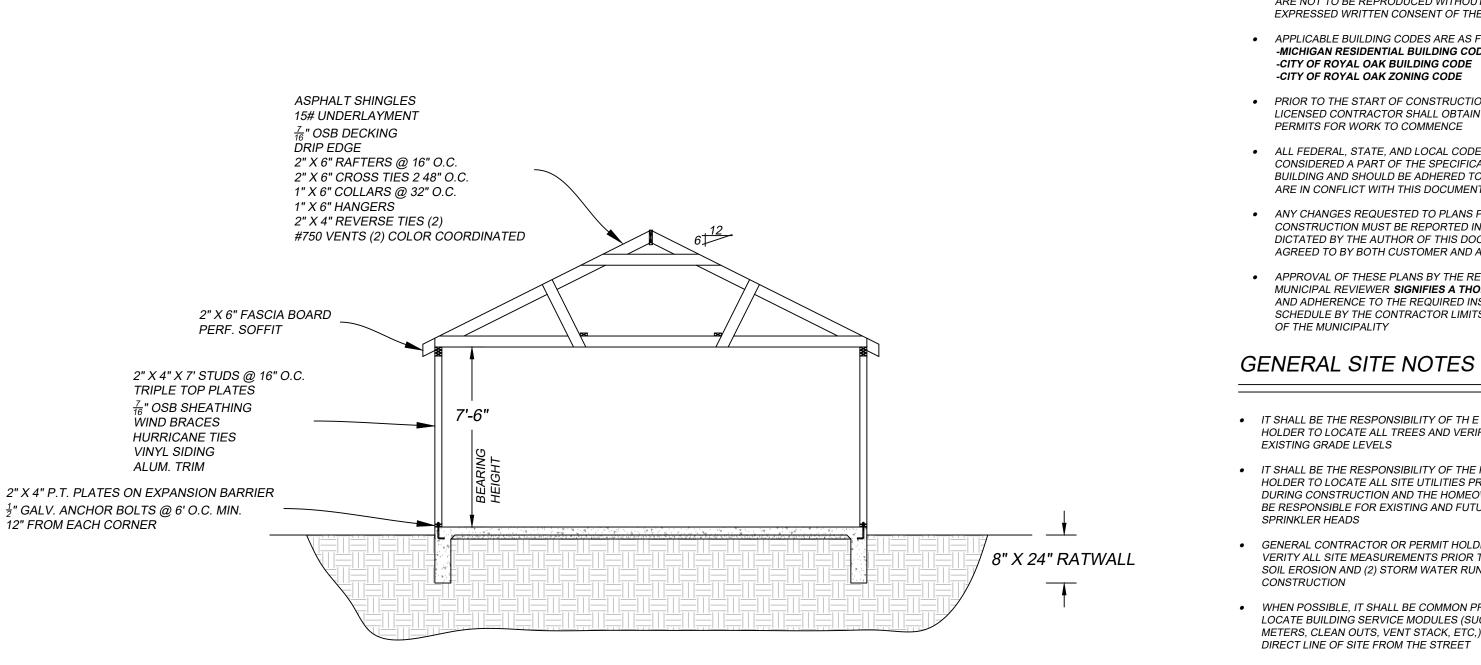

CROSS SECTION SCALE: 1/4" = 1'

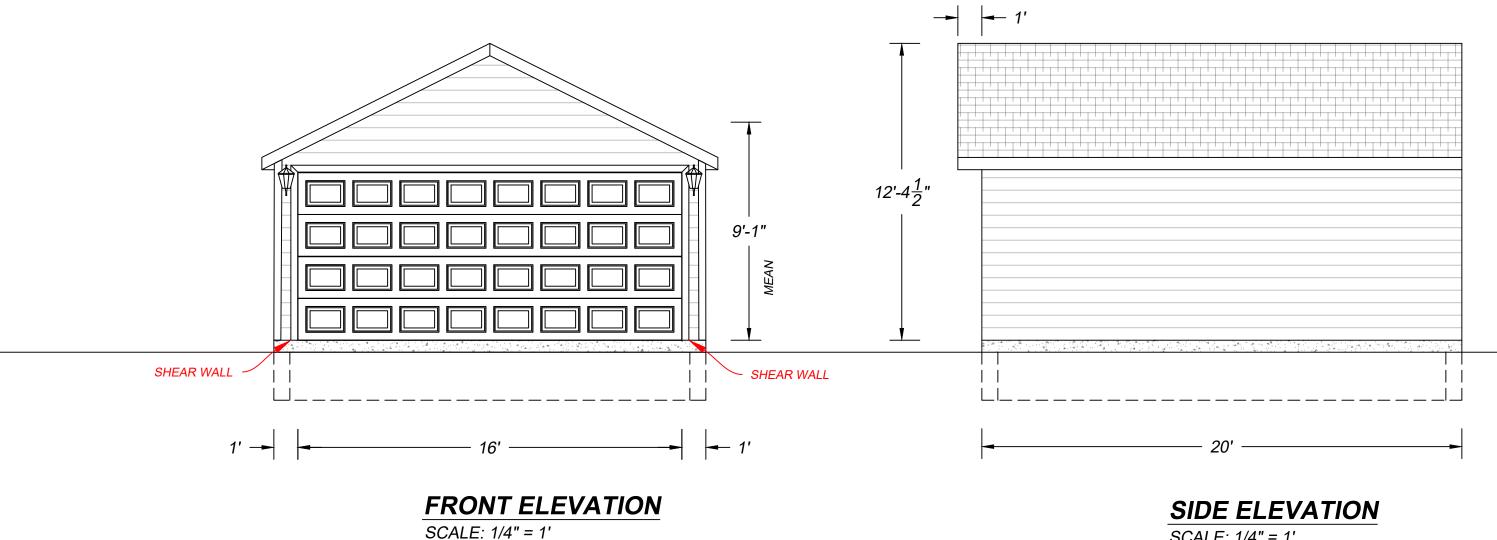

- THESE PLANS ARE PROTECTED BY COPYRIGHT AND ARE NOT TO BE REPRODUCED WITHOUT THE EXPRESSED WRITTEN CONSENT OF THE AUTHOR APPLICABLE BUILDING CODES ARE AS FOLLOWS -MICHIGAN RESIDENTIAL BUILDING CODE 2015
- PRIOR TO THE START OF CONSTRUCTION, THE LICENSED CONTRACTOR SHALL OBTAIN ALL NECESSARY
- ALL FEDERAL, STATE, AND LOCAL CODES SHALL BE CONSIDERED A PART OF THE SPECIFICATIONS OF THE BUILDING AND SHOULD BE ADHERED TO EVEN IF THEY ARE IN CONFLICT WITH THIS DOCUMENT
- ANY CHANGES REQUESTED TO PLANS PRIOR TO CONSTRUCTION MUST BE REPORTED IN THE FASHION DICTATED BY THE AUTHOR OF THIS DOCUMENT AND AGREED TO BY BOTH CUSTOMER AND AUTHOR
- APPROVAL OF THESE PLANS BY THE REQUIRED MUNICIPAL REVIEWER SIGNIFIES A THOROUGH REVIEW AND ADHERENCE TO THE REQUIRED INSPECTION SCHEDULE BY THE CONTRACTOR LIMITS THE INDEMNITY
- GENERAL SITE NOTES
- IT SHALL BE THE RESPONSIBILITY OF TH E PERMIT HOLDER TO LOCATE ALL TREES AND VERIFY ALL
- IT SHALL BE THE RESPONSIBILITY OF THE PERMIT HOLDER TO LOCATE ALL SITE UTILITIES PRIOR TO OR DURING CONSTRUCTION AND THE HOMEOWNER SHALL BE RESPONSIBLE FOR EXISTING AND FUTURE
- GENERAL CONTRACTOR OR PERMIT HOLDER WILL VERITY ALL SITE MEASUREMENTS PRIOR TO SITE (1) SOIL EROSION AND (2) STORM WATER RUN OFF DURING
- WHEN POSSIBLE, IT SHALL BE COMMON PRACTICE TO LOCATE BUILDING SERVICE MODULES (SUCH AS METERS, CLEAN OUTS, VENT STACK, ETC,) OUT OF DIRECT LINE OF SITE FROM THE STREET

CONSTRUCTION NOTES

- DRAWING PAGES WILL BE SCALED ON EITHER, (24" X 36") OR (11" X 17") PAPER AND PRESERVE PROPER FORMATTING & MEASUREMENTS.
- DOOR SIZES ARE INDICATED IN DRAWINGS NOMINALLY AND IT WILL BE THE RESPONSIBILITY OF THE CONTRACTOR TO PROVIDE ROUGH OPENINGS BASED ON THE DOOR MANUFACTURER'S SPECIFICATIONS
- BRACE ALL EXTERIOR CORNERS OF STUD WALLS WITH METAL STRAP BRACING LET INTO STUDS ON 45 DEGREE DIAGONALS FROM PLATE TO PLATE
- ALL RAFTER TAILS TO RECEIVE GALV. HURRICANE STRAPS AT WALL TOP PLATES TO PREVENT WIND UPLIFT

FDTN. & CONC. NOTES

- ALL DIMENSIONS ARE CALCULATED FROM OUTSIDE FACE OF MASONRY TO OUTSIDE FACE OF MASONRY
- FROST DEPTH IS ASSUMED TO BE 42" BELOW GRADE • COMPRESSIVE STRENGTH OF CONCRETE TO MEET OR EXCEED THE REQ'S OF MRC TABLE R402.2 UNDER THE
- CATEGORY OF SEVERE POTENTIAL FOR WEATHERING FOOTINGS SHALL REST ON UNDISTURBED SOIL AND GENERAL CONTRACTOR SHALL VERIFY SOIL IS FREE OF LOOSE DEBRIS AND WATER PRIOR TO POURING OF CONCRETE
- CONTRACTOR TO BE AWARE OF EXISTING FOUNDATIONS AND PREVENT AGAINST OVER EXCAVATION BELOW EXISTING FDTN. BEARING LINE
- PER MRC R506.22 A MIN. 4" THICK BASE COURSE SHALL BE PLACED ON THE PREPARED SUB-GRADE WHERE THE SLAB IS BELOW GRADE EXCEPT WHEN THE SUB-GRADE FALLS WITHIN THE CLASSIFICATION OF GROUP 1 OF MRC TABLE R405.1
- PER MRC R506.23 A 6 MIL THICK VAPOR RETARDER (OR BETTER) WITH MIN. 6" JOINT LAPPING SHALL BE PLACED BETWEEN THE CONCRETE FLOOR SLAB AND BASE WHERE APPLICABLE

CONTRACT NOTES

- TEAR DOWN EXISTING TWO CAR FRAME GARAGE. BREAKOUT EXISTING CONC. FLOOR AND TWO SECTION
- OF APRON AS SHOWN. ADD TO EXISTING RATWALL AS NEEDED AND PIN WITH STEEL RODS.
- BUILD NEW 18' X 20' SAVOY GABLE GARAGE WITH 6-12 PITCH AND TRIPLE TOP PLATES.
- INSTALL NEW 16' X 7' O.H. DOOR WITH 2 HAND CONTROLLERS AND KEY RELEASE.
- VINYL DUTCH LAP SIDING, PERF. VINYL SOFFIT AND ALUM TRIM.

CONSTRUCTION CONSTRUCTION 1-877-98-ITALY FAMILY OWNED SINCE 1954	
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SHEET INDEX DESCRIPTION

> GENERAL NOTES SITE SURVEY GARAGE FLOOR PLAN SECTION ELEVATIONS

SET ISSUE DATES ISSUE: DATE:

REF:

SHEET NOTES

NOTES: DRAWN BY: S.A. FERRISE

CHECKED BY:

SHEET No.



PROJECT No. TG2005

DATE CREATED: 13-JULY-2020

SCALE: 1/4" = 1'