

PROPOSED GARAGE

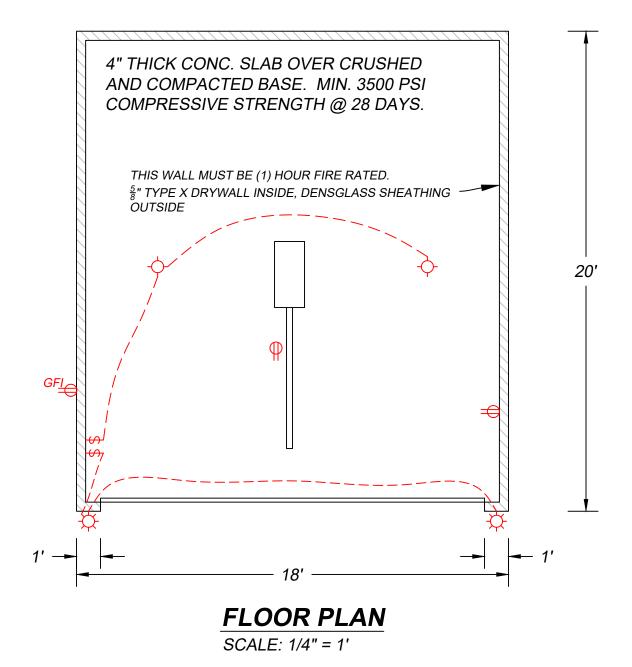

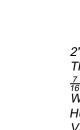


\_\_\_\_\_40.0'\_\_\_\_ ADD TO EXISTING RATWALL. \_\_\_\_\_ PIN WITH STEEL RODS. <mark>- ↓ 18' → →</mark> 3' -20' PROPOSED GAR. - 19'-6" ------- SAW CUT CLEAN AND PIN TO EXISTING CONC. 12'-6" - 24'-6" /-33'-6" EXIST. /CÓNC./ B.P. EXIST. RES. 25'-6" 76'-6" -- 5' F.P. 30' \_\_\_\_\_ \_ \_ \_ \_ \_ \_ \_ \_ \_ \_








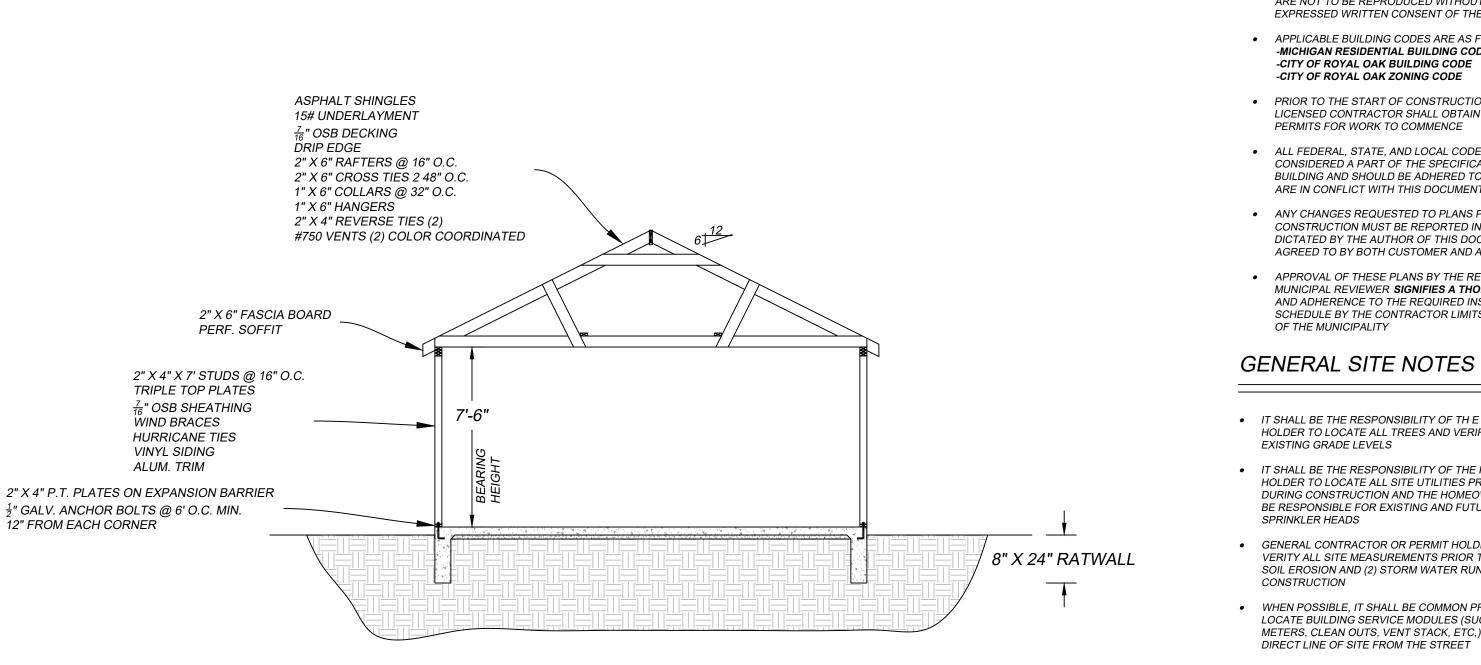

**CROSS SECTION** SCALE: 1/4" = 1'

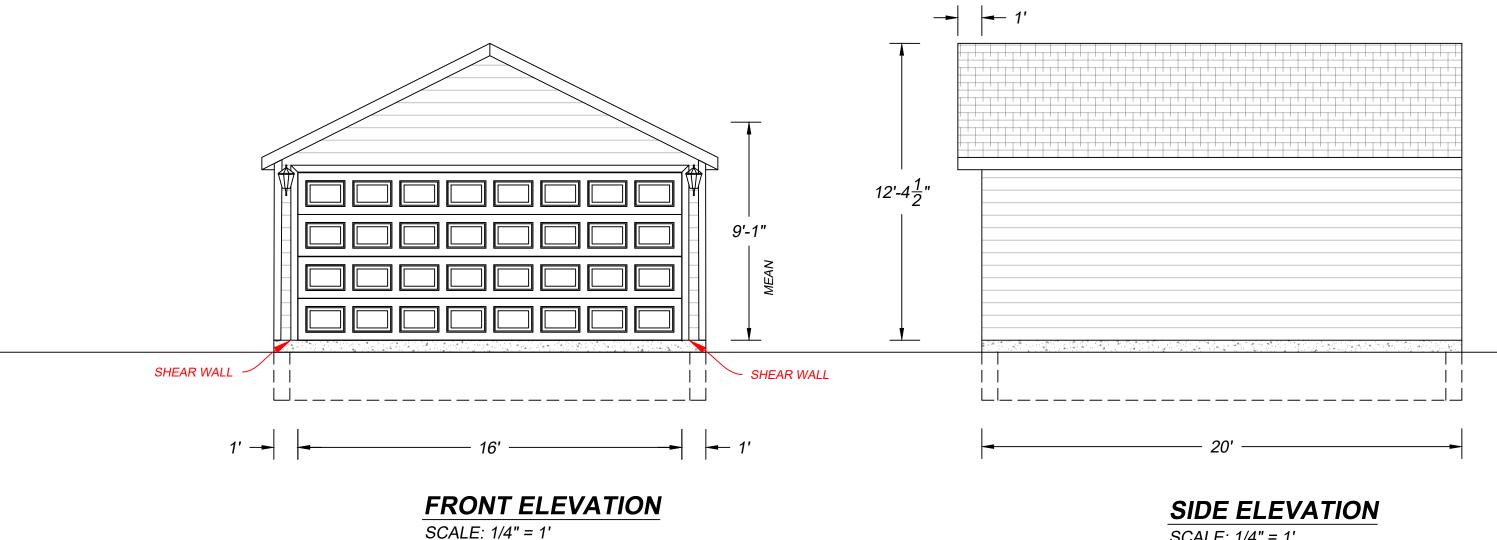

- THESE PLANS ARE PROTECTED BY COPYRIGHT AND ARE NOT TO BE REPRODUCED WITHOUT THE EXPRESSED WRITTEN CONSENT OF THE AUTHOR APPLICABLE BUILDING CODES ARE AS FOLLOWS -MICHIGAN RESIDENTIAL BUILDING CODE 2015
- PRIOR TO THE START OF CONSTRUCTION, THE LICENSED CONTRACTOR SHALL OBTAIN ALL NECESSARY
- ALL FEDERAL, STATE, AND LOCAL CODES SHALL BE CONSIDERED A PART OF THE SPECIFICATIONS OF THE BUILDING AND SHOULD BE ADHERED TO EVEN IF THEY ARE IN CONFLICT WITH THIS DOCUMENT
- ANY CHANGES REQUESTED TO PLANS PRIOR TO CONSTRUCTION MUST BE REPORTED IN THE FASHION DICTATED BY THE AUTHOR OF THIS DOCUMENT AND AGREED TO BY BOTH CUSTOMER AND AUTHOR
- APPROVAL OF THESE PLANS BY THE REQUIRED MUNICIPAL REVIEWER SIGNIFIES A THOROUGH REVIEW AND ADHERENCE TO THE REQUIRED INSPECTION SCHEDULE BY THE CONTRACTOR LIMITS THE INDEMNITY
- GENERAL SITE NOTES
- IT SHALL BE THE RESPONSIBILITY OF TH E PERMIT HOLDER TO LOCATE ALL TREES AND VERIFY ALL
- IT SHALL BE THE RESPONSIBILITY OF THE PERMIT HOLDER TO LOCATE ALL SITE UTILITIES PRIOR TO OR DURING CONSTRUCTION AND THE HOMEOWNER SHALL BE RESPONSIBLE FOR EXISTING AND FUTURE
- GENERAL CONTRACTOR OR PERMIT HOLDER WILL VERITY ALL SITE MEASUREMENTS PRIOR TO SITE (1) SOIL EROSION AND (2) STORM WATER RUN OFF DURING
- WHEN POSSIBLE, IT SHALL BE COMMON PRACTICE TO LOCATE BUILDING SERVICE MODULES (SUCH AS METERS, CLEAN OUTS, VENT STACK, ETC,) OUT OF DIRECT LINE OF SITE FROM THE STREET

## CONSTRUCTION NOTES

- DRAWING PAGES WILL BE SCALED ON EITHER, (24" X 36") OR (11" X 17") PAPER AND PRESERVE PROPER FORMATTING & MEASUREMENTS.
- DOOR SIZES ARE INDICATED IN DRAWINGS NOMINALLY AND IT WILL BE THE RESPONSIBILITY OF THE CONTRACTOR TO PROVIDE ROUGH OPENINGS BASED ON THE DOOR MANUFACTURER'S SPECIFICATIONS
- BRACE ALL EXTERIOR CORNERS OF STUD WALLS WITH METAL STRAP BRACING LET INTO STUDS ON 45 DEGREE DIAGONALS FROM PLATE TO PLATE
- ALL RAFTER TAILS TO RECEIVE GALV. HURRICANE STRAPS AT WALL TOP PLATES TO PREVENT WIND UPLIFT

## FDTN. & CONC. NOTES

- ALL DIMENSIONS ARE CALCULATED FROM OUTSIDE FACE OF MASONRY TO OUTSIDE FACE OF MASONRY
- FROST DEPTH IS ASSUMED TO BE 42" BELOW GRADE • COMPRESSIVE STRENGTH OF CONCRETE TO MEET OR EXCEED THE REQ'S OF MRC TABLE R402.2 UNDER THE
- CATEGORY OF SEVERE POTENTIAL FOR WEATHERING FOOTINGS SHALL REST ON UNDISTURBED SOIL AND GENERAL CONTRACTOR SHALL VERIFY SOIL IS FREE OF LOOSE DEBRIS AND WATER PRIOR TO POURING OF CONCRETE
- CONTRACTOR TO BE AWARE OF EXISTING FOUNDATIONS AND PREVENT AGAINST OVER EXCAVATION BELOW EXISTING FDTN. BEARING LINE
- PER MRC R506.22 A MIN. 4" THICK BASE COURSE SHALL BE PLACED ON THE PREPARED SUB-GRADE WHERE THE SLAB IS BELOW GRADE EXCEPT WHEN THE SUB-GRADE FALLS WITHIN THE CLASSIFICATION OF GROUP 1 OF MRC TABLE R405.1
- PER MRC R506.23 A 6 MIL THICK VAPOR RETARDER (OR BETTER) WITH MIN. 6" JOINT LAPPING SHALL BE PLACED BETWEEN THE CONCRETE FLOOR SLAB AND BASE WHERE APPLICABLE

## **CONTRACT NOTES**

- TEAR DOWN EXISTING TWO CAR FRAME GARAGE. BREAKOUT EXISTING CONC. FLOOR AND TWO SECTION
- OF APRON AS SHOWN. ADD TO EXISTING RATWALL AS NEEDED AND PIN WITH STEEL RODS.
- BUILD NEW 18' X 20' SAVOY GABLE GARAGE WITH 6-12 PITCH AND TRIPLE TOP PLATES.
- INSTALL NEW 16' X 7' O.H. DOOR WITH 2 HAND CONTROLLERS AND KEY RELEASE.
- VINYL DUTCH LAP SIDING, PERF. VINYL SOFFIT AND ALUM TRIM.

CONSTRUCTION CONSTRUCTION <b>1-877-98-ITALY</b> FAMILY OWNED SINCE 1954	
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SHEET INDEX DESCRIPTION

> GENERAL NOTES SITE SURVEY GARAGE FLOOR PLAN SECTION ELEVATIONS

SET ISSUE DATES ISSUE: DATE:

REF:

SHEET NOTES

NOTES: DRAWN BY: S.A. FERRISE

CHECKED BY:

SHEET No.



PROJECT No. TG2005

DATE CREATED: 13-JULY-2020

SCALE: 1/4" = 1'