STAFF REPORT: 09/09/2020 MEETING PREPARED BY: J. ROSS

ADDRESS: 290 EDMUND PLACE HISTORIC DISTRICT: BRUSH PARK

APPLICANT: JESSIKA HICKS

DATE OF PROVISIONALLY-COMPLETE APPLICATION: 8/24/2020

DATE OF STAFF VISIT: 9/03/2020

SCOPE: ERECT A NEW BUILDING (REVISION TO PREVIOUSLY-APPROVED

PROPOSAL)

EXISTING CONDITIONS

The project site consists of an empty parcel that is located within the 200 block of Edmund Place. The general surrounds are dominated by newly constructed, 2-6 story, mixed-use (multiple-family and commercial) buildings. Four, ca.1880, 3-story dwellings are located to the north of the project area/on the north side of Edmund Place. The historic buildings are clad with red brick.



Project area, photo taken 9/3/2020

PROPOSAL

The applicant appeared in front of this body at the 2-17-2016 special meeting with a proposal to establish a new mixed-use, multiple-building development (to include commercial and multiple family) within the area bounded by John R, Brush Street, Alfred, and Edmund Place. The development included several building typologies to include apartments, duplexes, townhomes,

and carriage homes. The Commission issued a Certificate of Appropriateness for the proposal as presented. With the current proposal, the applicant is seeking to revise the previously-approved duplex or "duplette" design at 290 Edmund Place (see the attached for the design which was approved in 2016). Specifically, as per the applicant, the new building/design is proposed as a 4-story building and shall be erected according to the following:

- The new apartment building design measures 46'-6" to the top of the parapet wall whereas the previously-approved duplette building measured 47'-6". In re: to the building footprint, proposed new building measures 184'x 50', which is generally consistent with the dimensions of the previously-approved design (which measured 185'x 47'). The setback for both buildings is consistent as well.
- The proposed apartment building design features red brick exterior walls (both modular and veneer) to reflect the red brick found at the nearby historic homes. Vertical cedar panel will be used as an accent material. The base/foundation of the building is a grey concrete.
- A concrete accessibility ramp will be located at the building's front elevation and will extend from the sidewalk to the primary entrance
- Windows are aluminum fixed and casement units and doors are aluminum.
- The landscaping and hardscaping (concrete walkways and rear parking lot) will remain as per the proposal which the Commission approved in 2016

STAFF OBSERVATIONS AND RESEARCH

- The design which the Commission approved in 2016 consisted of three separate, closely-set buildings which were clad with grey brick
- The current design is a single apartment block which shall be clad with red brick
- At the 9/11/2019 Regular monthly meeting, the Commission approved a change in design for the building to the west of/next to the subject parcel/290 Edmund
- The applicant submitted their proposed new project to Planning and Development (PDD) design staff for their opinion. The following outlines/paraphrases the general comments of Julio Cedano, staff from PDD's Design and Zoning Innovations division. Please note that Mr. Cedano's review was undertaken within an urban planning/design context. As PDD had an active role reviewing the original design, the following comments have been provided for the Commission's information. Mr. Cedano's review **did not** take the Secretary of the Interior Standards for Rehabilitation and/or the Brush Park Elements of Design into consideration:
 - The concrete at the base is too striking in contrast with the brick; suggestion to continue brick or provide additional landscape buffer
 - Better integration of the ramp on the front of the building into the architectural/landscape design
 - The brick is too red and contrast of materials is too strong with regard to the other City Modern buildings and the historic context

ISSUES

None

RECOMMENDATION


It is staff's opinion that the proposed project is appropriate to the defined Elements of Design for the Brush Park Historic District and the Secretary of the Interior's Standards for Rehabilitation (36 CFR Part 67). Staff therefore recommends that the Commission approve the issuance of a COA for the project as proposed.









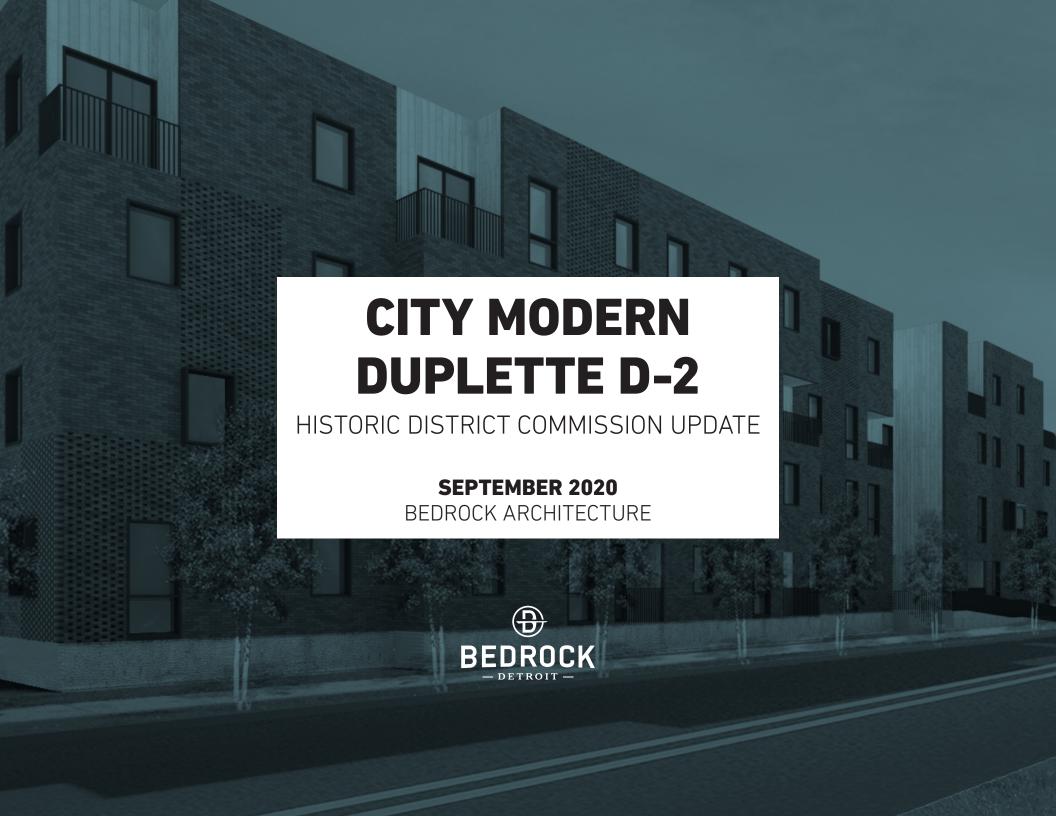

AGENDA

D-2 DESIGN UPDATE

- HISTORIC CONTEXT
- ORIGINAL DESIGN
- PROPOSED DESIGN
- ELEVATIONS
- MATERIALS
- OPENINGS






HISTORICAL CONTEXT

CITY MODERN

The historic mansions work in harmony to create a rich rhythm of solid and void, while the roof lines and building forms vary in order to break down their mass. This set of criteria creates a cohesive, familiar streetscape while affording each individual home a distinctive character.

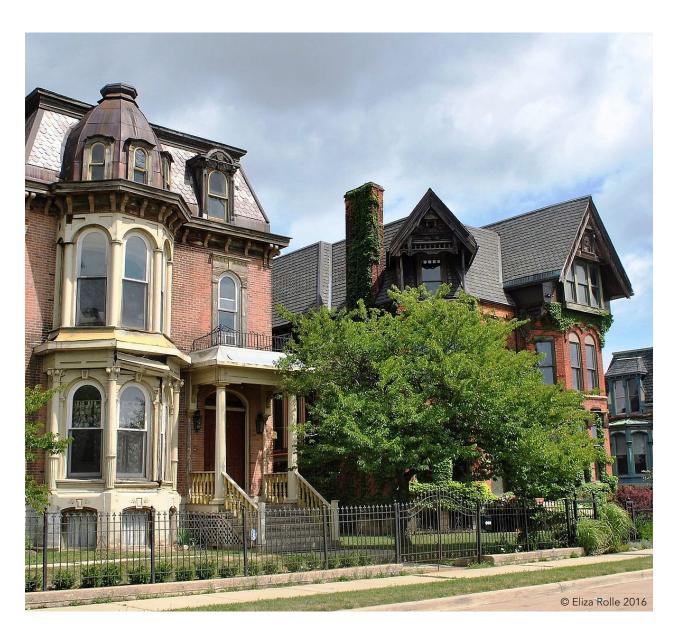

APPROVED D-2 DESIGN

PERSPECTIVE

APPROVED DESIGN




CONTEXT + MATERIALS

APPROVED DESIGN



APPROVED NORTH ELEVATION

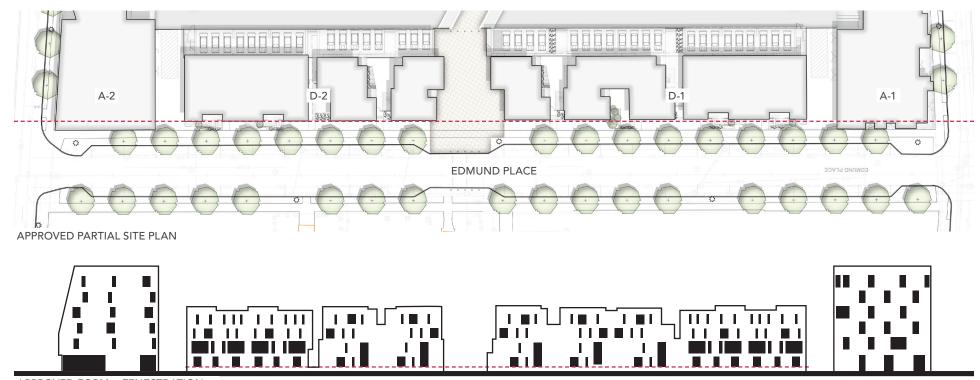


APPROVED FORM + FENESTRATION

CONTEXT + MATERIALS

APPROVED DESIGN



APPROVED NORTH ELEVATION

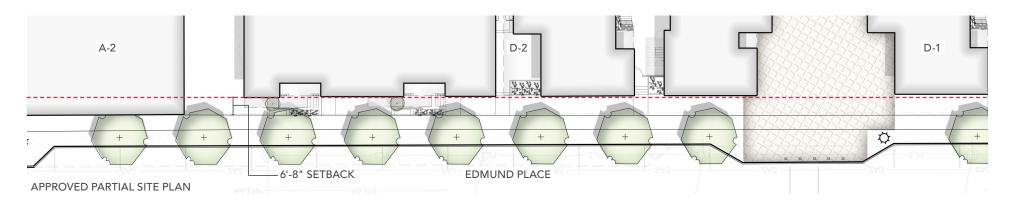

PRIMARY CLADDING(S)



LIGHT GRAY BRICK LIGHT & MEDIUM GRAY



CHARCOAL + IRONSPOT MIX W/ DARK MORTAR

SECONDARY CLADDING(S)



CEDAR SIDING NATURAL CLEAR COAT



VARIED RED MIX W/ LIGHT MORTAR



DARK + MEDIUM GRAY MIX W/ LIGHT MORTAR

PROPOSED D-2 DESIGN

DESIGN GOALS

PROPOSED DUPLEX D-2














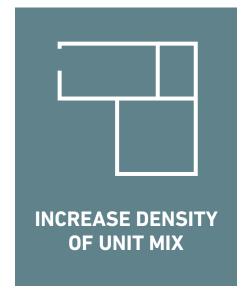

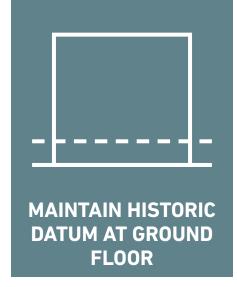

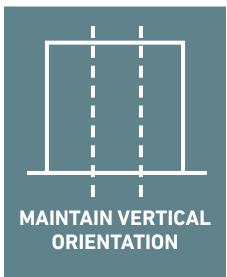

CONTEXT + MATERIALS

PROPOSED DESIGN




CONTEXT + MATERIALS

PROPOSED DESIGN



PROPOSED PARTIAL STREETSCAPE

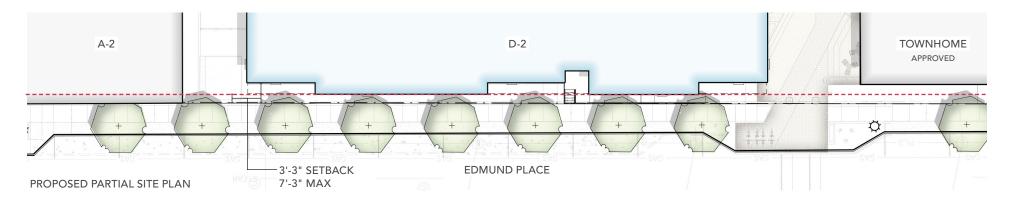





RED CEDAR CLADDING 4" WIDE, CLEAR COAT, VERTICAL



BRICK VENEER
2-1/4" MODULAR, MONTEREY RED MIX

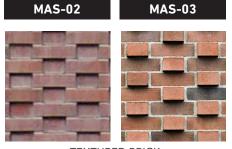

TEXTURED BRICK
2-1/4" MODULAR, MONTEREY RED MIX

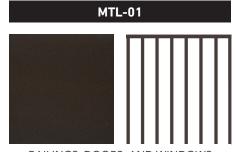

RAILINGS, DOORS, AND WINDOWS POWDER-COATED DARK BRONZE

REFINED DESIGN

PROPOSED DUPLEX D-2: MATERIAL REGIONS




PROPOSED NORTH MATERIAL REGIONS




REFINED DESIGN

PROPOSED DUPLEX D-2: OPENINGS

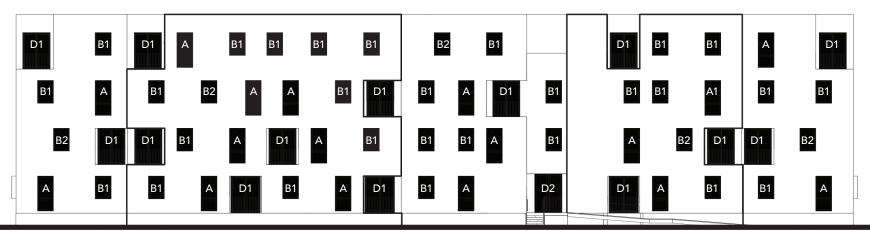


PROPOSED NORTH OPENINGS

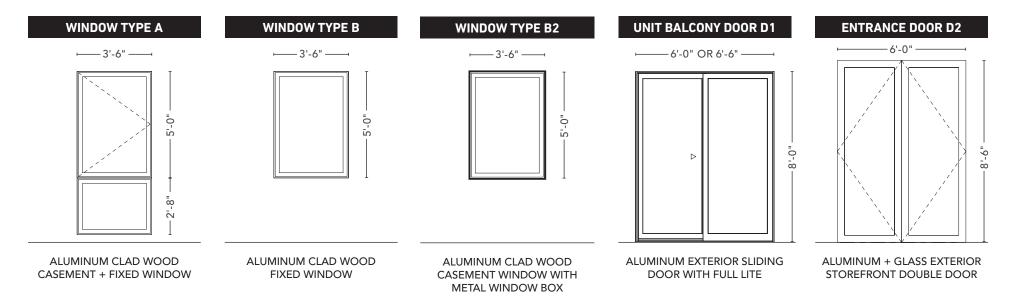

SITE PLAN

PROPOSED DUPLEX D-2

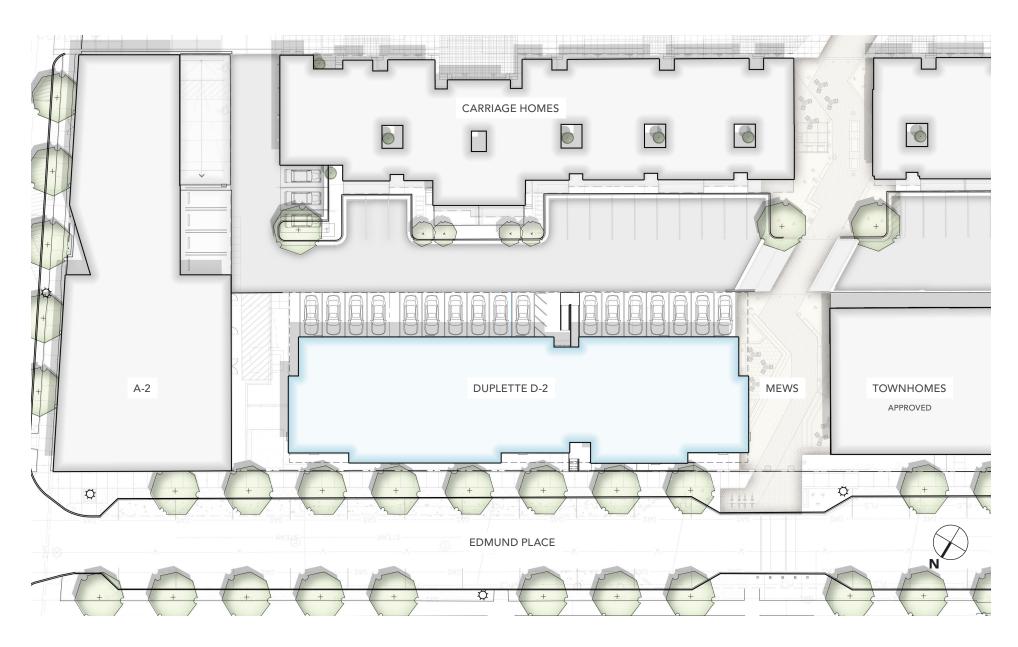

PERSPECTIVE

PROPOSED D-2 DESIGN



ELEVATIONS

PROPOSED



PROPOSED NORTH ELEVATION



ELEVATIONS

PROPOSED



PROPOSED EAST ELEVATION



PROPOSED WEST ELEVATION

MATERIALS

PROPOSED

MAS-01



BRICK VENEER 2-1/4" MODULAR, MONTEREY RED MIX

WD-01



RED CEDAR CLADDING
4" WIDE, CLEAR COAT, VERTICAL

MAS-02



TEXTURED BRICK, RECEDING 2-1/4" MODULAR, MONTEREY RED MIX

CON-02



POURED CONCRETE
EXPOSED FOUNDATION WALL

MAS-03



TEXTURED BRICK, PROTRUDING 2-1/4" MODULAR, MONTEREY RED MIX

MTL-01



RAILINGS, DOORS, AND WINDOWS POWDER-COATED DARK BRONZE

OPENINGS

PROPOSED WINDOWS

MANUFACTURER:

QUAKER WINDOWS AND DOORS

SERIES:


M600 MODERNVU

MATERIAL: ALUMINUM

COLOR:


DARK BRONZE ANODIZED



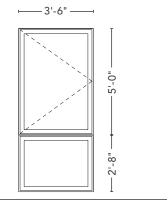


ALUMINUM CLAD WOOD CASEMENT + FIXED WINDOW

WINDOW TYPE B1

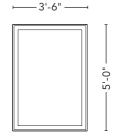

ALUMINUM CLAD WOOD FIXED WINDOW

WINDOW TYPE B2

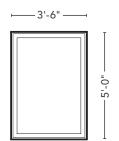

ALUMINUM CLAD WOOD CASEMENT WINDOW WITH METAL WINDOW BOX

MATERIALS



DARK BRONZE ANODIZED ALUMINUM + TYPICAL GLAZING

SAMPLE IMAGE



QUAKER CASEMENT WINDOW WITH MINIMAL PROFILE

OPENINGS

PROPOSED DOORS

BALCONY DOORS

MANUFACTURER:

QUAKER WINDOWS AND DOORS

SERIES:

M600 MODERNVU

MATERIAL: ALUMINUM

COLOR:

DARK BRONZE ANODIZED

LOBBY ENTRANCE DOORS

MANUFACTURER:

KAWNEER

SERIES:

INSULCLAD 360


MATERIAL: ALUMINUM

COLOR:

DARK BRONZE ANODIZED


UNIT BALCONY DOOR D1

6'-0" OR 6'-6"

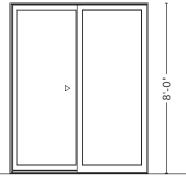


ALUMINUM EXTERIOR SLIDING DOOR
WITH FULL LITE

LOBBY ENTRANCE DOOR D2

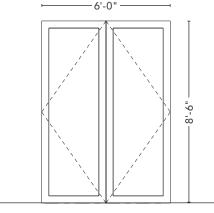


ALUMINUM + GLASS EXTERIOR STOREFRONT DOUBLE DOOR

UNIT BALCONY DOOR D3

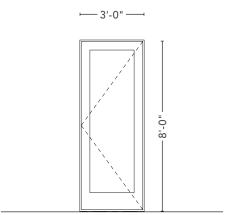


ALUMINUM EXTERIOR SWINGING DOOR WITH FULL LITE

MATERIALS

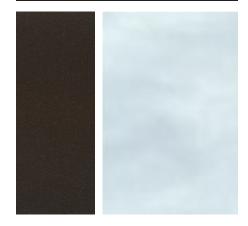

DARK BRONZE ANODIZED ALUMINUM + TYPICAL GLAZING


SAMPLE IMAGE

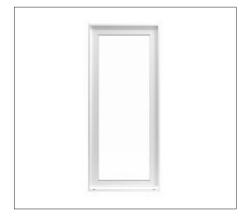

QUAKER EXTERIOR SWINGING DOOR WITH FULL LITE

SITE + LANDSCAPE


APPROVED PLAN

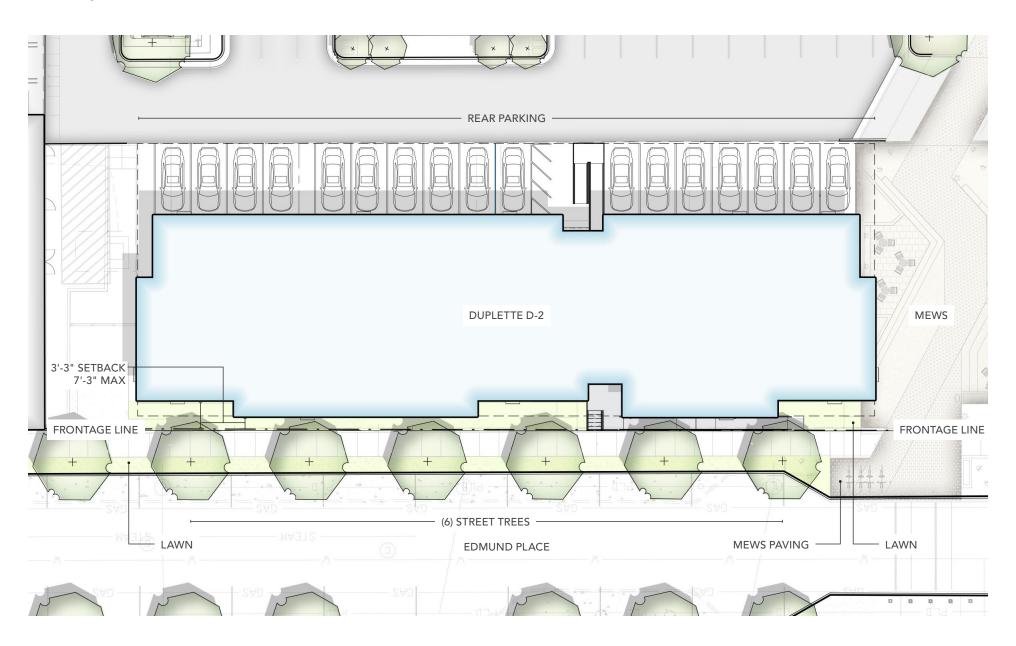






SITE LOCATION MAP

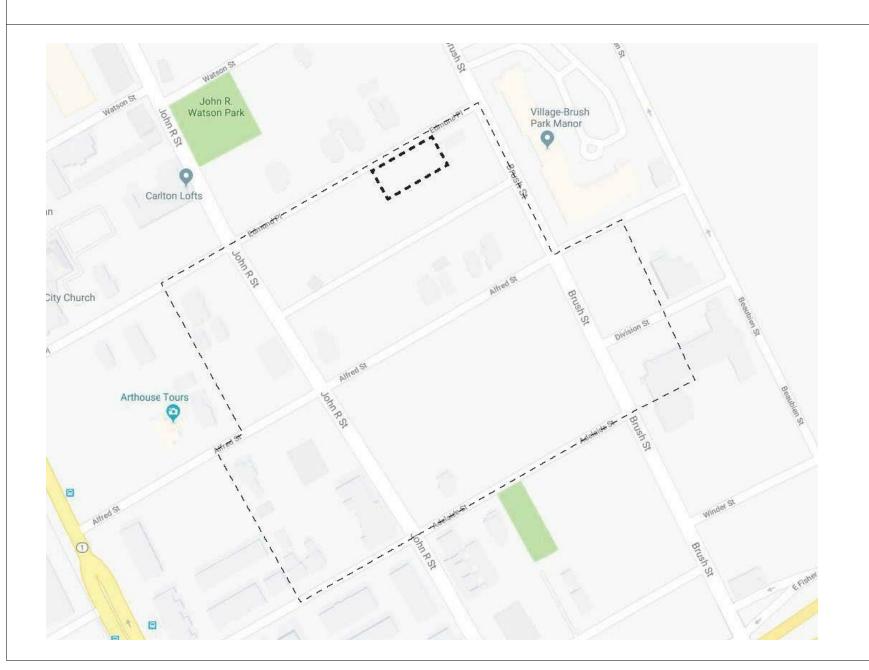

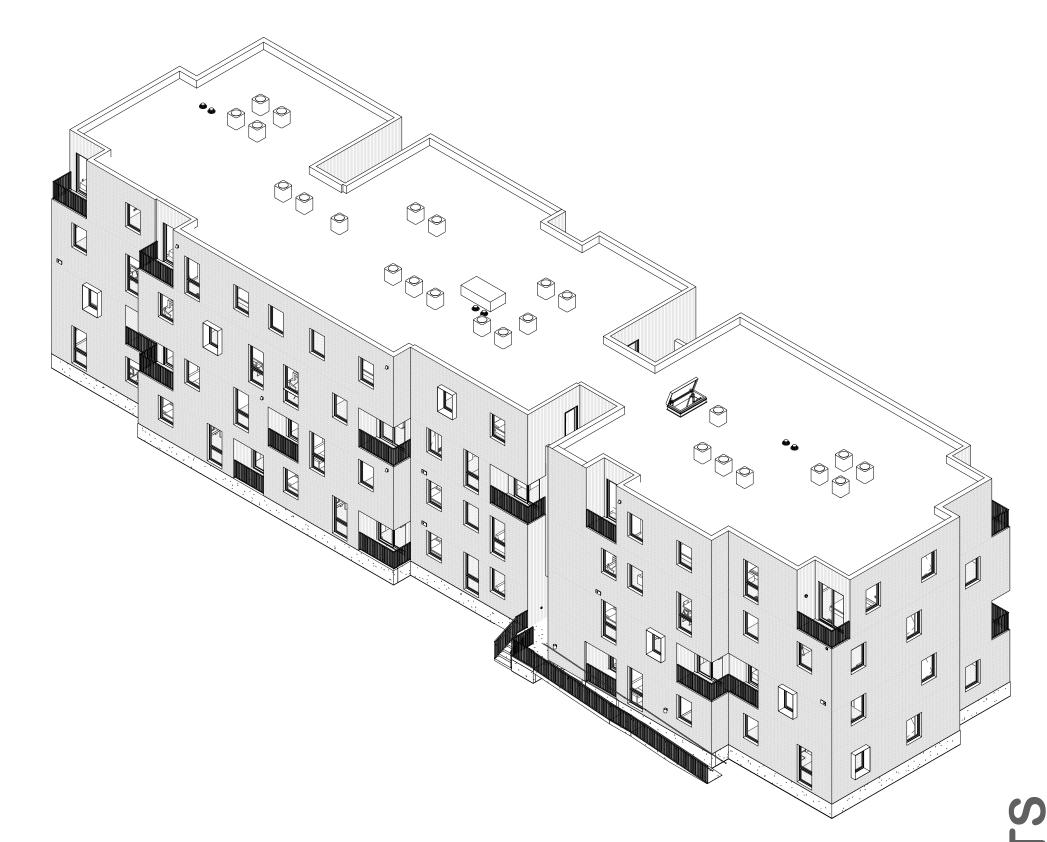

Brush Park Duplette D-2

100% CD/ PERMIT SET

On Edmund Place Between Brush St. and John R. St.

OWNER / DEVELOPER
BRUSH PARK DEVELOPMENT
COMPANY PHASE 1 LLC
1092 WOODWARD AVE.

Detroit MI, 48201

DETROIT, MI 48226

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15 MAY 2020

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ROYAL OAK, MI 48067
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CODE CONSULTANT CODE RED CONSULTANTS 154 TURNPIKE ROAD, SUITE 200 SOUTHBOROUGH, MA 01772

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REGISTRATION



OWNER

BRUSH PARK DEVELOPMENT COMPANY
PHASE 1 LLC
1092 WOODWARD AVE.
DETROIT, MI 48226

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CODE CONSULTANT

CODE RED CONSULTANTS 154 TURNPIKE ROAD, SUITE 200 SOUTHBOROUGH MA, 01772

SOUTHBOROUGH MA, 01772

ette D-2

John

Brush Park Duplette COn Edmund Place
Between Brush St. and
Detroit MI, 48201

05/15/20: 100% CD / PERMIT SET

THE CONTRACTOR IS RESPONSIBLE FOR MATERIALS, DETAILS AND ACCURACY, FOR ALL QUANTITIES AND DIMENSIONS, FOR SELECTING FABRICATION PROCESSES, FOR TECHNIQUES OF ASSEMBLY, FOR PERFORMING WORK IN A SAFE MANNER, AND FOR COORDINATING WORK WITH THAT OF ALL TRADES

JOB NO.: 18
SCALE:

DATE: **05/15/2020**

DRAWING TITLE

DRAWING INDEX

SHEET NO.

G-00'

PROJECT NOTES

USE OF CONSTRUCTION DOCUMENTS

- . CONTRACTOR SHALL NOT SCALE DRAWINGS. ONLY WRITTEN DIMENSIONS OR KEYNOTES SHALL BE USED. CONTACT ARCHITECT IF CLARIFICATION OR
- ADDITIONAL INFORMATION IS REQUIRED. 2. INFORMATION REGARDING EXITING SYSTEMS, FINISHES AND CONDITIONS WHICH IS SHOWN ON THESE DRAWINGS IS BASED UPON INFORMATION
- FURNISHED TO THE ARCHITECT BY THE OWNER AND/OR PERCEIVED CONDITION IN THE FIELD. THE INFORMATION IS NOT INTENDED TO GUARANTEE EXACT CONDITIONS BEFORE WORK IS STARTED.
- 3. THE DRAWINGS ARE SCHEMATIC IN NATURE. MODIFICATIONS IN DUCTS. PIPING, CONDUIT AND WIRING MAY BE REQUIRED TO ACCOMMODATE ACTUAL FIELD CONDITIONS.
- 4. CONTRACTOR SHALL TAKE PRECAUTIONS TO MAINTAIN AND PROTECT EXISTING SYSTEMS AND FINISHES WHICH ARE TO REMAIN. ANY DAMAGES TO SUCH SYSTEMS AND FINISHES SHALL BE IMMEDIATELY REPAIRED IN A MANNER ACCEPTABLE TO THE ARCHITECT. IF SATISFACTORY REPAIRS CANNOT BE MADE, CONTRACTOR SHALL REPLACE SYSTEM AND FINISHES WITH LIKE NEW QUALITY CONSTRUCTION ACCEPTABLE TO THE ARCHITECT ALL REPAIRS AND REPLACEMENT COSTS SHALL BE THE FINANCIAL
- 5. DRAWINGS SHALL NOT BE REPRODUCED FOR SUBMITTALS. DRAWINGS OR PORTIONS OF DRAWINGS UNUSED FOR SUBMITTALS WITHOUT PRIOR APPROVAL OF ARCHITECT WILL BE REJECTED AND RETURNED TO THE
- 6. DIMENSIONS ARE AS FOLLOWS UNLESS NOTED OTHERWISE
- A. TO FACE OF STUD.
- B. TO FINISH FACE OF WALL OR EXTERIOR WALL. C. TO CENTERLINE OF COLUMNS AND DOORS
- D. TO TOP OF FINISHED FLOOR

RESPONSIBILITY OF THE CONTRACTOR.

E. TO BOTTOM OF FINISHED CEILING

ADMINISTRATION OF THE WORK

THE DISCREPANCY.

- . CONTRACTOR SHALL BE SOLELY RESPONSIBLE FOR THE SAFETY OF ALL CONSTRUCTION PERSONNEL AND AUTHORIZED VISITORS. 2. CONTRACTOR SHALL BECOME FULLY ACQUAINTED WITH CONDITIONS RELATED TO THE WORK. ANY KNOWN DISCREPANCIES BETWEEN THE DOCUMENTS AND ACTUAL CONDITIONS SHALL BE REPORTED TO THE ARCHITECT FOR RESOLUTION PRIOR TO PROCEEDING WITH WORK RELATED TO
- 3. CONTRACTOR SHALL REMOVE AND PROPERLY DISPOSE OF ALL CONSTRUCTION AND DEMOLITION DEBRIS. CONTRACTOR SHALL OBTAIN APPROVAL OF OWNER (AND BUILDING OWNER, IF APPLICABLE) FOR DETAILS RELATED TO REMOVAL OF TRASH, INCLUDING SUCH ISSUES AS PATH OF TRAVEL, USE OF STAIRS AND ELEVATORS, REMOVAL OF WINDOWS, LOCATION OF CHUTES AND DUMPSTERS, ETC. PRIOR TO REMOVAL OF DEBRIS. CONTRACTOR SHALL CLEAN AND REPAIR ANY DAMAGES TO EXISTING SYSTEMS SOILED OR DAMAGED BY DEBRIS REMOVAL PROCESS. IF CLEANING AND REPAIR DOES NOT RETURN SYSTEMS TO ORIGINAL CONDITION CONTRACTOR SHALL
- INSTALL NEW SYSTEMS. 4. CONTRACTOR SHALL BECOME FAMILIAR WITH AND COMPLY WITH OWNER'S (OR BUILDING OWNER'S) PROCEDURES FOR MAINTAINING A SECURE SITE AND
- 5. CONTRACTOR SHALL BECOME FAMILIAR WITH AND COMPLY WITH OWNER'S (OR BUILDING OWNER'S) PROCEDURES FOR MAINTAINING A SECURE SITE AND
- 6. EACH INSTALLER SHALL EXAMINE SUBSTRATE CONDITION AND/OR SITE CONDITIONS WHICH AFFECT THE QUALITY OF EACH PRODUCT TO BE
- INSTALLED. IF ANY CONDITIONS EXIST WHICH WILL HAVE A DETRIMENTAL EFFECT ON THE QUALITY OF THE INSULATION SHALL SIGNIFY ACCEPTANCE OF THE CONDITIONS.
- . CONTRACTOR SHALL MAINTAIN RECORD DRAWINGS ON SITE AT ALL TIMES.
- 8. CONTRACTOR SHALL BE RESPONSIBLE FOR ENSURING COORDINATION EFFORTS OF ALL SUBCONTRACTORS.
- 9. CONTRACTOR SHALL LAY OUT WORK AS SOON AS POSSIBLE. ANY DISCREPANCIES SHALL BE REPORTED TO THE ARCHITECT FOR RESOLUTION PRIOR TO PROCEEDING WITH THE WORK IN QUESTION.

STANDARDS AND REGULATIONS

- 1. CONTRACTOR SHALL PERFORM ALL WORK IN CONFORMANCE WITH APPLICABLE BUILDING CODES, REGULATIONS, ORDINANCES, UTILITY PROVIDER
- REQUIREMENTS AND SIMILAR STANDARDS 2. CONTRACTOR SHALL OBTAIN ALL REQUIRED PERMITS AND SIMILAR RELEASES REQUIRED FOR CONSTRUCTION AND OCCUPANCY. CONTRACTOR SHALL FURNISH COPIES OF ALL SUCH ITEMS TO OWNER AND ARCHITECT WITHIN 10

DAYS OF RECEIPT. IF PERMITS ARE ISSUED SUBJECT TO CERTAIN CONDITIONS

- OR REVISIONS TO THE WORK OR IF PERMITS ARE DELAYED FOR ANY REASON, CONTRACTOR SHALL NOTIFY ARCHITECT IMMEDIATELY. 3. CONTRACTOR SHALL OBTAIN ALL REQUIRED INSPECTIONS OF THE WORK. CONTRACTOR SHALL REGULARLY UPDATE OWNER AND ARCHITECT REGARDING
- THE STATUS OF INSPECTIONS. 4. IF APPLICABLE, CONTRACTOR SHALL FILE NOTICE OF INTENT WITH THE
- **ENVIRONMENTAL PROTECTION AGENCY (EPA).** 5. CONTRACTOR SHALL COORDINATE WORK WITH APPLICABLE UTILITY PROVIDERS.
- 6. CONTRACTOR SHALL BE FAMILIAR WITH REQUIREMENTS AND CONSTRUCTION SHALL BE IN COMPLIANCE WITH REFERENCES FIRE-RATED ASSEMBLY TESTS
- AND STANDARDS. 7. IF UNANTICIPATED HAZARDOUS MATERIALS ARE ENCOUNTERED, CONTRACTOR SHALL CEASE WORK IN THE AREA AND CONTACT ARCHITECT AND OWNER
- IMMEDIATELY. 8. CONTRACTOR SHALL VISIT SITE PRIOR TO SUBMISSION OF BIDS TO REVIEW EXISTING CONDITIONS.
- 9. WORK NOT INDICATED BUT INFERABLE TO COMPLETE WORK IS UNDERSTOOD
- 10. CONTRACTOR TO VERIFY ALL EXISTING CONDITIONS IN FIELD BEFORE DEMOLITION OR CONSTRUCTION OF ANY PORTION OF THIS PROJECT.

DEFINITIONS

- 1. "ALIGN" AS USED IN THESE DOCUMENTS SHALL MEAN TO ACCURATELY LOCATE FINISH FACES IN THE SAME PLANE AND/OR TO INSTALL NEW CONSTRUCTION ADJACENT TO EXISTING CONSTRUCTION WITHOUT ANY
- VISIBLE JOINTS OR SURFACE IRREGULARITIES. 2. "CLEAR" AS USED IN THESE DOCUMENTS SHALL MEAN THAT THE CONDITION IS NOT ADJUSTABLE WITHOUT THE APPROVAL OF THE ARCHITECT, CLEAR DIMENSIONS ARE TYPICALLY TO FINISH FACE.
- . "MAXIMUM" OR "MAX" AS USED IN THESE DOCUMENTS SHALL MEAN THAT THE CONDITION IS SLIGHTLY ADJUSTABLE BUT MAY NOT VARY TO A DIMENSION OR QUANTITY LESS THAN THAT SHOWN WITHOUT APPROVAL OF
- 1. "MINIMUM" OR "MAX." AS USED IN THESE DOCUMENTS SHALL MEAN THE CONDITION IS SLIGHTLY ADJUSTABLE BUT MAY NOT VARY TO A DIMENSION
- OR QUANTITY LESS THAN THAT SHOWN WITHOUT APPROVAL OF THE 5. "TYPICAL" OR "TYP." AS USED IN THESE DOCUMENTS SHALL MEAN THAT THE
- CONDITION OR DIMENSION IS THE SAME OR REPRESENTATIVE FOR SIMILAR CONDITIONS THROUGHOUT.
- 6. "+/-" AS USED IN THESE DOCUMENTS SHALL MEAN THE DIMENSION OR QUALITY IS SLIGHTLY ADJUSTABLE TO ACCOMMODATE ACTUAL CONDITIONS.

MATERIALS

- 1. ALL DISSIMILAR METAL MATERIALS SHALL BE ISOLATED WITH A NON-
- METALLIC SEPARATOR. 2. WOOD SHALL BE FIRE-RETARDANT-TREATED UNLESS SPECIFICALLY NOTED ON THE DRAWINGS.
- 3. ANY MATERIAL SUBSTITUTIONS MUST BE SUBMITTED IN WRITING FOR APPROVAL BY THE ARCHITECT.
- 4. ALL MATERIALS USED IN FIRE-RATED ASSEMBLIES SHALL BE APPROVED BY. U.L. OR OTHER RECOGNIZED STANDARD FOR USE IN SUCH ASSEMBLIES.

GENERAL NOTES

- I. ALL WORK TO BE DONE IN ACCORDANCE WITH ALL FEDERAL, STATE, AND LOCAL CODES AND AGENCIES HAVING JURISDICTION.
- 2. ANY CONFLICT OR DISCREPANCY WHATSOEVER BETWEEN DRAWINGS, SPECIFICATIONS, AND/OR EXISTING CONDITIONS SHOULD BE BROUGHT TO THE ATTENTION OF THE ARCHITECT BEFORE PROCEEDING WITH THE WORK. CONTRACTOR TO FIELD VERIFY ALL EXISTING CONDITIONS.
- 3. WORK NOT INDICATED BUT INFERABLE TO COMPLETE WORK IS UNDERSTOOD TO BE INCLUDED.
- 4. CONTRACTOR TO COORDINATE ALL NEW CONSTRUCTION WITH DETAILS, SPECS, AND NOTES. 5. CONTRACTOR TO INCLUDE INSTALLATION FOR ALL NOT IN CONTRACT (N.I.C.)
- ITEMS IN BUDGET. CONTRACTOR TO INCLUDE ADDITIONAL BLOCKING AS REQUIRED FOR SURFACE MOUNTED ITEMS.

PROJECT DESCRIPTION

GENERAL SUMMARY OF WORK:

BUILD OUT OF 26 RENTAL DWELLING UNITS IN ONE STRUCTURE

BUILD OUT INCLUDES FOUNDATION, BALCONIES, DECKS, CLADDING, PARTITIONS, CASEWORK, AND FINISHES

INSTALLATION OF NATURAL GAS FURNACE IN ALL DWELLING UNITS WITH REMOTE CONDENSING UNIT ON ROOF

INSTALLATION OF PLUMBING FIXTURES AND ASSOCIATED PIPING AND EQUIPMENT

- INSTALLATION OF ELECTRICAL EQUIPMENT INCLUDING RANGE, HOT WATER HEATER, AND WASHER/ DRYER
- INSTALLATION OF LIGHT FIXTURES, SWITCHES, OUTLETS, AND ASSOCIATED WIRING INCLUDING DWELLINGS' ELECTRICAL PANELS
- INSTALLATION OF TELEPHONE AND DATA CABLES TO ALL UNITS

EXTERIOR MATERIAL

WOOD SIDING AND DECKING METAL SPINDLE GUARDRAIL AT BALCONIES

INTERIOR FINISH:


PAINTED GYPSUM BOARD, TYPICAL

APPLICABLE CODES & REGULATIONS


- 2015 Michigan Building Code
- 2017 City of Detroit Zoning Ordinance 2015 Detroit Fire Prevention and Protection Code (amended version of NFPA 1)
- 2015 Michigan Energy Code
- 2015 Michigan Mechanical Code
- 2015 Michigan Plumbing Code
- 2017 Michigan Electrical Code
- Accessibility: FHA, 2015 Michigan Building Code Chapter 11, ICC/ANSI A 117.1

GRILL


DUPLEX, OUTLETS TYP OUTLET HEIGHTS JANITOR'S MOP SINK TRASH HOSE STATION FIRE EXTINGUISHER RECEPTACLE CABINET HINGED AIR RETURN

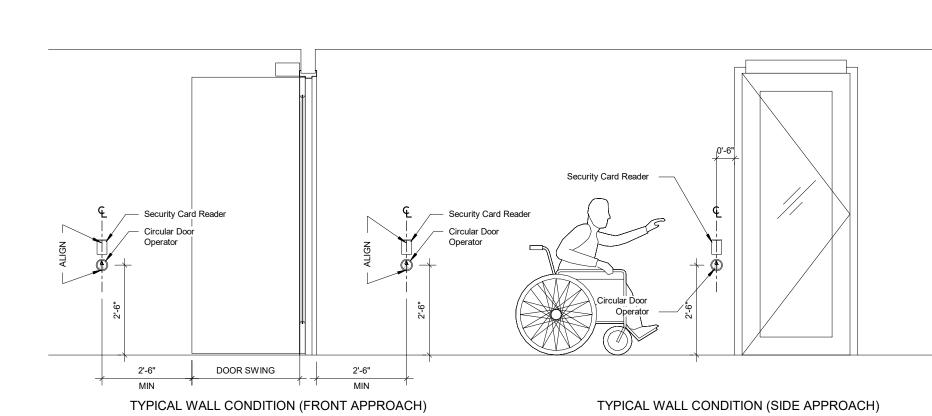


CARD READER THERMOSTAT TELEPHONE/DATA TYP. LIGHT SWITCH

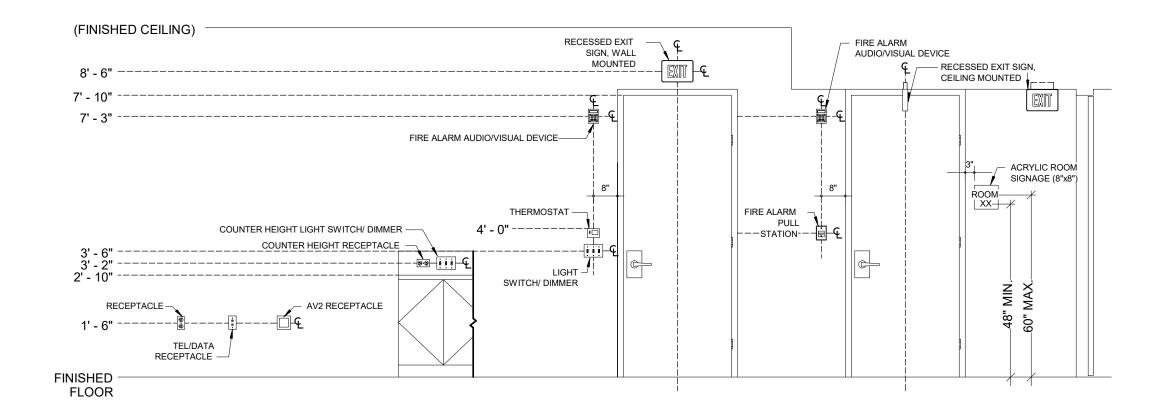

ABBREVIATIONS INTERIOR ABV **ABOVE** ACCESS DOOR JB JAMB ACT JOINT **ACOUSTICAL TILE** ADJ **ADJUSTABLE** LAMINATED AFF ABOVE FINISH FLOOR LAV LAVATORY ALT ALTERNATE LDR LEADER BLKG LVR LOUVER BLOCKING B.O. **BOTTOM OF LEV** LEVEL CAB CABINET MECH MECHANICAL CLGHT MEMBRANE **CEILING HEIGHT** MEMB CEM CEMENT MTL METAL CL MULL **CENTERLINE MULLION** СТ **CERAMIC TILE** NOM NOMINAL CLOS CLOSET NIC NOT IN CONTRACT COL COLUMN NTS NOT TO SCALE COL. L COLUMN LINE ON CENTER OC CONC CONCRETE **OPNG** OPENING CJ OPP **OPPOSITE CONTROL JOINT** OAI CMU **CONCRETE MASONRY UNIT OUTSIDE AIR INTAKE** CONV **PBO** PROVIDED BY OWNER CONVECTOR CLG CEILING PTD PAINTED DEG DEGREE PNL PANEL DF DRINKING FOUNTAIN PTN **PARTITION** DET **PERFORATED** DETAIL DIAG DIAGONAL PLASTER DIA PLASTIC LAMINATE DIAMETER DIFF **DIFFUSER** PLATE DISP **DISPENSER** PIPE RISERS DO DOOR OPENING PSF POUNDS / SQUARE FOOT POUNDS / SQUARE INCH DIV DIVISION PSI DR DOOR PROPERTY LINE DN PUBLIC ADDRESS DWG DRAWING PARTIAL EA QTY QUANTITY EC **ELECTRICAL CLOSET** RA **RETURN AIR** ELEC **ELECTRIC/ ELECTRICAL** RAD RADIUS **RCP** REFLECTED CEILING PLAN EL **ELEVATION EMERGENCY EMER** REQ'D REQUIRED **ENCL ENCLOSURE** RD **ROOF DRAIN ENTR ENTRANCE** RMROOM RO EQ ROUGH OPENING **EXP JT** STR **EXPANSION JOINT** STAIR **EXIST EXISTING** SA SUPPLY AIR EXP **EXPOSED** SCHED SCHEDULE EXT EXTERIOR SECT SECTION E.O.S. EDGE OF SLAB SHT SHEET F.O.B. **FACE OF BUILDING** SIMILAR FAB **FABRICATE** SKETCH FIN STC FIN FL FINISH FLOOR **SPKLD** SPRINKLERED FIN GF STD FINISH GRADE STANDARD FD **FLOOR DRAIN** STL STEEL STAINLESS STEEL FΑ FIRE ALARM SS FIRE EXTINGUISHER STOR STORAGE FE FIRE EXTINGUISHER CABINET FEC SUSPENDED FHC FIRE HOSE CABINET **STRUCT** STRUCTURAL FHR FIRE HOSE RACK SYMMETRICAL SYM FPRF TC **FIREPROOF TELEPHONE CLOSET** FLOOR **THR THRESHOLD** FD FLOOR DRAIN T.O. FF TOP OF FINISH FLOOR FTG T.O. S TOP OF SLAB **FOOTING** FOUNDATION T.O. STL TOP OF STEEL FDN FSP FIRE STANDPIPE TOP'G TOPPING TYP **TYPICAL** GAUGE GALV **UNLESS NOTED OTHERWISE** GALVANIZED GLASS URINAI GRADE VINYL BASE GWB **GYPSUM WALLBOARD** VCT VINYL COMPOSITION TILE HANDICAPPED VENT VENTILATION VERIFY IN FIELD HDNRL HANDRAIL **VERT** VERTICAL HDW **HARDWARE VESTIBULE HARDWOOD VEST** VINYL WALL COVERING WATER CLOSET **HOLLOW METAL** WEATHERPROOF HORIZ HORIZONTAL WEIGHT INSUL

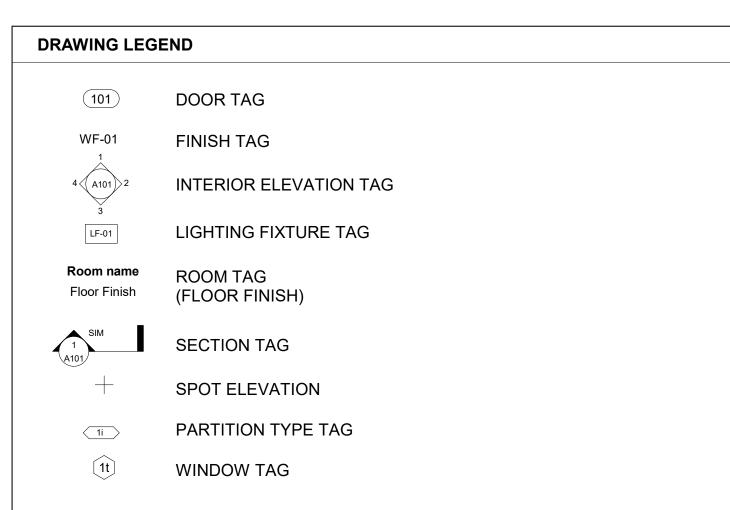



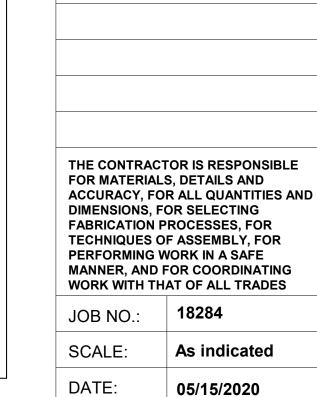

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05/15/20: 100% CD / PERMIT SET

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ELIZABETH LEE

ARCHITEOT No.

DRAWING TITLE

GENERAL NOTES & ABBREVIATIONS


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G-100

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PULL STATION

COUNTER



	co	DDE INFORMATION	
CODE ISSUE	DESCRIPTION	PROJECT DATA	CODE SECTION
OCCUPANCY		GROUP R-2	MBC 310.4
CONSTRUCTION TYPE		VA	MBC 602.5
FLOOR AREA	MAXIMUM ALLOWABLE AREA PER FLOOR = 12,000 SF	MAXIMUM = 8,126 SF (FIRST FLOOR)	MBC 506, TABLE 506.2
BUILDING AREA	MAXIMUM ALLOWABLE AREA PER BUILDING = 49,500 SF (NOT INCLUDING BASEMENT)	BUILDING AREA = 32,366 SF	MBC 506, TABLE 506.2
BUILDING HEIGHT	MAXIMUM ALLOWALBE HEIGHT = FOUR STORIES, 70'-0"	45"-0", FOUR STORIES (NOT INCLUDING UTILITIES BASEMENT)	TABLE 504.3 AND 504.4
BUILDING OCCUPANT LOADS		41 PER FLOOR	TABLE 1004.1.2
EXIT ACCESS TRAVEL DISTANCE	MAXIMUM ALLOWABLE (OCCUPANCY R AND WITH SPRINKLER SYSTEM) = 125'	PER CHART ON SHEETS LS-001 AND LS-002	TABLE 1017.2
EXIT(S)	TWO EXITS REQUIRED	TWO EXITS PROVIDED	TABLE 1006.3.1
STAIRWAY WIDTH	36" (MINIMUM) IF OCCUPANT LOAD PERF FLOOR IS UNDER 50	38" PROVIDED	MBC 1011.2
EXTERIOR BEARING WALLS		1 HR. RATED	TABLE 601
PRIMARY STRUCTURAL FRAME		1 HR. RATED	TABLE 601
INTERIOR BEARING WALLS		1 HR. RATED	TABLE 601
INTERIOR WALLS BETWEEN UNITS		1 HR. RATED	TABLE 601
FLOOR AND ROOF ASSEMBLY		1 HR. RATED	TABLE 601
SHAFT WALL ASSEMBLY		1 HR. RATED WHEN CONNECTING 3 STORIES, 2 HR. RATED (SELF-SUPPORTING) WHEN CONNECTING 4 STORIES	MBC 713.4
SPRINKLER	REQUIRED THROUGHOUT	BUILDING TO BE EQUIPPED WITH AUTOMATIC SPRINKLER SYSTEM IN ACCORDANCE WITH NFPA 13R FOR THE DWELLING UNITS AND NFPA 13 EVERYWHERE ELSE. SCOPE INLUDES EXTERIOR BALCONIES.	MBC 903.2.8
FIRE ALARM	REQUIRED THROUGHOUT	BUILDING TO BE EQUIPPED WITH A FIRE ALARM SYSTEM SYSTEM IN ACCORDANCE WITH NFPA 72 AND LISTED SINGLE- OR MULTIPLE-STATION PHOTOELECTRIC TYPE SMOKE ALARMS	MBC 420.5
ACCESSIBILITY	ONE TYPE A UNIT REQUIRED. REMAINING GROUND FLOOR SINGLE STORY UNITS REQUIRED TO BE PROVIDED WITH MINIMALLY TYPE B ELEMENTS AND COMPLY WITH FHA	ONE TYPE A (1 BEDROOM), ONE TYPE B (STUDIO), AND TWO TYPE B (ONE BEDROOM) PROVIDED	MBC 1107.6.2.2.1
ELEVATOR	AN ELEVATOR IS NOT REQUIRED IN THE BUILDING	NOT PROVIDED	MBC 1107.4 Exception 7

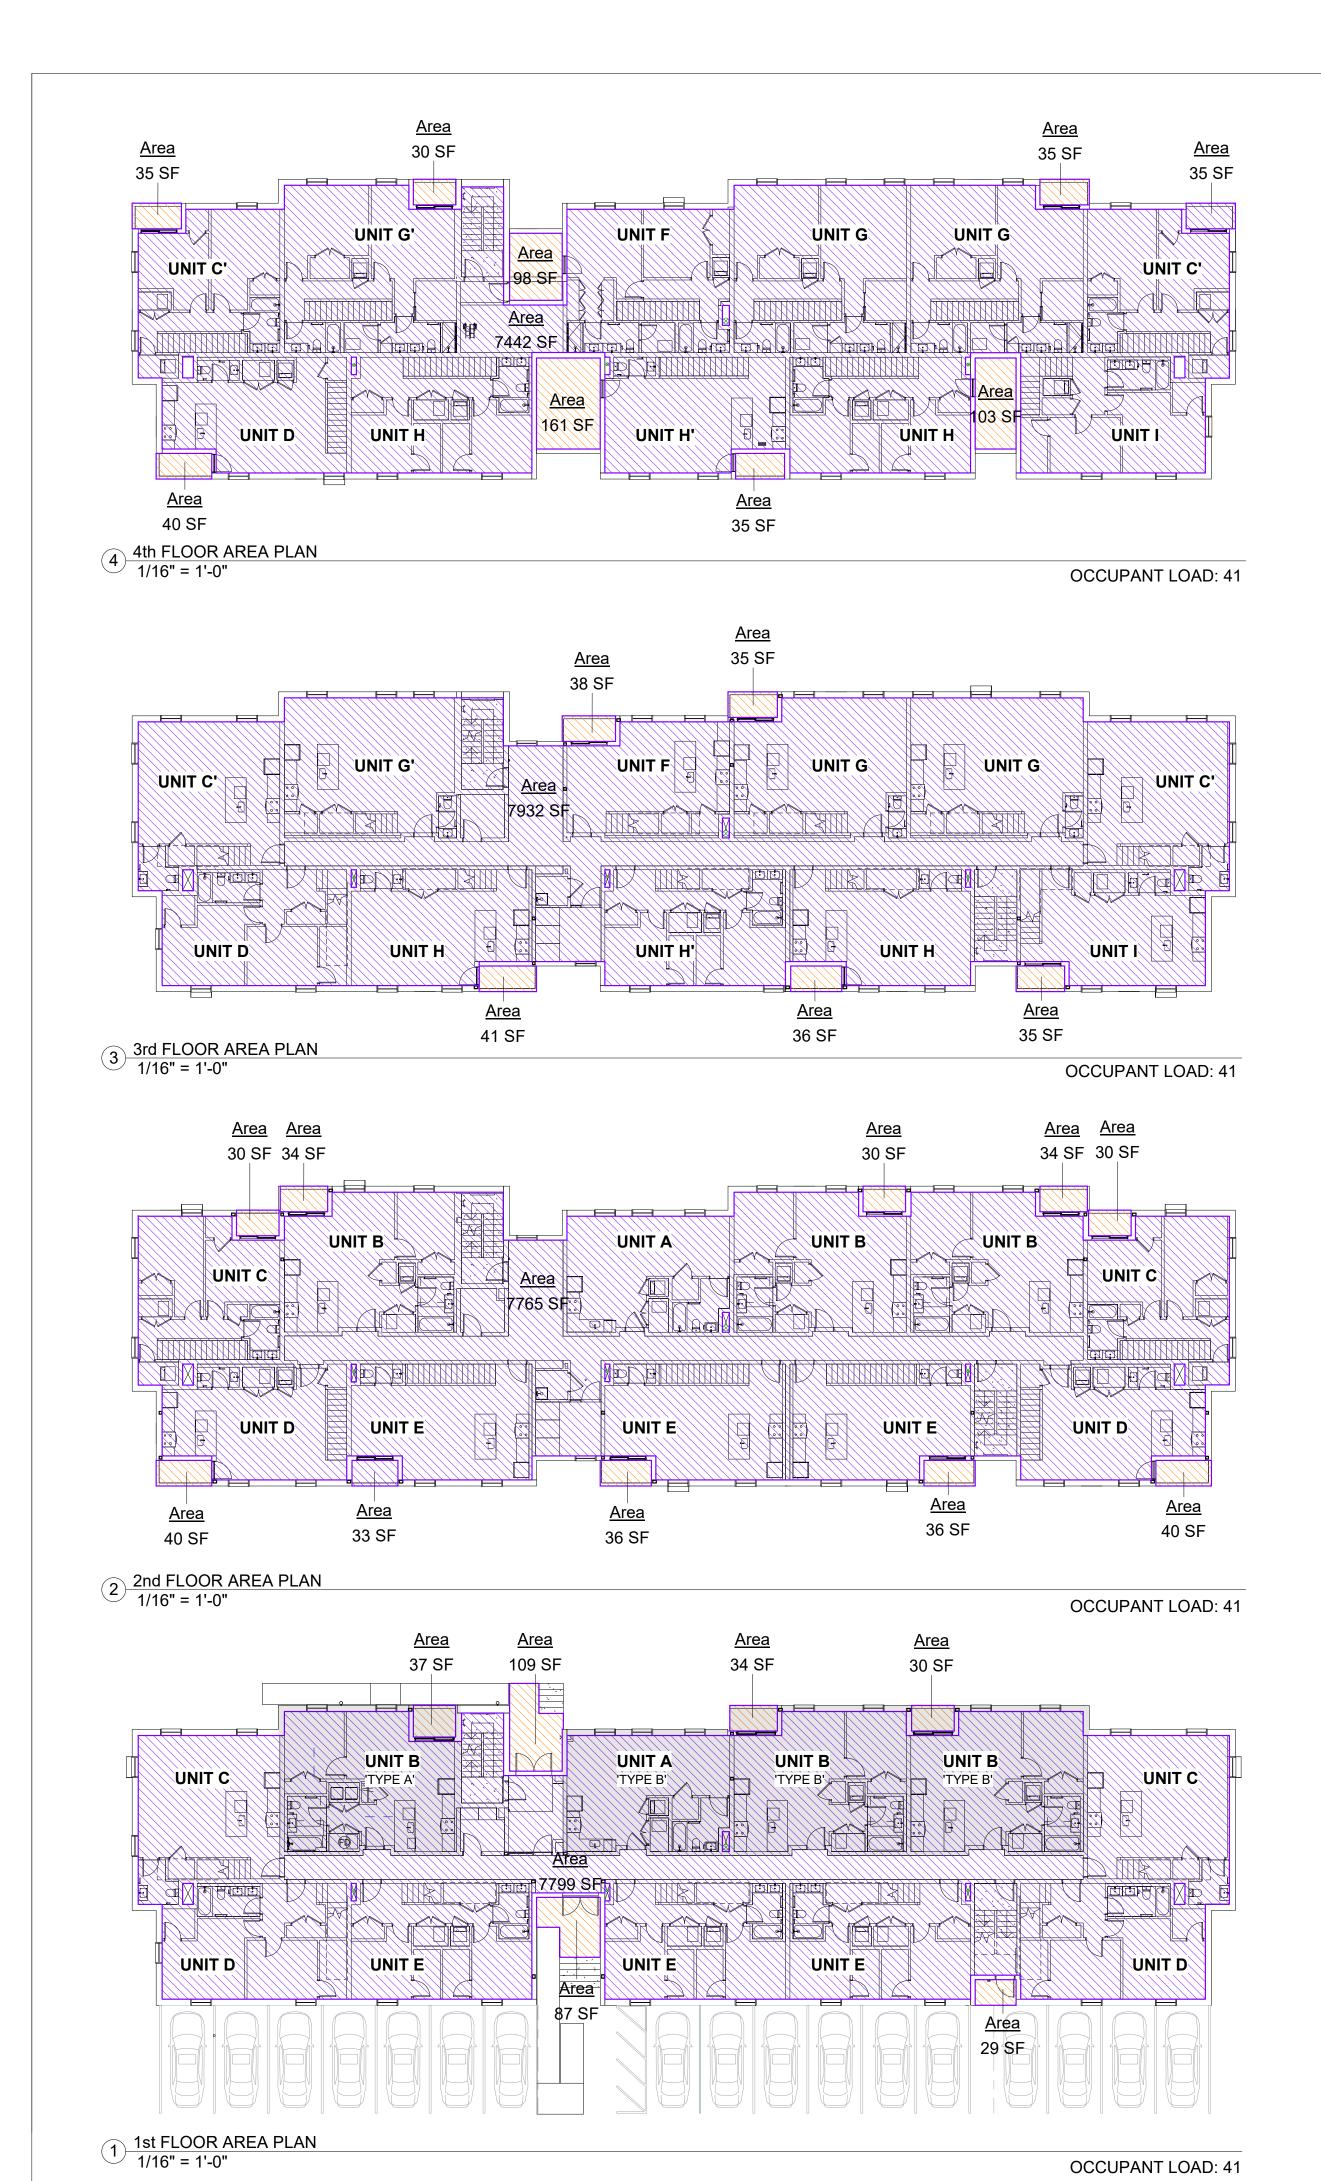GROSS FLOOR AREA			
LEVEL	AREA	AREA TYPE	
BASEMENT	410 SF	Gross Interior Area	
	410 SF		
FIRST FLOOR	327 SF	Gross Exterior Area	
FIRST FLOOR	7,799 SF	Gross Interior Area	
	8,126 SF		
SECOND FLOOR	311 SF	Gross Exterior Area	
SECOND FLOOR	7,797 SF	Gross Interior Area	
	8,108 SF		
THIRD FLOOR	185 SF	Gross Exterior Area	
THIRD FLOOR	7,932 SF	Gross Interior Area	
	8,117 SF		
FOURTH FLOOR	538 SF	Gross Exterior Area	
FOURTH FLOOR	7,478 SF	Gross Interior Area	
	8,015 SF		

UNIT MATRIX		
NAME	AREA	ACCESSIBILITY CLASSIFICATION
UNIT A	544 SF	ONE (1) 'TYPE B', FIRST FLOOR
UNIT B	667 SF	ONE (1) 'TYPE A', TWO (2) TYPE 'B', FIRST FLOOR
UNIT C/ C'	1199 SF	
UNIT D	1153 SF	
UNIT E	1194 SF	
UNIT F	1182 SF	
UNIT G/ G'	1503 SF	
UNIT H/ H'	1168 SF	
UNIT I	1150 SF	

REGISTRATION



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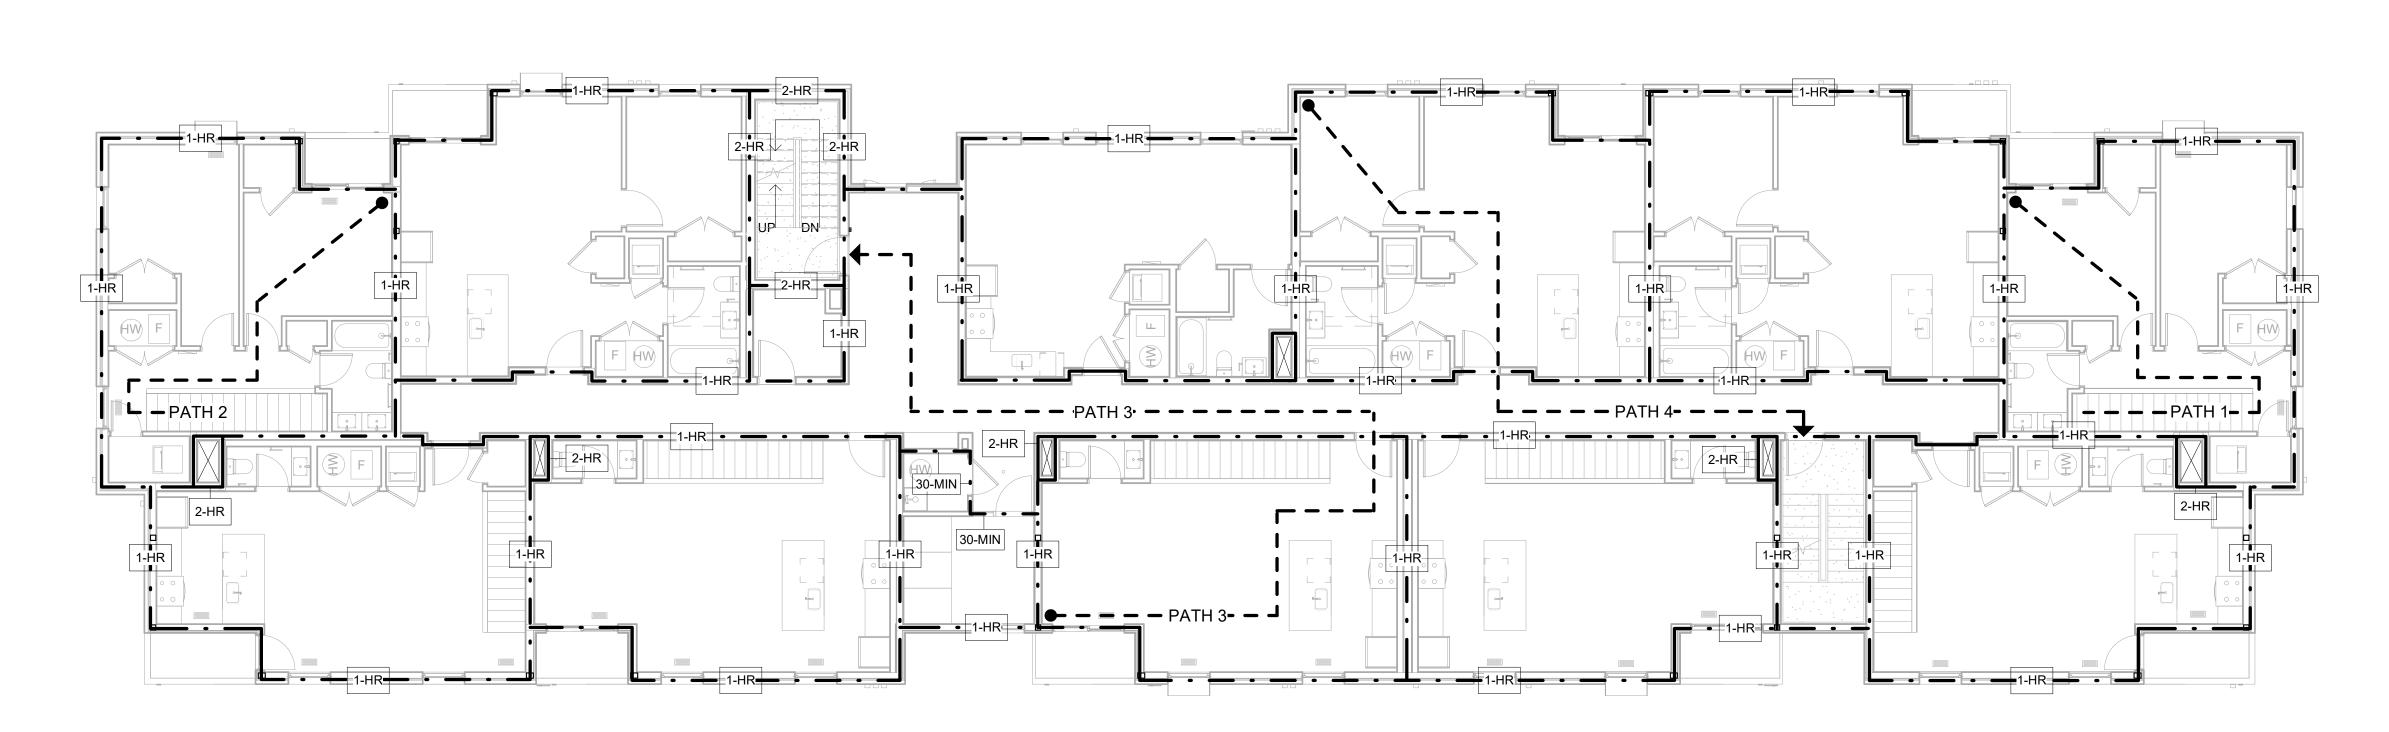
18284 JOB NO.: SCALE: 1/16" = 1'-0" DATE: 05/15/2020

DRAWING TITLE


CODE REVIEW & AREA PLANS

SHEET NO.

G-101



2 2nd FLOOR LIFE SAFETY 1/8" = 1'-0" EXIT CAPACITY: 6.15"

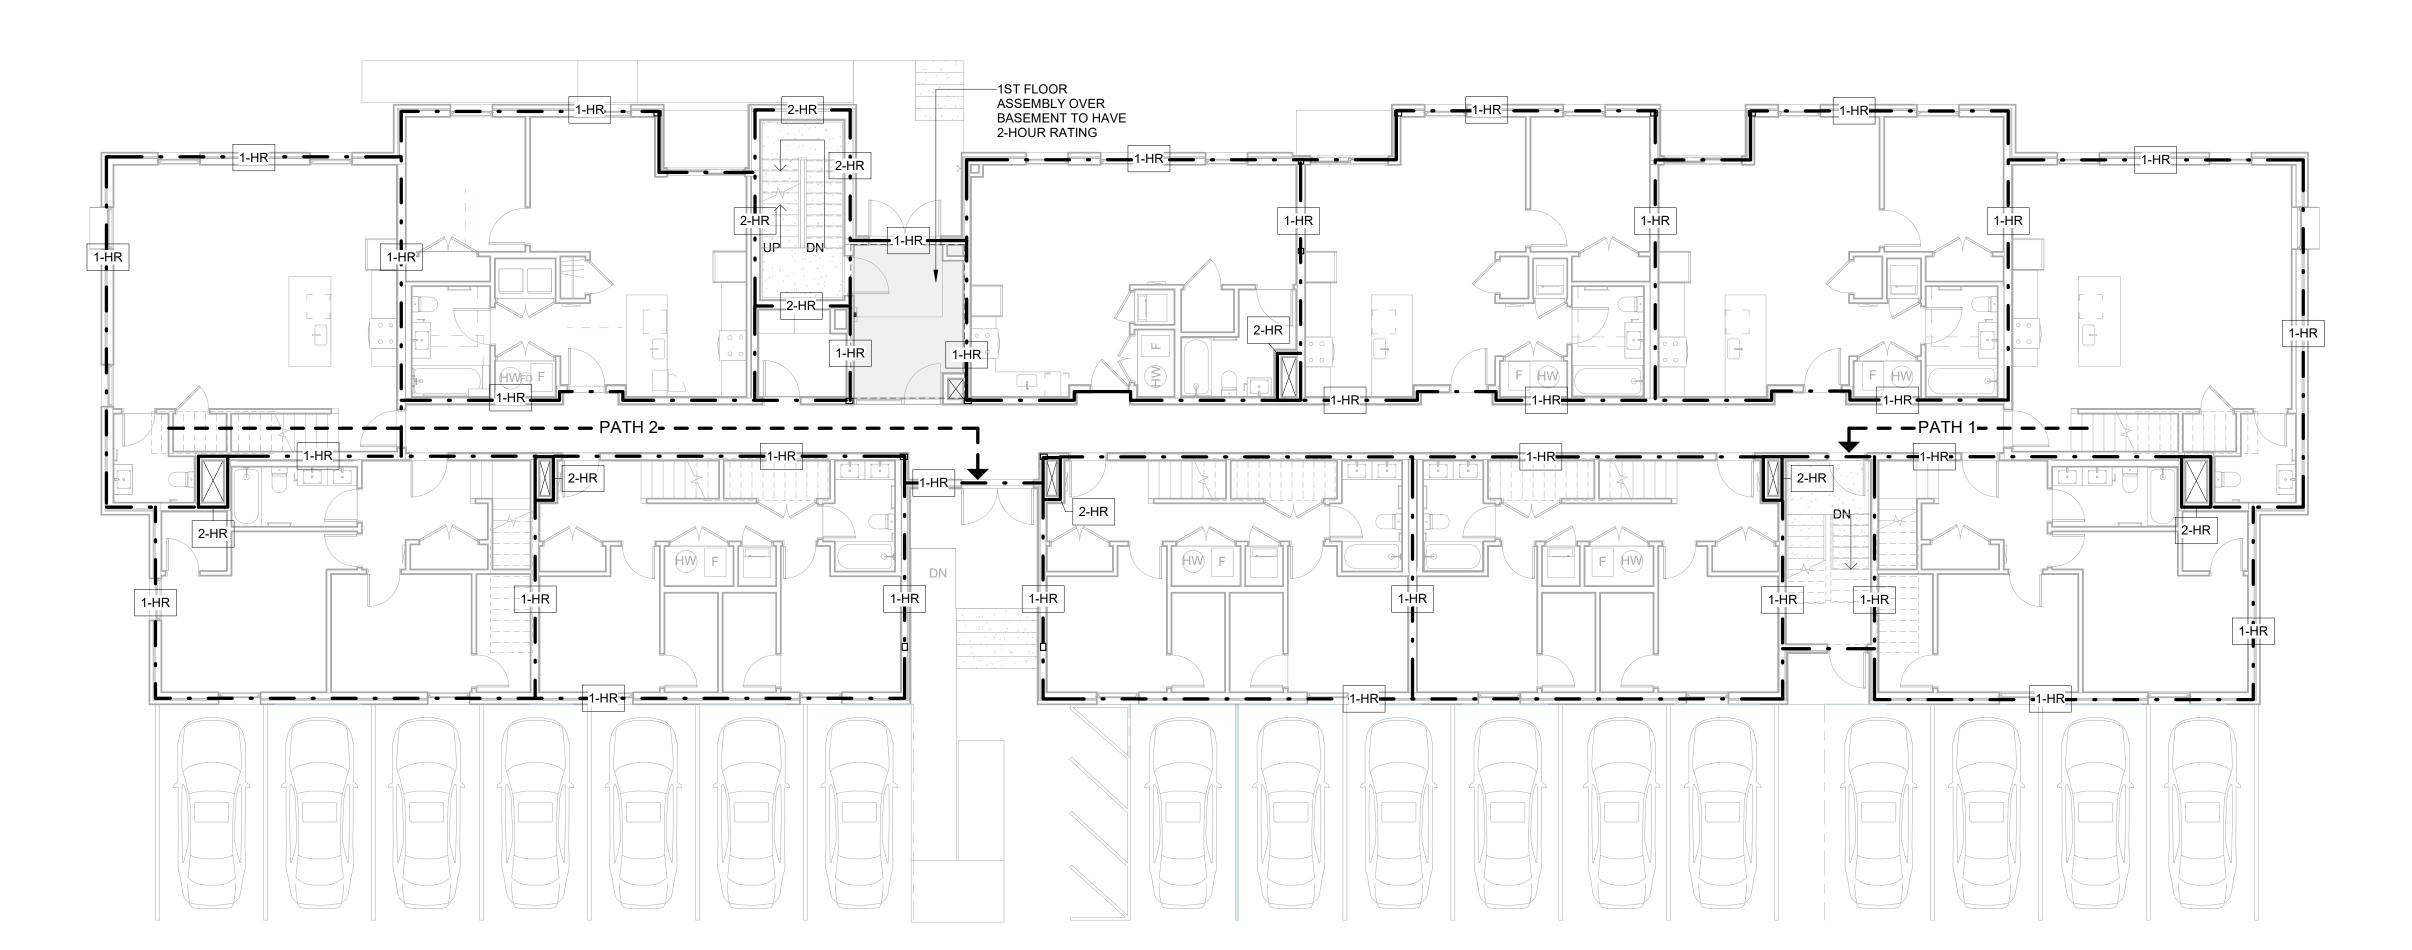

REGISTRATION

LIFE SAFETY LEGEND

─ ─ ─ TRAVEL PATH

EGRESS PATHS

Travel Path | Travel Distance

PATH 2

PATH 3

PATH 4

PATH 5

PATH 6

69' - 10 7/8"

103' - 6"

88' - 6"

106' - 0 7/16"

64' - 1 11/16"

120' - 1 1/4"



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John and **Duplette** d Place trush St. 48201 p On Edmun Between E Detroit MI,

05/15/20: 100% CD / PERMIT SET

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18284 JOB NO.: SCALE: As indicated

DATE: 05/15/2020

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LIFE SAFETY PLANS


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LS-001


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1 1st FLOOR LIFE SAFETY
1/8" = 1'-0"

EXIT CAPACITY: 6.15"



EXIT CAPACITY: 6.15"

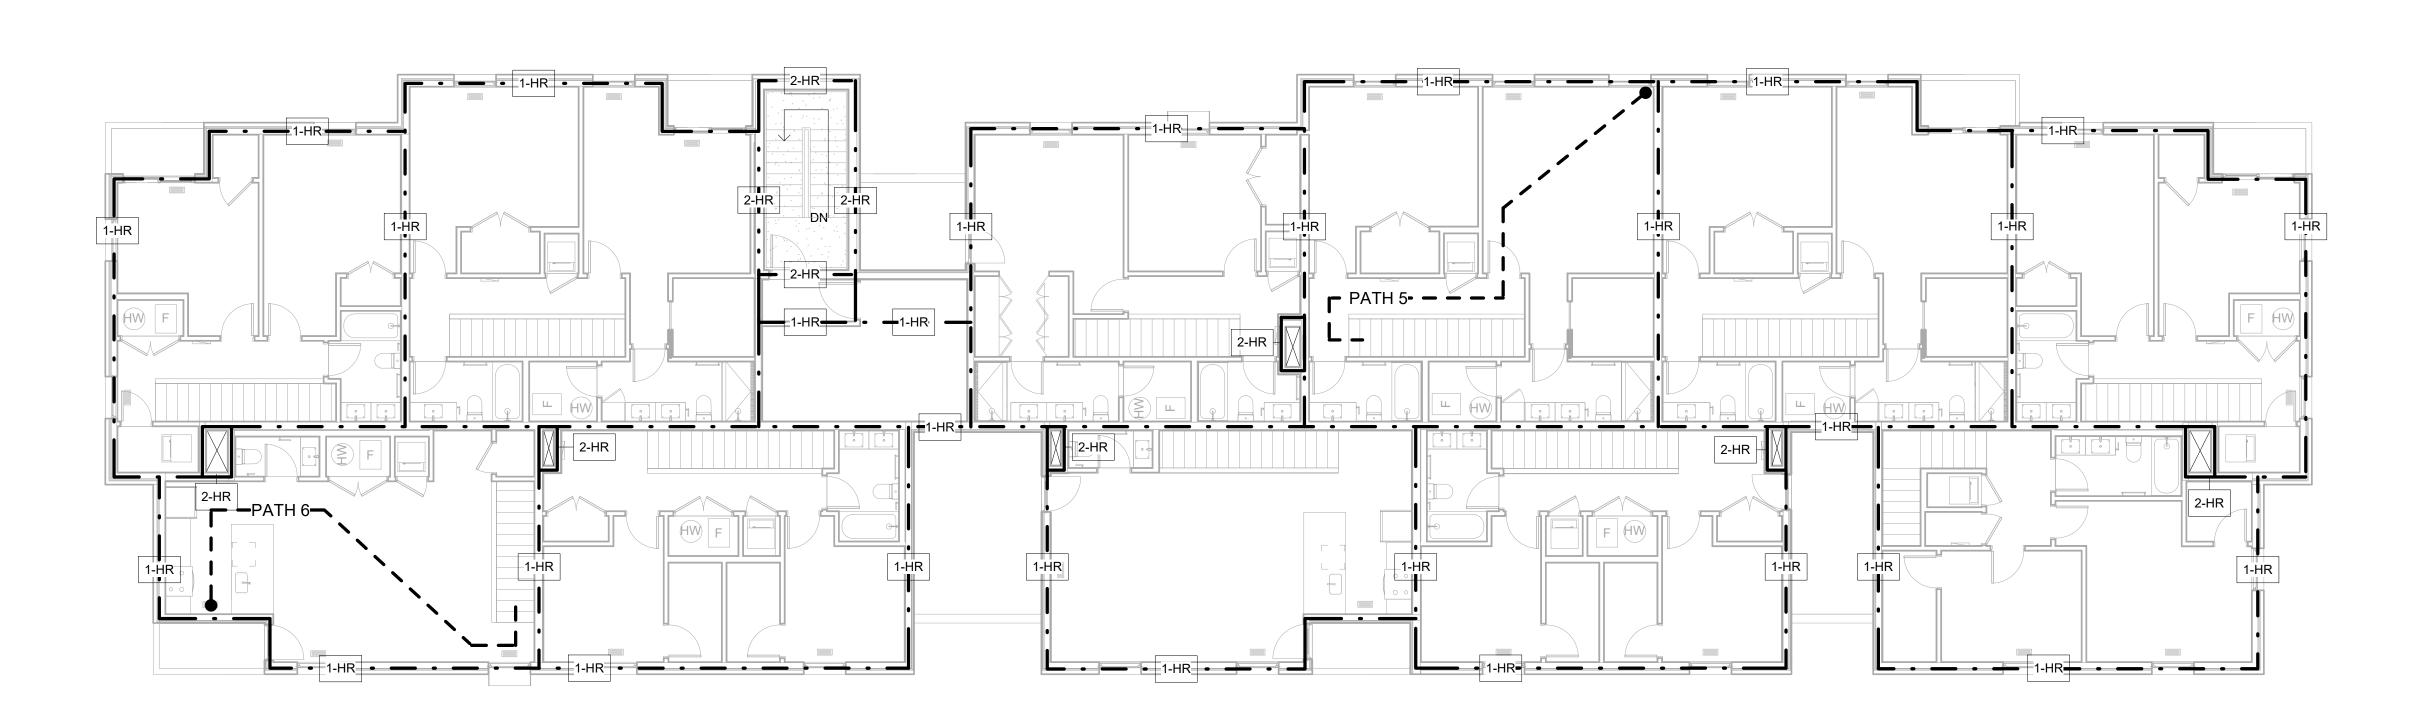

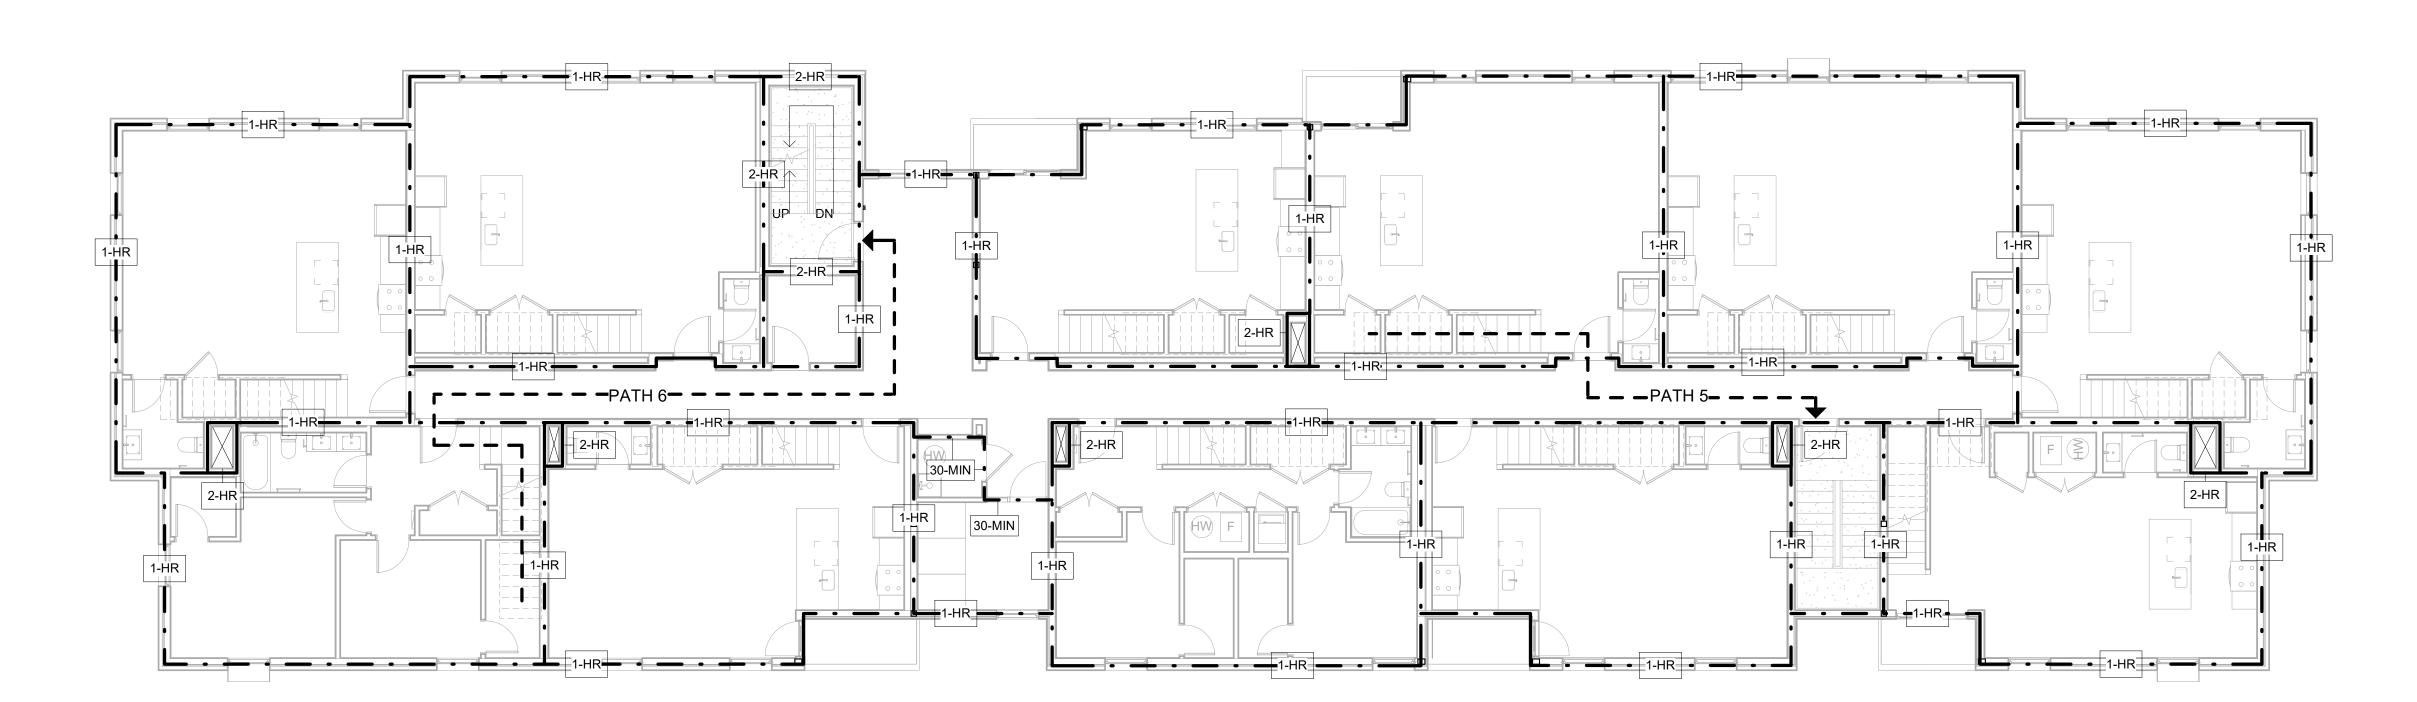2 4th FLOOR LIFE SAFETY 1/8" = 1'-0"

1 3rd FLOOR LIFE SAFETY 1/8" = 1'-0" EXIT CAPACITY: 6.15"

LIFE SAFETY LEGEND

EGRESS PATHS

Travel Path Travel Distance

PATH 2

PATH 3

PATH 4

PATH 5

PATH 6

69' - 10 7/8"

103' - 6"

88' - 6"

106' - 0 7/16"

64' - 1 11/16"

120' - 1 1/4"

REGISTRATION



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d Place srush St. 48201 O

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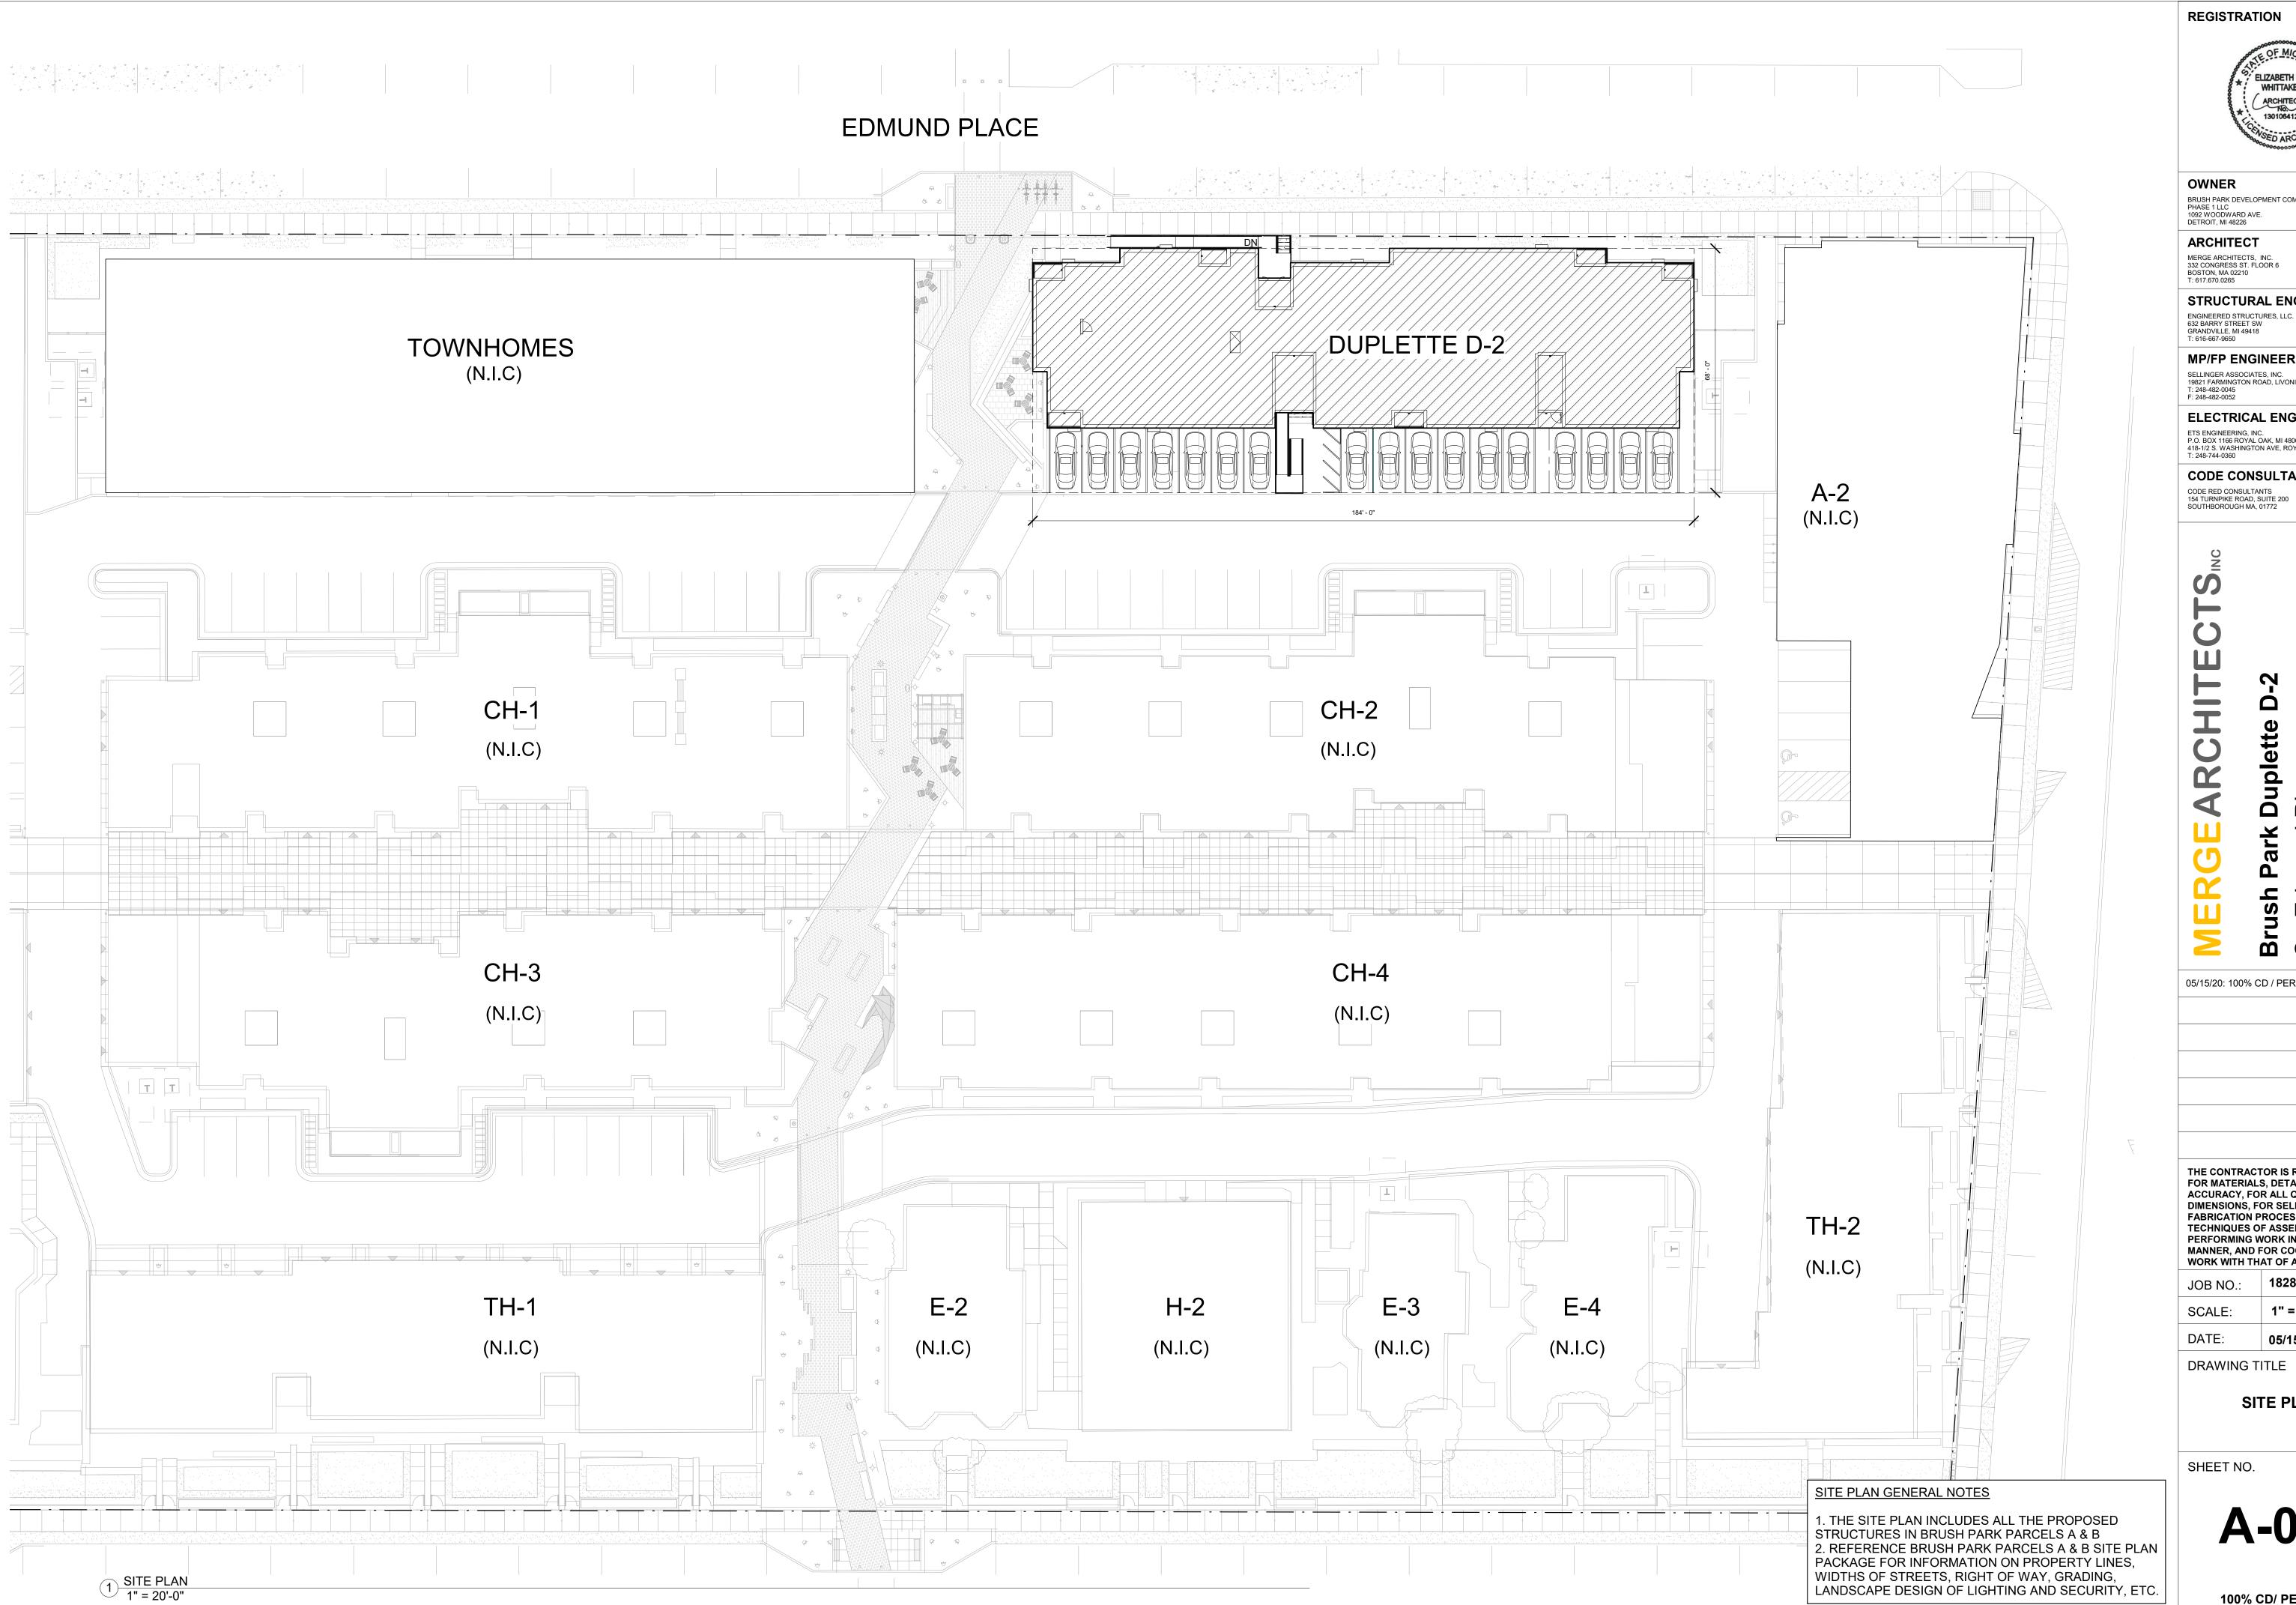
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DRAWING TITLE

LIFE SAFETY PLANS

SHEET NO.

LS-002



REGISTRATION



BRUSH PARK DEVELOPMENT COMPANY PHASE 1 LLC 1092 WOODWARD AVE. DETROIT, MI 48226

ARCHITECT

STRUCTURAL ENGINEER

MP/FP ENGINEER

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John **Duplette**

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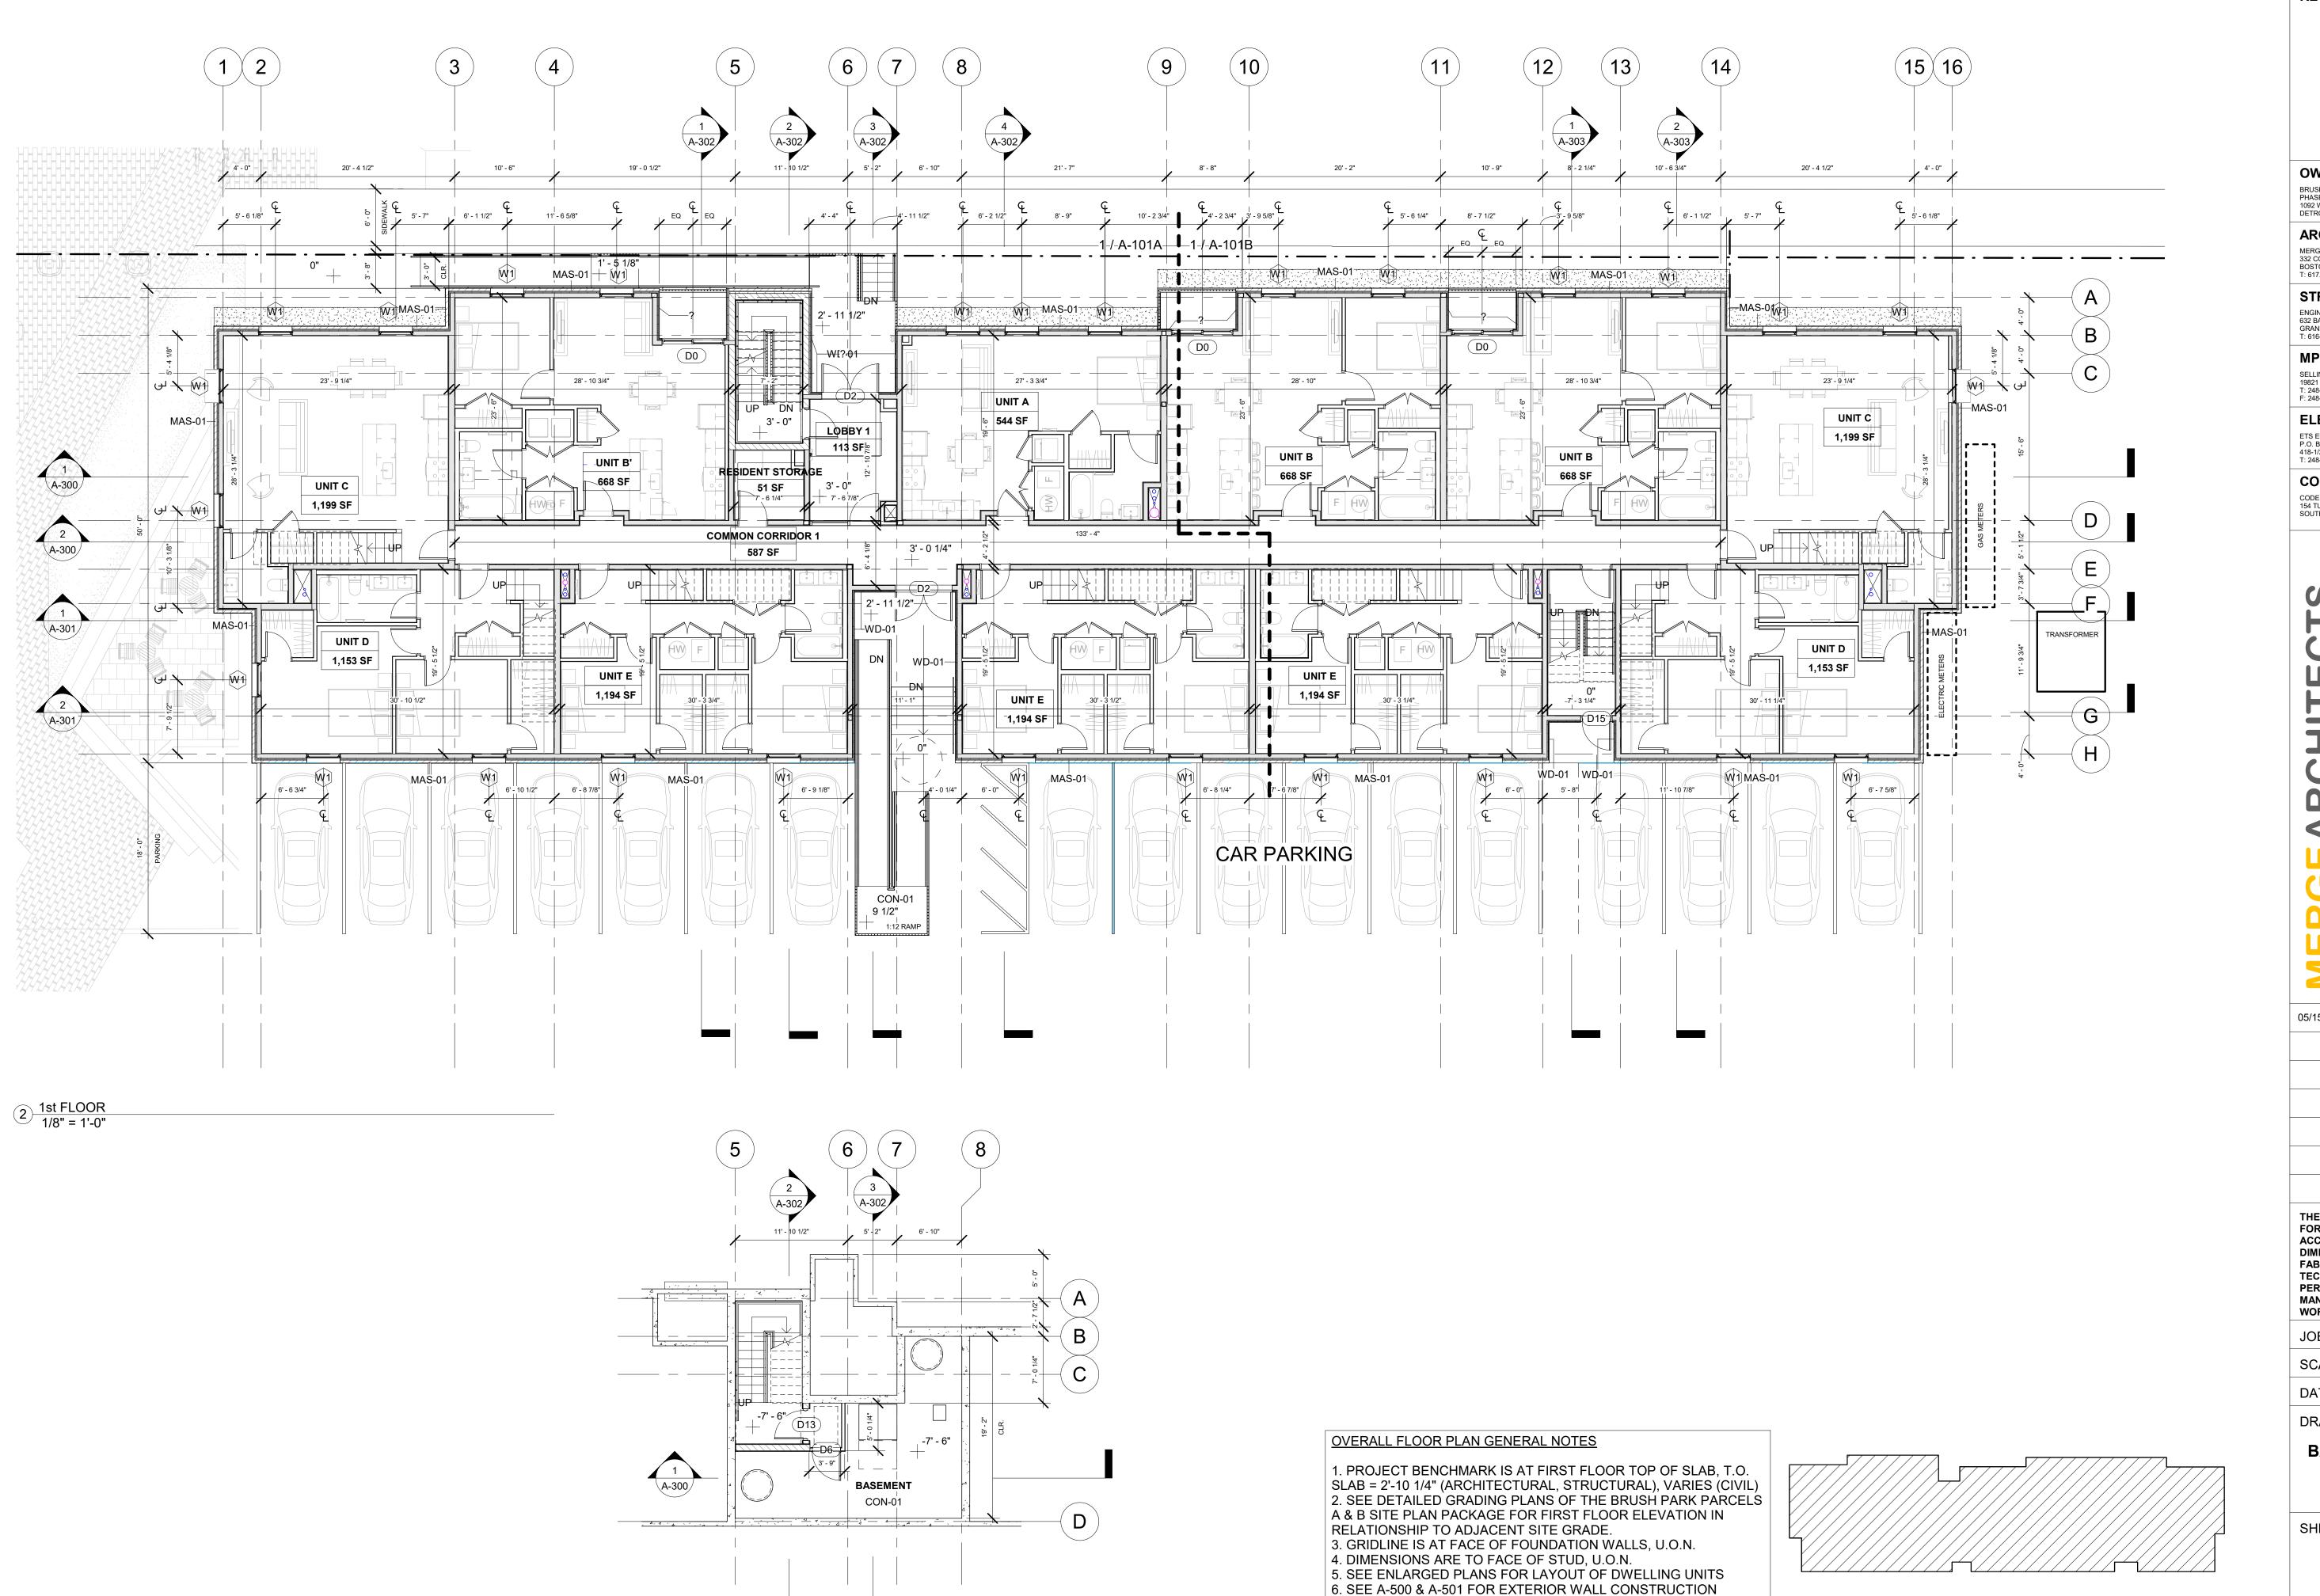
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18284 JOB NO.: 1" = 20'-0" 05/15/2020

DRAWING TITLE

SITE PLAN

A-001



1 BASEMENT 1/8" = 1'-0"

7. FURNITURE N.I.C. AND SHOWN FOR REFERENCE ONLY

A101 KEY PLAN

REGISTRATION



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THE CONTRACTOR IS RESPONSIBLE FOR MATERIALS, DETAILS AND ACCURACY, FOR ALL QUANTITIES AND DIMENSIONS, FOR SELECTING **FABRICATION PROCESSES, FOR** TECHNIQUES OF ASSEMBLY, FOR PERFORMING WORK IN A SAFE MANNER, AND FOR COORDINATING WORK WITH THAT OF ALL TRADES

JOB NO.: 18284 SCALE: As indicated


DATE: 05/15/2020

DRAWING TITLE

BASEMENT AND FIRST FLOOR PLAN

SHEET NO.

A-101

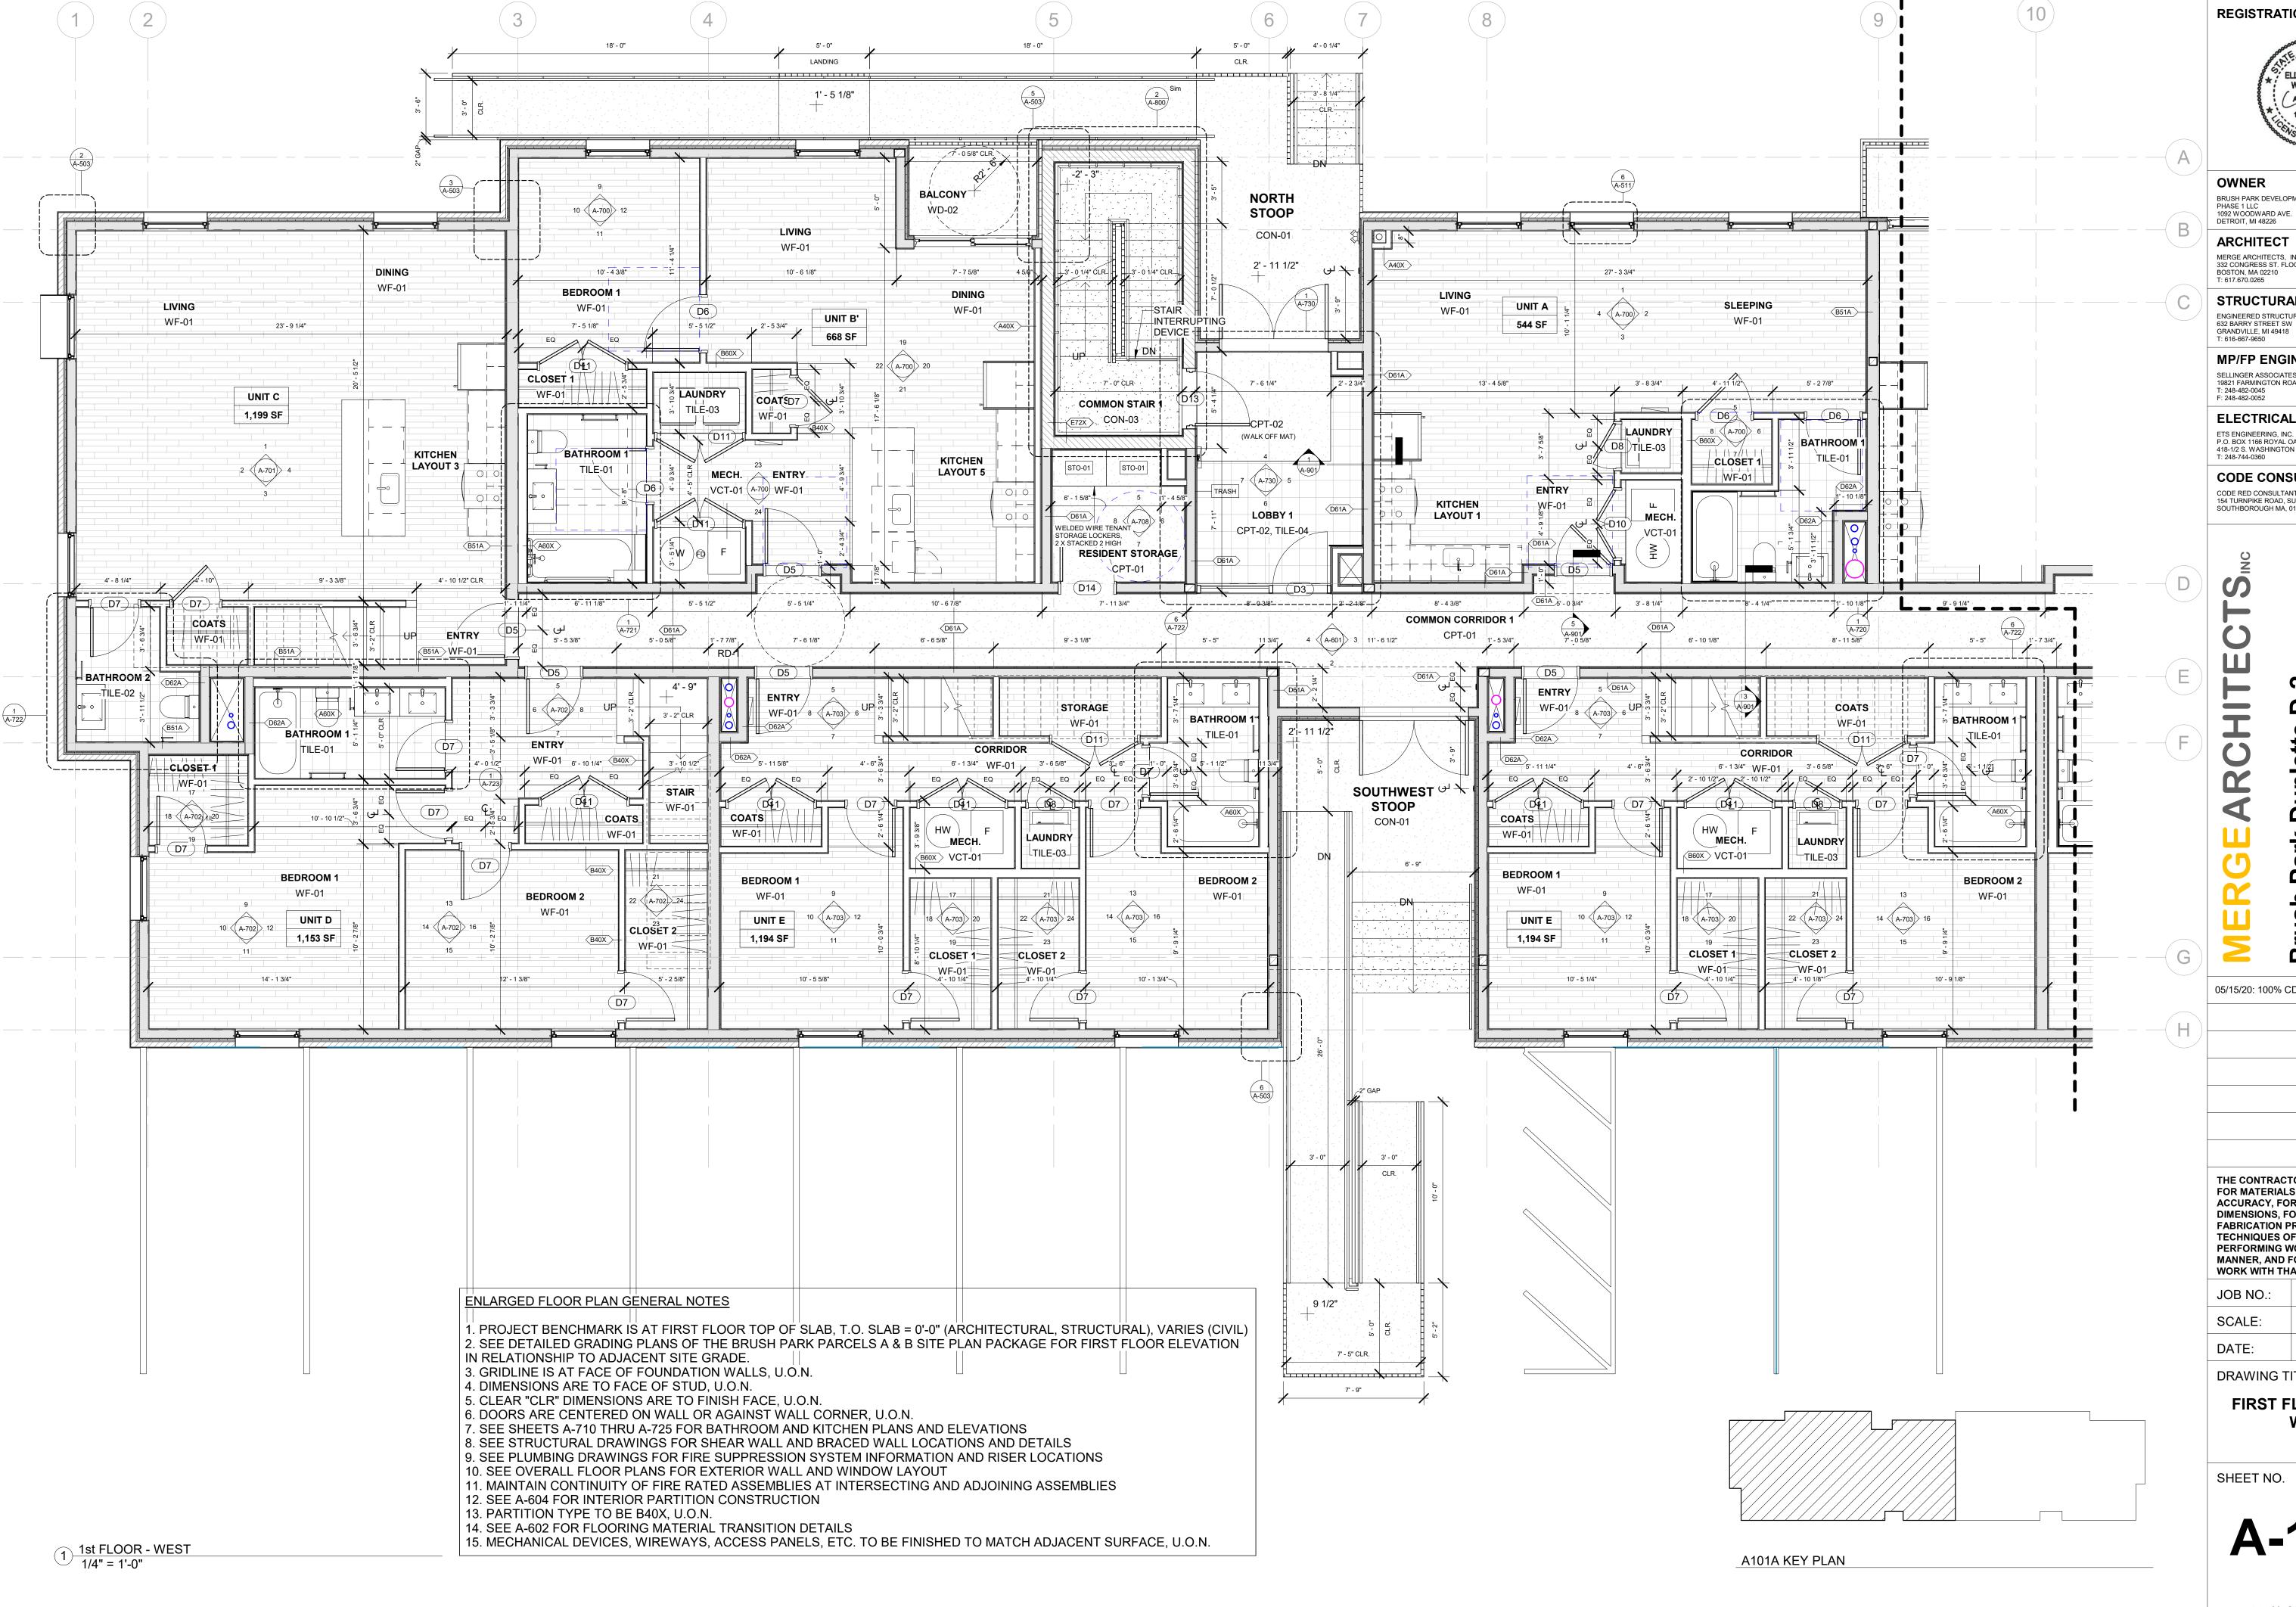

REGISTRATION



OWNER BRUSH PARK DEVELOPMENT COMPANY 1092 WOODWARD AVE.

ARCHITECT MERGE ARCHITECTS, INC. 332 CONGRESS ST. FLOOR 6 BOSTON, MA 02210 T: 617.670.0265

STRUCTURAL ENGINEER ENGINEERED STRUCTURES, LLC.

MP/FP ENGINEER

SELLINGER ASSOCIATES, INC. 19821 FARMINGTON ROAD, LIVONIA, MI 48152 T: 248-482-0045 F: 248-482-0052

ELECTRICAL ENGINEER ETS ENGINEERING, INC. P.O. BOX 1166 ROYAL OAK, MI 48068 418-1/2 S. WASHINGTON AVE, ROYAL OAK, MI 48067

CODE CONSULTANT

CODE RED CONSULTANTS 154 TURNPIKE ROAD, SUITE 200 SOUTHBOROUGH MA, 01772

05/15/20: 100% CD / PERMIT SET

THE CONTRACTOR IS RESPONSIBLE FOR MATERIALS, DETAILS AND ACCURACY, FOR ALL QUANTITIES AND DIMENSIONS, FOR SELECTING **FABRICATION PROCESSES, FOR** TECHNIQUES OF ASSEMBLY, FOR PERFORMING WORK IN A SAFE MANNER, AND FOR COORDINATING WORK WITH THAT OF ALL TRADES

JOB NO.: As indicated


05/15/2020

DRAWING TITLE

FIRST FLOOR PLAN -**WEST**

SHEET NO.

A-101A

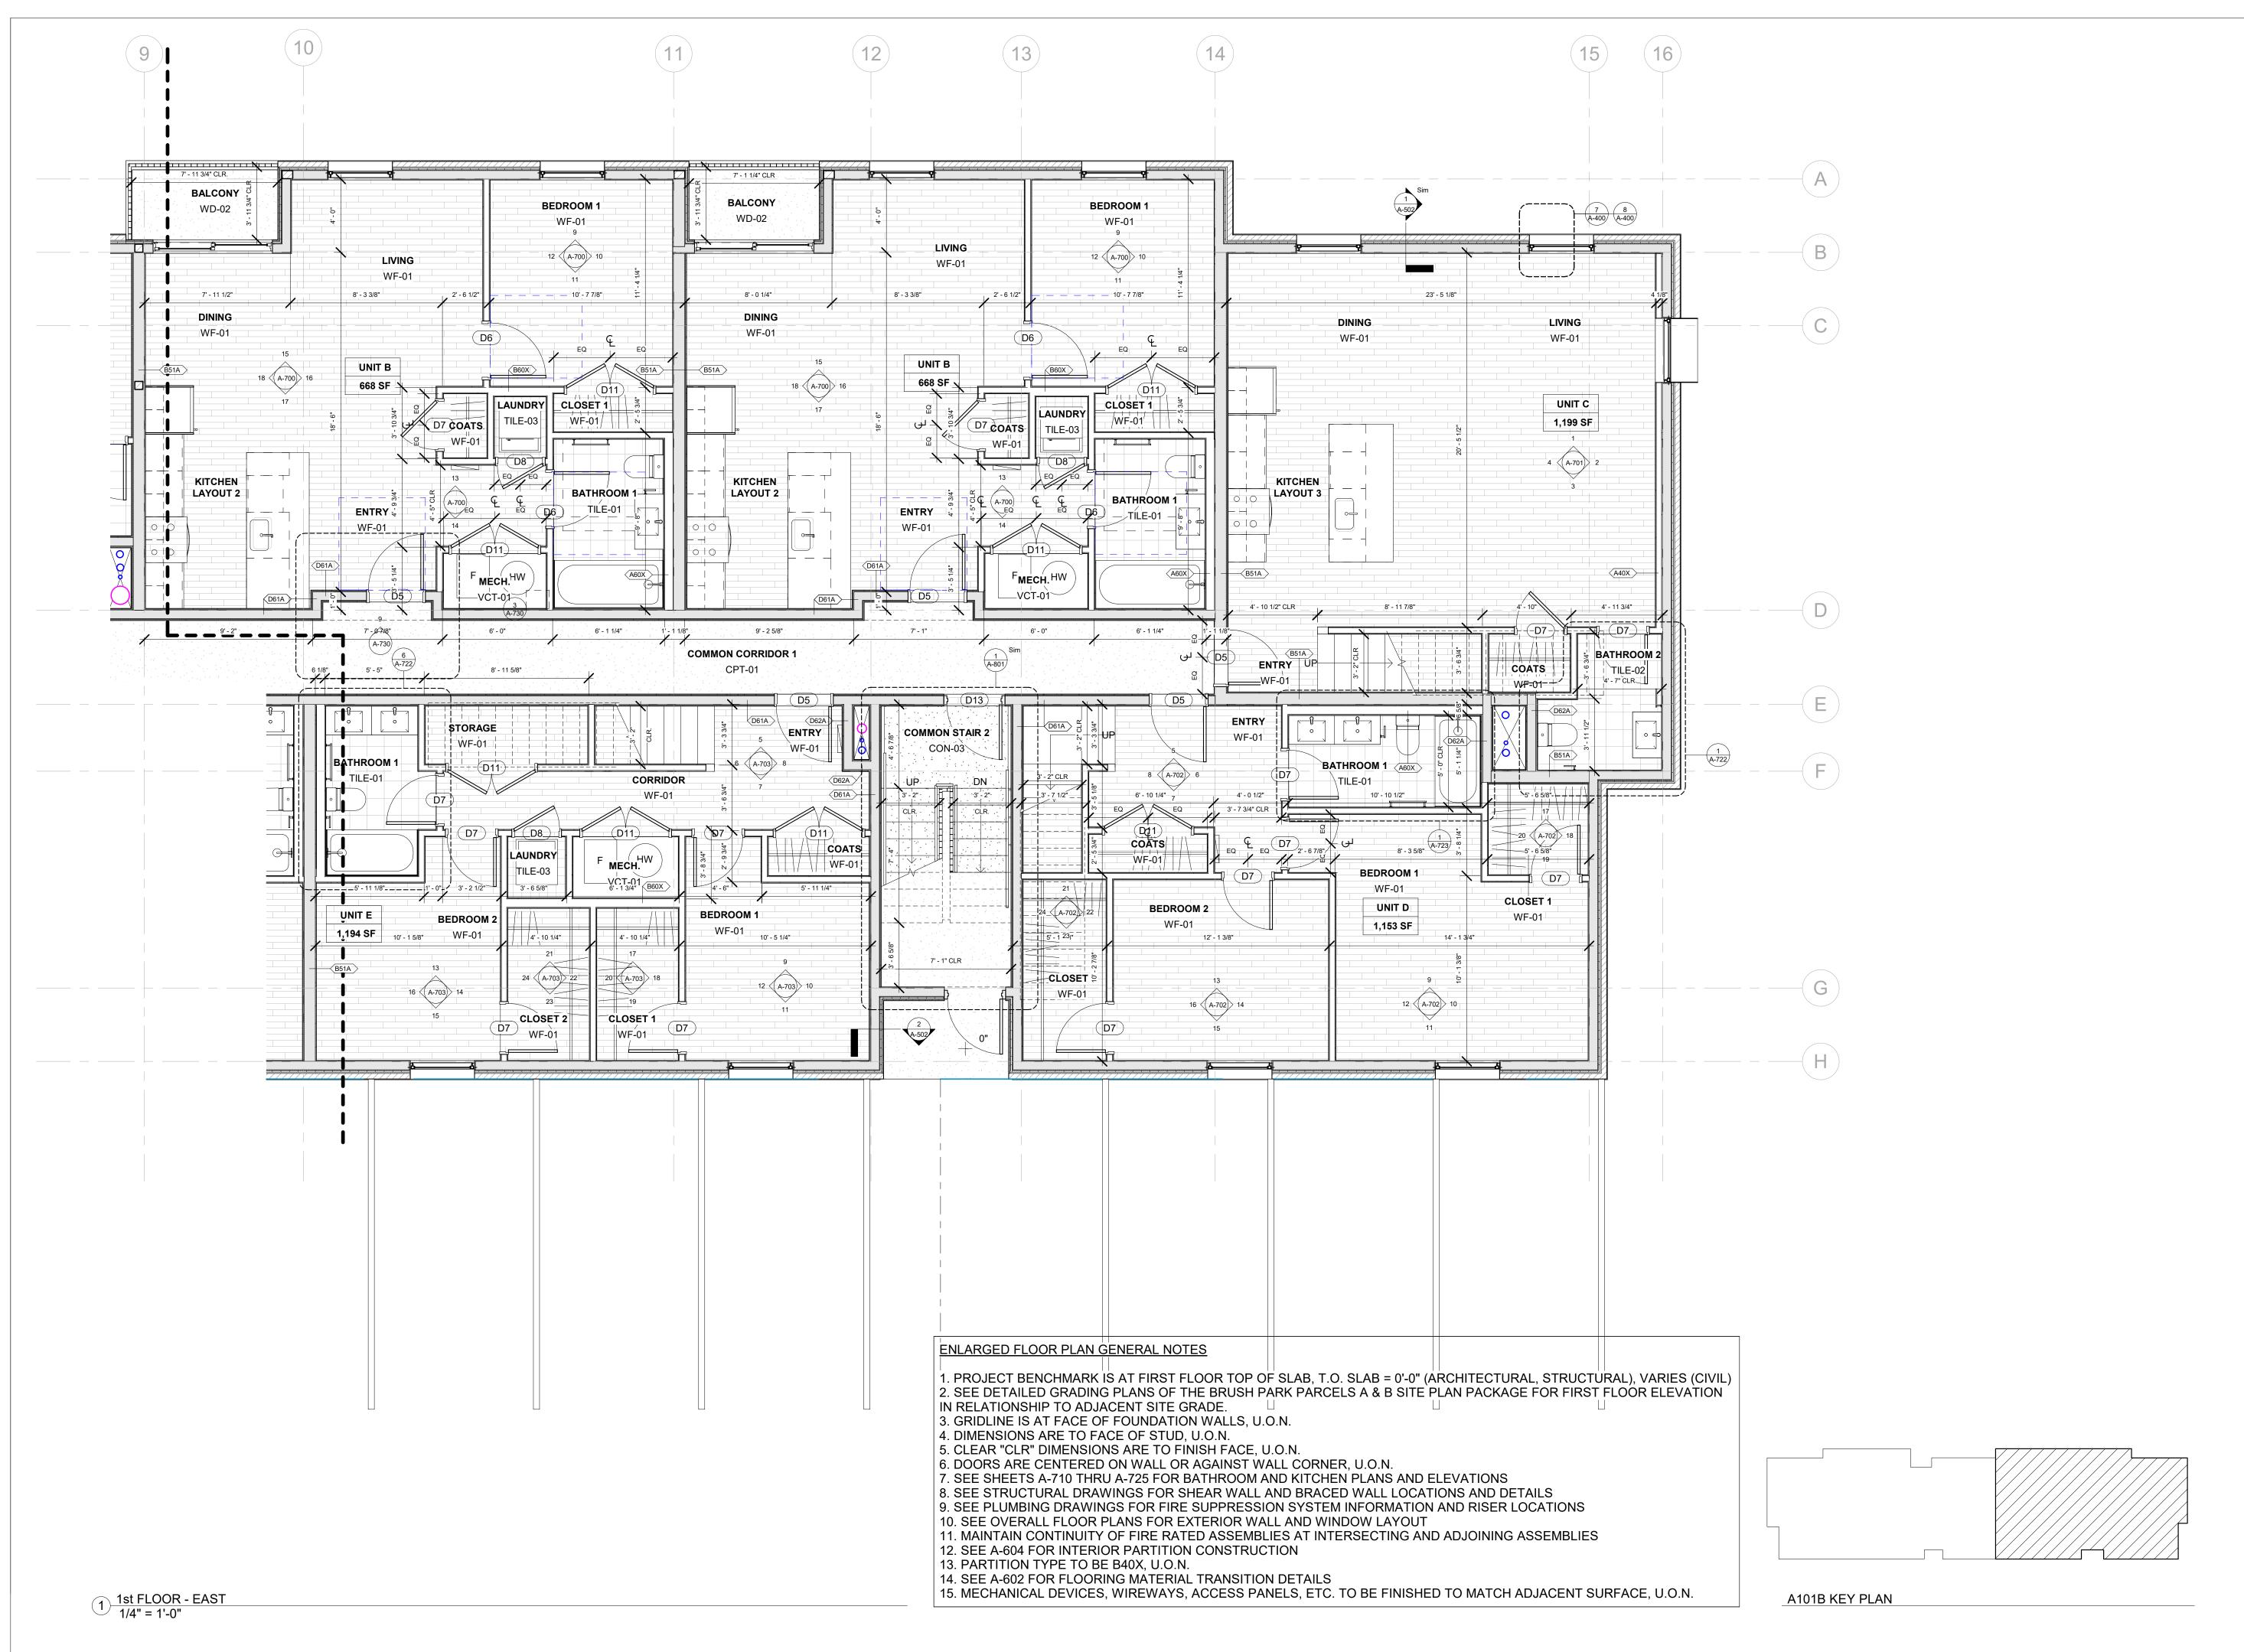

REGISTRATION



OWNER BRUSH PARK DEVELOPMENT COMPANY PHASE 1 LLC 1092 WOODWARD AVE. DETROIT, MI 48226

ARCHITECT MERGE ARCHITECTS, INC. 332 CONGRESS ST. FLOOR 6 BOSTON, MA 02210 T: 617.670.0265

STRUCTURAL ENGINEER ENGINEERED STRUCTURES, LLC. 632 BARRY STREET SW GRANDVILLE, MI 49418 T: 616-667-9650

MP/FP ENGINEER SELLINGER ASSOCIATES, INC.

19821 FARMINGTON ROAD, LIVONIA, MI 48152 T: 248-482-0045 F: 248-482-0052

ELECTRICAL ENGINEER ETS ENGINEERING, INC. P.O. BOX 1166 ROYAL OAK, MI 48068 418-1/2 S. WASHINGTON AVE, ROYAL OAK, MI 48067

CODE CONSULTANT

CODE RED CONSULTANTS 154 TURNPIKE ROAD, SUITE 200 SOUTHBOROUGH MA, 01772

and **Duplette**

0

05/15/20: 100% CD / PERMIT SET

THE CONTRACTOR IS RESPONSIBLE FOR MATERIALS, DETAILS AND ACCURACY, FOR ALL QUANTITIES AND DIMENSIONS, FOR SELECTING FABRICATION PROCESSES, FOR TECHNIQUES OF ASSEMBLY, FOR PERFORMING WORK IN A SAFE MANNER, AND FOR COORDINATING WORK WITH THAT OF ALL TRADES

18284 JOB NO.:

As indicated


DATE: 05/15/2020

DRAWING TITLE

FIRST FLOOR PLAN -**EAST**

SHEET NO.

A-101B

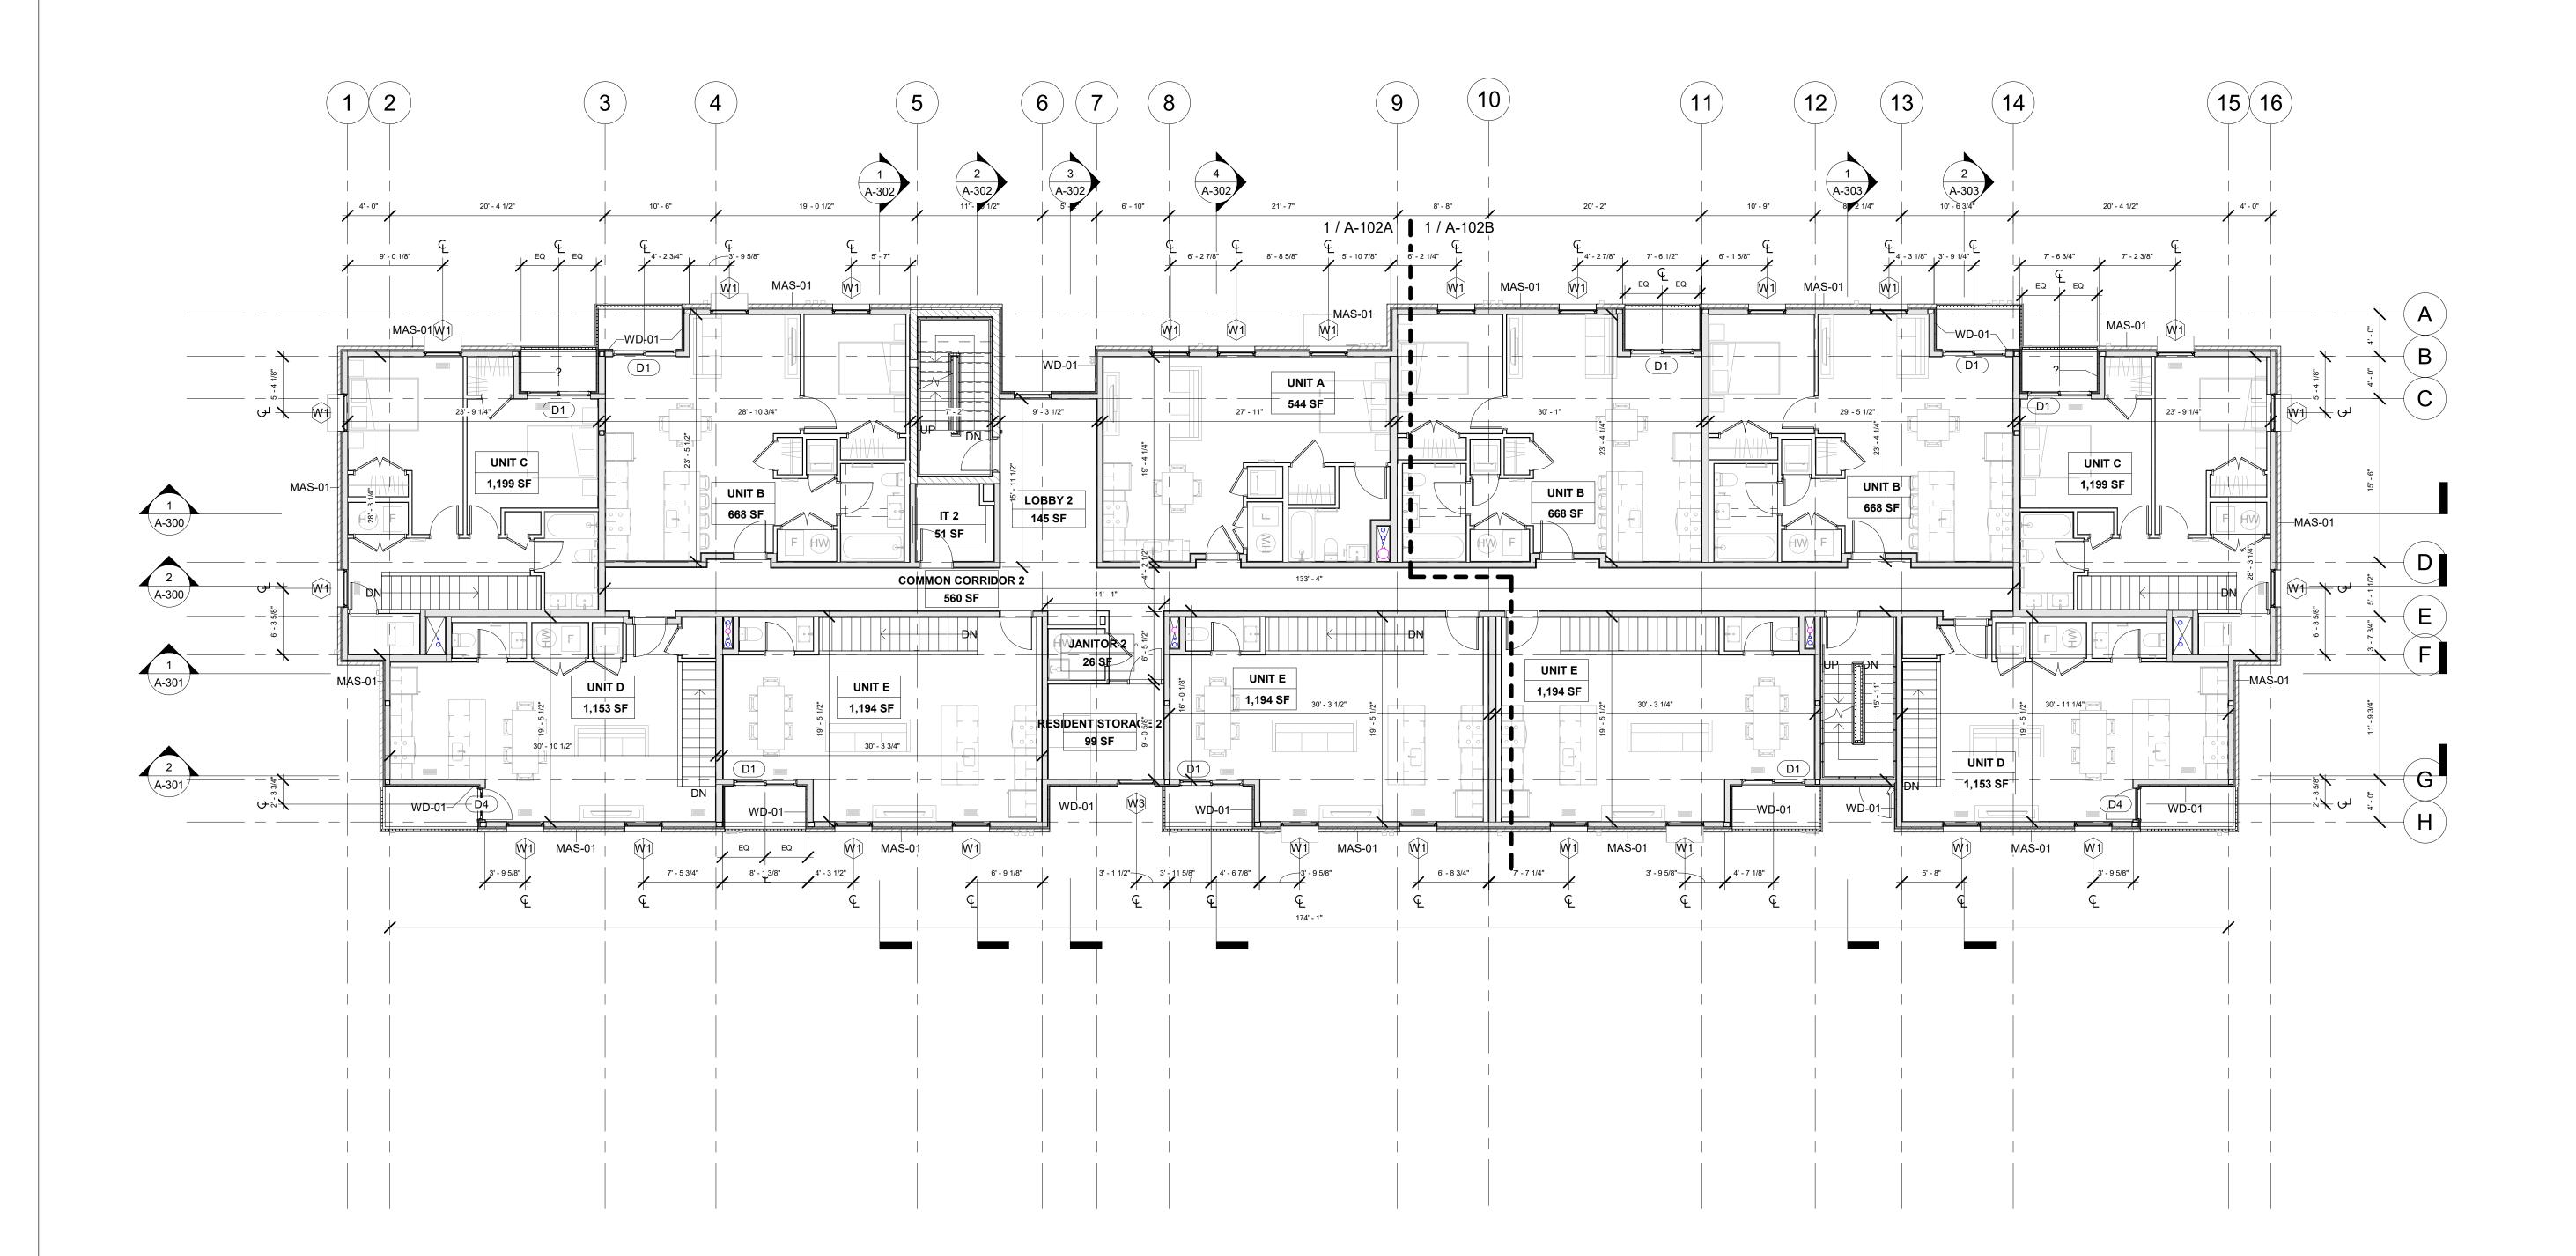


OVERALL FLOOR PLAN GENERAL NOTES

1. PROJECT BENCHMARK IS AT FIRST FLOOR TOP OF SLAB, T.O. SLAB = 2'-10 1/4" (ARCHITECTURAL, STRUCTURAL), VARIES (CIVIL) 2. SEE DETAILED GRADING PLANS OF THE BRUSH PARK PARCELS A & B SITE PLAN PACKAGE FOR FIRST FLOOR ELEVATION IN RELATIONSHIP TO ADJACENT SITE GRADE.

3. GRIDLINE IS AT FACE OF FOUNDATION WALLS, U.O.N.

4. DIMENSIONS ARE TO FACE OF STUD, U.O.N. 5. SEE ENLARGED PLANS FOR LAYOUT OF DWELLING UNITS 6. SEE A-500 & A-501 FOR EXTERIOR WALL CONSTRUCTION 7. FURNITURE N.I.C. AND SHOWN FOR REFERENCE ONLY

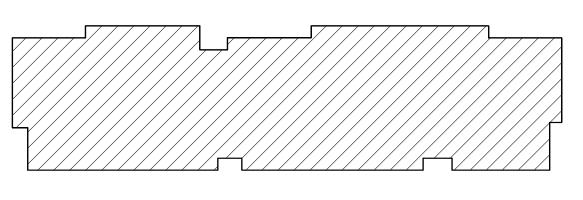

A102 KEY PLAN

REGISTRATION



OWNER BRUSH PARK DEVELOPMENT COMPANY PHASE 1 LLC 1092 WOODWARD AVE. DETROIT, MI 48226

ARCHITECT

MERGE ARCHITECTS, INC. 332 CONGRESS ST. FLOOR 6 BOSTON, MA 02210 T: 617.670.0265

STRUCTURAL ENGINEER ENGINEERED STRUCTURES, LLC. 632 BARRY STREET SW GRANDVILLE, MI 49418 T: 616-667-9650

MP/FP ENGINEER

SELLINGER ASSOCIATES, INC. 19821 FARMINGTON ROAD, LIVONIA, MI 48152 T: 248-482-0045 F: 248-482-0052

ELECTRICAL ENGINEER ETS ENGINEERING, INC.
P.O. BOX 1166 ROYAL OAK, MI 48068
418-1/2 S. WASHINGTON AVE, ROYAL OAK, MI 48067
T: 248-744-0360

CODE CONSULTANT

CODE RED CONSULTANTS 154 TURNPIKE ROAD, SUITE 200 SOUTHBOROUGH MA, 01772

John and d Place trush St. 48201

Duplette Q

05/15/20: 100% CD / PERMIT SET

THE CONTRACTOR IS RESPONSIBLE FOR MATERIALS, DETAILS AND ACCURACY, FOR ALL QUANTITIES AND DIMENSIONS, FOR SELECTING FABRICATION PROCESSES, FOR TECHNIQUES OF ASSEMBLY, FOR PERFORMING WORK IN A SAFE MANNER, AND FOR COORDINATING WORK WITH THAT OF ALL TRADES


JOB NO.: 18284 As indicated

DATE: 05/15/2020

DRAWING TITLE

SECOND FLOOR PLAN

SHEET NO.

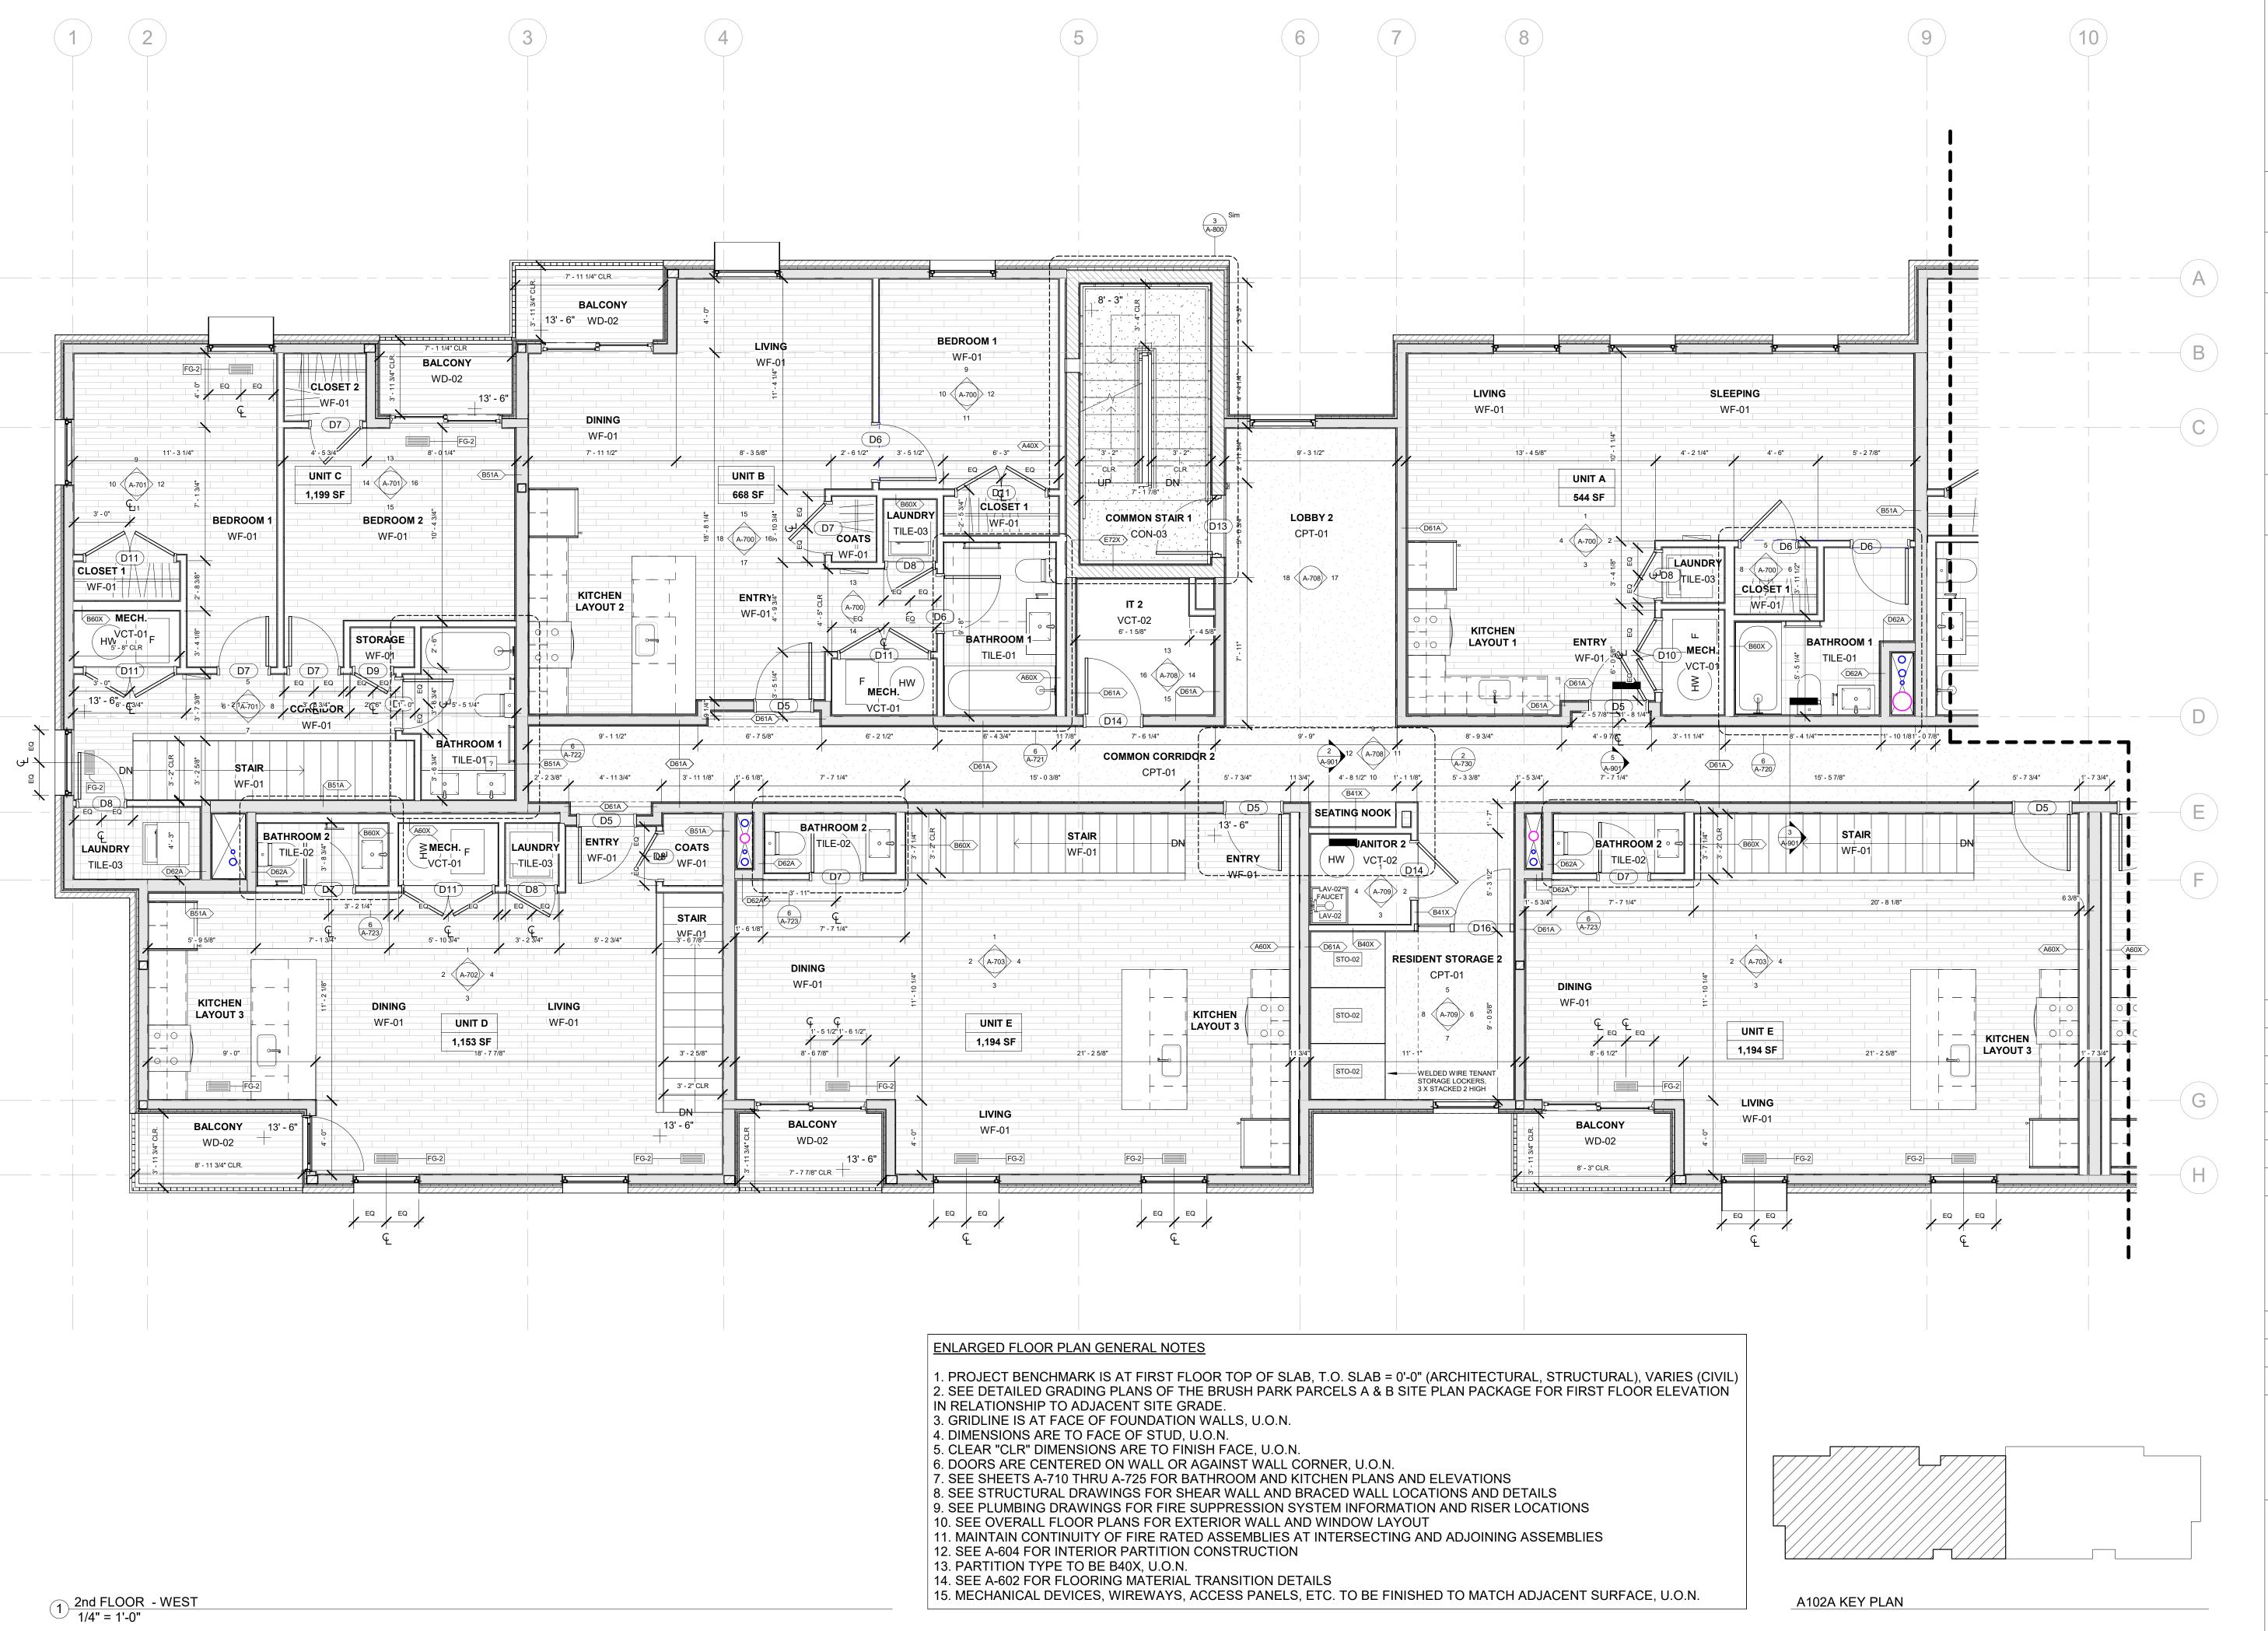



OWNER BRUSH PARK DEVELOPMENT COMPANY PHASE 1 LLC 1092 WOODWARD AVE.

ARCHITECT

MERGE ARCHITECTS, INC. 332 CONGRESS ST. FLOOR 6 BOSTON, MA 02210 T: 617.670.0265

STRUCTURAL ENGINEER ENGINEERED STRUCTURES, LLC. 632 BARRY STREET SW GRANDVILLE, MI 49418 T: 616-667-9650

MP/FP ENGINEER SELLINGER ASSOCIATES, INC. 19821 FARMINGTON ROAD, LIVONIA, MI 48152 T: 248-482-0045

F: 248-482-0052 **ELECTRICAL ENGINEER**

ETS ENGINEERING, INC. P.O. BOX 1166 ROYAL OAK, MI 48068 418-1/2 S. WASHINGTON AVE, ROYAL OAK, MI 48067

CODE CONSULTANT

CODE RED CONSULTANTS 154 TURNPIKE ROAD, SUITE 200 SOUTHBOROUGH MA, 01772

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On Bet Det

05/15/20: 100% CD / PERMIT SET

THE CONTRACTOR IS RESPONSIBLE FOR MATERIALS, DETAILS AND ACCURACY, FOR ALL QUANTITIES AND DIMENSIONS, FOR SELECTING **FABRICATION PROCESSES, FOR** TECHNIQUES OF ASSEMBLY, FOR PERFORMING WORK IN A SAFE MANNER, AND FOR COORDINATING WORK WITH THAT OF ALL TRADES

JOB NO.: SCALE:


As indicated DATE: 05/15/2020

DRAWING TITLE

SECOND FLOOR PLAN -WEST

SHEET NO.

A-102A

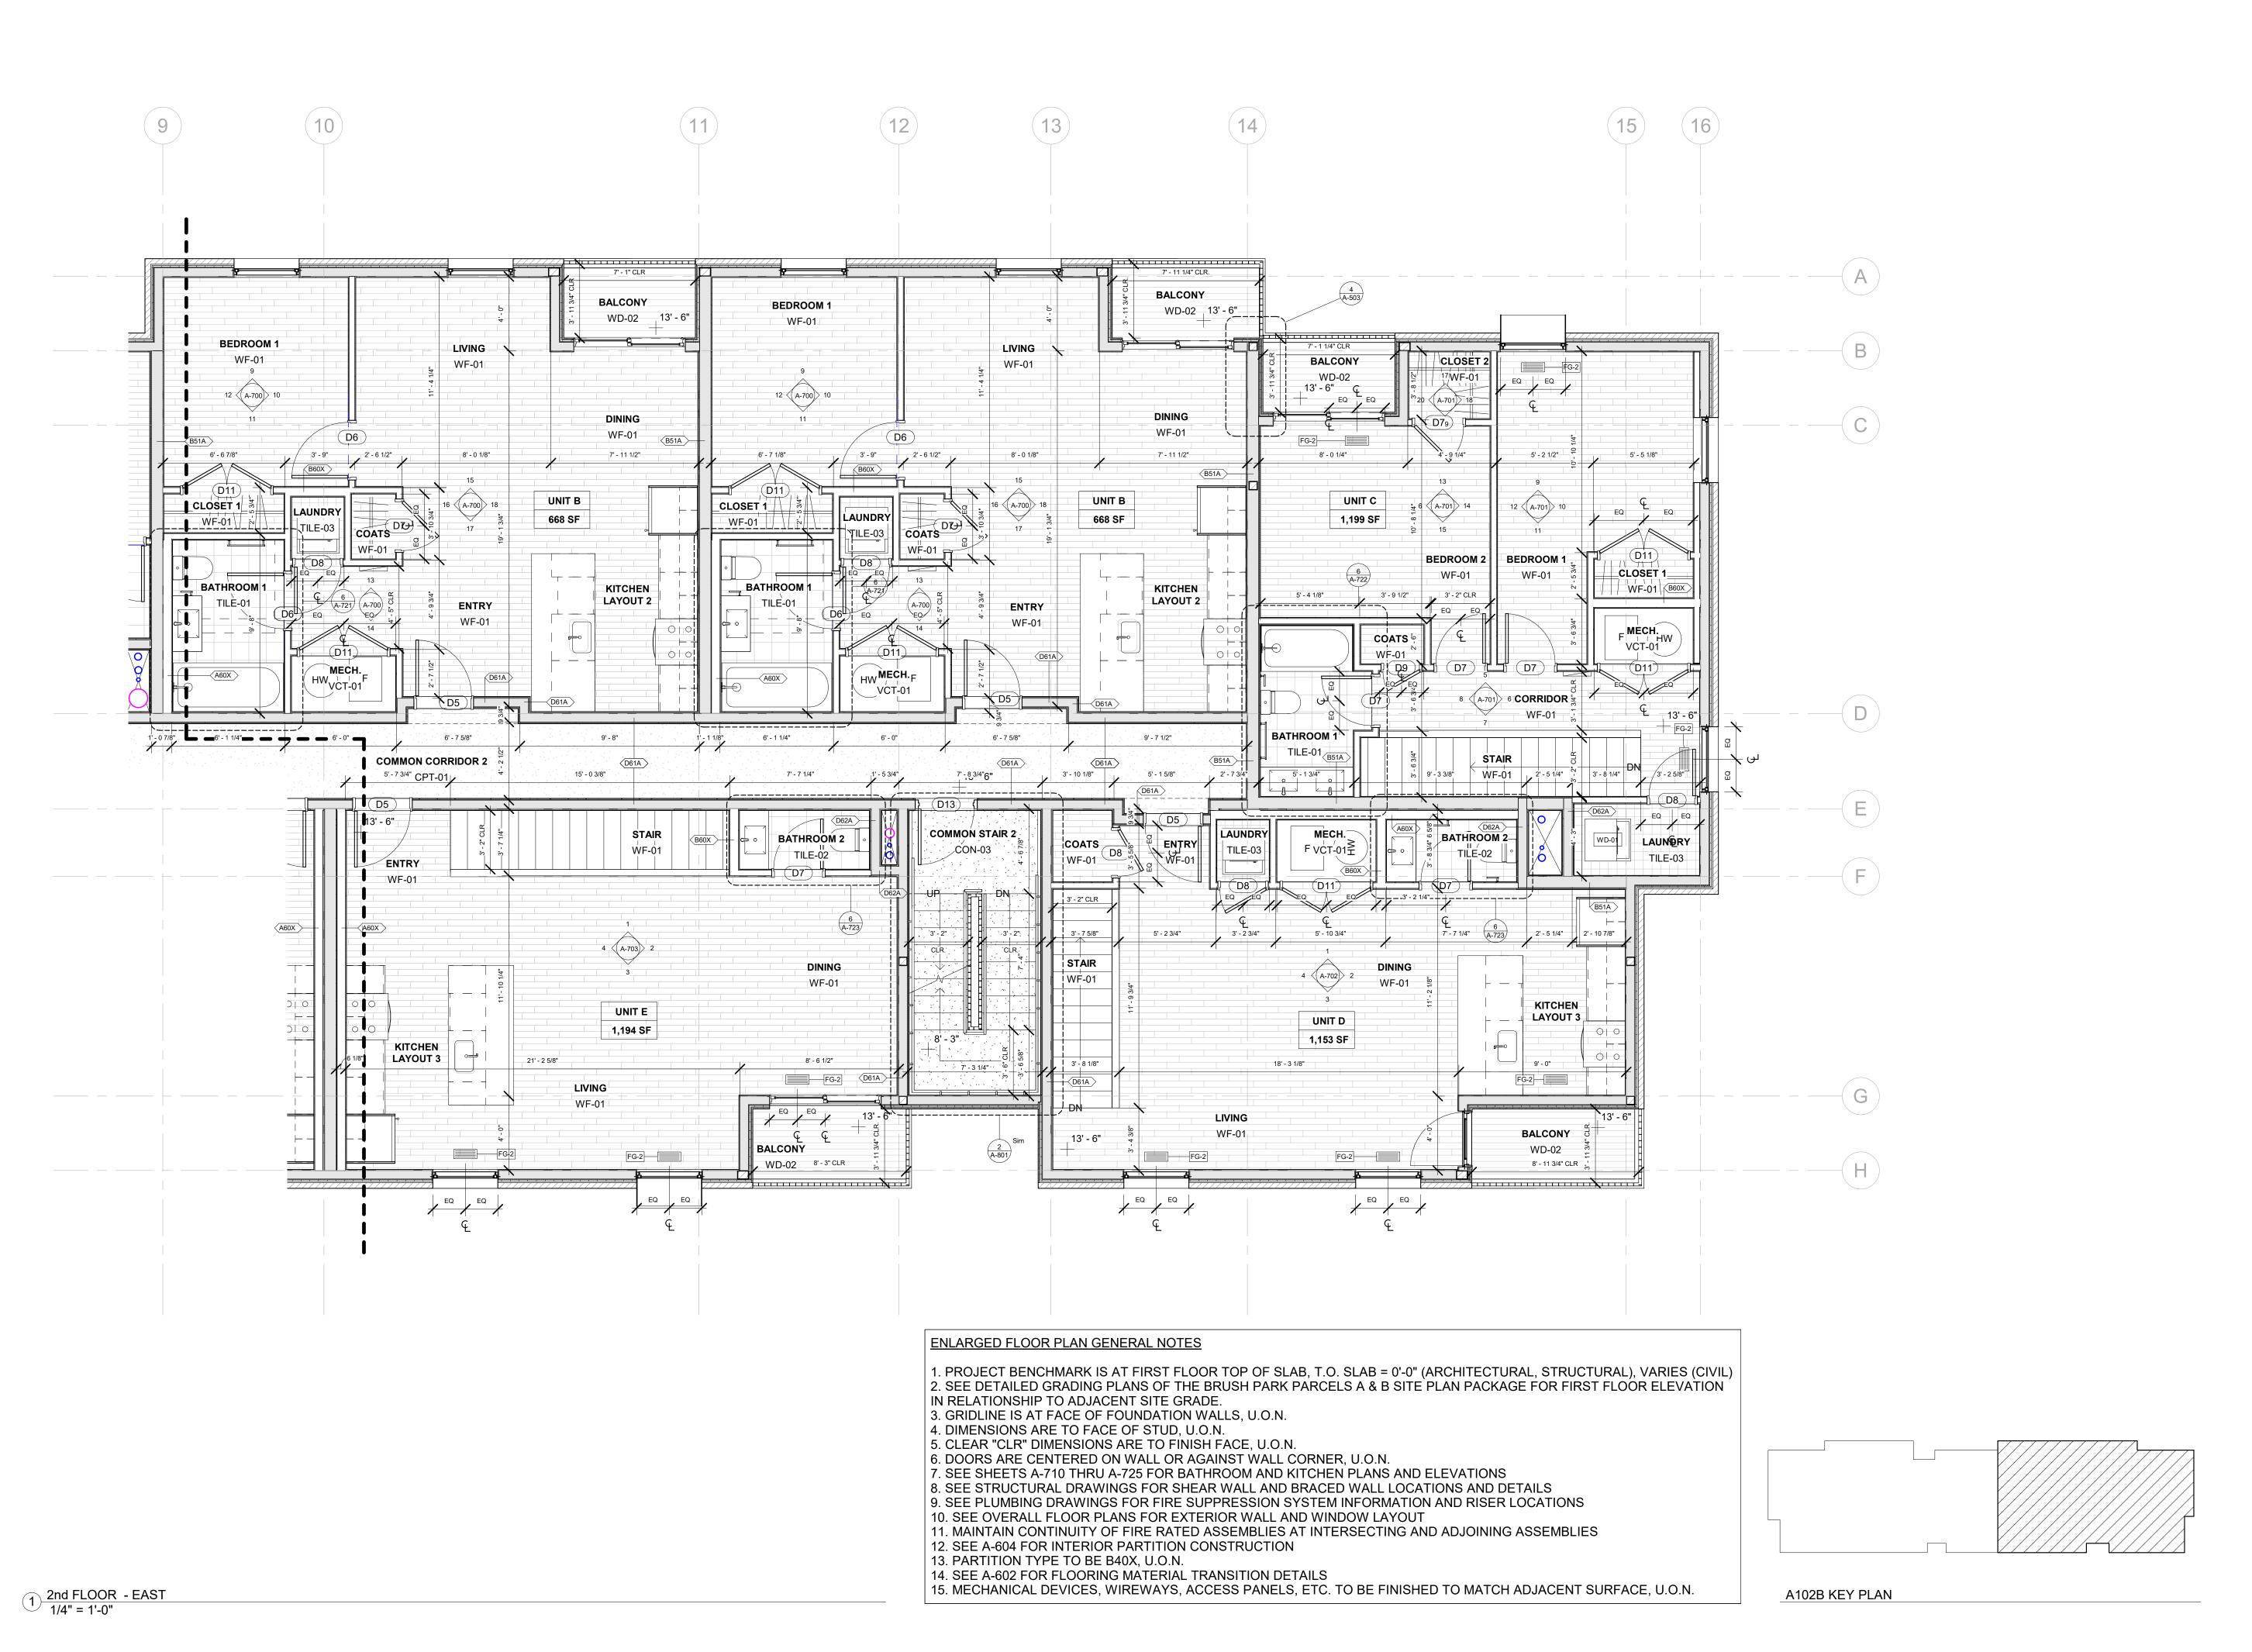



OWNER BRUSH PARK DEVELOPMENT COMPANY PHASE 1 LLC 1092 WOODWARD AVE.

ARCHITECT MERGE ARCHITECTS, INC. 332 CONGRESS ST. FLOOR 6 BOSTON, MA 02210 T: 617.670.0265

DETROIT, MI 48226

STRUCTURAL ENGINEER ENGINEERED STRUCTURES, LLC. 632 BARRY STREET SW GRANDVILLE, MI 49418 T: 616-667-9650

MP/FP ENGINEER SELLINGER ASSOCIATES, INC.

19821 FARMINGTON ROAD, LIVONIA, MI 48152 T: 248-482-0045 F: 248-482-0052 **ELECTRICAL ENGINEER**

ETS ENGINEERING, INC. P.O. BOX 1166 ROYAL OAK, MI 48068 418-1/2 S. WASHINGTON AVE, ROYAL OAK, MI 48067

CODE CONSULTANT

CODE RED CONSULTANTS 154 TURNPIKE ROAD, SUITE 200 SOUTHBOROUGH MA, 01772

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and **Duplette** 0

05/15/20: 100% CD / PERMIT SET

THE CONTRACTOR IS RESPONSIBLE FOR MATERIALS, DETAILS AND ACCURACY, FOR ALL QUANTITIES AND DIMENSIONS, FOR SELECTING **FABRICATION PROCESSES, FOR** TECHNIQUES OF ASSEMBLY, FOR PERFORMING WORK IN A SAFE MANNER, AND FOR COORDINATING WORK WITH THAT OF ALL TRADES

JOB NO.:


As indicated DATE: 05/15/2020

DRAWING TITLE

SECOND FLOOR PLAN -EAST

SHEET NO.

A-102B

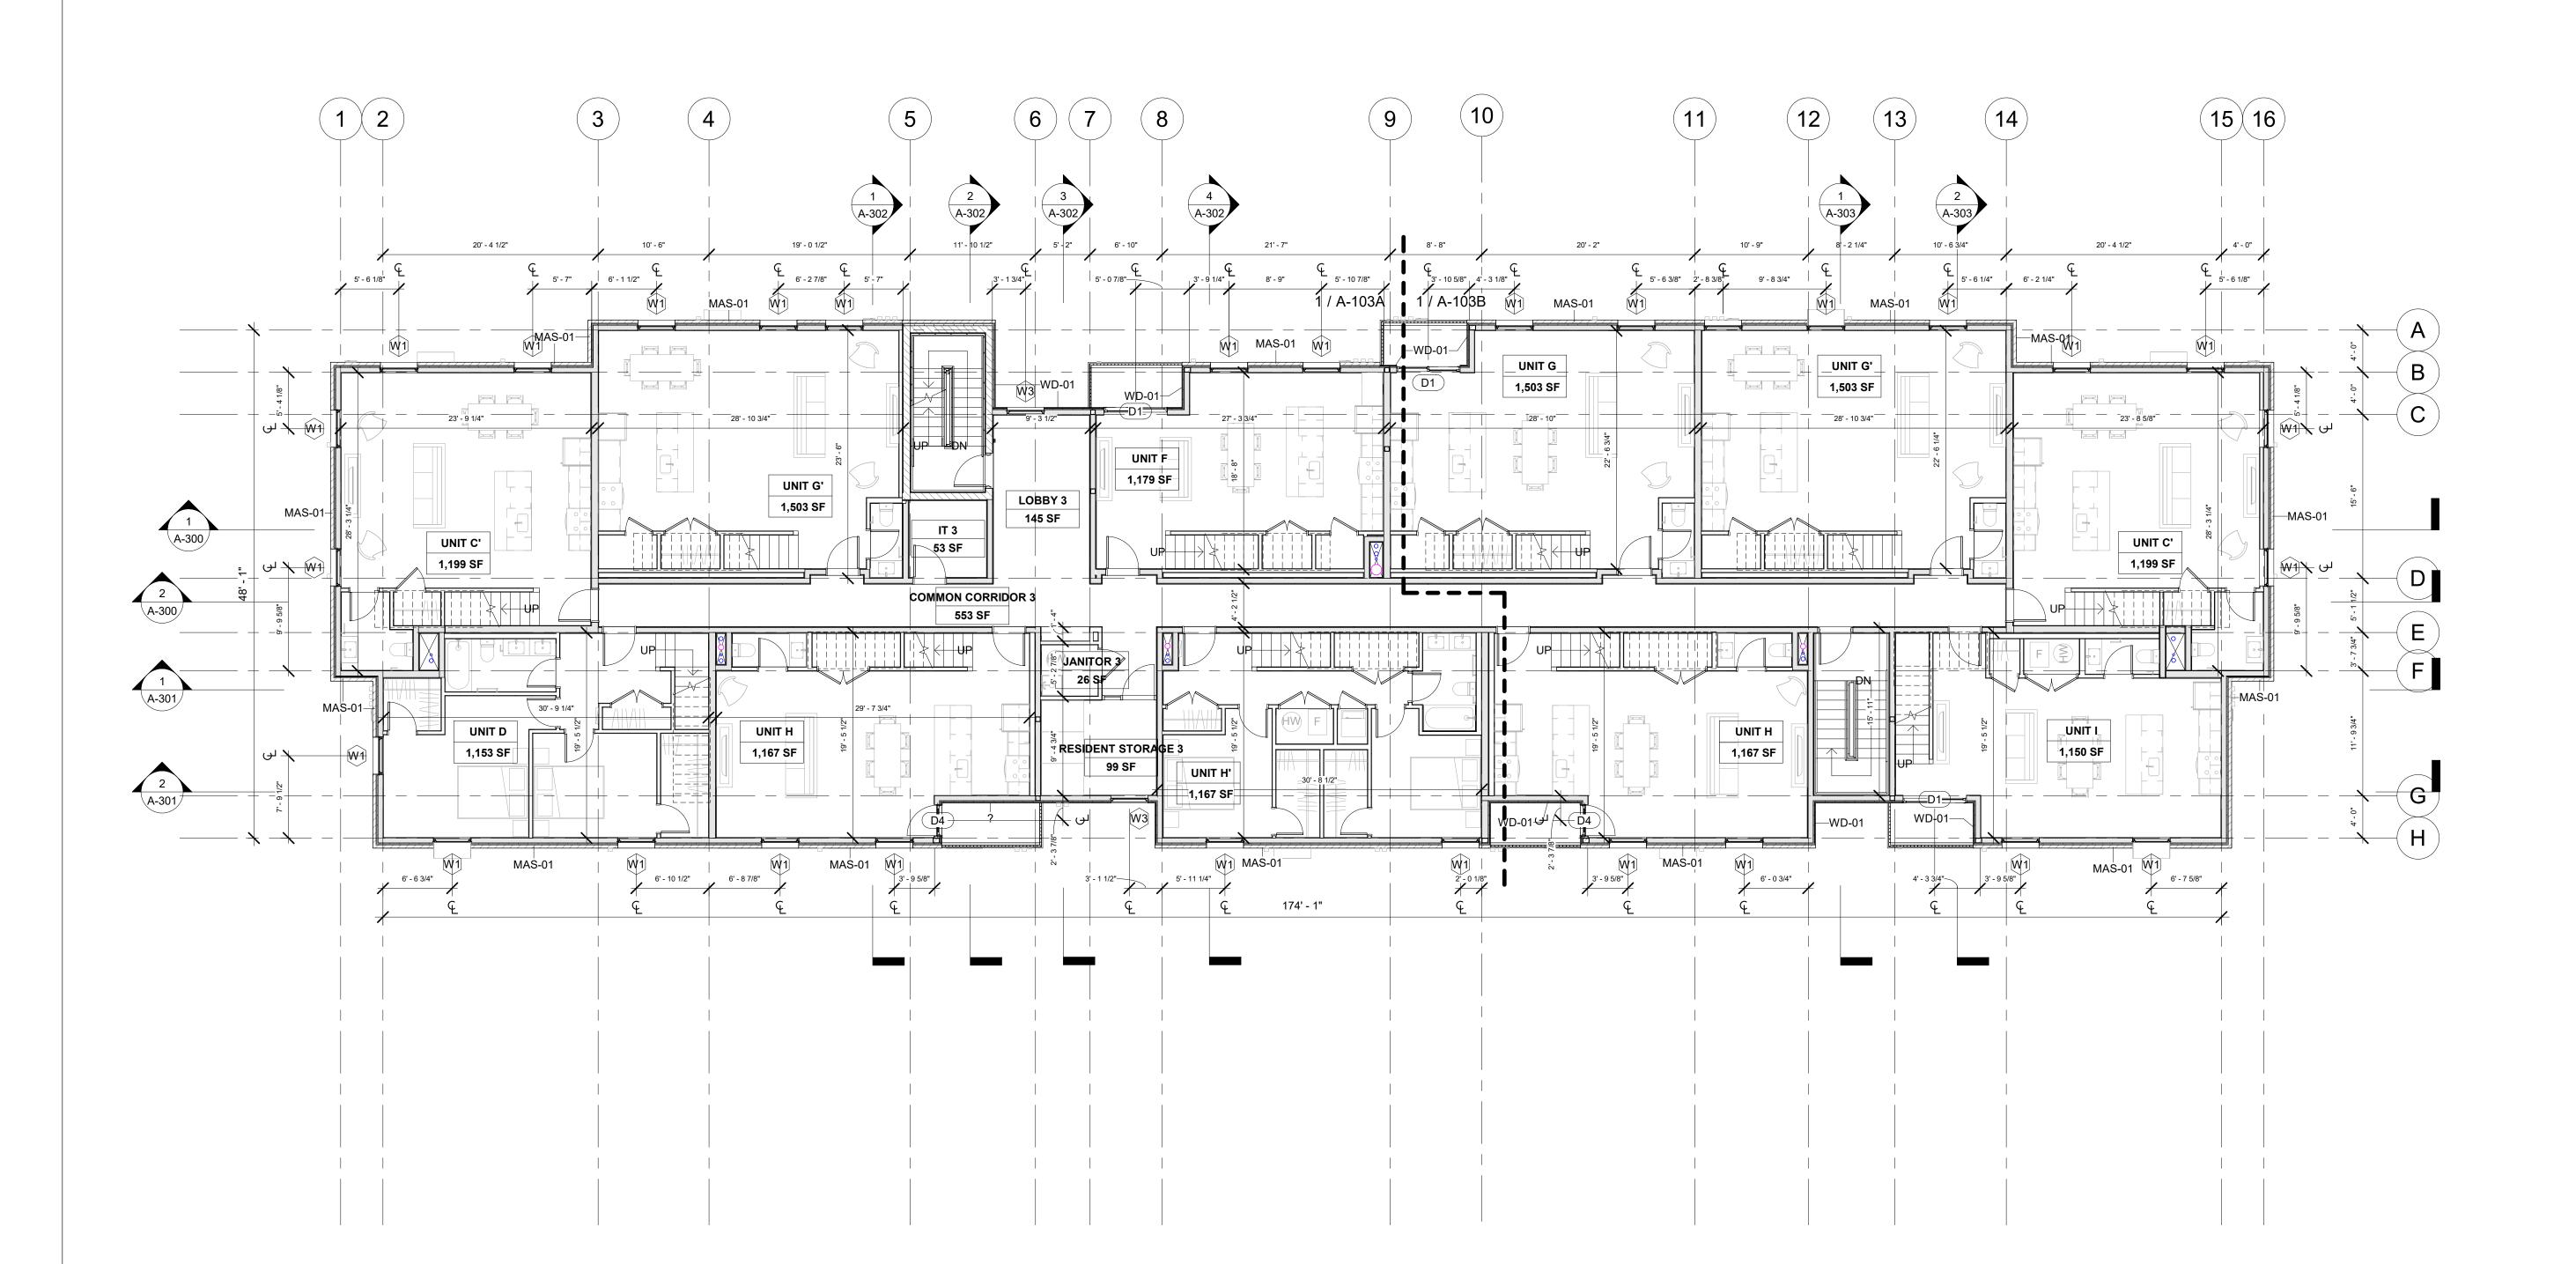


OVERALL FLOOR PLAN GENERAL NOTES

1. PROJECT BENCHMARK IS AT FIRST FLOOR TOP OF SLAB, T.O. SLAB = 2'-10 1/4" (ARCHITECTURAL, STRUCTURAL), VARIES (CIVIL) 2. SEE DETAILED GRADING PLANS OF THE BRUSH PARK PARCELS A & B SITE PLAN PACKAGE FOR FIRST FLOOR ELEVATION IN RELATIONSHIP TO ADJACENT SITE GRADE.

3. GRIDLINE IS AT FACE OF FOUNDATION WALLS, U.O.N. 4. DIMENSIONS ARE TO FACE OF STUD, U.O.N.

5. SEE ENLARGED PLANS FOR LAYOUT OF DWELLING UNITS 6. SEE A-500 & A-501 FOR EXTERIOR WALL CONSTRUCTION 7. FURNITURE N.I.C. AND SHOWN FOR REFERENCE ONLY

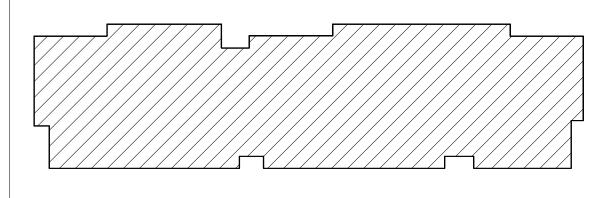

A103 KEY PLAN

REGISTRATION



OWNER BRUSH PARK DEVELOPMENT COMPANY PHASE 1 LLC 1092 WOODWARD AVE. DETROIT, MI 48226

ARCHITECT

MERGE ARCHITECTS, INC. 332 CONGRESS ST. FLOOR 6 BOSTON, MA 02210 T: 617.670.0265 STRUCTURAL ENGINEER

ENGINEERED STRUCTURES, LLC. 632 BARRY STREET SW GRANDVILLE, MI 49418 T: 616-667-9650

MP/FP ENGINEER SELLINGER ASSOCIATES, INC. 19821 FARMINGTON ROAD, LIVONIA, MI 48152 T: 248-482-0045 F: 248-482-0052

ELECTRICAL ENGINEER

ETS ENGINEERING, INC. P.O. BOX 1166 ROYAL OAK, MI 48068 418-1/2 S. WASHINGTON AVE, ROYAL OAK, MI 48067

CODE CONSULTANT

CODE RED CONSULTANTS 154 TURNPIKE ROAD, SUITE 200 SOUTHBOROUGH MA, 01772

John and **Duplette** d Place srush St. 48201 0

05/15/20: 100% CD / PERMIT SET

THE CONTRACTOR IS RESPONSIBLE FOR MATERIALS, DETAILS AND ACCURACY, FOR ALL QUANTITIES AND DIMENSIONS, FOR SELECTING FABRICATION PROCESSES, FOR TECHNIQUES OF ASSEMBLY, FOR PERFORMING WORK IN A SAFE MANNER, AND FOR COORDINATING **WORK WITH THAT OF ALL TRADES**


18284 JOB NO.: SCALE: As indicated

DATE: 05/15/2020

DRAWING TITLE

THIRD FLOOR PLAN

SHEET NO.

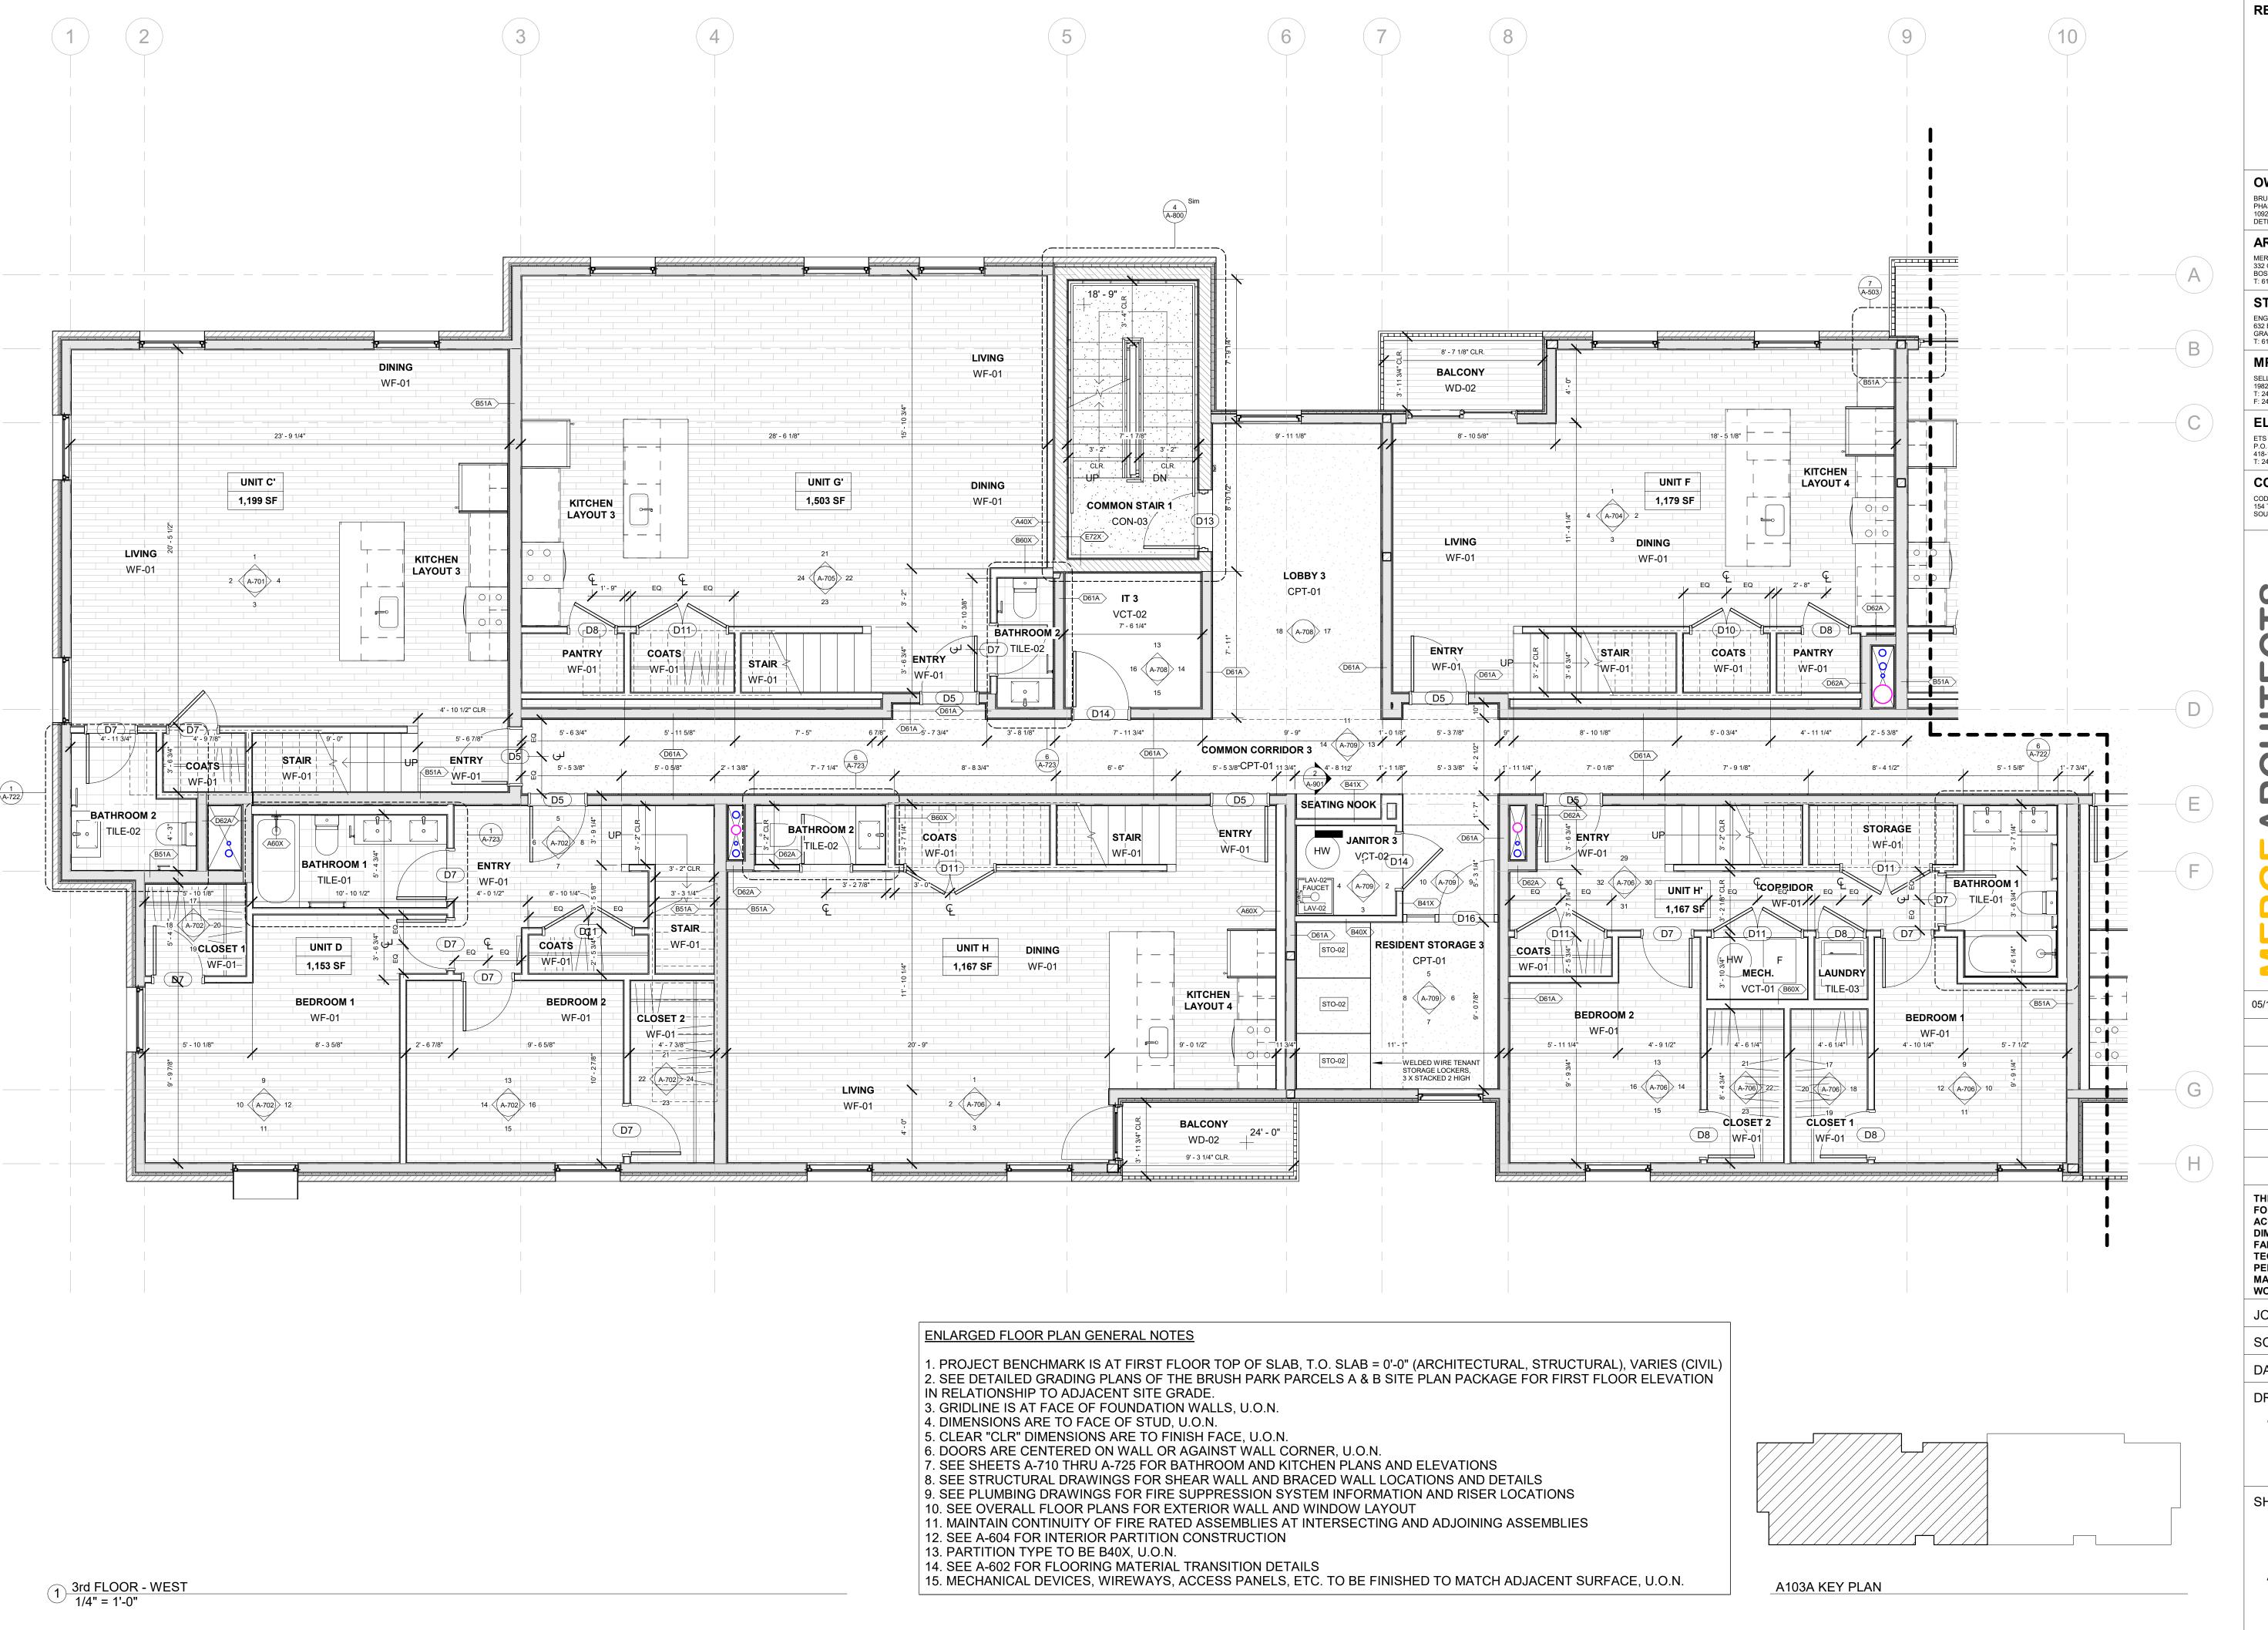



OWNER BRUSH PARK DEVELOPMENT COMPANY PHASE 1 LLC 1092 WOODWARD AVE.

ARCHITECT

MERGE ARCHITECTS, INC. 332 CONGRESS ST. FLOOR 6 BOSTON, MA 02210 T: 617.670.0265

STRUCTURAL ENGINEER ENGINEERED STRUCTURES, LLC. 632 BARRY STREET SW GRANDVILLE, MI 49418 T: 616-667-9650

MP/FP ENGINEER

SELLINGER ASSOCIATES, INC. 19821 FARMINGTON ROAD, LIVONIA, MI 48152 T: 248-482-0045 F: 248-482-0052

ELECTRICAL ENGINEER ETS ENGINEERING, INC. P.O. BOX 1166 ROYAL OAK, MI 48068 418-1/2 S. WASHINGTON AVE, ROYAL OAK, MI 48067

CODE CONSULTANT

CODE RED CONSULTANTS 154 TURNPIKE ROAD, SUITE 200 SOUTHBOROUGH MA, 01772

Duplette d Place trush St. 48201 0 dmur On Bet Det

05/15/20: 100% CD / PERMIT SET

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THE CONTRACTOR IS RESPONSIBLE FOR MATERIALS, DETAILS AND ACCURACY, FOR ALL QUANTITIES AND DIMENSIONS, FOR SELECTING **FABRICATION PROCESSES, FOR TECHNIQUES OF ASSEMBLY, FOR** PERFORMING WORK IN A SAFE MANNER, AND FOR COORDINATING WORK WITH THAT OF ALL TRADES

JOB NO.: SCALE:


As indicated

DATE: 05/15/2020 DRAWING TITLE

THIRD FLOOR PLAN -**WEST**

SHEET NO.

A-103A

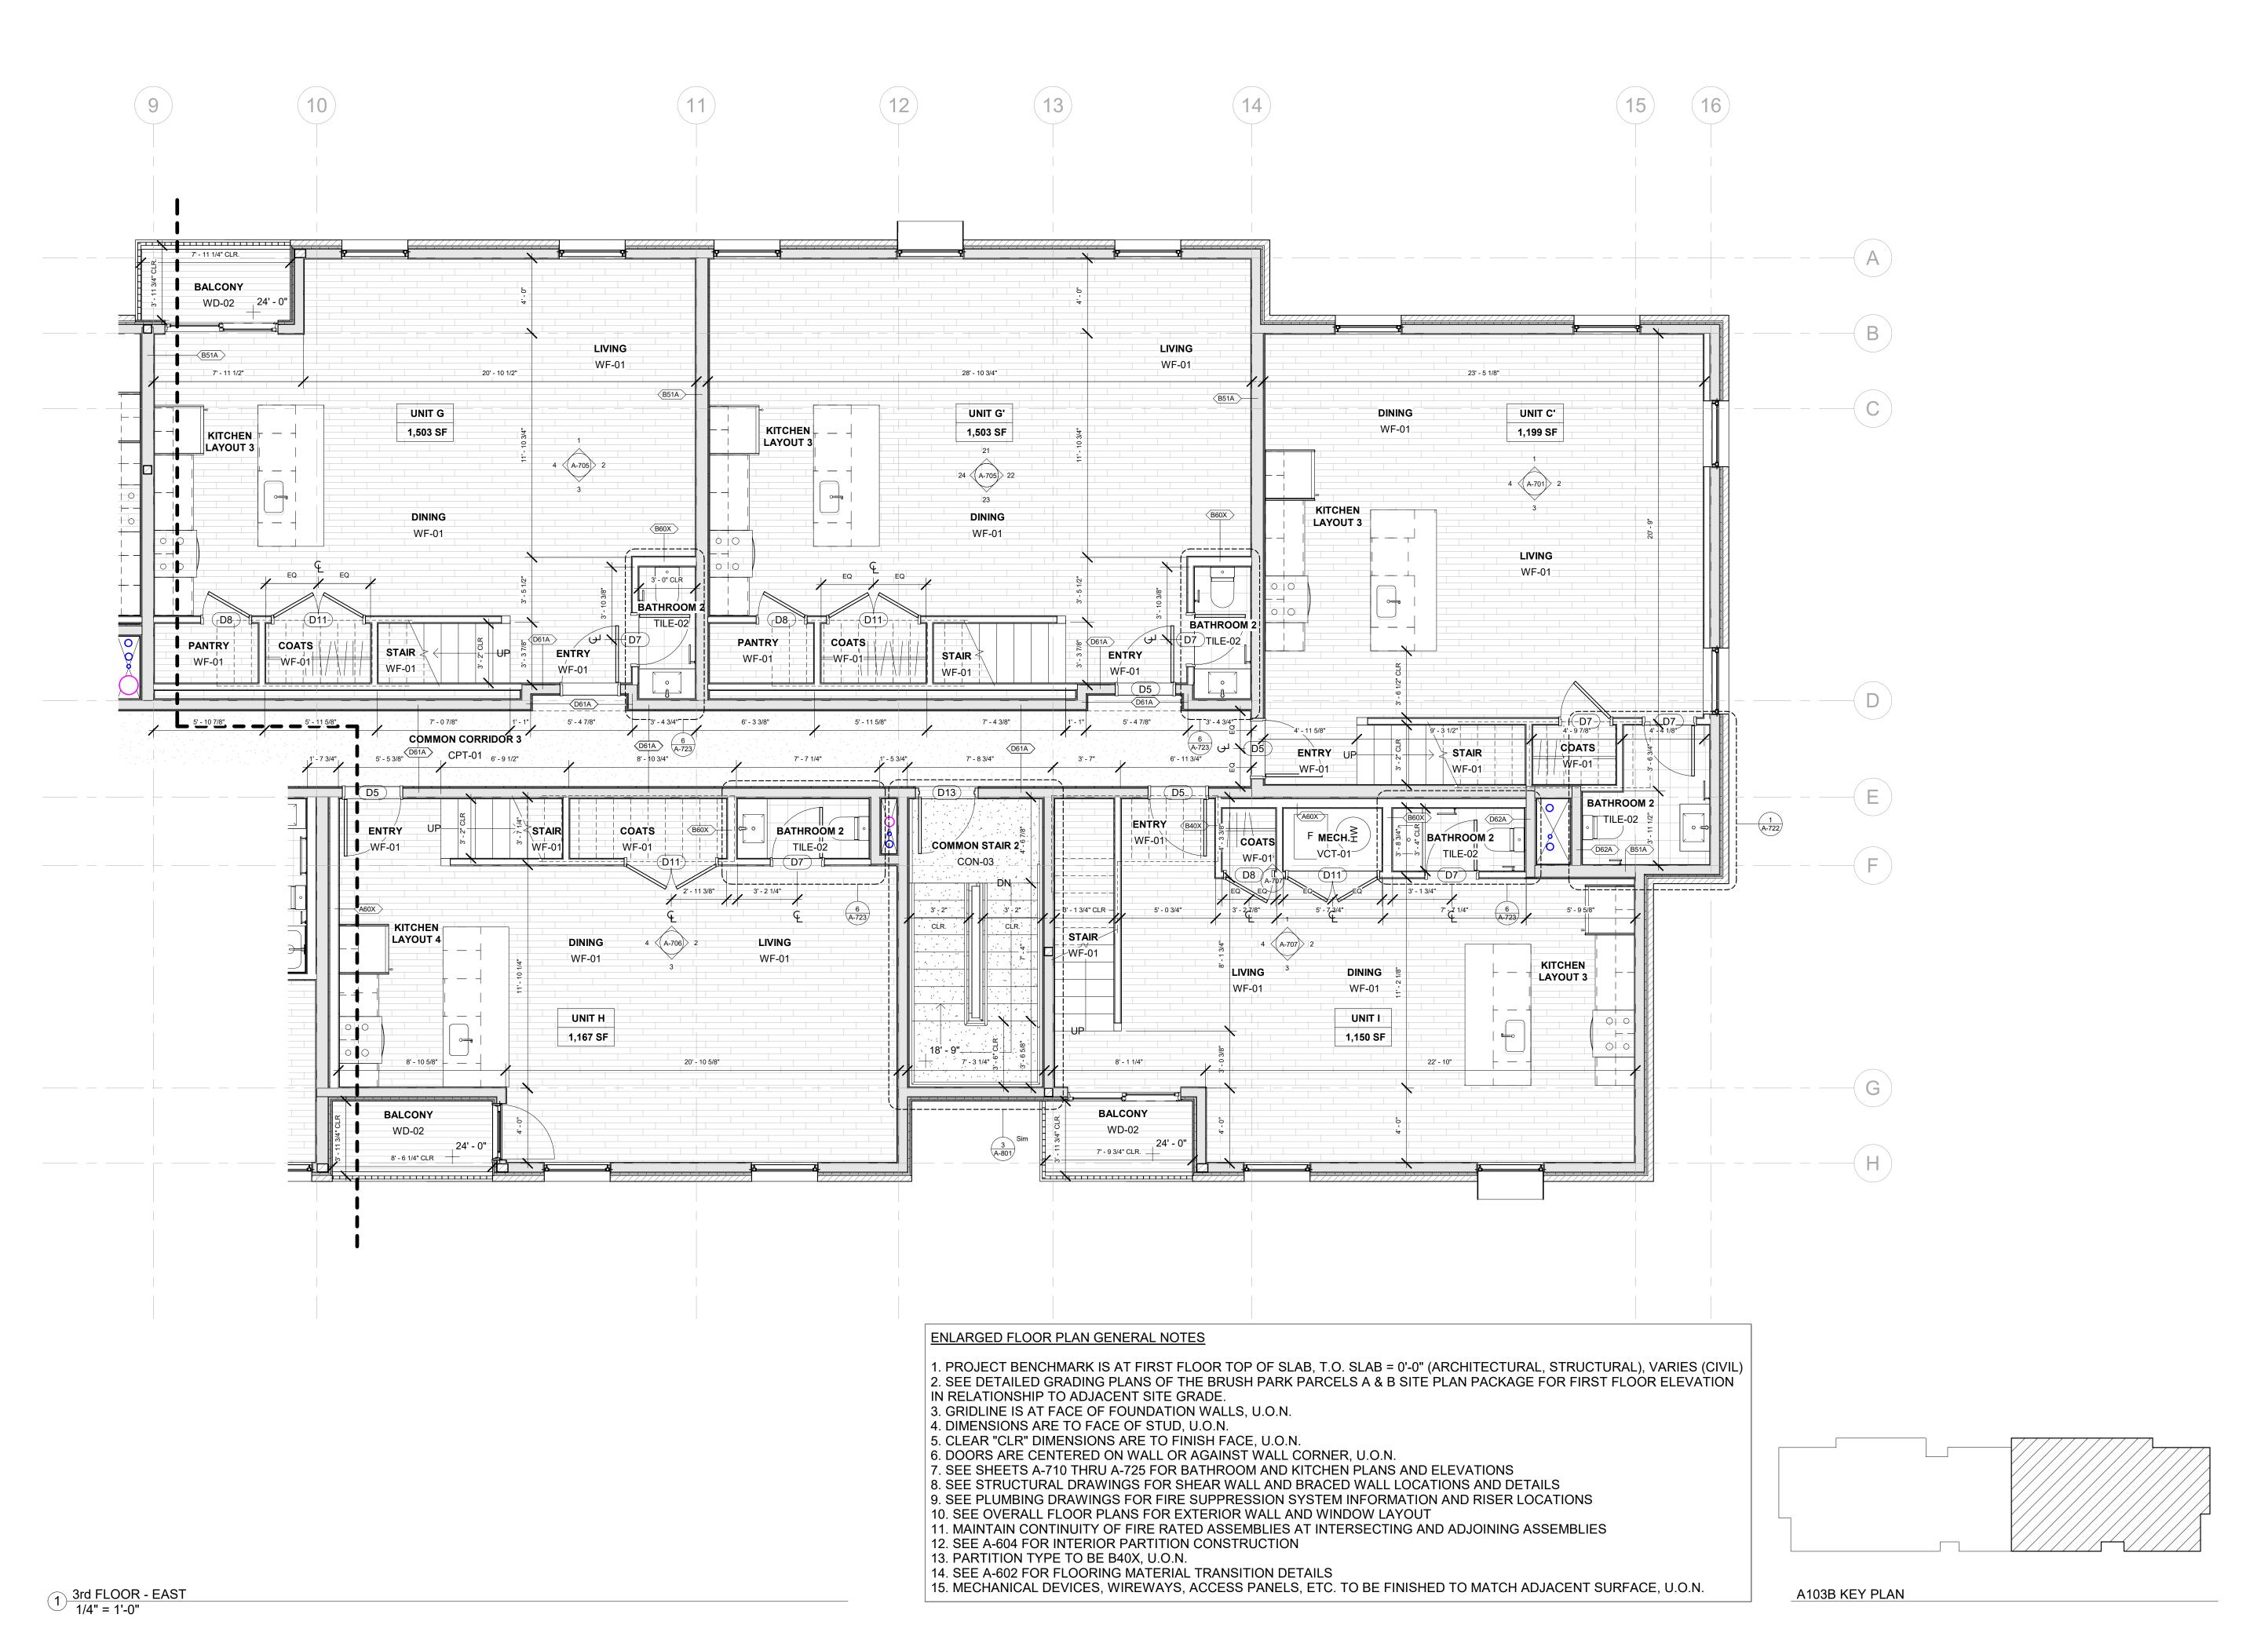



OWNER BRUSH PARK DEVELOPMENT COMPANY PHASE 1 LLC 1092 WOODWARD AVE.

ARCHITECT

DETROIT, MI 48226

MERGE ARCHITECTS, INC. 332 CONGRESS ST. FLOOR 6 BOSTON, MA 02210 T: 617.670.0265

STRUCTURAL ENGINEER ENGINEERED STRUCTURES, LLC. 632 BARRY STREET SW GRANDVILLE, MI 49418 T: 616-667-9650

MP/FP ENGINEER SELLINGER ASSOCIATES, INC. 19821 FARMINGTON ROAD, LIVONIA, MI 48152 T: 248-482-0045

F: 248-482-0052 ELECTRICAL ENGINEER

ETS ENGINEERING, INC. P.O. BOX 1166 ROYAL OAK, MI 48068 418-1/2 S. WASHINGTON AVE, ROYAL OAK, MI 48067

CODE CONSULTANT

CODE RED CONSULTANTS 154 TURNPIKE ROAD, SUITE 200 SOUTHBOROUGH MA, 01772

and **Duplette** Place ısh St. 8201 Q

05/15/20: 100% CD / PERMIT SET

THE CONTRACTOR IS RESPONSIBLE FOR MATERIALS, DETAILS AND ACCURACY, FOR ALL QUANTITIES AND DIMENSIONS, FOR SELECTING FABRICATION PROCESSES, FOR TECHNIQUES OF ASSEMBLY, FOR PERFORMING WORK IN A SAFE MANNER, AND FOR COORDINATING WORK WITH THAT OF ALL TRADES

JOB NO.:

As indicated


05/15/2020 DATE:

DRAWING TITLE

THIRD FLOOR PLAN -**EAST**

SHEET NO.

A-103B

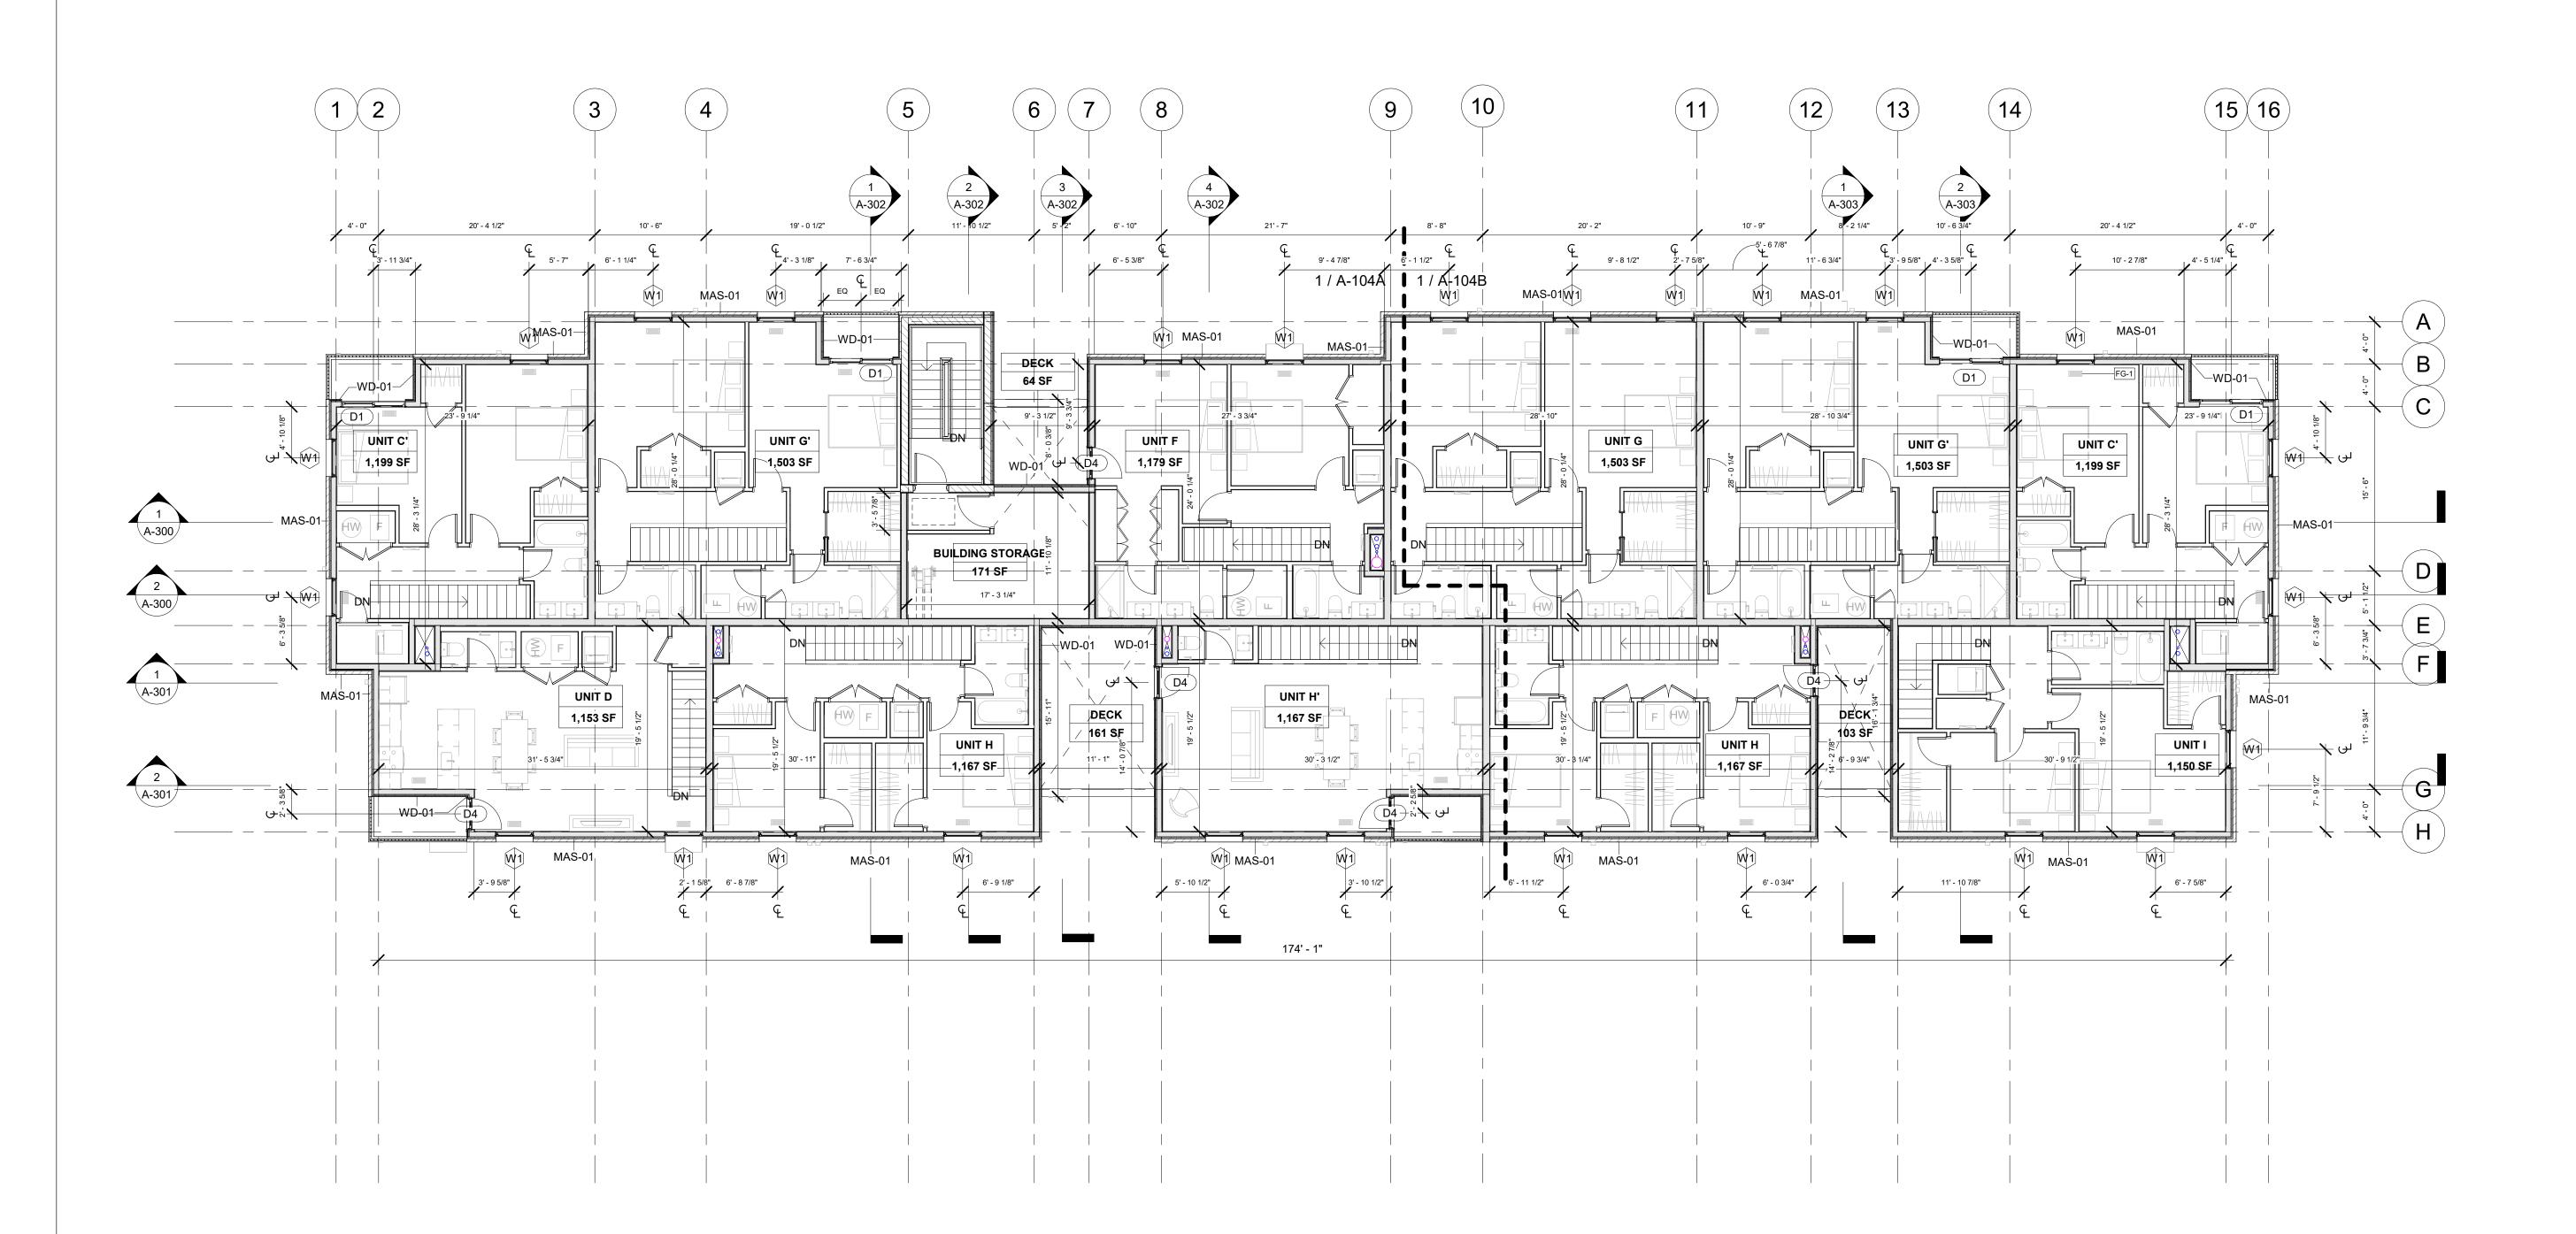


OVERALL FLOOR PLAN GENERAL NOTES

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3. GRIDLINE IS AT FACE OF FOUNDATION WALLS, U.O.N.

4. DIMENSIONS ARE TO FACE OF STUD, U.O.N. 5. SEE ENLARGED PLANS FOR LAYOUT OF DWELLING UNITS

6. SEE A-500 & A-501 FOR EXTERIOR WALL CONSTRUCTION 7. FURNITURE N.I.C. AND SHOWN FOR REFERENCE ONLY

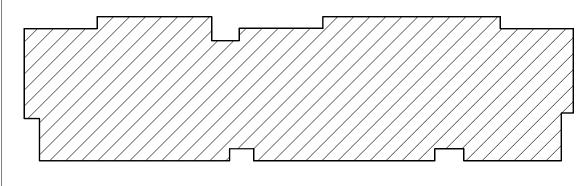

A104 KEY PLAN

ELIZABETH LEE ARCHITEOT No.

OWNER BRUSH PARK DEVELOPMENT COMPANY PHASE 1 LLC 1092 WOODWARD AVE. DETROIT, MI 48226

REGISTRATION

ARCHITECT MERGE ARCHITECTS, INC. 332 CONGRESS ST. FLOOR 6 BOSTON, MA 02210 T: 617.670.0265

STRUCTURAL ENGINEER ENGINEERED STRUCTURES, LLC. 632 BARRY STREET SW GRANDVILLE, MI 49418 T: 616-667-9650

MP/FP ENGINEER

SELLINGER ASSOCIATES, INC. 19821 FARMINGTON ROAD, LIVONIA, MI 48152 T: 248-482-0045 F: 248-482-0052

ELECTRICAL ENGINEER ETS ENGINEERING, INC. P.O. BOX 1166 ROYAL OAK, MI 48068 418-1/2 S. WASHINGTON AVE, ROYAL OAK, MI 48067

CODE CONSULTANT

CODE RED CONSULTANTS 154 TURNPIKE ROAD, SUITE 200 SOUTHBOROUGH MA, 01772

John and **Duplette** d Place trush St. 48201 р

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05/15/20: 100% CD / PERMIT SET

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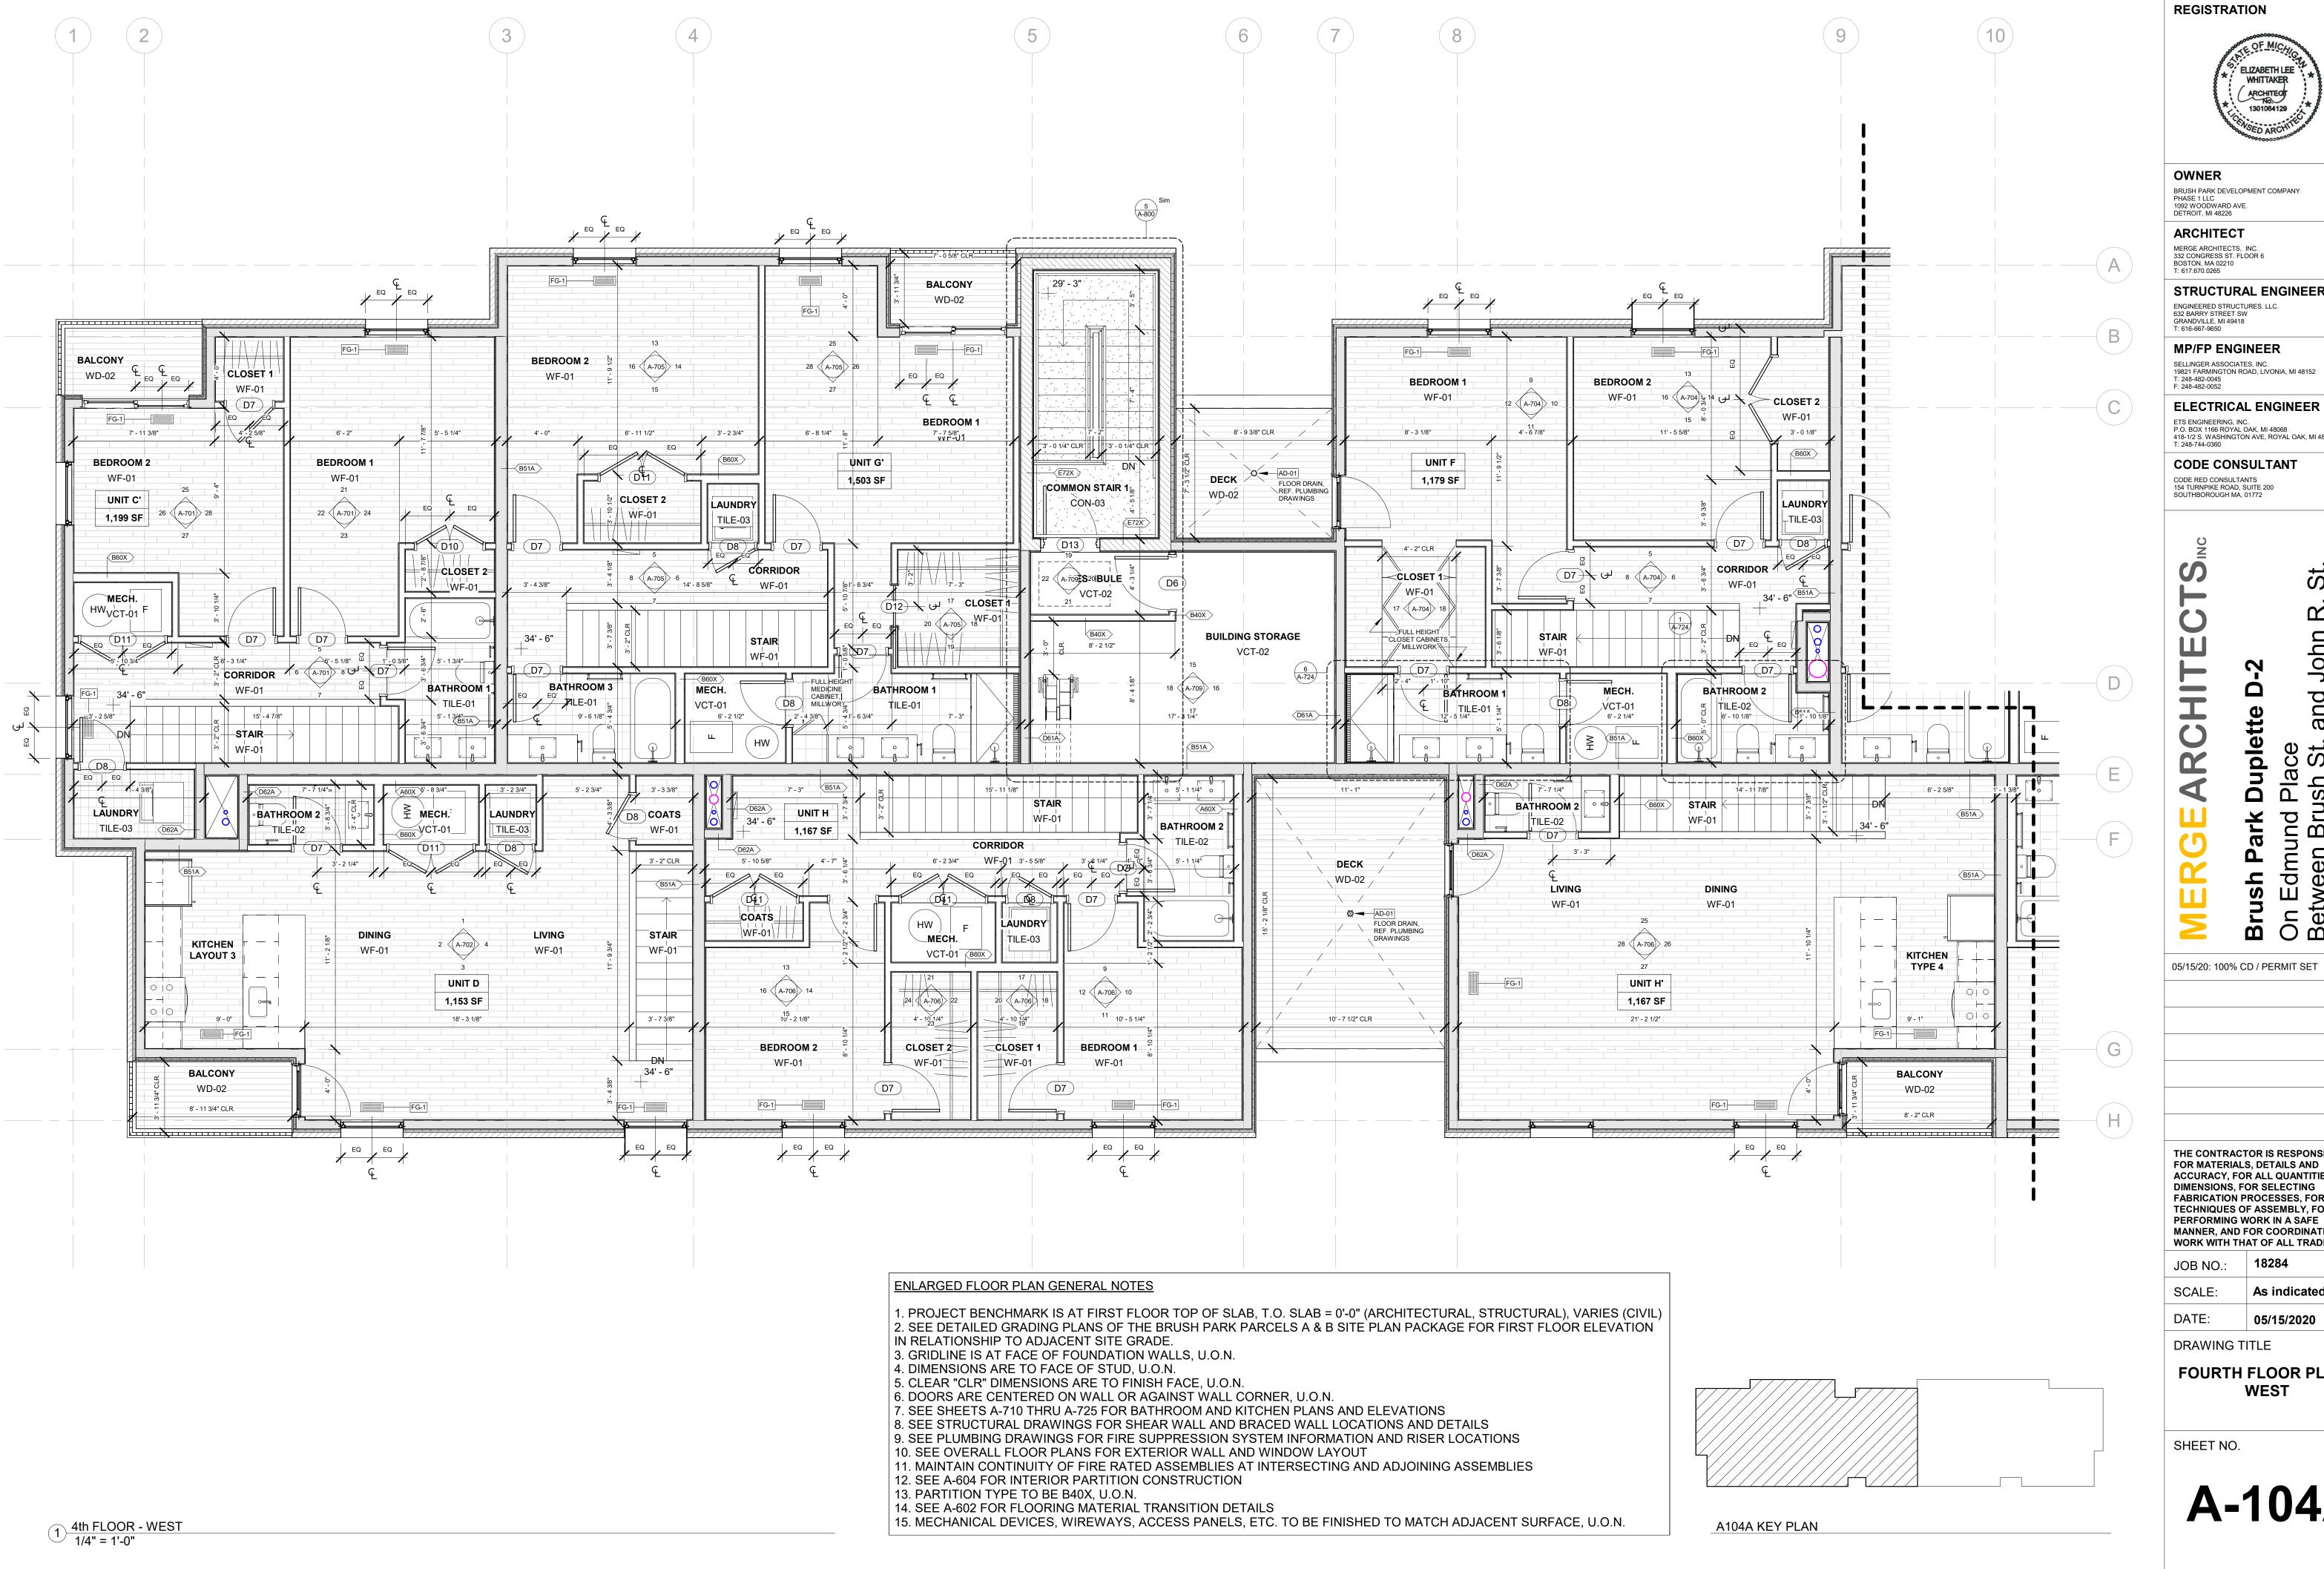
18284 JOB NO.: SCALE: As indicated

DATE: 05/15/2020

DRAWING TITLE

FOURTH FLOOR PLAN

SHEET NO.





OWNER BRUSH PARK DEVELOPMENT COMPANY PHASE 1 LLC 1092 WOODWARD AVE.

ARCHITECT MERGE ARCHITECTS, INC. 332 CONGRESS ST. FLOOR 6 BOSTON, 000210

STRUCTURAL ENGINEER ENGINEERED STRUCTURES, LLC.

MP/FP ENGINEER SELLINGER ASSOCIATES, INC.

19821 FARMINGTON ROAD, LIVONIA, MI 48152 T: 248-482-0045 F: 248-482-0052 **ELECTRICAL ENGINEER**

ETS ENGINEERING, INC. P.O. BOX 1166 ROYAL OAK, MI 48068 418-1/2 S. WASHINGTON AVE, ROYAL OAK, MI 48067

CODE CONSULTANT

CODE RED CONSULTANTS 154 TURNPIKE ROAD, SUITE 200 SOUTHBOROUGH MA, 01772

Duplette St. <u>Pla</u> 0


THE CONTRACTOR IS RESPONSIBLE FOR MATERIALS, DETAILS AND ACCURACY, FOR ALL QUANTITIES AND DIMENSIONS, FOR SELECTING **FABRICATION PROCESSES, FOR TECHNIQUES OF ASSEMBLY, FOR** PERFORMING WORK IN A SAFE MANNER, AND FOR COORDINATING WORK WITH THAT OF ALL TRADES

JOB NO.: As indicated SCALE:

05/15/2020 DATE:

FOURTH FLOOR PLAN -WEST

A-104A

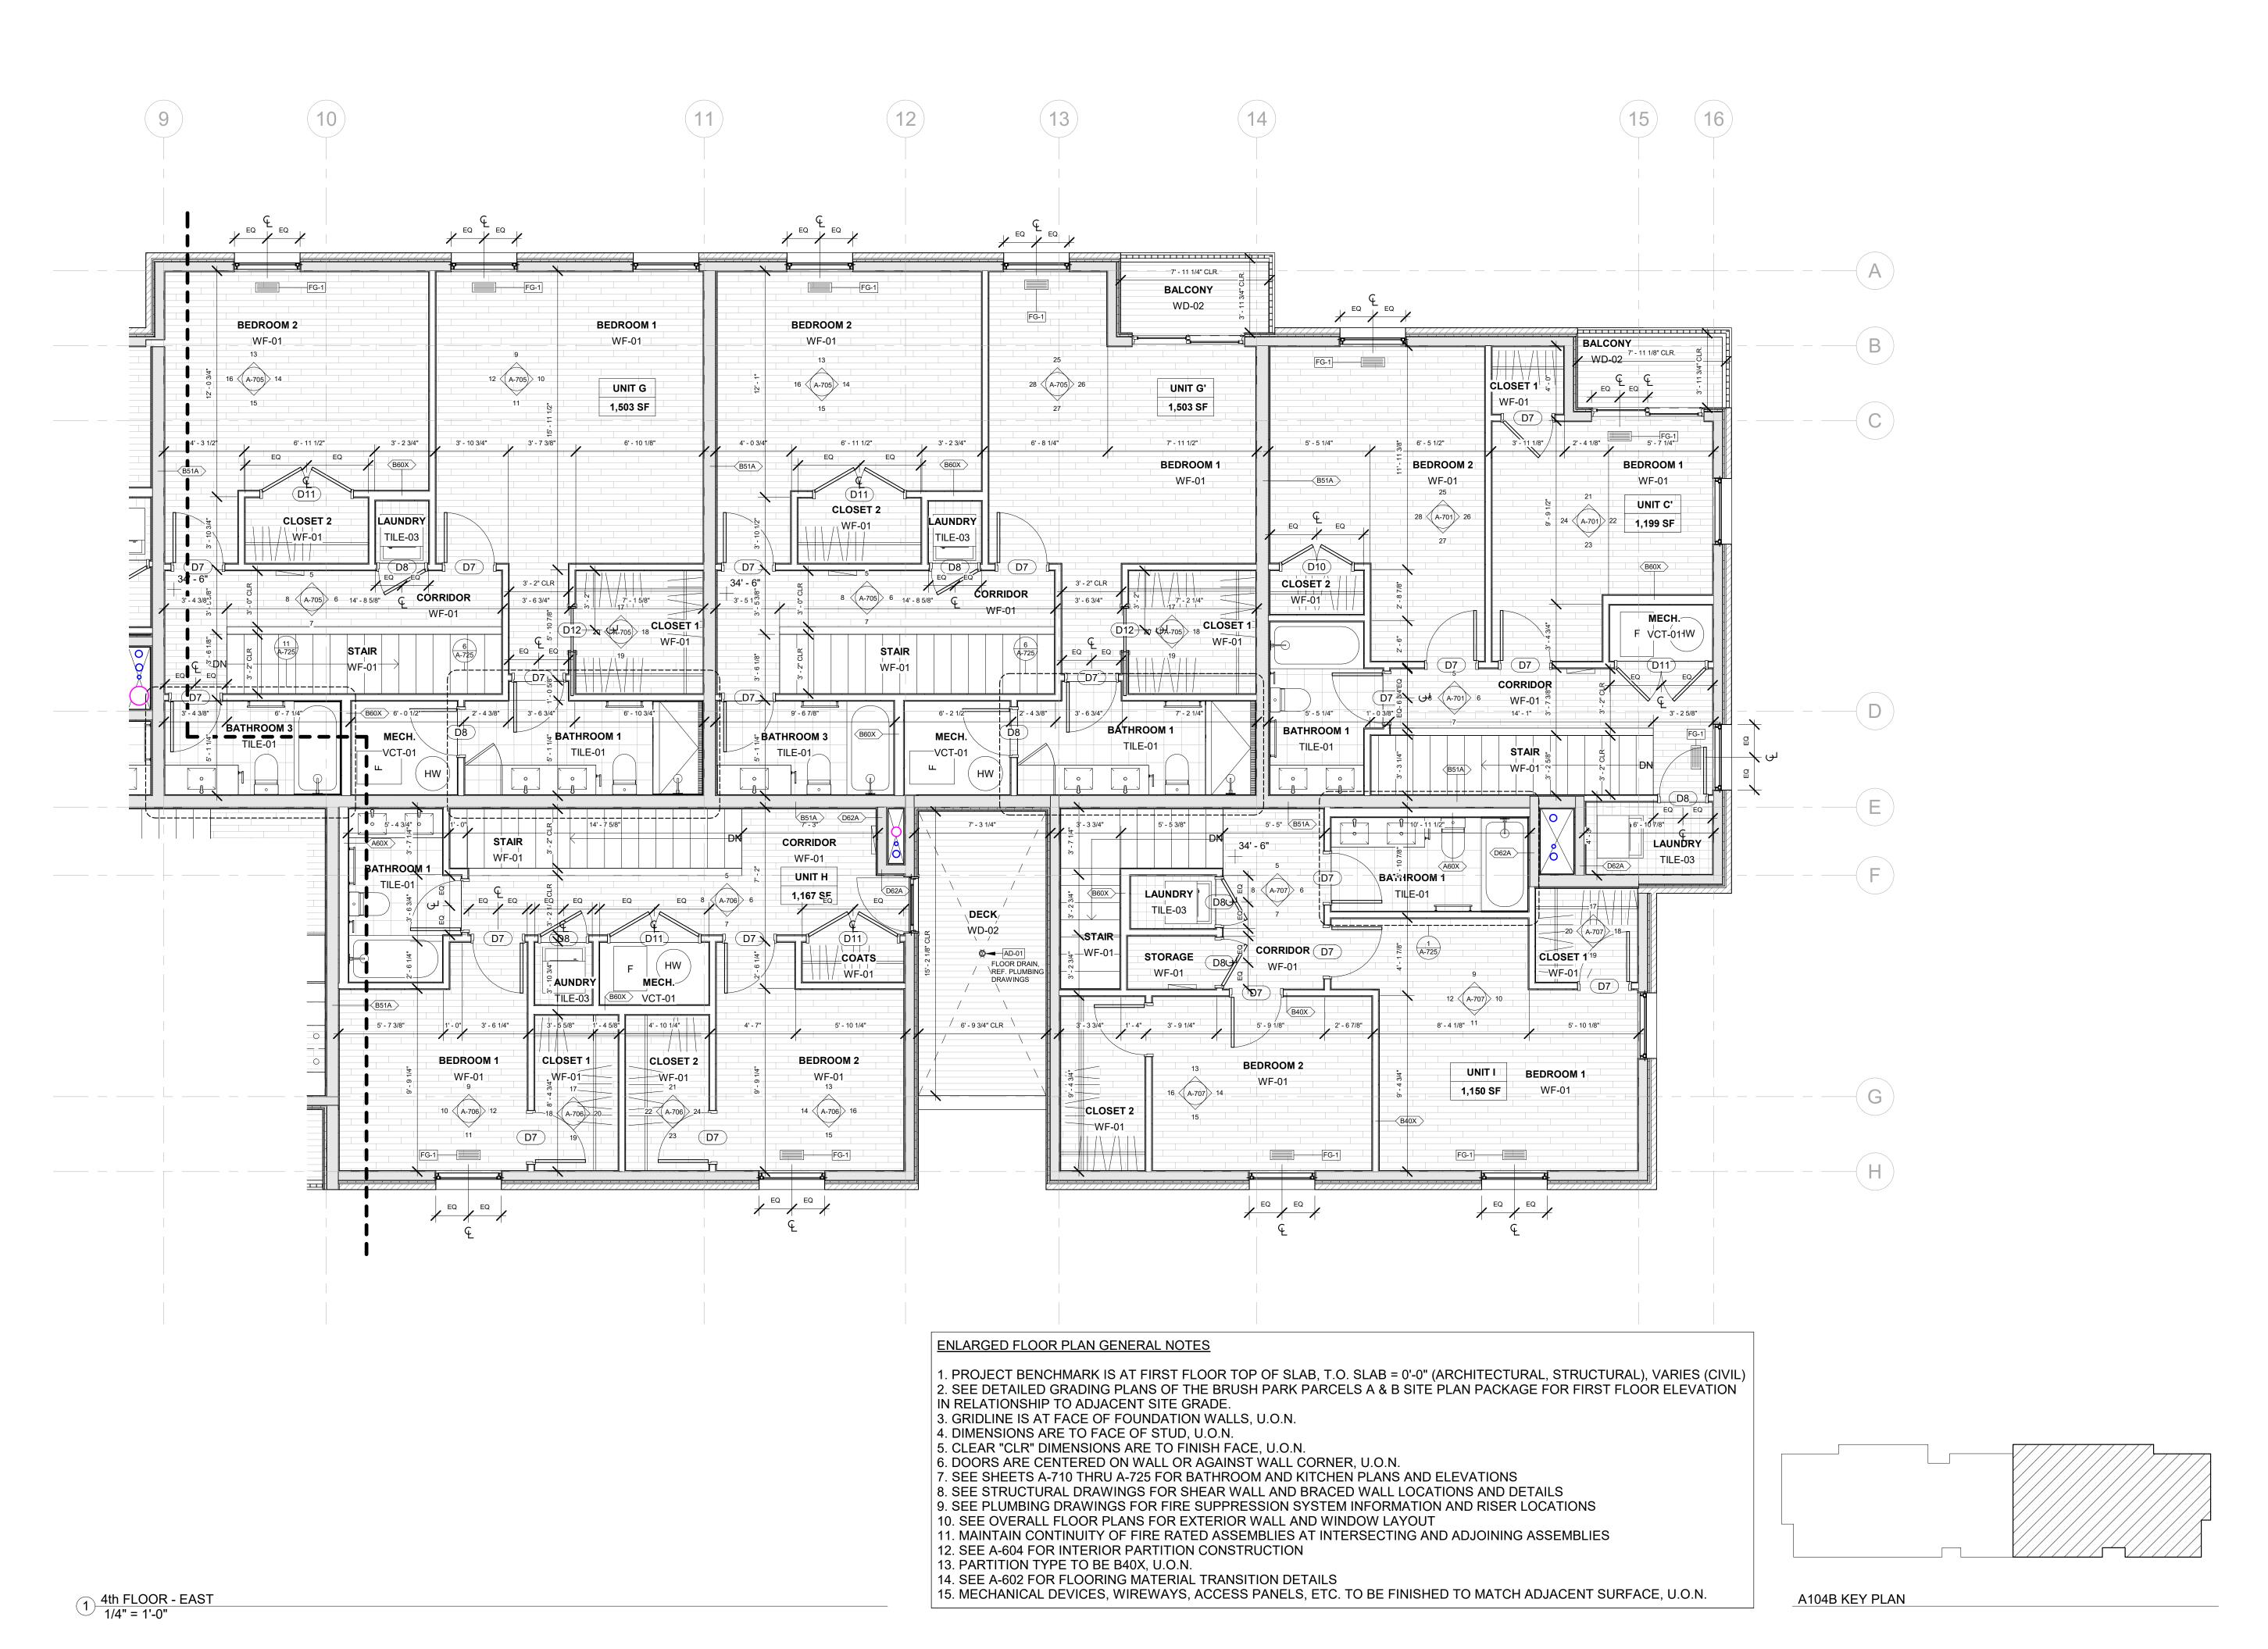



OWNER BRUSH PARK DEVELOPMENT COMPANY PHASE 1 LLC 1092 WOODWARD AVE.

ARCHITECT

DETROIT, MI 48226

MERGE ARCHITECTS, INC. 332 CONGRESS ST. FLOOR 6 BOSTON, MA 02210 T: 617.670.0265

STRUCTURAL ENGINEER ENGINEERED STRUCTURES, LLC. 632 BARRY STREET SW GRANDVILLE, MI 49418 T: 616-667-9650

MP/FP ENGINEER SELLINGER ASSOCIATES, INC.

19821 FARMINGTON ROAD, LIVONIA, MI 48152 T: 248-482-0045 F: 248-482-0052

ELECTRICAL ENGINEER ETS ENGINEERING, INC. P.O. BOX 1166 ROYAL OAK, MI 48068 418-1/2 S. WASHINGTON AVE, ROYAL OAK, MI 48067

CODE CONSULTANT

CODE RED CONSULTANTS 154 TURNPIKE ROAD, SUITE 200 SOUTHBOROUGH MA, 01772

and **Duplette** 0

On Bet Det

05/15/20: 100% CD / PERMIT SET

THE CONTRACTOR IS RESPONSIBLE FOR MATERIALS, DETAILS AND ACCURACY, FOR ALL QUANTITIES AND DIMENSIONS, FOR SELECTING FABRICATION PROCESSES, FOR **TECHNIQUES OF ASSEMBLY, FOR** PERFORMING WORK IN A SAFE MANNER, AND FOR COORDINATING WORK WITH THAT OF ALL TRADES

JOB NO.:


As indicated DATE: 05/15/2020

DRAWING TITLE

FOURTH FLOOR PLAN -EAST

SHEET NO.

A-104B

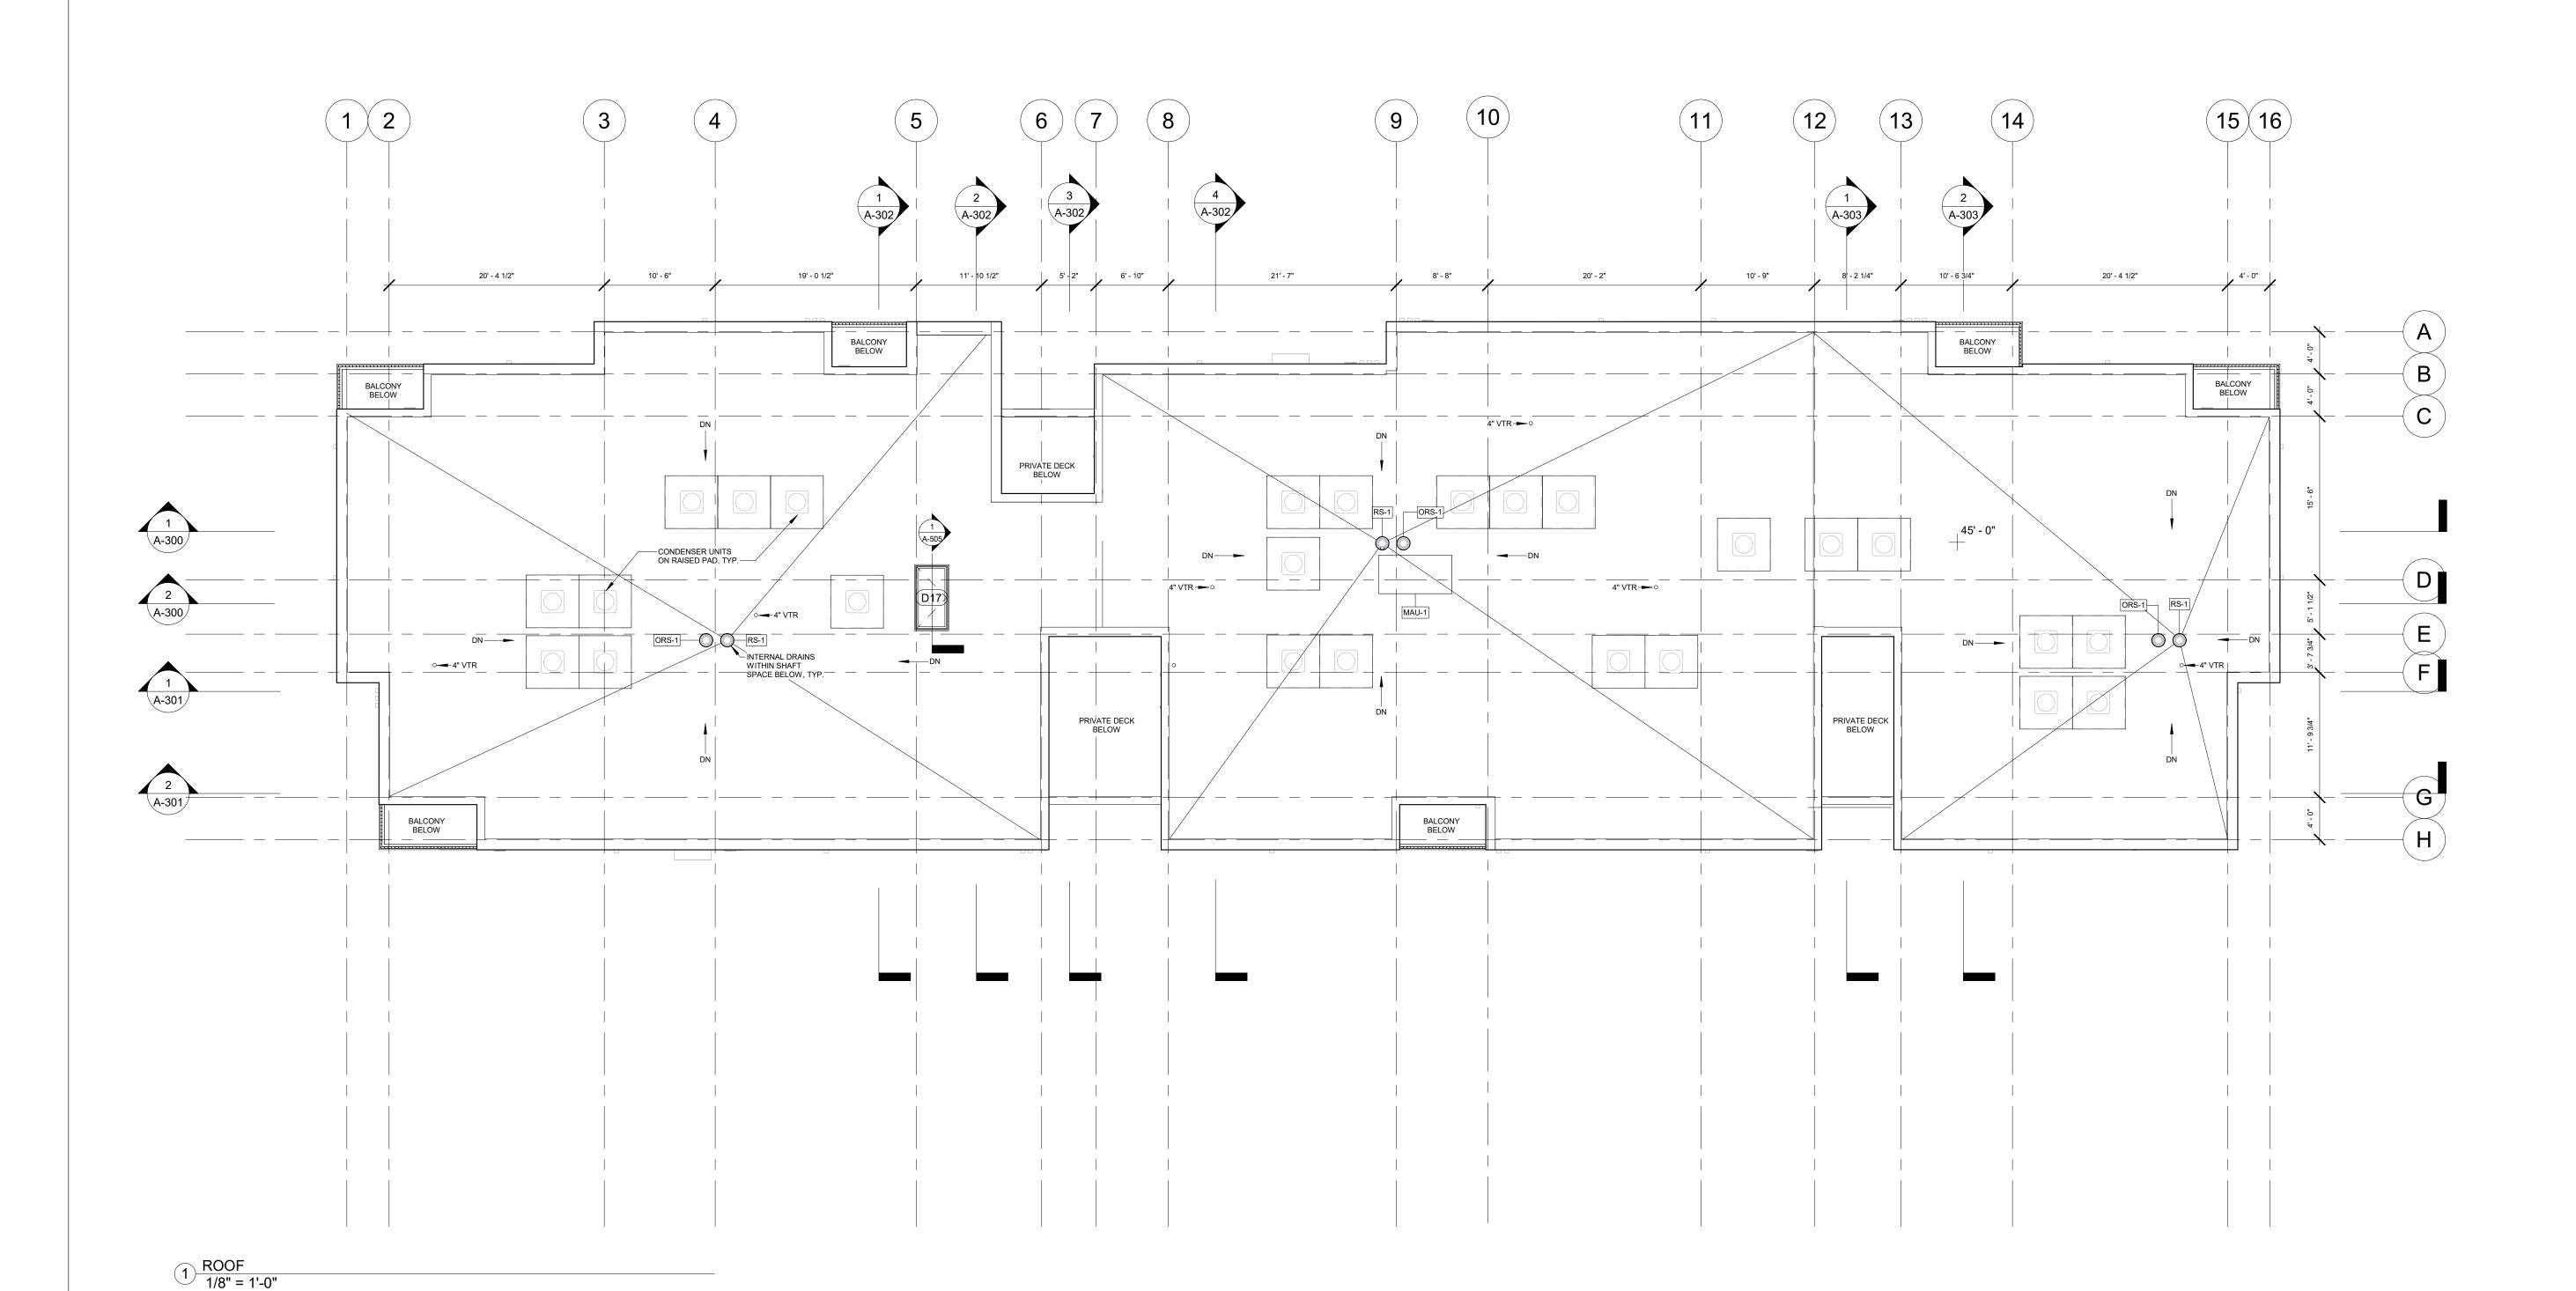


OVERALL FLOOR PLAN GENERAL NOTES

1. PROJECT BENCHMARK IS AT FIRST FLOOR TOP OF SLAB, T.O. SLAB = 2'-10 1/4" (ARCHITECTURAL, STRUCTURAL), VARIES (CIVIL) 2. SEE DETAILED GRADING PLANS OF THE BRUSH PARK PARCELS A & B SITE PLAN PACKAGE FOR FIRST FLOOR ELEVATION IN RELATIONSHIP TO ADJACENT SITE GRADE.

3. GRIDLINE IS AT FACE OF FOUNDATION WALLS, U.O.N.

4. DIMENSIONS ARE TO FACE OF STUD, U.O.N. 5. SEE ENLARGED PLANS FOR LAYOUT OF DWELLING UNITS 6. SEE A-500 & A-501 FOR EXTERIOR WALL CONSTRUCTION 7. FURNITURE N.I.C. AND SHOWN FOR REFERENCE ONLY

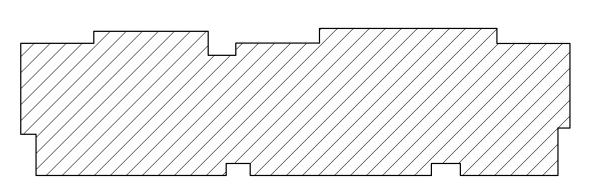

ROOF KEY PLAN

REGISTRATION



OWNER BRUSH PARK DEVELOPMENT COMPANY

PHASE 1 LLC 1092 WOODWARD AVE. DETROIT, MI 48226

ARCHITECT MERGE ARCHITECTS, INC. 332 CONGRESS ST. FLOOR 6 BOSTON, MA 02210 T: 617.670.0265

STRUCTURAL ENGINEER ENGINEERED STRUCTURES, LLC. 632 BARRY STREET SW GRANDVILLE, MI 49418 T: 616-667-9650

MP/FP ENGINEER

SELLINGER ASSOCIATES, INC. 19821 FARMINGTON ROAD, LIVONIA, MI 48152 T: 248-482-0045 F: 248-482-0052

ELECTRICAL ENGINEER ETS ENGINEERING, INC. P.O. BOX 1166 ROYAL OAK, MI 48068 418-1/2 S. WASHINGTON AVE, ROYAL OAK, MI 48067

CODE CONSULTANT

CODE RED CONSULTANTS 154 TURNPIKE ROAD, SUITE 200 SOUTHBOROUGH MA, 01772

and Duplette On Edmund Place Setween Brush St. & Detroit MI, 48201 O $\tilde{\Omega}$ $\tilde{\Omega}$

05/15/20: 100% CD / PERMIT SET

THE CONTRACTOR IS RESPONSIBLE
FOR MATERIALS, DETAILS AND
ACCURACY, FOR ALL QUANTITIES AND
DIMENSIONS, FOR SELECTING
FABRICATION PROCESSES, FOR TECHNIQUES OF ASSEMBLY, FOR PERFORMING WORK IN A SAFE MANNER, AND FOR COORDINATING WORK WITH THAT OF ALL TRADES


18284 JOB NO.: SCALE: As indicated

05/15/2020 DATE:

DRAWING TITLE

ROOF PLAN

SHEET NO.

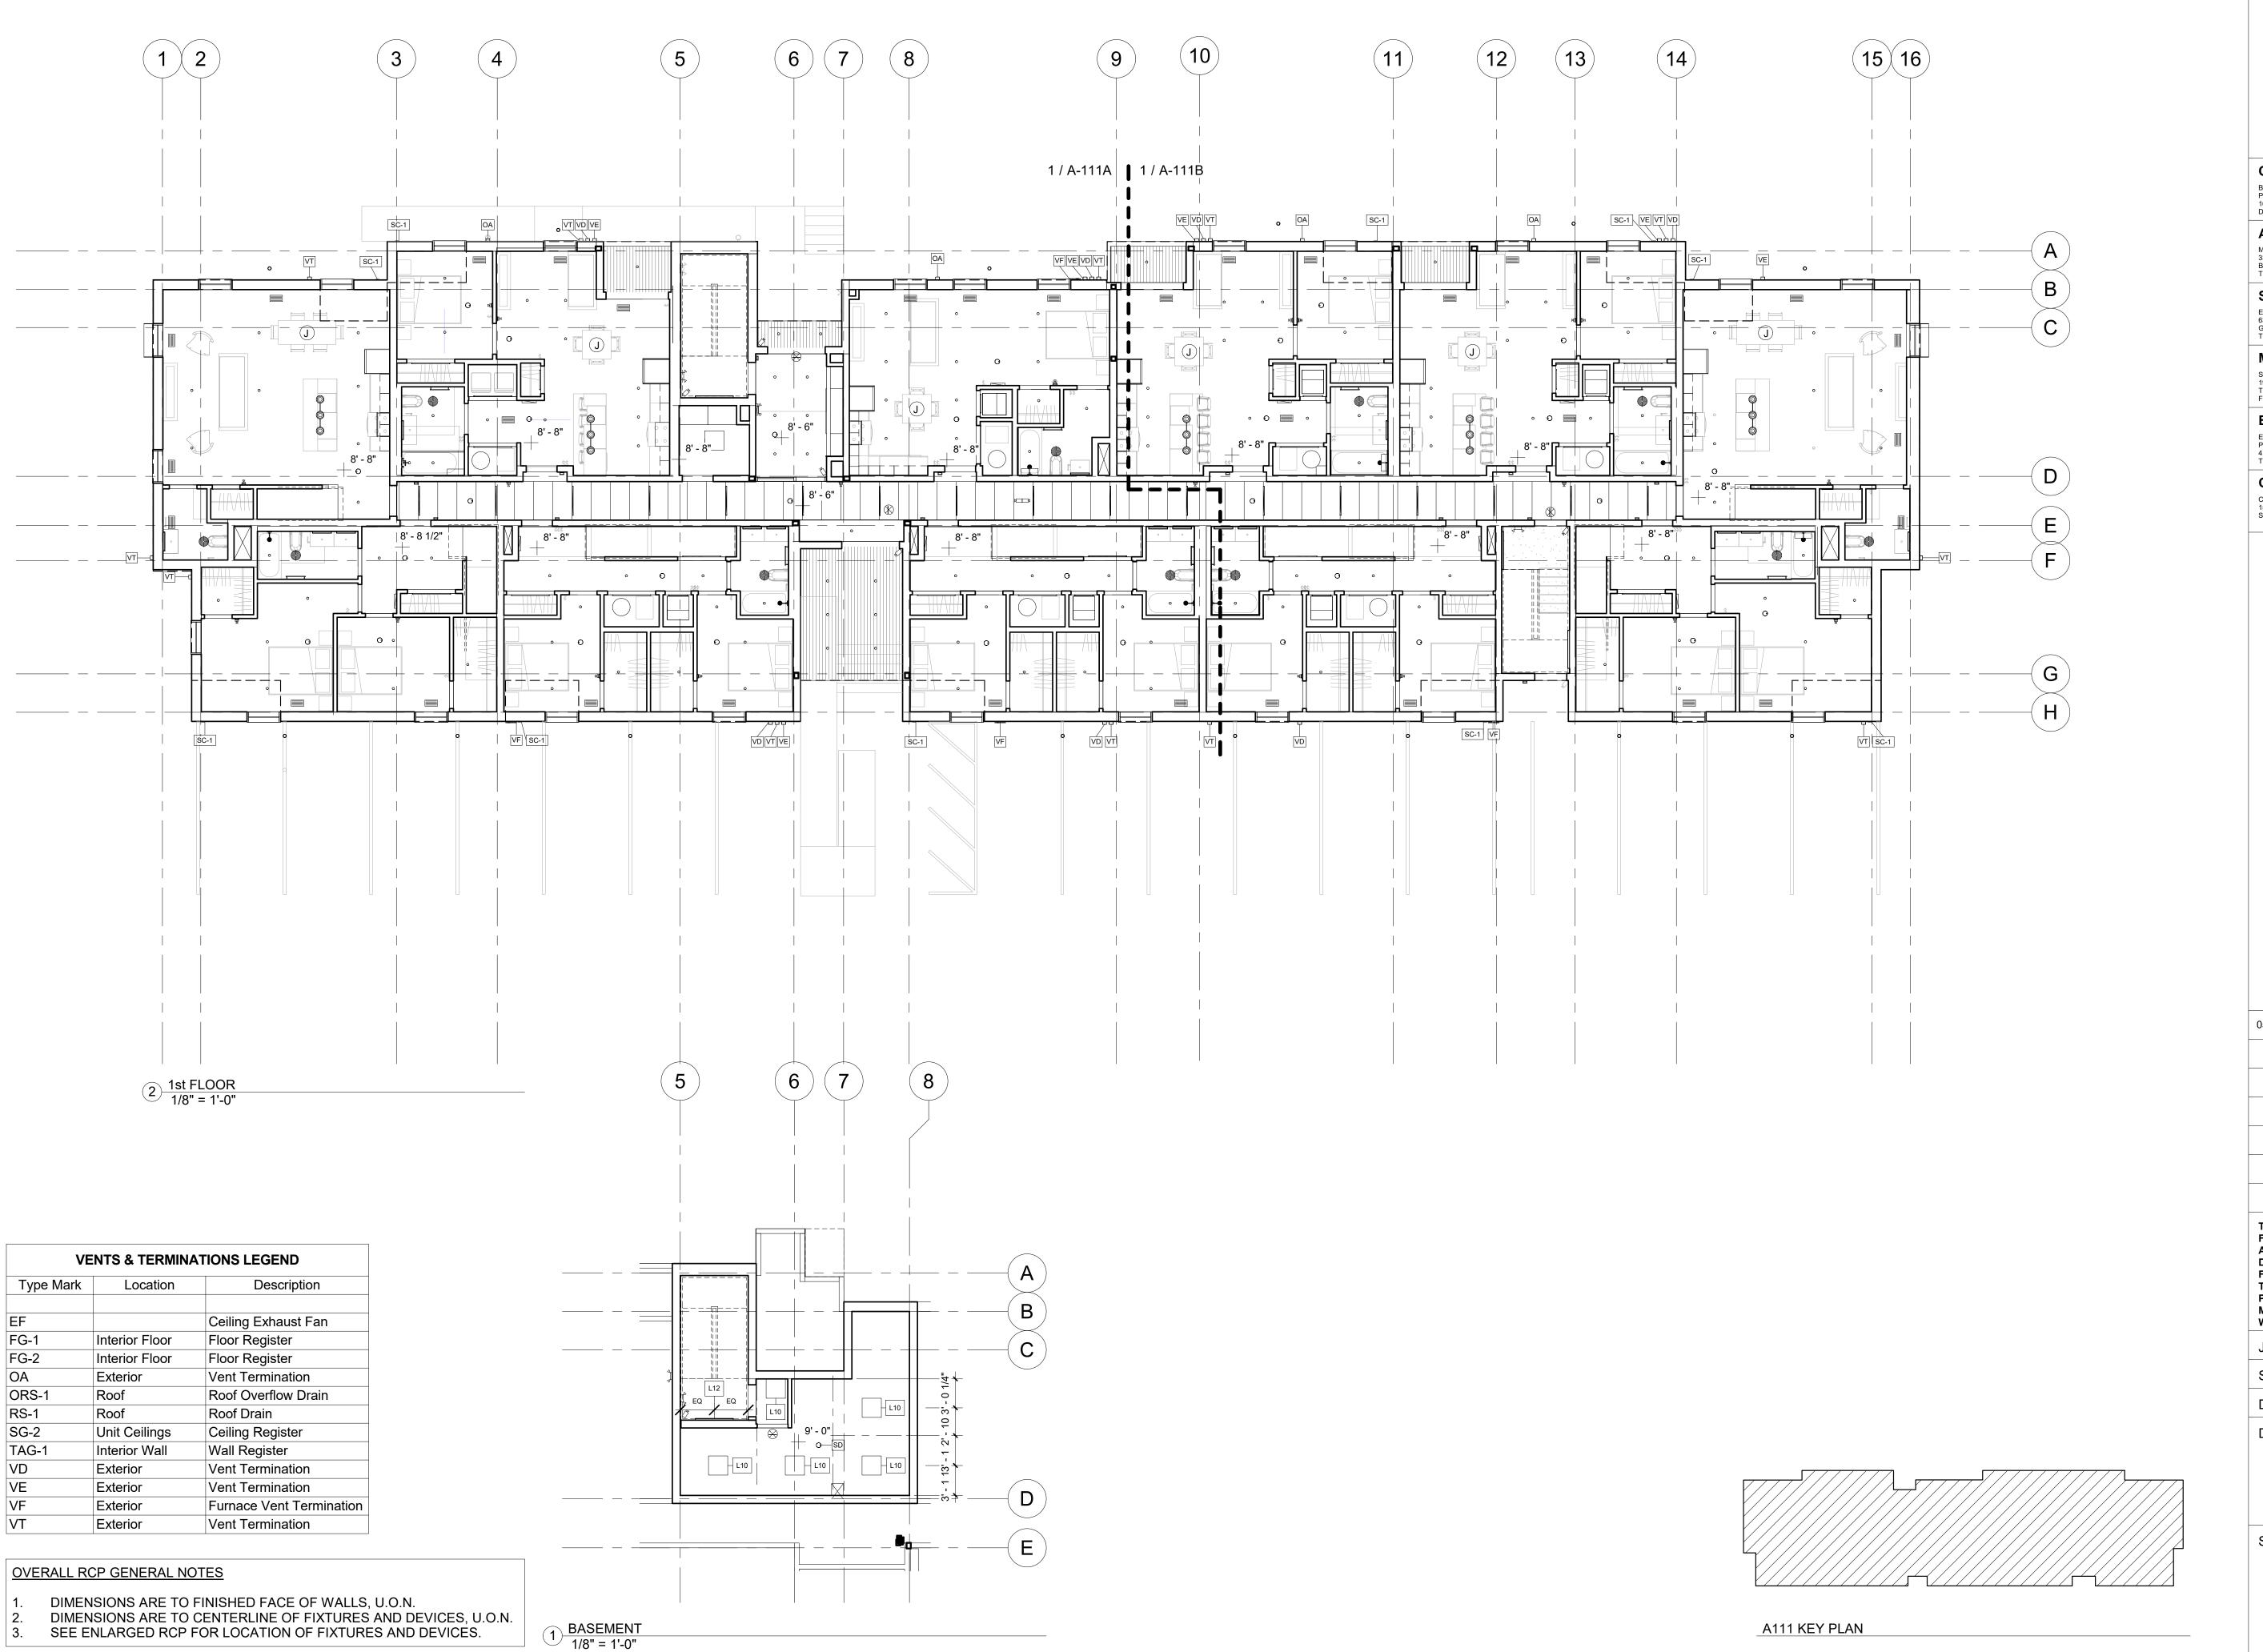



OWNER BRUSH PARK DEVELOPMENT COMPANY PHASE 1 LLC 1092 WOODWARD AVE. DETROIT, MI 48226

ARCHITECT MERGE ARCHITECTS, INC. 332 CONGRESS ST. FLOOR 6 BOSTON, MA 02210 T: 617.670.0265

STRUCTURAL ENGINEER

ENGINEERED STRUCTURES, LLC. 632 BARRY STREET SW GRANDVILLE, MI 49418 T: 616-667-9650

MP/FP ENGINEER SELLINGER ASSOCIATES, INC. 19821 FARMINGTON ROAD, LIVONIA, MI 48152 T: 248-482-0045 F: 248-482-0052

ELECTRICAL ENGINEER ETS ENGINEERING, INC.

P.O. BOX 1166 ROYAL OAK, MI 48068 418-1/2 S. WASHINGTON AVE, ROYAL OAK, MI 48067

CODE CONSULTANT

CODE RED CONSULTANTS 154 TURNPIKE ROAD, SUITE 200 SOUTHBOROUGH MA, 01772

John and Duplette ld Place srush St. 48201

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On Edmun Between B Detroit MI, Par dmur

05/15/20: 100% CD / PERMIT SET

THE CONTRACTOR IS RESPONSIBLE FOR MATERIALS, DETAILS AND ACCURACY, FOR ALL QUANTITIES AND DIMENSIONS, FOR SELECTING FABRICATION PROCESSES, FOR TECHNIQUES OF ASSEMBLY, FOR PERFORMING WORK IN A SAFE MANNER, AND FOR COORDINATING WORK WITH THAT OF ALL TRADES

18284 JOB NO.:


SCALE: As indicated DATE: 05/15/2020

DRAWING TITLE

BASEMENT AND FIRST FLOOR RCP

SHEET NO.

A-111

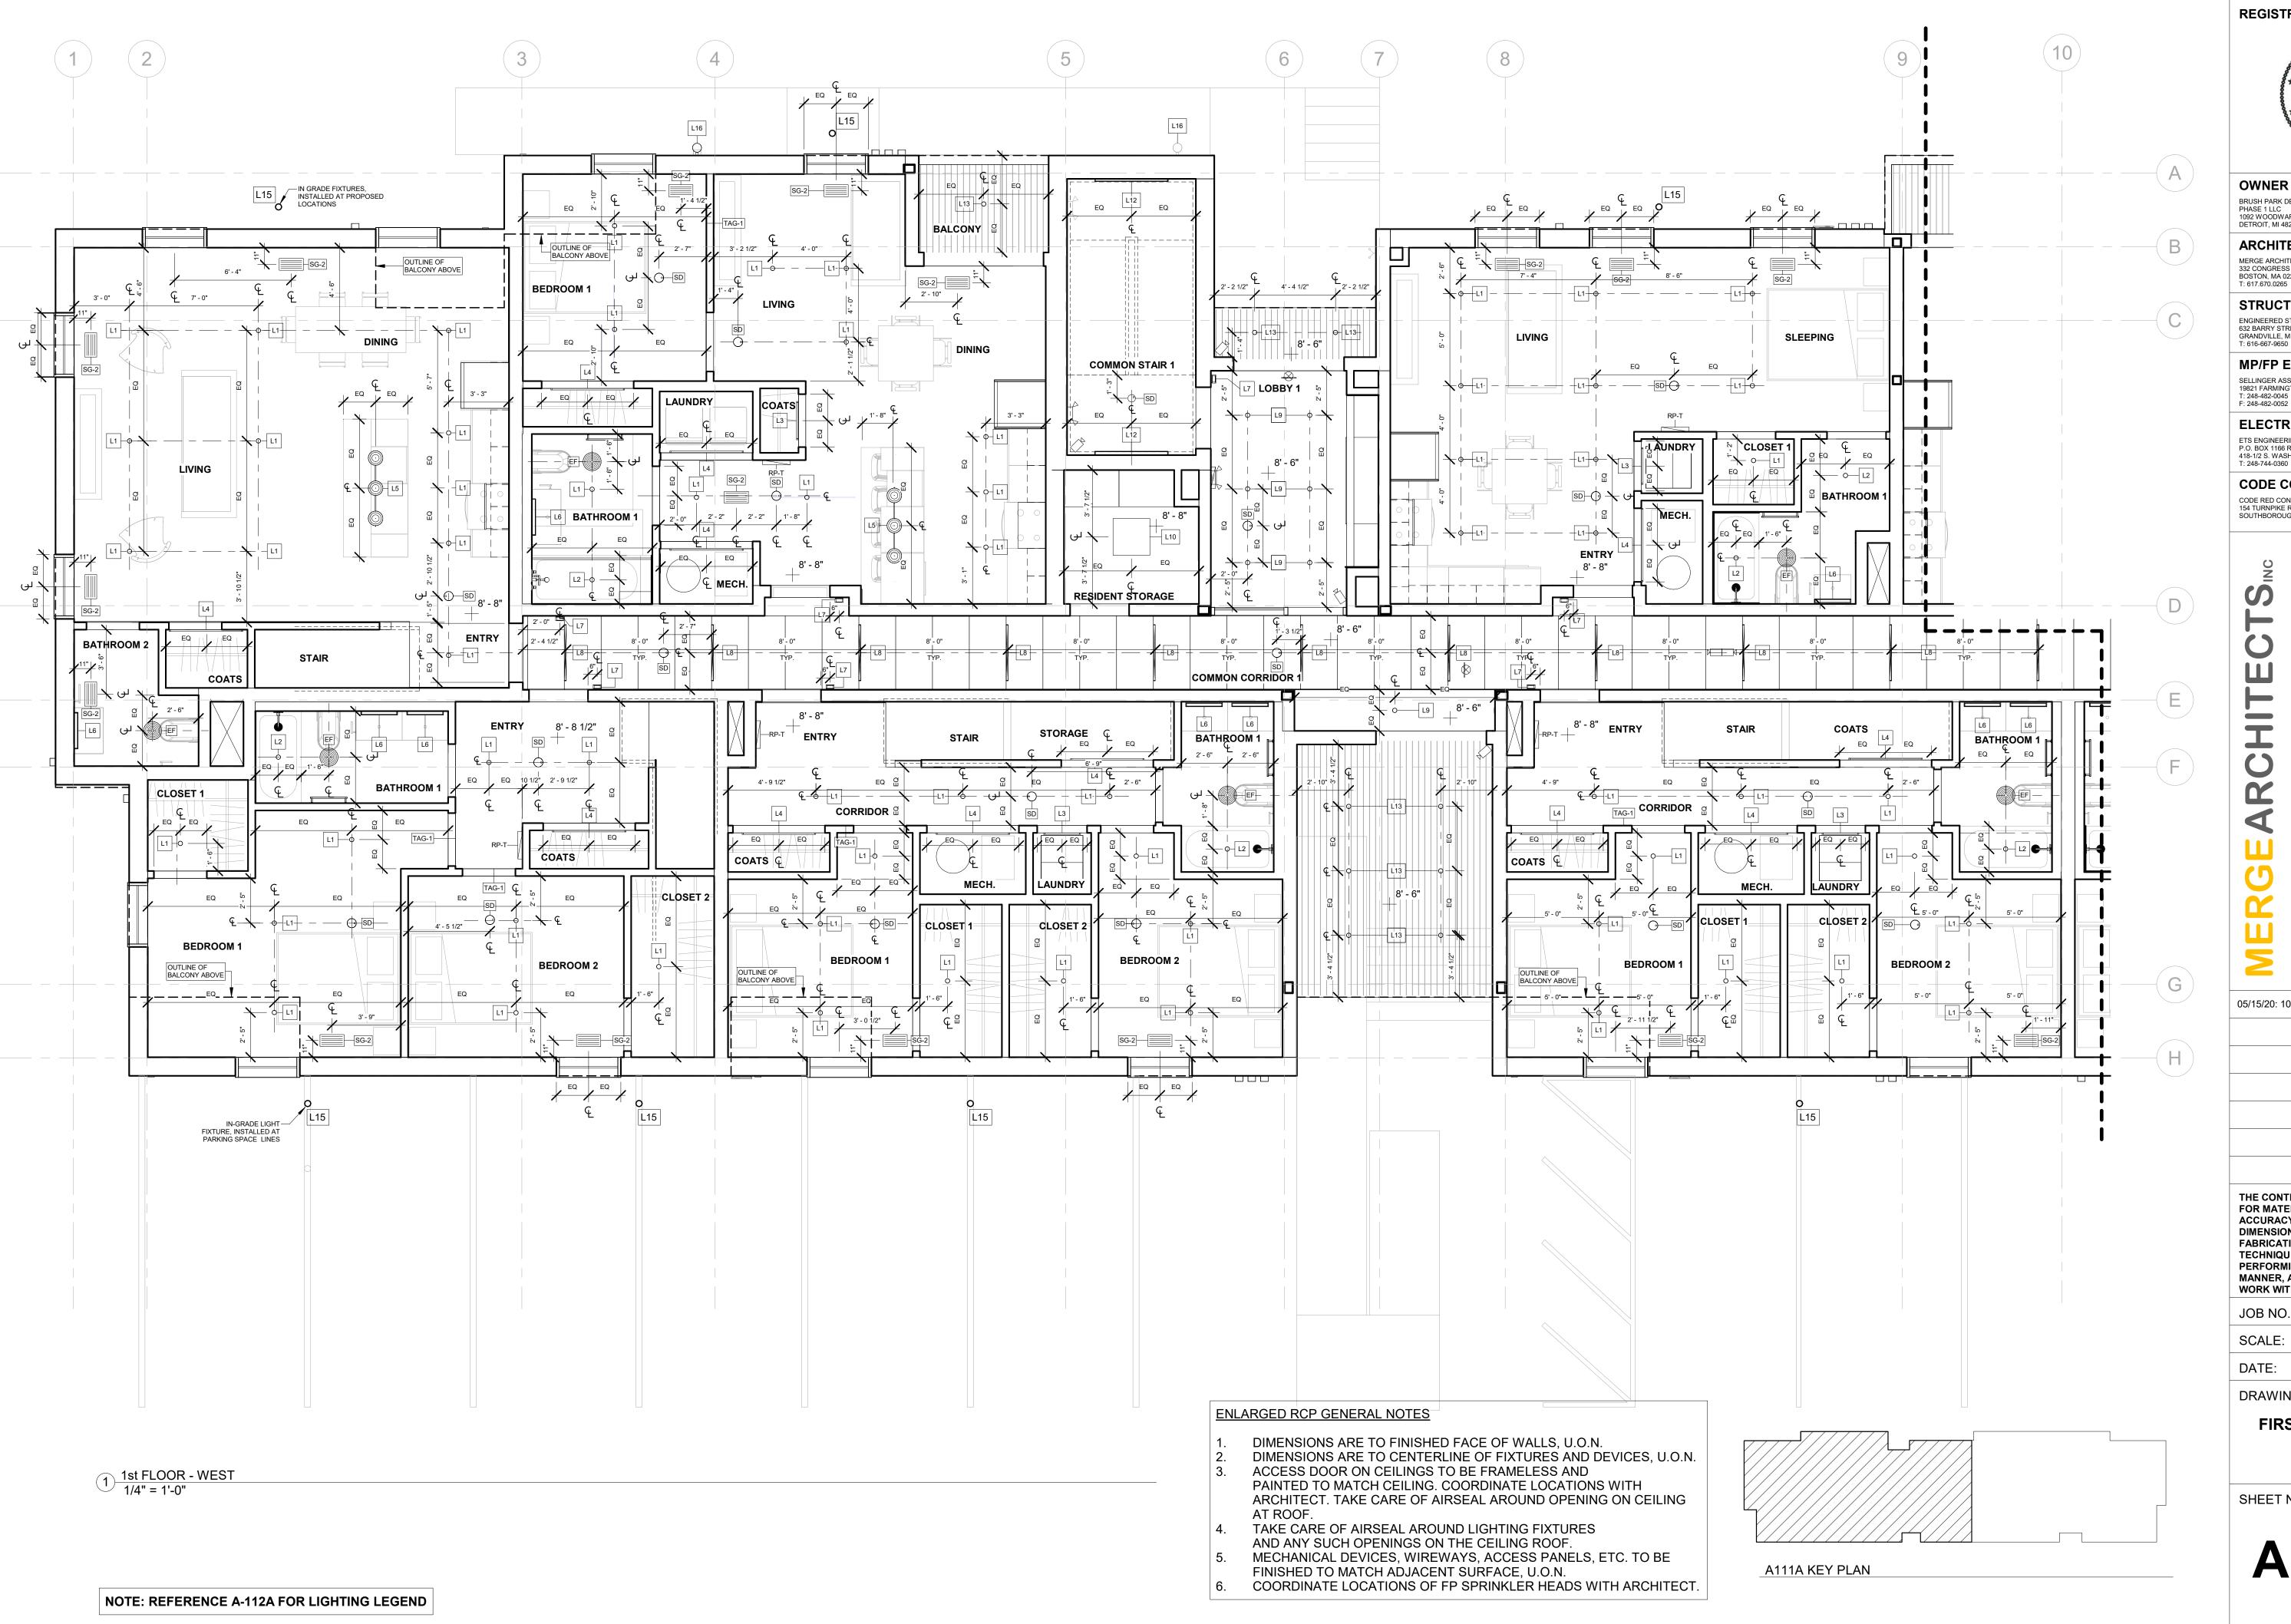



OWNER BRUSH PARK DEVELOPMENT COMPANY PHASE 1 LLC 1092 WOODWARD AVE. DETROIT, MI 48226

ARCHITECT MERGE ARCHITECTS, INC. 332 CONGRESS ST. FLOOR 6 BOSTON, MA 02210 T: 617.670.0265

STRUCTURAL ENGINEER ENGINEERED STRUCTURES, LLC.

632 BARRY STREET SW GRANDVILLE, MI 49418 T: 616-667-9650

MP/FP ENGINEER SELLINGER ASSOCIATES, INC. 19821 FARMINGTON ROAD, LIVONIA, MI 48152 T: 248-482-0045

ELECTRICAL ENGINEER ETS ENGINEERING, INC.

P.O. BOX 1166 ROYAL OAK, MI 48068 418-1/2 S. WASHINGTON AVE, ROYAL OAK, MI 48067

CODE CONSULTANT

CODE RED CONSULTANTS 154 TURNPIKE ROAD, SUITE 200 SOUTHBOROUGH MA, 01772

Duplette d Place srush St. 48201 0 Par dmur

On Bet Det 05/15/20: 100% CD / PERMIT SET

THE CONTRACTOR IS RESPONSIBLE FOR MATERIALS, DETAILS AND ACCURACY, FOR ALL QUANTITIES AND DIMENSIONS, FOR SELECTING **FABRICATION PROCESSES, FOR** TECHNIQUES OF ASSEMBLY, FOR PERFORMING WORK IN A SAFE MANNER, AND FOR COORDINATING WORK WITH THAT OF ALL TRADES

18284 JOB NO.:


SCALE: As indicated DATE: 05/15/2020

DRAWING TITLE

FIRST FLOOR RCP -**WEST**

SHEET NO.

A-111A

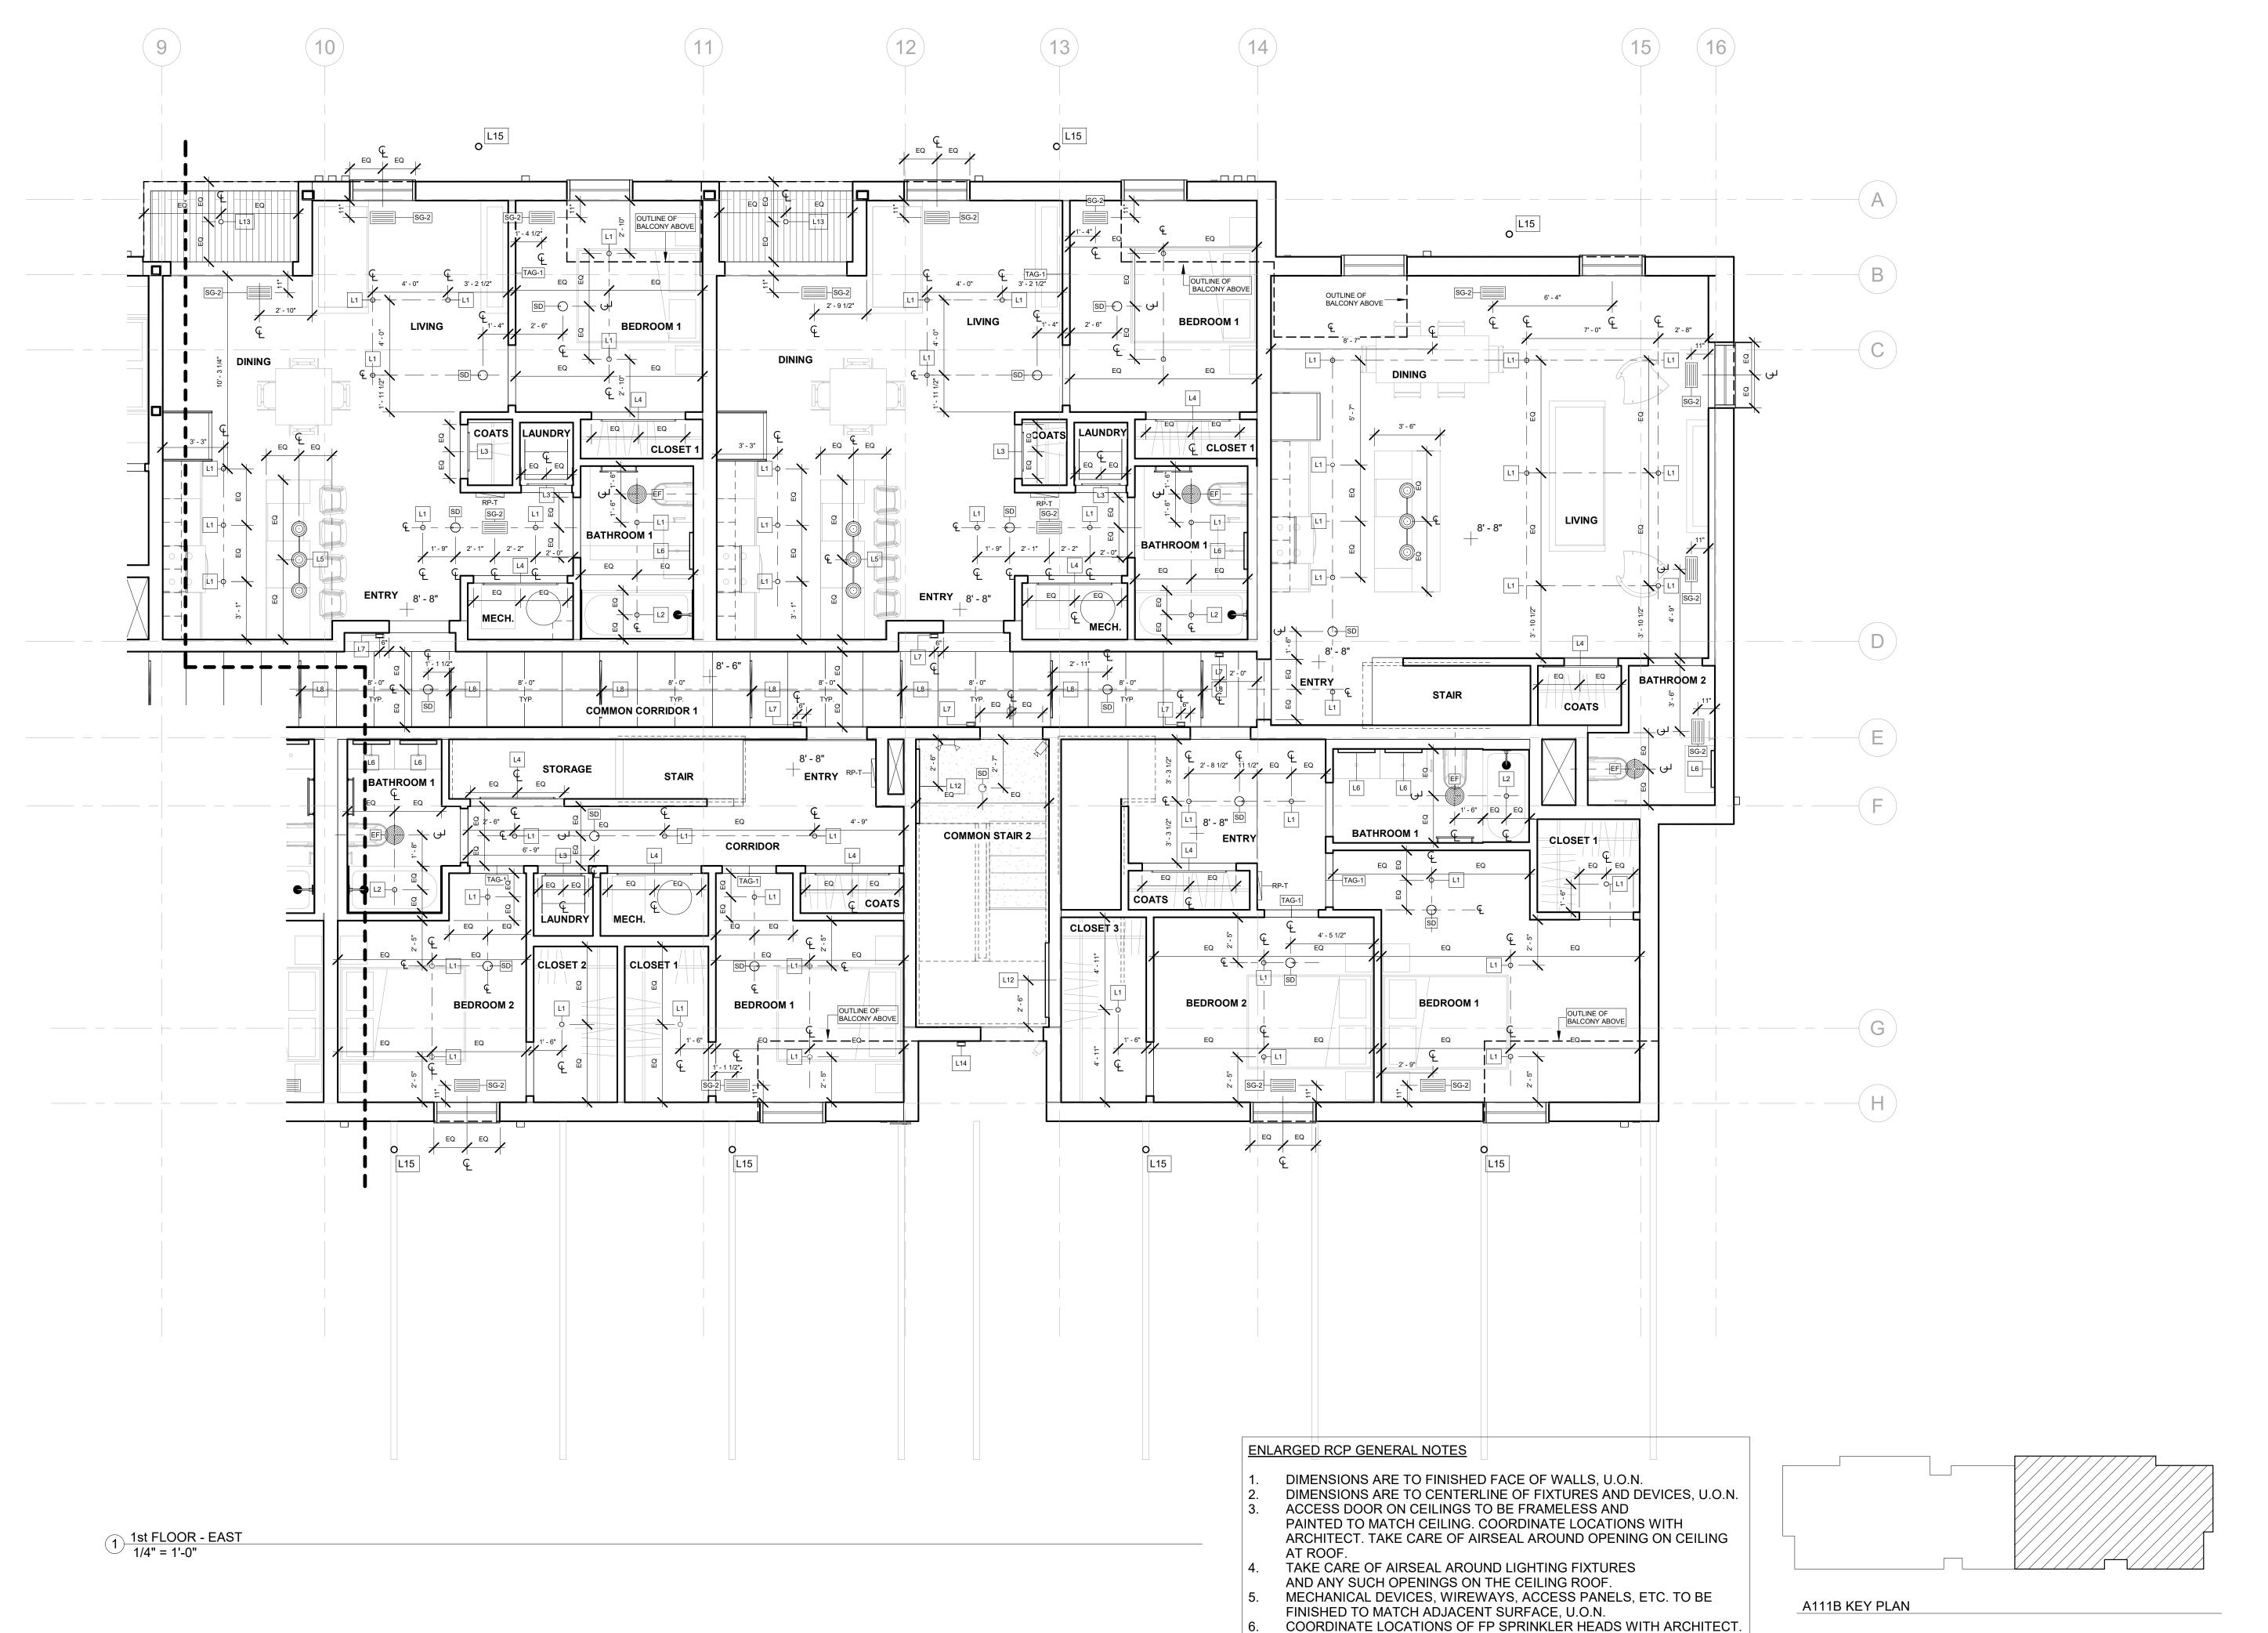

NOTE: REFERENCE A-112A FOR LIGHTING AND MECHANICAL LEGEND

REGISTRATION



OWNER BRUSH PARK DEVELOPMENT COMPANY PHASE 1 LLC 1092 WOODWARD AVE. DETROIT, MI 48226

ARCHITECT

MERGE ARCHITECTS, INC. 332 CONGRESS ST. FLOOR 6 BOSTON, MA 02210 T: 617.670.0265 STRUCTURAL ENGINEER

ENGINEERED STRUCTURES, LLC. 632 BARRY STREET SW GRANDVILLE, MI 49418 T: 616-667-9650

MP/FP ENGINEER

SELLINGER ASSOCIATES, INC. 19821 FARMINGTON ROAD, LIVONIA, MI 48152 T: 248-482-0045 F: 248-482-0052 ELECTRICAL ENGINEER

ETS ENGINEERING, INC. P.O. BOX 1166 ROYAL OAK, MI 48068 418-1/2 S. WASHINGTON AVE, ROYAL OAK, MI 48067

CODE CONSULTANT

CODE RED CONSULTANTS 154 TURNPIKE ROAD, SUITE 200 SOUTHBOROUGH MA, 01772

ohn and **Duplette** ld Place srush St. 48201 0 On Edmun Between B Detroit MI, Par

05/15/20: 100% CD / PERMIT SET

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JOB NO.: 18284

SCALE: As indicated


DATE: 05/15/2020

DRAWING TITLE

FIRST FLOOR RCP -**EAST**

SHEET NO.

A-111B

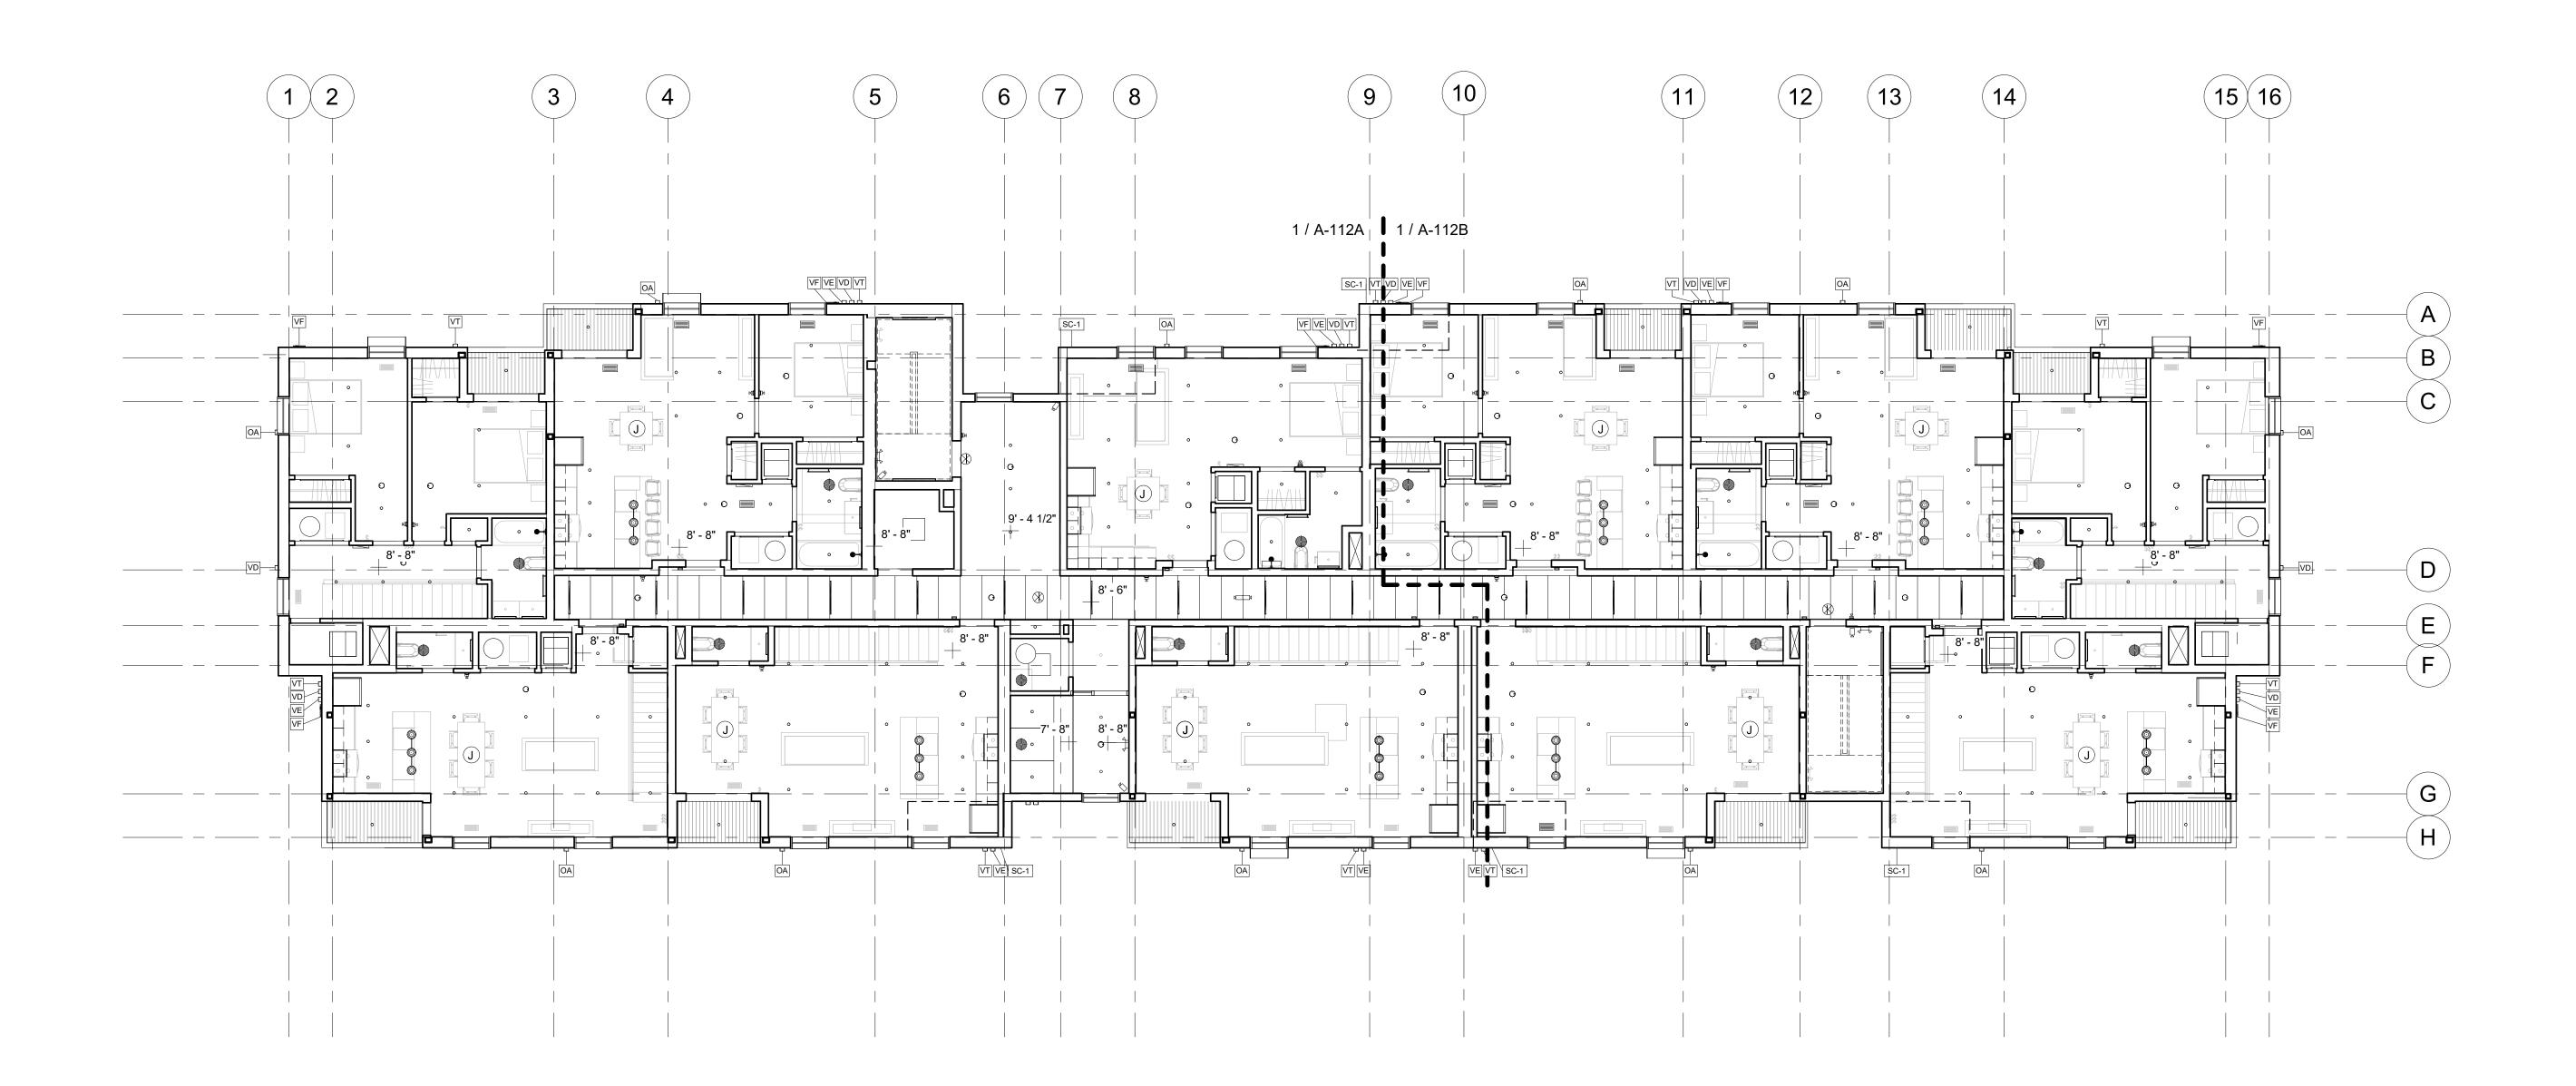


VENTS & TERMINATIONS LEGEND			
Type Mark	Location	Description	
EF		Ceiling Exhaust Fan	
FG-1	Interior Floor	Floor Register	
FG-2	Interior Floor	Floor Register	
OA	Exterior	Vent Termination	
ORS-1	Roof	Roof Overflow Drain	
RS-1	Roof	Roof Drain	
SG-2	Unit Ceilings	Ceiling Register	
TAG-1	Interior Wall	Wall Register	
VD	Exterior	Vent Termination	
VE	Exterior	Vent Termination	
VF	Exterior	Furnace Vent Termination	
VT	Exterior	Vent Termination	

1 2nd FLOOR 1/8" = 1'-0"

OVERALL RCP GENERAL NOTES

DIMENSIONS ARE TO FINISHED FACE OF WALLS, U.O.N. DIMENSIONS ARE TO CENTERLINE OF FIXTURES AND DEVICES, U.O.N.

SEE ENLARGED RCP FOR LOCATION OF FIXTURES AND DEVICES.

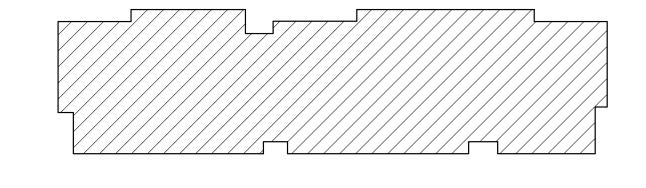

A112 KEY PLAN

REGISTRATION



OWNER BRUSH PARK DEVELOPMENT COMPANY PHASE 1 LLC 1092 WOODWARD AVE. DETROIT, MI 48226

ARCHITECT MERGE ARCHITECTS, INC. 332 CONGRESS ST. FLOOR 6 BOSTON, MA 02210 T: 617.670.0265

STRUCTURAL ENGINEER

ENGINEERED STRUCTURES, LLC. 632 BARRY STREET SW GRANDVILLE, MI 49418 T: 616-667-9650

MP/FP ENGINEER

SELLINGER ASSOCIATES, INC. 19821 FARMINGTON ROAD, LIVONIA, MI 48152 T: 248-482-0045 F: 248-482-0052 ELECTRICAL ENGINEER

ETS ENGINEERING, INC. P.O. BOX 1166 ROYAL OAK, MI 48068 418-1/2 S. WASHINGTON AVE, ROYAL OAK, MI 48067 T: 248-744-0360

CODE CONSULTANT

CODE RED CONSULTANTS 154 TURNPIKE ROAD, SUITE 200 SOUTHBOROUGH MA, 01772

John and Duplette ld Place srush St. 48201 D On Edmunc Between Br Detroit MI, ⁴

05/15/20: 100% CD / PERMIT SET

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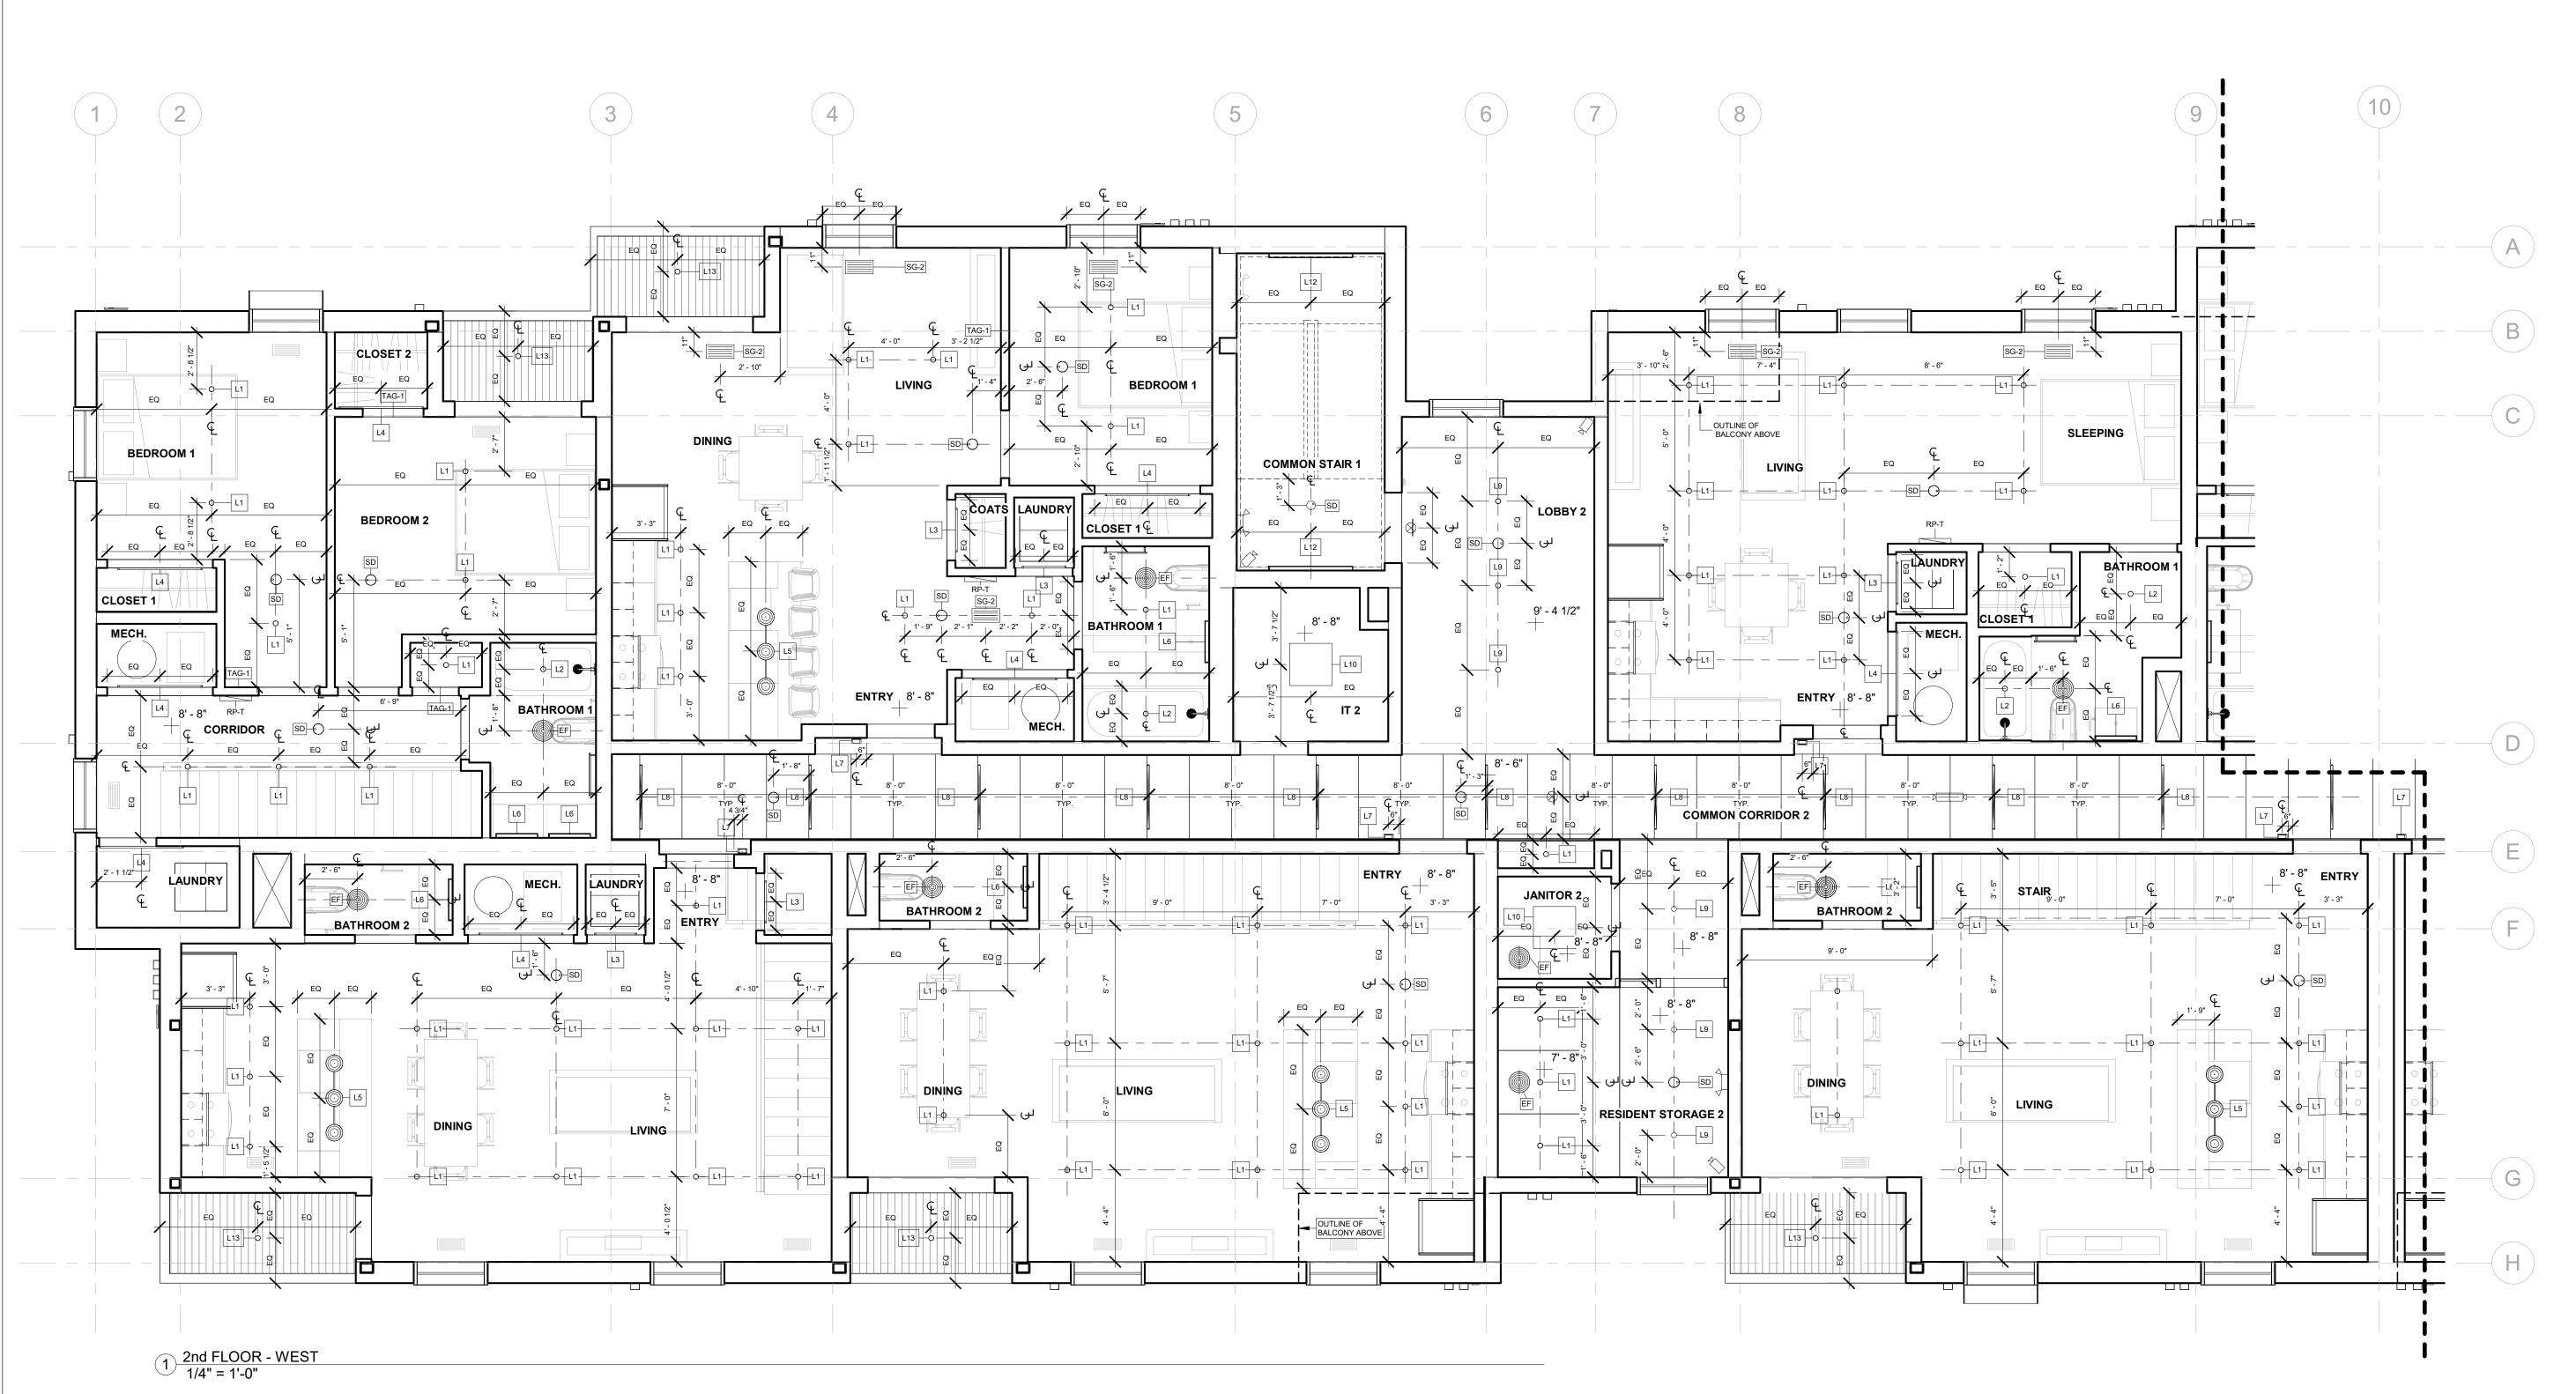
18284 JOB NO.: SCALE:

As indicated DATE: 05/15/2020

DRAWING TITLE

SECOND FLOOR RCP

SHEET NO.




LIGHTING LEGEND			
Type Mark	Description		
	120V EMERGENCY LIGHT FIXTURE		
L1	Surface Mounted Slim Downlight		
L2	Surface Mounted Slim Downlight		
L3	Lightstick 25" (Motion Sensor)		
L4	Lightstick 49" (Motion Sensor)		
L5	Pendant		
L6	Vanity Light		
L7	Small Sconce		
L8	Linear Downlight ACT System Clip-On		
L9	Surface Mounted Slim Downlight		
L10	Surface Mounted Downlight		
L12	Linear Wall Sconce		
L13	Recessed Can Light (Exterior)		
L14	Small Sconce (Exterior)		
L15	In-grade LED Light (Exterior)		
L16	Wall Mounted Sconce (Exterior)		

VENTS & TERMINATIONS LEGEND		
Type Mark	Location	Description
EF		Ceiling Exhaust Fan
FG-1	Interior Floor	Floor Register
FG-2	Interior Floor	Floor Register
OA	Exterior	Vent Termination
ORS-1	Roof	Roof Overflow Drain
RS-1	Roof	Roof Drain
SG-2	Unit Ceilings	Ceiling Register
TAG-1	Interior Wall	Wall Register
VD	Exterior	Vent Termination
VE	Exterior	Vent Termination
VF	Exterior	Furnace Vent Terminatio
VT	Exterior	Vent Termination

ENLARGED RCP GENERAL NOTES

- DIMENSIONS ARE TO FINISHED FACE OF WALLS, U.O.N. DIMENSIONS ARE TO CENTERLINE OF FIXTURES AND DEVICES, U.O.N.
- ACCESS DOOR ON CEILINGS TO BE FRAMELESS AND PAINTED TO MATCH CEILING. COORDINATE LOCATIONS WITH ARCHITECT. TAKE CARE OF AIRSEAL AROUND OPENING ON CEILING AT ROOF.
- TAKE CARE OF AIRSEAL AROUND LIGHTING FIXTURES AND ANY SUCH OPENINGS ON THE CEILING ROOF.
- MECHANICAL DEVICES, WIREWAYS, ACCESS PANELS, ETC. TO BE
- FINISHED TO MATCH ADJACENT SURFACE, U.O.N.
- COORDINATE LOCATIONS OF FP SPRINKLER HEADS WITH ARCHITECT.

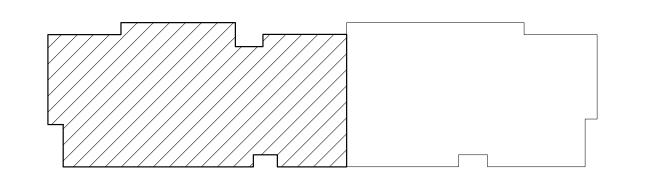

A112A KEY PLAN

REGISTRATION



OWNER BRUSH PARK DEVELOPMENT COMPANY PHASE 1 LLC 1092 WOODWARD AVE. DETROIT, MI 48226

ARCHITECT MERGE ARCHITECTS, INC. 332 CONGRESS ST. FLOOR 6 BOSTON, MA 02210 T: 617.670.0265

STRUCTURAL ENGINEER ENGINEERED STRUCTURES, LLC.

632 BARRY STREET SW GRANDVILLE, MI 49418 T: 616-667-9650 **MP/FP ENGINEER** SELLINGER ASSOCIATES, INC. 19821 FARMINGTON ROAD, LIVONIA, MI 48152 T: 248-482-0045

F: 248-482-0052 **ELECTRICAL ENGINEER**

ETS ENGINEERING, INC. P.O. BOX 1166 ROYAL OAK, MI 48068 418-1/2 S. WASHINGTON AVE, ROYAL OAK, MI 48067

CODE CONSULTANT

CODE RED CONSULTANTS 154 TURNPIKE ROAD, SUITE 200 SOUTHBOROUGH MA, 01772

Duplette

and d Place srush St. 48201 Q

05/15/20: 100% CD / PERMIT SET

THE CONTRACTOR IS RESPONSIBLE FOR MATERIALS, DETAILS AND ACCURACY, FOR ALL QUANTITIES AND DIMENSIONS, FOR SELECTING FABRICATION PROCESSES, FOR TECHNIQUES OF ASSEMBLY, FOR PERFORMING WORK IN A SAFE MANNER, AND FOR COORDINATING WORK WITH THAT OF ALL TRADES

JOB NO.: SCALE: As indicated


DATE: 05/15/2020

DRAWING TITLE

SECOND FLOOR RCP -**WEST**

SHEET NO.

A-112A

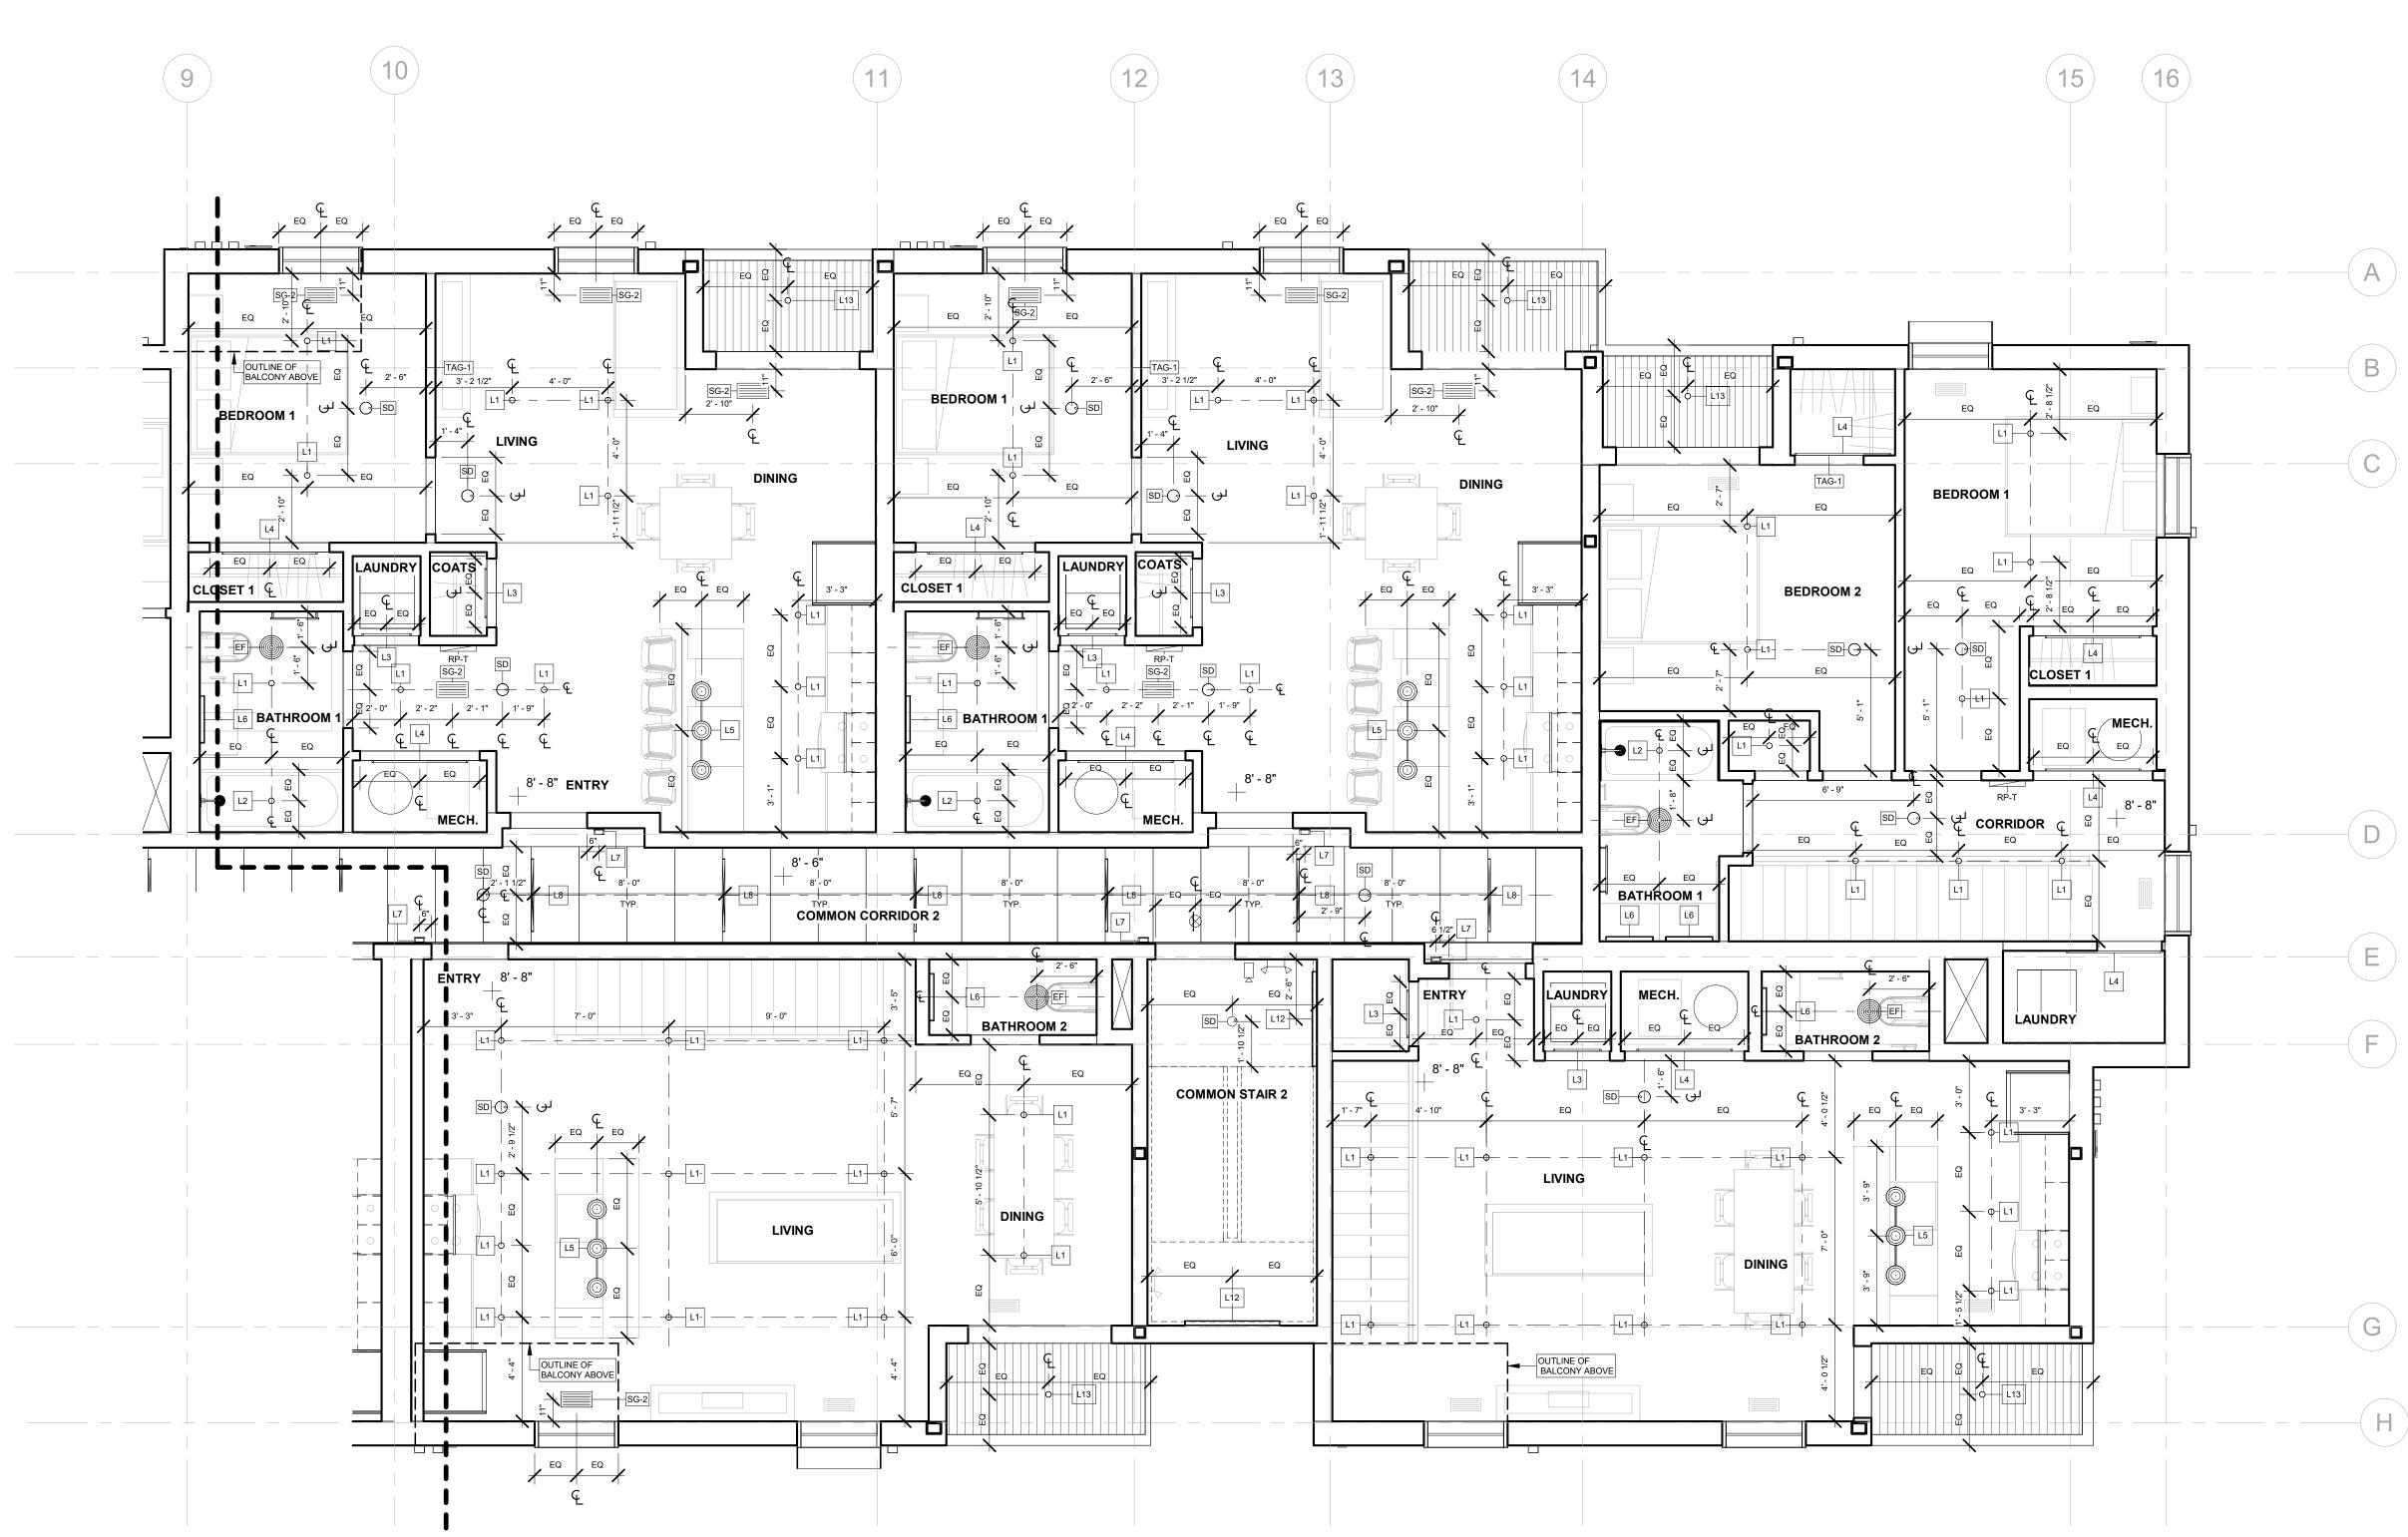


1 2nd FLOOR - EAST 1/4" = 1'-0"

LIGHTING LEGEND		
Type Mark	Description	
	120V EMERGENCY LIGHT FIXTURE	
L1	Surface Mounted Slim Downlight	
L2	Surface Mounted Slim Downlight	
L3	Lightstick 25" (Motion Sensor)	
L4	Lightstick 49" (Motion Sensor)	
L5	Pendant	
L6	Vanity Light	
L7	Small Sconce	
L8	Linear Downlight ACT System Clip-On	
L9	Surface Mounted Slim Downlight	
L10	Surface Mounted Downlight	
L12	Linear Wall Sconce	
L13	Recessed Can Light (Exterior)	
L14	Small Sconce (Exterior)	
L15	In-grade LED Light (Exterior)	
L16	Wall Mounted Sconce (Exterior)	

VENTS & TERMINATIONS LEGEND		
Type Mark	Location	Description
EF		Ceiling Exhaust Fan
FG-1	Interior Floor	Floor Register
FG-2	Interior Floor	Floor Register
OA	Exterior	Vent Termination
ORS-1	Roof	Roof Overflow Drain
RS-1	Roof	Roof Drain
SG-2	Unit Ceilings	Ceiling Register
TAG-1	Interior Wall	Wall Register
VD	Exterior	Vent Termination
VE	Exterior	Vent Termination
VF	Exterior	Furnace Vent Termination
VT	Exterior	Vent Termination

ENLARGED RCP GENERAL NOTES

- DIMENSIONS ARE TO FINISHED FACE OF WALLS, U.O.N.
- DIMENSIONS ARE TO CENTERLINE OF FIXTURES AND DEVICES, U.O.N. ACCESS DOOR ON CEILINGS TO BE FRAMELESS AND PAINTED TO MATCH CEILING. COORDINATE LOCATIONS WITH ARCHITECT. TAKE CARE OF AIRSEAL AROUND OPENING ON CEILING
- AT ROOF. TAKE CARE OF AIRSEAL AROUND LIGHTING FIXTURES AND ANY SUCH OPENINGS ON THE CEILING ROOF.
- MECHANICAL DEVICES, WIREWAYS, ACCESS PANELS, ETC. TO BE FINISHED TO MATCH ADJACENT SURFACE, U.O.N.
- COORDINATE LOCATIONS OF FP SPRINKLER HEADS WITH ARCHITECT.

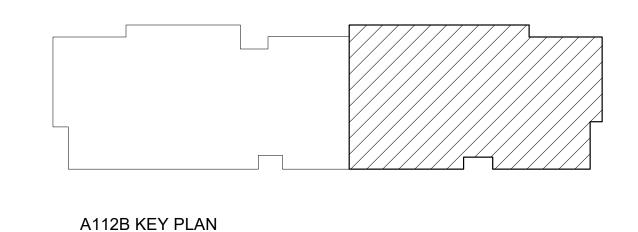

REGISTRATION



OWNER BRUSH PARK DEVELOPMENT COMPANY PHASE 1 LLC 1092 WOODWARD AVE.

ARCHITECT

DETROIT, MI 48226

MERGE ARCHITECTS, INC. 332 CONGRESS ST. FLOOR 6 BOSTON, MA 02210 T: 617.670.0265 STRUCTURAL ENGINEER

ENGINEERED STRUCTURES, LLC. 632 BARRY STREET SW GRANDVILLE, MI 49418 T: 616-667-9650

MP/FP ENGINEER SELLINGER ASSOCIATES, INC. 19821 FARMINGTON ROAD, LIVONIA, MI 48152 T: 248-482-0045 F: 248-482-0052

ELECTRICAL ENGINEER ETS ENGINEERING, INC. P.O. BOX 1166 ROYAL OAK, MI 48068 418-1/2 S. WASHINGTON AVE, ROYAL OAK, MI 48067

CODE CONSULTANT

CODE RED CONSULTANTS 154 TURNPIKE ROAD, SUITE 200 SOUTHBOROUGH MA, 01772

John and **Duplette**

d Place srush St. 48201 p

05/15/20: 100% CD / PERMIT SET

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18284 JOB NO.: SCALE: As indicated


DATE: 05/15/2020

DRAWING TITLE

SECOND FLOOR RCP -**EAST**

SHEET NO.


A-112B

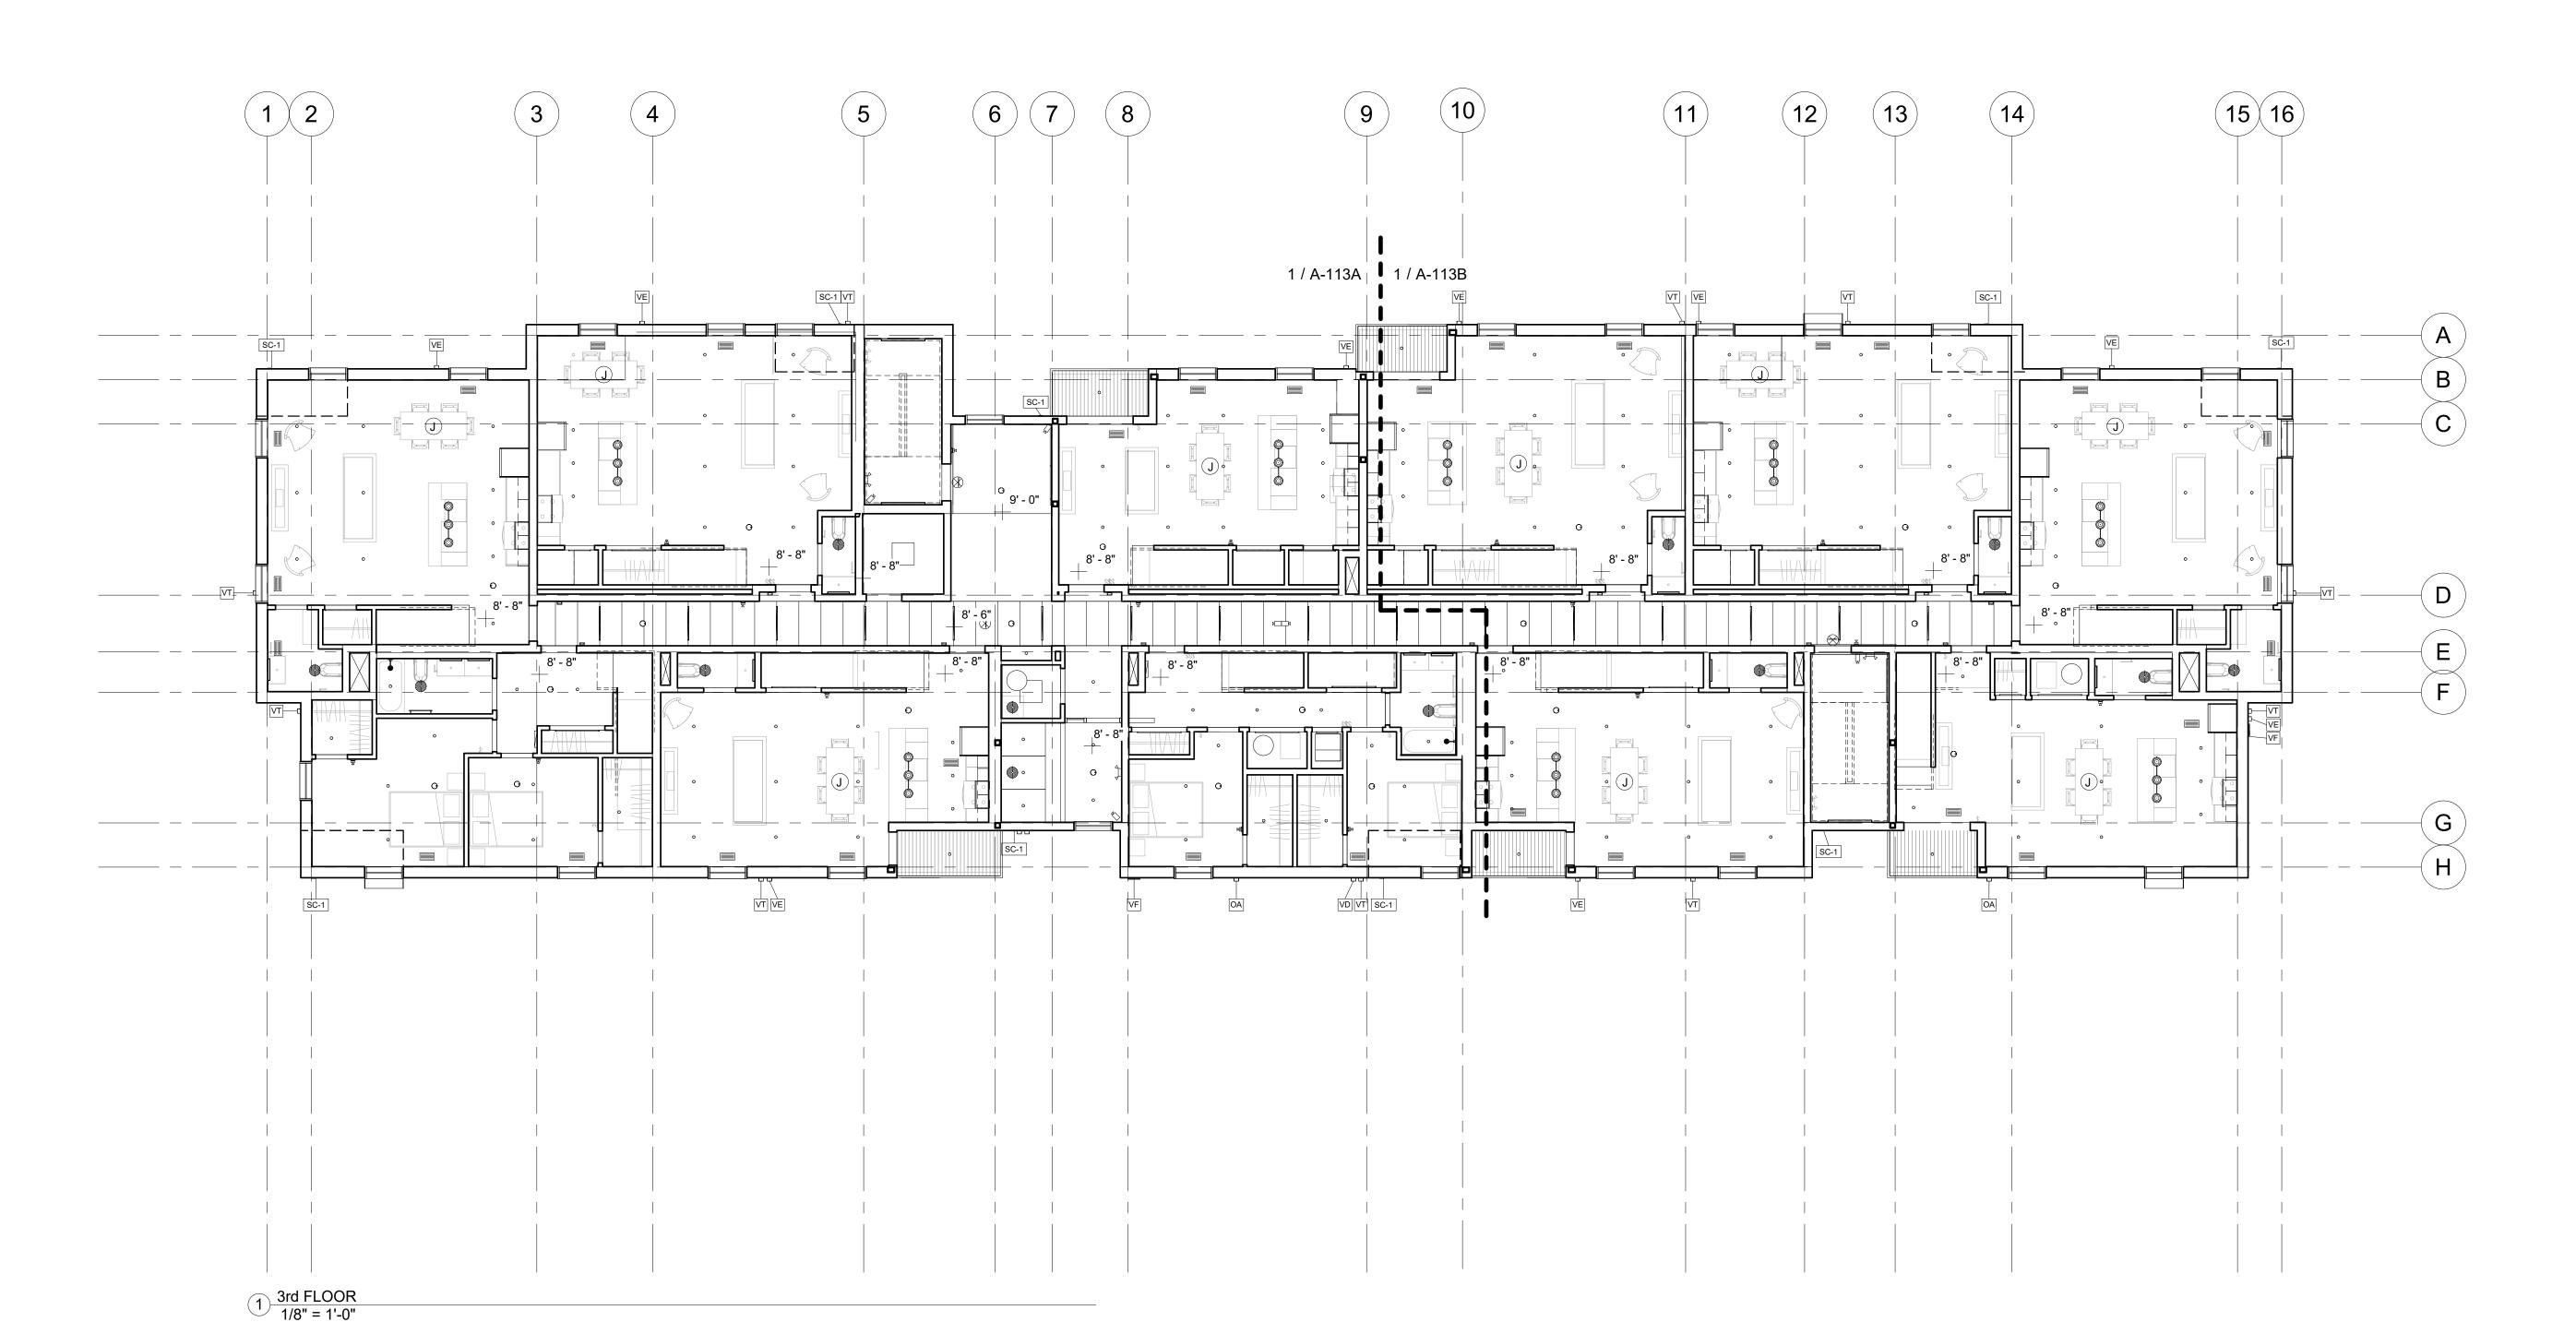

VENTS & TERMINATIONS LEGEND			
Type Mark	Location	Description	
EF		Ceiling Exhaust Fan	
FG-1	Interior Floor	Floor Register	
FG-2	Interior Floor	Floor Register	
OA	Exterior	Vent Termination	
ORS-1	Roof	Roof Overflow Drain	
RS-1	Roof	Roof Drain	
SG-2	Unit Ceilings	Ceiling Register	
TAG-1	Interior Wall	Wall Register	
VD	Exterior	Vent Termination	
VE	Exterior	Vent Termination	
VF	Exterior	Furnace Vent Termination	
VT	Exterior	Vent Termination	

OVERALL RCP GENERAL NOTES

- DIMENSIONS ARE TO FINISHED FACE OF WALLS, U.O.N. DIMENSIONS ARE TO CENTERLINE OF FIXTURES AND DEVICES, U.O.N.
- SEE ENLARGED RCP FOR LOCATION OF FIXTURES AND DEVICES.

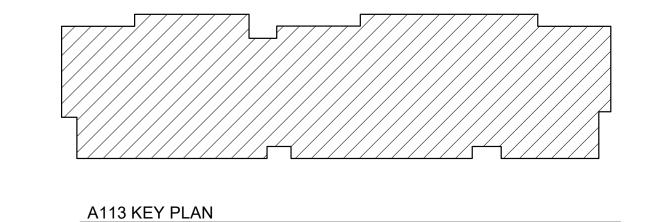

REGISTRATION



OWNER BRUSH PARK DEVELOPMENT COMPANY PHASE 1 LLC 1092 WOODWARD AVE. DETROIT, MI 48226

ARCHITECT MERGE ARCHITECTS, INC. 332 CONGRESS ST. FLOOR 6 BOSTON, MA 02210 T: 617.670.0265

STRUCTURAL ENGINEER ENGINEERED STRUCTURES, LLC. 632 BARRY STREET SW GRANDVILLE, MI 49418 T: 616-667-9650

MP/FP ENGINEER SELLINGER ASSOCIATES, INC. 19821 FARMINGTON ROAD, LIVONIA, MI 48152 T: 248-482-0045 F: 248-482-0052

ELECTRICAL ENGINEER

ETS ENGINEERING, INC.
P.O. BOX 1166 ROYAL OAK, MI 48068
418-1/2 S. WASHINGTON AVE, ROYAL OAK, MI 48067
T: 248-744-0360

CODE CONSULTANT

CODE RED CONSULTANTS 154 TURNPIKE ROAD, SUITE 200 SOUTHBOROUGH MA, 01772

John and d Place trush St. 48201

Duplette D **Brush Park**On Edmunc
Between Br
Detroit MI, 4

05/15/20: 100% CD / PERMIT SET

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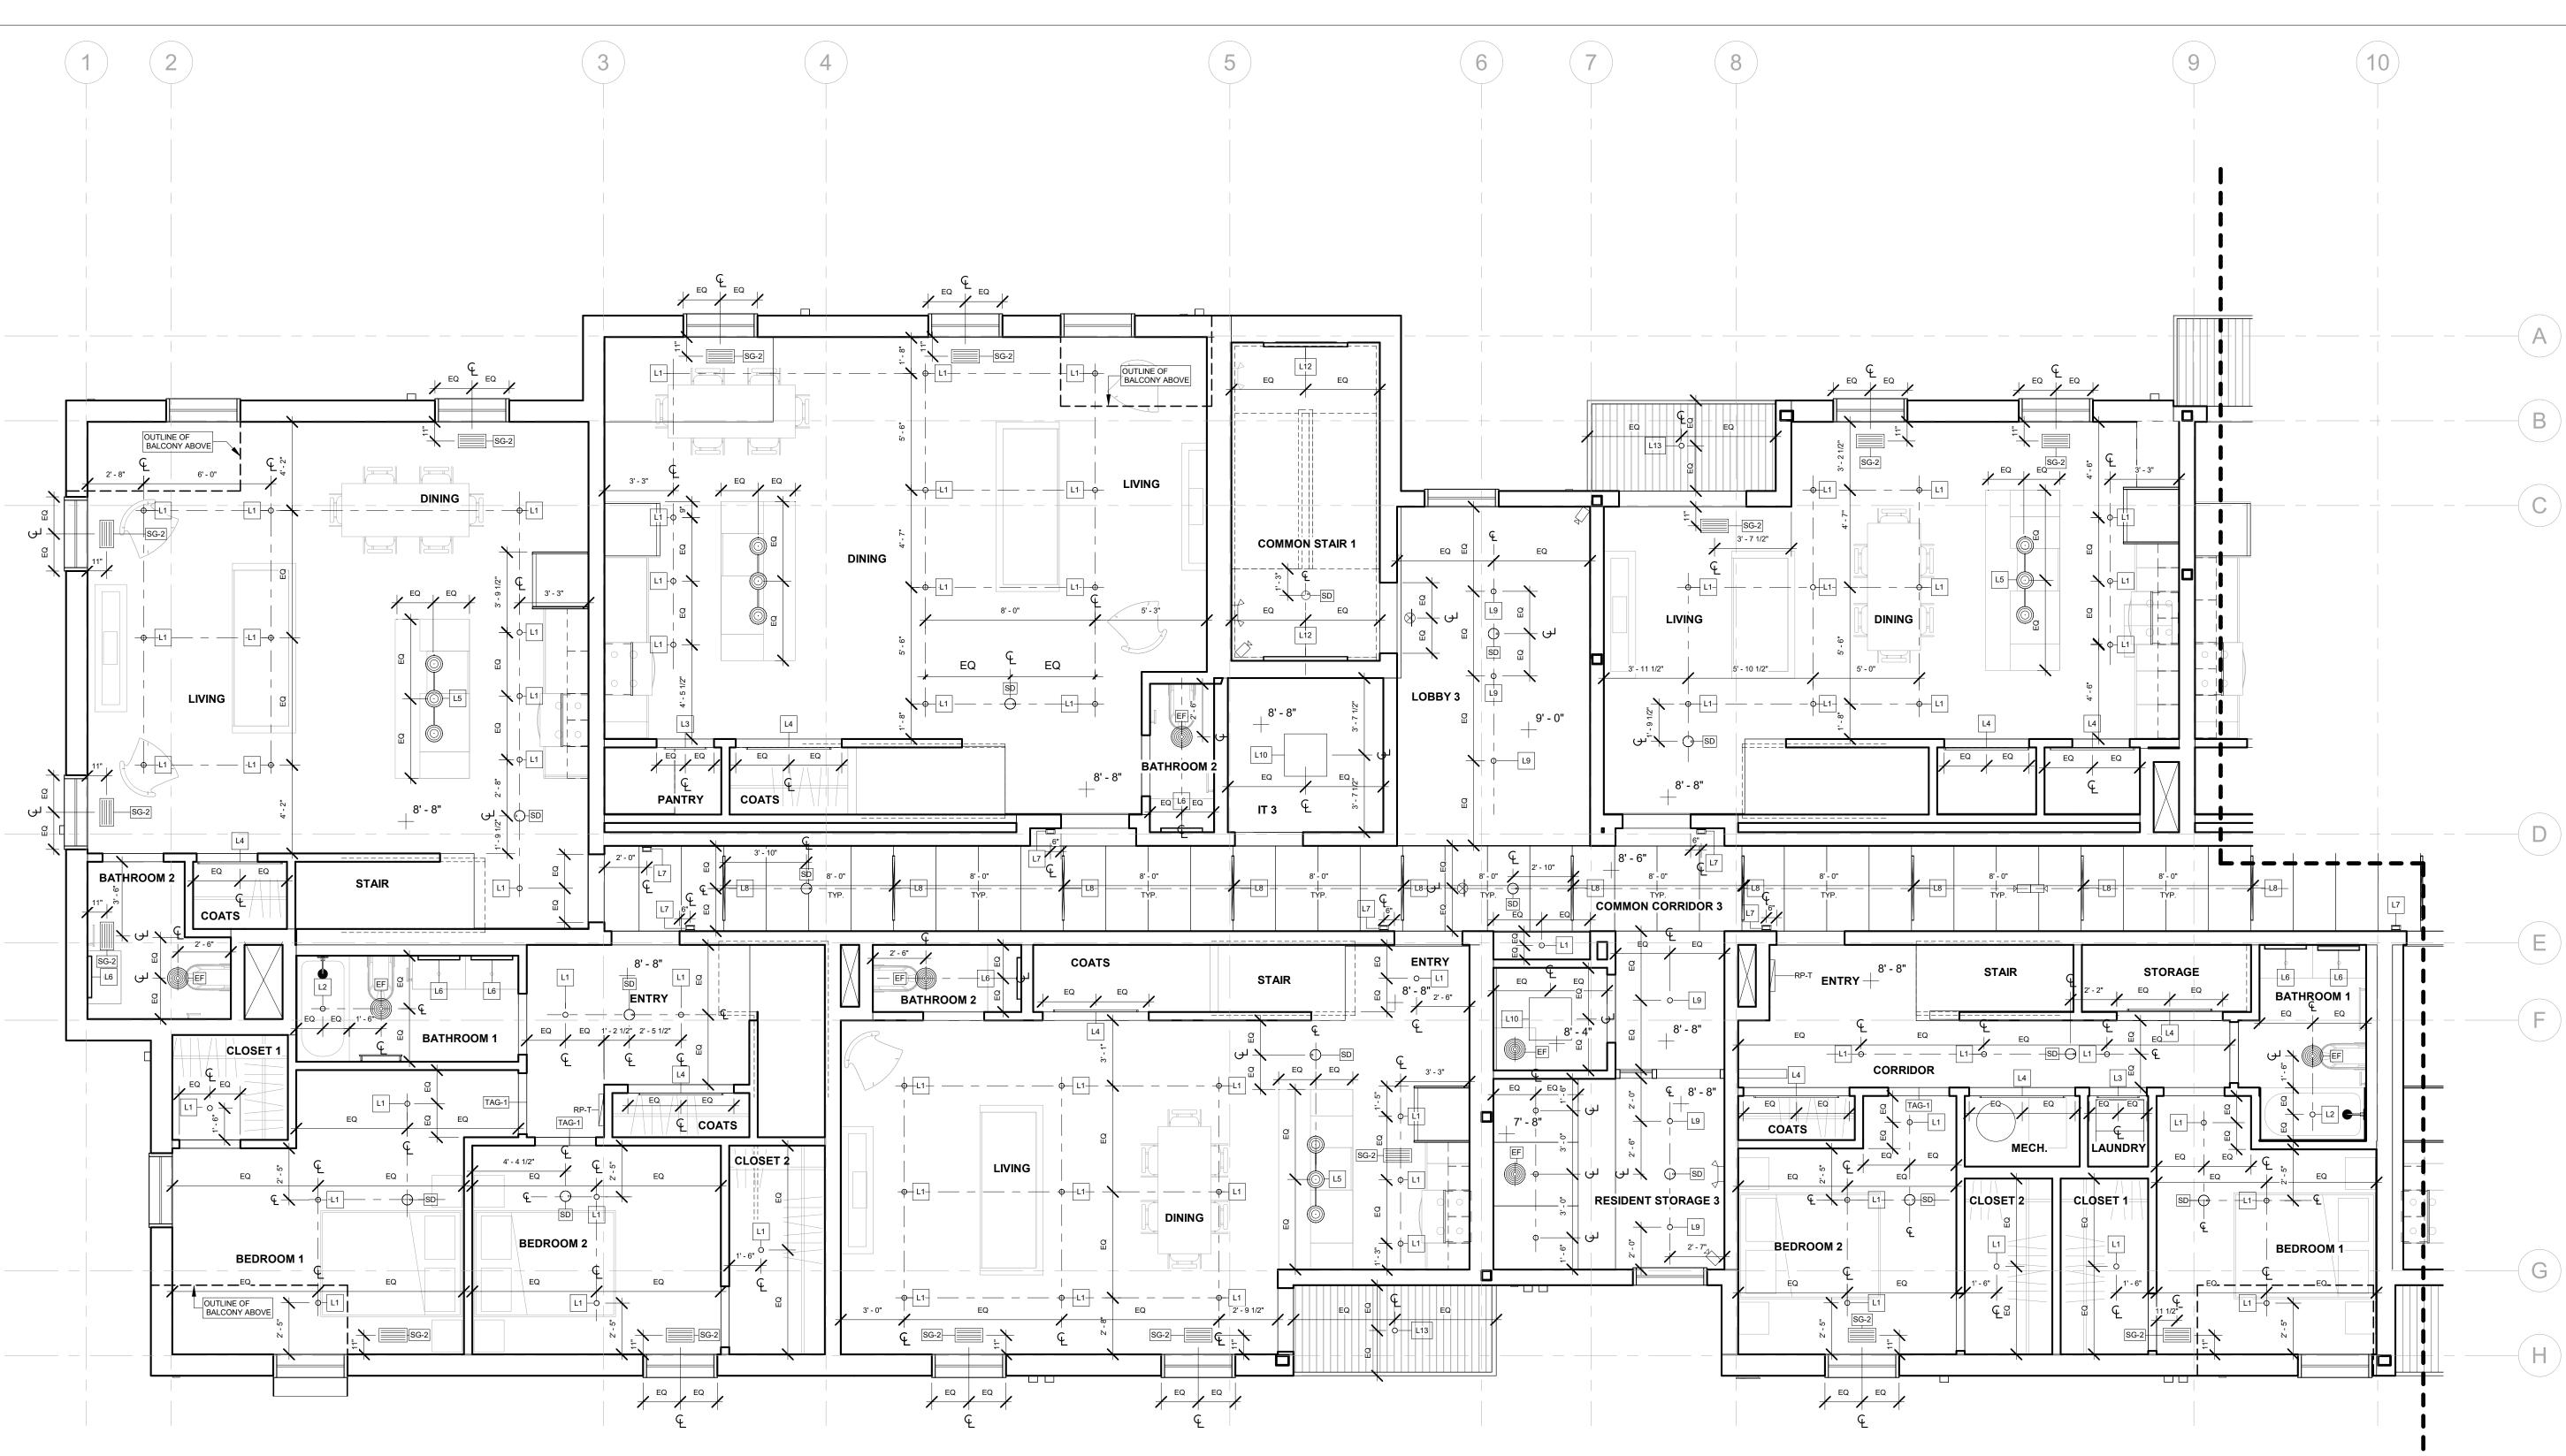
18284 JOB NO.:

SCALE: As indicated

DATE: 05/15/2020 DRAWING TITLE

THIRD FLOOR RCP

SHEET NO.



1 3rd FLOOR - WEST 1/4" = 1'-0"


LIGHTING LEGEND		
Type Mark	Description	
	120V EMERGENCY LIGHT FIXTURE	
L1	Surface Mounted Slim Downlight	
L2	Surface Mounted Slim Downlight	
L3	Lightstick 25" (Motion Sensor)	
L4	Lightstick 49" (Motion Sensor)	
L5	Pendant	
L6	Vanity Light	
L7	Small Sconce	
L8	Linear Downlight ACT System Clip-On	
L9	Surface Mounted Slim Downlight	
L10	Surface Mounted Downlight	
L12	Linear Wall Sconce	
L13	Recessed Can Light (Exterior)	
L14	Small Sconce (Exterior)	
L15	In-grade LED Light (Exterior)	
L16	Wall Mounted Sconce (Exterior)	

VENTS & TERMINATIONS LEGEND		
Type Mark	Location	Description
EF		Ceiling Exhaust Fan
FG-1	Interior Floor	Floor Register
FG-2	Interior Floor	Floor Register
OA	Exterior	Vent Termination
ORS-1	Roof	Roof Overflow Drain
RS-1	Roof	Roof Drain
SG-2	Unit Ceilings	Ceiling Register
TAG-1	Interior Wall	Wall Register
VD	Exterior	Vent Termination
VE	Exterior	Vent Termination
VF	Exterior	Furnace Vent Termination
VT	Exterior	Vent Termination

ENLARGED RCP GENERAL NOTES

AT ROOF.

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- DIMENSIONS ARE TO CENTERLINE OF FIXTURES AND DEVICES, U.O.N. ACCESS DOOR ON CEILINGS TO BE FRAMELESS AND PAINTED TO MATCH CEILING. COORDINATE LOCATIONS WITH ARCHITECT. TAKE CARE OF AIRSEAL AROUND OPENING ON CEILING
- TAKE CARE OF AIRSEAL AROUND LIGHTING FIXTURES AND ANY SUCH OPENINGS ON THE CEILING ROOF.
- MECHANICAL DEVICES, WIREWAYS, ACCESS PANELS, ETC. TO BE FINISHED TO MATCH ADJACENT SURFACE, U.O.N.
- COORDINATE LOCATIONS OF FP SPRINKLER HEADS WITH ARCHITECT.

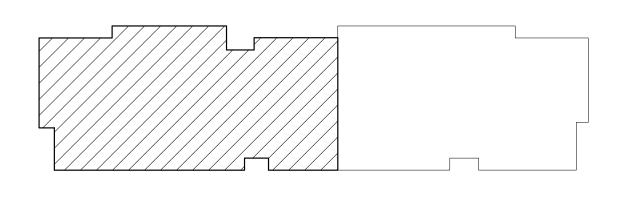

A113A KEY PLAN

REGISTRATION



OWNER BRUSH PARK DEVELOPMENT COMPANY PHASE 1 LLC 1092 WOODWARD AVE.

ARCHITECT

MERGE ARCHITECTS, INC. 332 CONGRESS ST. FLOOR 6 BOSTON, MA 02210 T: 617.670.0265

STRUCTURAL ENGINEER ENGINEERED STRUCTURES, LLC. 632 BARRY STREET SW GRANDVILLE, MI 49418 T: 616-667-9650

MP/FP ENGINEER SELLINGER ASSOCIATES, INC. 19821 FARMINGTON ROAD, LIVONIA, MI 48152 T: 248-482-0045 F: 248-482-0052

ELECTRICAL ENGINEER ETS ENGINEERING, INC.

P.O. BOX 1166 ROYAL OAK, MI 48068 418-1/2 S. WASHINGTON AVE, ROYAL OAK, MI 48067

CODE CONSULTANT

CODE RED CONSULTANTS 154 TURNPIKE ROAD, SUITE 200 SOUTHBOROUGH MA, 01772

and Duplette ld Place srush St. 48201 0 dmur setween E etroit MI, On Bet Det 05/15/20: 100% CD / PERMIT SET

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18284 JOB NO.: SCALE: As indicated


DATE: 05/15/2020

DRAWING TITLE

THIRD FLOOR RCP -**WEST**

SHEET NO.

A-113A

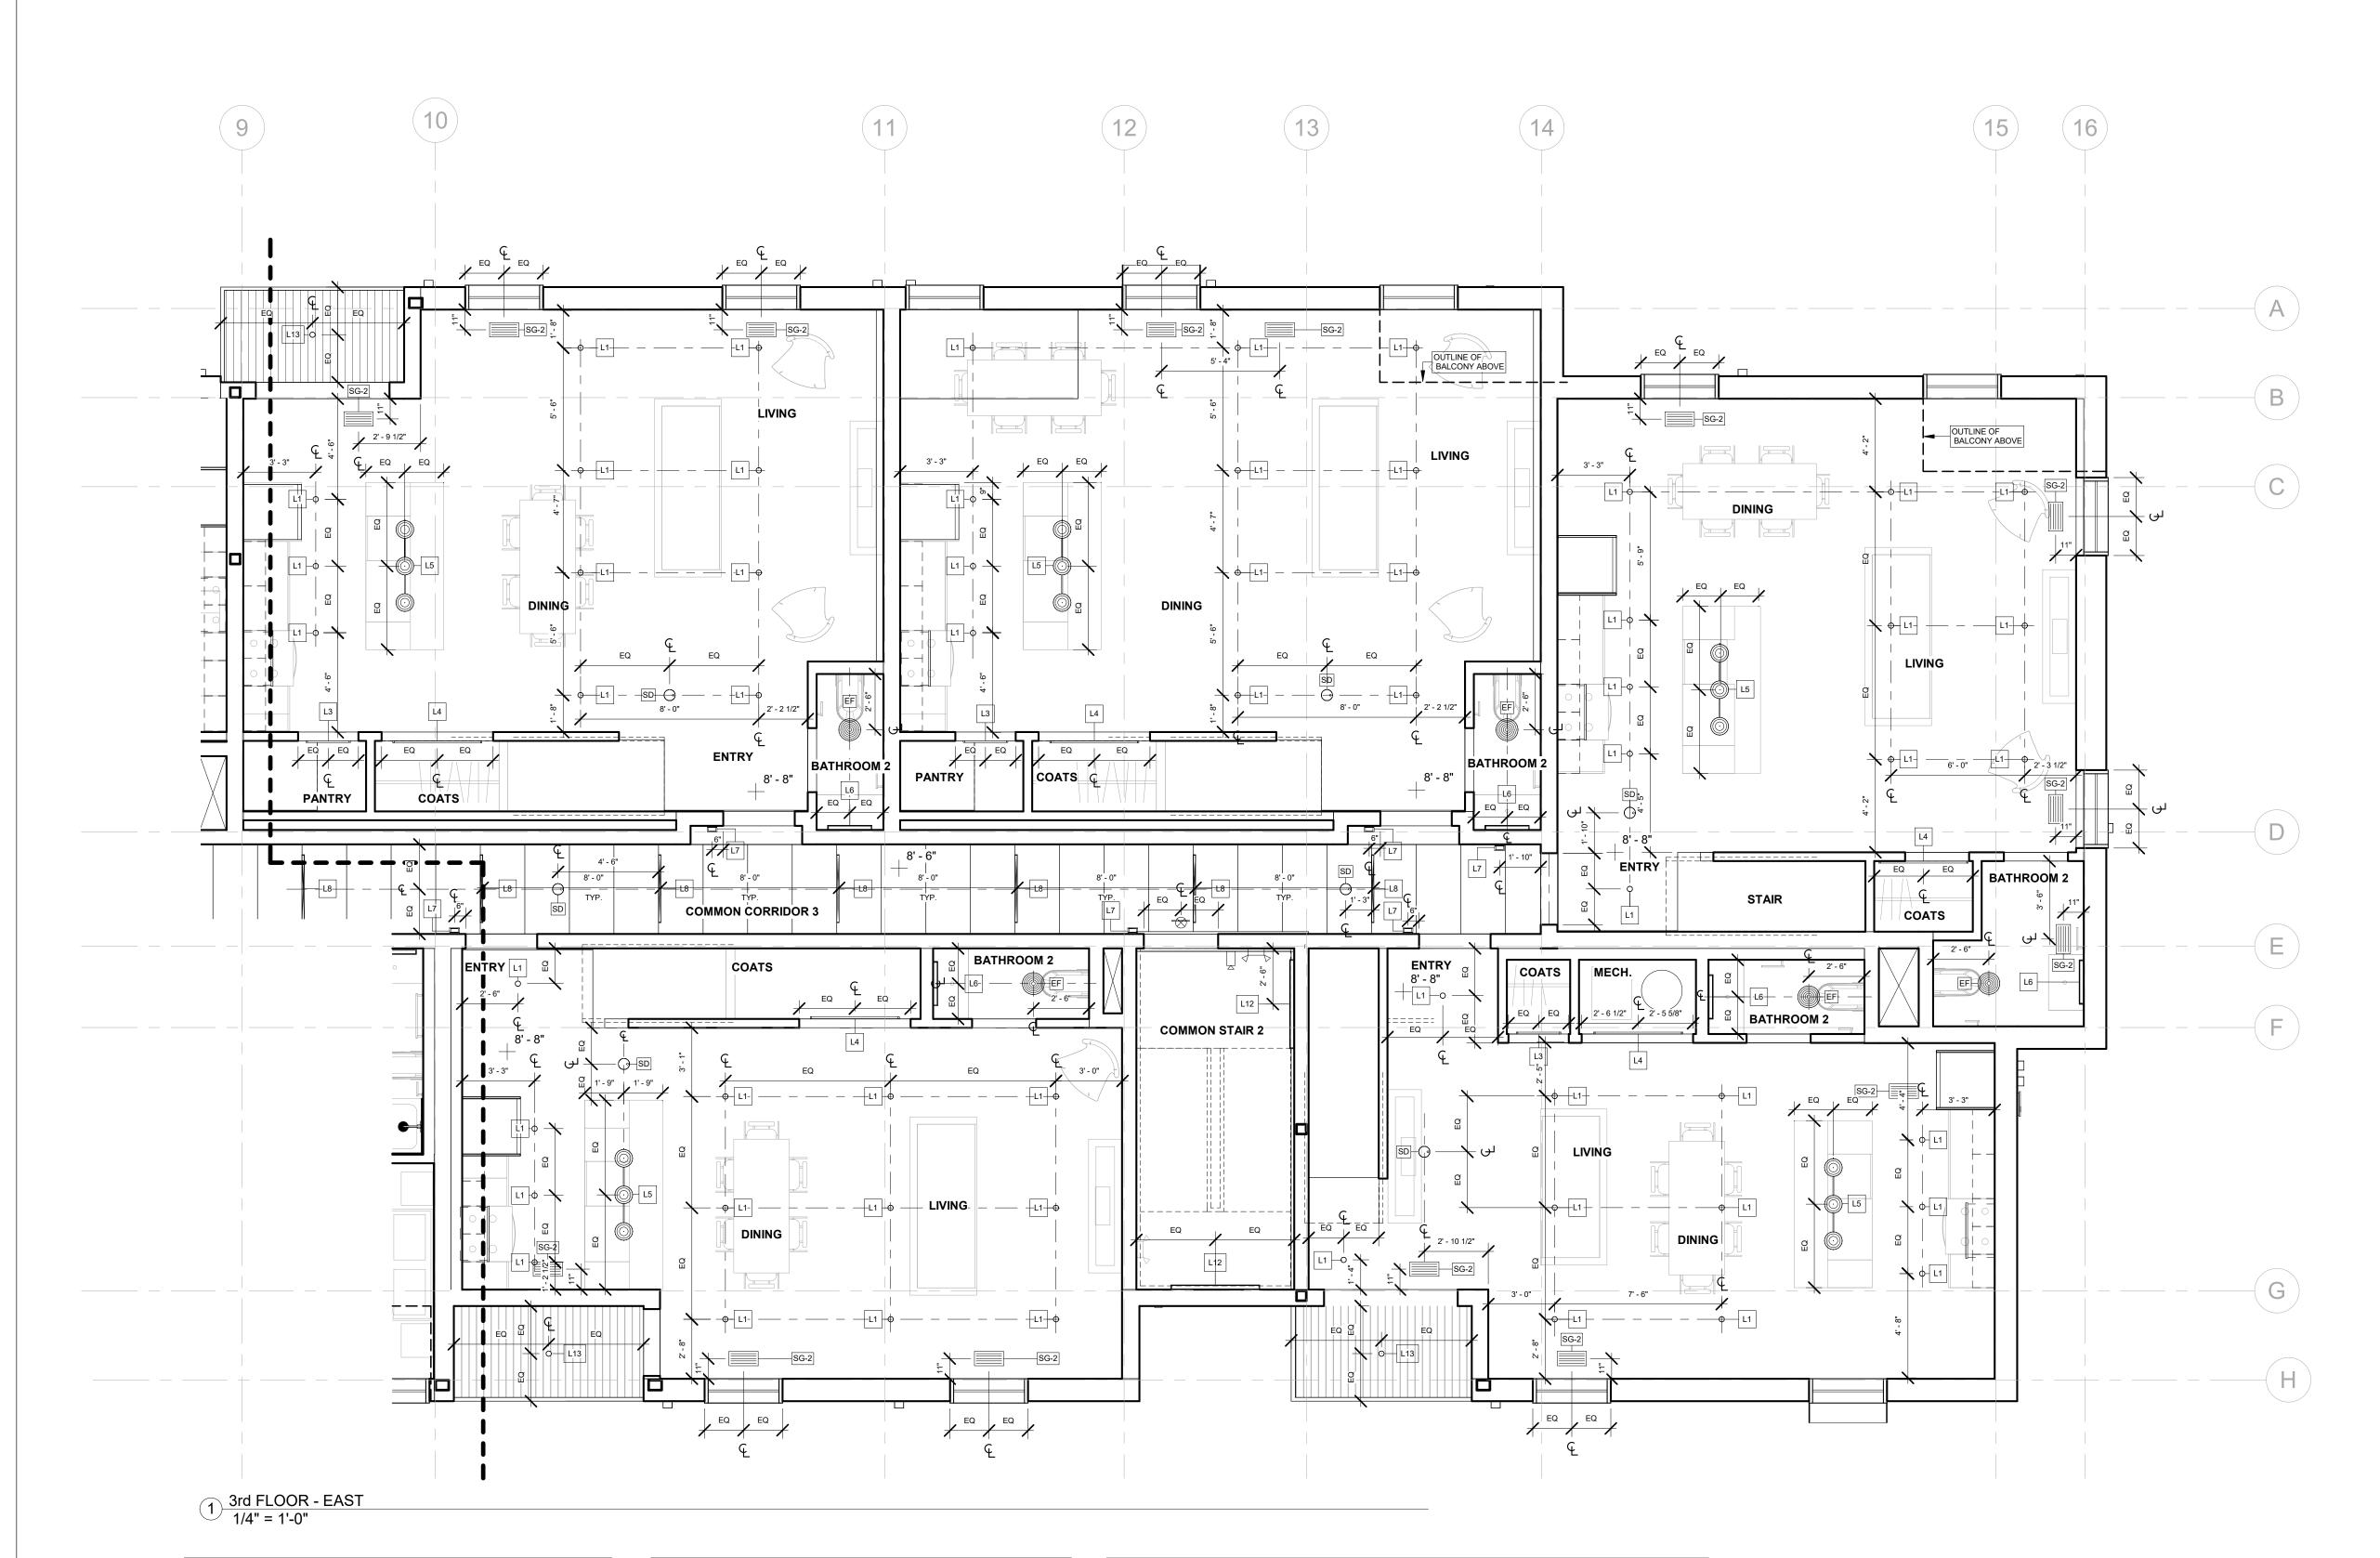


LIGHTING LEGEND			
Type Mark	Description		
	120V EMERGENCY LIGHT FIXTURE		
L1	Surface Mounted Slim Downlight		
L2	Surface Mounted Slim Downlight		
L3	Lightstick 25" (Motion Sensor)		
L4	Lightstick 49" (Motion Sensor)		
L5	Pendant		
L6	Vanity Light		
L7	Small Sconce		
L8	Linear Downlight ACT System Clip-On		
L9	Surface Mounted Slim Downlight		
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L14	Small Sconce (Exterior)		
L15	In-grade LED Light (Exterior)		
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VENTS & TERMINATIONS LEGEND		
Type Mark	Location	Description
EF		Ceiling Exhaust Fan
FG-1	Interior Floor	Floor Register
FG-2	Interior Floor	Floor Register
OA	Exterior	Vent Termination
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RS-1	Roof	Roof Drain
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VF	Exterior	Furnace Vent Termination
VT	Exterior	Vent Termination

ENLARGED RCP GENERAL NOTES

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- COORDINATE LOCATIONS OF FP SPRINKLER HEADS WITH ARCHITECT.

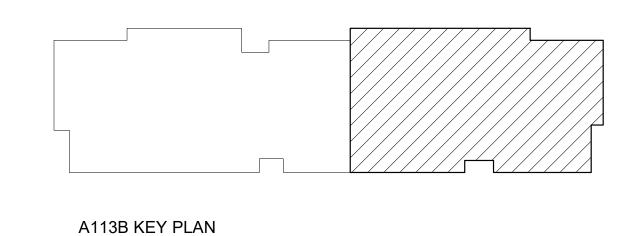

REGISTRATION



OWNER BRUSH PARK DEVELOPMENT COMPANY PHASE 1 LLC 1092 WOODWARD AVE. DETROIT, MI 48226

ARCHITECT

MERGE ARCHITECTS, INC. 332 CONGRESS ST. FLOOR 6 BOSTON, MA 02210 T: 617.670.0265

STRUCTURAL ENGINEER ENGINEERED STRUCTURES, LLC. 632 BARRY STREET SW GRANDVILLE, MI 49418 T: 616-667-9650

MP/FP ENGINEER

SELLINGER ASSOCIATES, INC. 19821 FARMINGTON ROAD, LIVONIA, MI 48152 T: 248-482-0045 F: 248-482-0052 ELECTRICAL ENGINEER

ETS ENGINEERING, INC. P.O. BOX 1166 ROYAL OAK, MI 48068 418-1/2 S. WASHINGTON AVE, ROYAL OAK, MI 48067

CODE CONSULTANT

CODE RED CONSULTANTS 154 TURNPIKE ROAD, SUITE 200 SOUTHBOROUGH MA, 01772

Duplette

John

and

d Place srush St. 48201 Q On Edmun Between E Detroit MI,

05/15/20: 100% CD / PERMIT SET

THE CONTRACTOR IS RESPONSIBLE
FOR MATERIALS, DETAILS AND
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JOB NO.: SCALE: As indicated


DATE: 05/15/2020

DRAWING TITLE

THIRD FLOOR RCP -**EAST**

SHEET NO.

A-113B

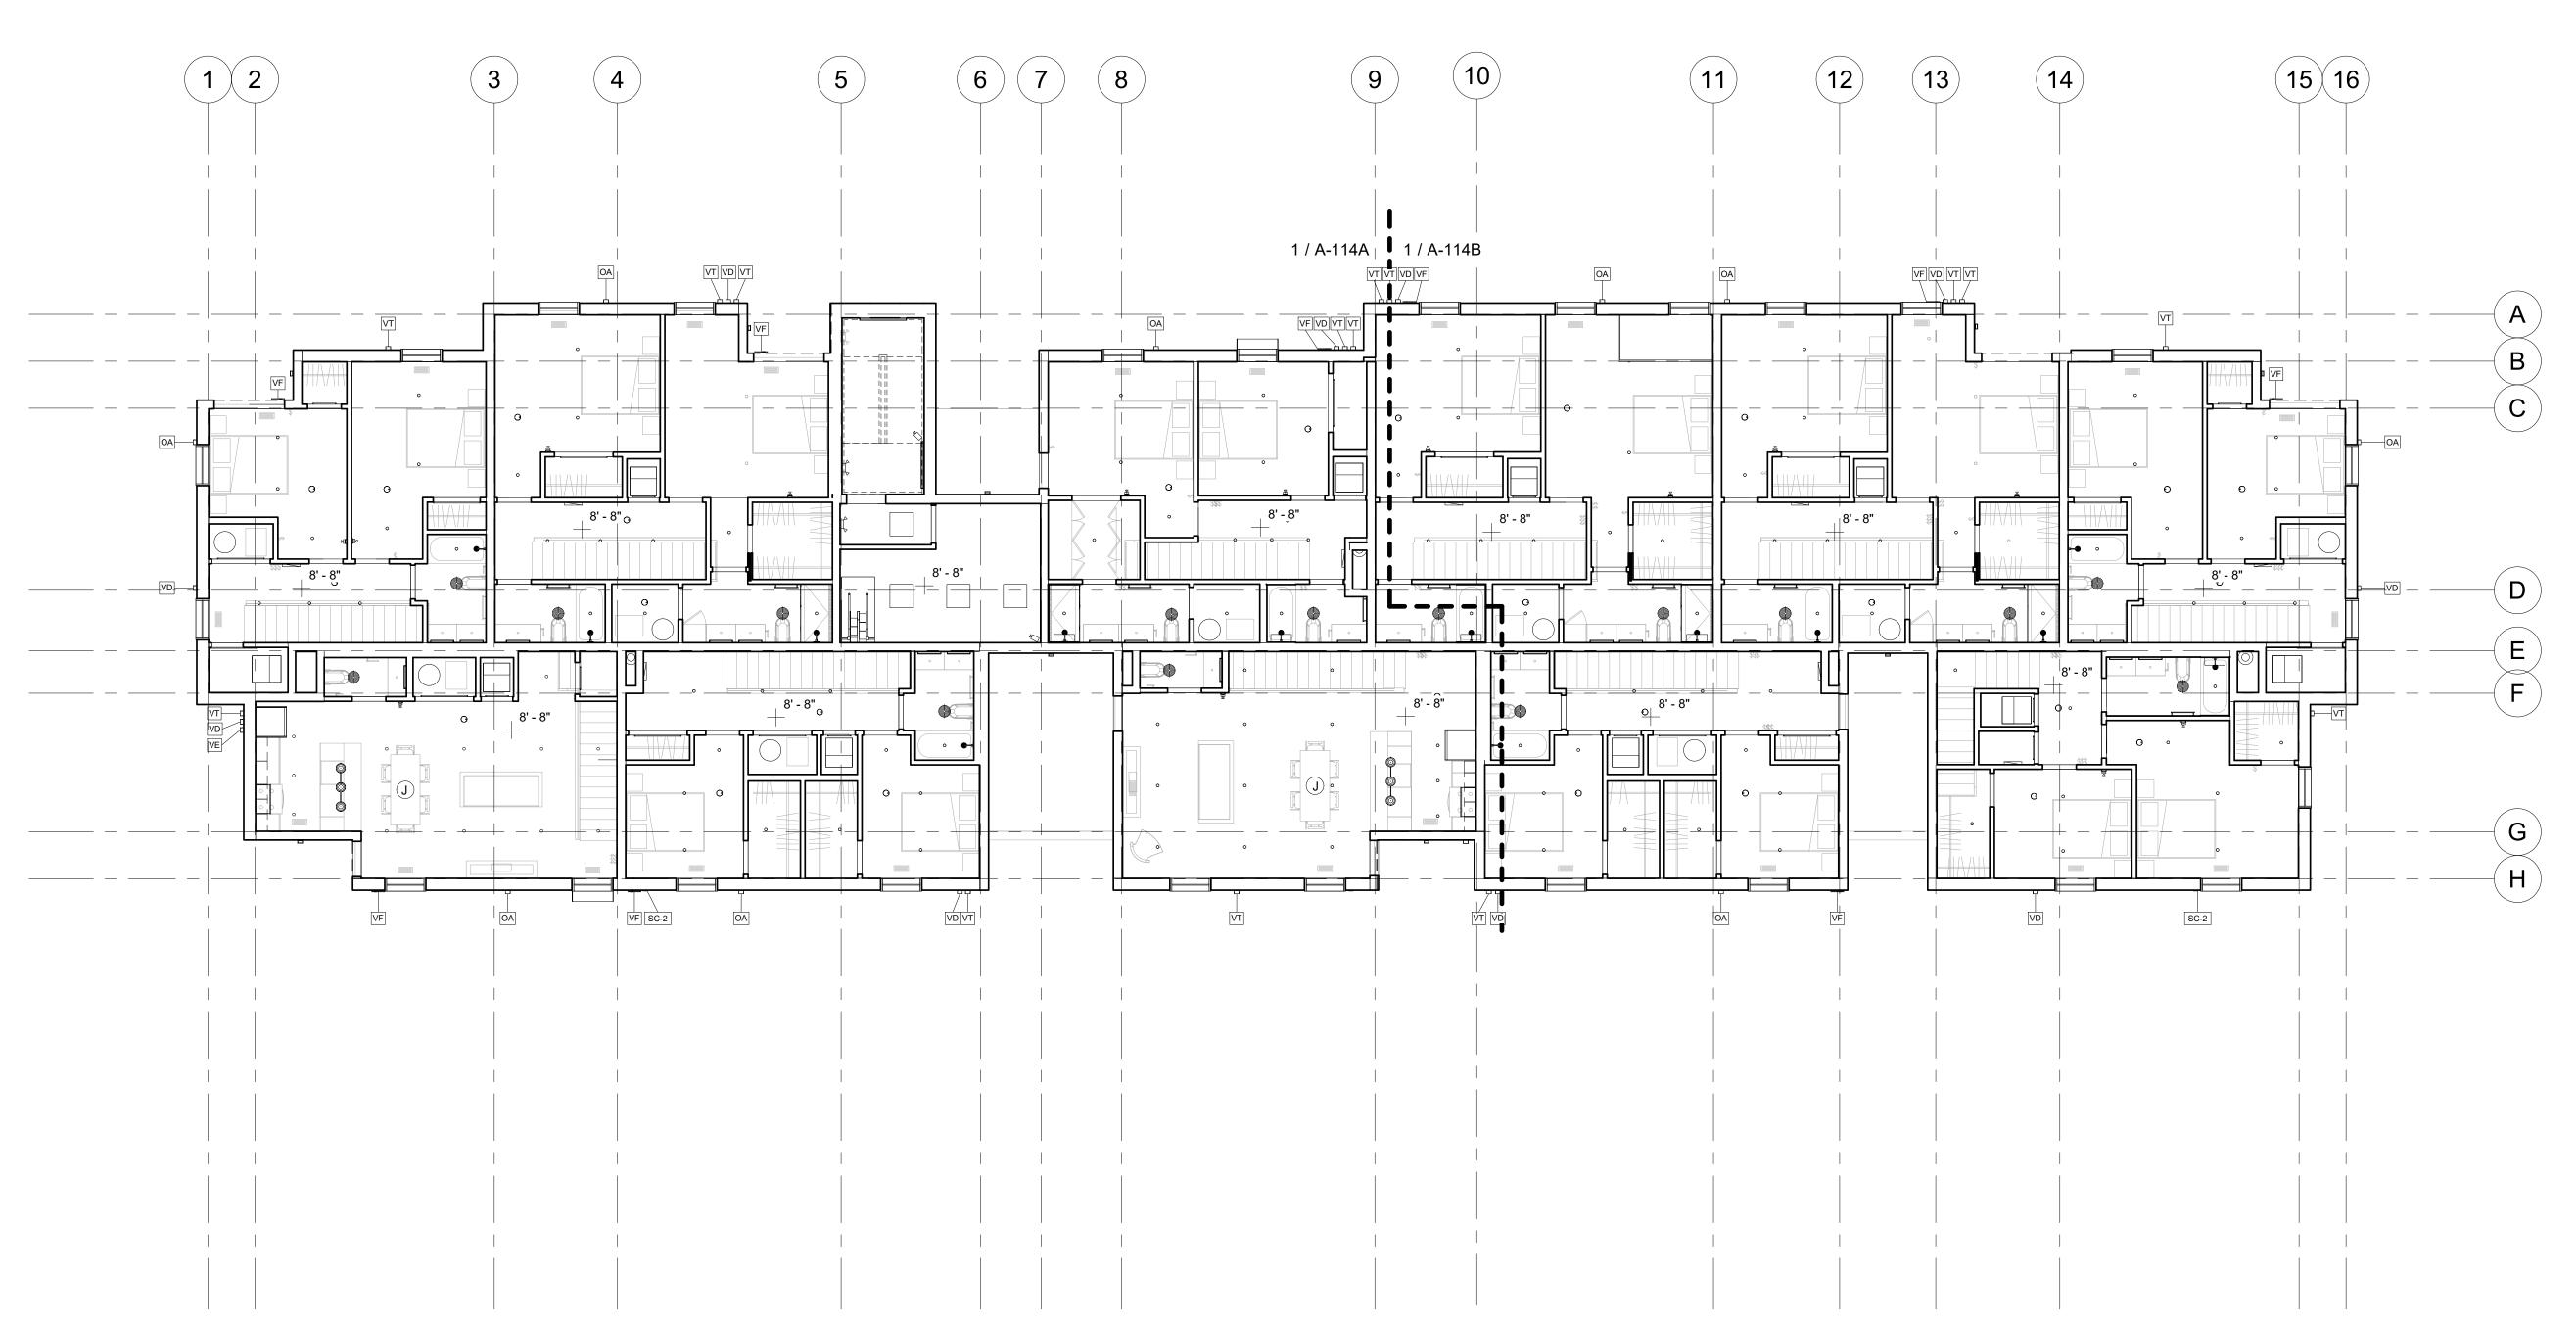


1	4th FLOOR
	1/8" = 1'-0"

VENTS & TERMINATIONS LEGEND			
Type Mark	Location	Description	
EF		Ceiling Exhaust Fan	
FG-1	Interior Floor	Floor Register	
FG-2	Interior Floor	Floor Register	
OA	Exterior	Vent Termination	
ORS-1	Roof	Roof Overflow Drain	
RS-1	Roof	Roof Drain	
SG-2	Unit Ceilings	Ceiling Register	
TAG-1	Interior Wall	Wall Register	
VD	Exterior	Vent Termination	
VE	Exterior	Vent Termination	
VF	Exterior	Furnace Vent Termination	
VT	Exterior	Vent Termination	

OVERALL RCP GENERAL NOTES

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A114 KEY PLAN

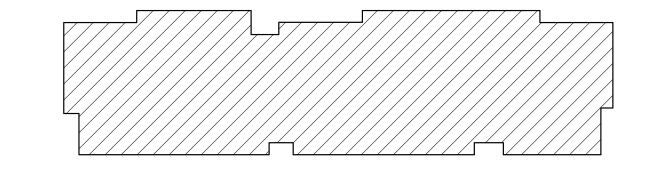REGISTRATION



OWNER BRUSH PARK DEVELOPMENT COMPANY PHASE 1 LLC 1092 WOODWARD AVE. DETROIT, MI 48226

ARCHITECT

MERGE ARCHITECTS, INC. 332 CONGRESS ST. FLOOR 6 BOSTON, MA 02210 T: 617.670.0265

STRUCTURAL ENGINEER ENGINEERED STRUCTURES, LLC. 632 BARRY STREET SW GRANDVILLE, MI 49418 T: 616-667-9650

MP/FP ENGINEER

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ETS ENGINEERING, INC.
P.O. BOX 1166 ROYAL OAK, MI 48068
418-1/2 S. WASHINGTON AVE, ROYAL OAK, MI 48067
T: 248-744-0360

CODE CONSULTANT

CODE RED CONSULTANTS 154 TURNPIKE ROAD, SUITE 200 SOUTHBOROUGH MA, 01772

John and Duplette d Place rush St. 48201

p **Brush Park**On Edmunc
Between Br
Detroit MI, 4

05/15/20: 100% CD / PERMIT SET

THE CONTRACTOR IS RESPONSIBLE FOR MATERIALS, DETAILS AND ACCURACY, FOR ALL QUANTITIES AND DIMENSIONS, FOR SELECTING FABRICATION PROCESSES, FOR TECHNIQUES OF ASSEMBLY, FOR PERFORMING WORK IN A SAFE MANNER, AND FOR COORDINATING WORK WITH THAT OF ALL TRADES


18284 JOB NO.: SCALE: As indicated

DATE: 05/15/2020

DRAWING TITLE

FOURTH FLOOR RCP

SHEET NO.

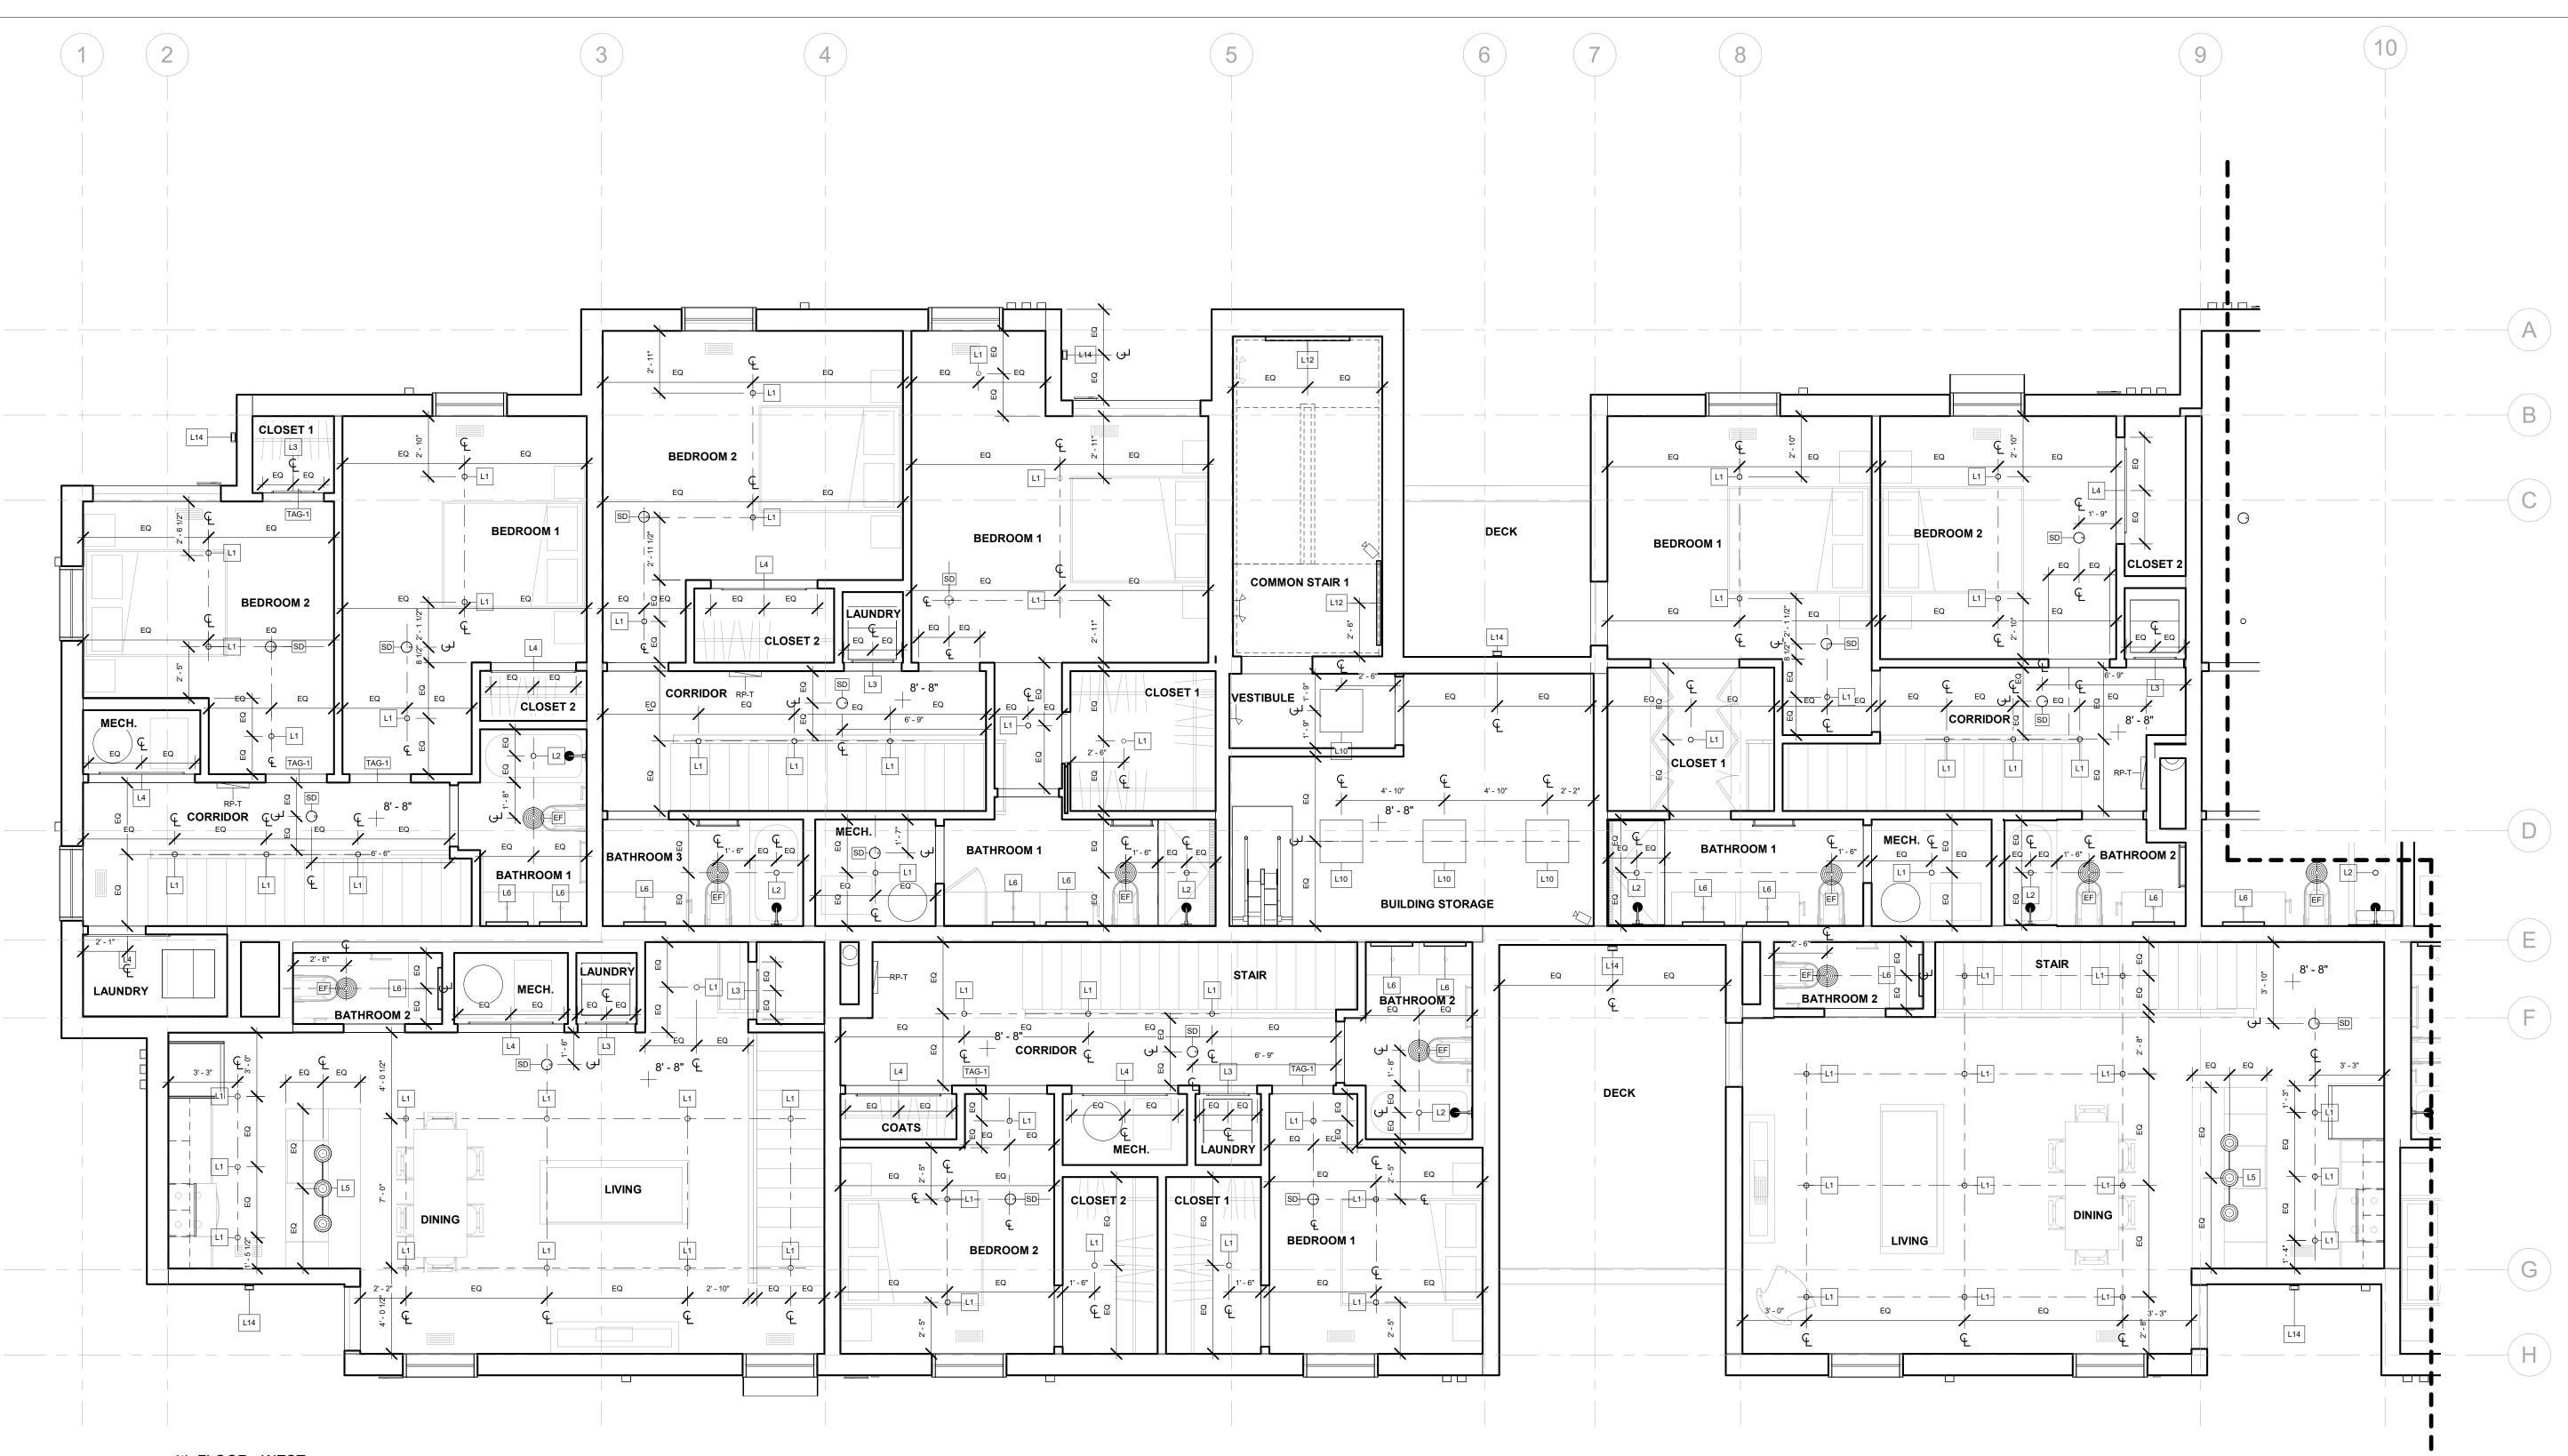


1 4th FLOOR - WEST 1/4" = 1'-0"

LIGHTING LEGEND				
Type Mark	Description			
	120V EMERGENCY LIGHT FIXTURE			
L1	Surface Mounted Slim Downlight			
L2	Surface Mounted Slim Downlight			
L3	Lightstick 25" (Motion Sensor)			
L4	Lightstick 49" (Motion Sensor)			
L5	Pendant			
L6	Vanity Light			
L7	Small Sconce			
L8	Linear Downlight ACT System Clip-On			
L9	Surface Mounted Slim Downlight			
L10	Surface Mounted Downlight			
L12	Linear Wall Sconce			
L13	Recessed Can Light (Exterior)			
L14	Small Sconce (Exterior)			
L15	In-grade LED Light (Exterior)			
L16	Wall Mounted Sconce (Exterior)			

VENTS & TERMINATIONS LEGEND				
Type Mark	Location	Description		
EF		Ceiling Exhaust Fan		
FG-1	Interior Floor	Floor Register		
FG-2	Interior Floor	Floor Register		
OA	Exterior	Vent Termination		
ORS-1	Roof	Roof Overflow Drain		
RS-1	Roof	Roof Drain		
SG-2	Unit Ceilings	Ceiling Register		
TAG-1	Interior Wall	Wall Register		
VD	Exterior	Vent Termination		
VE	Exterior	Vent Termination		
VF	Exterior	Furnace Vent Terminatio		
VT	Exterior	Vent Termination		

ENLARGED RCP GENERAL NOTES

- DIMENSIONS ARE TO FINISHED FACE OF WALLS, U.O.N.
- DIMENSIONS ARE TO CENTERLINE OF FIXTURES AND DEVICES, U.O.N. ACCESS DOOR ON CEILINGS TO BE FRAMELESS AND PAINTED TO MATCH CEILING. COORDINATE LOCATIONS WITH ARCHITECT. TAKE CARE OF AIRSEAL AROUND OPENING ON CEILING
- AT ROOF. TAKE CARE OF AIRSEAL AROUND LIGHTING FIXTURES AND ANY SUCH OPENINGS ON THE CEILING ROOF.
- MECHANICAL DEVICES, WIREWAYS, ACCESS PANELS, ETC. TO BE FINISHED TO MATCH ADJACENT SURFACE, U.O.N.
- COORDINATE LOCATIONS OF FP SPRINKLER HEADS WITH ARCHITECT.

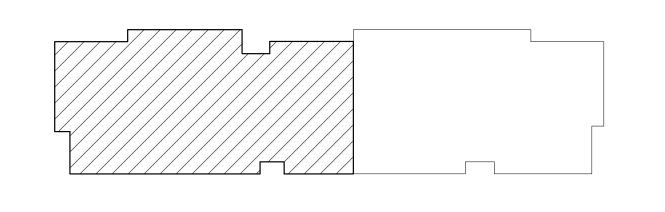

A114A KEY PLAN

REGISTRATION

ELIZABETH LEE ARCHITEOT No.

OWNER BRUSH PARK DEVELOPMENT COMPANY PHASE 1 LLC 1092 WOODWARD AVE. DETROIT, MI 48226

ARCHITECT

MERGE ARCHITECTS, INC. 332 CONGRESS ST. FLOOR 6 BOSTON, MA 02210 T: 617.670.0265 STRUCTURAL ENGINEER

ENGINEERED STRUCTURES, LLC. 632 BARRY STREET SW GRANDVILLE, MI 49418 T: 616-667-9650

MP/FP ENGINEER SELLINGER ASSOCIATES, INC. 19821 FARMINGTON ROAD, LIVONIA, MI 48152 T: 248-482-0045 F: 248-482-0052

ELECTRICAL ENGINEER ETS ENGINEERING, INC. P.O. BOX 1166 ROYAL OAK, MI 48068 418-1/2 S. WASHINGTON AVE, ROYAL OAK, MI 48067

CODE CONSULTANT

CODE RED CONSULTANTS 154 TURNPIKE ROAD, SUITE 200 SOUTHBOROUGH MA, 01772

and Duplette d Place srush St. 48201 D

05/15/20: 100% CD / PERMIT SET

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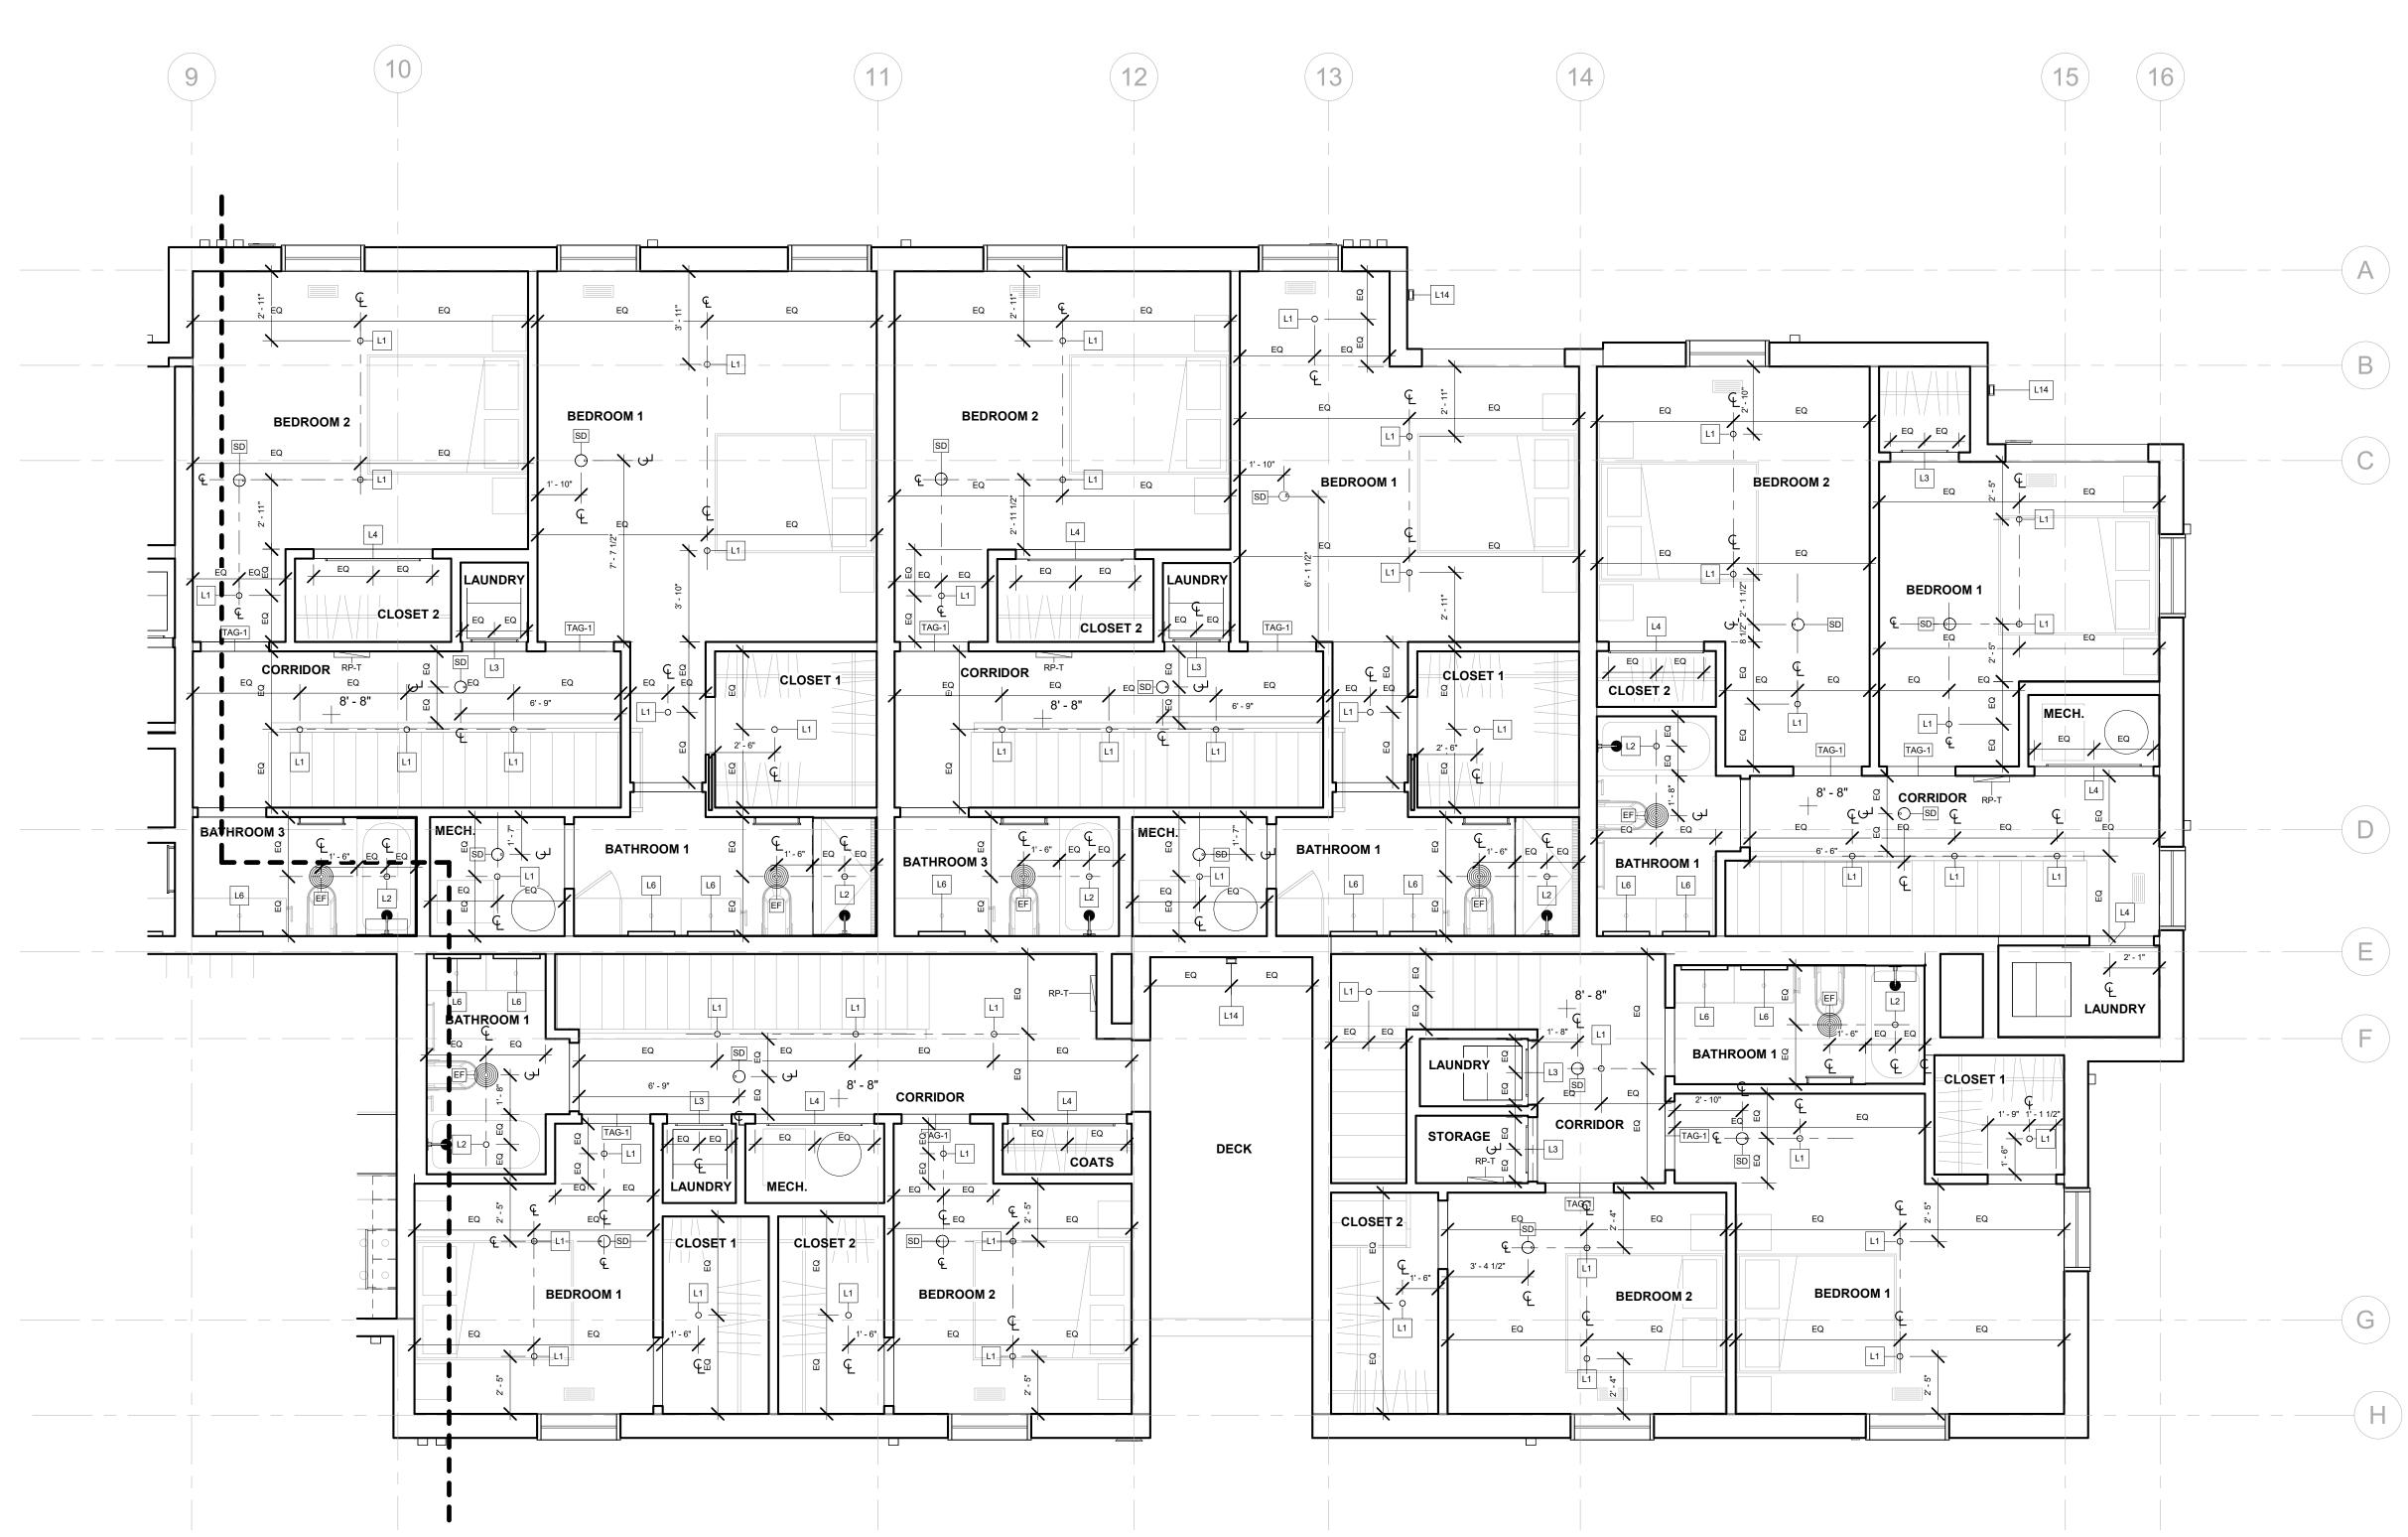
JOB NO.: SCALE: As indicated

DATE: 05/15/2020 DRAWING TITLE

FOURTH FLOOR RCP -**WEST**

SHEET NO.

A-114A




1 4th FLOOR - EAST 1/4" = 1'-0"

LIGHTING LEGEND				
Type Mark	Description			
	120V EMERGENCY LIGHT FIXTURE			
L1	Surface Mounted Slim Downlight			
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L3	Lightstick 25" (Motion Sensor)			
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VF	Exterior	Furnace Vent Termination		
VT	Exterior	Vent Termination		

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- MECHANICAL DEVICES, WIREWAYS, ACCESS PANELS, ETC. TO BE
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- COORDINATE LOCATIONS OF FP SPRINKLER HEADS WITH ARCHITECT.



REGISTRATION

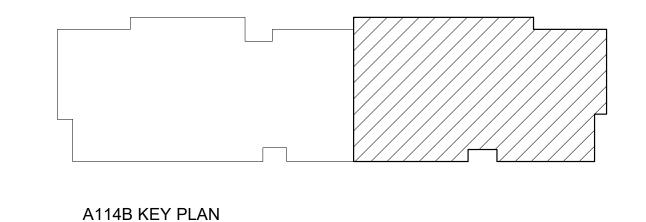

OWNER BRUSH PARK DEVELOPMENT COMPANY PHASE 1 LLC 1092 WOODWARD AVE.

ARCHITECT

DETROIT, MI 48226

MERGE ARCHITECTS, INC. 332 CONGRESS ST. FLOOR 6 BOSTON, MA 02210 T: 617.670.0265

STRUCTURAL ENGINEER ENGINEERED STRUCTURES, LLC. 632 BARRY STREET SW GRANDVILLE, MI 49418 T: 616-667-9650

MP/FP ENGINEER SELLINGER ASSOCIATES, INC. 19821 FARMINGTON ROAD, LIVONIA, MI 48152 T: 248-482-0045 F: 248-482-0052

ELECTRICAL ENGINEER ETS ENGINEERING, INC.

P.O. BOX 1166 ROYAL OAK, MI 48068 418-1/2 S. WASHINGTON AVE, ROYAL OAK, MI 48067

CODE CONSULTANT

CODE RED CONSULTANTS 154 TURNPIKE ROAD, SUITE 200 SOUTHBOROUGH MA, 01772

John and **Duplette** d Place srush St. 48201

On Bet Det

D

05/15/20: 100% CD / PERMIT SET

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18284 JOB NO.:

SCALE: As indicated

DATE: 05/15/2020

DRAWING TITLE

FOURTH FLOOR RCP -**EAST**

SHEET NO.





OWNER BRUSH PARK DEVELOPMENT COMPANY PHASE 1 LLC 1092 WOODWARD AVE. DETROIT, MI 48226

ARCHITECT MERGE ARCHITECTS, INC. 332 CONGRESS ST. FLOOR 6 BOSTO, MO2210

T: 617.670.0265 STRUCTURAL ENGINEER ENGINEERED STRUCTURES, LLC.

632 BARRY STREET SW GRANDVILLE, MI 49418 T: 616-667-9650 **MP/FP ENGINEER** SELLINGER ASSOCIATES, INC.

19821 FARMINGTON ROAD, LIVONIA, MI 48152 T: 248-482-0045 F: 248-482-0052

ELECTRICAL ENGINEER ETS ENGINEERING, INC. P.O. BOX 1166 ROYAL OAK, MI 48068 418-1/2 S. WASHINGTON AVE, ROYAL OAK, MI 48067

CODE CONSULTANT

CODE RED CONSULTANTS 154 TURNPIKE ROAD, SUITE 200 SOUTHBOROUGH MA, 01772

ohn and **Duplette** St. rush \$4820 Pla(p Par dmur etween E rush

THE CONTRACTOR IS RESPONSIBLE FOR MATERIALS, DETAILS AND ACCURACY, FOR ALL QUANTITIES AND DIMENSIONS, FOR SELECTING FABRICATION PROCESSES, FOR **TECHNIQUES OF ASSEMBLY, FOR** PERFORMING WORK IN A SAFE MANNER, AND FOR COORDINATING

18284 JOB NO.: SCALE: As indicated

DATE: 05/15/2020


WORK WITH THAT OF ALL TRADES

DRAWING TITLE

EXTERIOR ELEVATIONS

SHEET NO.

A-200

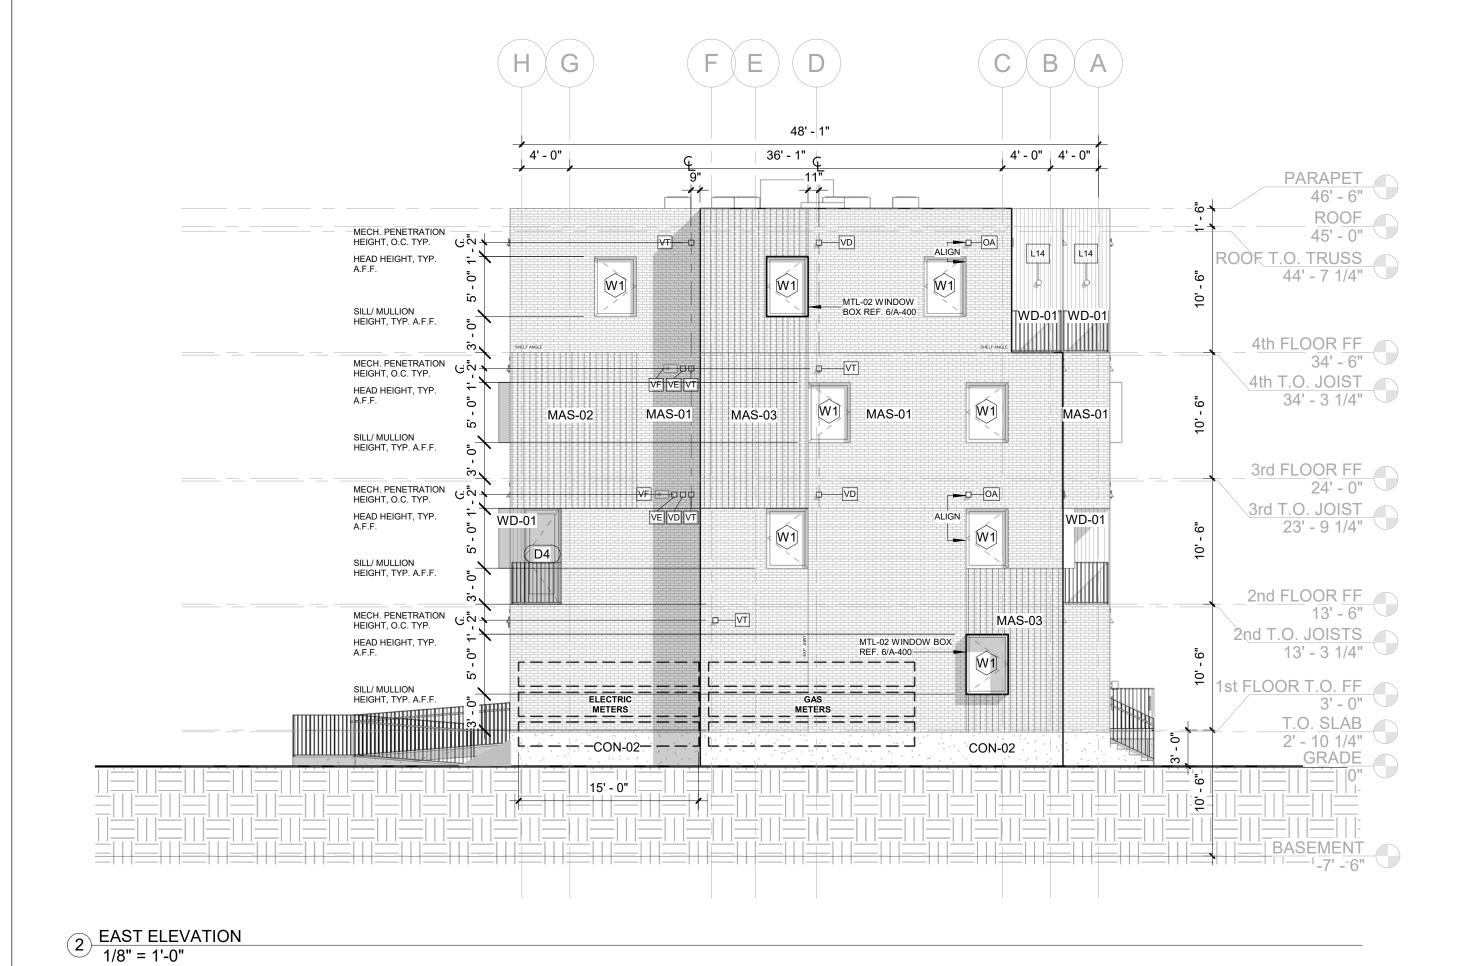

ELEVATIONS GENERAL NOTES


1. SEE OVERALL FLOOR PLANS FOR HORIZONTAL WINDOW LOCATION.


2. SEE A-400 FOR LOCATION AND SCOPE OF TEXTURED

BRICK (MAS-02, MAS-03)

3. AVOID MECHANICAL PENETRATIONS (VD, VE, VF, VT, OA) WITHIN AREAS OF TEXTURED BRICK (MAS-02, MAS-03) 4. GROUP AND ALIGN MECHANICAL PENETRATIONS (VD, VE, VF, VT, OA)

5. SEE A-510 AND A-511 FOR DOOR AND WINDOW DETAILS

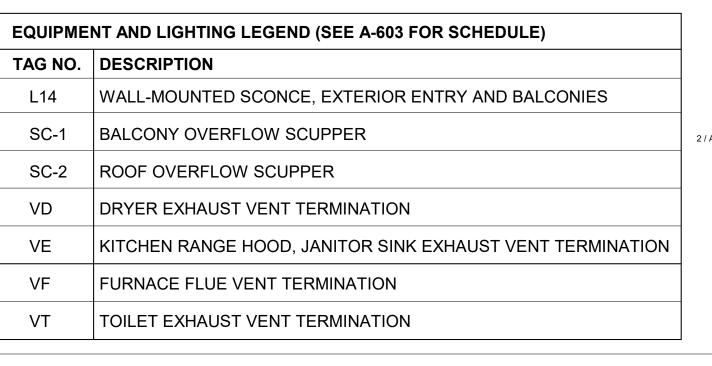

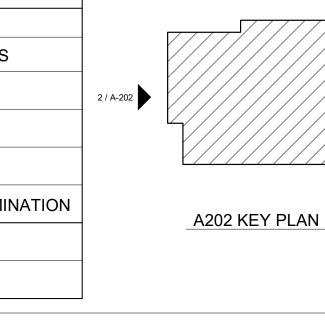

G H

4' - 0"

WD-01

(D4)

MAS-02

WD-01

MAS-01 W1

CON-02

VT VD VE

48' - 1"

MTL-02 WINDOW

MAS-01 W1

MTL-02 WINDOW

BOX REF. 6/A-400

CON-02

~ 36' - 1"

MAS-03

4' - 0" | 4' - 0"

/ / /

WD-01

WD-01

1 WEST ELEVATION
1/8" = 1'-0"

MECH. PENETRATION € N

MECH. PENETRATION GN HEIGHT, O.C. TYP.

MECH. PENETRATION GO

MECH PENETRATION GN →

HEIGHT, O.C. TYP.

HEAD HEIGHT, TYP.

SILL/ MULLION HEIGHT, TYP. A.F.F.

HEAD HEIGHT, TYP. A.F.F.

HEIGHT, TYP. A.F.F.

HEIGHT, O.C. TYP.

HEAD HEIGHT, TYP. A.F.F.

SILL/ MULLION HEIGHT, TYP. A.F.F.

HEIGHT, O.C. TYP.

HEAD HEIGHT, TYP. A.F.F.

SILL/ MULLION HEIGHT, TYP. A.F.F.

REGISTRATION



OWNER BRUSH PARK DEVELOPMENT COMPANY PHASE 1 LLC 1092 WOODWARD AVE.

ARCHITECT

MERGE ARCHITECTS, INC. 332 CONGRESS ST. FLOOR 6 BOSTON, MA 02210 T: 617.670.0265

STRUCTURAL ENGINEER ENGINEERED STRUCTURES, LLC. 632 BARRY STREET SW GRANDVILLE, MI 49418 T: 616-667-9650

MP/FP ENGINEER SELLINGER ASSOCIATES, INC. 19821 FARMINGTON ROAD, LIVONIA, MI 48152 T: 248-482-0045

F: 248-482-0052 **ELECTRICAL ENGINEER**

ETS ENGINEERING, INC. P.O. BOX 1166 ROYAL OAK, MI 48068 418-1/2 S. WASHINGTON AVE, ROYAL OAK, MI 48067

CODE CONSULTANT

CODE RED CONSULTANTS 154 TURNPIKE ROAD, SUITE 200 SOUTHBOROUGH MA, 01772

PARAPET _

ROOF

44' - 7 1/4"

4th FLOOR FF 34' - 6"

4th T.O. JOIST 34' - 3 1/4"

3rd FLOOR FF

3rd T.O. JOIST

2nd FLOOR FF

2nd T.O. JOISTS

1st FLOOR T.O. FF

23' - 9 1/4"

13' - 6"

13' - 3 1/4"

T.O. SLAB

2' - 10 1/4" GRADE

ROOF T.O. TRUSS

ohn and **Duplette** St. rush (4820 Pla(Park р In Edmund Setween Br Detroit MI, 4 **rush** In Edr On Bet Det

05/15/20: 100% CD / PERMIT SET

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18284 JOB NO.: SCALE: As indicated


DATE: 05/15/2020

DRAWING TITLE


EXTERIOR ELEVATIONS

3 / A-202 SHEET NO.

A-201

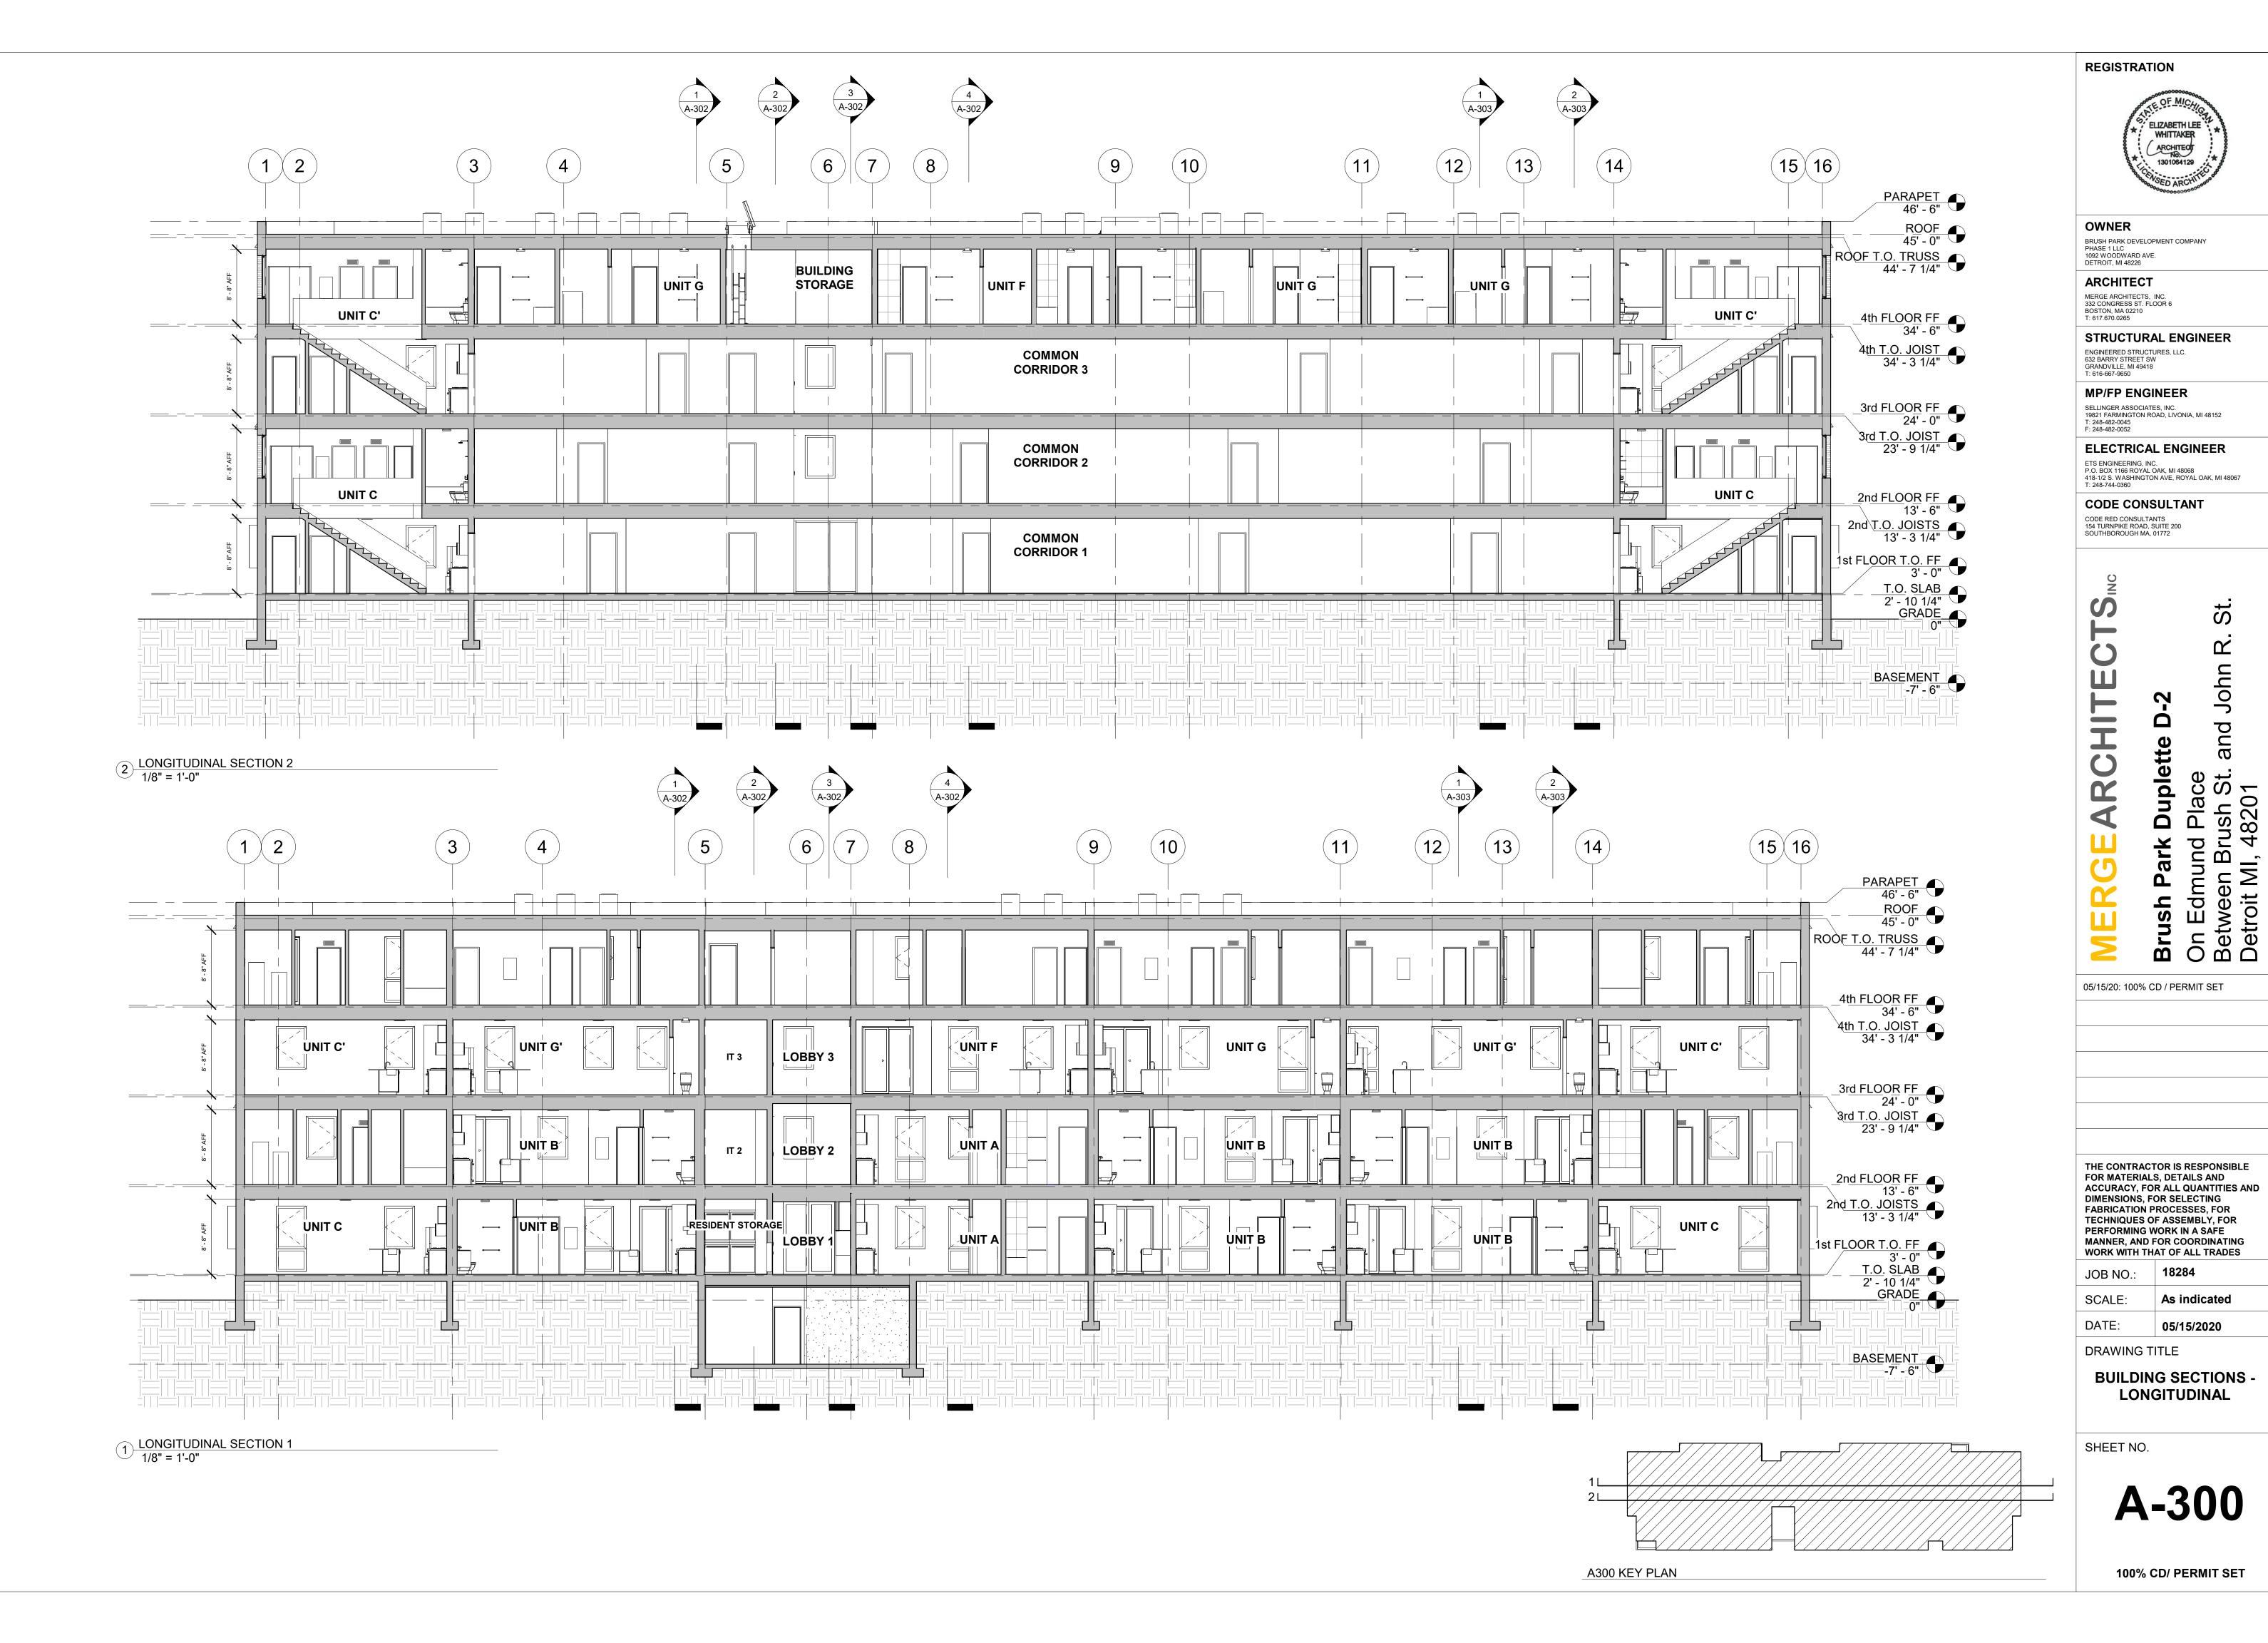

5/18/2020 2:21:28 AM

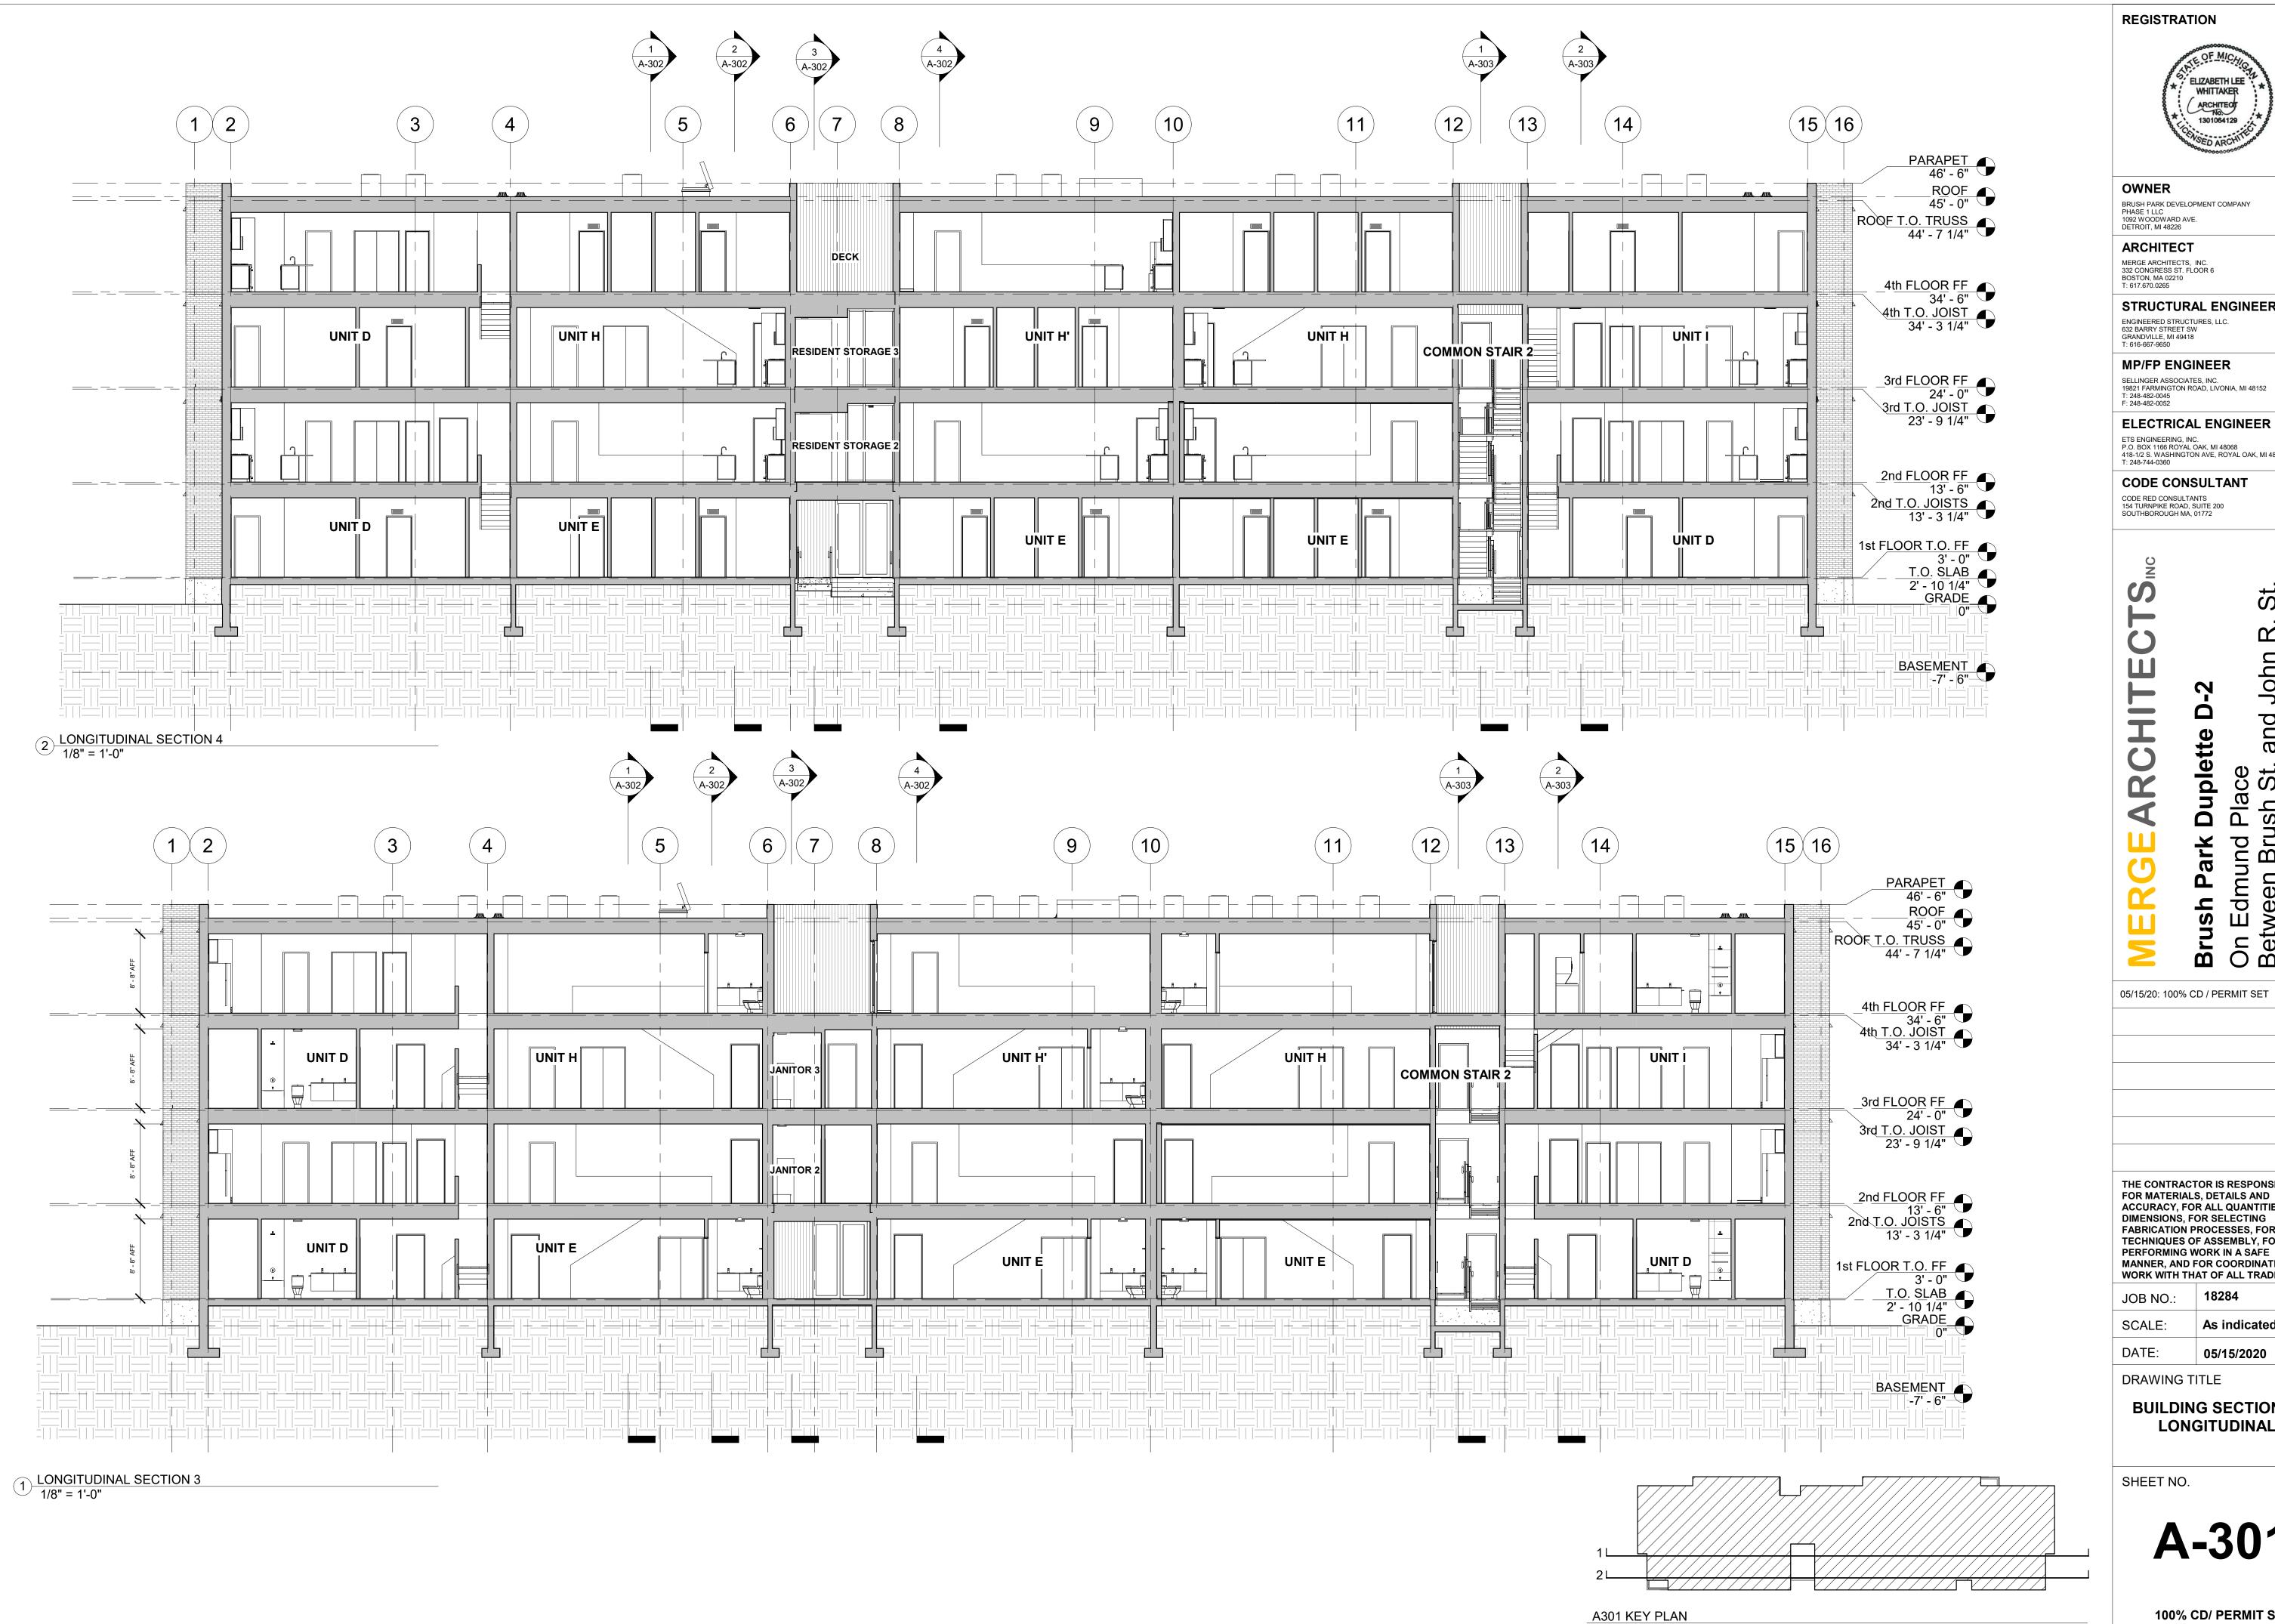



OWNER BRUSH PARK DEVELOPMENT COMPANY PHASE 1 LLC 1092 WOODWARD AVE.

ARCHITECT

MERGE ARCHITECTS, INC. 332 CONGRESS ST. FLOOR 6 BOSTON, MA 02210 T: 617.670.0265

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CODE CONSULTANT

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ohn and **Duplette** d Place trush St. 48201 Park р On Edmunc Between Br Detroit MI, ⁴

Brush On Edr

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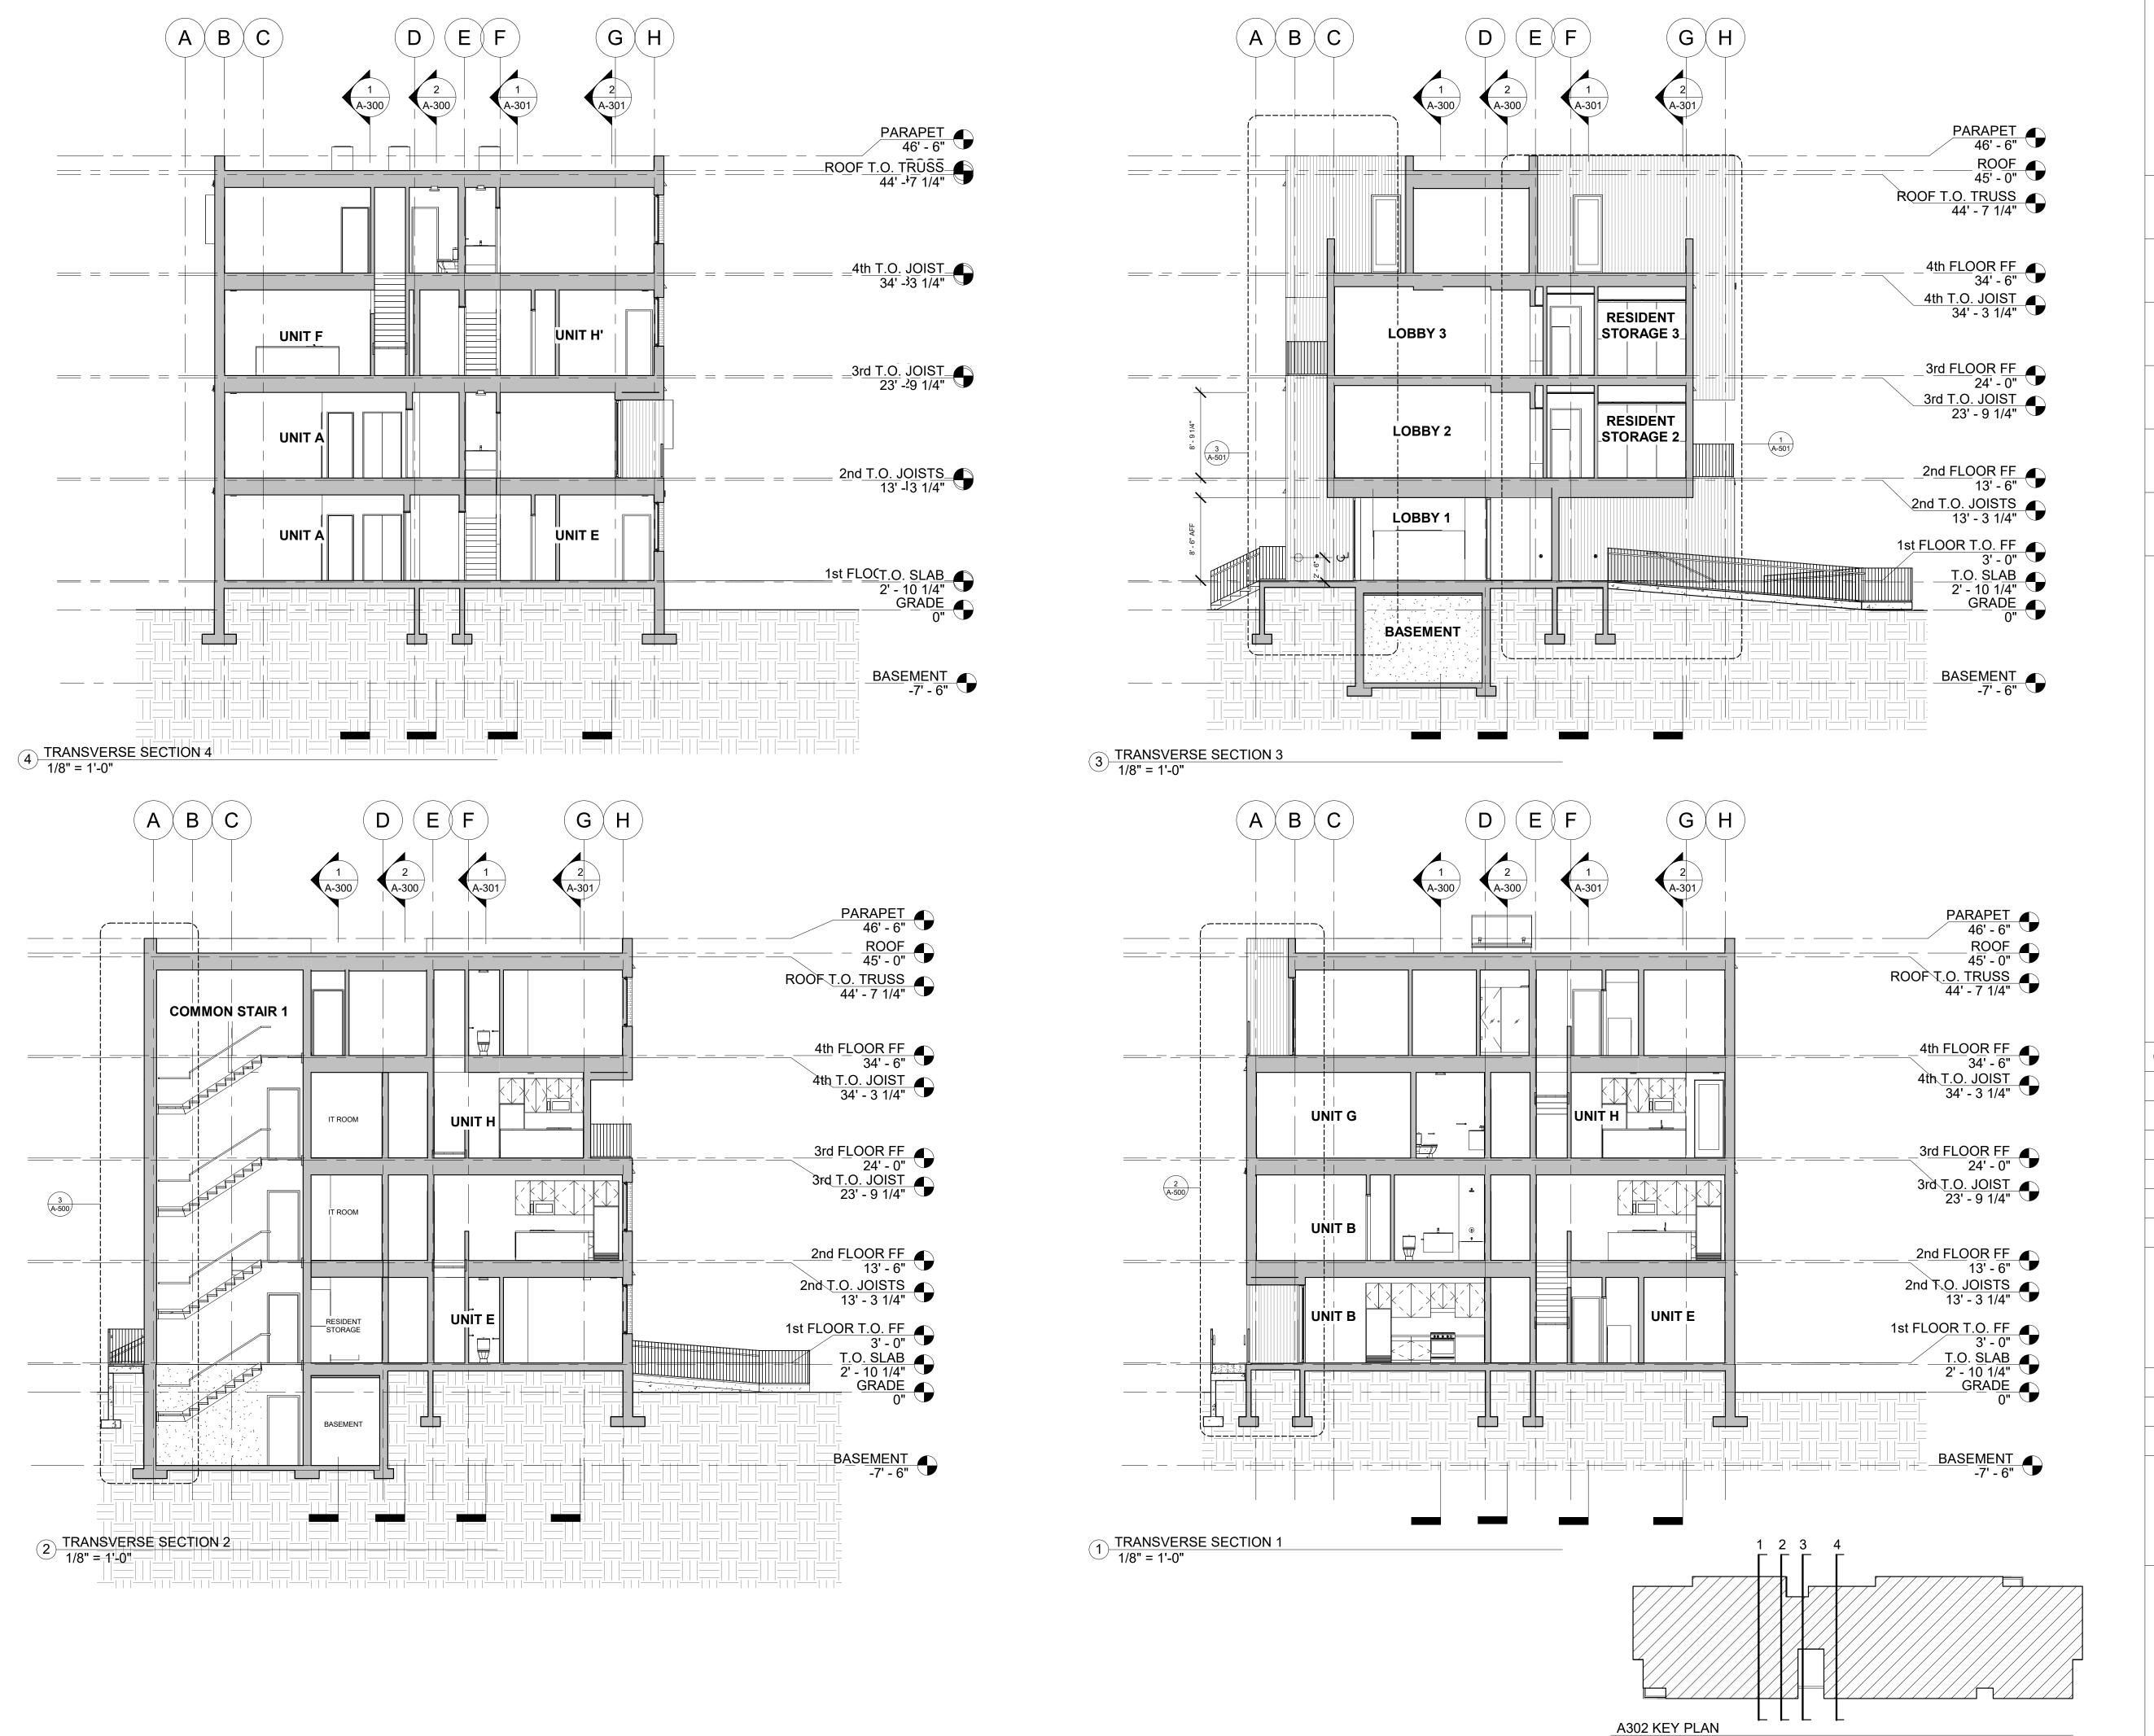
DATE: 05/15/2020

DRAWING TITLE

BUILDING SECTIONS -LONGITUDINAL

SHEET NO.

A-301





OWNER BRUSH PARK DEVELOPMENT COMPANY PHASE 1 LLC 1092 WOODWARD AVE.

ARCHITECT MERGE ARCHITECTS, INC. 332 CONGRESS ST. FLOOR 6 BOSTON, MA 02210 T: 617.670.0265

STRUCTURAL ENGINEER ENGINEERED STRUCTURES, LLC. 632 BARRY STREET SW GRANDVILLE, MI 49418 T: 616-667-9650

MP/FP ENGINEER

SELLINGER ASSOCIATES, INC. 19821 FARMINGTON ROAD, LIVONIA, MI 48152 T: 248-482-0045 F: 248-482-0052

ELECTRICAL ENGINEER ETS ENGINEERING, INC. P.O. BOX 1166 ROYAL OAK, MI 48068 418-1/2 S. WASHINGTON AVE, ROYAL OAK, MI 48067

CODE CONSULTANT

CODE RED CONSULTANTS 154 TURNPIKE ROAD, SUITE 200 SOUTHBOROUGH MA, 01772

John and **Duplette** St. rush \$4820 Pla(р **Brush Park**On Edmund
Between Br
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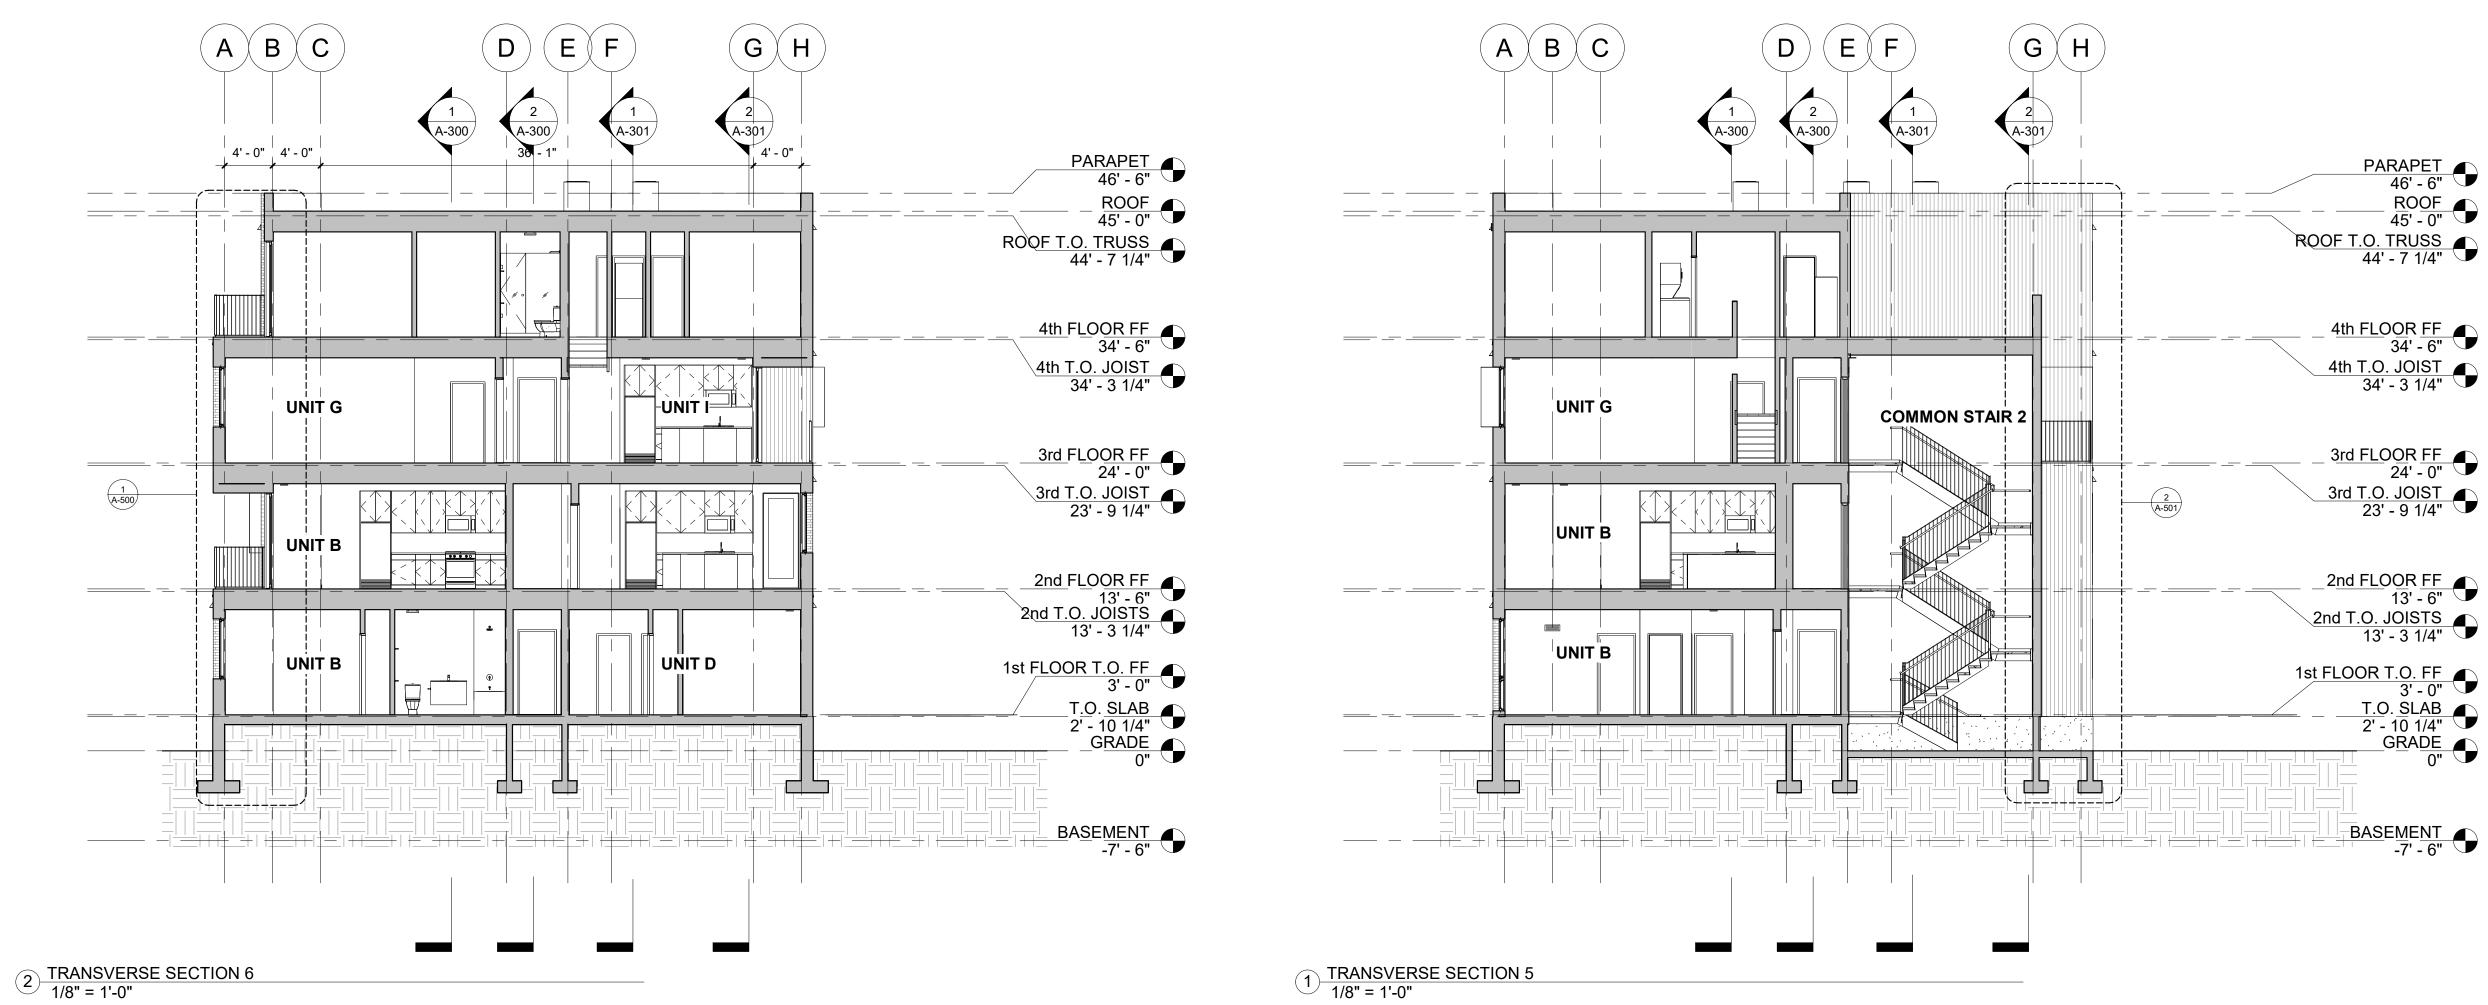
18284 JOB NO.: SCALE: As indicated

05/15/2020 DATE: DRAWING TITLE

BUILDING SECTIONS -TRANSVERSE

SHEET NO.

A-302



A303 KEY PLAN

PARAPET 121 6"

ROOF 45' - 0"

4th FLOOR FF 34' - 6"

4th T.O. JOIST 34' - 3 1/4"

3rd FLOOR FF 24' - 0"

3rd T.O. JOIST 23' - 9 1/4"

2nd FLOOR FF 13' - 6"

T.O. SLAB 2' - 10 1/4" GRADE 0"

BASEMENT -7' - 6"

REGISTRATION



OWNER BRUSH PARK DEVELOPMENT COMPANY

PHASE 1 LLC 1092 WOODWARD AVE. DETROIT, MI 48226

ARCHITECT MERGE ARCHITECTS, INC. 332 CONGRESS ST. FLOOR 6 BOSTON, MA 02210 T: 617.670.0265

STRUCTURAL ENGINEER ENGINEERED STRUCTURES, LLC. 632 BARRY STREET SW GRANDVILLE, MI 49418 T: 616-667-9650

MP/FP ENGINEER

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ETS ENGINEERING, INC. P.O. BOX 1166 ROYAL OAK, MI 48068 418-1/2 S. WASHINGTON AVE, ROYAL OAK, MI 48067

CODE CONSULTANT

CODE RED CONSULTANTS 154 TURNPIKE ROAD, SUITE 200 SOUTHBOROUGH MA, 01772

John and Duplette Place Ish St. 8201 rush \$4820 **Brush Park I**On Edmund I
Between Brus
Detroit MI, 48

05/15/20: 100% CD / PERMIT SET

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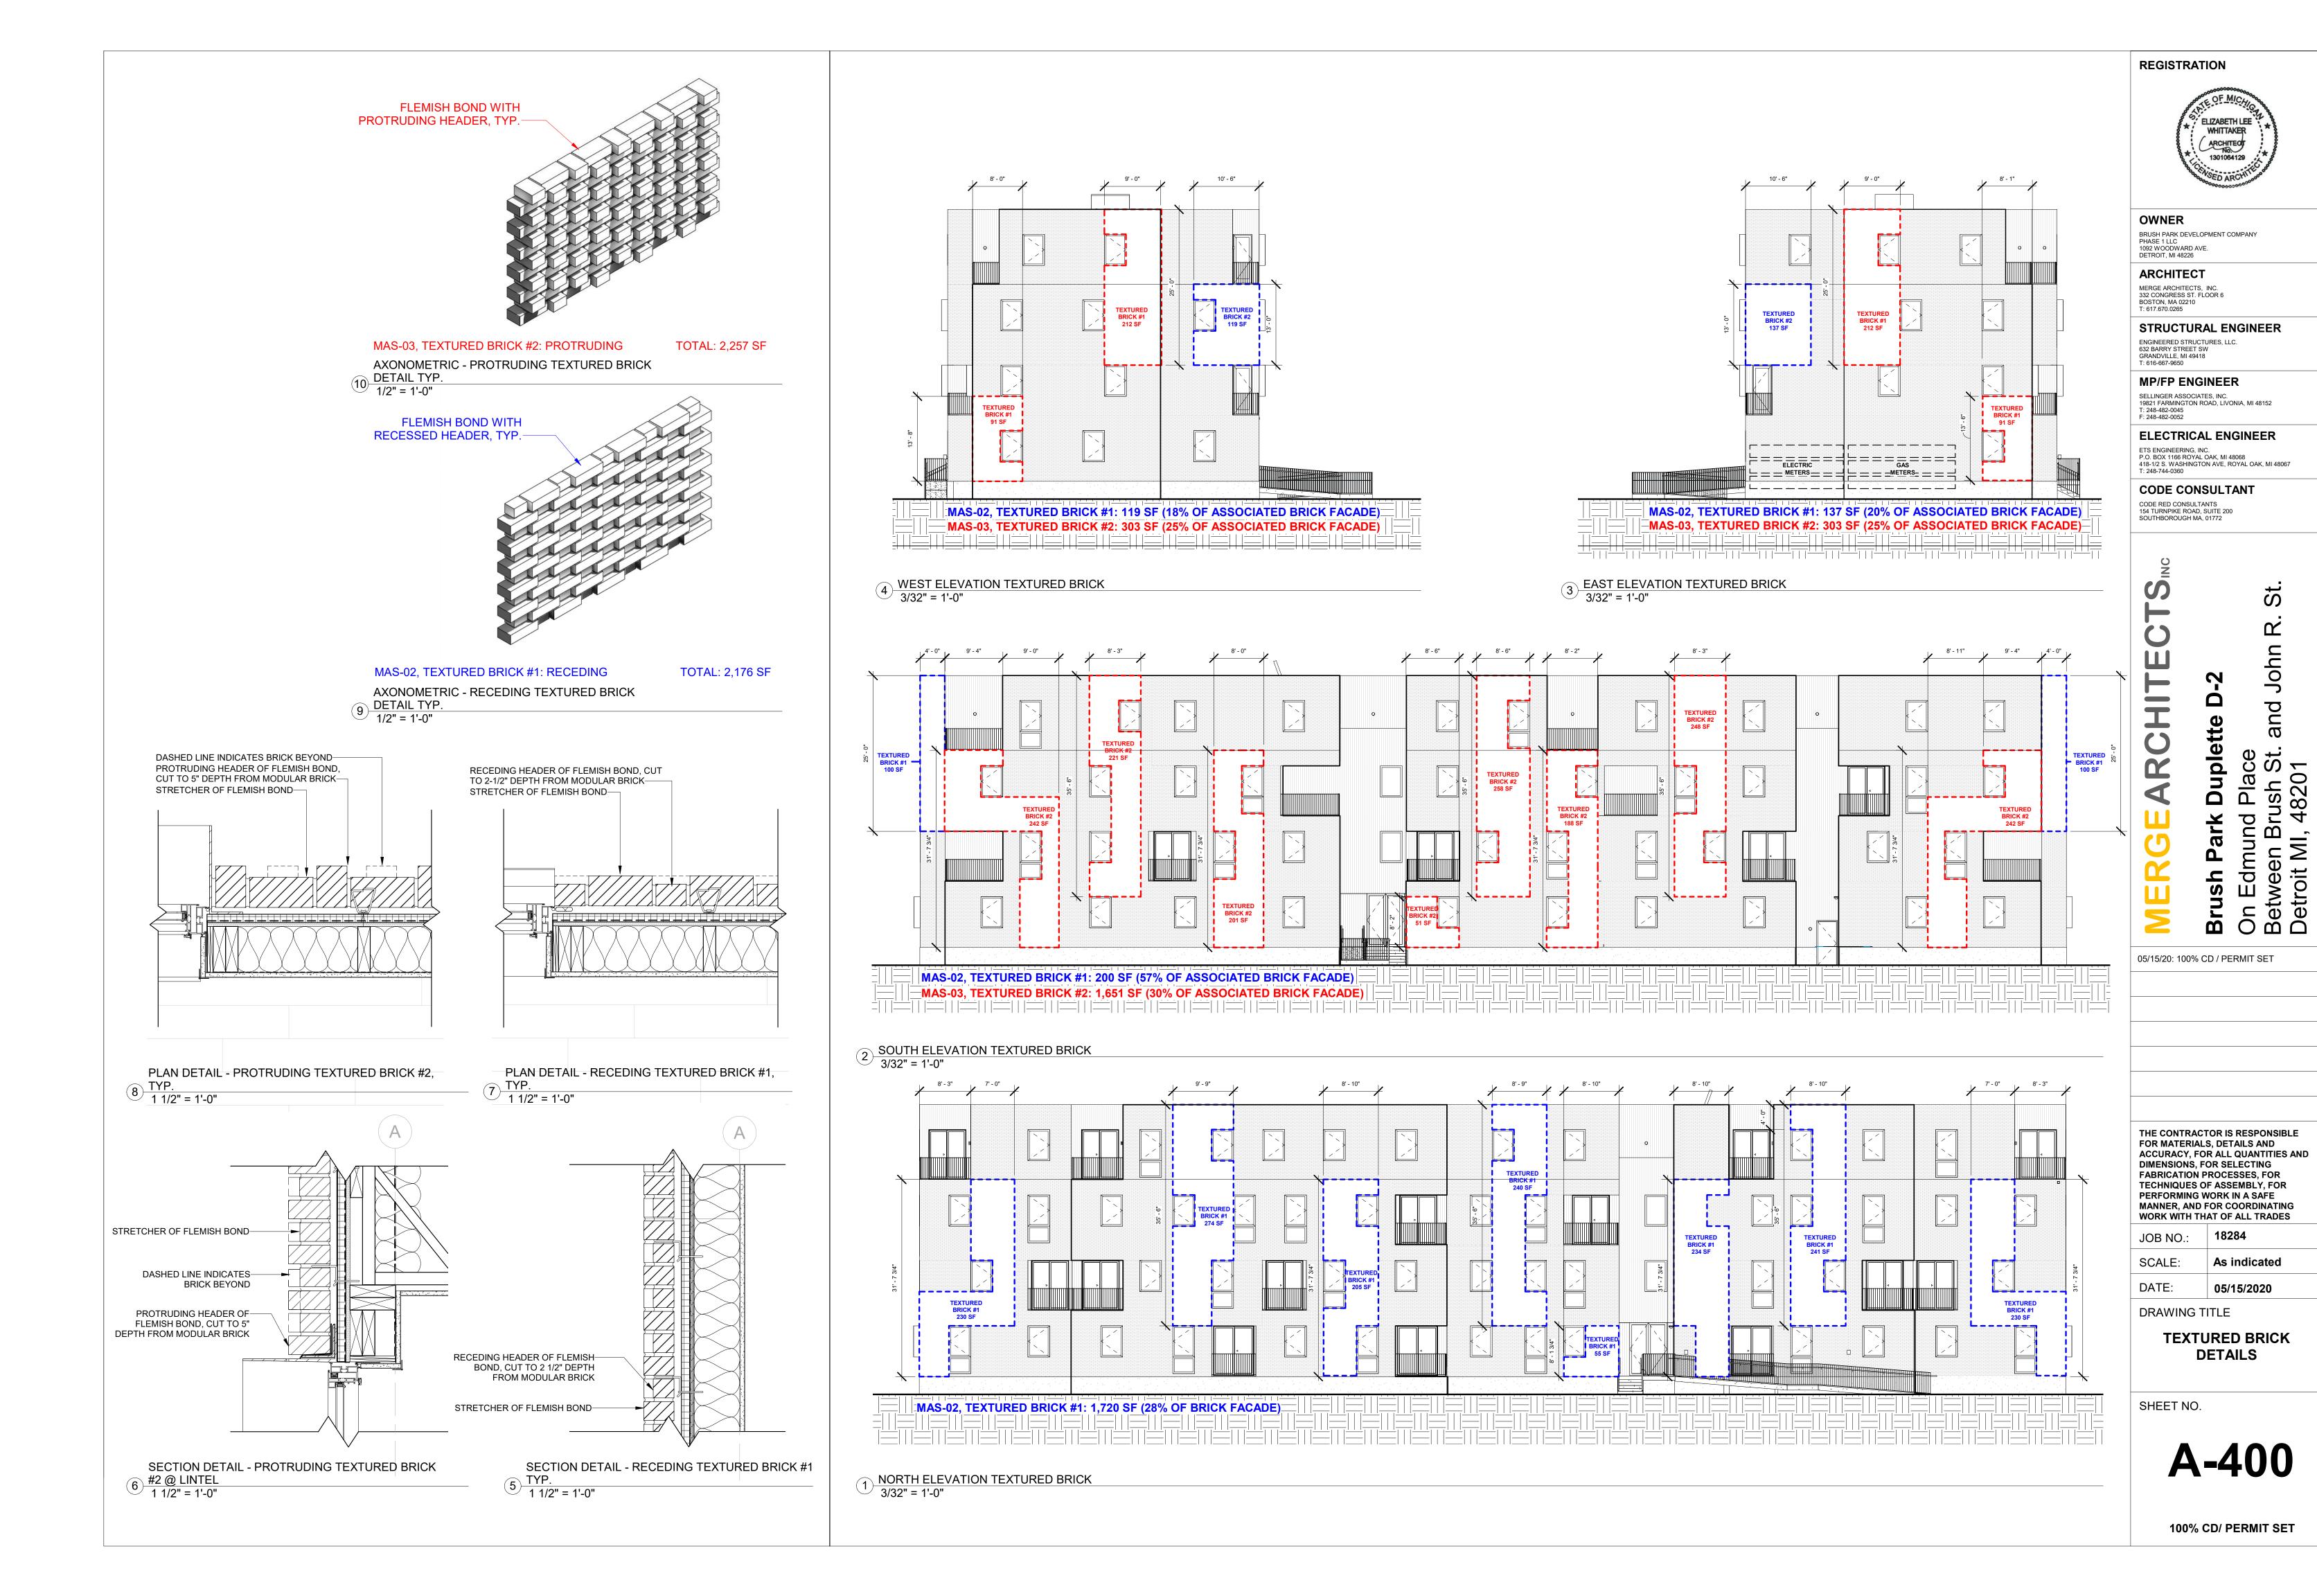
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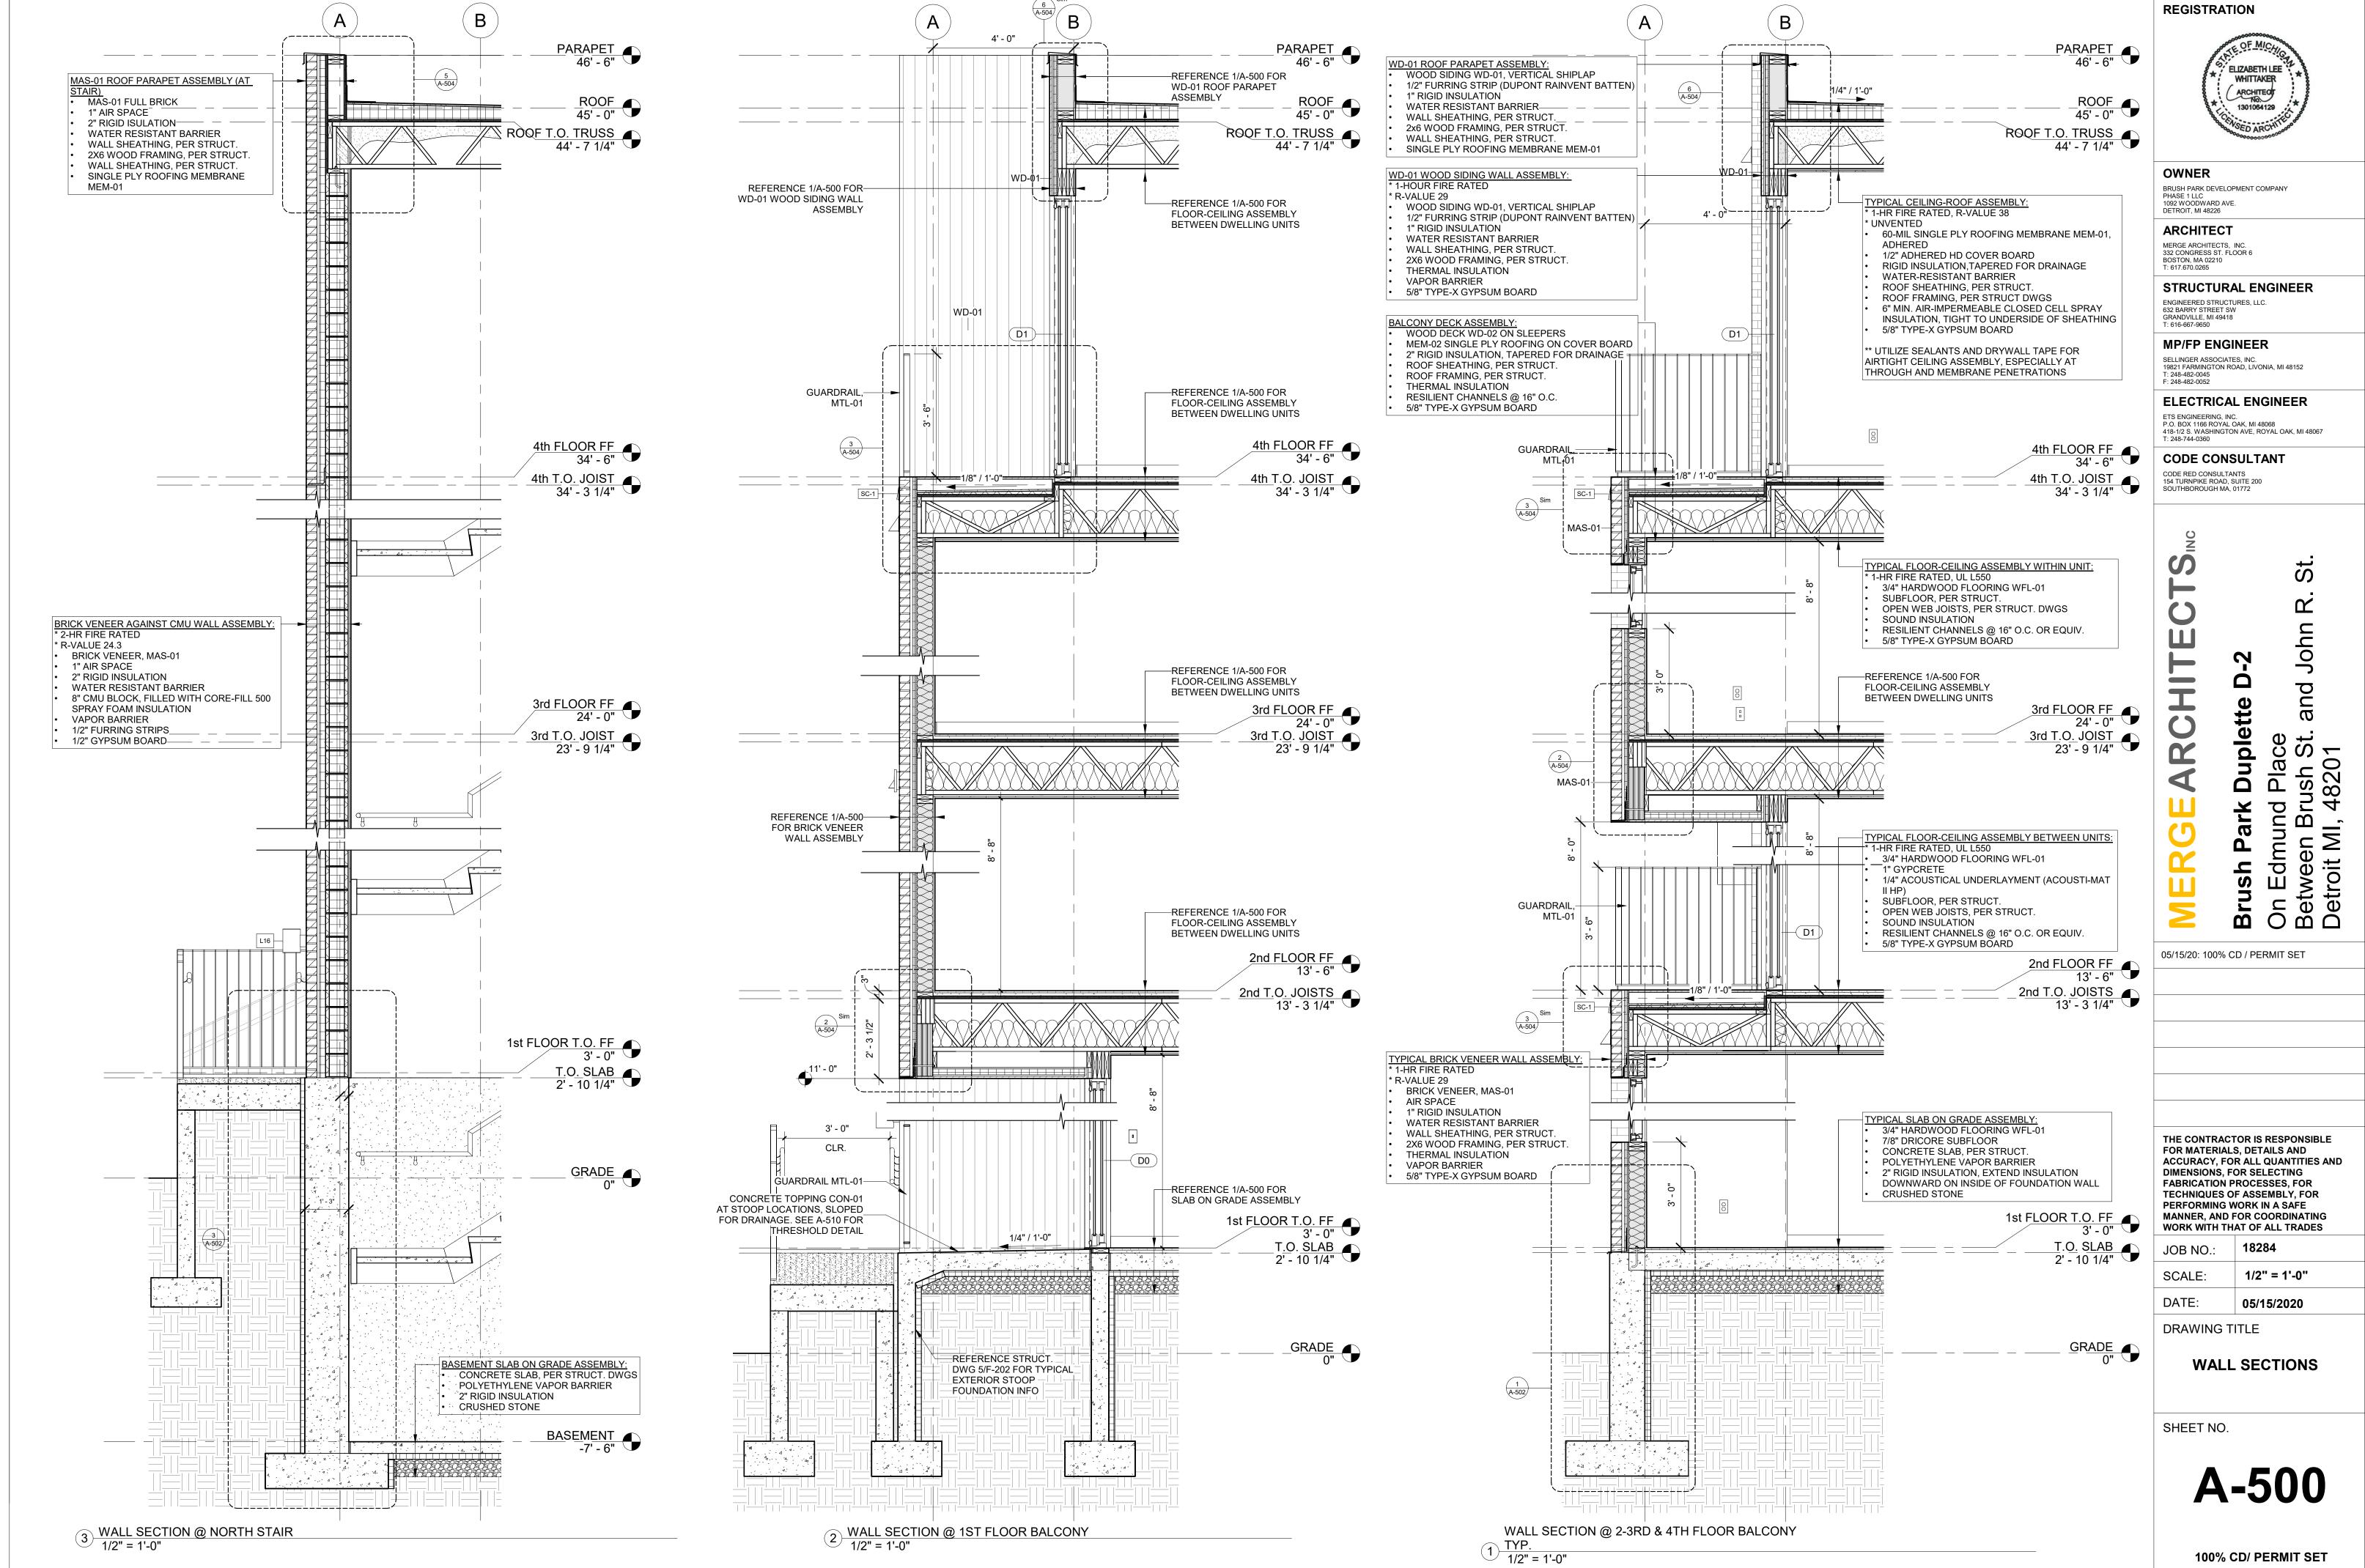
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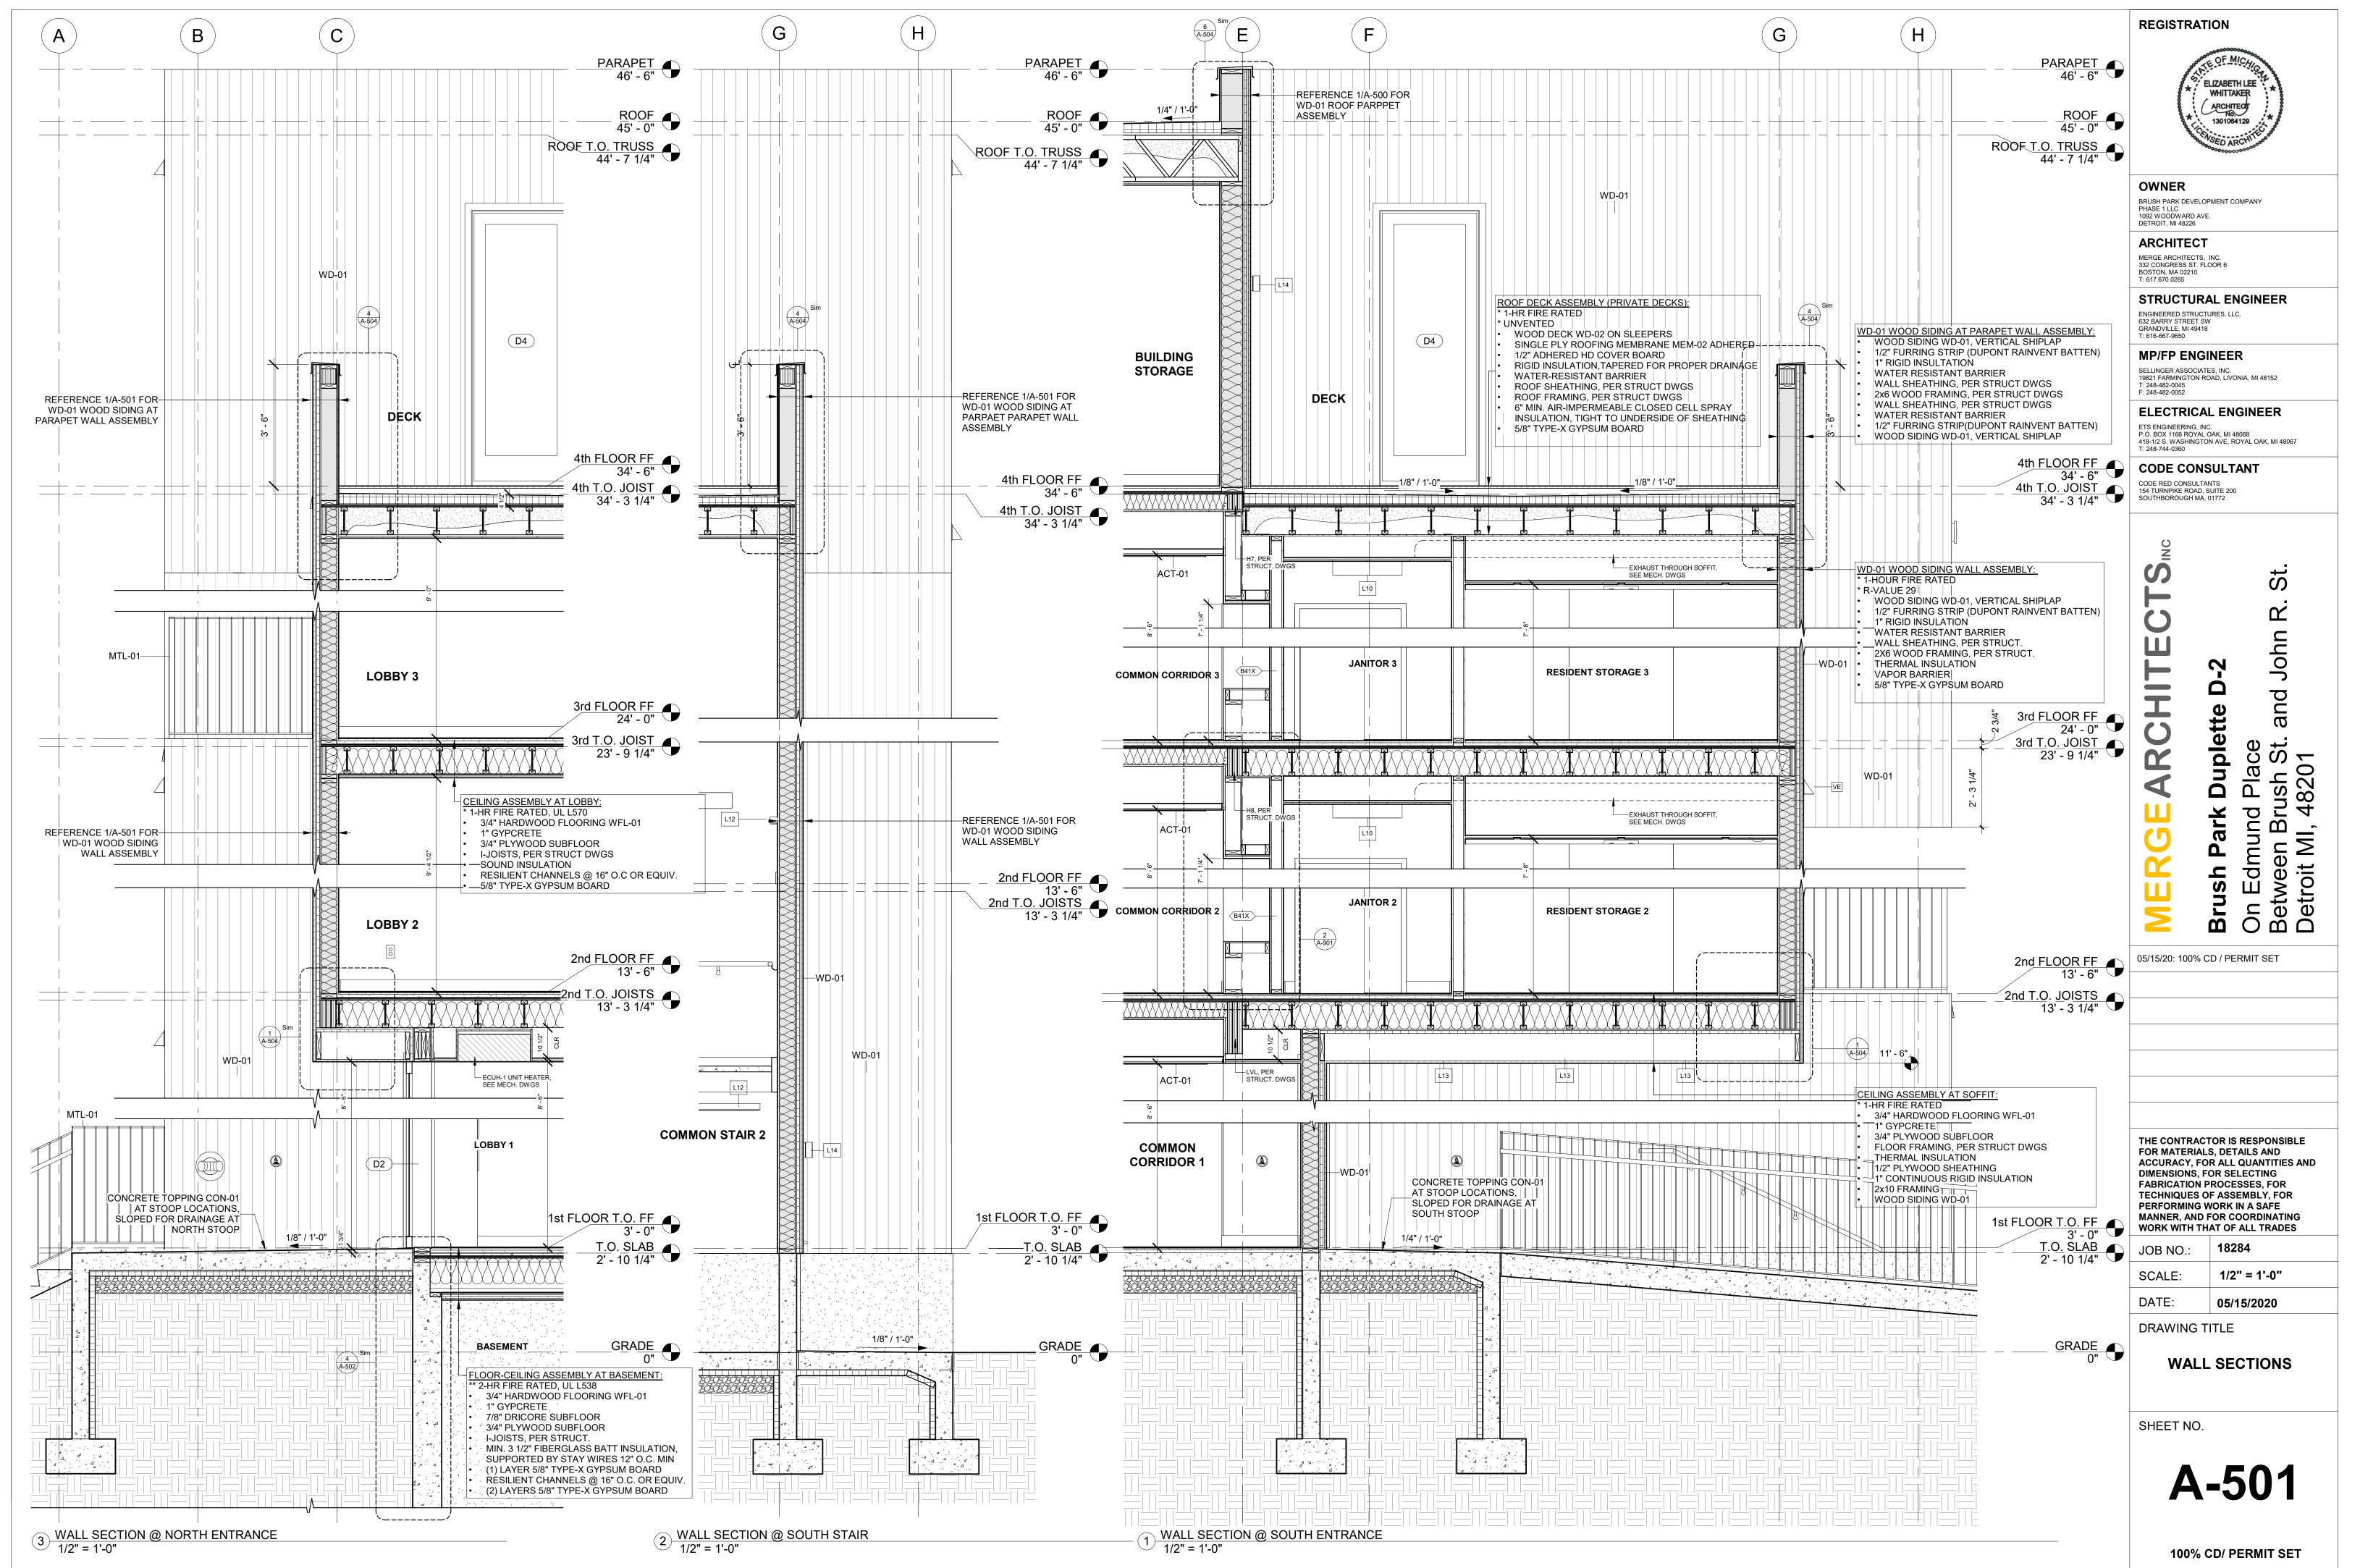
BUILDING SECTIONS -TRANSVERSE

SHEET NO.

A-303







18/2020 2:22:22 AM



BRUSH PARK DEVELOPMENT COMPANY

ARCHITECT

MERGE ARCHITECTS, INC. 332 CONGRESS ST. FLOOR 6 BOSTON, MA 02210 T: 617.670.0265

STRUCTURAL ENGINEER ENGINEERED STRUCTURES, LLC.

MP/FP ENGINEER

SELLINGER ASSOCIATES, INC. 19821 FARMINGTON ROAD, LIVONIA, MI 48152 T: 248-482-0045

ELECTRICAL ENGINEER ETS ENGINEERING, INC.

CODE CONSULTANT

CODE RED CONSULTANTS 154 TURNPIKE ROAD, SUITE 200 SOUTHBOROUGH MA, 01772

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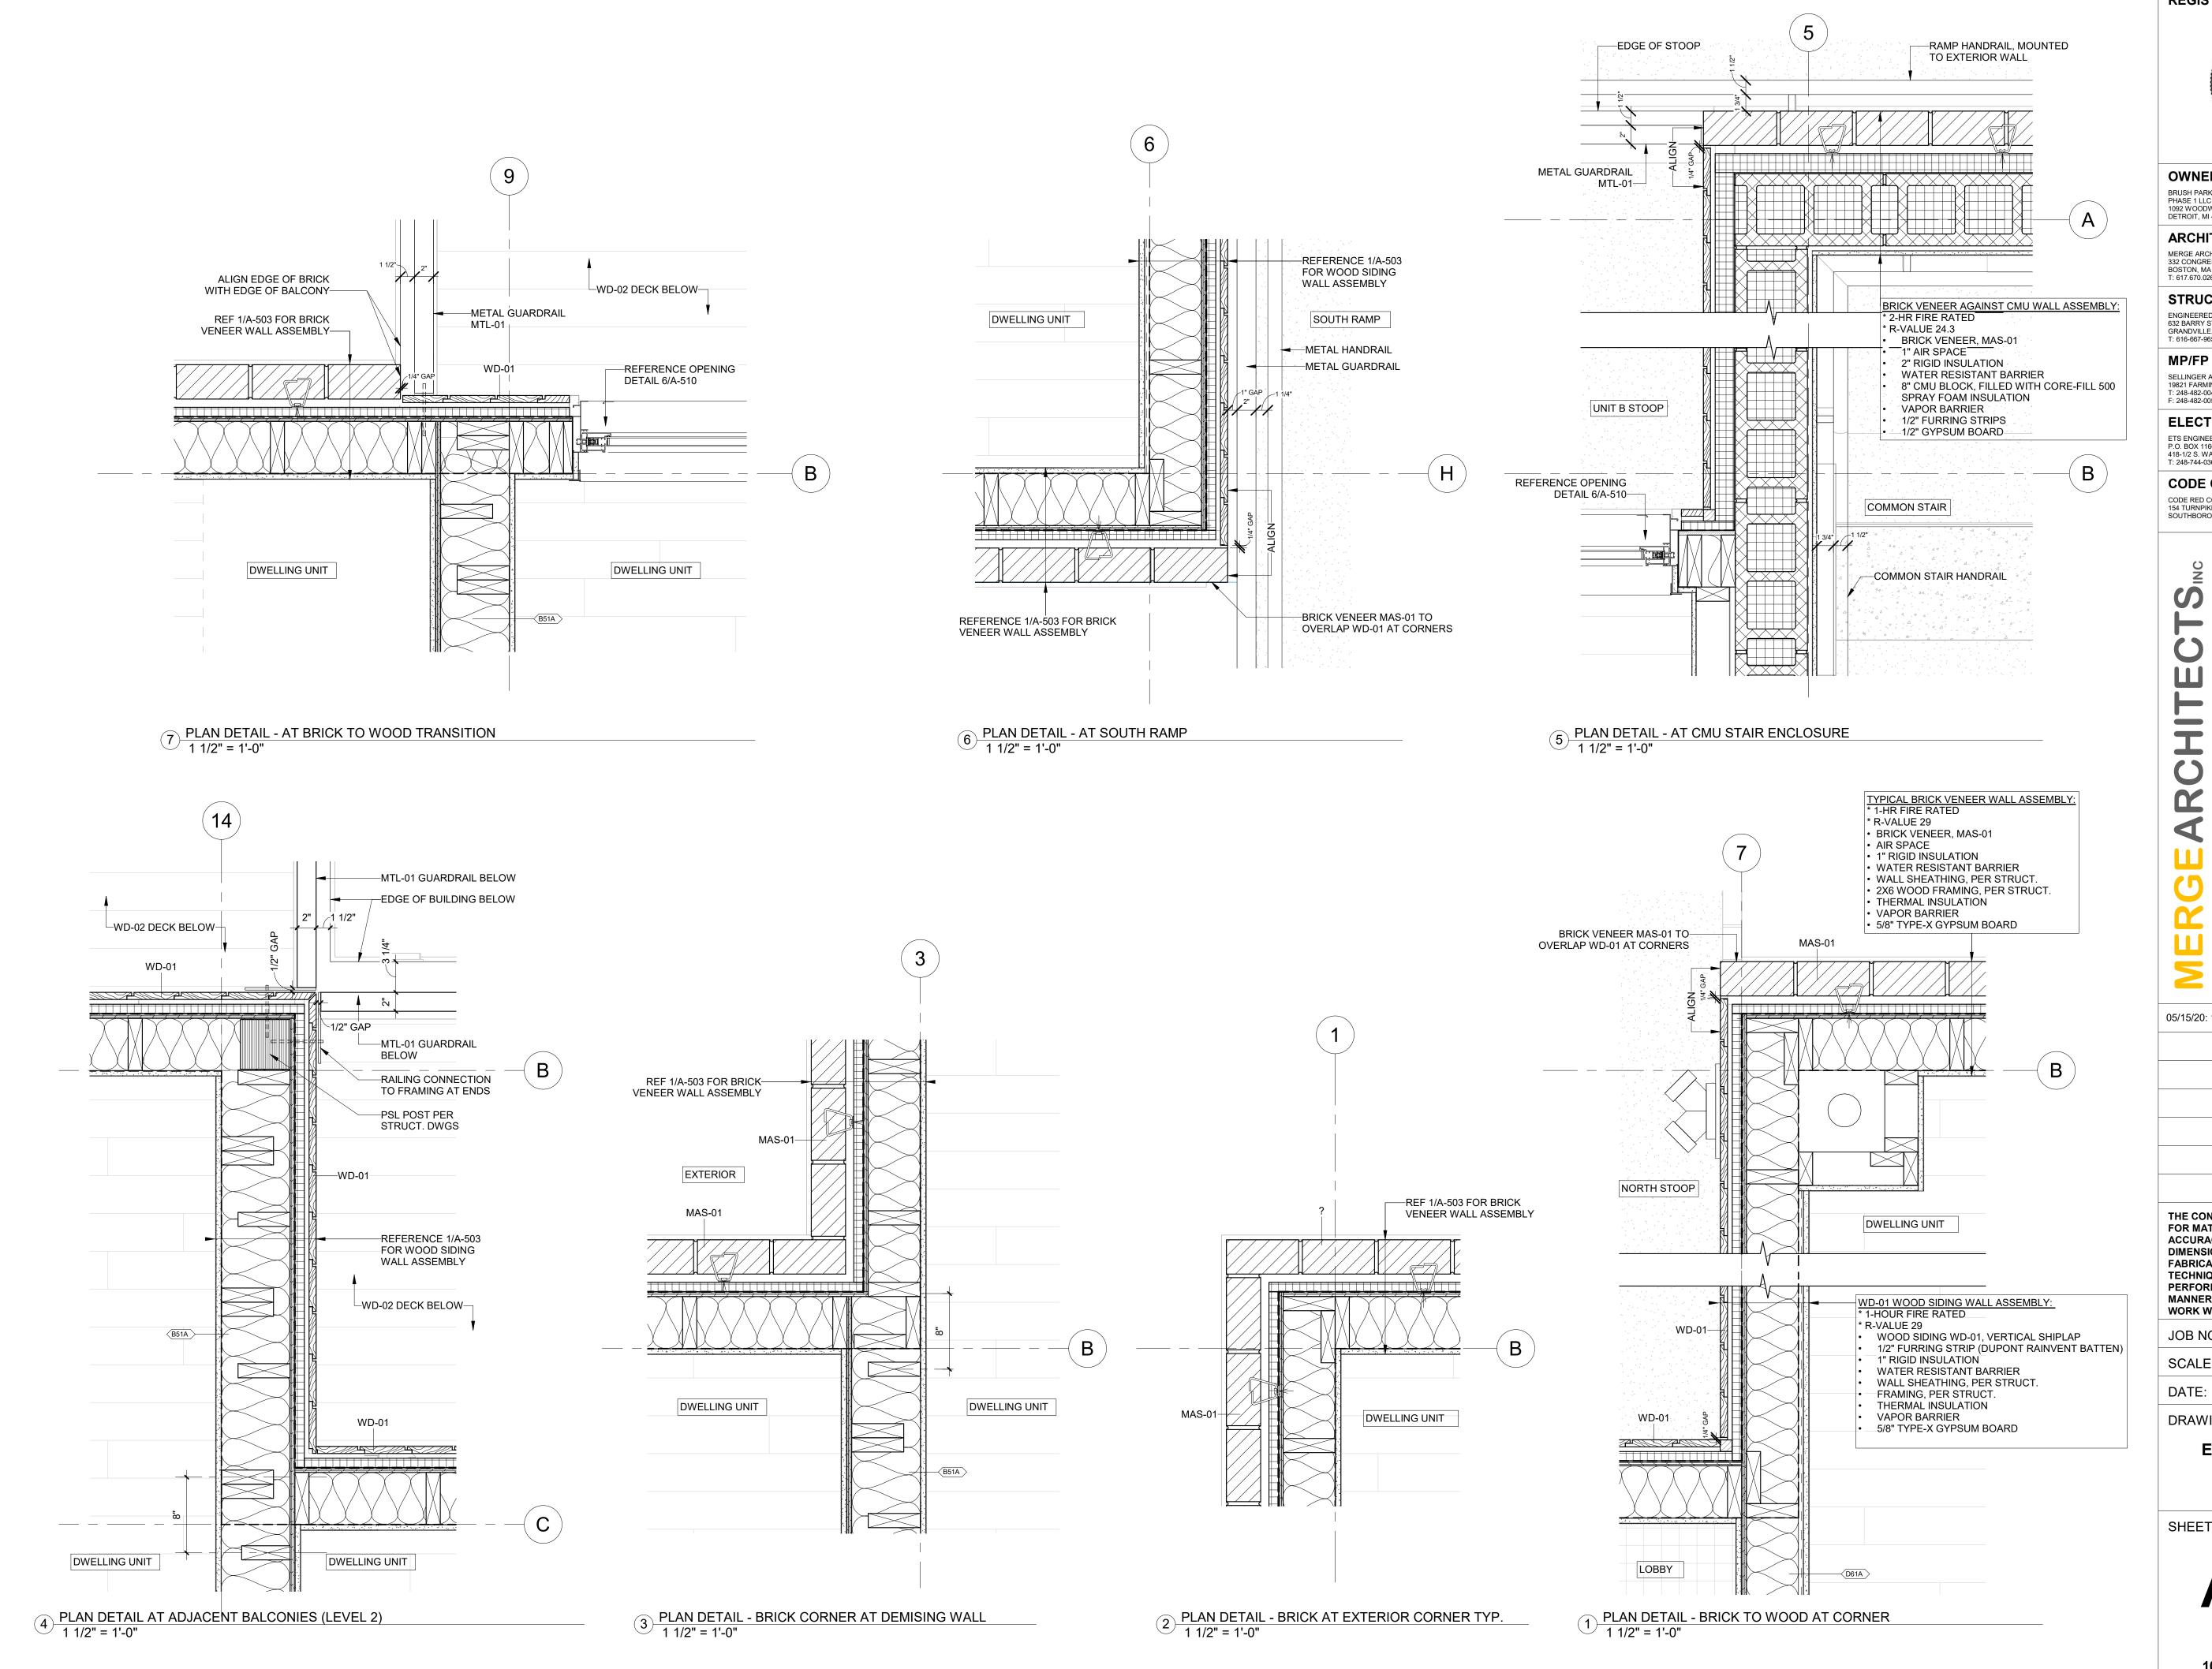
18284 1 1/2" = 1'-0"

05/15/2020

FOUNDATION DETAILS

SHEET NO.

A-502





OWNER BRUSH PARK DEVELOPMENT COMPANY PHASE 1 LLC 1092 WOODWARD AVE. DETROIT, MI 48226

ARCHITECT MERGE ARCHITECTS, INC. 332 CONGRESS ST. FLOOR 6 BOSTON, MA 02210 T: 617.670.0265

STRUCTURAL ENGINEER

ENGINEERED STRUCTURES, LLC. 632 BARRY STREET SW GRANDVILLE, MI 49418 T: 616-667-9650

MP/FP ENGINEER

SELLINGER ASSOCIATES, INC. 19821 FARMINGTON ROAD, LIVONIA, MI 48152 T: 248-482-0045 F: 248-482-0052 **ELECTRICAL ENGINEER**

ETS ENGINEERING, INC. P.O. BOX 1166 ROYAL OAK, MI 48068 418-1/2 S. WASHINGTON AVE, ROYAL OAK, MI 48067

CODE CONSULTANT

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0 and **Duplette** S S Z Pla(0 dmur On Bet Det

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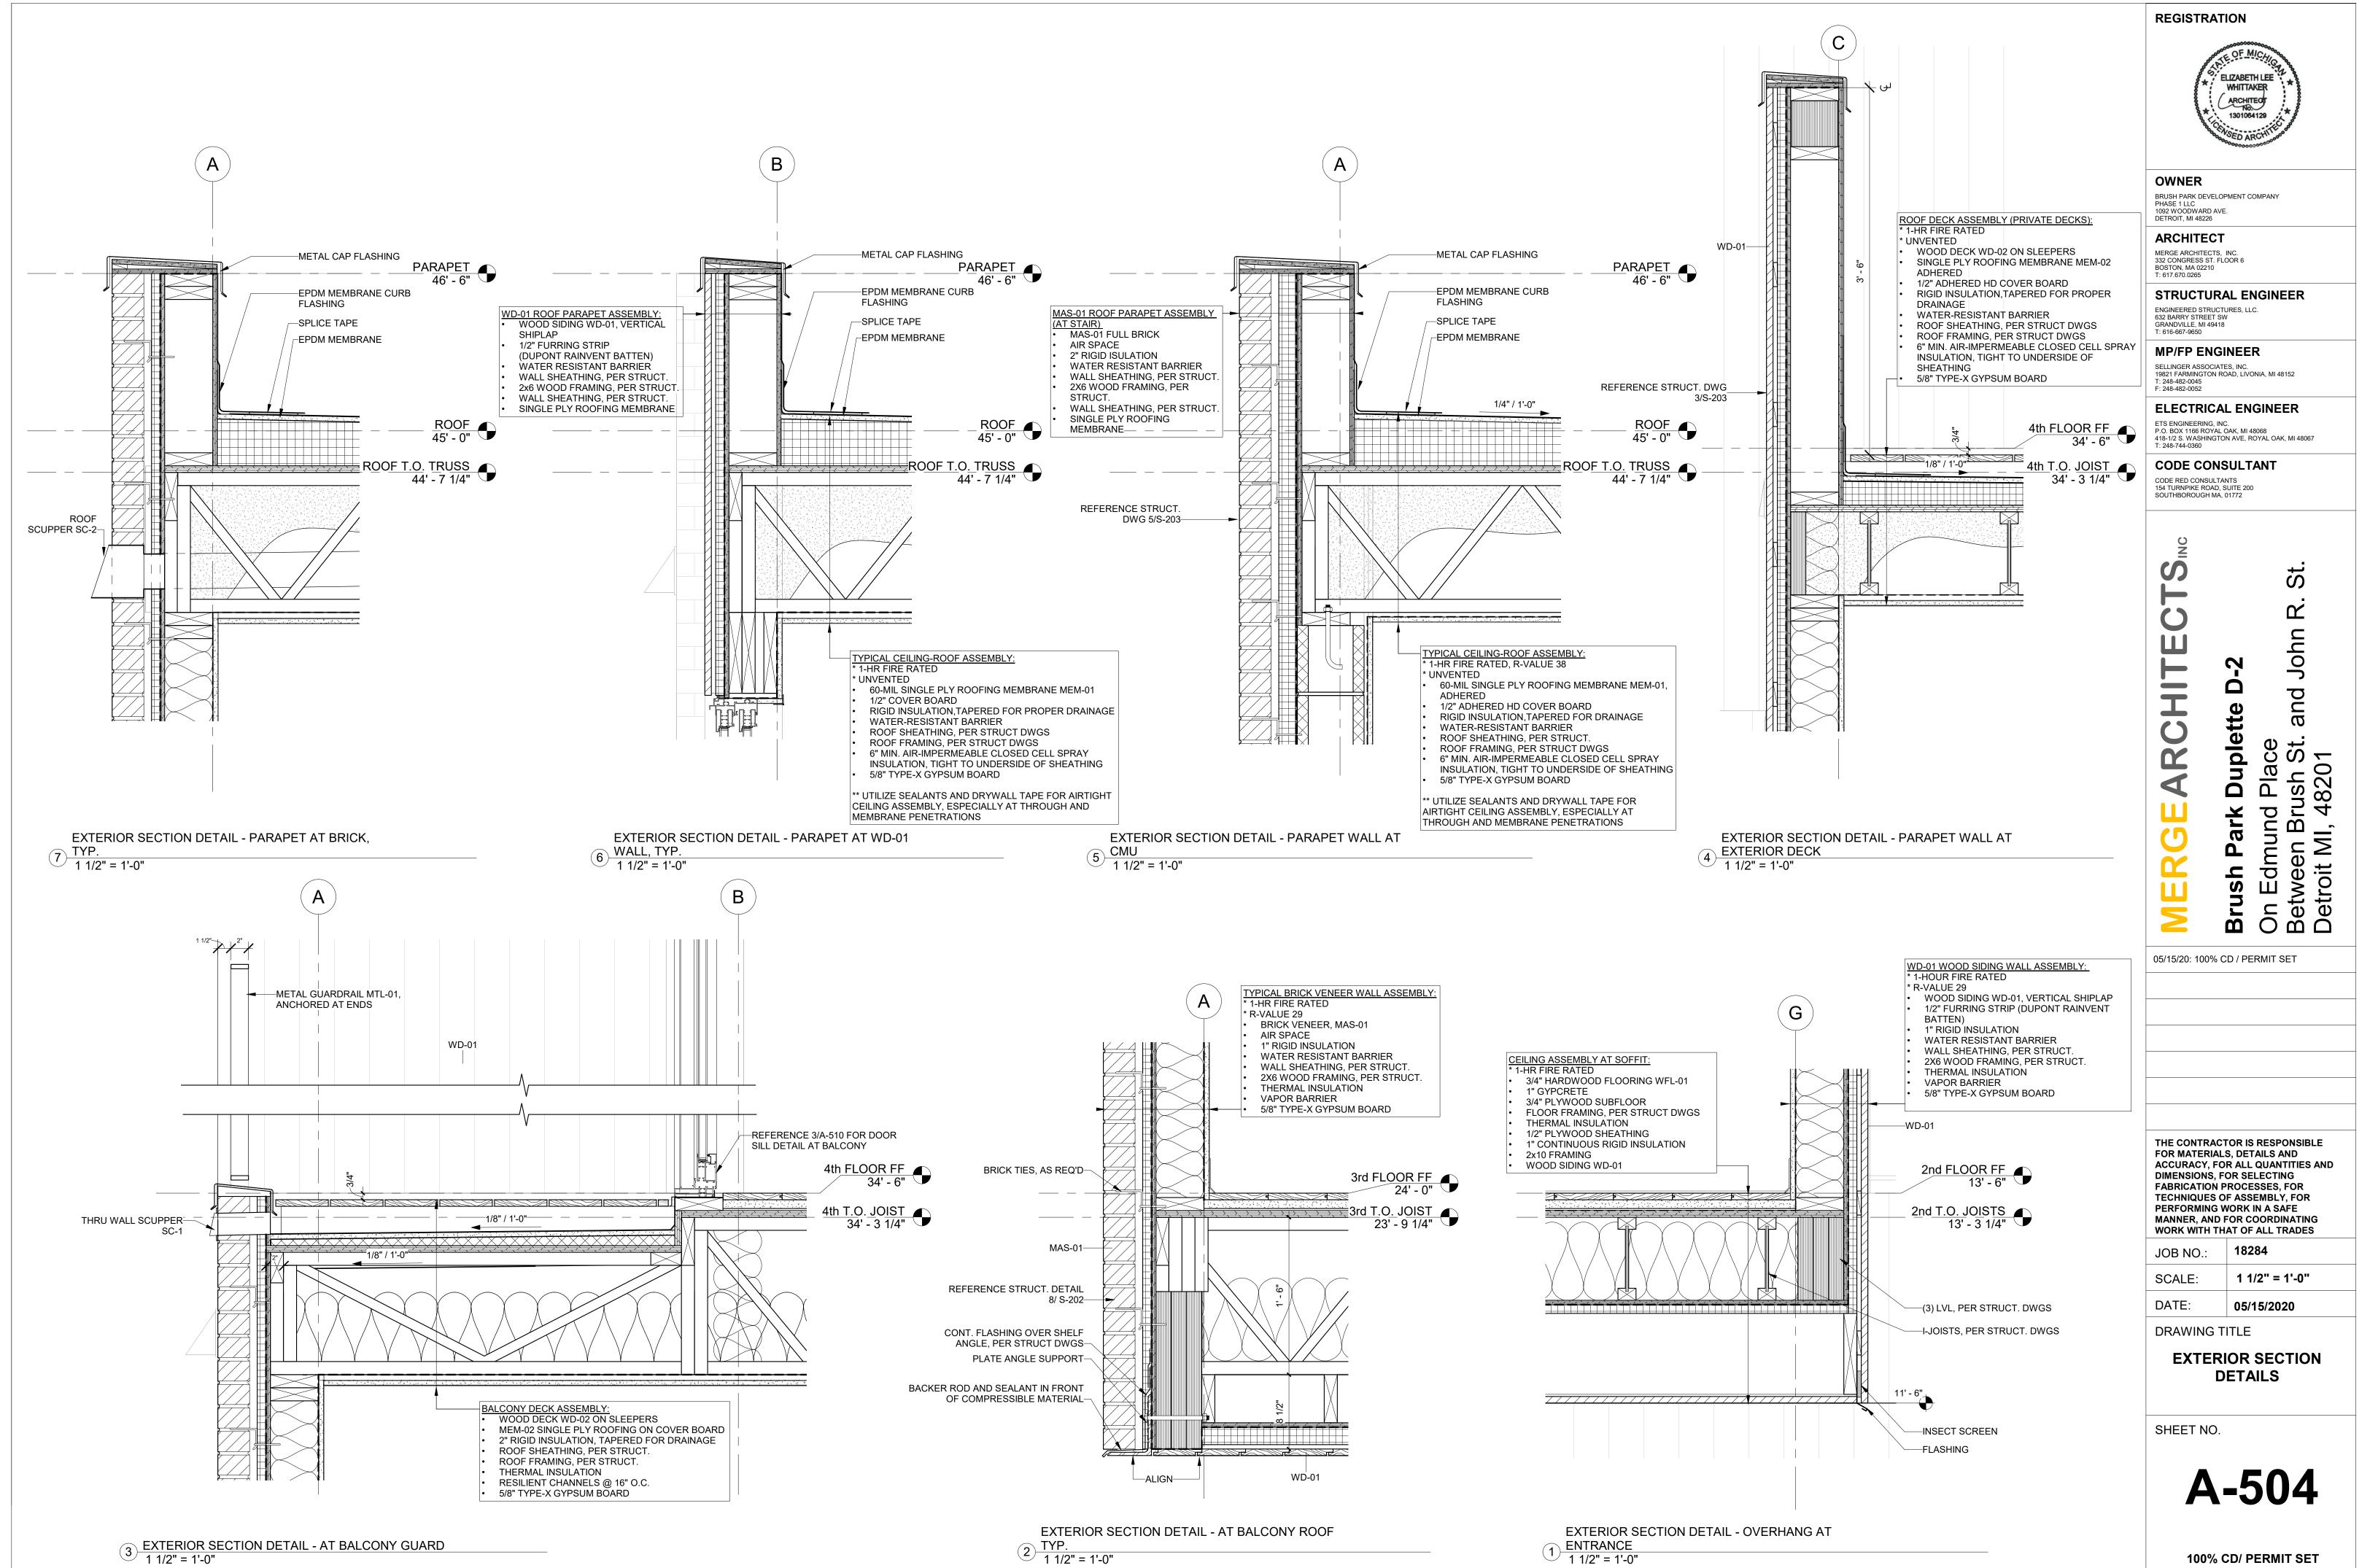
18284 JOB NO.: 1 1/2" = 1'-0" 05/15/2020

DRAWING TITLE


EXTERIOR PLAN DETAILS

SHEET NO.

A-503



/18/2020 2:22:31 AM

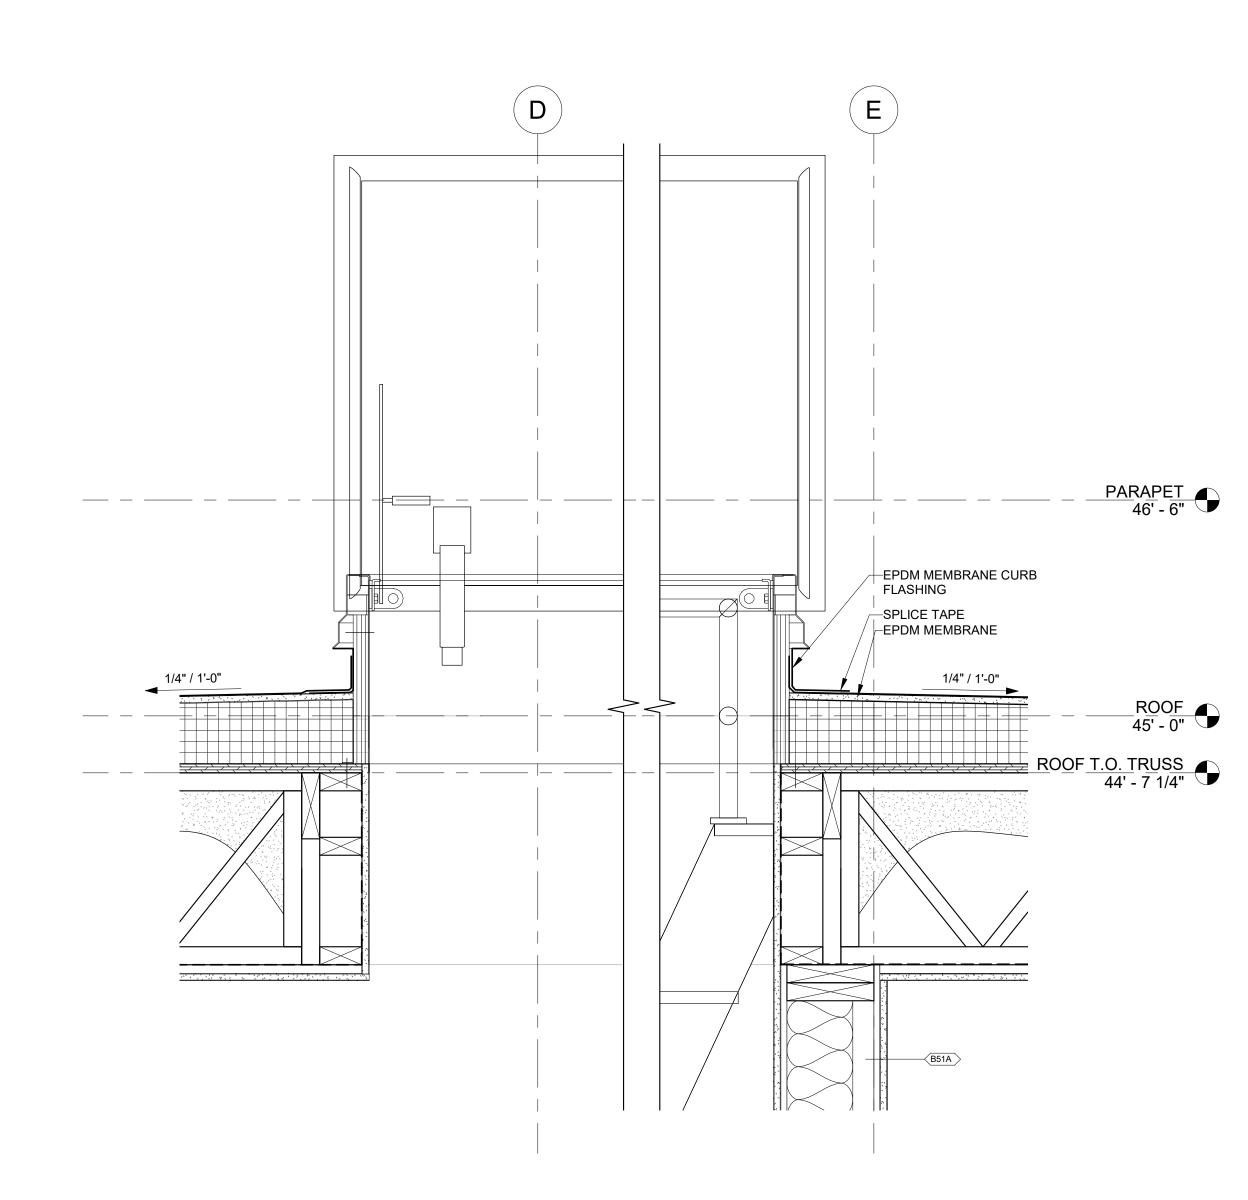

EXTERIOR SECTION DETAIL - THROUGH ROOF

HATCH

1 1/2" = 1'-0"

REGISTRATION



OWNER

BRUSH PARK DEVELOPMENT COMPANY PHASE 1 LLC 1092 WOODWARD AVE. DETROIT, MI 48226

ARCHITECT MERGE ARCHITECTS, INC. 332 CONGRESS ST. FLOOR 6 BOSTON, MA 02210 T: 617.670.0265

STRUCTURAL ENGINEER

ENGINEERED STRUCTURES, LLC. 632 BARRY STREET SW GRANDVILLE, MI 49418 T: 616-667-9650

MP/FP ENGINEER SELLINGER ASSOCIATES, INC. 19821 FARMINGTON ROAD, LIVONIA, MI 48152 T: 248-482-0045 F: 248-482-0052

ELECTRICAL ENGINEER

ETS ENGINEERING, INC.
P.O. BOX 1166 ROYAL OAK, MI 48068
418-1/2 S. WASHINGTON AVE, ROYAL OAK, MI 48067
T: 248-744-0360

CODE CONSULTANT

CODE RED CONSULTANTS 154 TURNPIKE ROAD, SUITE 200 SOUTHBOROUGH MA, 01772

John and Duplette

On Edmund Place Between Brush St. a Detroit MI, 48201

05/15/20: 100% CD / PERMIT SET

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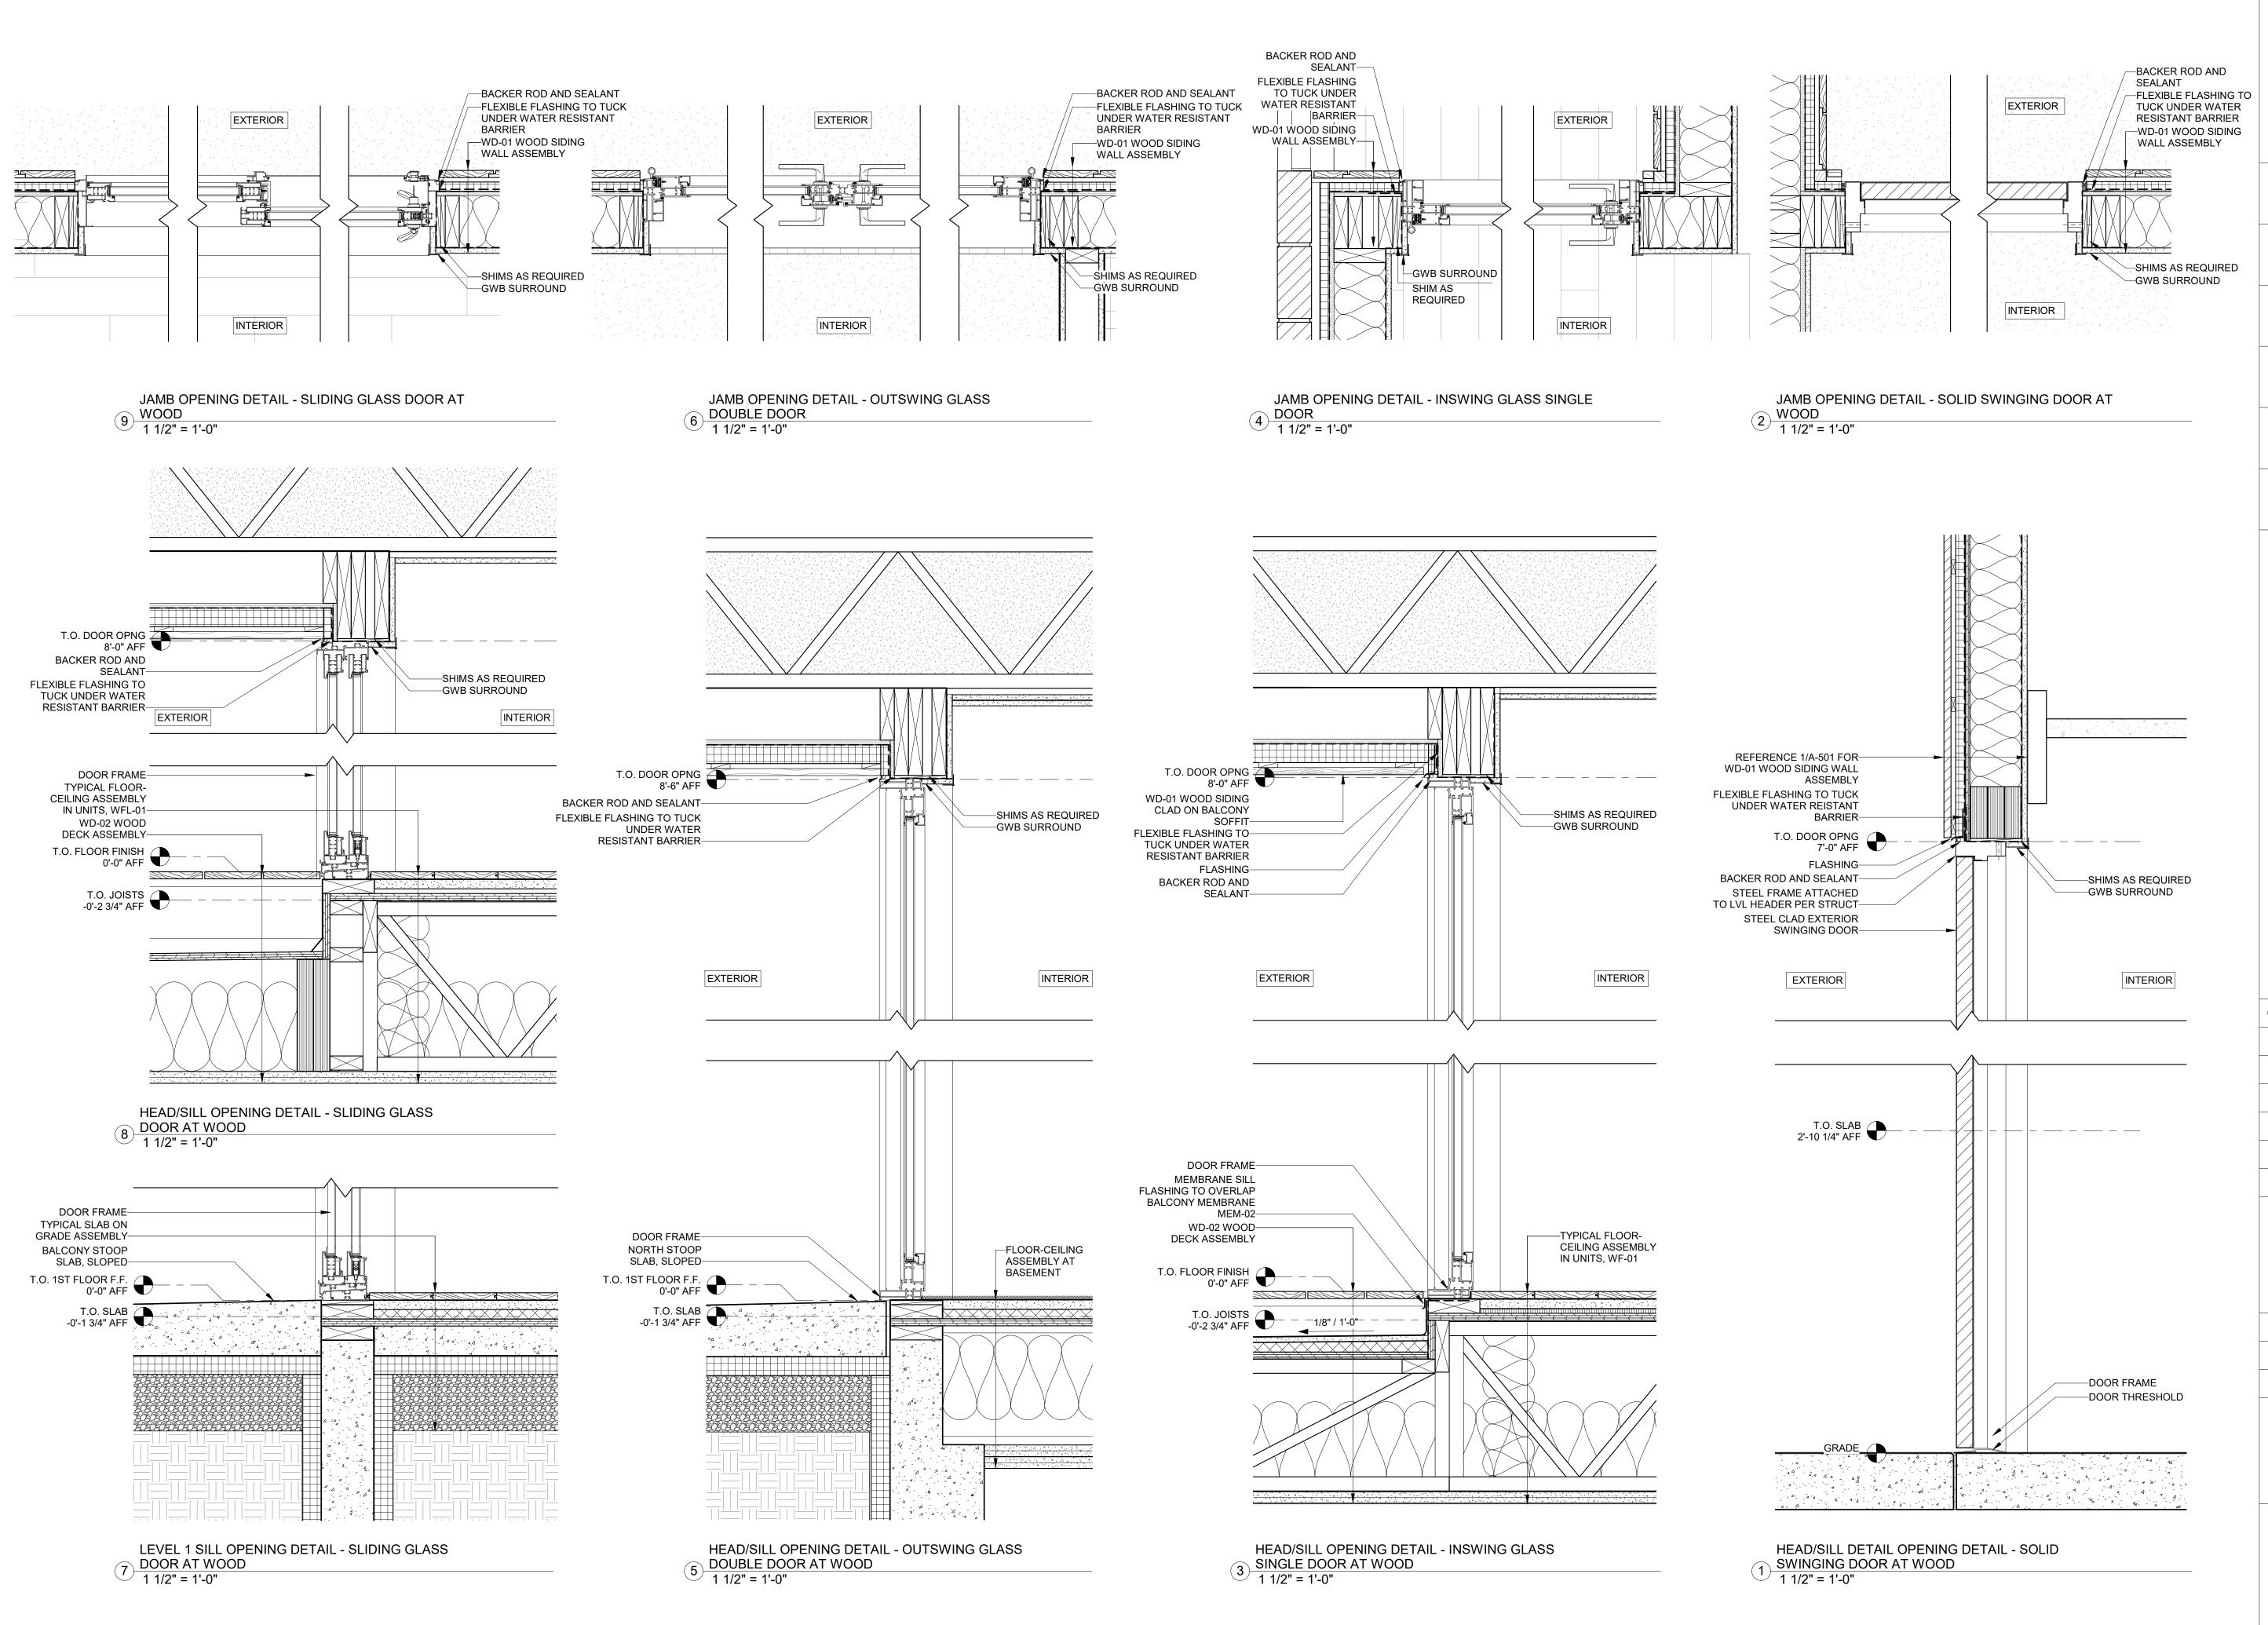
18284 JOB NO.: 1 1/2" = 1'-0" SCALE: DATE: 05/15/2020

DRAWING TITLE

EXTERIOR SECTION DETAILS

SHEET NO.

A-505





OWNER BRUSH PARK DEVELOPMENT COMPANY PHASE 1 LLC 1092 WOODWARD AVE.

ARCHITECT MERGE ARCHITECTS, INC. 332 CONGRESS ST. FLOOR 6 BOSTON, MO2210

T: 617.670.0265

STRUCTURAL ENGINEER ENGINEERED STRUCTURES, LLC.

632 BARRY STREET SW GRANDVILLE, MI 49418 T: 616-667-9650

MP/FP ENGINEER

SELLINGER ASSOCIATES, INC. 19821 FARMINGTON ROAD, LIVONIA, MI 48152 T: 248-482-0045 F: 248-482-0052 **ELECTRICAL ENGINEER**

ETS ENGINEERING, INC. P.O. BOX 1166 ROYAL OAK, MI 48068 418-1/2 S. WASHINGTON AVE, ROYAL OAK, MI 48067

CODE CONSULTANT

CODE RED CONSULTANTS 154 TURNPIKE ROAD, SUITE 200 SOUTHBOROUGH MA, 01772

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05/15/20: 100% CD / PERMIT SET

THE CONTRACTOR IS RESPONSIBLE FOR MATERIALS, DETAILS AND ACCURACY, FOR ALL QUANTITIES AND DIMENSIONS, FOR SELECTING FABRICATION PROCESSES, FOR TECHNIQUES OF ASSEMBLY, FOR PERFORMING WORK IN A SAFE MANNER, AND FOR COORDINATING WORK WITH THAT OF ALL TRADES


18284 JOB NO.: SCALE: 1 1/2" = 1'-0" DATE: 05/15/2020

DRAWING TITLE

EXTERIOR DOOR DETAILS

SHEET NO.

A-510

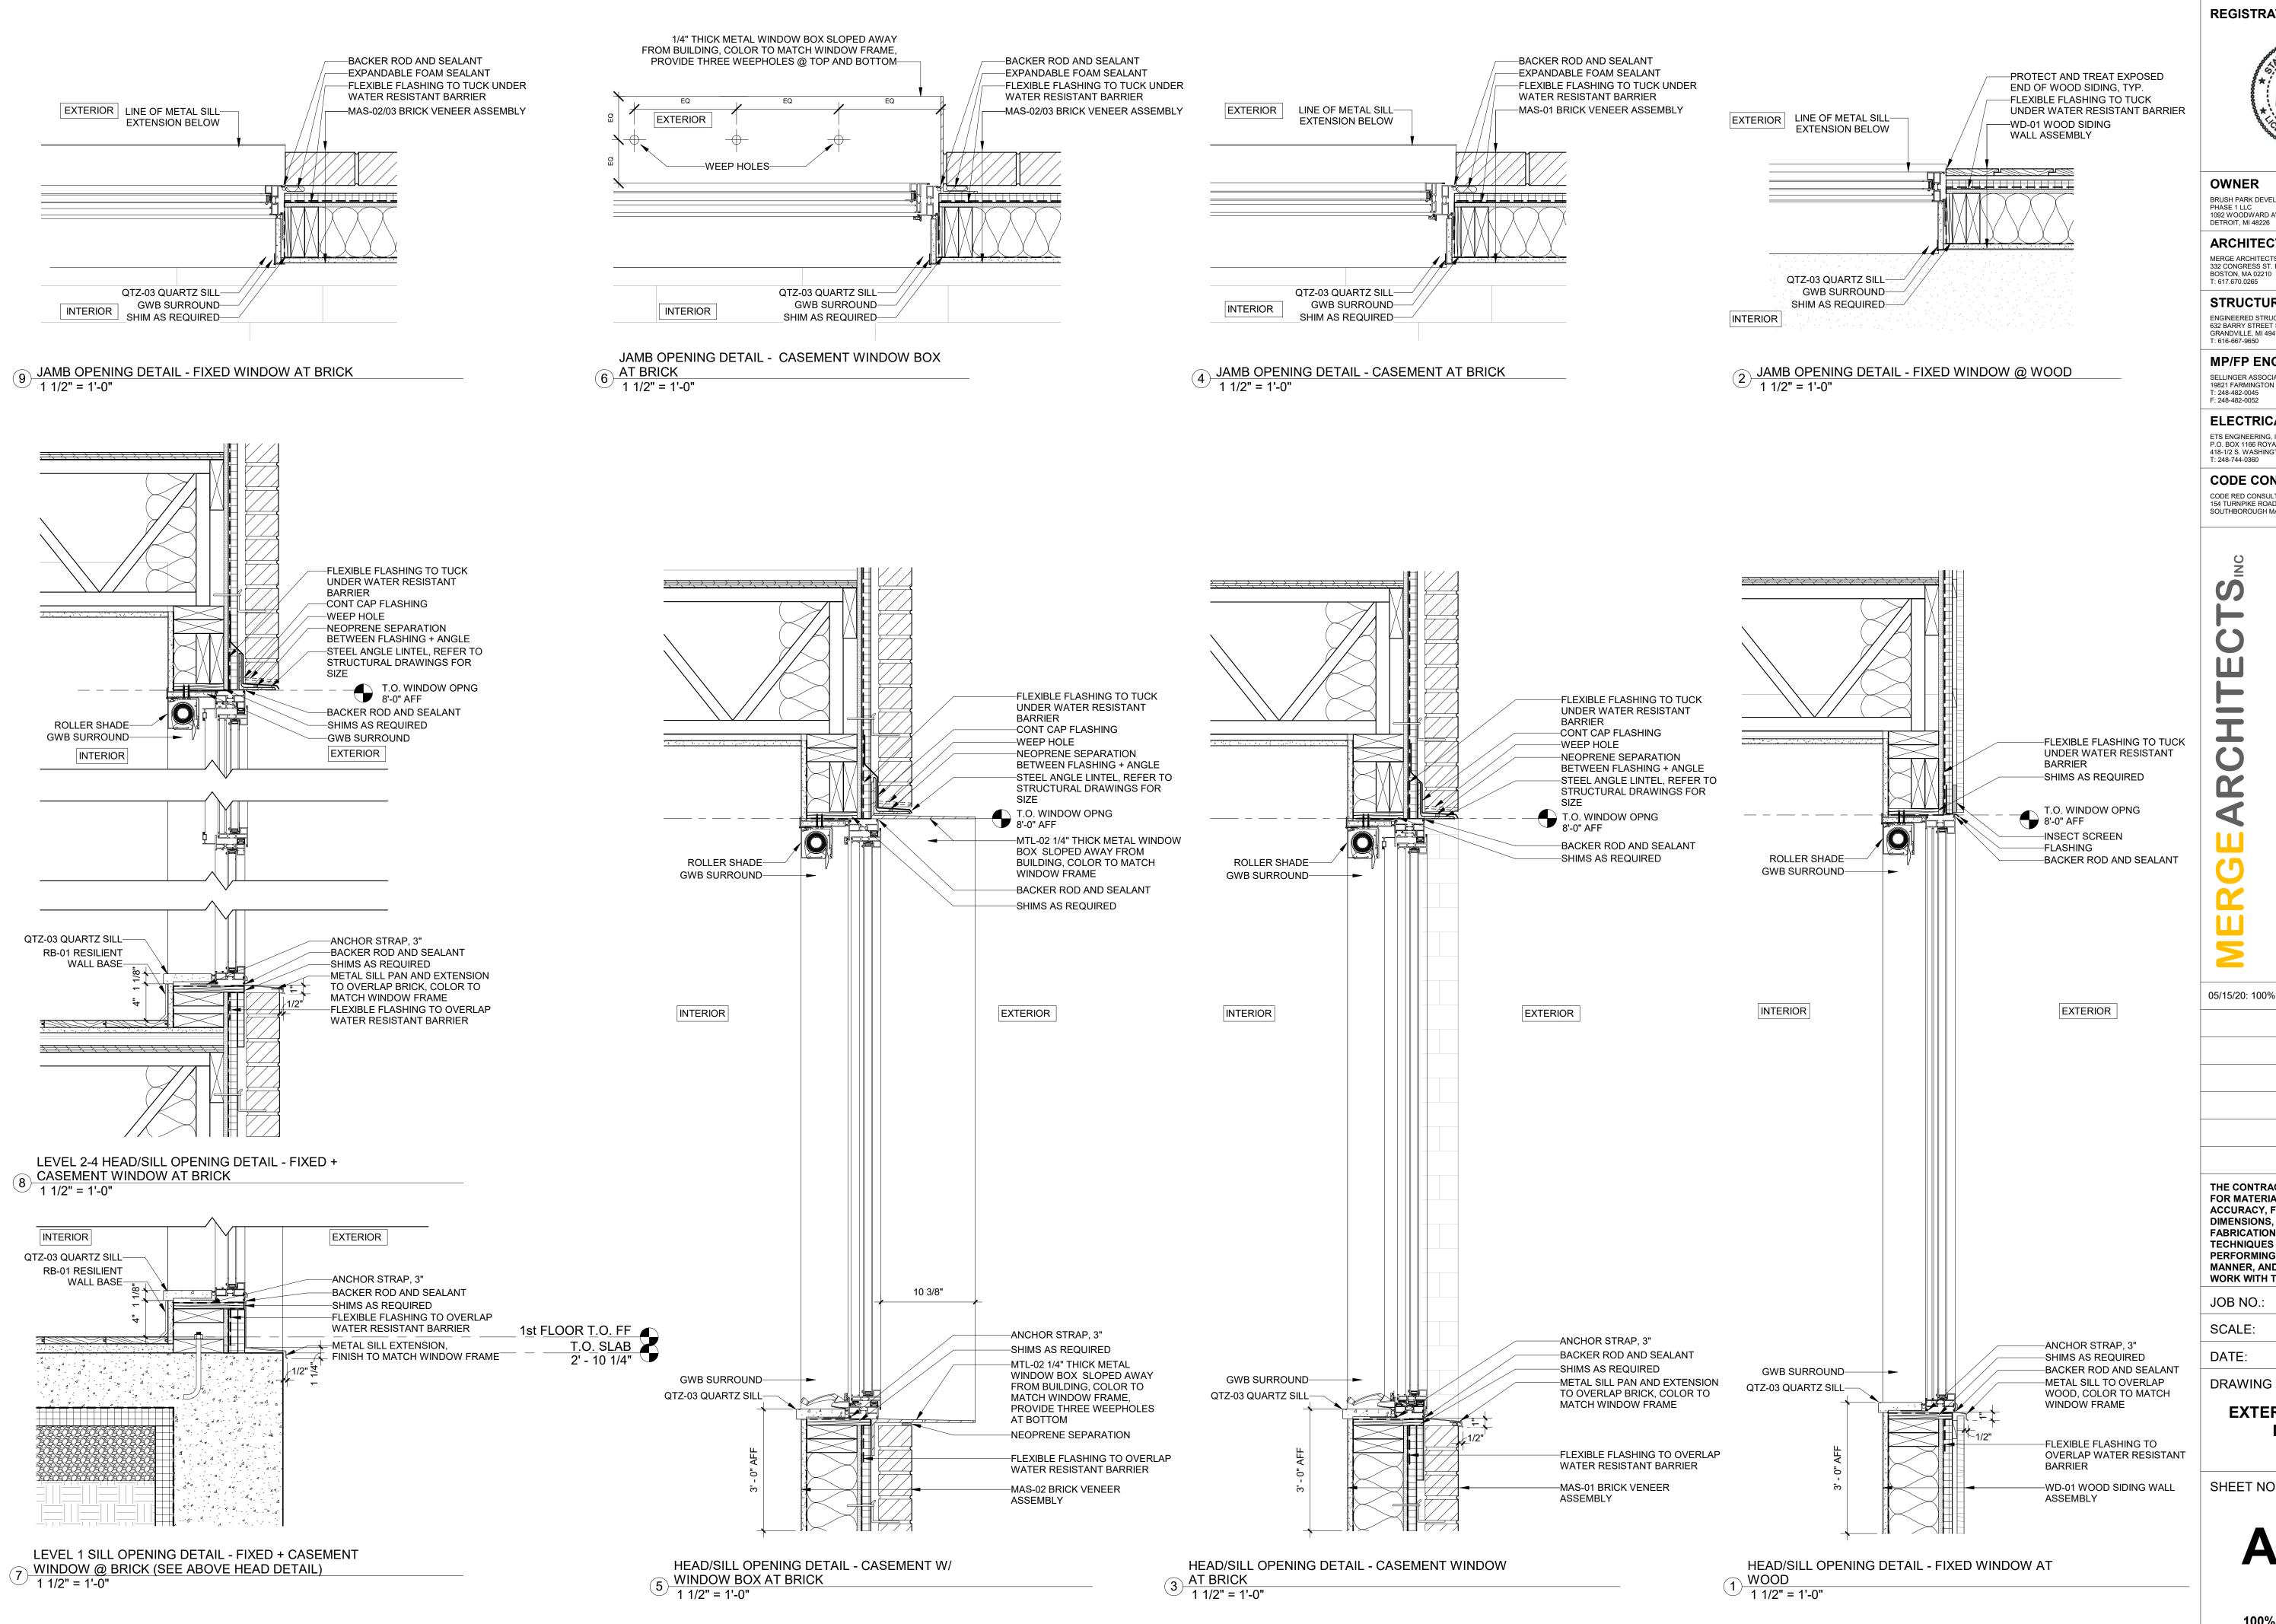



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18284 JOB NO.: 1 1/2" = 1'-0" SCALE: 05/15/2020


DRAWING TITLE

EXTERIOR WINDOW DETAILS

SHEET NO.



DOOR LEGEND

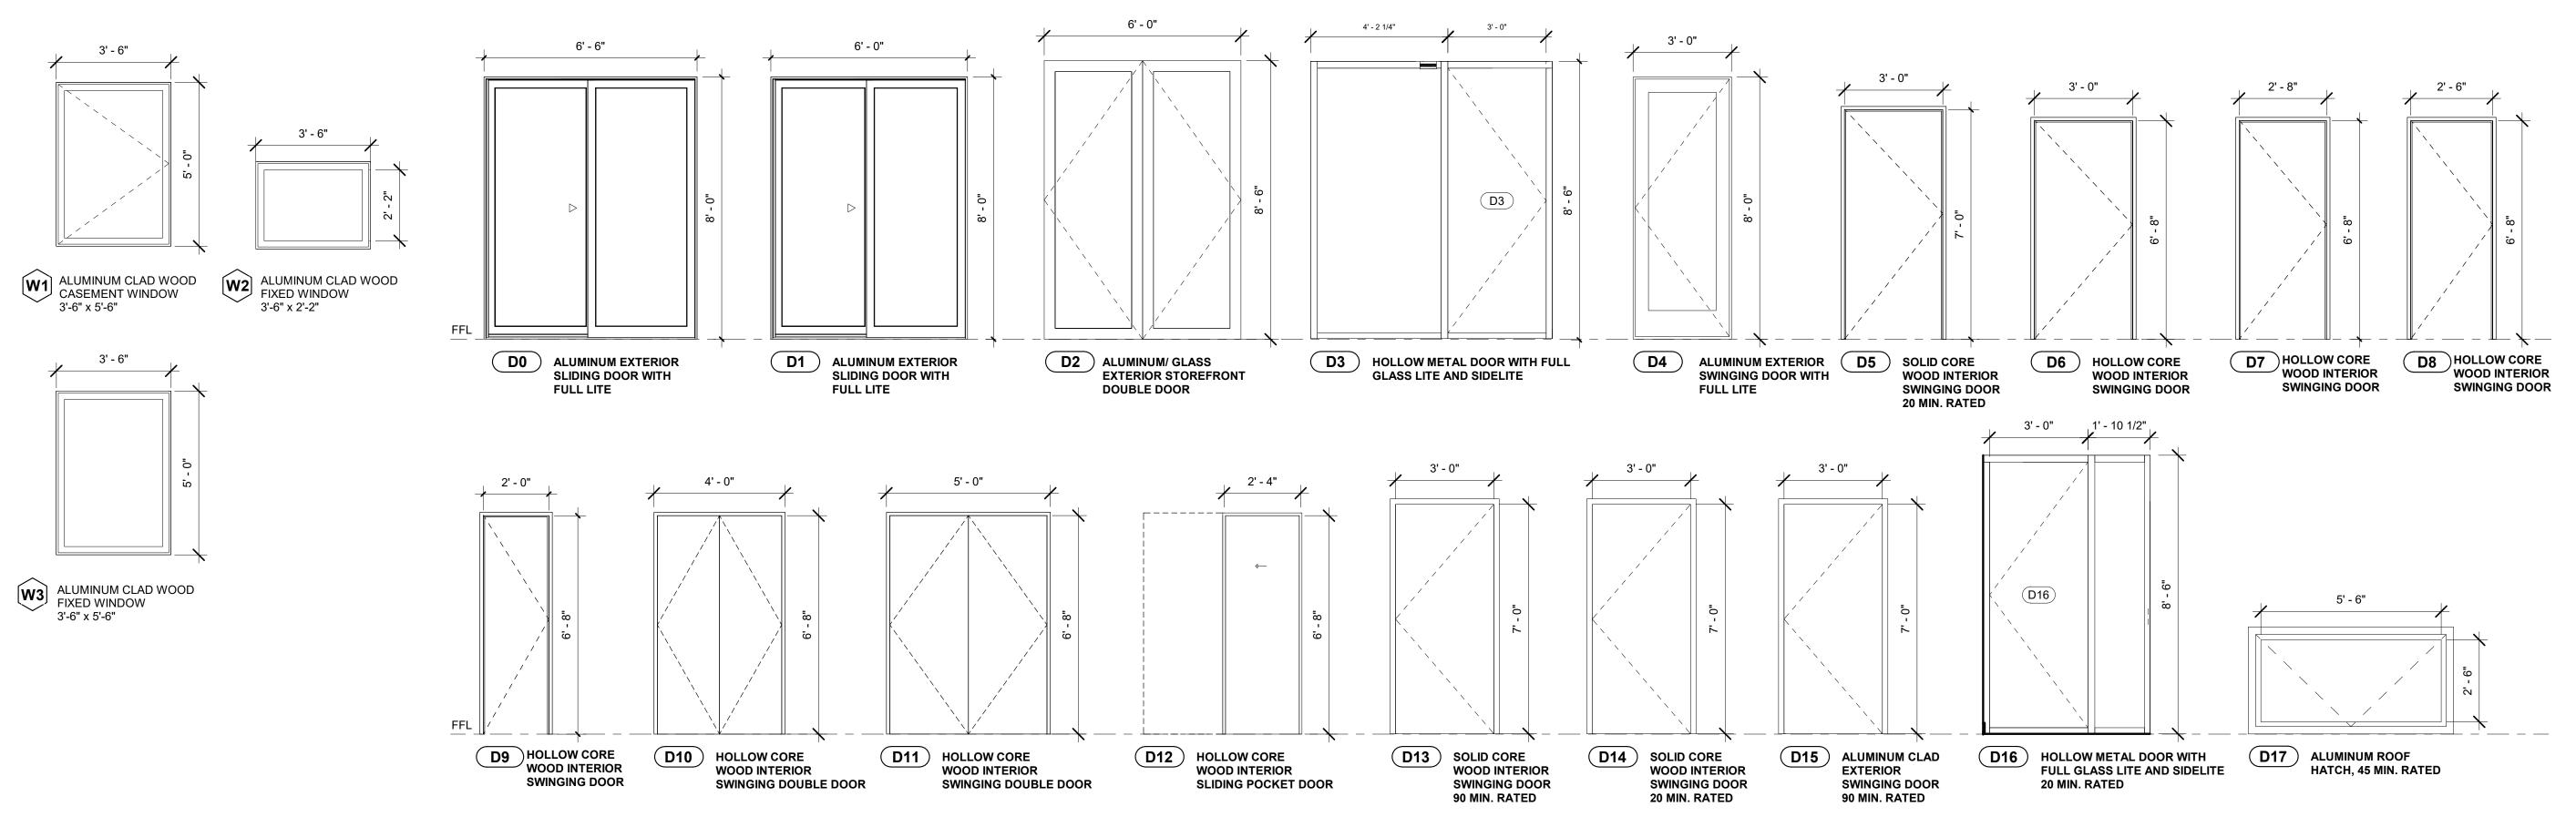

WINDO	WINDOW SCHEDULE								
Mark	Location	Count	Width	Height	Description	Basis of Design	Frame Finish	Head/ Sill	Jamb
W1	Units	107	3' - 6"	5' - 0"	Aluminum Casement Window	Quaker, M600 ModernVu	Dark Bronze Anodized	3/5, A-511	4/6, A-511
W2	Units	27	3' - 6"	2' - 8"	Aluminum Fixed Window	Quaker, M600 ModernVu	Dark Bronze Anodized	7/8, A-511	9, A-511
W3	Lobbies, Residential Storage 2,3	4	3' - 6"	5' - 0"	Aluminum Fixed Window	Quaker, M600 ModernVu	Dark Bronze Anodized	1, A-511	2, A-511
	Total:	138							

				Size				Door						Frame		Sidelite		H	ardware	
Mark	Location	Coun	t Widtl	h Height	Thickn	ess Fire Ratir	g Description	Basis of Design	Finish	Glass Size	Glass Type	Description	Head/ Sill	Jamb	Finish	Glass Size Glass Type	Handle	Latch	Hinges	Additional Hardware
	Unit Balcony	3	6' - 6"	8' - 0"	2-1/8"	stile -	Aluminum Exterior Sliding Door with Full Lite	Quaker, M600 Sliding Door	Dark Bronze Anodized 2	2'-9" x 7'-2" per leaf	1" Tempered A	luminum	7,8, A-510	9, A-510	Dark Bronze Anodized		Flush Handle (per manufacturer options)	TBD	Steel Rollers/ Stainless Steel Track	-
	Unit Balcony	15	6' - 0"	8' - 0"	2-1/8"	stile -	Aluminum Exterior Sliding Door with Full Lite	Quaker, M600 Sliding Door	Dark Bronze Anodized 2	2'-6" x 7'-2" per leaf	1" Tempered A	luminum	8, A-510	9, A-510	Dark Bronze Anodized		Flush Handle (per manufacturer options)	TBD	Steel Rollers/ Stainless Steel Track	-
	Lobby Entrances	2	6' - 0"	8' - 0"	2-1/4"	-	Aluminum/ Glass Exterior Storefront Double Door	Kawneer Insulclad 360 Thermal Entrance	Dark Bronze Anodized 2	2'-3 7/8" x 7'-4 7/8" per leaf	1" Tempered A	luminum	5, A-510	6, A-510	Dark Bronze Anodized		Arbortek Rockwood Straight Pull RM4160 Black Suede Powder Coat + Maple, Standard Domestic 48"	Adams-Rite MS 1850A deadlock (per manufacturer)	Steel, bearing type	1601 BF adjustable surface closer with hold-open, Card Re ADA automatic door opener Push Button, Exit Device
	Lobby Airlock	1	3' - 0"	8' - 3"	1-3/4"	-	Hollow Metal Door with Full Glass Lite and Sidelite	Ceco Assa Abloy Thrulite 3-5/8" Stile + Rail Entrance Door (No Center Rail)	Dark Bronze Anodized 2	2'-4 7/8" x 7'-1 7/8"	1" Tempered H	lollow Metal Series BQ	1, 7, A-602	9, A-602	Dark Bronze Anodized	8'-6" x 4'-2 1/4" 1" Tempered	Sargent Lock IN120 7976 B E4 MI 20D RH Set Dark Statuary Bronze Clear Powder Coat	-	Steel, bearing type	Closer, Card Reader (see Handle), ADA Push Paddle
	Unit Balcony	9	3' - 0"	8' - 0"	2-1/4"	-	Aluminum Clad Exterior Swinging Door with Full Lite	Quaker, ModernVu Terrace Door - Inswing	Dark Bronze Anodized 2	2'-2" x 7'-2"	1" Insulated A	luminum	3, A-510	4, A-510	Dark Bronze Anodized		Kwikset Halifax 156HFLRDT-514 SMT Iron Black (Keyed Entry)	TBD	Steel, bearing type	-
	Unit Entries	31	3' - 0"	7' - 0"	1-3/4"	20 min.	Solid Core Wood Interior Swing Door	Masonite Architectural Aspiro Marshfield-Algoma Paintable Particleboard Core	PT-04 -		- V	Vood	3, 8 A-602	10, A-602	PT-04		Sargent Lock IN120 7976 B E4 MI 20D RH Set, Dark Statuary Bronze Clear Powder Coat	3/4" Projection Stainless Steel Latchbolt 1" Projection Steel Deadbolt Per Lockset	Steel, bearing type	Peephole Viewer, Closer, Door Position Switch, Electric Mortise Lock, Card Reader (see Handle)
	Unit Interiors	18	3' - 0"	6' - 8"	1-3/4"	-	Hollow Core Wood Interior Swing Door	Steve's Doors Flush - Primed Smooth Hardboard	PT-01 -		- v	Vood	4, 5 Sim, 8 A-602	10, A-602	PT-01		Kwikset Milan 155MILRDT-514, Iron Black (Privacy Door Lever Set with Push Button Lock)	-	Steel, bearing type	-
	Unit Interiors	107	2' - 8"	6' - 8"	1-3/4"	-	Hollow Core Wood Swinging Door	Steve's Doors Flush - Primed Smooth Hardboard	PT-01 -		- v	Vood	4, 5 Sim, 8 A-602	10, A-603	PT-01		Kwikset Milan 155MILRDT-514, Iron Black (Privacy Door Lever Set with Push Button Lock)	-	Steel, bearing type	-
	Unit Interiors	40	2' - 6"	6' - 8"	1-3/4"	-	Hollow Core Wood Swinging Door	Steve's Doors Flush - Primed Smooth Hardboard	PT-01 -		- V	Vood	4, 5 Sim, 8 A-602	2 10, A-604	PT-01		Kwikset Milan 157MILRDT-514, Iron Black (Reversible, Non-Turning One-Sided Dummy Door)	-	Steel, bearing type	-
	Unit Closets	2		6' - 8"	1-3/4"	-	Hollow Core Wood Swinging Door	Steve's Doors Flush - Primed Smooth Hardboard	PT-01 -		- V	Vood	4, 5 Sim, 8 A-602	2 10, A-605	PT-01		Kwikset Milan 157MILRDT-514, Iron Black (Reversible, Non-Turning One-Sided Dummy Door)	-	Steel, bearing type	-
	Unit Closets	5		6' - 8"	1-3/4"	-	Hollow Core Wood Swinging Double Door	Steve's Doors Flush - Primed Smooth Hardboard	PT-01 -		- V	Vood	4, 5 Sim, 8 A-602	10, A-606	PT-01		Kwikset Milan 157MILRDT-514, Iron Black (Reversible, Non-Turning One-Sided Dummy Door)	-	Steel, bearing type	-
	Unit Closets	51	5' - 0"		1-3/4"	-	Hollow Core Wood Swinging Double Door	Steve's Doors Flush - Primed Smooth Hardboard	PT-01 -		- V	Vood	4, 5 Sim, 8 A-602	10, A-607	PT-01		Kwikset Milan 157MILRDT-514, Iron Black (Reversible, Non-Turning One-Sided Dummy Door)	-	Steel, bearing type	-
	Unit F Walk-in Closet	3		6' - 8"	1-3/4"	-	Hollow Core Wood Sliding Pocket Door	Steve's Doors Flush - Primed Smooth Hardboard			- V	Vood	4, 5 Sim, 8 A-602	10, A-608	PT-01		Emtek Modern 220304US19, Flat Black (Rectangular 4 Inch Tall Flush Door Pull)	-	Johnson 100PDSC Soft-Close Pocket Door Hardware or sim.	-
	Common Stairs 1 & 2	8		7' - 0"	1-3/4"	90 min.	Solid Core Wood Interior Swing Door	Masonite Architectural Aspiro Marshfield-Algoma Paintable Fire-Resistant Mineral Core	PT-04 TYP. PT-06 @ Lobby 1		- V	Vood	4, 5 Sim, 8 A-609	10, A-609	PT-04 TYP. PT-06 @ Lobby 1		Kwikset Halifax 156HFLRDT-514 SMT, Iron Black (Keyed Entry)	-	Steel, bearing type	Card Reader, Exit Device (Push Bar)
	Residential Storage, Janitor	5		7' - 0"	1-3/4"	20 min.	Solid Core Wood Interior Swing Door	Masonite Architectural Aspiro Marshfield-Algoma Paintable Particleboard Core	PT-04 -		- V	Vood	2 Sim, 8 A-602	10, A-610	PT-04		Kwikset Halifax 156HFLRDT-514 SMT, Iron Black (Keyed Entry)	-	Steel, bearing type	Card Reader, ADA Push Paddle
	Common Stair 2	1		7' - 0"	1-3/4"	90 min.	Steel Clad Exterior Swinging Door	Ceco Assa Abloy Mercury Door (F) and Frame	RAL 9017		- S	iteel	1, A-510	2, A-510	RAL 9017		Kwikset Halifax 156HFLRDT-514 SMT, Iron Black (Keyed Entry)	-	Steel, bearing type	Card Reader, Exit Device (Push Bar)
	Residential Storage 2 &	3 2	3' - 0"		1-3/4"	20 min.	Hollow Metal Door with Full Glass Lite and Sidelite	Stile + Rail Entrance Door (No Center Rail)	Dark Bronze Anodized 2	2'-4 7/8" x 7'-1 7/8"		lollow Metal Series BQ	1 Sim, 7, A-602	9, A-602	Dark Bronze Anodized	8'-6" x 1'-10 1/2" 1" Tempered	Sargent Lock IN120 7976 B E4 MI 20D RH Set, Dark Statuary Bronze Clear Powder Coat	-	Steel, bearing type	Closer, Card Reader (see Handle)
	Roof Access	1	2' - 6"	1' - 0"	-	-	Aluminum Roof Hatch	Bilco, NB-TB	Mill Finish -		- A	luminum	-	-	Mill Finish		Per Manufacturer (Interior and exterior turn handles and padlock hasps, zinc plated chromate sealed)	Slam latch, zinc plated chromate sealed (per manufacturer)	Type 316 steel hinges (per manufacturer)) -

REGISTRATION



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418-1/2 S. WASHINGTON AVE, ROYAL OAK, MI 48067
T: 248-744-0360

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John and **Duplette Brush Park Duplet**On Edmund Place
Between Brush St. a
Detroit MI, 48201

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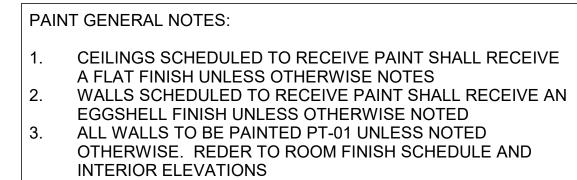
3/8" = 1'-0" 05/15/2020

18284

DRAWING TITLE

WINDOW & DOOR **SCHEDULES**

SHEET NO.



- WET AREAS SCHEDULED TO RECEIVE PAINT SHALL RECEIVE A SEMI-GLOSS FINISH (E.G. TOILET ROOMS, SHOWER ROOMS, AND WALLS BEHIND DRINKING FOUNTAINS) FOR ALL SURFACES (WALLS, CEILINGS, ETC) UNLESS NOTED OTHERWISE
- ALL DOORS AND FRAMES TO RECEIVE PAINT SHALL RECEIVE SEMI-GLOSS FINISH. ALL DOORS, DOOR FRAMES, TRIM, AND WINDOW FRAMES TO BE PT-01 UNLESS NOTED OTHERWISE
- TYPICAL CONDITIONS HAVE BEEN INDICATED ON DRAWINGS BUT DO NOT EXPRESS ALL CONDITIONS. THE INDICATION OF PAINTING DOES NOT PRECLUDE PAINTING ON OTHER AREAS NOT INDICATED ON DRAWINGS
- PROVIDE ACCENT PAINT COLOR MOCKUP FOR ARCHITECT | FINISH GENERAL NOTES: APPROVL OF ACCENT PAINT COLORS AND LOCATIONS


PREPARE ALL FLOORING SUBSTRATES TO RECEIVE NEW FLOORING MATERIAL. MAKE ALL TRANSITIONS FLUSH AND CLEAN AS REQUIRED TO RECEIVE NEW FLOORING

- MATERIAL EXTEND FLOORING INTO TOE SPACES AND KNEE SPACES
- AS NEEDED INSTALL FLOORING UNDER ALL FLOOR MOUNTED **EQUIPMENT**
- TERMINATE FLOORING MATERIAL AT THRESHOLD, PER FLOORING TRANSITION DETAILS, WHERE ADJACENT FLOOR FINISH AND/ OR COLOR IS DISSIMILAR ADA COMPLIANT TRANSITION/ REDUCER STRIPS TO BE USED AT MATERIAL HEIGHT DIFFERENCE AND DISSIMILAR MATERIALS, U.O.N.
- FLOORING CONTRACTOR TO SUBMIT SEAMING PATTERN TO ARCHITECT FOR APPROVAL PRIOR TO INSTALLATION ALL GROUT JOINTS TO ALIGN WITH ADJACENT WALL TILE/ BASE TILE, U.O.N. CONTRACTOR TO SUBMIT GROUT AND TILE LAYOUT FOR APPROVAL PRIOR TO INSTALLATION


FLOORING GENERAL NOTES:


ALL FINISHES SHALL BE PROVIDED AS SPECIFIED. NO SUBSTITUTIONS, U.O.N.

DISCREPANICES IN FINISH DESIGNATIONS SHALL BE BROUGHT TO THE ATTENTION TO THE ARCHITECT FOR RESELECTION OR CLARIFICATION

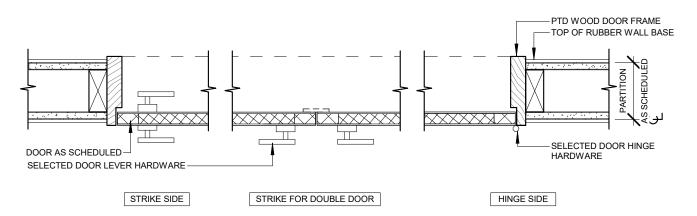

10 PLAN DETAIL - WOOD FRAME SWING DOOR, TYP. 1 1/2" = 1'-0"

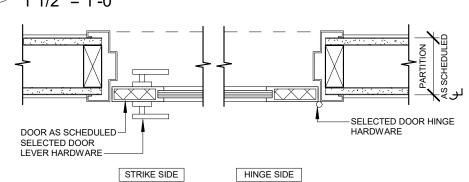

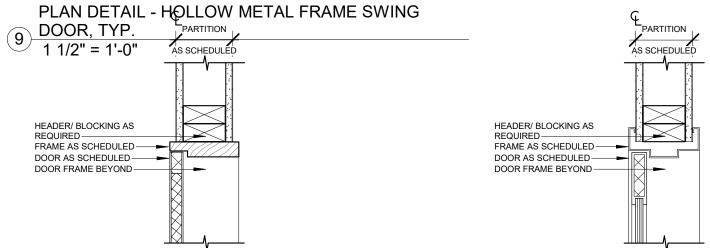


SECTION DETAIL - WOOD FRAME

DOOR FRAME


BEYOND —


RUBBER WALL BASE AS SCHEDULED

AS SCHEDULED —

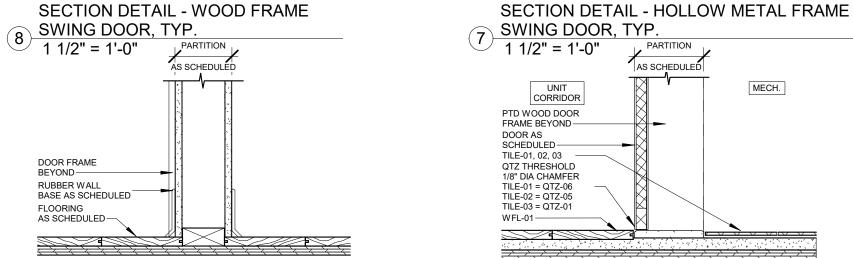

6 SECTION DETAIL - BASEBOARD, TYP.

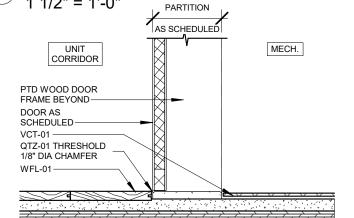

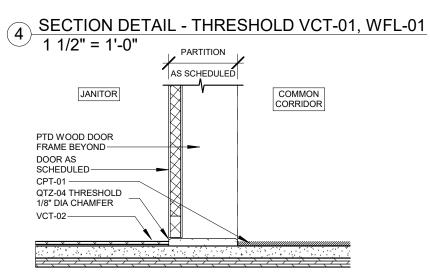

2 SECTION DETAIL - THRESHOLD CPT-01, VCT-02 1 1/2" = 1'-0"

SECTION DETAIL - THRESHOLD CPT-01, WFL-01 3 1 1/2" = 1'-0" CORRIDOR HOLLOW METAL DOOR FRAME BEYOND -DOOR AS SCHEDULED-CPT-01 ----SCHLUTER SCHIENE TRANSITION STRIP GROUT-1 SECTION DETAIL - THRESHOLD CPT-01, TILE 1 1/2" = 1'-0"

5 SECTION DETAIL - THRESHOLD TILE, WFL-01

AS SCHEDULE

CORRIDOR

Shower Enclosure

Wood Veneered Cabinetry

Wood Veneered Vanities

FURNISHINGS

C.R. Laurence Co.

Locally Sourced by GC

Locally Sourced by GC

Tempered Glass Wall and Door

Flat Panel, Full Overlay

Flat Panel, Full Overlay

Clear Glass, U-Channel at shower Per detail 3/A-902

Per detail 2/A-902

Per detail 1/A-902

sill and wall for panels. Stainless

Steel hinges.

UNIT

PTD WOOD DOOR

FRAME BEYOND -

QTZ-04 THRESHOLD

1/8" DIA CHAMFER

DOOR AS

WFL-01----

SCHEDULED-CPT-01 ----

	Description	Manufacturer	Series/ Type	Finish/ Color	Size/ Dims	Location
CONCRETE CON-01	Concrete with Integral Color	Concrete: Locally Sourced by GC Integral Color: Butterfield Color	Uni-Mix Integral Color	U18 Gull Gray	See Floor Plans	Stoop and Steps at Building Exterior
CON-02	Concrete, Exposed Foundation Wall	Locally Sourced by GC			varies	Exposed Foundation wall at Building Base up +36" above Grade
CON-03	Concrete with Non-slip Traffic Coating	Concrete: Locally Sourced by GC	No Slip Skid Safe System™ For Concrete	Satin/ Matte	varies	First Floor Balcony Flooring; Treads and
MASONRY		Coating: New Dimensions Solutions				Landings at Metal Pan Stair MTL-03
MAS-01,02,03	Brick Veneer	Interstate	2-1/4" Modular	Monterey red mix	3-5/8" x 2-1/4" x 7-5/8" (Modular)	Exterior Cladding
CMU-01	Concrete Masonry Unit	Locally Sourced by GC			8" x 8" x 16"	Common Stair 1 Shaft Enclosure
METALS						
MTL-01	Steel Railing and Spindles	American Stair	Custom with stock flat metal	Powder-coated Dark Bronze to	Per detail 3/ A-504	Balcony Guardrail; Ramp and Stair Guard a
	g and opinion			match window finish		Handrail
MTL-02	Steel Window Box	Locally Sourced by GC		Powder-coated Dark Bronze to match window finish	Per detail 5/ A-511	At Windows noted on Exterior Elevations
MTL-03	Metal Pan Stairs and Railing	American Stair	Box Stringer, Metal Pan Tread, Vertical Picket Railing	Powder-coated to match PT-07 color	Per drawings A-800, A-801	Common Stair 1 and 2
MTL-04	Steel Wall Panels	Brandner Design or equal (https://brandnerdesign.com/)	Blackened hot rolled (from standard steel finish)	Sealer	16-gauge, Glue applied to substrate, Per detail 6/ A-901	Lobby 1 Walls for Mailboxes, Package Drop Receptacle
WOOD						
WD-01	Cedar Siding	Locally Sourced by GC	Red Cedar species	A-Grade Clear, Shiplap, Vertical Application	4" wide	Exterior Cladding
WD-02	Composite Wood Decking	Trex	Transcend	Havana Gold	1" Square Edge Board	Balcony Flooring
WD-03	Top Rail Wood Trim	Locally Sourced by GC	Pine species	Painted to match wall finish	Per detail 2/A-900	Unit Stair
OISTURE PRO	OTECTION					
MEM-01	EPDM Membrane	Johns Manville	Adhered 60 mil 2 Sided FIT EPDM over Adhered Invinsa Cover Board (150 psi) and Energy 3 CGF 25 psi ISO	Black color	60-mil thick	Roof Covering
MEM-02	EPDM Membrane	Johns Manville	Adhered 60 mil 2 Sided FIT EPDM	Black color	60-mil thick	Covering beneath Balcony Decking
OPENINGS		A contributor & conserve and a contribution				W. H. W. Marrier and
MIR-01	Mirror	Locally Sourced by GC		Frameless, Clear finish	Per Bathroom layout on A-721 though A-72	Unit Bathroom
QTZ-01	Quartz (Cultured Stone)	Caesarstone		Airy Concrete 4044 color	2-cm thick, square edge	Unit Kitchen Countertop and Backsplash
QTZ-02	Quartz (Cultured Stone)	mti bath	SculptureStone, Boutique collection bathroom counter sink (Custom)	White	Integrated Vanity/ Basin and 3"	Unit Bathroom
QTZ-02 (ALT)	Quartz (Cultured Stone)	Avanity	Solid Surface #VUT61WT (61 in vanity), #VUT37WT (37 in vanity),	Solid White	Backsplash, per sheets A-700s and A-901 Integrated Vanity/ Basin and 3"	Unit Bathroom
		Feb. 155 Mg. 165 G.	#VUT31WT (31 in vanity)	Section (1997) Section (1997) Section (1997)	Backsplash, per sheets A-700s and A-901	
QTZ-03	Quartz (Cultured Stone)	Locally Sourced by GC	Dwyer Marble and Stone ENVI™ ENGINEERED QUARTZ	TEMPLE WHITE	2-cm thick	Window Sill
QTZ-04	Quartz (Cultured Stone)	Locally Sourced by GC	Dwyer Marble and Stone ENVI™ ENGINEERED QUARTZ	ASH SUEDE FINISH	3-cm thick	Unit Door Threshold
QTZ-05	Quartz (Cultured Stone)	Locally Sourced by GC	Dwyer Marble and Stone ENVI™ ENGINEERED QUARTZ	Grey Birch Suede Finish	3-cm thick	Bathroom 1 Door Threshold
QTZ-06	Quartz (Cultured Stone)	Locally Sourced by GC	Dwyer Marble and Stone ENVI™ ENGINEERED QUARTZ	Metro Slate Brushed	3-cm thick	Bathroom 2 Door Threshold
TILE-01	Porcelain Tile	Stone Source	Giocare	Grey	8.5mm thick	Unit Full Bathroom Flooring and Wet Walls
TILE-02	Porcelain Tile	Nemo Tile	Tread	Neutral	10mm thick	Unit Half Bathroom Flooring
TILE-03	Ceramic Tile	Daltile	Balans	White BA30 color	5/16" thick	Unit Laundry Room Flooring
TILE-04	Porcelain Tile	Stone Source	Gris	Ancienne	24"x48"x10mm	Lobby 1 Flooring
WF-01		Havwoods	PurePlank	HW2204 Provence	7 1/8" wide	Unit Flooring
	Engineered Weed Flooring	Tiavwoods	1 del falle	TIVVEEST FISTORICS	7 170 Wide	Office Hoofing
ACT-01	Acoustic Ceiling Tile	Armstrong	Ultima Tegular 535 w/ Suprafine 9/16" Suspension System	White	24" x 48"	Common Corridor Ceiling
FLOORING						
CPT-01	Carpet, Tiles	Ege Carpets	Reform Terra ECT350	Anthracit (Black/ Grey)	96-cm x 96-cm	Common Corridor Flooring
CPT-02	High Traffic Carpet Walk-off Mat	Musson	HT-CM Hi-Traffic Carpet Entrance Matting	Black Shadow	13'-2" width, custom cut	at Doors of Lobby 1 and Common Corridor
VCT-01	Vinyl Composite Tile	Armstrong	Premium Excelon Crown Texture 5c899	Cool White	12" x 12" x 1/8"	Unit Mech Room Flooring
VCT-02	Vinyl Composite Tile		Premium Excelon Raffia 55802	Charcoal Dust	12" x 12" x 1/8"	· ·
	Viriyi Composite Tile	Armstrong	Premium excelon Rama 55602	Charcoal Dust	12 X 12 X 1/0	Janitor's Room and IT Room Flooring
BASE						
RB-01	Resilient Wall Base	Johnsonite	Vinyl, Toe	White	4" height	Unit General
RB-02	Resilient Wall Base	Johnsonite	Vinyl, Toe	Mist	4" height	Unit Laundry Room
RB-03	Resilient Wall Base	Johnsonite	Vinyl, Toe	Burnt Umber	4" height	Common Corridor
RB-04	Resilient Wall Base	Johnsonite	Vinyl, Toe	Dover	4" height	Lobby 1
RB-05	Resilient Wall Base	Johnsonite	Vinyl, Toe	Pewter	4" height	Janitor's Room and IT Room
RB-06	Resilient Wall Base	Johnsonite	Vinyl, Toe	Vapor Grey	4" height	Unit Mech Room
PAINT PT-01	Interior Paint	Sherwin-Williams	Latex, Low VOC	Designer White color, Eggshell	-	Unit Walls and Trim
PT-02	Interior Paint	Sherwin-Williams	Latex, Low VOC	finish, two coats, Level 4 drywall Designer White color, Flat finish,	-	Unit Ceilings
PT-03	Interior Paint	Sherwin-Williams	Latex, Low VOC	two coats, Level 4 drywall Designer White color, Semi-gloss		Unit Bathroom Walls and Ceilings
	300 (300 300 300 (300 (300 (300 (300 (3			finish, two coats, Level 4 drywall		_
PT-04	Interior Paint	Benjamine Moore	Latex, Low VOC	Iron Mountain, Flat finish, two coats, Level 4 drywall	-	Unit Entry area along Common Corridor
PT-05	Interior Paint	Benjamine Moore	Latex, Low VOC	Iron Mountain, Flat finish, two coats, Level 4 drywall	===	Lobby 1 Ceiling
PT-06	Interior Paint	Sherwin-Williams	Latex, Low VOC	Solstice, Eggshell finish, two coats, Level 4 drywall	-	Common Corridor Walls, Lobby walls
PT-07	Interior Paint	Sherwin-Williams	Latex, Low VOC	Common Stair Accent 1, Eggshell finish, two coats, Level 4 drywall	-	Common Stair 1 and 2 Stairs, Railing, Walls Ceilings
PT-08	Interior Paint	Sherwin-Williams	Latex, Low VOC	Common Stair Accent 2, Eggshell finish, two coats, Level 4 drywall	-	Common Stair 1 and 2 Stairs, Railing, Walls Ceilings
PT-09	Interior Paint	Sherwin-Williams	Latex, Low VOC	Common Stair Accent 3, Eggshell finish, two coats, Level 4 drywall	-	Common Stair 1 and 2 Stairs, Railing, Walls Ceilings
SPECIALTIES						
WT-01	Roller Shade	Hunter Douglas	Designer Roller Shades, Cordless	White (Fabric TBD), Solar Screen Fabric and 1% Opacity	Per window dimensions	Unit General
WT-02	Roller Shade	Hunter Douglas	Designer Roller Shades, Cordless	White (Fabric TBD), Solid Blackout	t Per window dimensions	Unit Bedrooms and Bathrooms

REGISTRATION



OWNER BRUSH PARK DEVELOPMENT COMPANY PHASE 1 LLC 1092 WOODWARD AVE.

ARCHITECT MERGE ARCHITECTS, INC. 332 CONGRESS ST. FLOOR 6 BOSTON, MA 02210

T: 617.670.0265 STRUCTURAL ENGINEER ENGINEERED STRUCTURES, LLC.

632 BARRY STREET SW GRANDVILLE, MI 49418 **MP/FP ENGINEER**

SELLINGER ASSOCIATES, INC. 19821 FARMINGTON ROAD, LIVONIA, MI 48152 T: 248-482-0045 F: 248-482-0052

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P.O. BOX 1166 ROYAL OAK, MI 48068 418-1/2 S. WASHINGTON AVE, ROYAL OAK, MI 48067

CODE CONSULTANT CODE RED CONSULTANTS 154 TURNPIKE ROAD, SUITE 200 SOUTHBOROUGH MA, 01772

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05/15/20: 100% CD / PERMIT SET

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18284 JOB NO.: As indicated DATE: 05/15/2020

DRAWING TITLE

MATERIAL INDEX & TRANSITION DETAILS

SHEET NO.

EnSuite Bathroom (Units F, G, G')

Unit Kitchen

Unit Bathroom

			ACCESSORIES & EQUI	PMENT SCHEDULE		
Type Mark	Location	Description	Manufacturer	Туре	Model	Finish
				Exit Sign		
GB-01	Bathroom	Components Grab Bar	Kohler	42" Grab Bar	K-25162-BL	Matte Black
GB-02	Bathroom	Components Grab Bar	Kohler	24" Grab Bar	K-78387-BL	Matte Black
MAIL	Lobby	Mailboxes	Florence Manufacturing Co	Versatile	4C09D (See Elevations A-730)	Black (BK)
ROD-01	Bathroom	Shower Rod	Allied Brass	60" Shower Curtain Rod	SR-60-BKM	Matte Black
ROD-02	Unit Closets	Shelf & Heavy Duty Rod	TBD	TBD	TBD (Not Wire System)	White
SS-01	Bathroom	Choreograph Floating Shower Shelf	Kohler	21" Shower Shelf	K-97623-BNK	Anodized Brushed Nicke
STO-01	Residential Storage 1	Welded Wire Tenant Storage Units, 2 stacked	BeastWire Mesh Guarding	2'-0"x 4'-0"		Gray
STO-02	Residential Storage 2, 3	Welded Wire Tenant Storage Units, 2 stacked	BeastWire Mesh Guarding	3'-0"x 4'-0"		Gray
TP-01	Bathroom	Composed Pivoting Toilet Tissue Holder	Kohler	Toilet Paper Holder	K-73147-BL	Matte Black
TR-01	Bathroom	Components Towel Bar	Kohler	Towel Bar 24"	K-78373-BL	Matte Black
TR-02	Bathroom	Components Towel Arm	Kohler	Towel Arm	K-78377-BL	Matte Black
TRASH	Lobby	Trash Receptacle	American Specialties Inc.	Piatto Collection Waste Receptacle	6474-41	Matte Black

			APPL	LIANCE SCHEDULE		
Type Mark	Location	Description	Manufacturer	Туре	Model	Finish
				Exit Sign		
D-01	Laundry	Dryer Front Loading	Bosch	500 Series Compact Condensation Dryer 24"	WTG86401UC	White
DW-01	Kitchen	Dishwasher	Whirlpool	Stainless Steel Dishwasher	WDF560SAFM	Stainless Steel
DW-02	Kitchen (Type A)	Dishwasher	Whirlpool	Stainless Steel Dishwasher (Short)	WDF550SAHS	Stainless Steel
MW-01	Kitchen	Microwave Oven	Whirlpool	1.7 cu. ft. Microwave Hood Combination	WMH31017HS	Stainless Steel
MW-02	Kitchen (Type A)	Microwave Oven	Whirlpool	1.7 cu. ft. Microwave Hood Combination (Type A)	WMH31017HS	Stainless Steel
RANGE-01	Kitchen	Oven/ Range	Whirlpool	5.8 Cu. Ft. Smart Slide-in Electric Range	WEE510S0FS	Black-on-Stainless
RANGE-02	Kitchen (Type A)	Oven/ Range	Whirlpool	5.8 Cu. Ft. Smart Slide-in Electric Range (Type A)	WEE510S0FS	Black-on-Stainless
REF-01	Kitchen	Refrigerator	Whirlpool	30" Wide Top Freezer Refrigerator	WRT348FMES	Stainless Steel
REF-02	Kitchen (Type A)	Refrigerator	Whirlpool	30" Wide Top Freezer Refrigerator (Type A)	WRT318FZDM	Stainless Steel
RH-01	Kitchen (Type A)	Range Hood	Whirlpool	30" Wide Range Hood	UXT4030ADS	Stainless Steel
W-01	Laundry	Washer Front Loading	Bosch	500 Series Compact Washer 24"	WAT28401UC	White
WD-01	Laundry	Electric Stacked Laundry Center	Bosch	500 Series Compact Condensation Washer + Dryer 24"	WAT28401UC/ WTG86401UC	White

		LIGHTI	NG FIXTURE SCHEDUL	E		
Type Mark	Location	Description	Manufacturer	Туре	Model	Finish
	5 WATT EYEBALL	120V EMERGENCY LIGHT FIXTURE	LSI	LSI-EPM_120V	EPM-SD2-WHT	
L1	Living Room, Kitchen, Bedrooms	Surface Mounted Slim Downlight	Philips Lightolier	SlimSurface LED Round 5" (L1)	S5R830K7	White
L2	Bathrooms	Surface Mounted Slim Downlight	Philips Lightolier	SlimSurface LED Round 5" (L2)	S5R830K7	White
L3	Closets	Lightstick 25" (Motion Sensor)	Modern Forms		WS-47925	White
L4	Closets	Lightstick 49" (Motion Sensor)	Modern Forms		WS-47949	White
L5	Kitchen Island	Pendant	Muuto	Ambit Rail Light	15423	Grey
L6	Vanity	Vanity Light	Tech Lighting	Finn 24 Bath	LED930	Black
L7	Crisp Sconce Small	Small Sconce	Rich Brilliant Willing	Crisp Frosted Interior	CR-S12-30-120-TR-DEX-IP65	Black
L8	Public Corridor	Linear Downlight ACT System Clip-On	Vode	ZipTwo Micro Profile 36"	707-Z2 SL 36 T1 0 RP AE 2 ZZ Z SO 30 S3 ZZ WH 0	White
L9	Public Lobbies/ Commons	Surface Mounted Slim Downlight	Philips Lightolier	SlimSurface LED Round 5" (L9)	S5R830K7	White
L10	Janitors Closets, Residential Storage	Surface Mounted Downlight	Philips	CoreLine Panel Square	SM134V-W60L60-DPP	White
L12	Stairs	Linear Wall Sconce	Alcon	Continuum 23	12100-23-W-D27-18-30K-ELV- WH	White
L13	Exterior Overhangs, Balconies	Recessed Can Light (Exterior)	BEGA	LED Recessed Downlight 6-3/8"	55825	Black
L14	Crisp Sconce Small	Small Sconce (Exterior)	Rich Brilliant Willing	Crisp Frosted Exterior	CR-S12-30-120-TR-DEX-IP65	Black
_15	In-grade	In-grade LED Light (Exterior)	BEGA	In-grade LED	77116	
L16	Exterior Ramp Areas	Wall Mounted Sconce (Exterior)	BEGA	LED Directional Wall Light	24502	Black

			PLUMBING	FIXTURE SCHEDULE		
Type Mark	Location	Description	Manufacturer	Туре	Model	Finish
BT-01	Bathroom	Bath and Shower Trim	Kohler	Purist Rite-Temp Bath and Shower Trim with Lever Handle	#K-T14420-4-BL	Matte Black
BT-02	Bathroom	Handshower Kit	Kohler	Purist® 2.5 gpm Multifunction Handshower Kit	#K-22178-BL	Matte Black
LAV-01	Bathroom	Sink	Kohler	Verticyl Rectangular Undermount Bathroom Sink	#K-2882-7	
LAV-01 FAUCET	Bathroom	Faucet	Kohler	Single-handle Bathroom Sink Faucet	K-99491-4-BL	
LAV-02	Janitors Closet	Mop Service Basin	Zurn Industries, LLC	Mop Service Basin 24" x 24" x 12"	Z1996-24	
LAV-02 FAUCET	Janitors Closet	Wall Mounted Service Sink Faucet	Chicago Faucets	Wall-Mounted Manual Sink Faucet with 8" Centers	897-RCF	
SC-1	Exterior	Box Roof Drainage Scupper	Majestic	Juliette Scupper	Nelson 4"	
SC-2	Exterior	Roof Drainage Scupper	Majestic	Roof Overflow Scupper	Hugo 6"	
SH-01	Bathroom (Ensuite)	Provide with Linear Drain		Tiled Shower		
SK-01	Kitchen	Sink	Vigo	Ludlow Undermount Stainless Steel Sink 23" x 20"	VG2320CK1	
SK-01 FAUCET	Kitchen	Sink	Kohler	Concetto Single Handle Pull Down Sprayer Kitchen Faucet in Super Steel with Dual Spray	K-24982	
TUB-01	Bathroom	Tub - Regular	Duravit	Starck Bathtub Panel Alcove 59" x 29-1/2"	#700332-ST8936	
TUB-02	Bathroom	Tub - Long	Duravit	Starck Bathtub Panel Alcove 70-7/8" x 31-1/2"	#700338-ST8939	
WC-01	Bathroom	Toilet	Duravit	Starck 3 Close Coupled, 14 5/8" x 27 3/4" Inch	#214109	

Type Mark	Location	Description	Manufacturer	Model	Finish
Typo Mark	Location	Возоприон	Wandidotaror	IVIOGOI	T IIIIOTT
EF		Ceiling Exhaust Fan	See Mech. Dwgs	See Mech. Dwgs	
FG-1	Interior Floor	Floor Register	See Mech. Dwgs	See Mech. Dwgs	
FG-2	Interior Floor	Floor Register	See Mech. Dwgs	See Mech. Dwgs	
OA	Exterior	Vent Termination	Luxury Metals	Wall Vent	Stainless Steel
ORS-1	Roof	Roof Overflow Drain	See Plumbing Dwgs	See Plumbing Dwg	
RS-1	Roof	Roof Drain	See Plumbing Dwgs	See Plumbing Dwg	
SG-2	Unit Ceilings	Ceiling Register	See Mech. Dwgs	See Mech. Dwgs	Ptd to match ceiling
TAG-1	Interior Wall	Wall Register	See Mech. Dwgs	See Mech. Dwgs	Ptd to match wall
VD	Exterior	Vent Termination	Luxury Metals	Wall Vent	Stainless Steel
VE	Exterior	Vent Termination	Luxury Metals	Wall Vent	Stainless Steel
VF	Exterior	Furnace Vent Termination	Triangle Tube	4" Wall Vent	Stainless Steel
VT	Exterior	Vent Termination	Luxury Metals	Wall Vent	Stainless Steel

		CABINET	HARDWARE SCHEDULE		
Type Mark	Location	Description	Manufacturer	Model	Finish
HW-01	Kitchen	Cabinet Tab Pull (Long)	Atlas Hardwares	Tab Edge A832-BN	Brushed Nickel
HW-02	Kitchen	Cabinet Tab Pull (Short)	Atlas Hardwares	Tab Edge A831-BN	Brushed Nickel
HW-03	Bathroom	Cabinet Tab Pull (Long)	Atlas Hardwares	Tab Edge A832-BL	Matte Black
HW-04	Bathroom	Cabinet Tab Pull (Short)	Atlas Hardwares	Tab Edge A831-BL	Matte Black
HW-05	Kitchen (Type A)	Cabinet Pull (Long)	Atlas Hardwares	Malin A643-BRN	Brushed Nickel
HW-06	Kitchen (Type A)	Cabinet Pull (Short)	Atlas Hardwares	Malin A641-BRN	Brushed Nickel
HW-07	Bathroom (Type A)	Cabinet Pull (Long)	Atlas Hardwares	Malin A643-BL	Matte Black
HW-08	Bathroom (Type A)	Cabinet Pull (Short)	Atlas Hardwares	Malin A641-BL	Matte Black

Room Name	Floor Finish	Wall Finish	Base Finish	Ceiling Finish
BALCONY	WD-02	WD-01		WD-01
BASEMENT	CON-01	PT-01	RB-05	PT-02
BATHROOM 1	TILE-01	PT-03, TILE-01	TILE-01	PT-03
BATHROOM 2	TILE-02	PT-03	TILE-02	PT-03
BATHROOM 3	TILE-01	PT-03, TILE-01	TILE-01	PT-03
BEDROOM 1	WF-01	PT-01	RB-01	PT-02
BEDROOM 2	WF-01	PT-01	RB-01	PT-02
BUILDING STORAGE	VCT-02	PT-01	RB-05	PT-02
CLOSET 1	WF-01	PT-01	RB-01	PT-02
CLOSET 2	WF-01	PT-01	RB-01	PT-02
CLOSET 3	WF-01	PT-01	RB-01	PT-02
COATS	WF-01	PT-01	RB-01	PT-02
COMMON CORRIDOR 1	CPT-01	PT-04, PT-06	RB-03	ACT-01
COMMON CORRIDOR 2	CPT-01	PT-04, PT-06	RB-03	ACT-01
COMMON CORRIDOR 3	CPT-01	PT-04, PT-06	RB-03	ACT-01
COMMON STAIR 1	CON-03	PT-07, PT-08, PT-09	RB-05	PT-07, PT-08, PT-09
COMMON STAIR 2	CON-03	PT-07, PT-08, PT-09	RB-05	PT-07, PT-08, PT-09
CORRIDOR	WF-01	PT-01	RB-01	PT-02
DECK	WD-02	WD-01		
DINING	WF-01	PT-01	RB-01	PT-02
ENTRY	WF-01	PT-01	RB-01	PT-02
IT 2	VCT-02	PT-06	RB-05	PT-02
IT 3	VCT-02	PT-06	RB-05	PT-02
JANITOR 2	VCT-02	PT-06	RB-05	PT-02
JANITOR 2 JANITOR 3	VCT-02	PT-06	RB-05	PT-02
KITCHEN	WF-01	PT-01, QTZ-01	RB-01	PT-02
LAUNDRY	TILE-03	PT-01, Q12-01	RB-02	PT-02
LIVING	WF-01	PT-01	RB-01	PT-02
		PT-06	RB-03	PT-02
LOBBY 1 LOBBY 2	CPT-02, TILE-04 CPT-01	PT-06	RB-03	PT-03
LOBBY 3	CPT-01	PT-06	RB-03	PT-02
MECH.	VCT-01	PT-01	RB-06	PT-02
N STOOP	CON-02	WD-01	 DD 04	WD-01
PANTRY	WF-01	PT-01	RB-01	PT-02
RESIDENT STORAGE	CPT-01	PT-01	RB-03	PT-02
RESIDENT STORAGE 2	CPT-01	PT-06	RB-03	PT-02
RESIDENT STORAGE 3	CPT-01	PT-06	RB-03	PT-02
SE STOOP	CON-02	WD-01	 DD 04	 DT 00
SLEEPING	WF-01	PT-01	RB-01	PT-02
STAIR	WF-01	PT-01	RB-01	PT-02
STORAGE	WF-01	PT-01	RB-01	PT-02
SW STOOP VESTIBULE	VCT-02	WD-01 PT-01	 RB-05	WD-01 PT-02



OWNER

BRUSH PARK DEVELOPMENT COMPANY
PHASE 1 LLC
1092 WOODWARD AVE.
DETROIT, MI 48226

ARCHITECT

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CODE CONSULTANT

CODE RED CONSULTANTS 154 TURNPIKE ROAD, SUITE 200 SOUTHBOROUGH MA, 01772

SOUTHBOROUGH MA, 01772

ark Duplette D-2 and Place Brush St. and John R. St.

Brush Park Duplette IOn Edmund Place
Between Brush St. and
Detroit MI, 48201

05/15/20: 100% CD / PERMIT SET

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JOB NO.: **18284**SCALE:


DATE: 05/15/2020

DRAWING TITLE

SHEET NO.

A-603

SCHEDULES

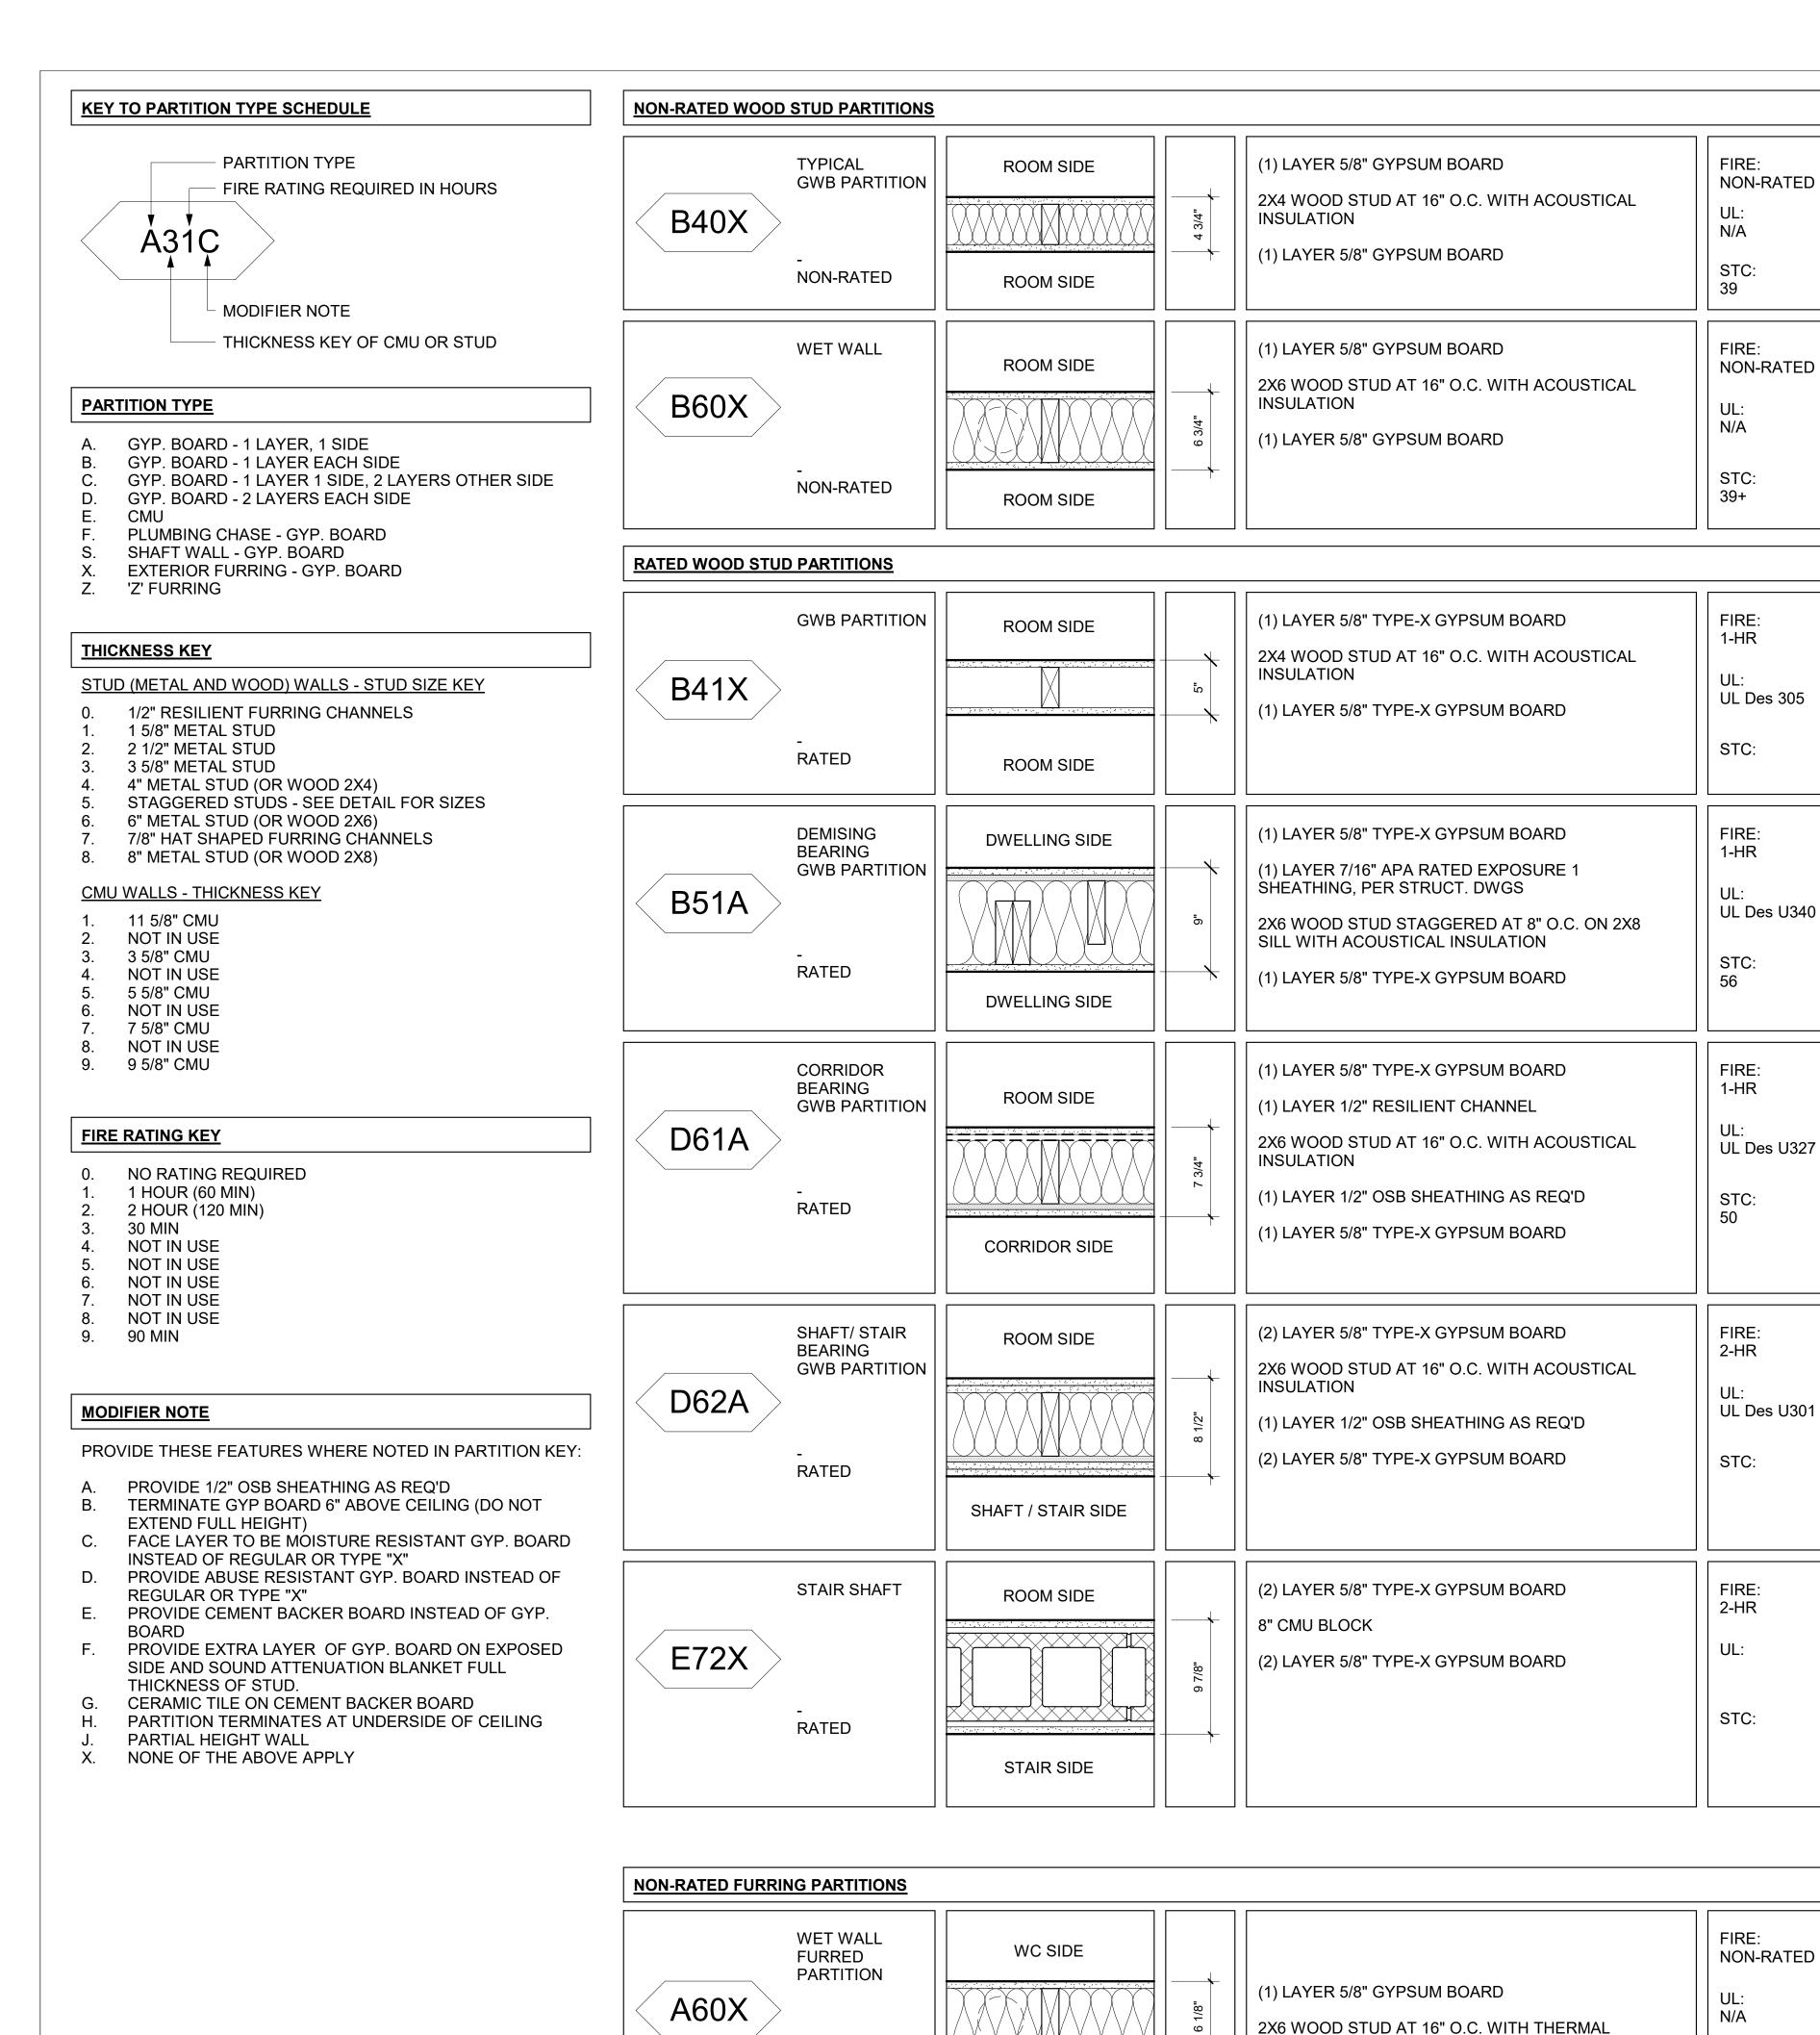

NON-RATED

CAVITY SIDE

INSULATION

STC:

STANDARDS: GYPSUM BOARD PARTITIONS (PROVIDE THESE FEATURES AT ALL GYPSUM BOARD & STUD (WOOD OR METAL) PARTITIONS) 1. SPACE STUDS AT 16" O.C., MAX, UNLESS NOTED PROVIDE BRACING AS REQUIRED IF STUD LENGHT EXCEEDS MAXIMUM HEIGHT SPECIFIED PROVIDE TYPE "X" GYP. BOARD AT ALL FIRE RATED GYP.

GYPSUM WALLBOARD SHOULD BE 5/8" THICK UNLESS NOTED OTHERWISE. STUDS AND ALL LAYERS OF GYP. BOARD ARE TO EXTEND TO UNDERSIDE OF FLOOR OR ROOF DECK ABOVE UNLESS NOTED OTHERWISE

PROVIDE CEMENTITIOUS BACKER BOARD IN LIEU OF GYPSUM WALL BOARD AT LOCATIONS TO RECEIVE TILE AS INDICATED IN FINISH SCHEDULE. PROVIDE MOLD & MOISTURE RESISTANT GYP. BOARD

BEHIND ALL CERAMIC TILE WAINSCOTIS AND FULL HEIGHT CERAMIC WALLS UNLESS NOTED OTHERWISE PROVIDE WATER RESISTANT GYPSUM WALL BOARD AT SURFACES IN BATHROOMS AND SIMILAR WET AREAS NOT INDICATED TO RECEIVE WALL TILE.

PROVIDE SAG RESISTANT GYP. BOARD AT ALL INTERIOR CEILING APPLICATIONS UNLESS NOTED OTHERWISE. PROVIDE "BLUEBOARD" GYPSUM WALL BOARD AT

PARTITIONS INDICATED TO RECEIVE VENEER PLASTER. 11. PROVIDE SOUND ATTENUATION BLANKETS FULL THICKNESS OF STUD UNLESS NOTED OTHERWISE

12. MAINTAIN INTEGRITY OF MORE STRINGENT PARTITION TYPE AT PARTITION INTERSECTIONS.

13. REFERENCE STRUCTURAL DRAWINGS FOR TYPE AND DETAILS ON STRUCTURAL OSB SHEATHING AT SHEAR WALL LOCATIONS. PREP OSB SHEATHING TO RECEIVING PERPENDICULAR PARTITION. INSTALL OSB SHEATHING AFTER INSTALLATION OF PLUMBING PIPING WITHIN PARTITION.

PROVIDE FIRESTOPS AND SMOKE SEALS AT ALL PENETRATIONS OF FIRE RATED PARTITIONS PER SPECIFICATIONS.

15. PROVIDE FIRE RESISTANT JOINT SYSTEM. PROVIDE ACOUSTICAL SEALANT AT ALL NON RATED PARTITIONS.

17. SEAL ALL PENETRATIONS THROUGH WALL AT CONDUIT, DUCTWORK, BEAMS, BRACING, ETC., WITH SOUND SEALANT AND SOUND BATT PER SPECIFICATIONS.

18. DEVICES SHALL NOT BE ALIGNED BACK TO BACK IN SAME

STUD LOCATION. EXTRA LAYER OF GYPSUM WALL BOARD AT ASYMMETRICAL PARTITIONS IS TO BE INSTALLED ON SIDE OF PARTITION WHICH TYPE KEY IS SHOWN.

BOARD AND METAL STUD PARTITIONS.

ELIZABETH LEE WHITTAKER ARCHITEOT No. 1301064129

OWNER BRUSH PARK DEVELOPMENT COMPANY

REGISTRATION

MERGE ARCHITECTS, INC. 332 CONGRESS ST. FLOOR 6

STRUCTURAL ENGINEER

ENGINEERED STRUCTURES, LLC.

MP/FP ENGINEER SELLINGER ASSOCIATES, INC.

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ETS ENGINEERING, INC. P.O. BOX 1166 ROYAL OAK, MI 48068 418-1/2 S. WASHINGTON AVE, ROYAL OAK, MI 48067

CODE RED CONSULTANTS 154 TURNPIKE ROAD, SUITE 200 SOUTHBOROUGH MA, 01772

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18284

1 1/2" = 1'-0" 05/15/2020

DRAWING TITLE

PARTITION TYPES

SHEET NO.







OWNER BRUSH PARK DEVELOPMENT COMPANY

ARCHITECT

STRUCTURAL ENGINEER ENGINEERED STRUCTURES, LLC.

632 BARRY STREET SW GRANDVILLE, MI 49418 T: 616-667-9650 **MP/FP ENGINEER**

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CODE CONSULTANT

CODE RED CONSULTANTS 154 TURNPIKE ROAD, SUITE 200 SOUTHBOROUGH MA, 01772

John and **Duplette** ld Place srush St. 48201 Park р On Edmunc Between Br Detroit MI, ⁴ **Brush** On Edr

05/15/20: 100% CD / PERMIT SET

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18284 JOB NO.: SCALE: 1/4" = 1'-0" 05/15/2020


DRAWING TITLE

UNIT TYPE A, B, B' INTERIOR ELEVATIONS

SHEET NO.

ADJACENT SURFACE, U.O.N.

A-700

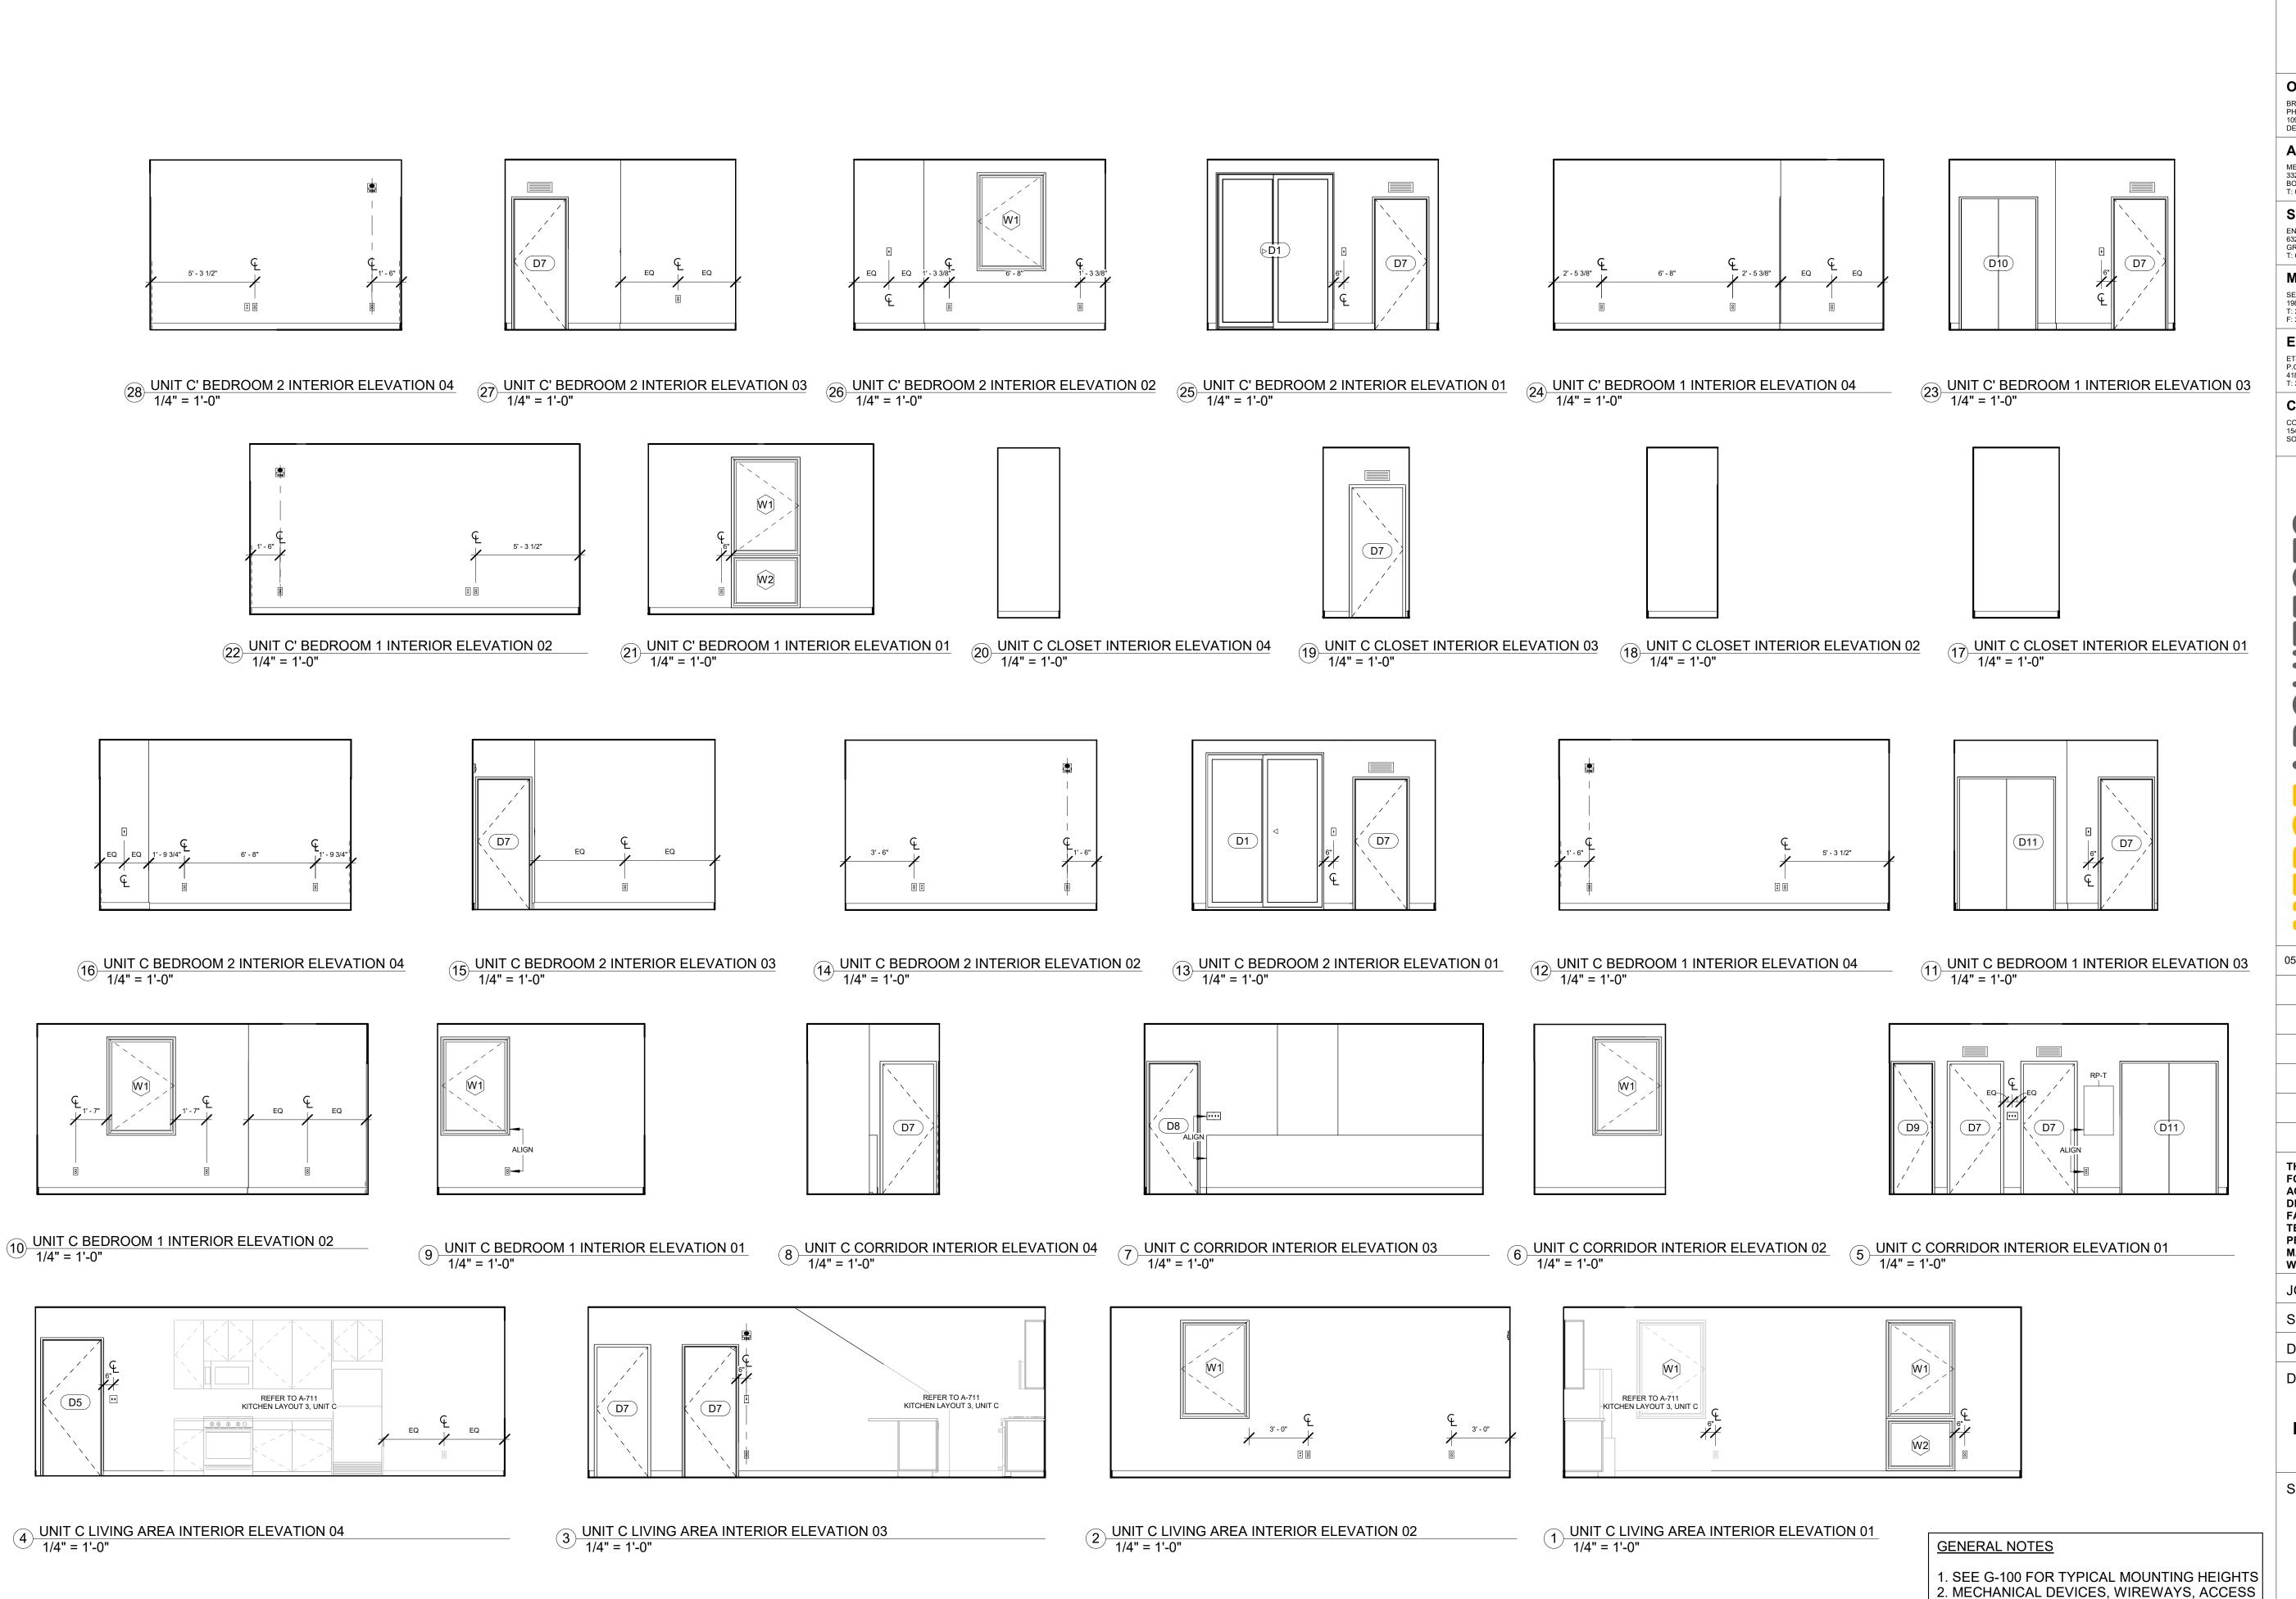



OWNER BRUSH PARK DEVELOPMENT COMPANY 1092 WOODWARD AVE. DETROIT, MI 48226

ARCHITECT MERGE ARCHITECTS, INC. 332 CONGRESS ST. FLOOR 6 BOSTON, MA 02210 T: 617.670.0265

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DATE: 05/15/2020 DRAWING TITLE


UNIT TYPE C, C' INTERIOR ELEVATIONS

SHEET NO.

PANELS, ETC. TO BE FINISHED TO MATCH

ADJACENT SURFACE, U.O.N.

A-701

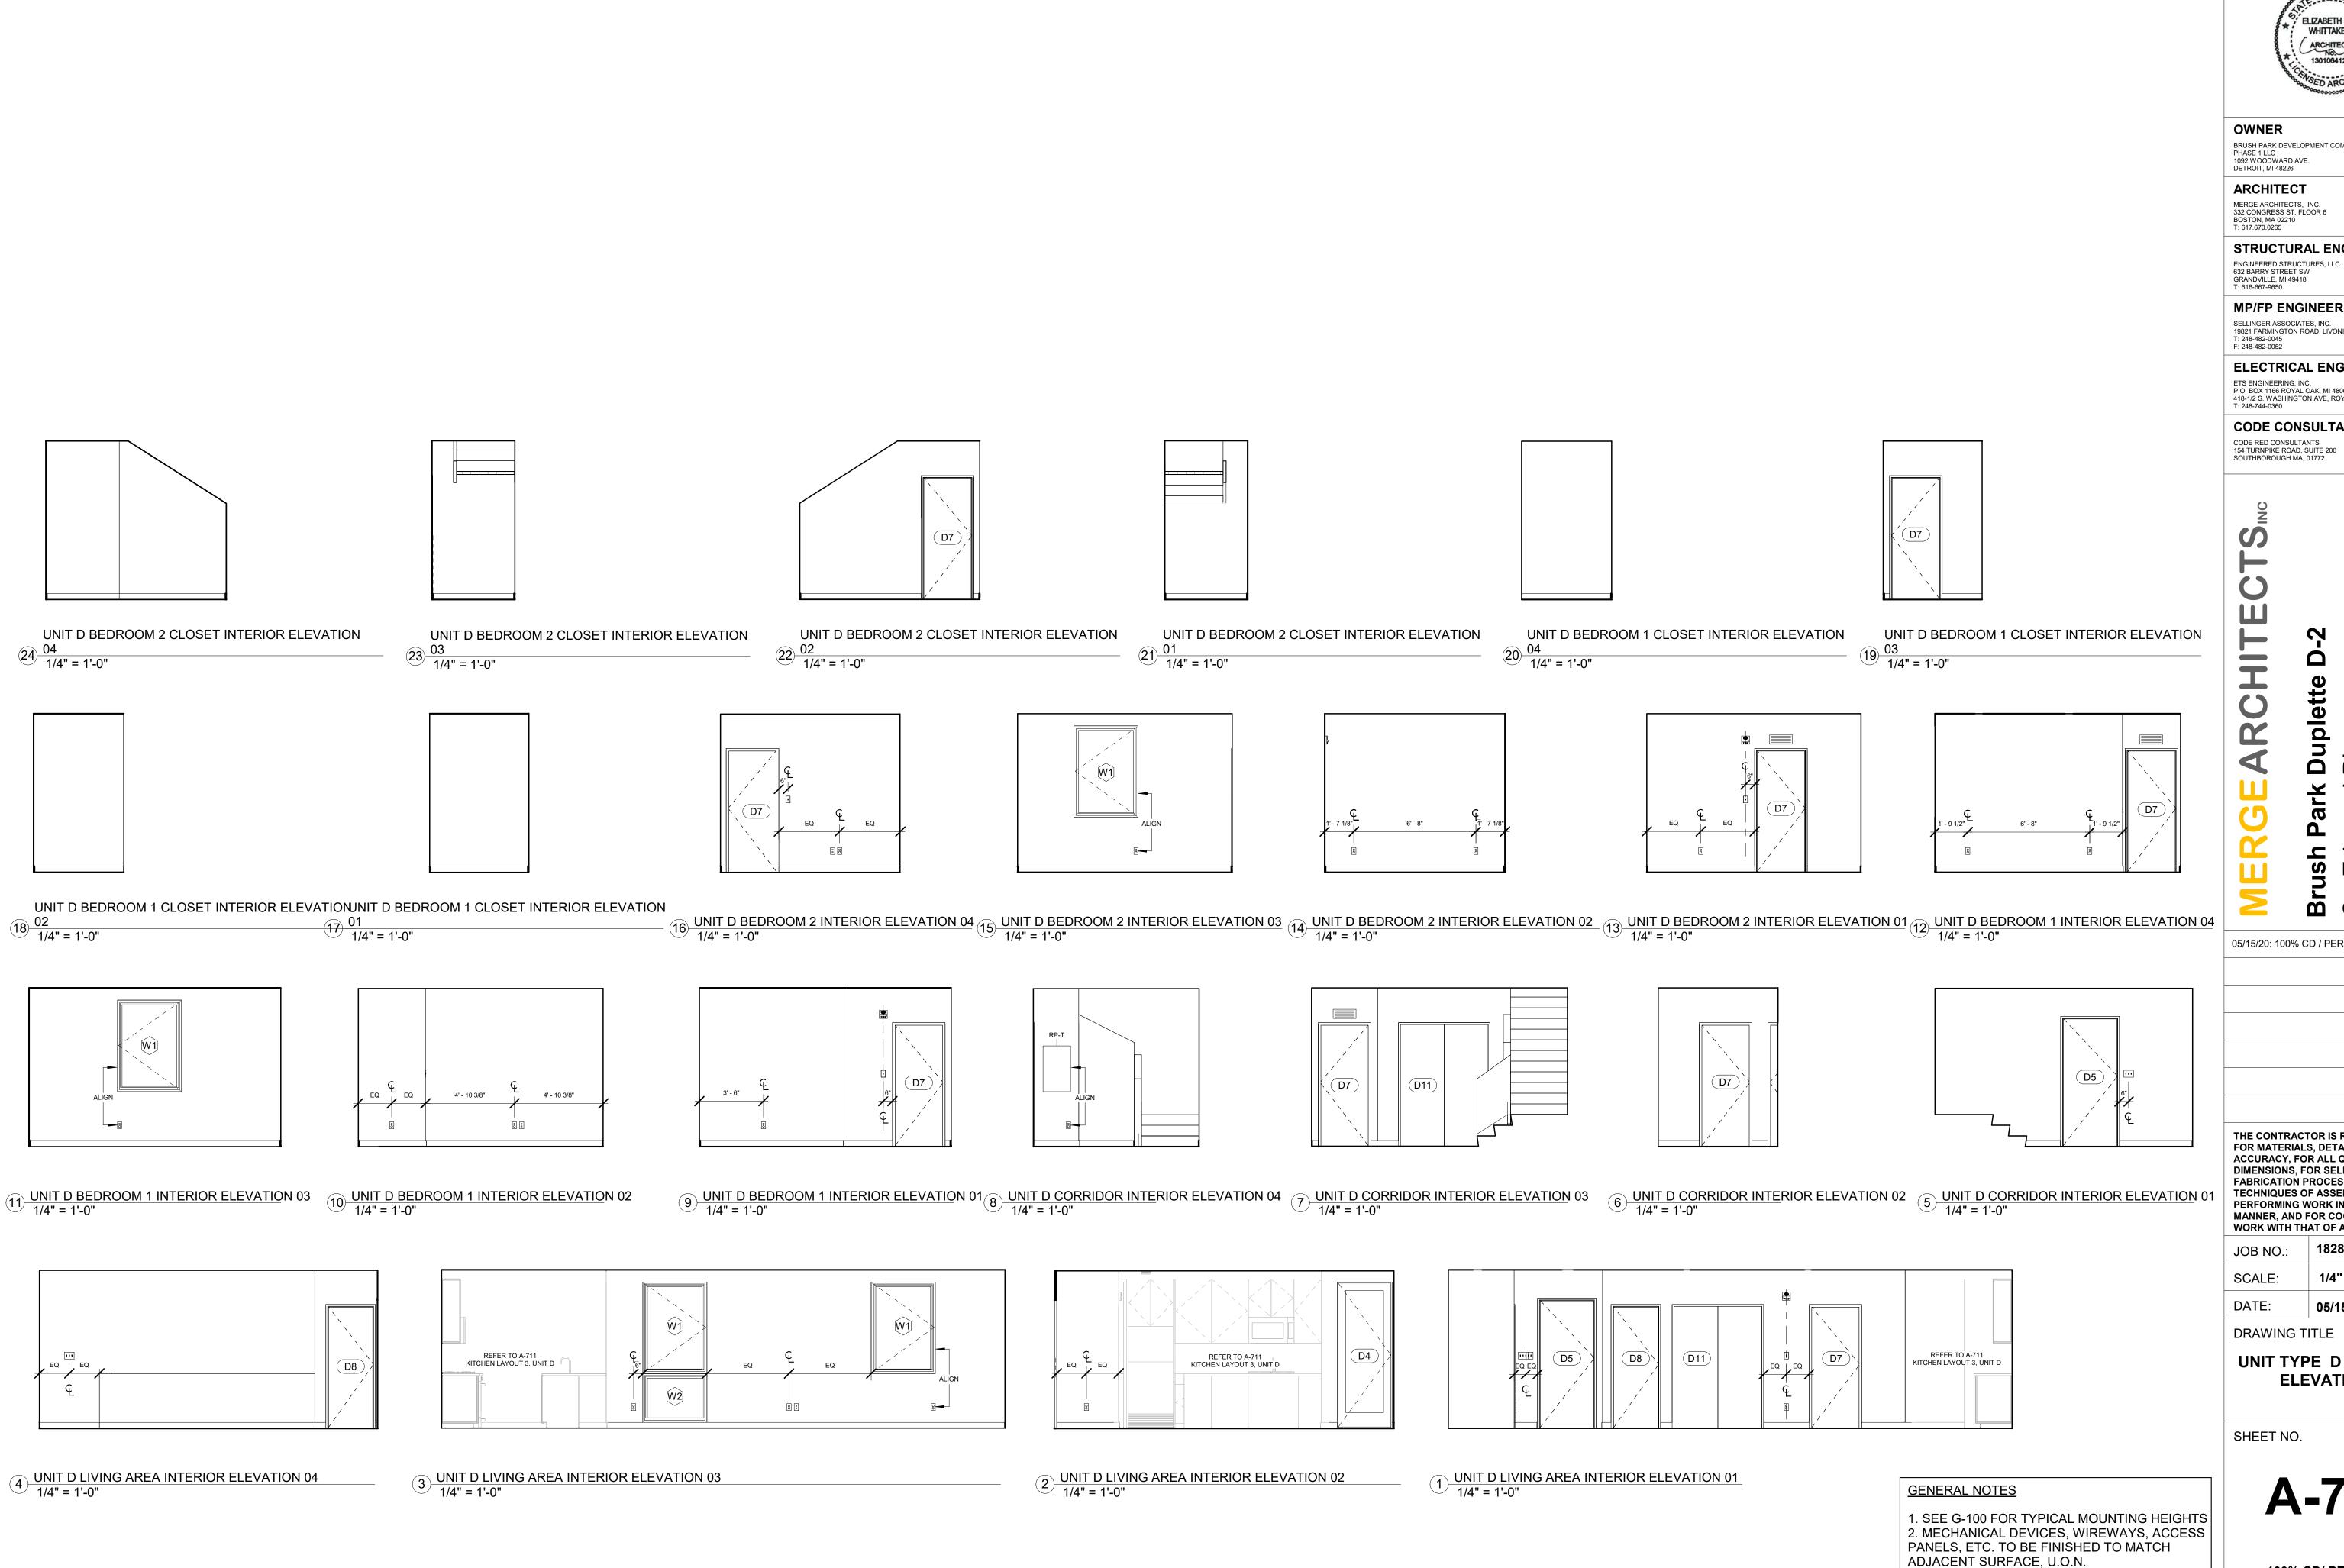



OWNER BRUSH PARK DEVELOPMENT COMPANY

ARCHITECT

MERGE ARCHITECTS, INC. 332 CONGRESS ST. FLOOR 6 BOSTON, MA 02210 T: 617.670.0265 STRUCTURAL ENGINEER

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ohn pu **Duplette** $\boldsymbol{\omega}$ St St Pla(p On Edmund Between Br Detroit MI, ² Par

05/15/20: 100% CD / PERMIT SET

THE CONTRACTOR IS RESPONSIBLE FOR MATERIALS, DETAILS AND ACCURACY, FOR ALL QUANTITIES AND DIMENSIONS, FOR SELECTING FABRICATION PROCESSES, FOR TECHNIQUES OF ASSEMBLY, FOR PERFORMING WORK IN A SAFE MANNER, AND FOR COORDINATING WORK WITH THAT OF ALL TRADES


18284 JOB NO.: SCALE: 1/4" = 1'-0" 05/15/2020

DRAWING TITLE

UNIT TYPE D INTERIOR ELEVATIONS

SHEET NO.

A-702

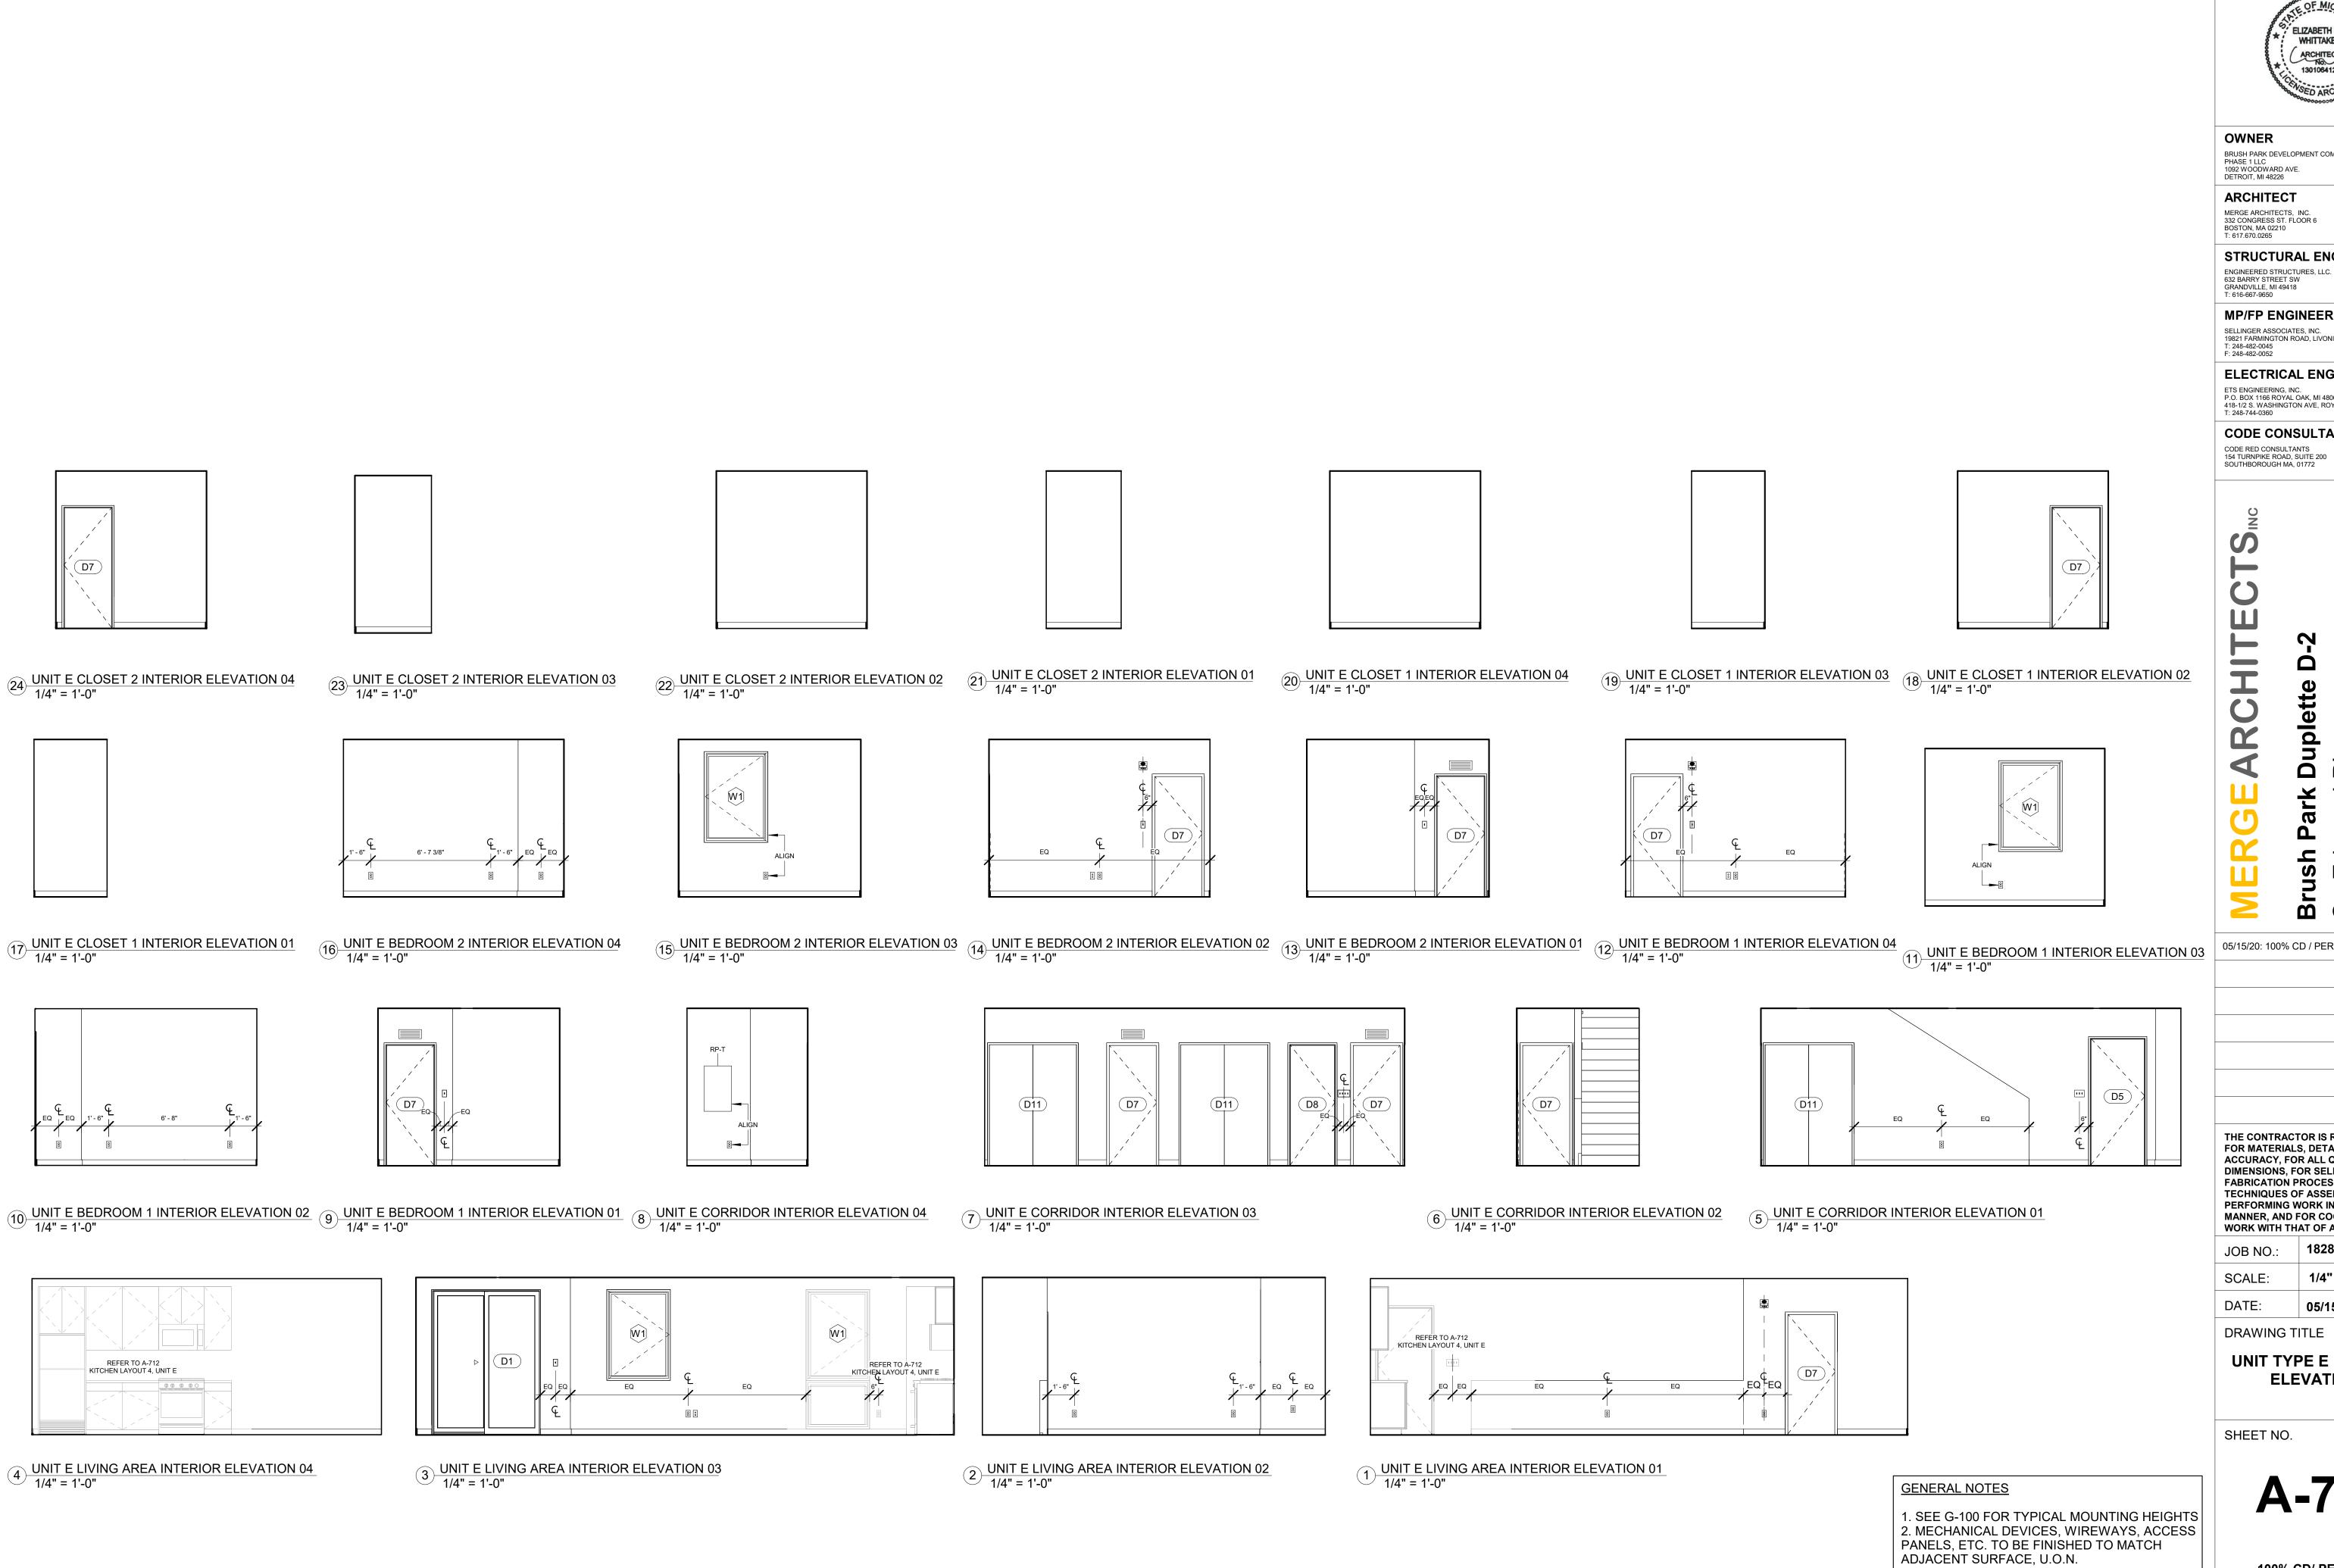



OWNER BRUSH PARK DEVELOPMENT COMPANY

ARCHITECT

STRUCTURAL ENGINEER

MP/FP ENGINEER

SELLINGER ASSOCIATES, INC. 19821 FARMINGTON ROAD, LIVONIA, MI 48152 T: 248-482-0045 F: 248-482-0052

ELECTRICAL ENGINEER ETS ENGINEERING, INC.

P.O. BOX 1166 ROYAL OAK, MI 48068 418-1/2 S. WASHINGTON AVE, ROYAL OAK, MI 48067

CODE CONSULTANT

CODE RED CONSULTANTS 154 TURNPIKE ROAD, SUITE 200 SOUTHBOROUGH MA, 01772

Duplette

and St St rush \$4820 Pla(р **Brush Park**On Edmunc
Between Br
Detroit MI, 4

ohn

05/15/20: 100% CD / PERMIT SET

THE CONTRACTOR IS RESPONSIBLE FOR MATERIALS, DETAILS AND ACCURACY, FOR ALL QUANTITIES AND DIMENSIONS, FOR SELECTING FABRICATION PROCESSES, FOR TECHNIQUES OF ASSEMBLY, FOR PERFORMING WORK IN A SAFE MANNER, AND FOR COORDINATING WORK WITH THAT OF ALL TRADES


18284 JOB NO.: SCALE: 1/4" = 1'-0" 05/15/2020

DRAWING TITLE

UNIT TYPE E INTERIOR **ELEVATIONS**

SHEET NO.

A-703

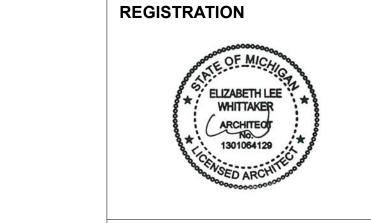

OWNER BRUSH PARK DEVELOPMENT COMPANY PHASE 1 LLC 1092 WOODWARD AVE. DETROIT, MI 48226

ARCHITECT MERGE ARCHITECTS, INC. 332 CONGRESS ST. FLOOR 6 BOSTON, MA 02210 T: 617.670.0265

ENGINEERED STRUCTURES, LLC.

STRUCTURAL ENGINEER

632 BARRY STREET SW GRANDVILLE, MI 49418 T: 616-667-9650 **MP/FP ENGINEER**

SELLINGER ASSOCIATES, INC. 19821 FARMINGTON ROAD, LIVONIA, MI 48152 T: 248-482-0045 F: 248-482-0052

ELECTRICAL ENGINEER ETS ENGINEERING, INC. P.O. BOX 1166 ROYAL OAK, MI 48068 418-1/2 S. WASHINGTON AVE, ROYAL OAK, MI 48067

CODE CONSULTANT


CODE RED CONSULTANTS 154 TURNPIKE ROAD, SUITE 200 SOUTHBOROUGH MA, 01772

ohn and Duplette On Edmunc Between Br Detroit MI, ⁴ Par


Brush On Edn


05/15/20: 100% CD / PERMIT SET


UNIT F CLOSET INTERIOR ELEVATION 02 1/4" = 1'-0" UNIT F CLOSET INTERIOR ELEVATION 01 1/4" = 1'-0" UNIT F BEDROOM 2 INTERIOR ELEVATION 03 1/4" = 1'-0" UNIT F BEDROOM 2 INTERIOR ELEVATION 03 1/4" = 1'-0" UNIT F BEDROOM 2 INTERIOR ELEVATION 04 1/4" = 1'-0" UNIT F BEDROOM 2 INTERIOR ELEVATION 04 1/4" = 1'-0" UNIT F BEDROOM 2 INTERIOR ELEVATION 04 1/4" = 1'-0" UNIT F BEDROOM 2 INTERIOR ELEVATION 05 1/4" = 1'-0" UNIT F BEDROOM 2 INTERI

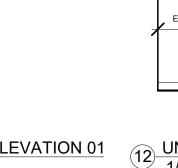


D7

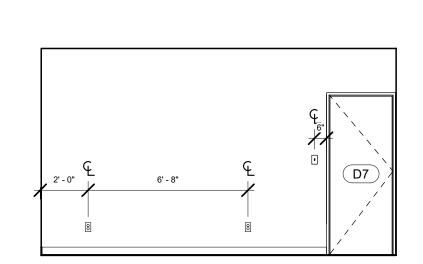


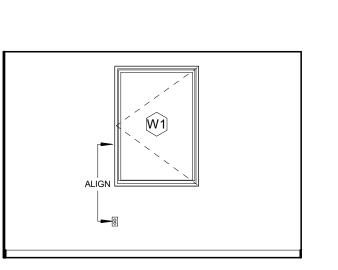


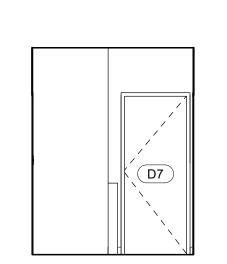

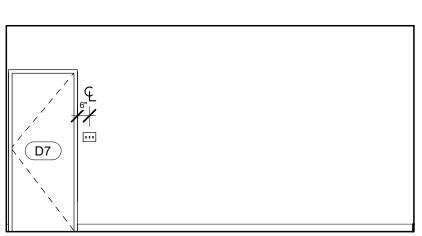

3' - 6"

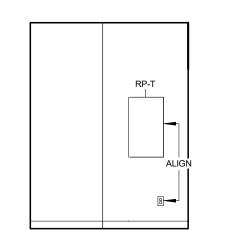

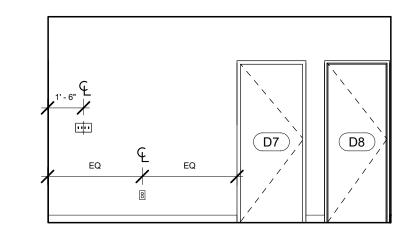

UNIT F BEDROOM 1 INTERIOR ELEVATION 03

10 UNIT F BEDROOM 1 INTERIOR ELEVATION 02


1/4" = 1'-0"


UNIT F BEDROOM 1 INTERIOR ELEVATION 02

1/4" = 1'-0"


UNIT F BEDROOM 1 INTERIOR ELEVATION 01

1/4" = 1'-0" 8 UNIT F CORRIDOR INTERIOR ELEVATION 04 1/4" = 1'-0" 7 UNIT F CORRIDOR INTERIOR ELEVATION 03
1/4" = 1'-0" 6 UNIT F CORRIDOR INTERIOR ELEVATION 02 5 UNIT F CORRIDOR INTERIOR ELEVATION 01 1/4" = 1'-0"

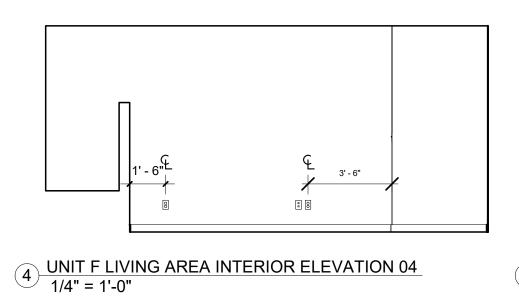

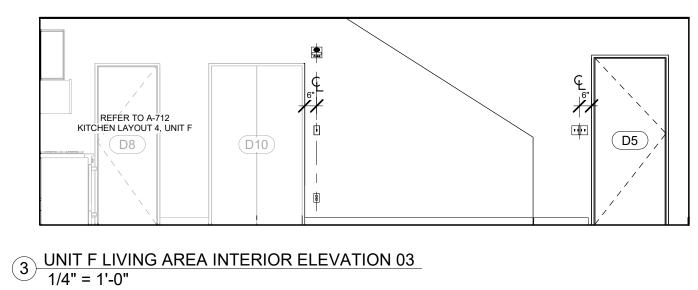



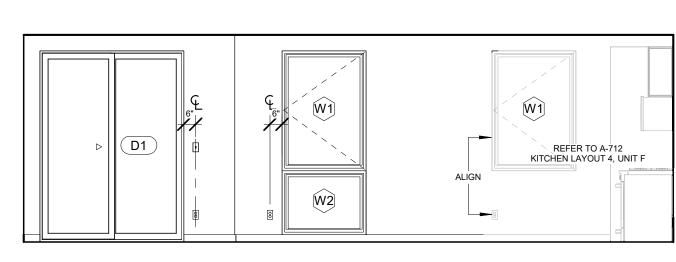

1) UNIT F LIVING AREA INTERIOR ELEVATION 01 1/4" = 1'-0"

GENERAL NOTES

1. SEE G-100 FOR TYPICAL MOUNTING HEIGHTS 2. MECHANICAL DEVICES, WIREWAYS, ACCESS PANELS, ETC. TO BE FINISHED TO MATCH ADJACENT SURFACE, U.O.N.

THE CONTRACTOR IS RESPONSIBLE FOR MATERIALS, DETAILS AND ACCURACY, FOR ALL QUANTITIES AND DIMENSIONS, FOR SELECTING FABRICATION PROCESSES, FOR TECHNIQUES OF ASSEMBLY, FOR PERFORMING WORK IN A SAFE MANNER, AND FOR COORDINATING WORK WITH THAT OF ALL TRADES


18284 JOB NO.: SCALE: 1/4" = 1'-0" DATE: 05/15/2020

DRAWING TITLE

UNIT TYPE F INTERIOR ELEVATIONS

SHEET NO.

A-704

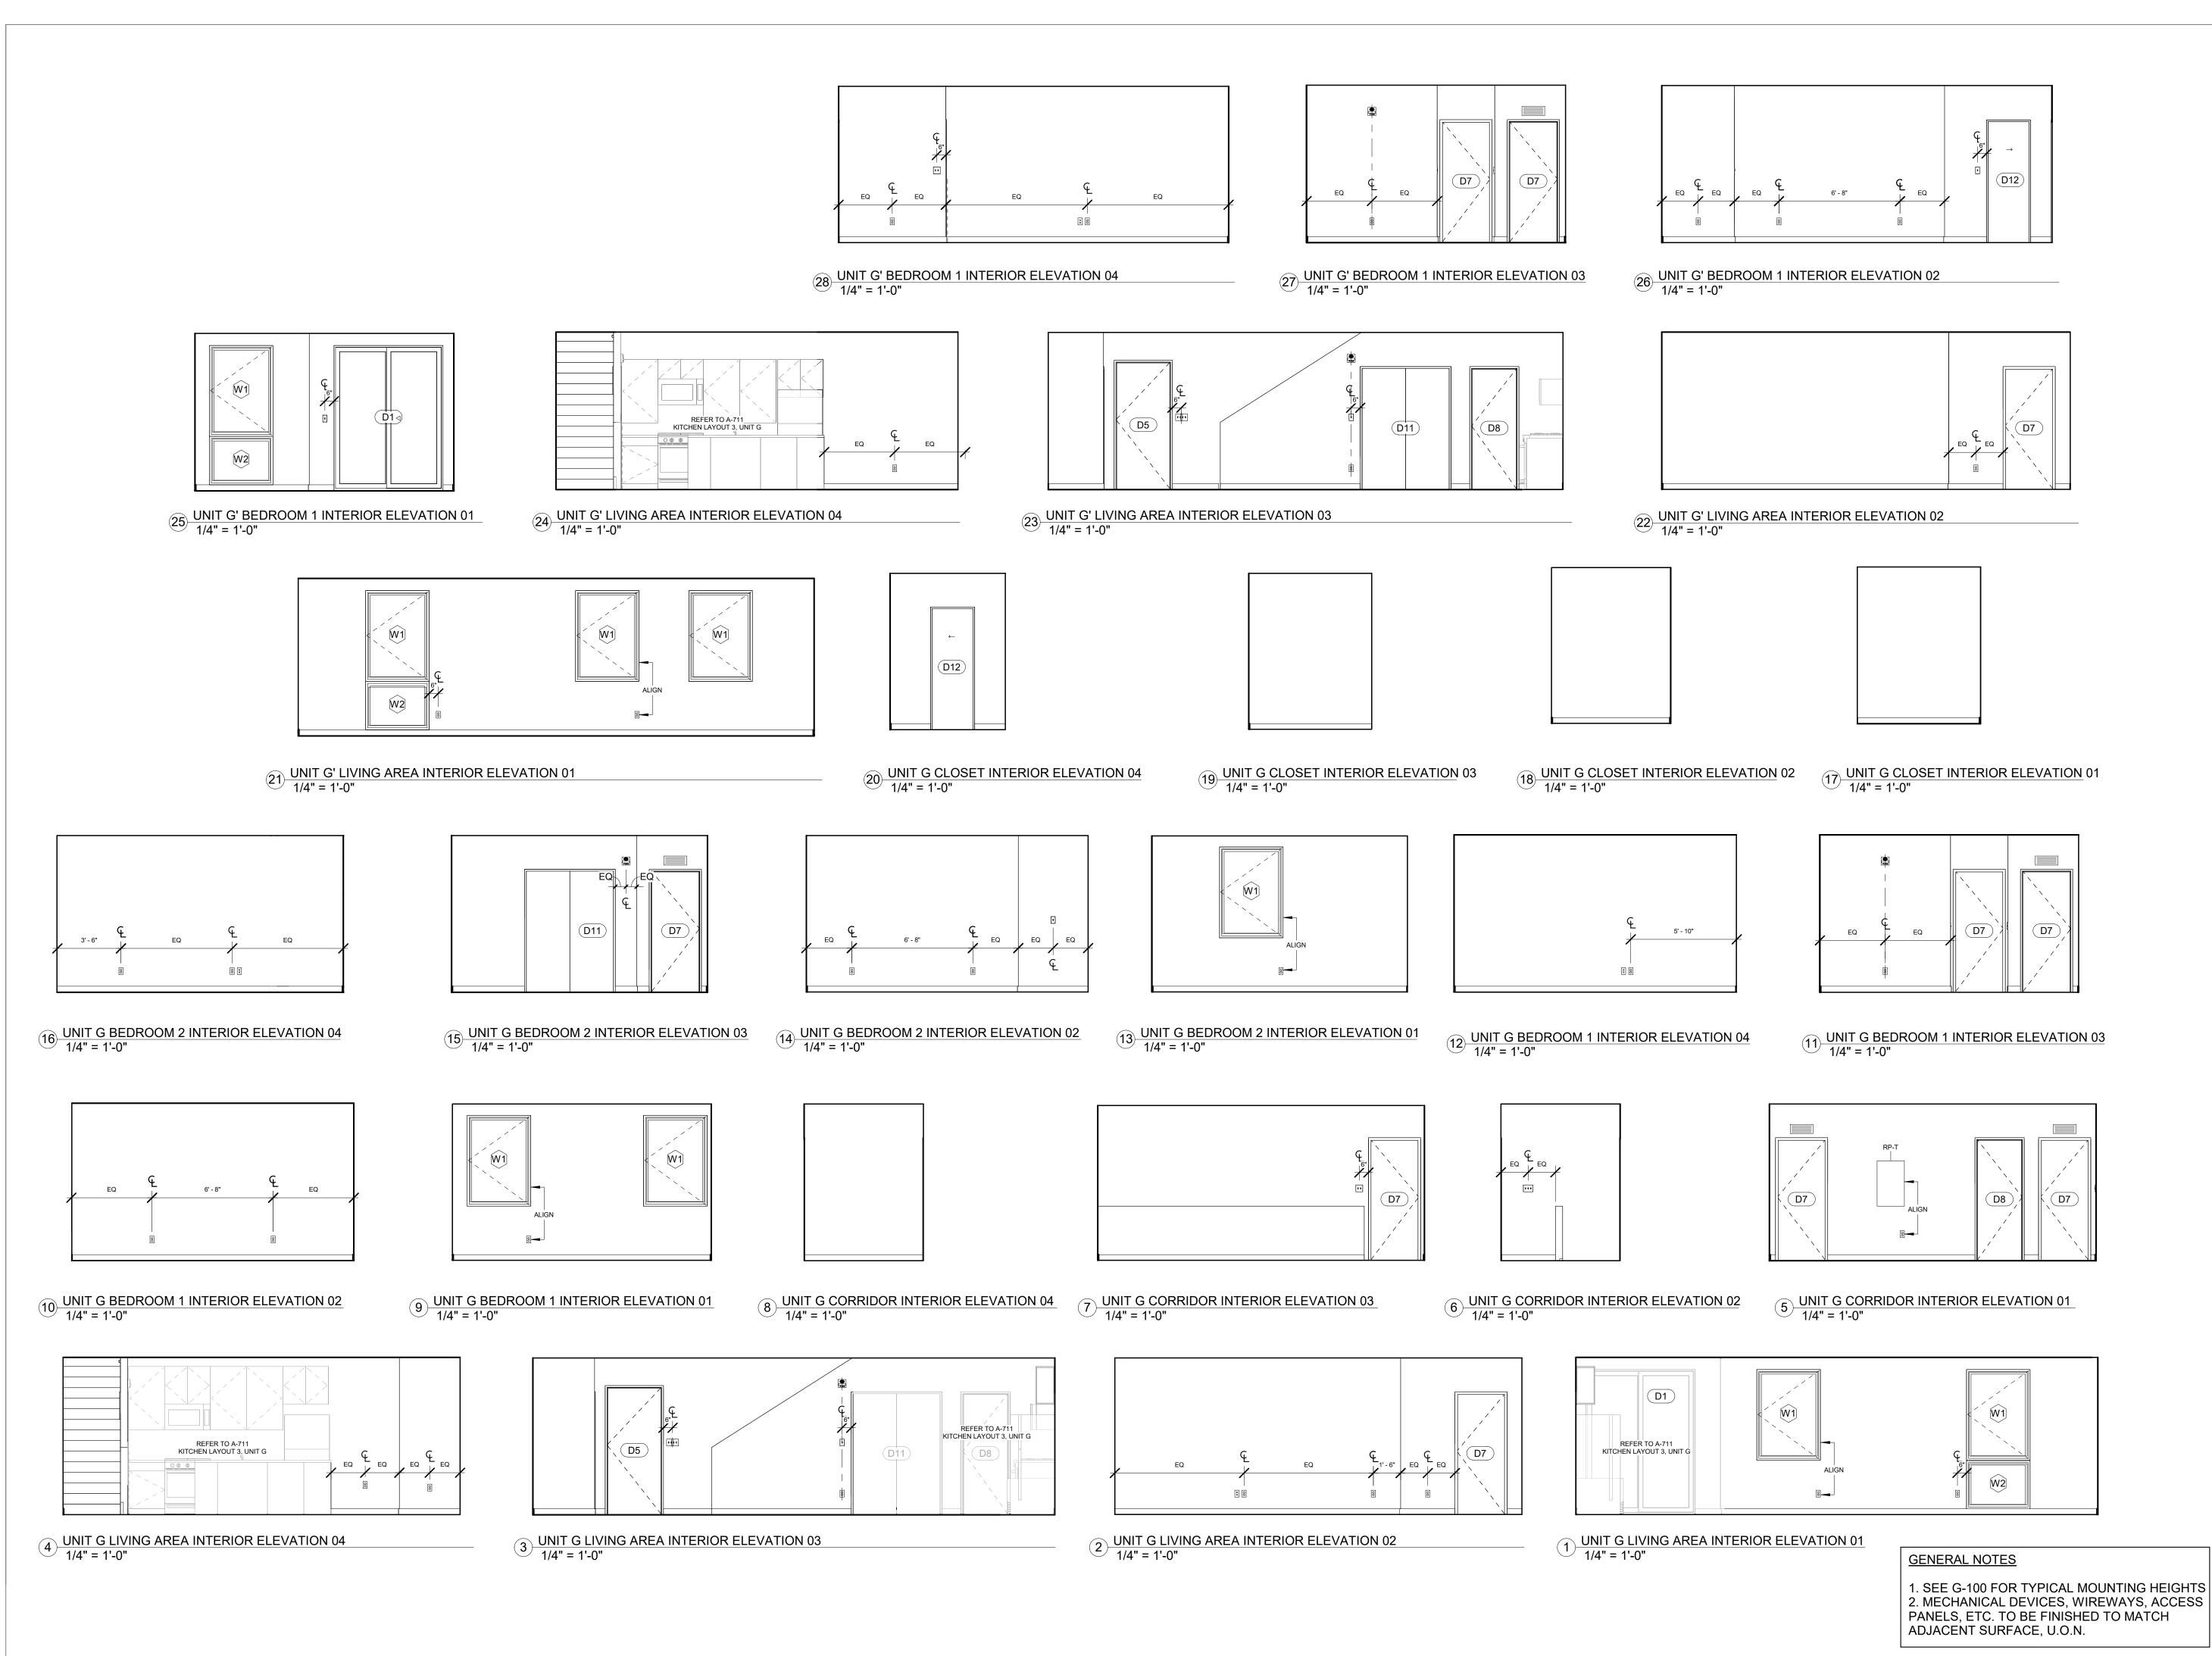



OWNER BRUSH PARK DEVELOPMENT COMPANY PHASE 1 LLC

ARCHITECT MERGE ARCHITECTS, INC. 332 CONGRESS ST. FLOOR 6 BOSTON, MA 02210 T: 617.670.0265

1092 WOODWARD AVE. DETROIT, MI 48226

STRUCTURAL ENGINEER ENGINEERED STRUCTURES, LLC.

632 BARRY STREET SW GRANDVILLE, MI 49418 T: 616-667-9650 **MP/FP ENGINEER** SELLINGER ASSOCIATES, INC.

19821 FARMINGTON ROAD, LIVONIA, MI 48152 T: 248-482-0045 F: 248-482-0052

ELECTRICAL ENGINEER ETS ENGINEERING, INC. P.O. BOX 1166 ROYAL OAK, MI 48068 418-1/2 S. WASHINGTON AVE, ROYAL OAK, MI 48067

CODE CONSULTANT

CODE RED CONSULTANTS 154 TURNPIKE ROAD, SUITE 200 SOUTHBOROUGH MA, 01772

ohn and **Duplette** St. rush \$4820 Pla(р On Edmund Between Br Detroit MI, ² Par **Brush** On Edr

05/15/20: 100% CD / PERMIT SET

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18284 JOB NO.: SCALE: 1/4" = 1'-0"


DATE: 05/15/2020

DRAWING TITLE

UNIT TYPE G, G' INTERIOR ELEVATIONS

SHEET NO.

A-705

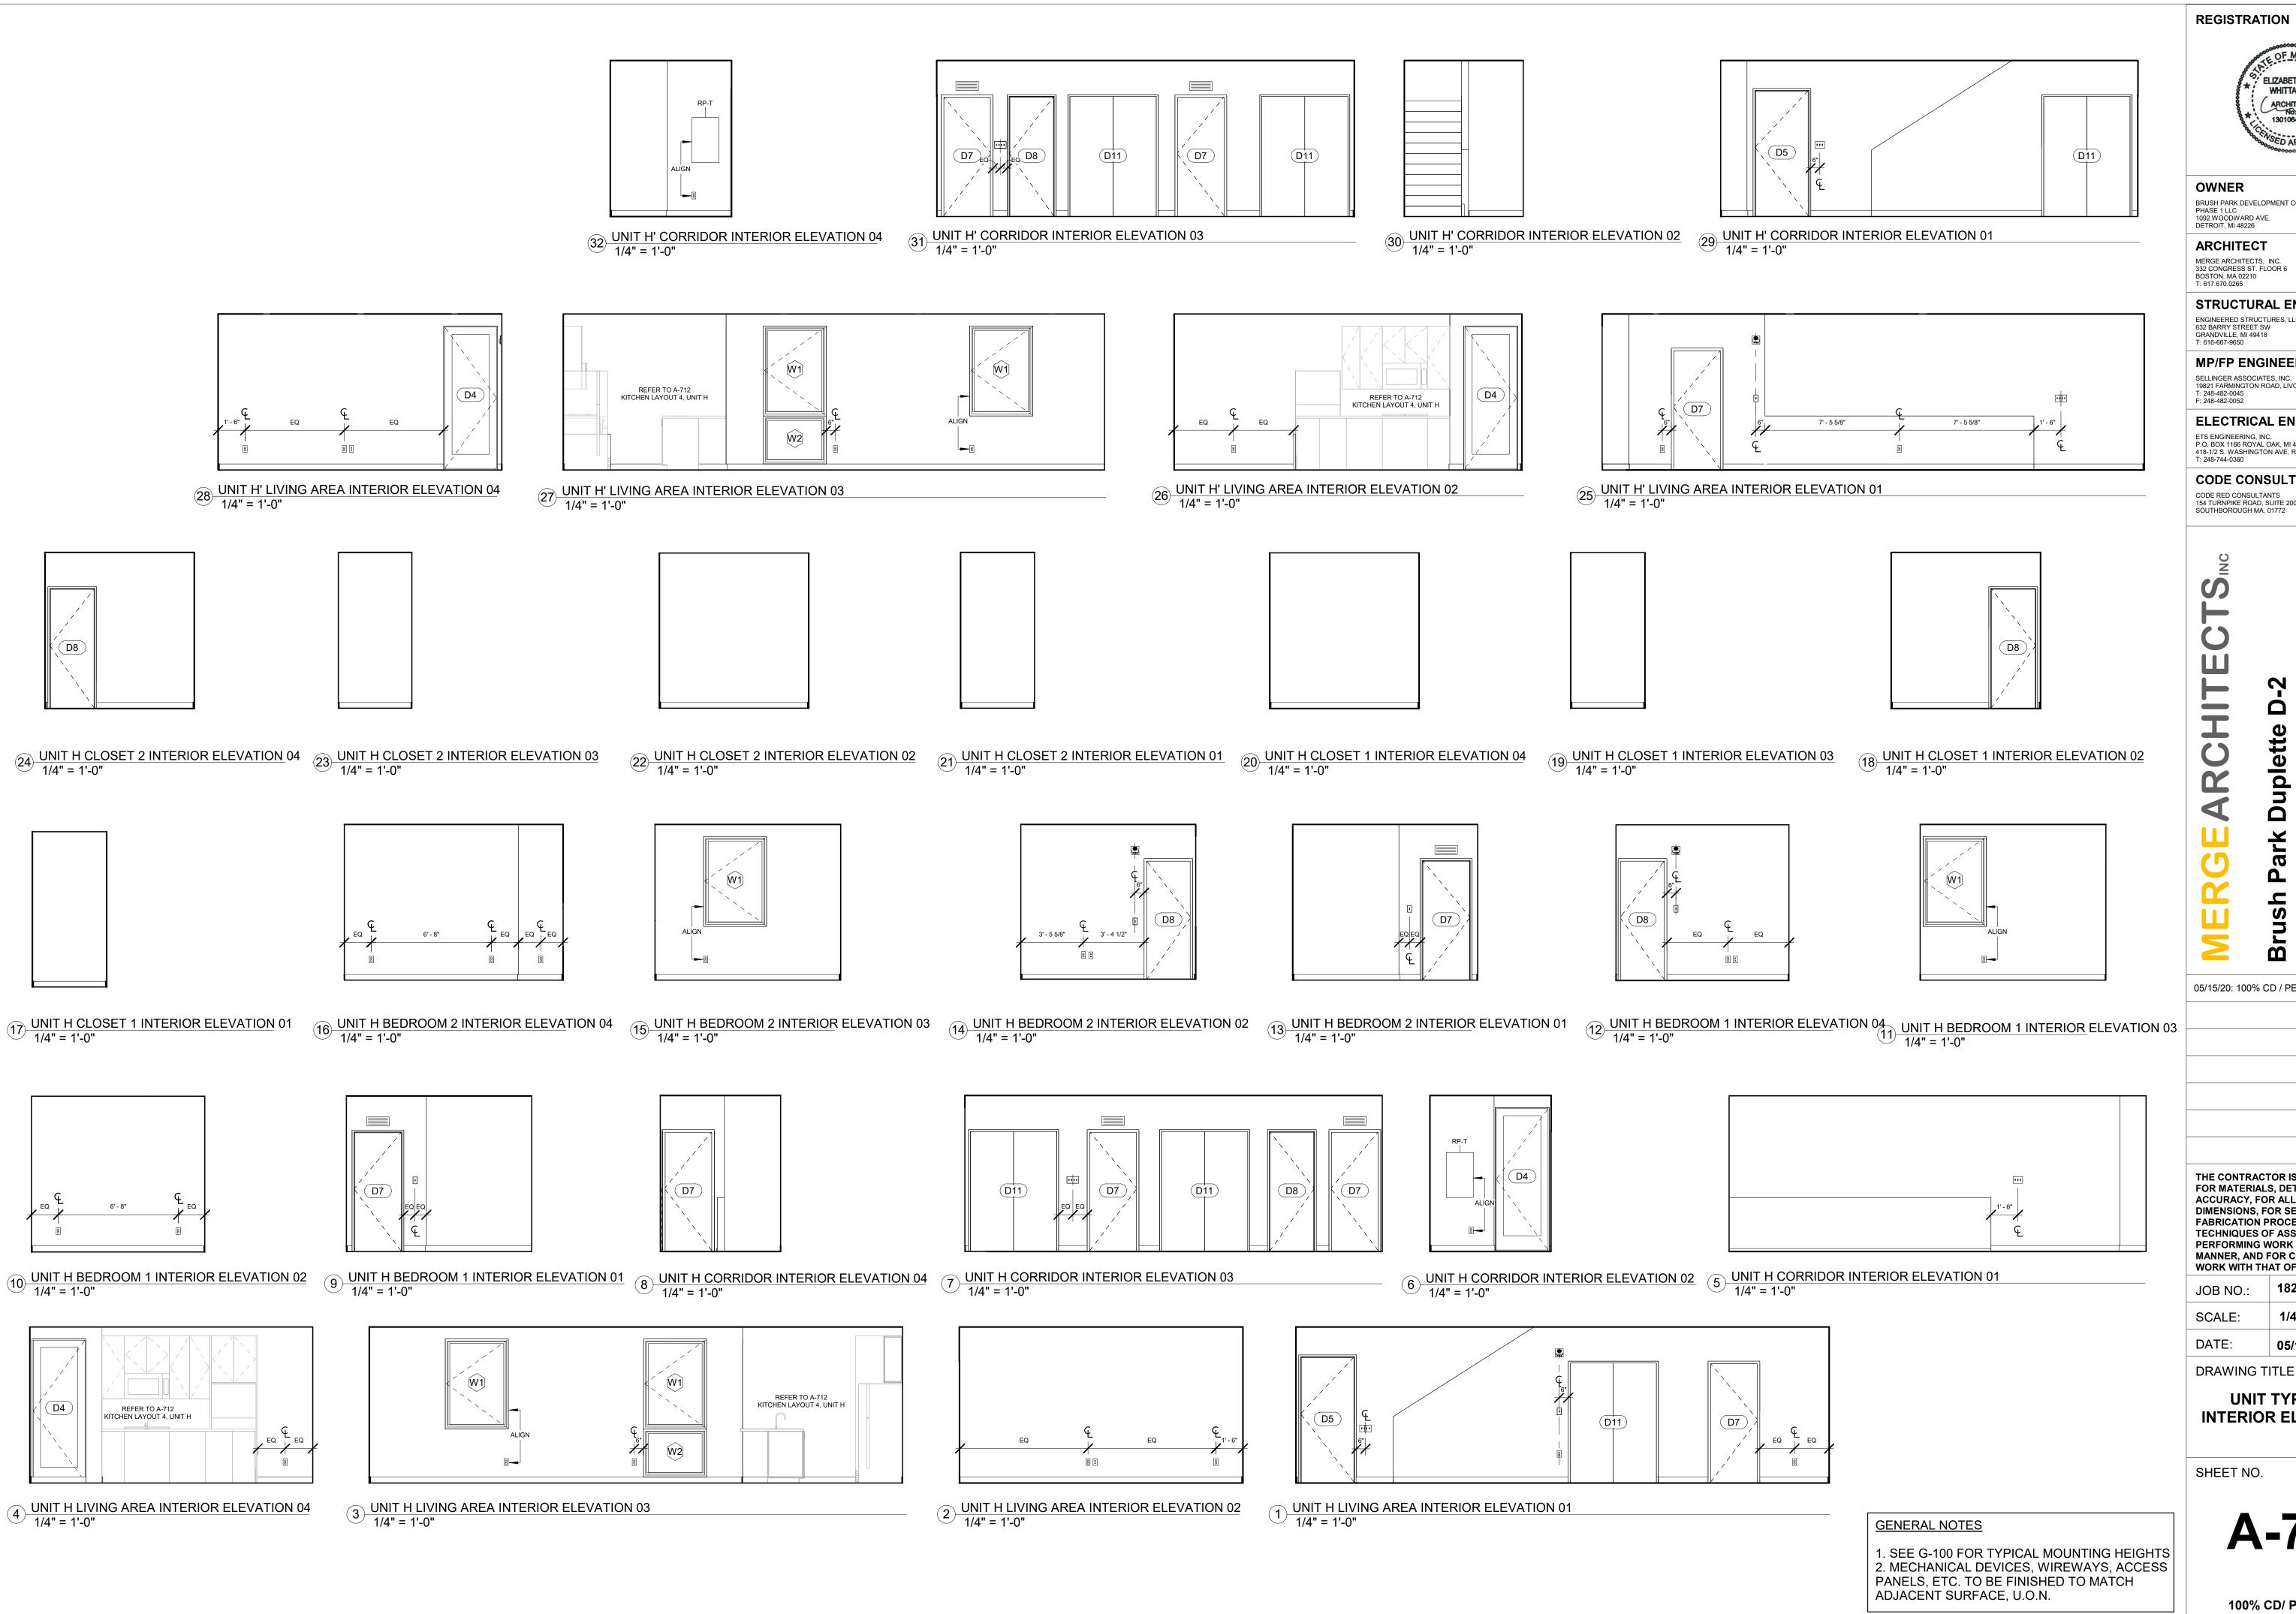



OWNER BRUSH PARK DEVELOPMENT COMPANY 1092 WOODWARD AVE.

ARCHITECT MERGE ARCHITECTS, INC. 332 CONGRESS ST. FLOOR 6

STRUCTURAL ENGINEER ENGINEERED STRUCTURES, LLC.

632 BARRY STREET SW GRANDVILLE, MI 49418 T: 616-667-9650 **MP/FP ENGINEER**

SELLINGER ASSOCIATES, INC. 19821 FARMINGTON ROAD, LIVONIA, MI 48152 T: 248-482-0045

ELECTRICAL ENGINEER P.O. BOX 1166 ROYAL OAK, MI 48068 418-1/2 S. WASHINGTON AVE, ROYAL OAK, MI 48067

CODE CONSULTANT

CODE RED CONSULTANTS 154 TURNPIKE ROAD, SUITE 200 SOUTHBOROUGH MA, 01772

ohn

and **Duplette** S C Pla 0 On Edmund Between Br Detroit MI, ² Par

05/15/20: 100% CD / PERMIT SET

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18284 JOB NO.: SCALE: 1/4" = 1'-0"


05/15/2020

DRAWING TITLE

UNIT TYPE H, H' **INTERIOR ELEVATIONS**

SHEET NO.

A-706

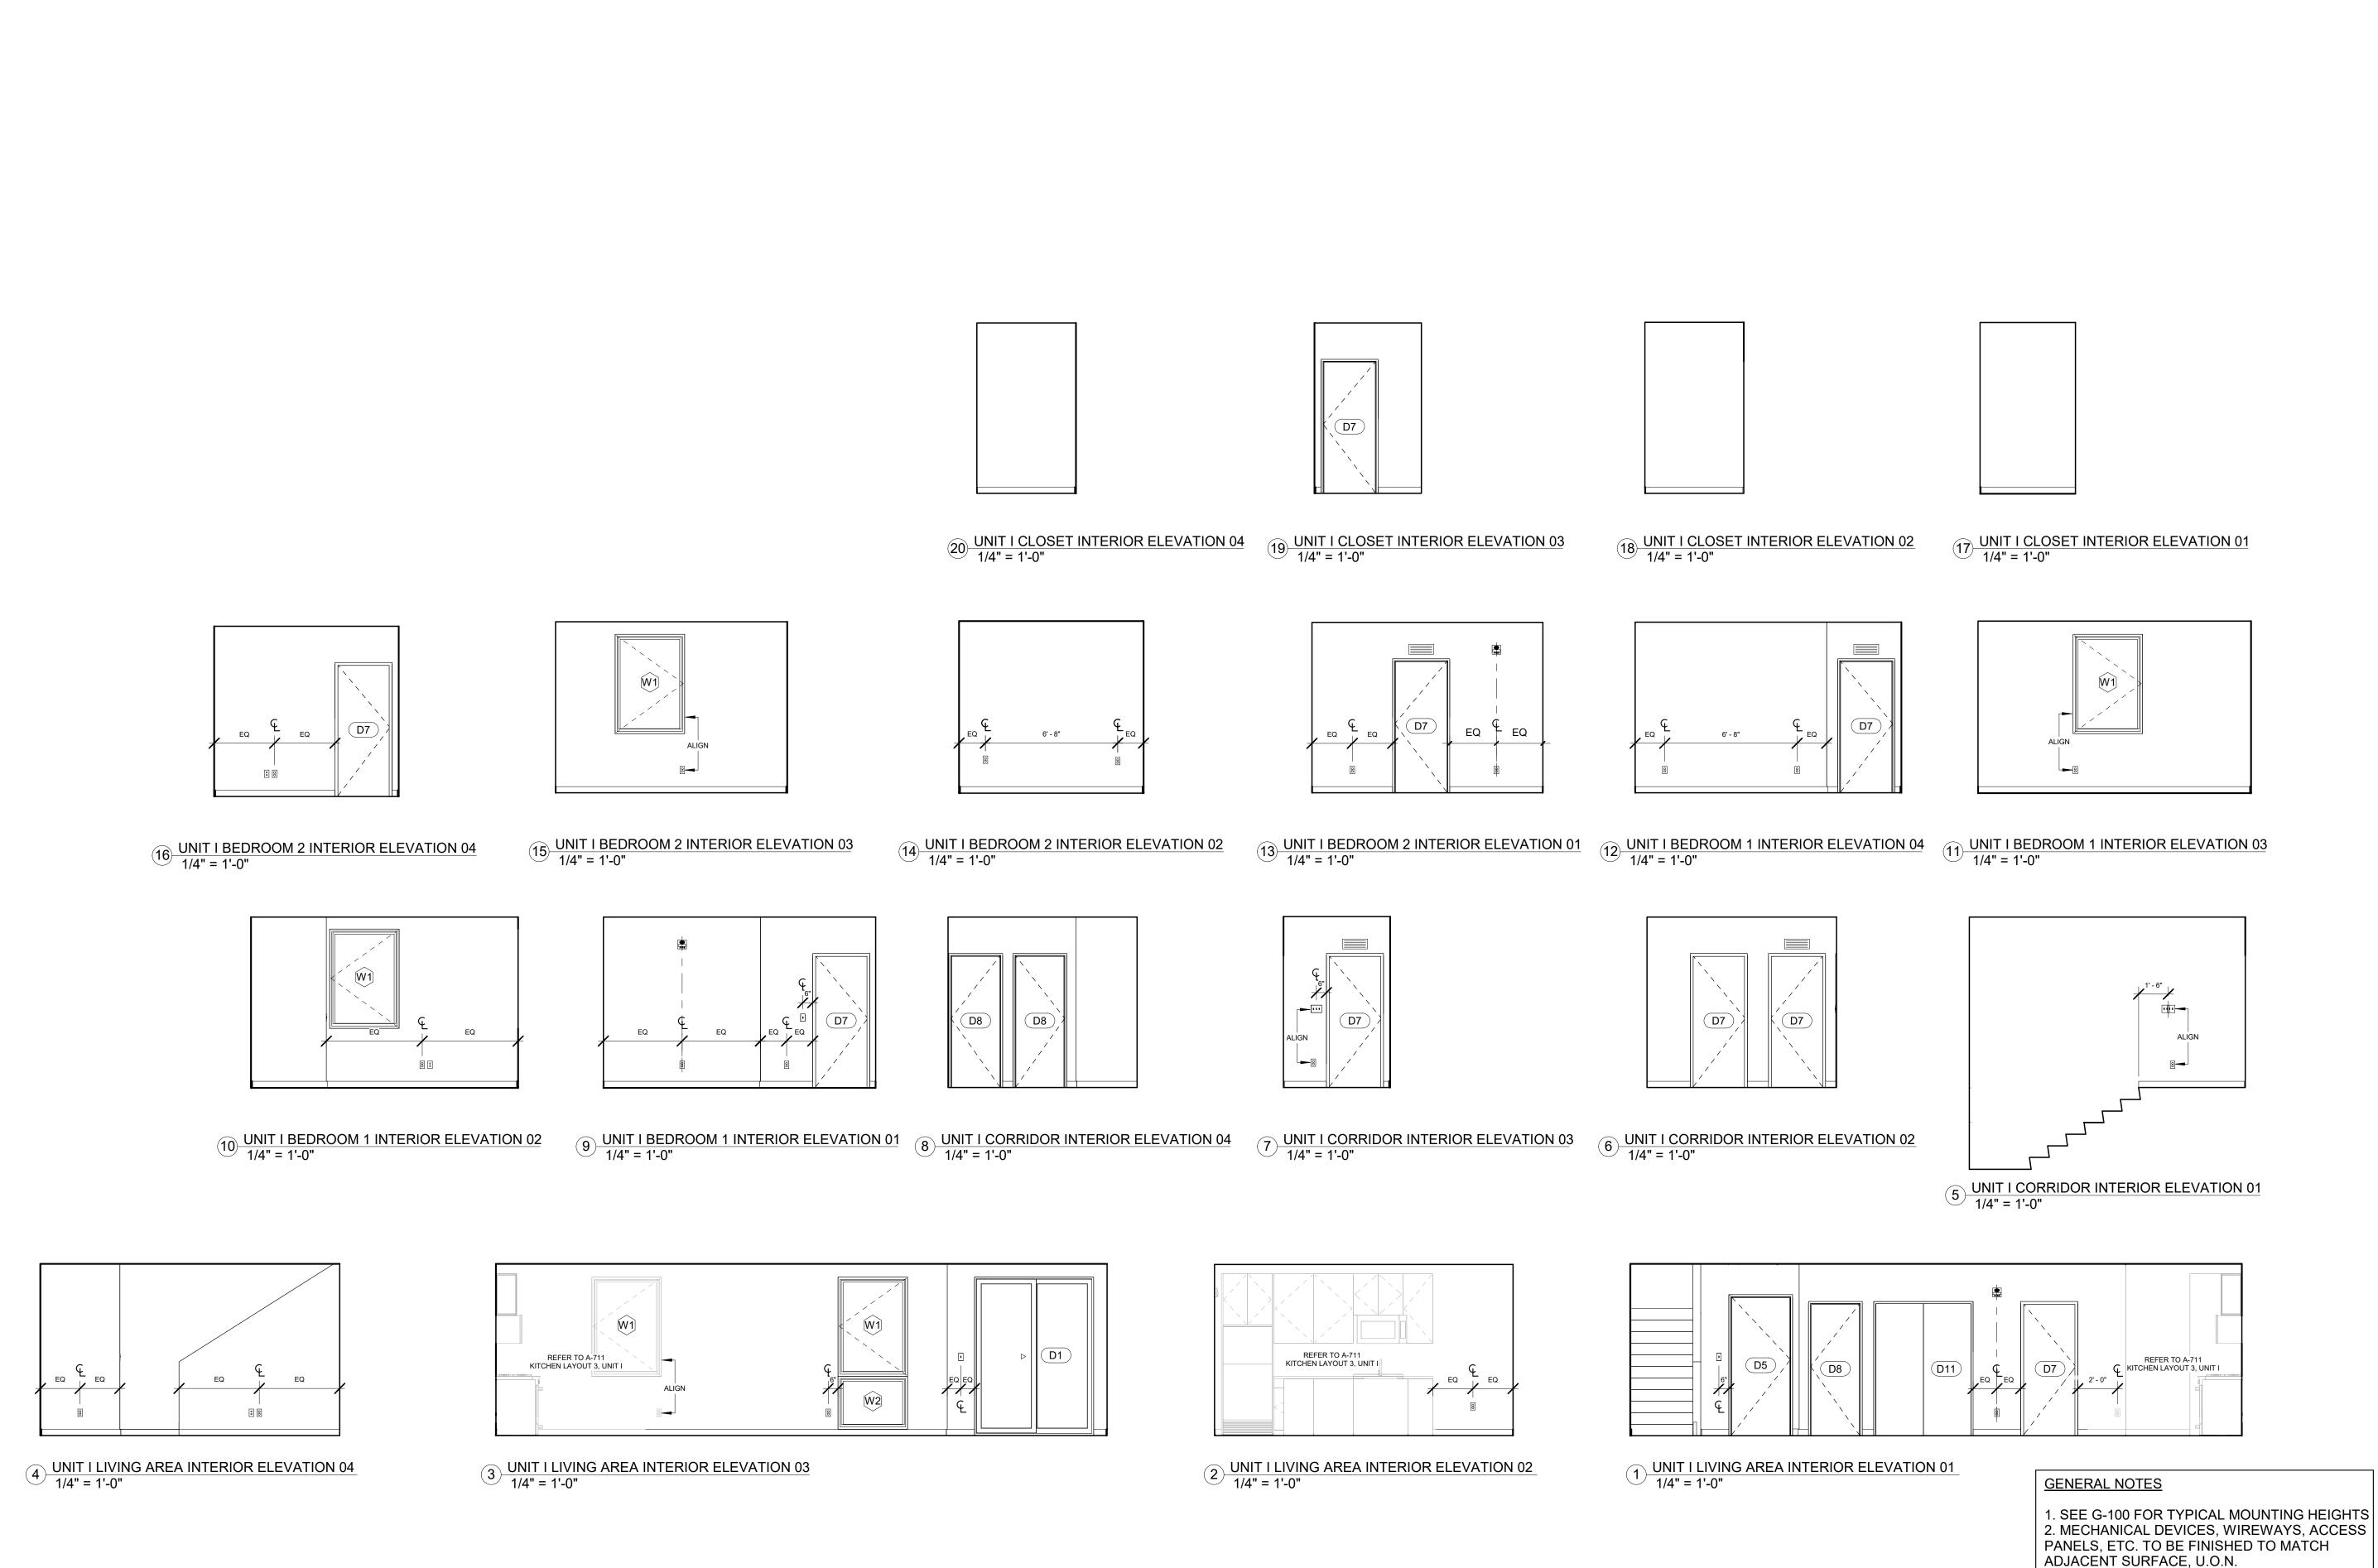



OWNER BRUSH PARK DEVELOPMENT COMPANY PHASE 1 LLC 1092 WOODWARD AVE. DETROIT, MI 48226

ARCHITECT

MERGE ARCHITECTS, INC. 332 CONGRESS ST. FLOOR 6 BOSTON, MA 02210 T: 617.670.0265

STRUCTURAL ENGINEER ENGINEERED STRUCTURES, LLC. 632 BARRY STREET SW GRANDVILLE, MI 49418 T: 616-667-9650

MP/FP ENGINEER

SELLINGER ASSOCIATES, INC. 19821 FARMINGTON ROAD, LIVONIA, MI 48152 T: 248-482-0045 F: 248-482-0052

ELECTRICAL ENGINEER ETS ENGINEERING, INC. P.O. BOX 1166 ROYAL OAK, MI 48068 418-1/2 S. WASHINGTON AVE, ROYAL OAK, MI 48067

CODE CONSULTANT

CODE RED CONSULTANTS 154 TURNPIKE ROAD, SUITE 200 SOUTHBOROUGH MA, 01772

ohn and Duplette Place Ish St. 8201 Park р On Edmunc Between Br Detroit MI, ⁴ **Brush** On Edn

05/15/20: 100% CD / PERMIT SET

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18284 JOB NO.: SCALE: 1/4" = 1'-0"


DATE: 05/15/2020

DRAWING TITLE

UNIT TYPE I INTERIOR ELEVATIONS

SHEET NO.

A-707

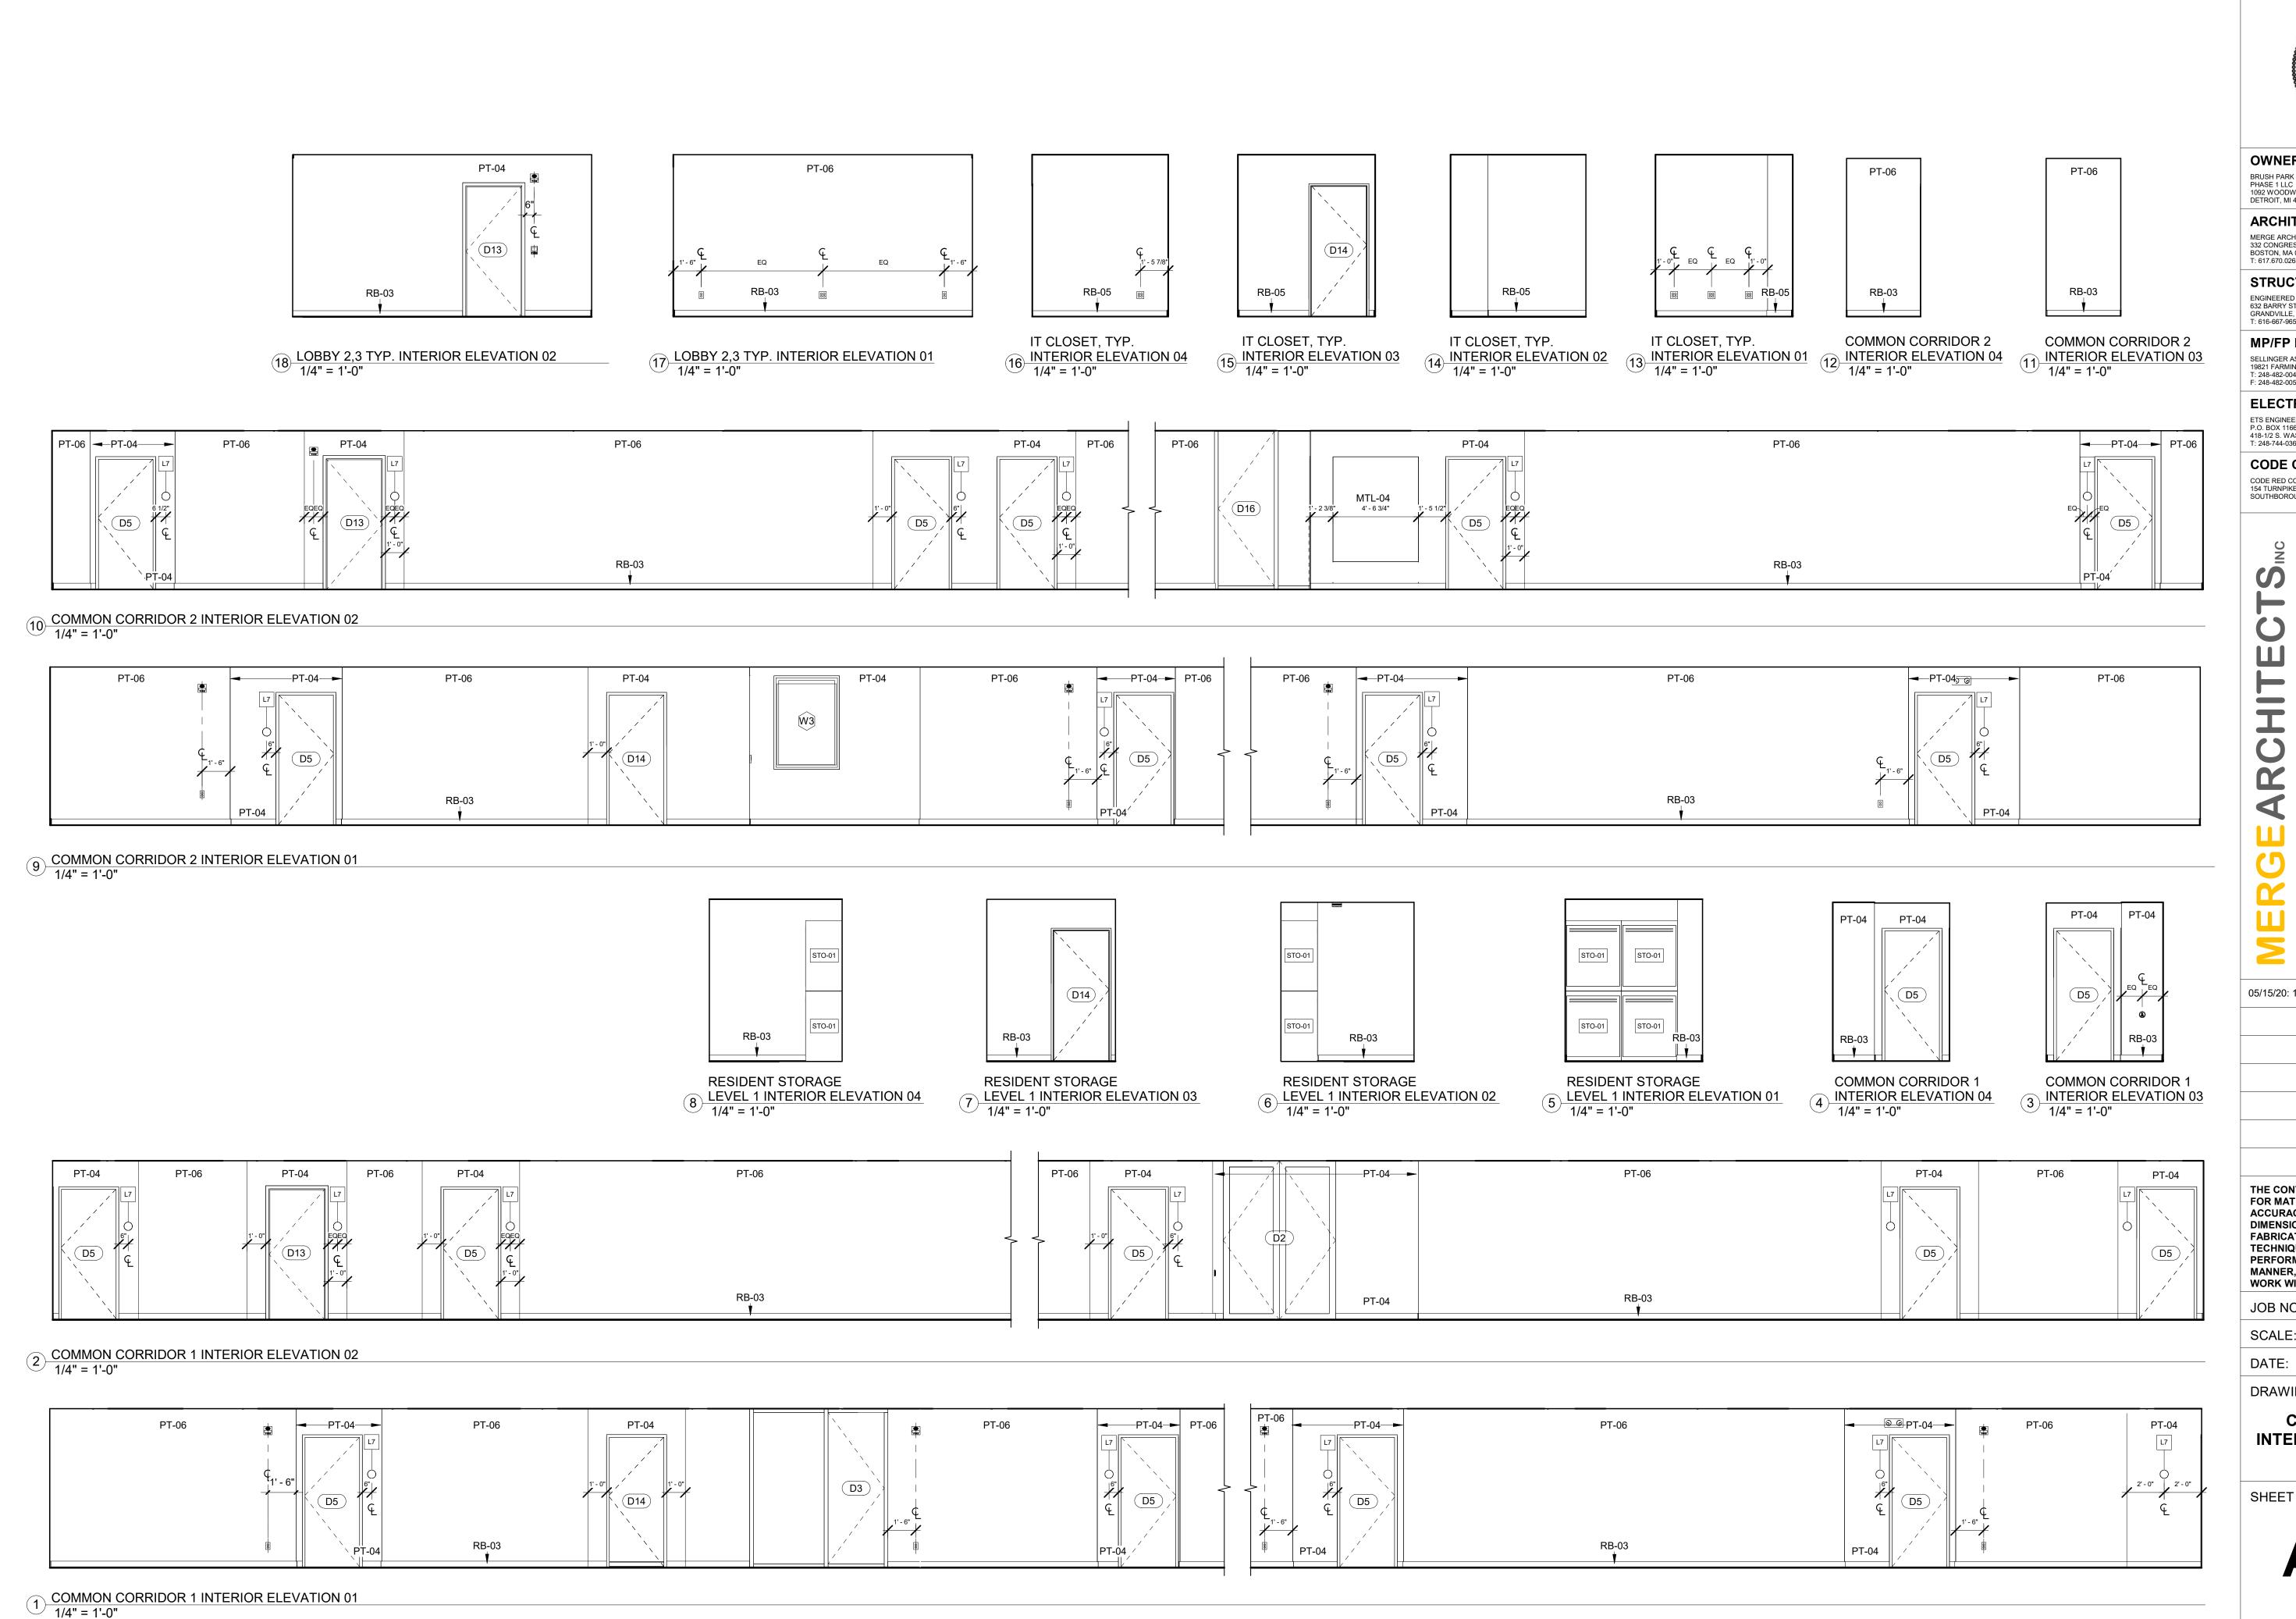



OWNER BRUSH PARK DEVELOPMENT COMPANY PHASE 1 LLC 1092 WOODWARD AVE. DETROIT, MI 48226

ARCHITECT MERGE ARCHITECTS, INC. 332 CONGRESS ST. FLOOR 6 BOSTON, MA 02210 T: 617.670.0265

STRUCTURAL ENGINEER ENGINEERED STRUCTURES, LLC.

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ELECTRICAL ENGINEER

ETS ENGINEERING, INC. P.O. BOX 1166 ROYAL OAK, MI 48068 418-1/2 S. WASHINGTON AVE, ROYAL OAK, MI 48067

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John and **Duplette** d Place srush St. 48201 **Brush Park I**On Edmund I
Between Brus
Detroit MI, 48

05/15/20: 100% CD / PERMIT SET


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18284 JOB NO.: SCALE: 1/4" = 1'-0" 02/07/20

DRAWING TITLE

COMMON AREA INTERIOR ELEVATIONS

SHEET NO.



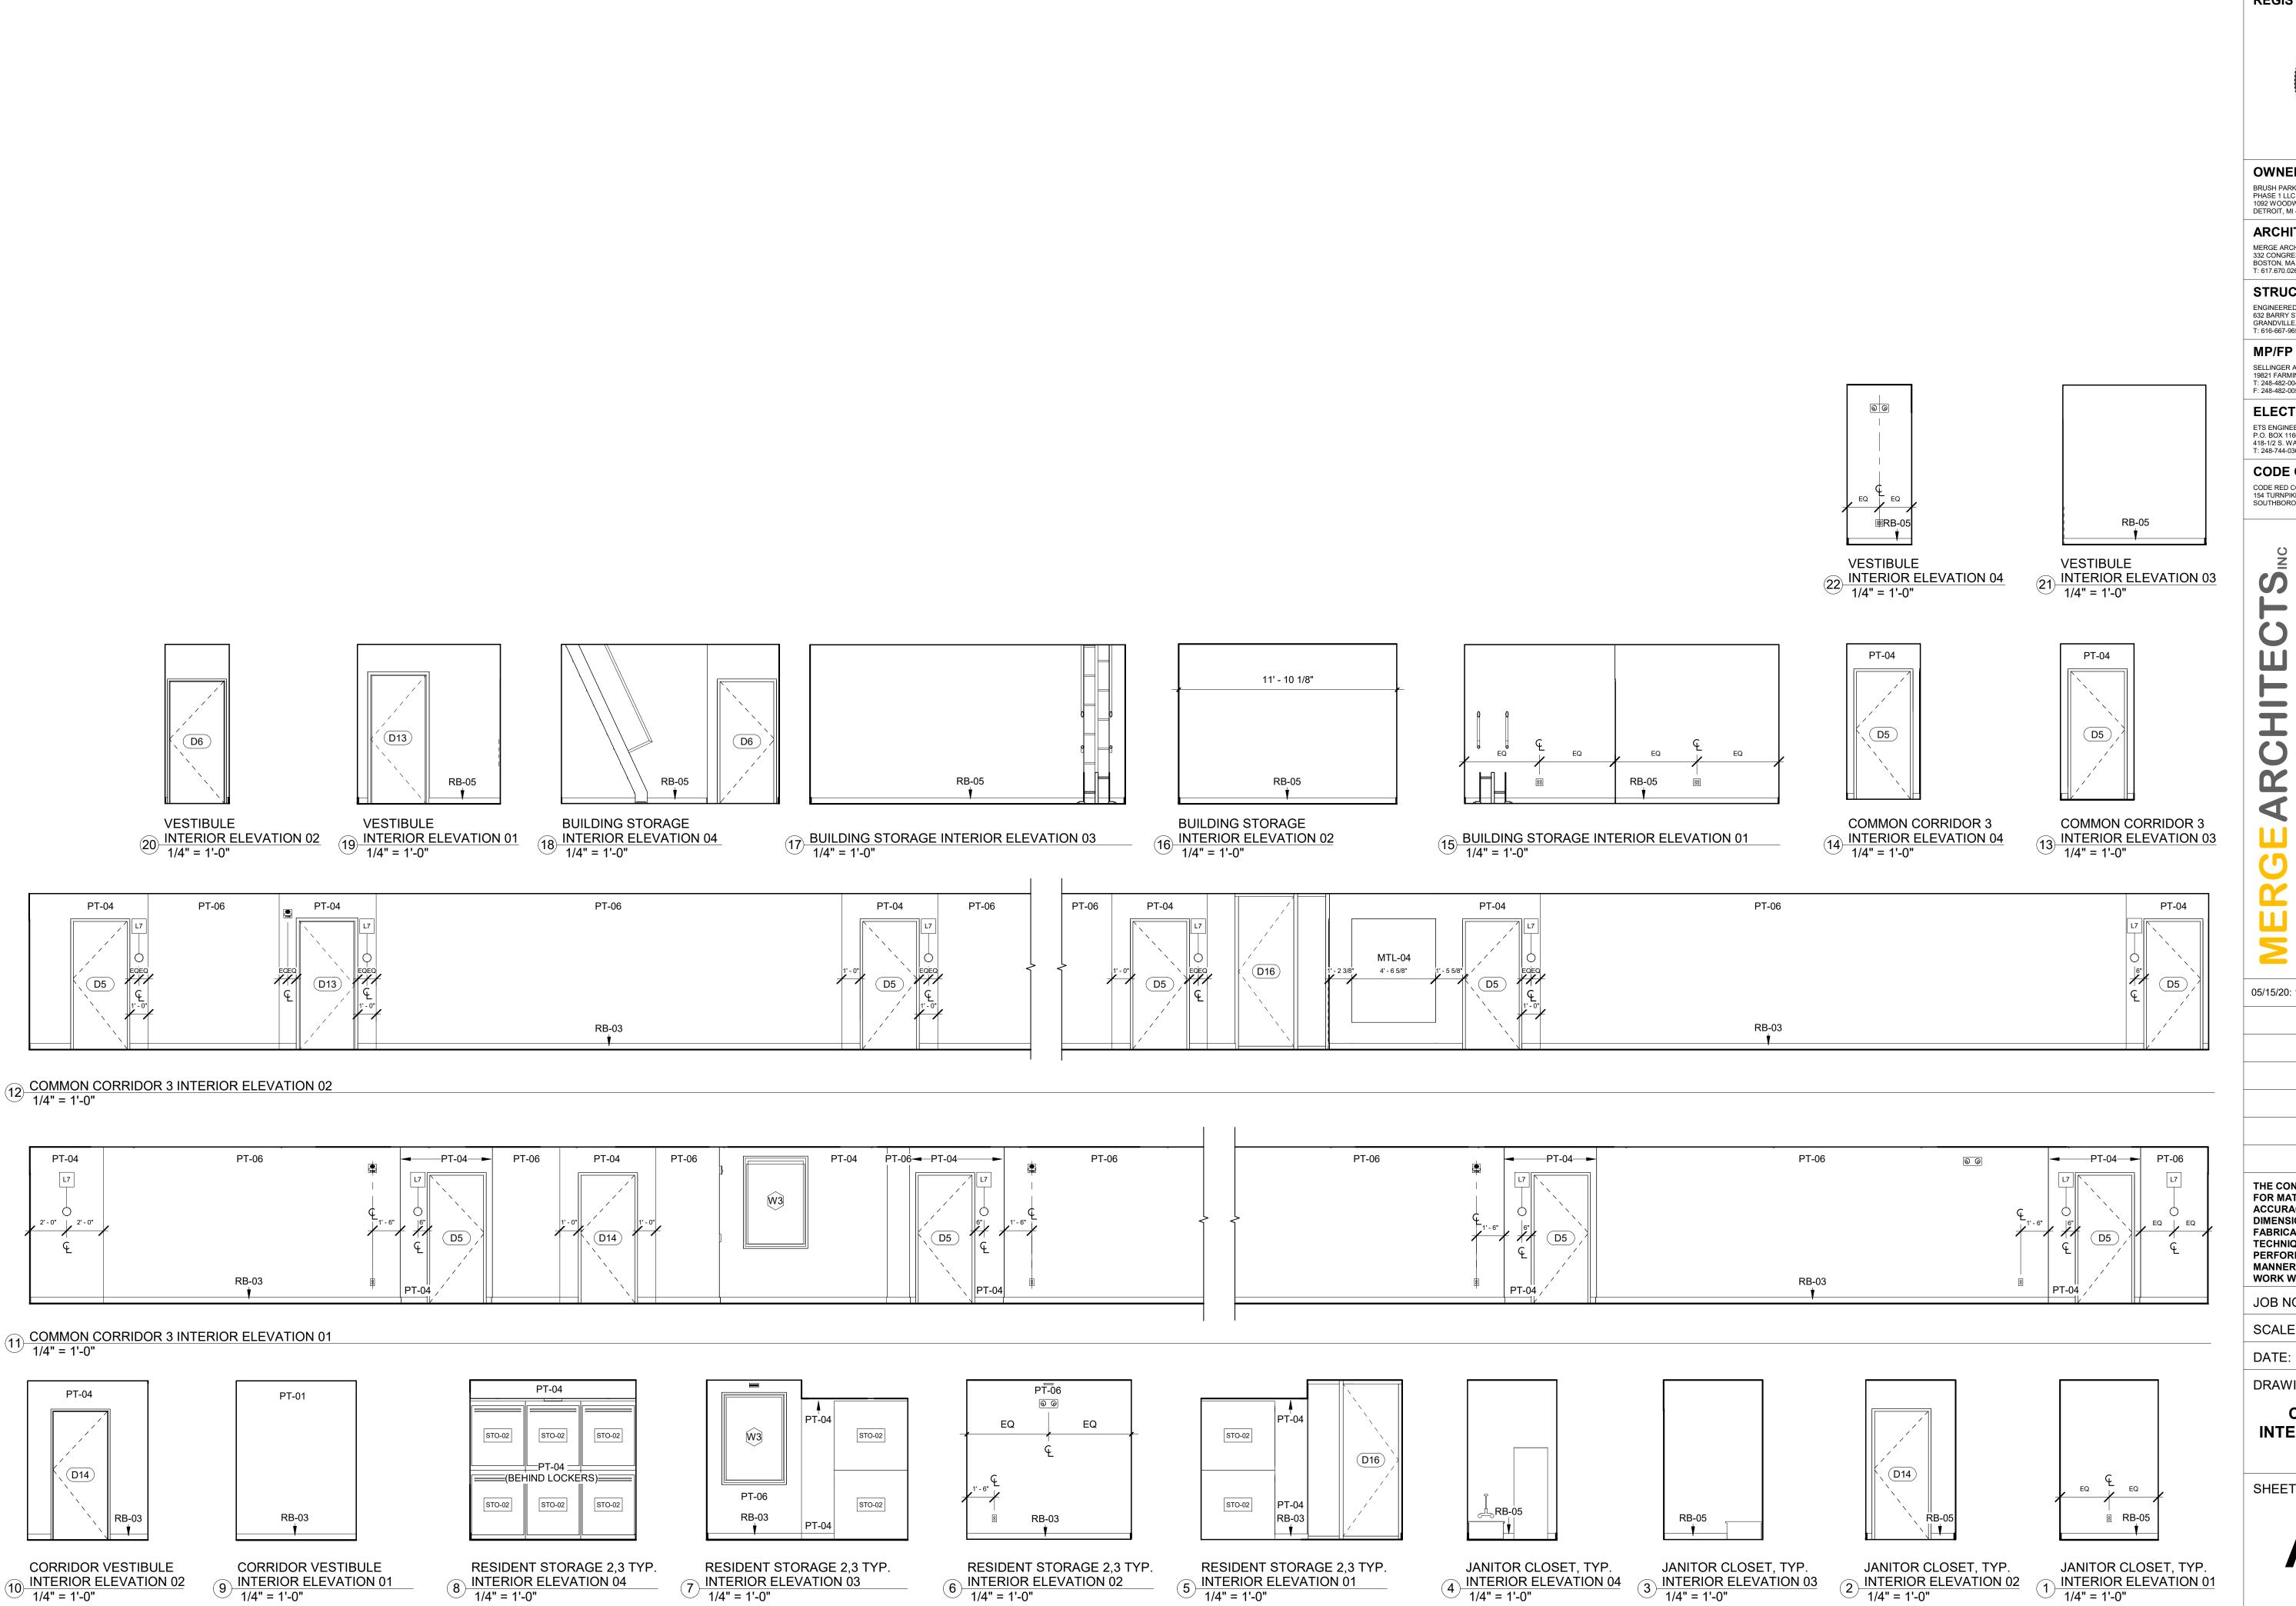

OWNER BRUSH PARK DEVELOPMENT COMPANY PHASE 1 LLC 1092 WOODWARD AVE. DETROIT, MI 48226

ARCHITECT

MERGE ARCHITECTS, INC. 332 CONGRESS ST. FLOOR 6 BOSTON, MA 02210 T: 617.670.0265

STRUCTURAL ENGINEER ENGINEERED STRUCTURES, LLC. 632 BARRY STREET SW GRANDVILLE, MI 49418 T: 616-667-9650

MP/FP ENGINEER

SELLINGER ASSOCIATES, INC. 19821 FARMINGTON ROAD, LIVONIA, MI 48152 T: 248-482-0045 F: 248-482-0052

ELECTRICAL ENGINEER ETS ENGINEERING, INC. P.O. BOX 1166 ROYAL OAK, MI 48068 418-1/2 S. WASHINGTON AVE, ROYAL OAK, MI 48067

CODE CONSULTANT

CODE RED CONSULTANTS 154 TURNPIKE ROAD, SUITE 200 SOUTHBOROUGH MA, 01772

Duplette

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p

On Edmunc Between Br Detroit MI, ⁴ Brush

Par

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18284 JOB NO.: SCALE: 1/4" = 1'-0" 05/06/20

DRAWING TITLE


COMMON AREA INTERIOR ELEVATIONS

SHEET NO.


ı	PLUMBING LEGEND		APPLIANCE LEGEND
Type Mark	Description	Type Mark	Description
BT-01	Bath and Shower Trim	D-01	Dryer Front Loading
BT-02	Handshower Kit	DW-01	Dishwasher
LAV-01	Sink	DW-02	Dishwasher
LAV-01 FAUCET	Faucet	MW-01	Microwave Oven
LAV-02	Mop Service Basin	MW-02	Microwave Oven
LAV-02 FAUCET	Wall Mounted Service Sink Faucet	RANGE-01	Oven/ Range
SC-1	Box Roof Drainage Scupper	RANGE-02	Oven/ Range
SC-2	Roof Drainage Scupper	REF-01	Refrigerator
SH-01	Provide with Linear Drain	REF-02	Refrigerator
SK-01	Sink	RH-01	Range Hood
SK-01 FAUCET	Sink	W-01	Washer Front Loading
TUB-01	Tub - Regular	WD-01	Electric Stacked Laundry Center
TUB-02	Tub - Long		
WC-01	Toilet		

KITCHEN GENERAL NOTES


- DIMENSIONS ARE TO FINISH FACE U.O.N.
- COORDINATE CASEWORK WITH APPLIANCE SPECIFICATIONS PROVIDE FINISH FACE CABINETS AT CASEWORK CORNERS, WALL
- TERMINATIONS, AND VISIBLE ENDS
- CONTINUE BACKSPLASH 4" BELOW TOP OF RANGE
- CONTINUE PAINT BEHIND APPLIANCES AND REMOVABLE CABINETS
- CONTINUE FINISH FLOOR UNDER REMOVABLE CABINETS
- REFER TO ENLARGED PLANS FOR ORIENTATION OF KITCHEN LAYOUT.

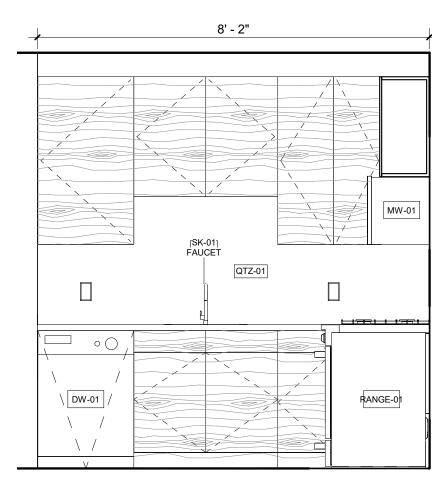




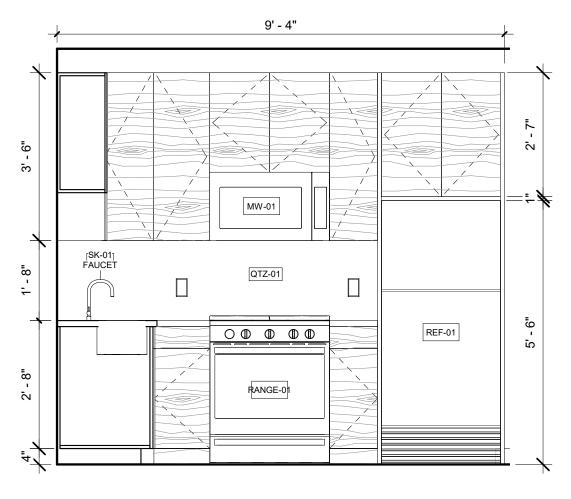


2 KITCHEN LAYOUT 1 INTERIOR ELEVATION 01
1/2" = 1'-0"

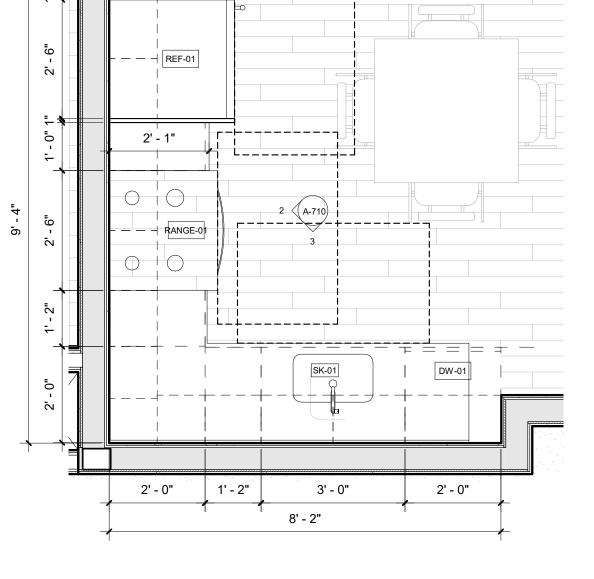


1 KITCHEN LAYOUT 1 ENLARGED PLAN (UNIT A) 1/2" = 1'-0"

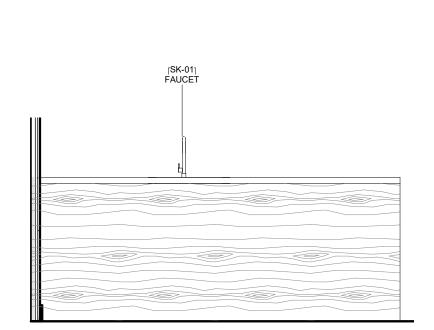



8 KITCHEN LAYOUT 2 INTERIOR ELEVATION 04 1/2" = 1'-0"

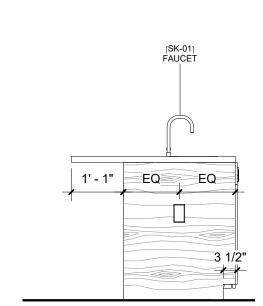


7 KITCHEN LAYOUT 2 INTERIOR ELEVATION 03
1/2" = 1'-0"

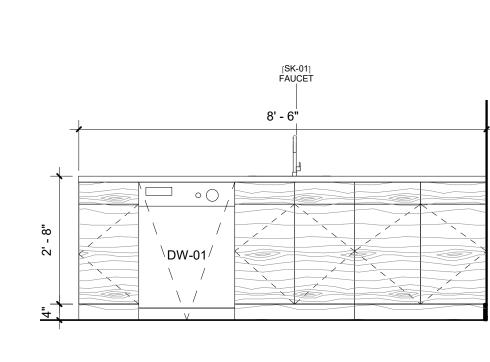

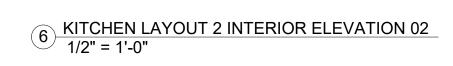

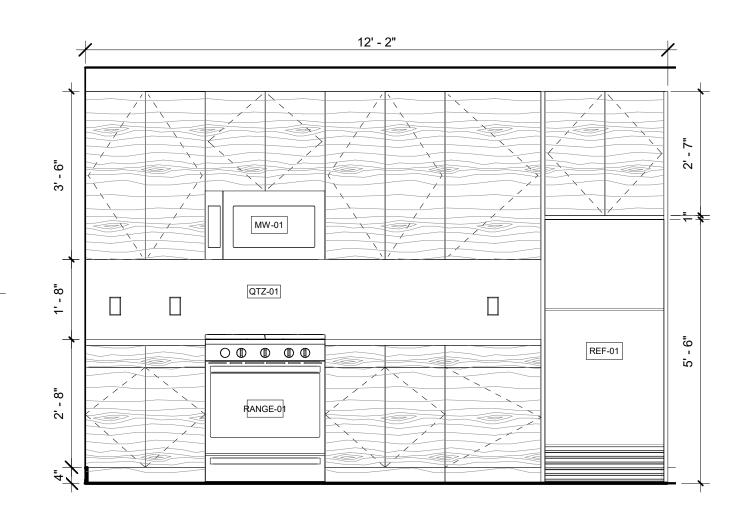

5 KITCHEN LAYOUT 2 INTERIOR ELEVATION 01 1/2" = 1'-0"

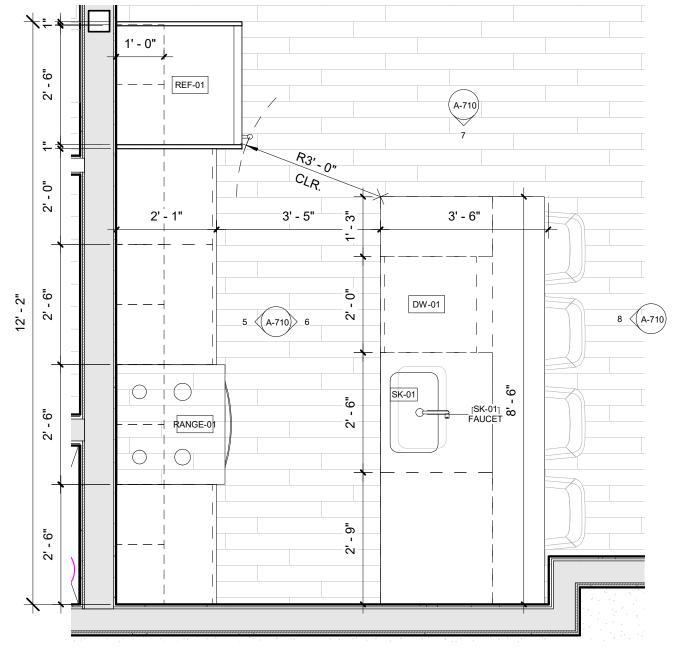

4 KITCHEN LAYOUT 2 ENLARGED PLAN (UNIT B) 1/2" = 1'-0"

REGISTRATION



OWNER BRUSH PARK DEVELOPMENT COMPANY PHASE 1 LLC 1092 WOODWARD AVE. DETROIT, MI 48226

ARCHITECT

MERGE ARCHITECTS, INC. 332 CONGRESS ST. FLOOR 6 BOSTON, MA 02210 T: 617.670.0265

STRUCTURAL ENGINEER ENGINEERED STRUCTURES, LLC. 632 BARRY STREET SW GRANDVILLE, MI 49418 T: 616-667-9650

MP/FP ENGINEER

SELLINGER ASSOCIATES, INC. 19821 FARMINGTON ROAD, LIVONIA, MI 48152 T: 248-482-0045 F: 248-482-0052

ELECTRICAL ENGINEER ETS ENGINEERING, INC. P.O. BOX 1166 ROYAL OAK, MI 48068 418-1/2 S. WASHINGTON AVE, ROYAL OAK, MI 48067

CODE CONSULTANT

CODE RED CONSULTANTS 154 TURNPIKE ROAD, SUITE 200 SOUTHBOROUGH MA, 01772

ohn and **Duplette** d Place srush St. 48201 0 Par

On Edmunc Between Br Detroit MI, ⁴

05/15/20: 100% CD / PERMIT SET

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18284 JOB NO.: SCALE: 1/2" = 1'-0" DATE: 05/15/2020

DRAWING TITLE

KITCHEN LAYOUTS 1 + 2, UNITS A, B


SHEET NO.

A-710


I	PLUMBING LEGEND		APPLIANCE LEGEND
Type Mark	Description	Type Mark	Description
BT-01	Bath and Shower Trim	D-01	Dryer Front Loading
BT-02	Handshower Kit	DW-01	Dishwasher
LAV-01	Sink	DW-02	Dishwasher
LAV-01 FAUCET	Faucet	MW-01	Microwave Oven
LAV-02	Mop Service Basin	MW-02	Microwave Oven
LAV-02 FAUCET	Wall Mounted Service Sink Faucet	RANGE-01	Oven/ Range
SC-1	Box Roof Drainage Scupper	RANGE-02	Oven/ Range
SC-2	Roof Drainage Scupper	REF-01	Refrigerator
SH-01	Provide with Linear Drain	REF-02	Refrigerator
SK-01	Sink	RH-01	Range Hood
SK-01 FAUCET	Sink	W-01	Washer Front Loading
TUB-01	Tub - Regular	WD-01	Electric Stacked Laundry Center
TUB-02	Tub - Long		
WC-01	Toilet		

KITCHEN GENERAL NOTES


- DIMENSIONS ARE TO FINISH FACE U.O.N.
- COORDINATE CASEWORK WITH APPLIANCE SPECIFICATIONS PROVIDE FINISH FACE CABINETS AT CASEWORK CORNERS, WALL
- TERMINATIONS, AND VISIBLE ENDS
- CONTINUE BACKSPLASH 4" BELOW TOP OF RANGE
- CONTINUE PAINT BEHIND APPLIANCES AND REMOVABLE CABINETS
- CONTINUE FINISH FLOOR UNDER REMOVABLE CABINETS
- REFER TO ENLARGED PLANS FOR ORIENTATION OF KITCHEN LAYOUT.

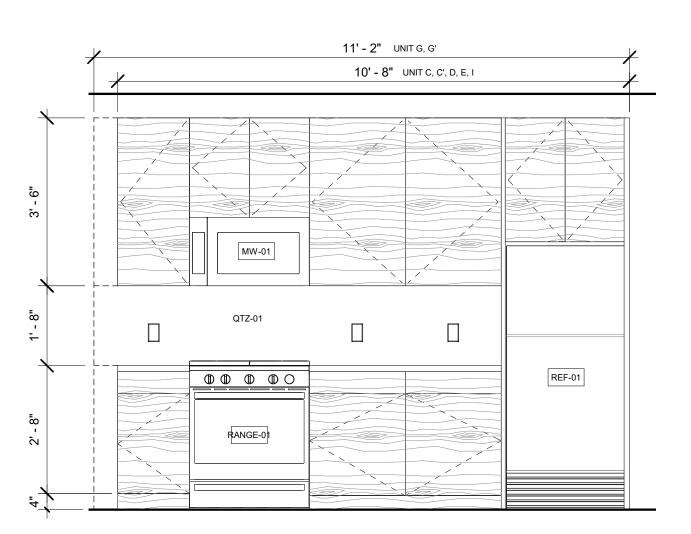

2 KITCHEN LAYOUT 3 INTERIOR ELEVATION 01 1/2" = 1'-0"

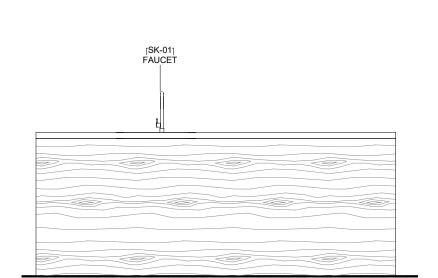


6 KITCHEN LAYOUT 3 INTERIOR ELEVATION 05
1/2" = 1'-0"

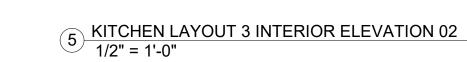


[SK-01] FAUCET


1' - 2" EQ EQ

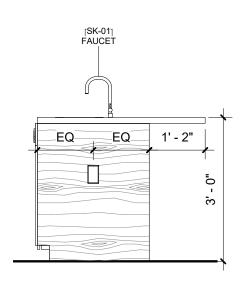

4 KITCHEN LAYOUT 3 INTERIOR ELEVATION 03
1/2" = 1'-0"

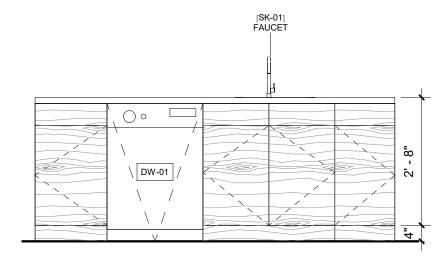

3 KITCHEN LAYOUT 3 INTERIOR ELEVATION 04 1/2" = 1'-0"

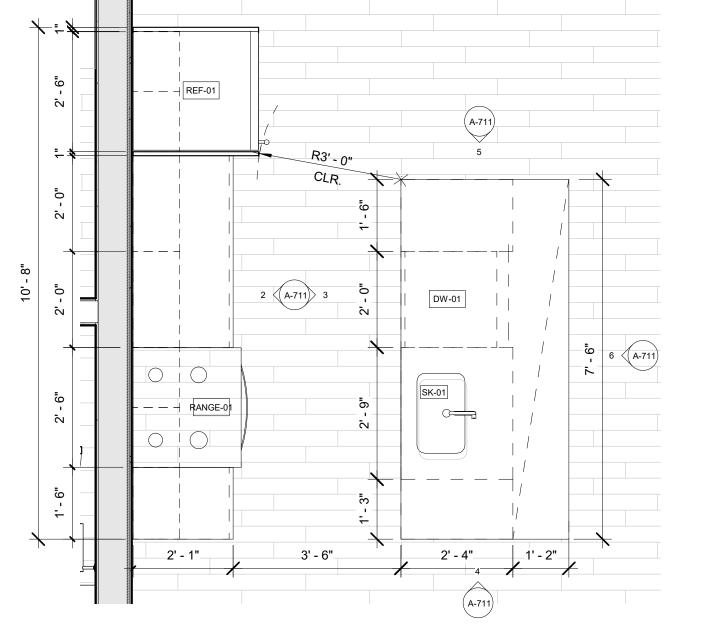

KITCHEN LAYOUT 3 ENLARGED PLAN (UNITS C, C', D, G, G', I, E) 1/2" = 1'-0"

REGISTRATION



OWNER BRUSH PARK DEVELOPMENT COMPANY PHASE 1 LLC 1092 WOODWARD AVE. DETROIT, MI 48226

ARCHITECT MERGE ARCHITECTS, INC. 332 CONGRESS ST. FLOOR 6 BOSTON, MA 02210 T: 617.670.0265

STRUCTURAL ENGINEER

ENGINEERED STRUCTURES, LLC. 632 BARRY STREET SW GRANDVILLE, MI 49418 T: 616-667-9650

MP/FP ENGINEER SELLINGER ASSOCIATES, INC. 19821 FARMINGTON ROAD, LIVONIA, MI 48152 T: 248-482-0045 F: 248-482-0052

ELECTRICAL ENGINEER ETS ENGINEERING, INC.

P.O. BOX 1166 ROYAL OAK, MI 48068 418-1/2 S. WASHINGTON AVE, ROYAL OAK, MI 48067

CODE CONSULTANT

CODE RED CONSULTANTS 154 TURNPIKE ROAD, SUITE 200 SOUTHBOROUGH MA, 01772

0 and Duplette Place ısh St. 8201 p **Brush Park**On Edmunc
Between Br
Detroit MI, ⁴

05/15/20: 100% CD / PERMIT SET

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TECHNIQUES OF ASSEMBLY, FOR
PERFORMING WORK IN A SAFE
MANNER, AND FOR COORDINATING MANNER, AND FOR COORDINATING WORK WITH THAT OF ALL TRADES

18284 JOB NO.: 1/2" = 1'-0" SCALE:

DATE: 05/15/2020

DRAWING TITLE


KITCHEN LAYOUT 3, UNITS C, C', D, G, G', I, E


SHEET NO.

A-711

		_	
PLUMBING LEGEND		APPLIANCE LEGEND	
Type Mark	Description	Type Mark	Description
BT-01	Bath and Shower Trim	D-01	Dryer Front Loading
BT-02	Handshower Kit	DW-01	Dishwasher
LAV-01	Sink	DW-02	Dishwasher
LAV-01 FAUCET	Faucet	MW-01	Microwave Oven
LAV-02	Mop Service Basin	MW-02	Microwave Oven
LAV-02 FAUCET	Wall Mounted Service Sink Faucet	RANGE-01	Oven/ Range
SC-1	Box Roof Drainage Scupper	RANGE-02	Oven/ Range
SC-2	Roof Drainage Scupper	REF-01	Refrigerator
SH-01	Provide with Linear Drain	REF-02	Refrigerator
SK-01	Sink	RH-01	Range Hood
SK-01 FAUCET	Sink	W-01	Washer Front Loading
TUB-01	Tub - Regular	WD-01	Electric Stacked Laundry Center
TUB-02	Tub - Long		
WC-01	Toilet		

KIT	CHEN GENERAL NOTES	
1.	DIMENSIONS ARE TO FINISH FACE U.O.N.	
2.	COORDINATE CASEWORK WITH APPLIANCE SPECIFICATIONS	
3.	PROVIDE FINISH FACE CABINETS AT CASEWORK CORNERS, WALL	
	TERMINATIONS, AND VISIBLE ENDS	
4.	CONTINUE BACKSPLASH 4" BELOW TOP OF RANGE	
5.	CONTINUE PAINT BEHIND APPLIANCES AND REMOVABLE CABINETS	
6.	CONTINUE FINISH FLOOR UNDER REMOVABLE CABINETS	
7.	REFER TO ENLARGED PLANS FOR ORIENTATION OF KITCHEN LAYOUT.	
	1. 2. 3. 4. 5. 6.	 COORDINATE CASEWORK WITH APPLIANCE SPECIFICATIONS PROVIDE FINISH FACE CABINETS AT CASEWORK CORNERS, WALL TERMINATIONS, AND VISIBLE ENDS CONTINUE BACKSPLASH 4" BELOW TOP OF RANGE CONTINUE PAINT BEHIND APPLIANCES AND REMOVABLE CABINETS CONTINUE FINISH FLOOR UNDER REMOVABLE CABINETS

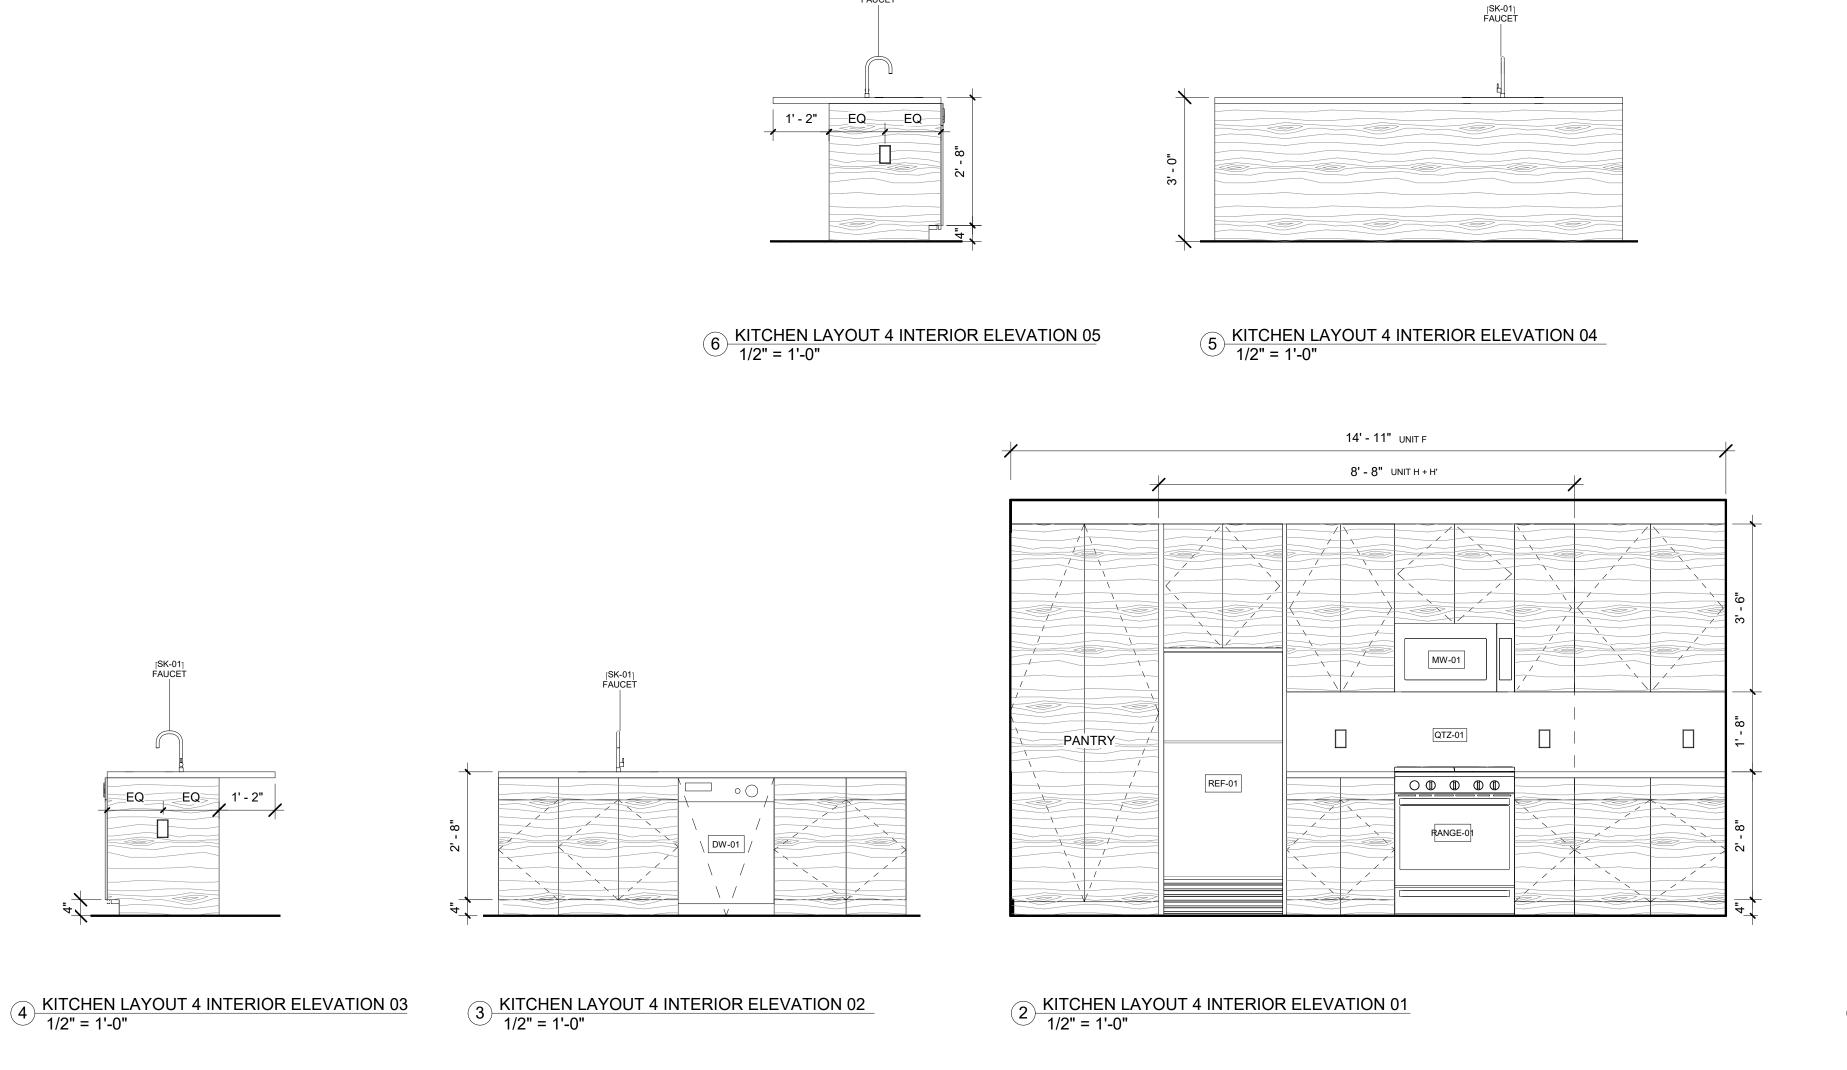

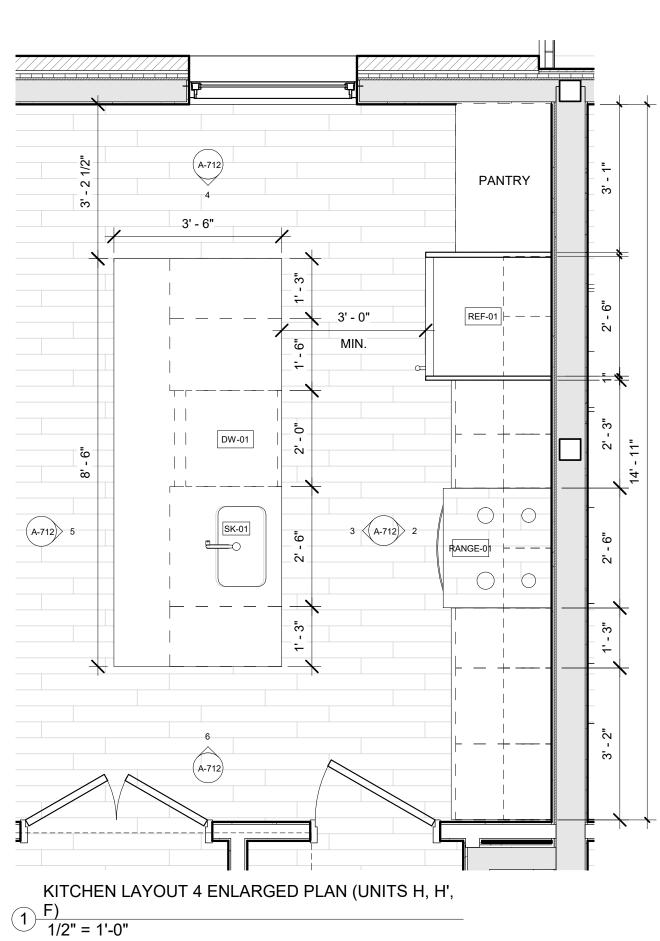



OWNER BRUSH PARK DEVELOPMENT COMPANY PHASE 1 LLC 1092 WOODWARD AVE. DETROIT, MI 48226

ARCHITECT MERGE ARCHITECTS, INC. 332 CONGRESS ST. FLOOR 6 BOSTON, MA 02210 T: 617.670.0265

STRUCTURAL ENGINEER

ENGINEERED STRUCTURES, LLC.

632 BARRY STREET SW GRANDVILLE, MI 49418 T: 616-667-9650

MP/FP ENGINEER SELLINGER ASSOCIATES, INC. 19821 FARMINGTON ROAD, LIVONIA, MI 48152 T: 248-482-0045 F: 248-482-0052

ELECTRICAL ENGINEER ETS ENGINEERING, INC. P.O. BOX 1166 ROYAL OAK, MI 48068 418-1/2 S. WASHINGTON AVE, ROYAL OAK, MI 48067

CODE CONSULTANT

CODE RED CONSULTANTS 154 TURNPIKE ROAD, SUITE 200 SOUTHBOROUGH MA, 01772

ohn and Duplette ld Place srush St. 48201 **Brush Park I**On Edmund I
Between Brus
Detroit MI, 48

05/15/20: 100% CD / PERMIT SET

THE CONTRACTOR IS RESPONSIBLE
FOR MATERIALS, DETAILS AND
ACCURACY, FOR ALL QUANTITIES AND
DIMENSIONS, FOR SELECTING
FABRICATION PROCESSES, FOR
TECHNIQUES OF ASSEMBLY, FOR PERFORMING WORK IN A SAFE MANNER, AND FOR COORDINATING WORK WITH THAT OF ALL TRADES

18284 JOB NO.: SCALE: 1/2" = 1'-0" 05/15/2020 DATE:

DRAWING TITLE

KITCHEN LAYOUT 4, UNITS F, H

SHEET NO.

A-712

ELECTRICAL ENGINEER

CODE RED CONSULTANTS 154 TURNPIKE ROAD, SUITE 200 SOUTHBOROUGH MA, 01772

REGISTRATION

OWNER

PHASE 1 LLC 1092 WOODWARD AVE. DETROIT, MI 48226

ARCHITECT

MERGE ARCHITECTS, INC. 332 CONGRESS ST. FLOOR 6 BOSTON, MA 02210 T: 617.670.0265

ENGINEERED STRUCTURES, LLC.

MP/FP ENGINEER

632 BARRY STREET SW GRANDVILLE, MI 49418 T: 616-667-9650

F: 248-482-0052

BRUSH PARK DEVELOPMENT COMPANY

ELIZABETH LEE

WHITTAKER ARCHITEOT No.

ohn and Duplette St. d Plac rush \$ 4820

On Edmunc Between Br Detroit MI, ⁴ Par

05/15/20: 100% CD / PERMIT SET

r-----

—3'_. - 5"—

4' MIN. FROM EDGE
OF APPLIANCE TO
OPPOSITE COUNTER.

1 KITCHEN LAYOUT 5 (UNIT B, TYPE A)
1/2" = 1'-0"

REF-02

1' - 10 3/4"

1'-7" KNEE CLEARANCE BELOW COUNTER

THE CONTRACTOR IS RESPONSIBLE FOR MATERIALS, DETAILS AND ACCURACY, FOR ALL QUANTITIES AND DIMENSIONS, FOR SELECTING **FABRICATION PROCESSES, FOR TECHNIQUES OF ASSEMBLY, FOR** PERFORMING WORK IN A SAFE

MANNER, AND FOR COORDINATING WORK WITH THAT OF ALL TRADES 18284 JOB NO.: 1/2" = 1'-0"

05/15/2020

DRAWING TITLE

KITCHEN LAYOUT 5, UNIT B (TYPE A)

SHEET NO.

A-713

KITCHEN GENERAL NOTES

DIMENSIONS ARE TO FINISH FACE U.O.N. COORDINATE CASEWORK WITH APPLIANCE SPECIFICATIONS PROVIDE FINISH FACE CABINETS AT CASEWORK CORNERS, WALL

TERMINATIONS, AND VISIBLE ENDS

CONTINUE BACKSPLASH 4" BELOW TOP OF RANGE

REFER TO ENLARGED PLANS FOR ORIENTATION OF KITCHEN LAYOUT.

CONTINUE PAINT BEHIND APPLIANCES AND REMOVABLE CABINETS CONTINUE FINISH FLOOR UNDER REMOVABLE CABINETS


PLUMBING LEGEND APPLIANCE LEGEND Type Mark Type Mark Description Description Bath and Shower Trim D-01 Dryer Front Loading Handshower Kit DW-01 Dishwasher DW-02 Sink Dishwasher Faucet MW-01 Microwave Oven MW-02 Mop Service Basin Microwave Oven RANGE-01 Oven/ Range Box Roof Drainage Scupper RANGE-02 Oven/ Range Roof Drainage Scupper REF-01 Refrigerator REF-02 Provide with Linear Drain Refrigerator RH-01 Sink Range Hood Sink W-01 Washer Front Loading Tub - Regular Electric Stacked Laundry Center


BT-01 BT-02 LAV-01 LAV-01 FAUCET LAV-02 LAV-02 FAUCET | Wall Mounted Service Sink Faucet SC-1 SC-2 SH-01 SK-01 SK-01 FAUCET TUB-01 TUB-02 Tub - Long WC-01 Toilet

> NOTE: -CABINETRY TO BE REMOVABLE. -FLOORS AND WALLS TO BE FINISHED BEHIND CABINERTY. DW-02

3 UNIT B KITCHEN ELEVATION 02 (TYPE A) 1/2" = 1'-0"

2 UNIT B KITCHEN ELEVATION 01 (TYPE A)
1/2" = 1'-0"

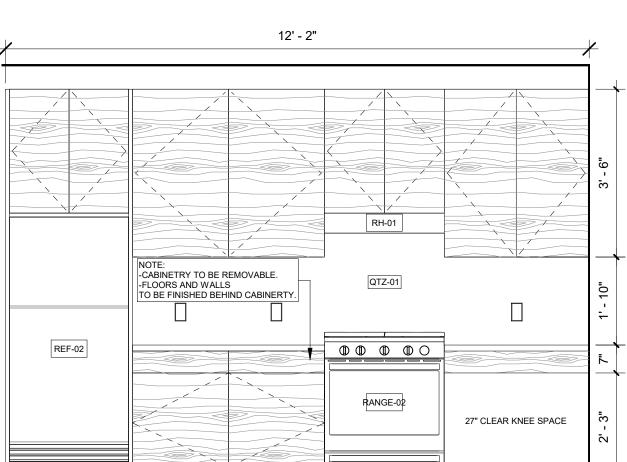

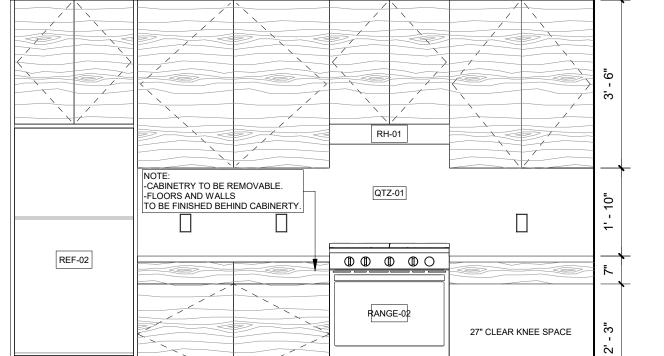

5 UNIT B KITCHEN ELEVATION 04 (TYPE A)
1/2" = 1'-0" 4 UNIT B KITCHEN ELEVATION 03 (TYPE A)
1/2" = 1'-0"

EQ 1' - 1"

EQ

-CABINETRY TO BE REMOVABLE. -FLOORS AND WALLS


100% CD/ PERMIT SET

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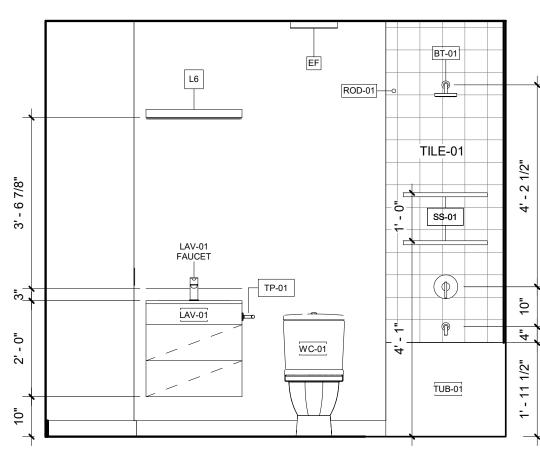
PLUMBING LEGEND		
Type Mark	Description	
BT-01	Bath and Shower Trim	
BT-02	Handshower Kit	
LAV-01	Sink	
LAV-01 FAUCET	Faucet	
LAV-02	Mop Service Basin	
LAV-02 FAUCET	Wall Mounted Service Sink Faucet	
SC-1	Box Roof Drainage Scupper	
SC-2	Roof Drainage Scupper	
SH-01	Provide with Linear Drain	
SK-01	Sink	
SK-01 FAUCET	Sink	
TUB-01	Tub - Regular	
TUB-02	Tub - Long	
WC-01	Toilet	

ACCESSORIES & EQUIPMENT LEGEND		
Type Mark	Description	
GB-01	Components Grab Bar	
GB-02	Components Grab Bar	
MAIL	Mailboxes	
ROD-01	Shower Rod	
ROD-02	Shelf & Heavy Duty Rod	
SS-01	Choreograph Floating Shower Shelf	
STO-01	Welded Wire Tenant Storage Units, 2 stacked	
STO-02	Welded Wire Tenant Storage Units, 2 stacked	
TP-01	Composed Pivoting Toilet Tissue Holder	
TR-01	Components Towel Bar	
TR-02	Components Towel Arm	
TRASH	Trash Receptacle	


- DIMENSIONS ARE TO FINISH FACE U.O.N.
- LAY TILES IN PATTERN DIRECTION AS INDICATED ON DRAWINGS. CENTER TILE FIELDS IN BOTH DIRECTIONS IN EACH SPACE OR ON EACH WALL AREA, U.O.N. PROVIDE UNIFORM JOINT WIDTHS, U.O.N.
- PROVIDE SOLID WOOD BLOCKING FOR AND COORDINATE LOCATIONS OF ALL ACCESSORY ITEMS INCLUDING, BUT NOT LIMITED TO: TOWEL RACKS, SHELVING, AND ROD.
- VERIFY ROUGH OPENING REQUIREMENTS AT BATHTUB AND SHOWER WITH APPROVED MANUFACTURER.
- REFER TO ENLARGED PLANS FOR ORIENTATION OF BATHROOM LAYOUT.



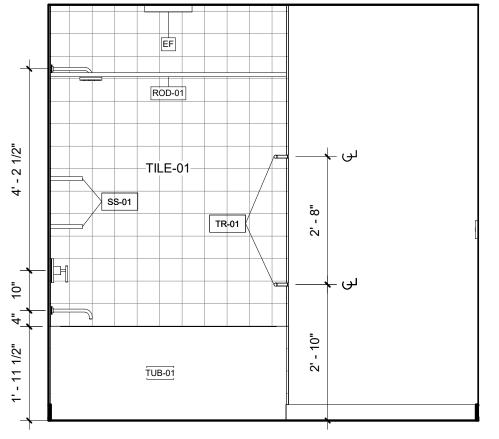





9 UNIT A BATHROOM INTERIOR ELEVATION 03
1/2" = 1'-0"

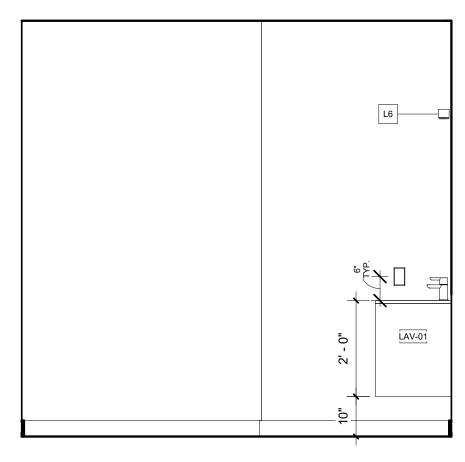



8 UNIT A BATHROOM INTERIOR ELEVATION 02 1/2" = 1'-0"

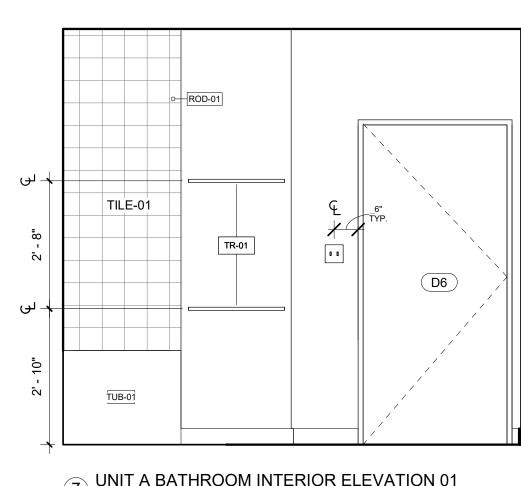


7 UNIT A BATHROOM INTERIOR ELEVATION 01
1/2" = 1'-0"

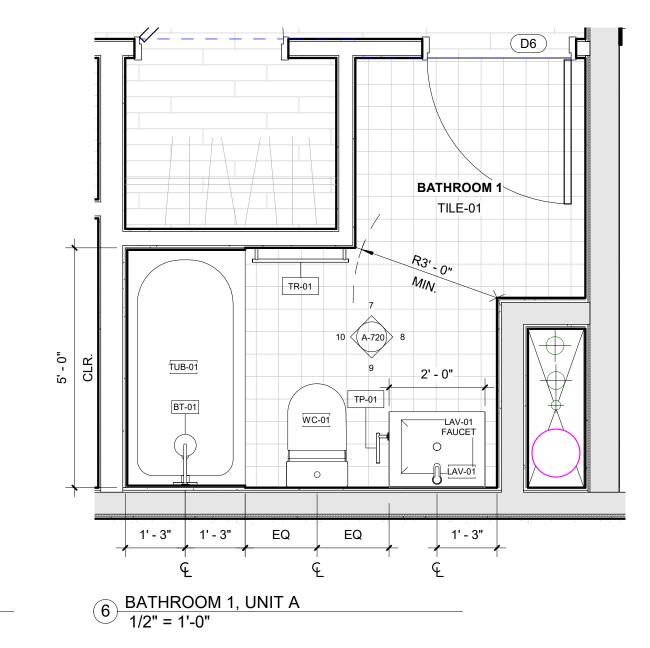


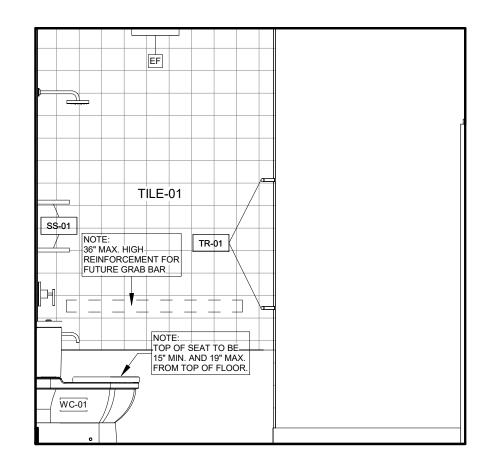

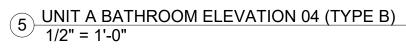


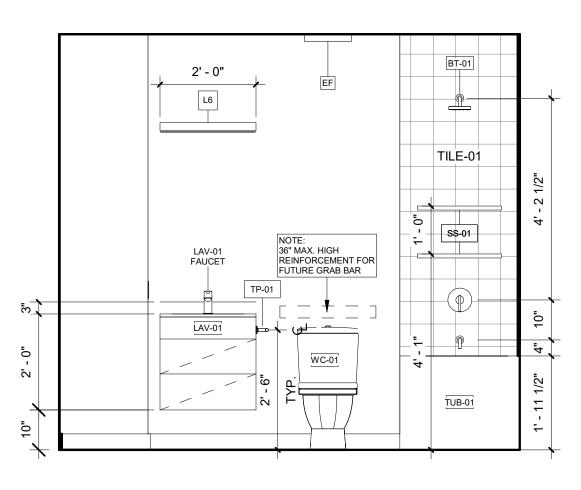


4 UNIT A BATHROOM ELEVATION 03 (TYPE B)
1/2" = 1'-0"

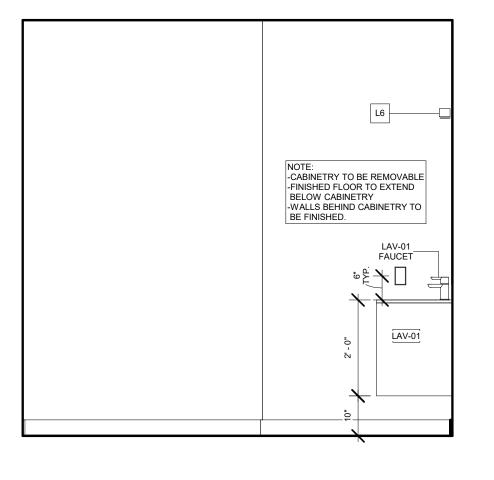

3 UNIT A BATHROOM ELEVATION 02 (TYPE B)
1/2" = 1'-0"

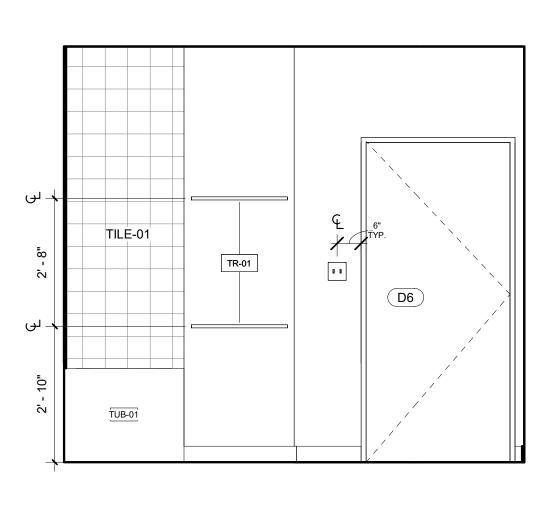

2 UNIT A BATHROOM ELEVATION 01 (TYPE B)
1/2" = 1'-0"

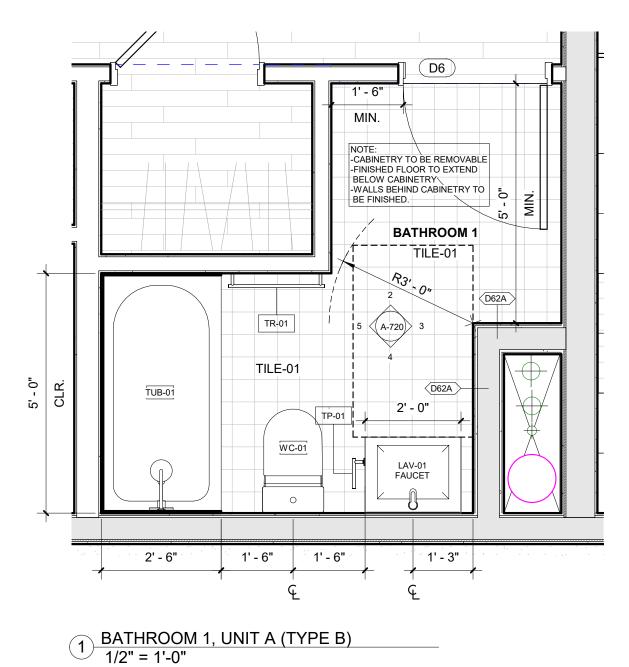

REGISTRATION



OWNER BRUSH PARK DEVELOPMENT COMPANY PHASE 1 LLC 1092 WOODWARD AVE. DETROIT, MI 48226

ARCHITECT MERGE ARCHITECTS, INC. 332 CONGRESS ST. FLOOR 6 BOSTON, MA 02210 T: 617.670.0265

ENGINEERED STRUCTURES, LLC.

STRUCTURAL ENGINEER

632 BARRY STREET SW GRANDVILLE, MI 49418 T: 616-667-9650 **MP/FP ENGINEER**

SELLINGER ASSOCIATES, INC. 19821 FARMINGTON ROAD, LIVONIA, MI 48152 T: 248-482-0045 F: 248-482-0052

ELECTRICAL ENGINEER ETS ENGINEERING, INC. P.O. BOX 1166 ROYAL OAK, MI 48068 418-1/2 S. WASHINGTON AVE, ROYAL OAK, MI 48067

CODE CONSULTANT

CODE RED CONSULTANTS 154 TURNPIKE ROAD, SUITE 200 SOUTHBOROUGH MA, 01772

ohn and **Duplette** p On Edmund Between Br Detroit MI, ²

05/15/20: 100% CD / PERMIT SET

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18284 JOB NO.: 1/2" = 1'-0" 05/15/2020 DATE:

DRAWING TITLE

BATHROOMS UNIT A


SHEET NO.

A-720


PLUMBING LEGEND		
Type Mark	Description	
BT-01	Bath and Shower Trim	
BT-02	Handshower Kit	
LAV-01	Sink	
LAV-01 FAUCET	Faucet	
LAV-02	Mop Service Basin	
LAV-02 FAUCET	Wall Mounted Service Sink Faucet	
SC-1	Box Roof Drainage Scupper	
SC-2	Roof Drainage Scupper	
SH-01	Provide with Linear Drain	
SK-01	Sink	
SK-01 FAUCET	Sink	
TUB-01	Tub - Regular	
TUB-02	Tub - Long	
WC-01	Toilet	

ACCE	SSORIES & EQUIPMENT LEGEND
Type Mark	Description
GB-01	Components Grab Bar
GB-02	Components Grab Bar
MAIL	Mailboxes
ROD-01	Shower Rod
ROD-02	Shelf & Heavy Duty Rod
SS-01	Choreograph Floating Shower Shelf
STO-01	Welded Wire Tenant Storage Units, 2 stacked
STO-02	Welded Wire Tenant Storage Units, 2 stacked
TP-01	Composed Pivoting Toilet Tissue Holder
TR-01	Components Towel Bar
TR-02	Components Towel Arm
TRASH	Trash Receptacle


- DIMENSIONS ARE TO FINISH FACE U.O.N.
- LAY TILES IN PATTERN DIRECTION AS INDICATED ON DRAWINGS. CENTER TILE FIELDS IN BOTH DIRECTIONS IN EACH SPACE OR ON
- EACH WALL AREA, U.O.N. PROVIDE UNIFORM JOINT WIDTHS, U.O.N. PROVIDE SOLID WOOD BLOCKING FOR AND COORDINATE LOCATIONS OF ALL ACCESSORY ITEMS INCLUDING, BUT NOT LIMITED TO: TOWEL RACKS, SHELVING, AND ROD.
- VERIFY ROUGH OPENING REQUIREMENTS AT BATHTUB AND SHOWER WITH APPROVED MANUFACTURER.
- REFER TO ENLARGED PLANS FOR ORIENTATION OF BATHROOM LAYOUT.

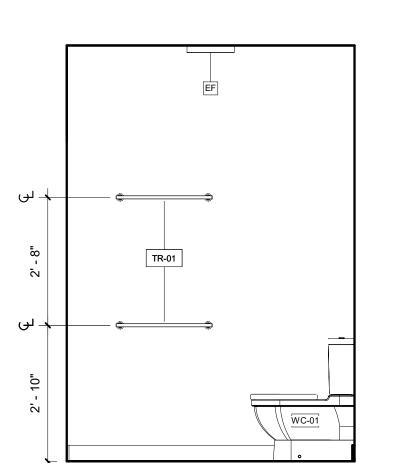


10 UNIT B BATHROOM INTERIOR ELEVATION 04
1/2" = 1'-0"

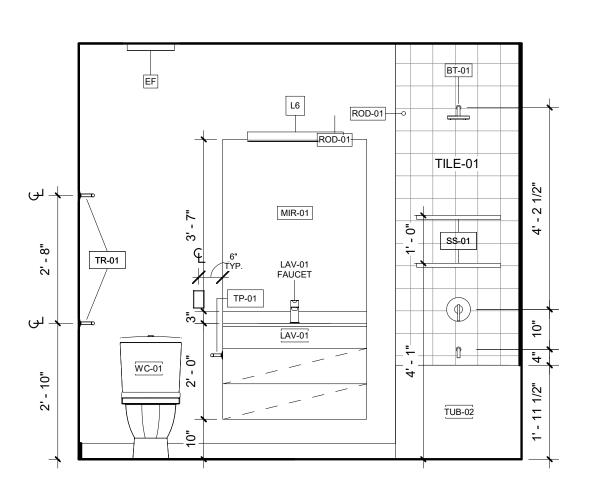


9 UNIT B BATHROOM INTERIOR ELEVATION 03
1/2" = 1'-0"

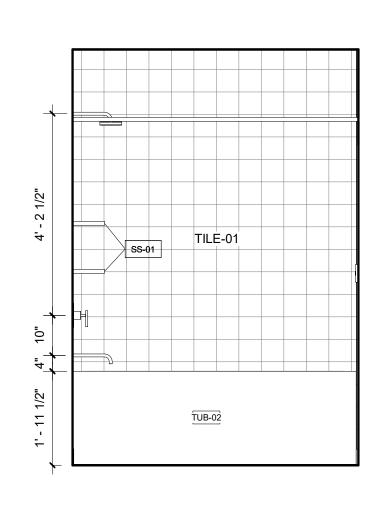


8 UNIT B BATHROOM INTERIOR ELEVATION 02 1/2" = 1'-0"

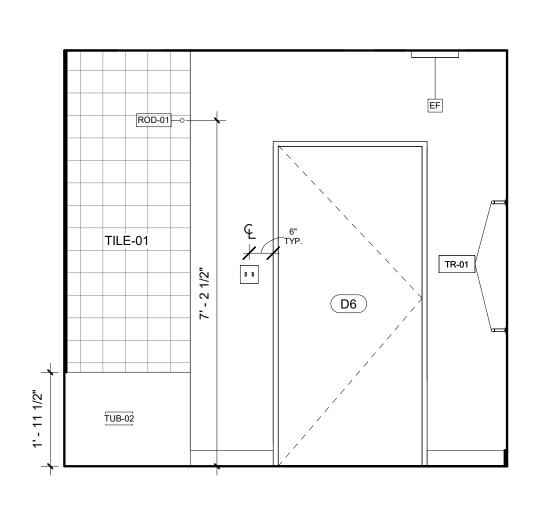


7 UNIT B BATHROOM INTERIOR ELEVATION 01
1/2" = 1'-0"

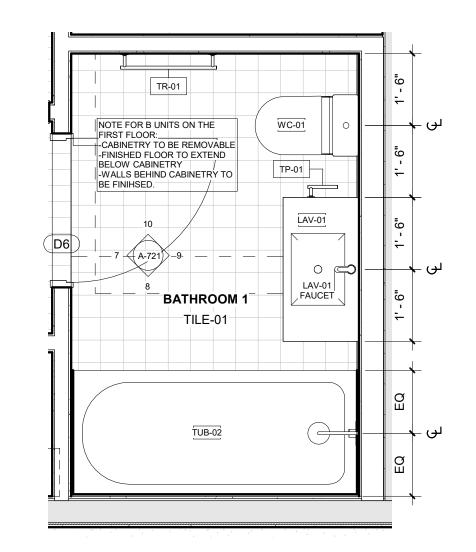


6 BATHROOM 1, UNIT B 1/2" = 1'-0"

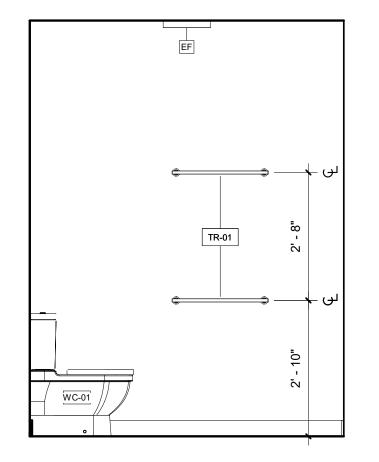


5 UNIT B BATHROOM ELEVATION 04 (TYPE A)
1/2" = 1'-0"

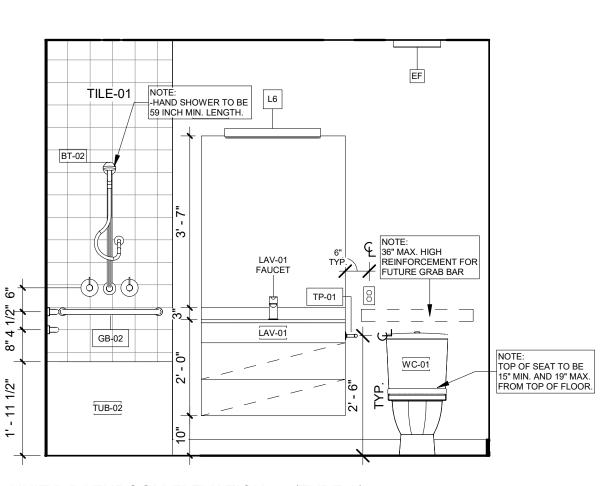


4 UNIT B BATHROOM ELEVATION 03 (TYPE A)
1/2" = 1'-0"

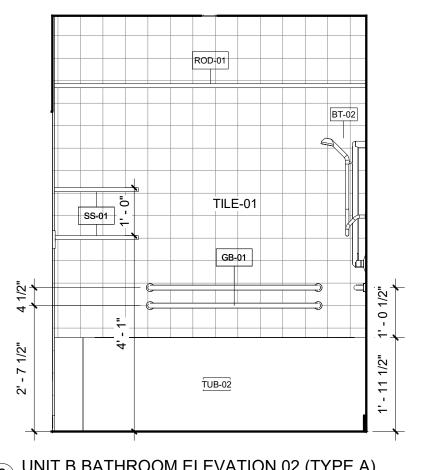

3 UNIT B BATHROOM ELEVATION 02 (TYPE A) 1/2" = 1'-0"

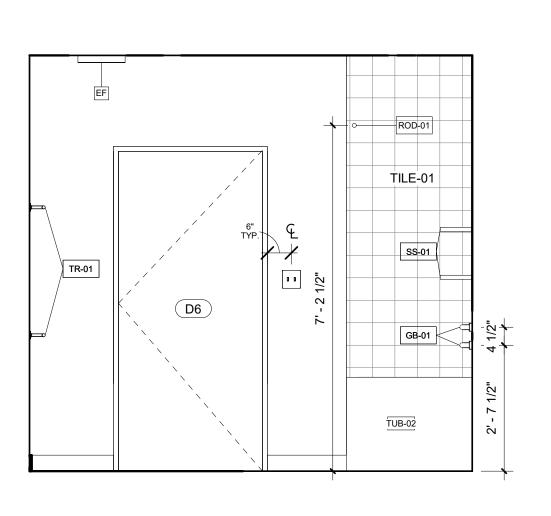

2 UNIT B BATHROOM ELEVATION 01 (TYPE A)
1/2" = 1'-0"

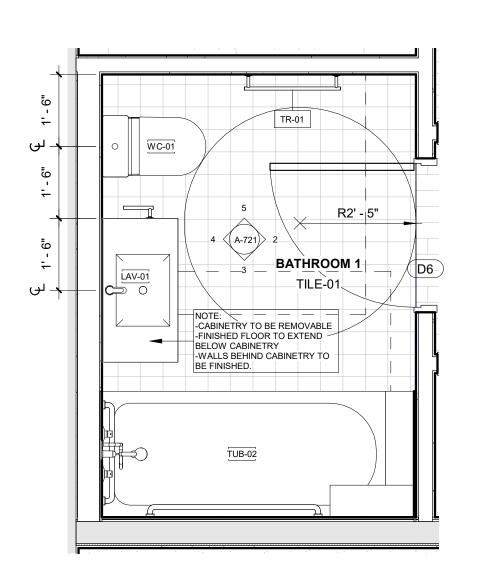

1 BATHROOM 1, UNIT B (TYPE A)
1/2" = 1'-0"

REGISTRATION



OWNER BRUSH PARK DEVELOPMENT COMPANY PHASE 1 LLC 1092 WOODWARD AVE. DETROIT, MI 48226

ARCHITECT MERGE ARCHITECTS, INC. 332 CONGRESS ST. FLOOR 6 BOSTON, MA 02210 T: 617.670.0265

STRUCTURAL ENGINEER

ENGINEERED STRUCTURES, LLC. 632 BARRY STREET SW GRANDVILLE, MI 49418 T: 616-667-9650

MP/FP ENGINEER

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CODE CONSULTANT

CODE RED CONSULTANTS 154 TURNPIKE ROAD, SUITE 200 SOUTHBOROUGH MA, 01772

ohn and Pla(0

Duplette On Edmunc Between Br Detroit MI, ⁴ Par

05/15/20: 100% CD / PERMIT SET

THE CONTRACTOR IS RESPONSIBLE FOR MATERIALS, DETAILS AND ACCURACY, FOR ALL QUANTITIES AND DIMENSIONS, FOR SELECTING FABRICATION PROCESSES, FOR TECHNIQUES OF ASSEMBLY, FOR PERFORMING WORK IN A SAFE MANNER, AND FOR COORDINATING WORK WITH THAT OF ALL TRADES

18284 JOB NO.: SCALE: 1/2" = 1'-0"

05/15/2020 DATE: DRAWING TITLE

BATHROOMS UNIT B


SHEET NO.

A-721


PLUMBING LEGEND		
Type Mark	Description	
BT-01	Bath and Shower Trim	
BT-02	Handshower Kit	
LAV-01	Sink	
LAV-01 FAUCET	Faucet	
LAV-02	Mop Service Basin	
LAV-02 FAUCET	Wall Mounted Service Sink Faucet	
SC-1	Box Roof Drainage Scupper	
SC-2	Roof Drainage Scupper	
SH-01	Provide with Linear Drain	
SK-01	Sink	
SK-01 FAUCET	Sink	
TUB-01	Tub - Regular	
TUB-02	Tub - Long	
WC-01	Toilet	

ACCE	SSORIES & EQUIPMENT LEGEND
Type Mark	Description
GB-01	Components Grab Bar
GB-02	Components Grab Bar
MAIL	Mailboxes
ROD-01	Shower Rod
ROD-02	Shelf & Heavy Duty Rod
SS-01	Choreograph Floating Shower Shelf
STO-01	Welded Wire Tenant Storage Units, 2 stacked
STO-02	Welded Wire Tenant Storage Units, 2 stacked
TP-01	Composed Pivoting Toilet Tissue Holder
TR-01	Components Towel Bar
TR-02	Components Towel Arm
TRASH	Trash Receptacle


- DIMENSIONS ARE TO FINISH FACE U.O.N.
- LAY TILES IN PATTERN DIRECTION AS INDICATED ON DRAWINGS. CENTER TILE FIELDS IN BOTH DIRECTIONS IN EACH SPACE OR ON EACH WALL AREA, U.O.N. PROVIDE UNIFORM JOINT WIDTHS, U.O.N.
- PROVIDE SOLID WOOD BLOCKING FOR AND COORDINATE LOCATIONS OF ALL ACCESSORY ITEMS INCLUDING, BUT NOT LIMITED TO: TOWEL RACKS, SHELVING, AND ROD.
- VERIFY ROUGH OPENING REQUIREMENTS AT BATHTUB AND SHOWER WITH APPROVED MANUFACTURER.
- REFER TO ENLARGED PLANS FOR ORIENTATION OF BATHROOM
- LAYOUT.

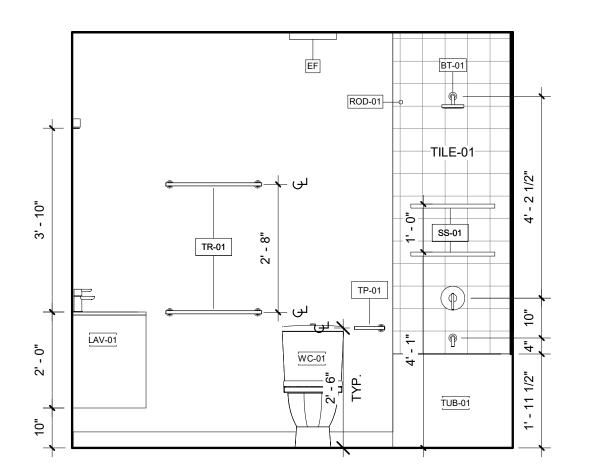




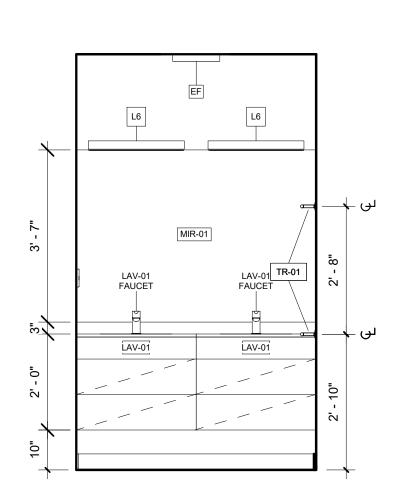


9 UNIT C, E, H BATHROOM 1 INTERIOR ELEAVTION 03
1/2" = 1'-0"

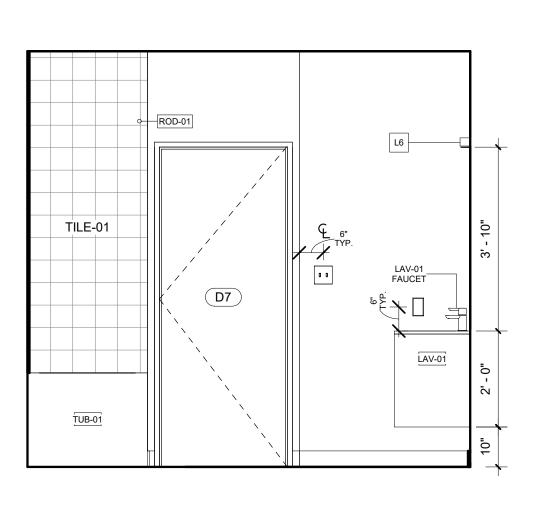

8 UNIT C, E, H BATHROOM 1 INTERIOR ELEVATION 02 1/2" = 1'-0"

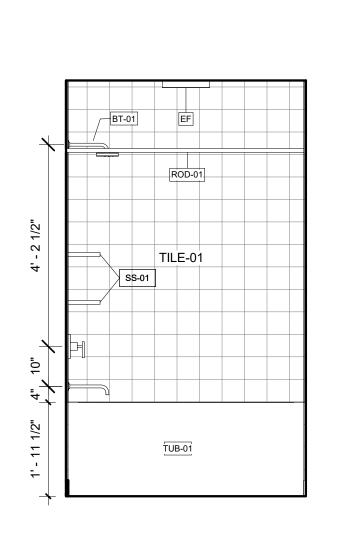


7 UNIT C, E, H BATHROOM 1 INTERIOR ELEVATION 01 1/2" = 1'-0"

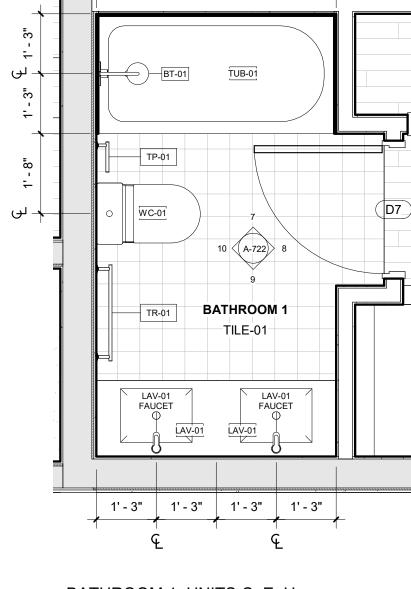


5' - 0" CLR.


6 BATHROOM 1, UNITS C, E, H
1/2" = 1'-0"

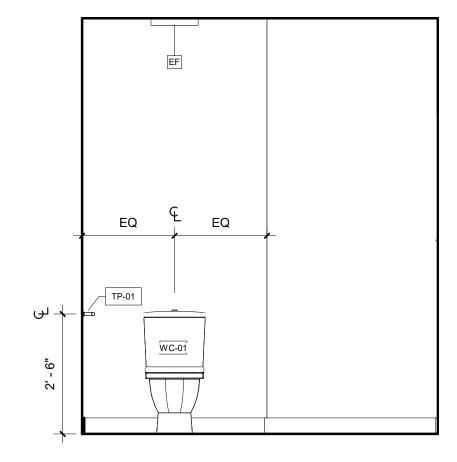


5 UNIT C BATHROOM 2 INTERIOR ELEVATION 04 1/2" = 1'-0"

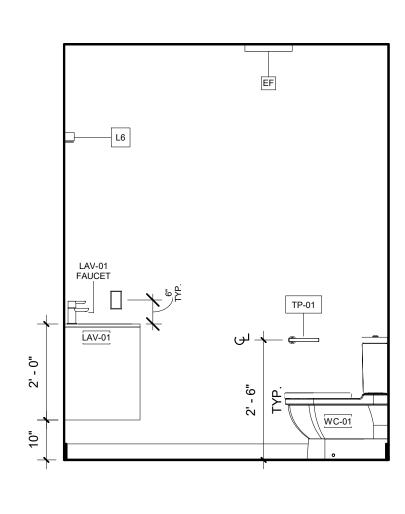


4 UNIT C BATHROOM 2 INTERIOR ELEVATION 03 1/2" = 1'-0"

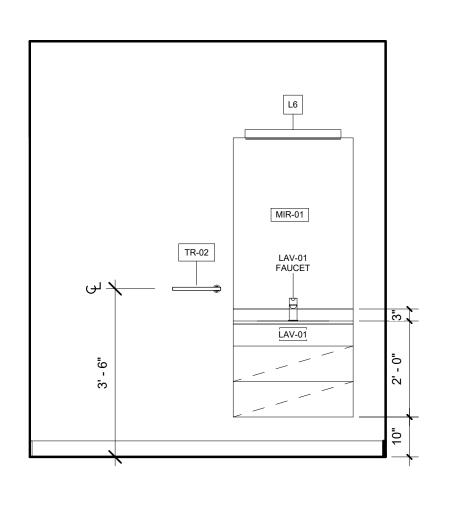

3 UNIT C BATHROOM 2 INTERIOR ELEVATION 02 1/2" = 1'-0"

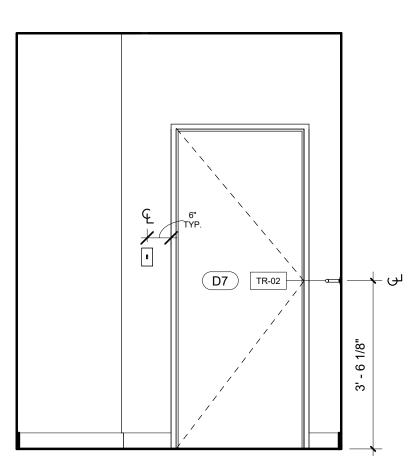

2 UNIT C BATHROOM 2 INTERIOR ELEVATION 01 1/2" = 1'-0"

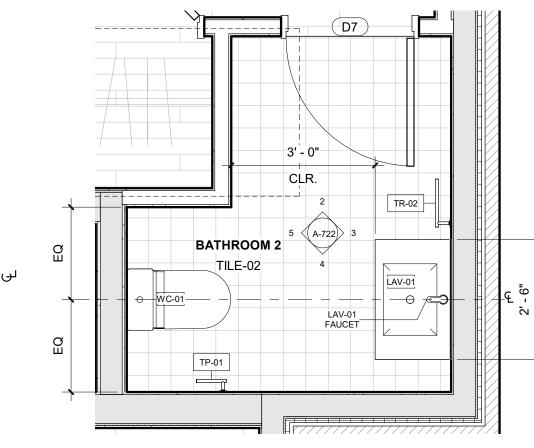

1 BATHROOM 2, UNIT C 1/2" = 1'-0"

REGISTRATION



OWNER BRUSH PARK DEVELOPMENT COMPANY PHASE 1 LLC 1092 WOODWARD AVE. DETROIT, MI 48226

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ENGINEERED STRUCTURES, LLC.

STRUCTURAL ENGINEER

632 BARRY STREET SW GRANDVILLE, MI 49418 T: 616-667-9650 **MP/FP ENGINEER**

SELLINGER ASSOCIATES, INC. 19821 FARMINGTON ROAD, LIVONIA, MI 48152 T: 248-482-0045 F: 248-482-0052 ELECTRICAL ENGINEER

ETS ENGINEERING, INC. P.O. BOX 1166 ROYAL OAK, MI 48068 418-1/2 S. WASHINGTON AVE, ROYAL OAK, MI 48067

CODE CONSULTANT

CODE RED CONSULTANTS 154 TURNPIKE ROAD, SUITE 200 SOUTHBOROUGH MA, 01772

ohn and Duplette Place ısh St. 8201 rush \$4820 0 On Edmunc Between Br Detroit MI, ⁴

05/15/20: 100% CD / PERMIT SET

THE CONTRACTOR IS RESPONSIBLE FOR MATERIALS, DETAILS AND ACCURACY, FOR ALL QUANTITIES AND DIMENSIONS, FOR SELECTING FABRICATION PROCESSES, FOR TECHNIQUES OF ASSEMBLY, FOR PERFORMING WORK IN A SAFE MANNER, AND FOR COORDINATING WORK WITH THAT OF ALL TRADES

18284 JOB NO.: SCALE: 1/2" = 1'-0" DATE: 05/15/2020

DRAWING TITLE

BATHROOMS UNITS C, E,


SHEET NO.

A-722


PLUMBING LEGEND		
Type Mark	Description	
BT-01	Bath and Shower Trim	
BT-02	Handshower Kit	
LAV-01	Sink	
LAV-01 FAUCET	Faucet	
LAV-02	Mop Service Basin	
LAV-02 FAUCET	Wall Mounted Service Sink Faucet	
SC-1	Box Roof Drainage Scupper	
SC-2	Roof Drainage Scupper	
SH-01	Provide with Linear Drain	
SK-01	Sink	
SK-01 FAUCET	Sink	
TUB-01	Tub - Regular	
TUB-02	Tub - Long	
WC-01	Toilet	

ACCE	SSORIES & EQUIPMENT LEGEND
Type Mark	Description
GB-01	Components Grab Bar
GB-02	Components Grab Bar
MAIL	Mailboxes
ROD-01	Shower Rod
ROD-02	Shelf & Heavy Duty Rod
SS-01	Choreograph Floating Shower Shelf
STO-01	Welded Wire Tenant Storage Units, 2 stacked
STO-02	Welded Wire Tenant Storage Units, 2 stacked
TP-01	Composed Pivoting Toilet Tissue Holder
TR-01	Components Towel Bar
TR-02	Components Towel Arm
TRASH	Trash Receptacle


- DIMENSIONS ARE TO FINISH FACE U.O.N.
- LAY TILES IN PATTERN DIRECTION AS INDICATED ON DRAWINGS. CENTER TILE FIELDS IN BOTH DIRECTIONS IN EACH SPACE OR ON
- EACH WALL AREA, U.O.N. PROVIDE UNIFORM JOINT WIDTHS, U.O.N. PROVIDE SOLID WOOD BLOCKING FOR AND COORDINATE LOCATIONS OF ALL ACCESSORY ITEMS INCLUDING, BUT NOT LIMITED TO: TOWEL RACKS, SHELVING, AND ROD.
- VERIFY ROUGH OPENING REQUIREMENTS AT BATHTUB AND SHOWER WITH APPROVED MANUFACTURER.
- REFER TO ENLARGED PLANS FOR ORIENTATION OF BATHROOM LAYOUT.

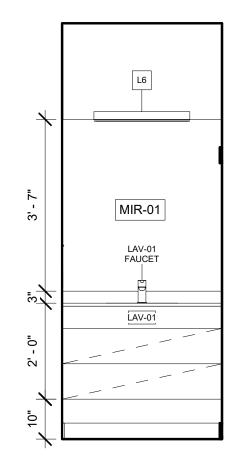


UNITS D, E, G, H, I BATHROOM 2 INTERIOR 10 ELEVATION 04 1/2" = 1'-0"

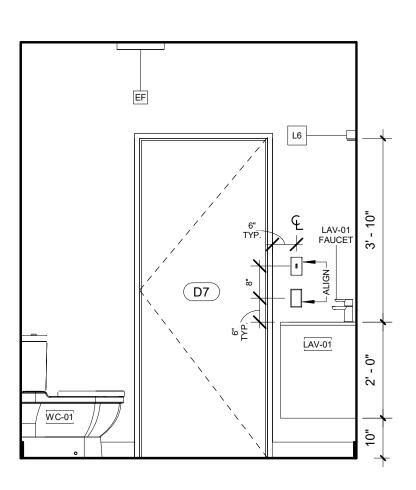


UNITS D, E, G, H, I BATHROOM 2 INTERIOR 9 ELEVATION 03 1/2" = 1'-0"

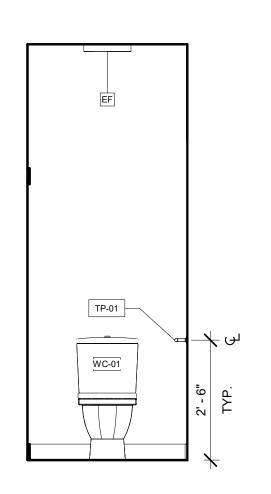


UNITS D, E, G, H, I BATHROOM 2 INTERIOR 8 ELEVATION 02 1/2" = 1'-0"

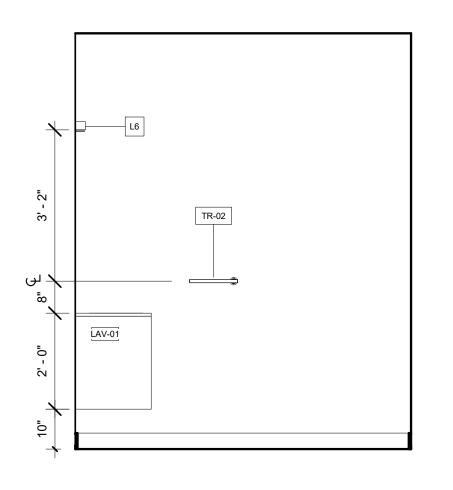



UNITS D, E, G, H, I BATHROOM 2 INTERIOR 7 ELEVATION 01 1/2" = 1'-0"

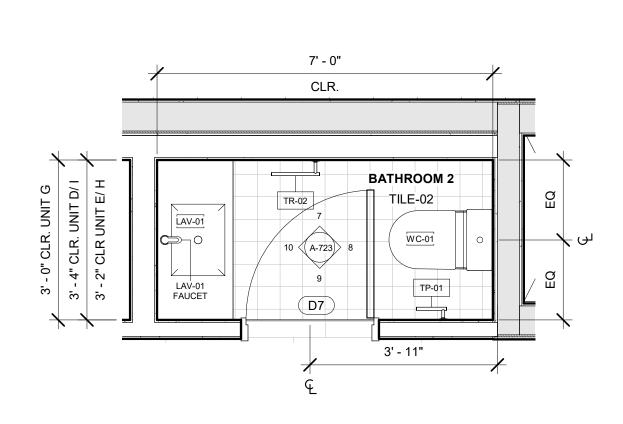



6 BATHROOM 2, UNITS D, E, G, H, I
1/2" = 1'-0"

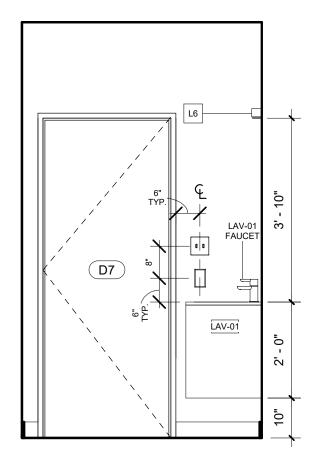

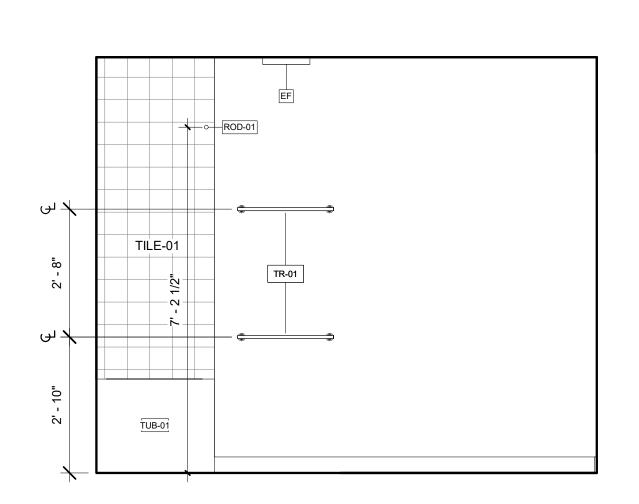

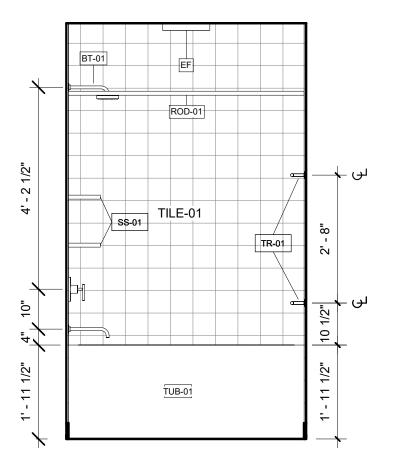

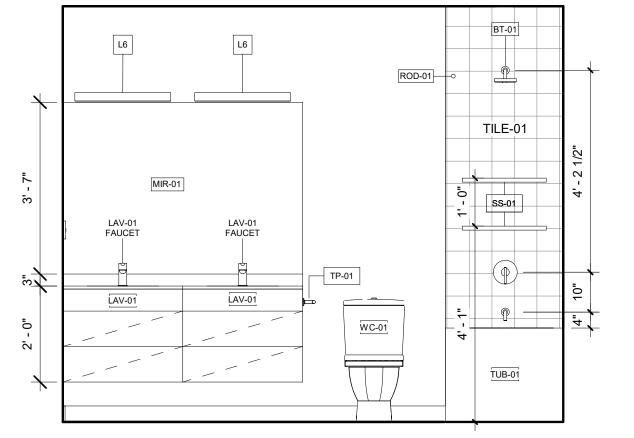

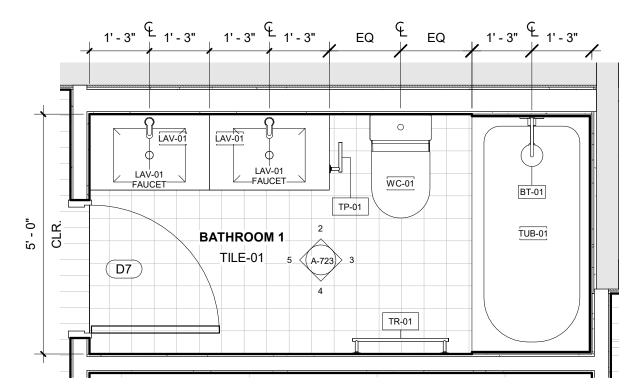

5 UNIT D BATHROOM 1 INTERIOR ELEVATION 04 1/2" = 1'-0"

4 UNIT D BATHROOM 1 INTERIOR ELEVATION 03
1/2" = 1'-0"

3 UNIT D BATHROOM 1 INTERIOR ELEVATION 02 1/2" = 1'-0"

2 UNIT D BATHROOM 1 INTERIOR ELEVATION 01
1/2" = 1'-0"

1 BATHROOM 1, UNIT D 1/2" = 1'-0"

REGISTRATION



OWNER BRUSH PARK DEVELOPMENT COMPANY PHASE 1 LLC 1092 WOODWARD AVE. DETROIT, MI 48226

ARCHITECT MERGE ARCHITECTS, INC. 332 CONGRESS ST. FLOOR 6 BOSTON, MA 02210 T: 617.670.0265

ENGINEERED STRUCTURES, LLC.

STRUCTURAL ENGINEER

632 BARRY STREET SW GRANDVILLE, MI 49418 T: 616-667-9650 MP/FP ENGINEER

SELLINGER ASSOCIATES, INC. 19821 FARMINGTON ROAD, LIVONIA, MI 48152 T: 248-482-0045 F: 248-482-0052

ELECTRICAL ENGINEER ETS ENGINEERING, INC. P.O. BOX 1166 ROYAL OAK, MI 48068 418-1/2 S. WASHINGTON AVE, ROYAL OAK, MI 48067

CODE CONSULTANT

CODE RED CONSULTANTS 154 TURNPIKE ROAD, SUITE 200 SOUTHBOROUGH MA, 01772

ohn and **Duplette** Place ısh St. 8201 p On Edmunc Between Br Detroit MI, ⁴ Par

05/15/20: 100% CD / PERMIT SET

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18284 JOB NO.: SCALE: 1/2" = 1'-0" 05/15/2020

DATE: DRAWING TITLE

BATHROOMS, UNITS D, E, G, H, I


SHEET NO.


A-723


PLUMBING LEGEND		
Type Mark	Description	
BT-01	Bath and Shower Trim	
BT-02	Handshower Kit	
LAV-01	Sink	
LAV-01 FAUCET	Faucet	
LAV-02	Mop Service Basin	
LAV-02 FAUCET	Wall Mounted Service Sink Faucet	
SC-1	Box Roof Drainage Scupper	
SC-2	Roof Drainage Scupper	
SH-01	Provide with Linear Drain	
SK-01	Sink	
SK-01 FAUCET	Sink	
TUB-01	Tub - Regular	
TUB-02	Tub - Long	
WC-01	Toilet	


ACCE	SSORIES & EQUIPMENT LEGEND
Type Mark	Description
GB-01	Components Grab Bar
GB-02	Components Grab Bar
MAIL	Mailboxes
ROD-01	Shower Rod
ROD-02	Shelf & Heavy Duty Rod
SS-01	Choreograph Floating Shower Shelf
STO-01	Welded Wire Tenant Storage Units, 2 stacked
STO-02	Welded Wire Tenant Storage Units, 2 stacked
TP-01	Composed Pivoting Toilet Tissue Holder
TR-01	Components Towel Bar
TR-02	Components Towel Arm
TRASH	Trash Receptacle


- DIMENSIONS ARE TO FINISH FACE U.O.N.
- LAY TILES IN PATTERN DIRECTION AS INDICATED ON DRAWINGS. CENTER TILE FIELDS IN BOTH DIRECTIONS IN EACH SPACE OR ON EACH WALL AREA, U.O.N. PROVIDE UNIFORM JOINT WIDTHS, U.O.N.
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- REFER TO ENLARGED PLANS FOR ORIENTATION OF BATHROOM
- LAYOUT.

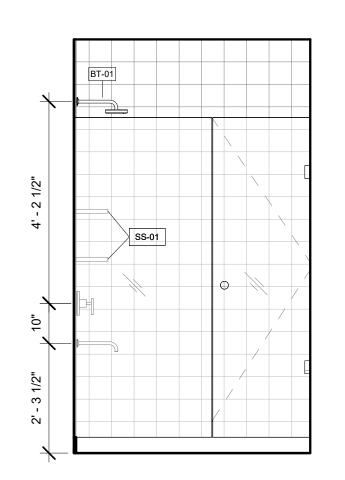

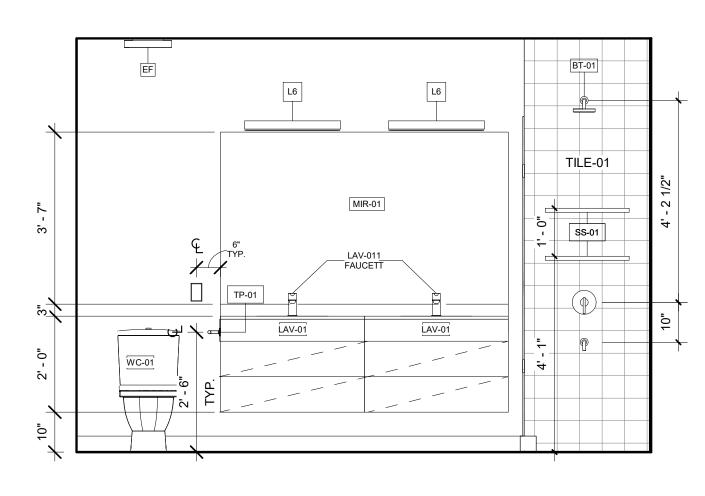

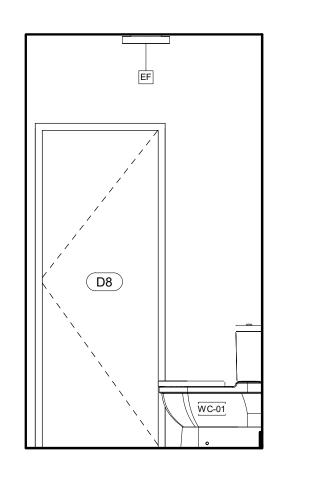

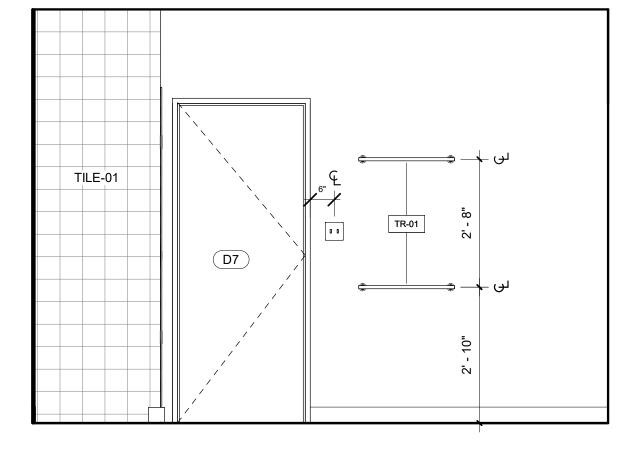

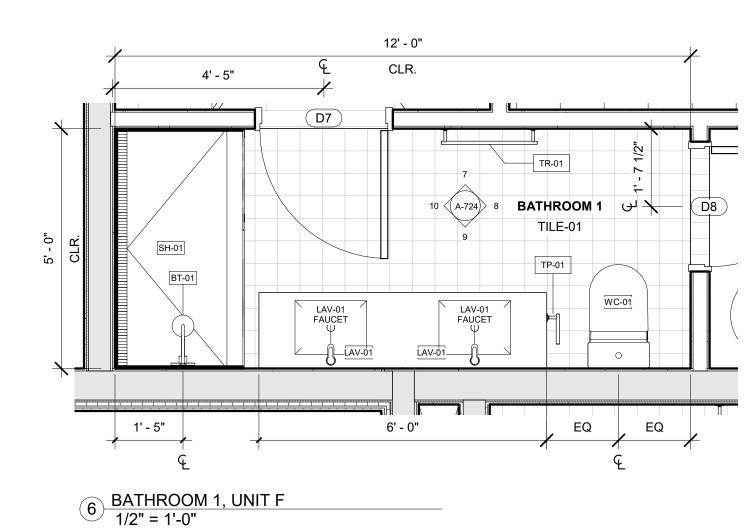



10 UNIT F BATHROOM 1 INTERIOR ELEVATION 04 1/2" = 1'-0"


9 UNIT F BATHROOM 1 INTERIOR ELEVATION 03
1/2" = 1'-0"


8 UNIT F BATHROOM 1 INTERIOR ELEVATION 02 1/2" = 1'-0"


7 UNIT F BATHROOM 1 INTERIOR ELEVATION 01 1/2" = 1'-0"

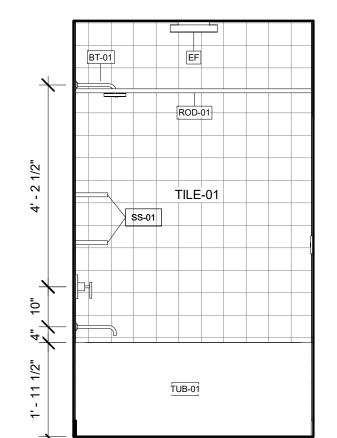

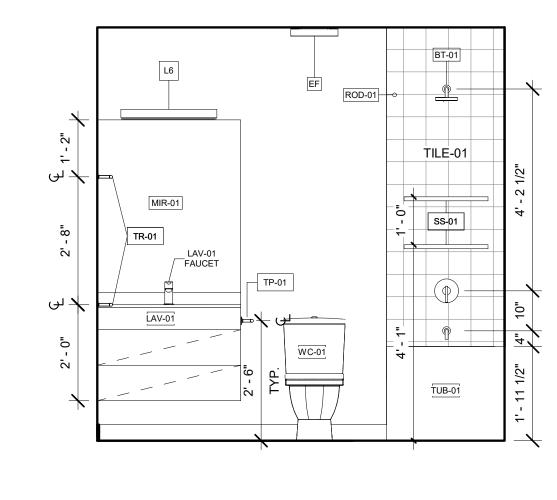

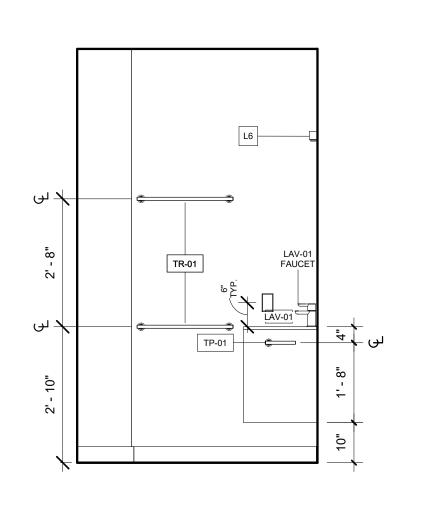

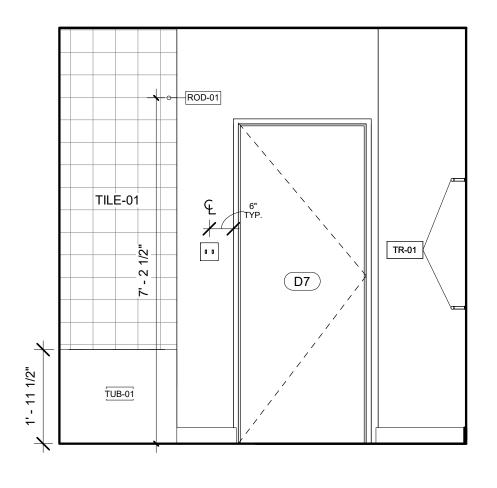

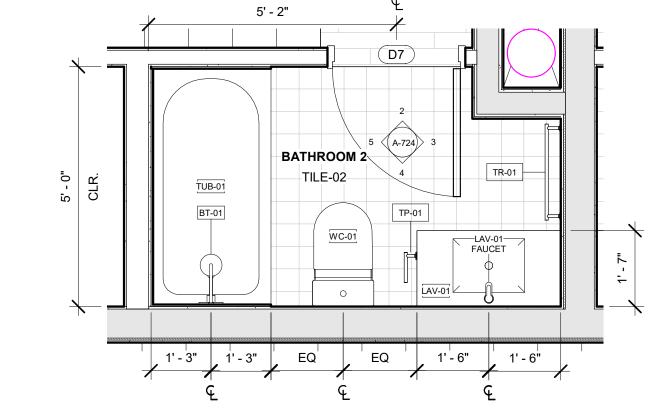

5 UNIT F BATHROOM 2 INTERIOR ELEVATION 04 1/2" = 1'-0"

4 UNIT F BATHROOM 2 INTERIOR ELEVATION 03
1/2" = 1'-0"

3 UNIT F BATHROOM 2 INTERIOR ELEVATION 02 1/2" = 1'-0"

2 UNIT F BATHROOM 2 INTERIOR ELEVATION 01 1/2" = 1'-0"

1 BATHROOM 2, UNIT F 1/2" = 1'-0"

REGISTRATION



OWNER BRUSH PARK DEVELOPMENT COMPANY PHASE 1 LLC 1092 WOODWARD AVE. DETROIT, MI 48226

ARCHITECT

MERGE ARCHITECTS, INC. 332 CONGRESS ST. FLOOR 6 BOSTON, MA 02210 T: 617.670.0265

STRUCTURAL ENGINEER ENGINEERED STRUCTURES, LLC.

632 BARRY STREET SW GRANDVILLE, MI 49418 T: 616-667-9650 **MP/FP ENGINEER**

SELLINGER ASSOCIATES, INC. 19821 FARMINGTON ROAD, LIVONIA, MI 48152 T: 248-482-0045 F: 248-482-0052

ELECTRICAL ENGINEER ETS ENGINEERING, INC.

P.O. BOX 1166 ROYAL OAK, MI 48068 418-1/2 S. WASHINGTON AVE, ROYAL OAK, MI 48067

CODE CONSULTANT

CODE RED CONSULTANTS 154 TURNPIKE ROAD, SUITE 200 SOUTHBOROUGH MA, 01772

John and **Duplette** Place ısh St. 8201 0 On Edmunc Between Br Detroit MI, ⁴ Par

05/15/20: 100% CD / PERMIT SET

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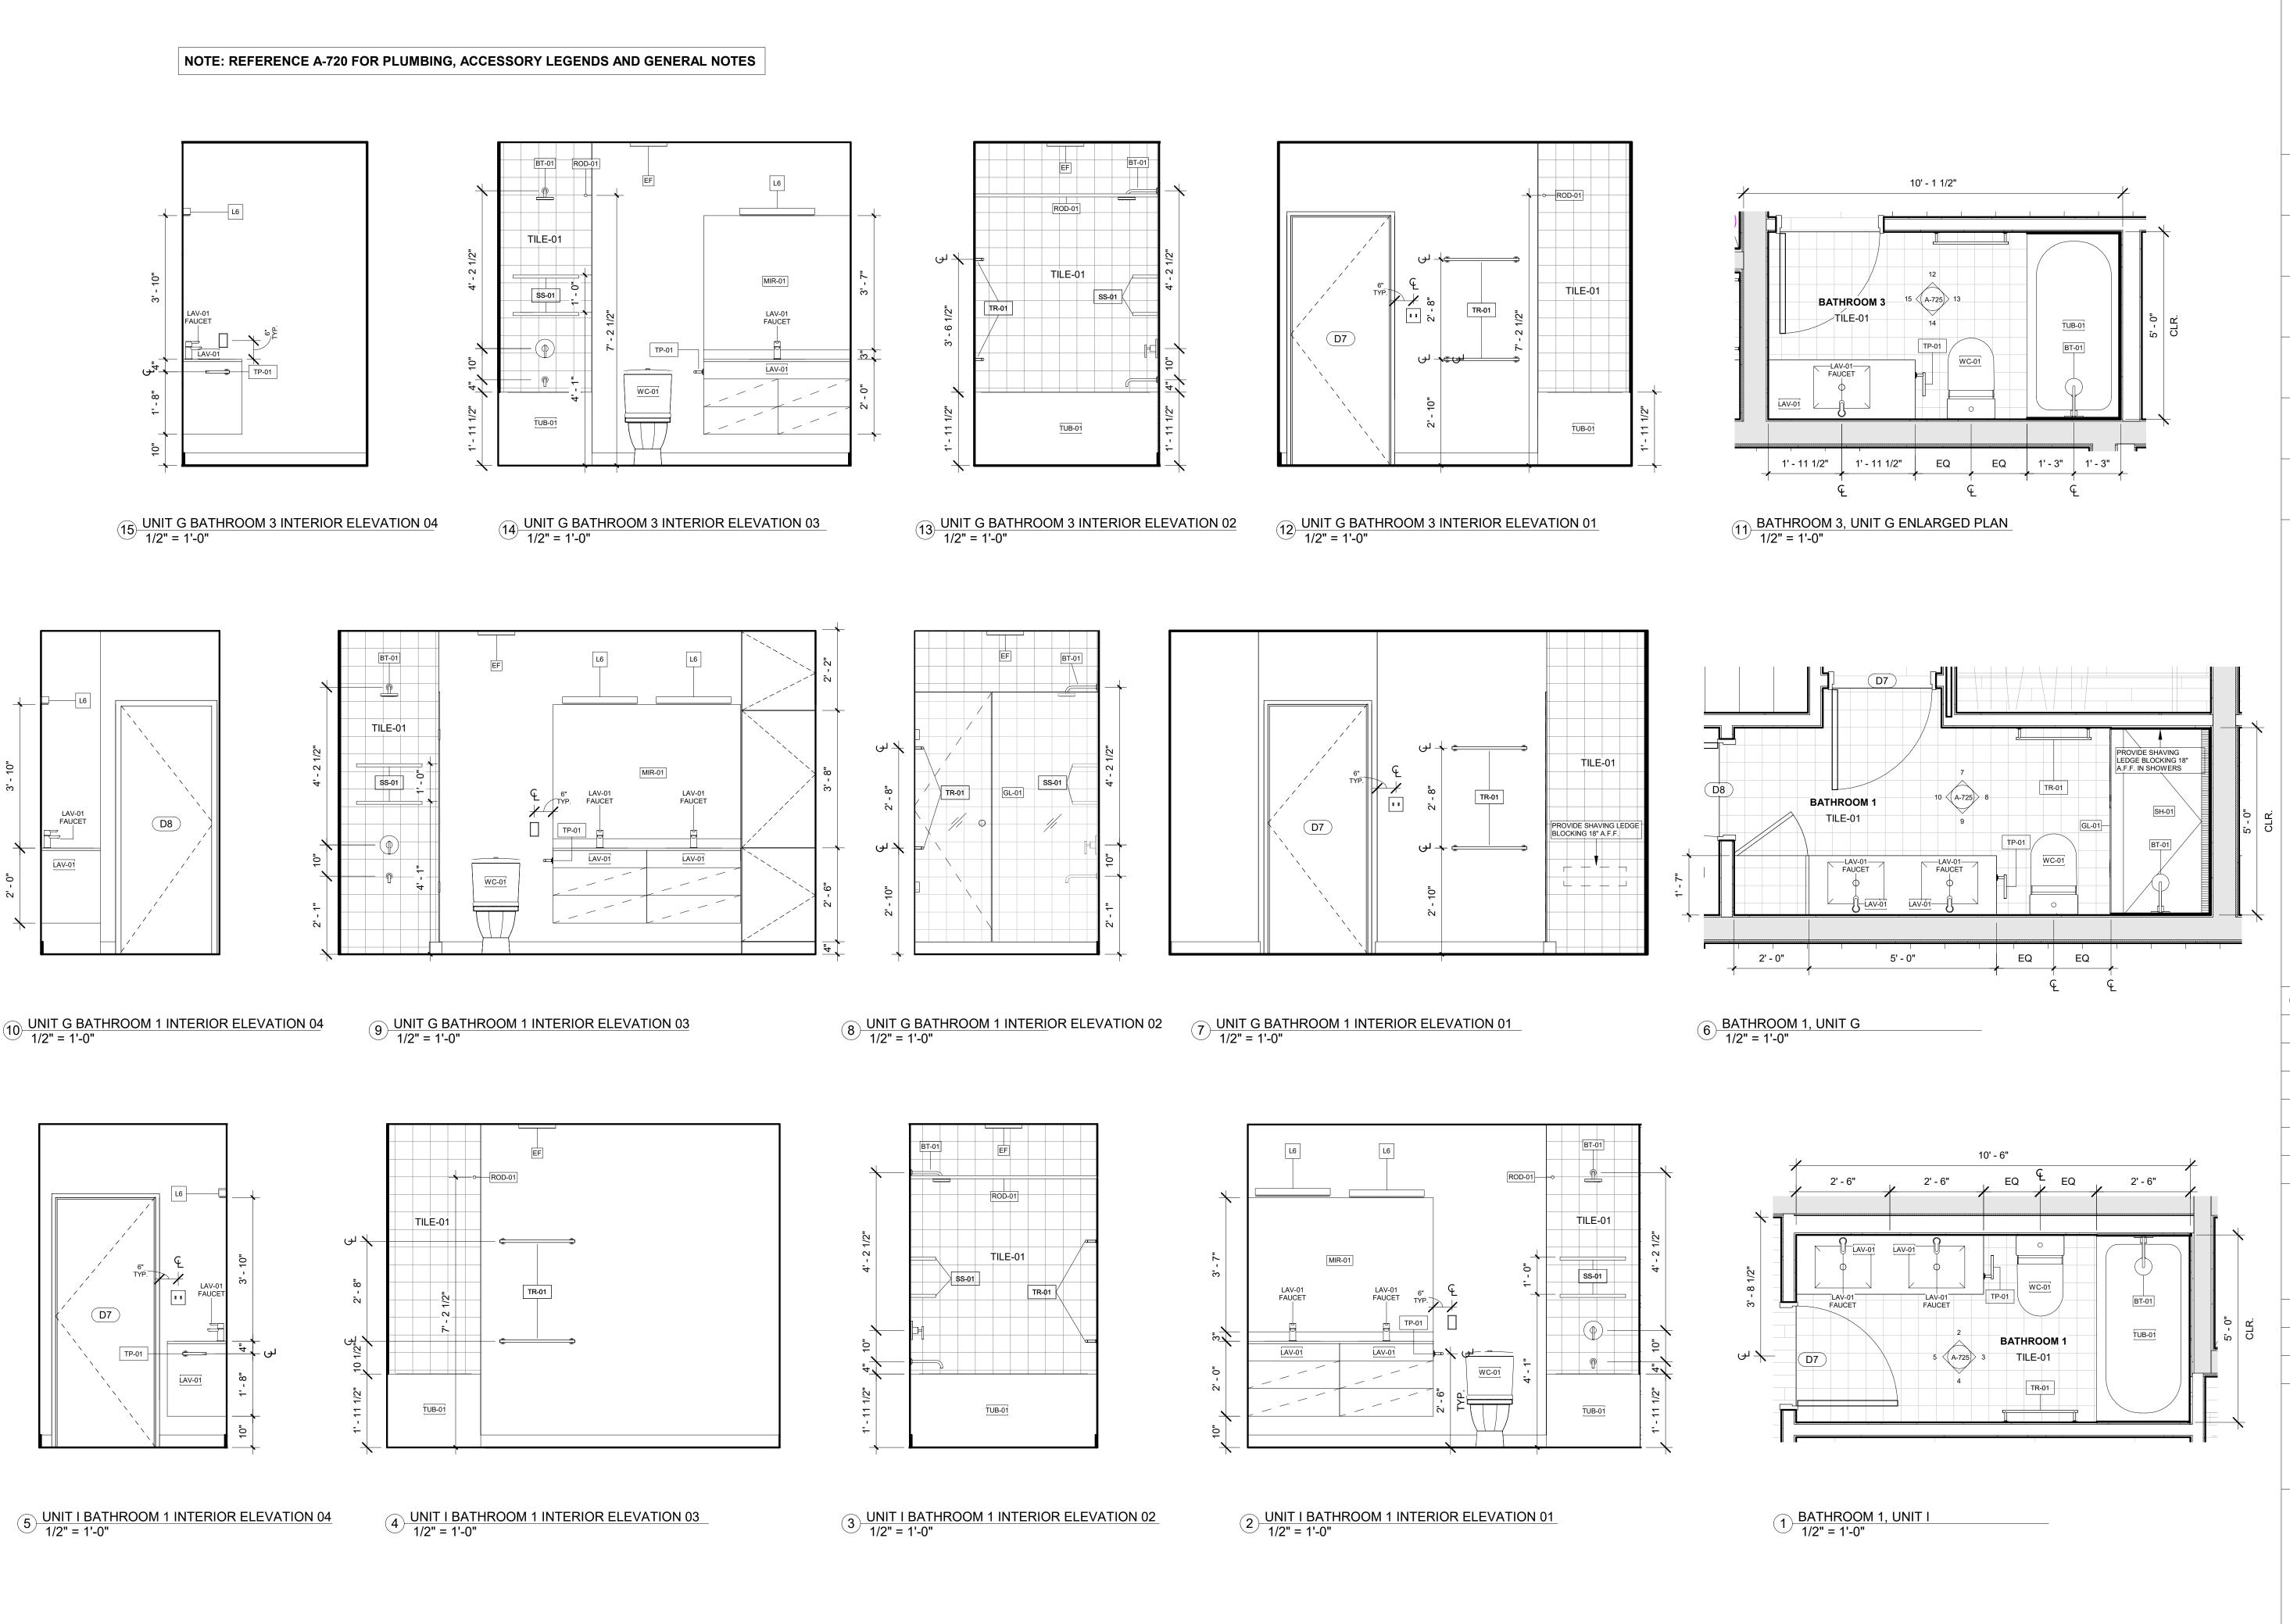
WORK WITH THAT OF ALL TRADE	
JOB NO.:	18284
SCALE:	1/2" = 1'-0"

05/15/2020 DRAWING TITLE

BATHROOMS, UNIT F

SHEET NO.

A-724





OWNER BRUSH PARK DEVELOPMENT COMPANY PHASE 1 LLC 1092 WOODWARD AVE. DETROIT, MI 48226

ARCHITECT

MERGE ARCHITECTS, INC. 332 CONGRESS ST. FLOOR 6 BOSTON, MA 02210 T: 617.670.0265

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ELECTRICAL ENGINEER

P.O. BOX 1166 ROYAL OAK, MI 48068 418-1/2 S. WASHINGTON AVE, ROYAL OAK, MI 48067

CODE CONSULTANT

CODE RED CONSULTANTS 154 TURNPIKE ROAD, SUITE 200 SOUTHBOROUGH MA, 01772

John and **Duplette** On Edmund Place Between Brush St. Detroit MI, 48201

05/15/20: 100% CD / PERMIT SET

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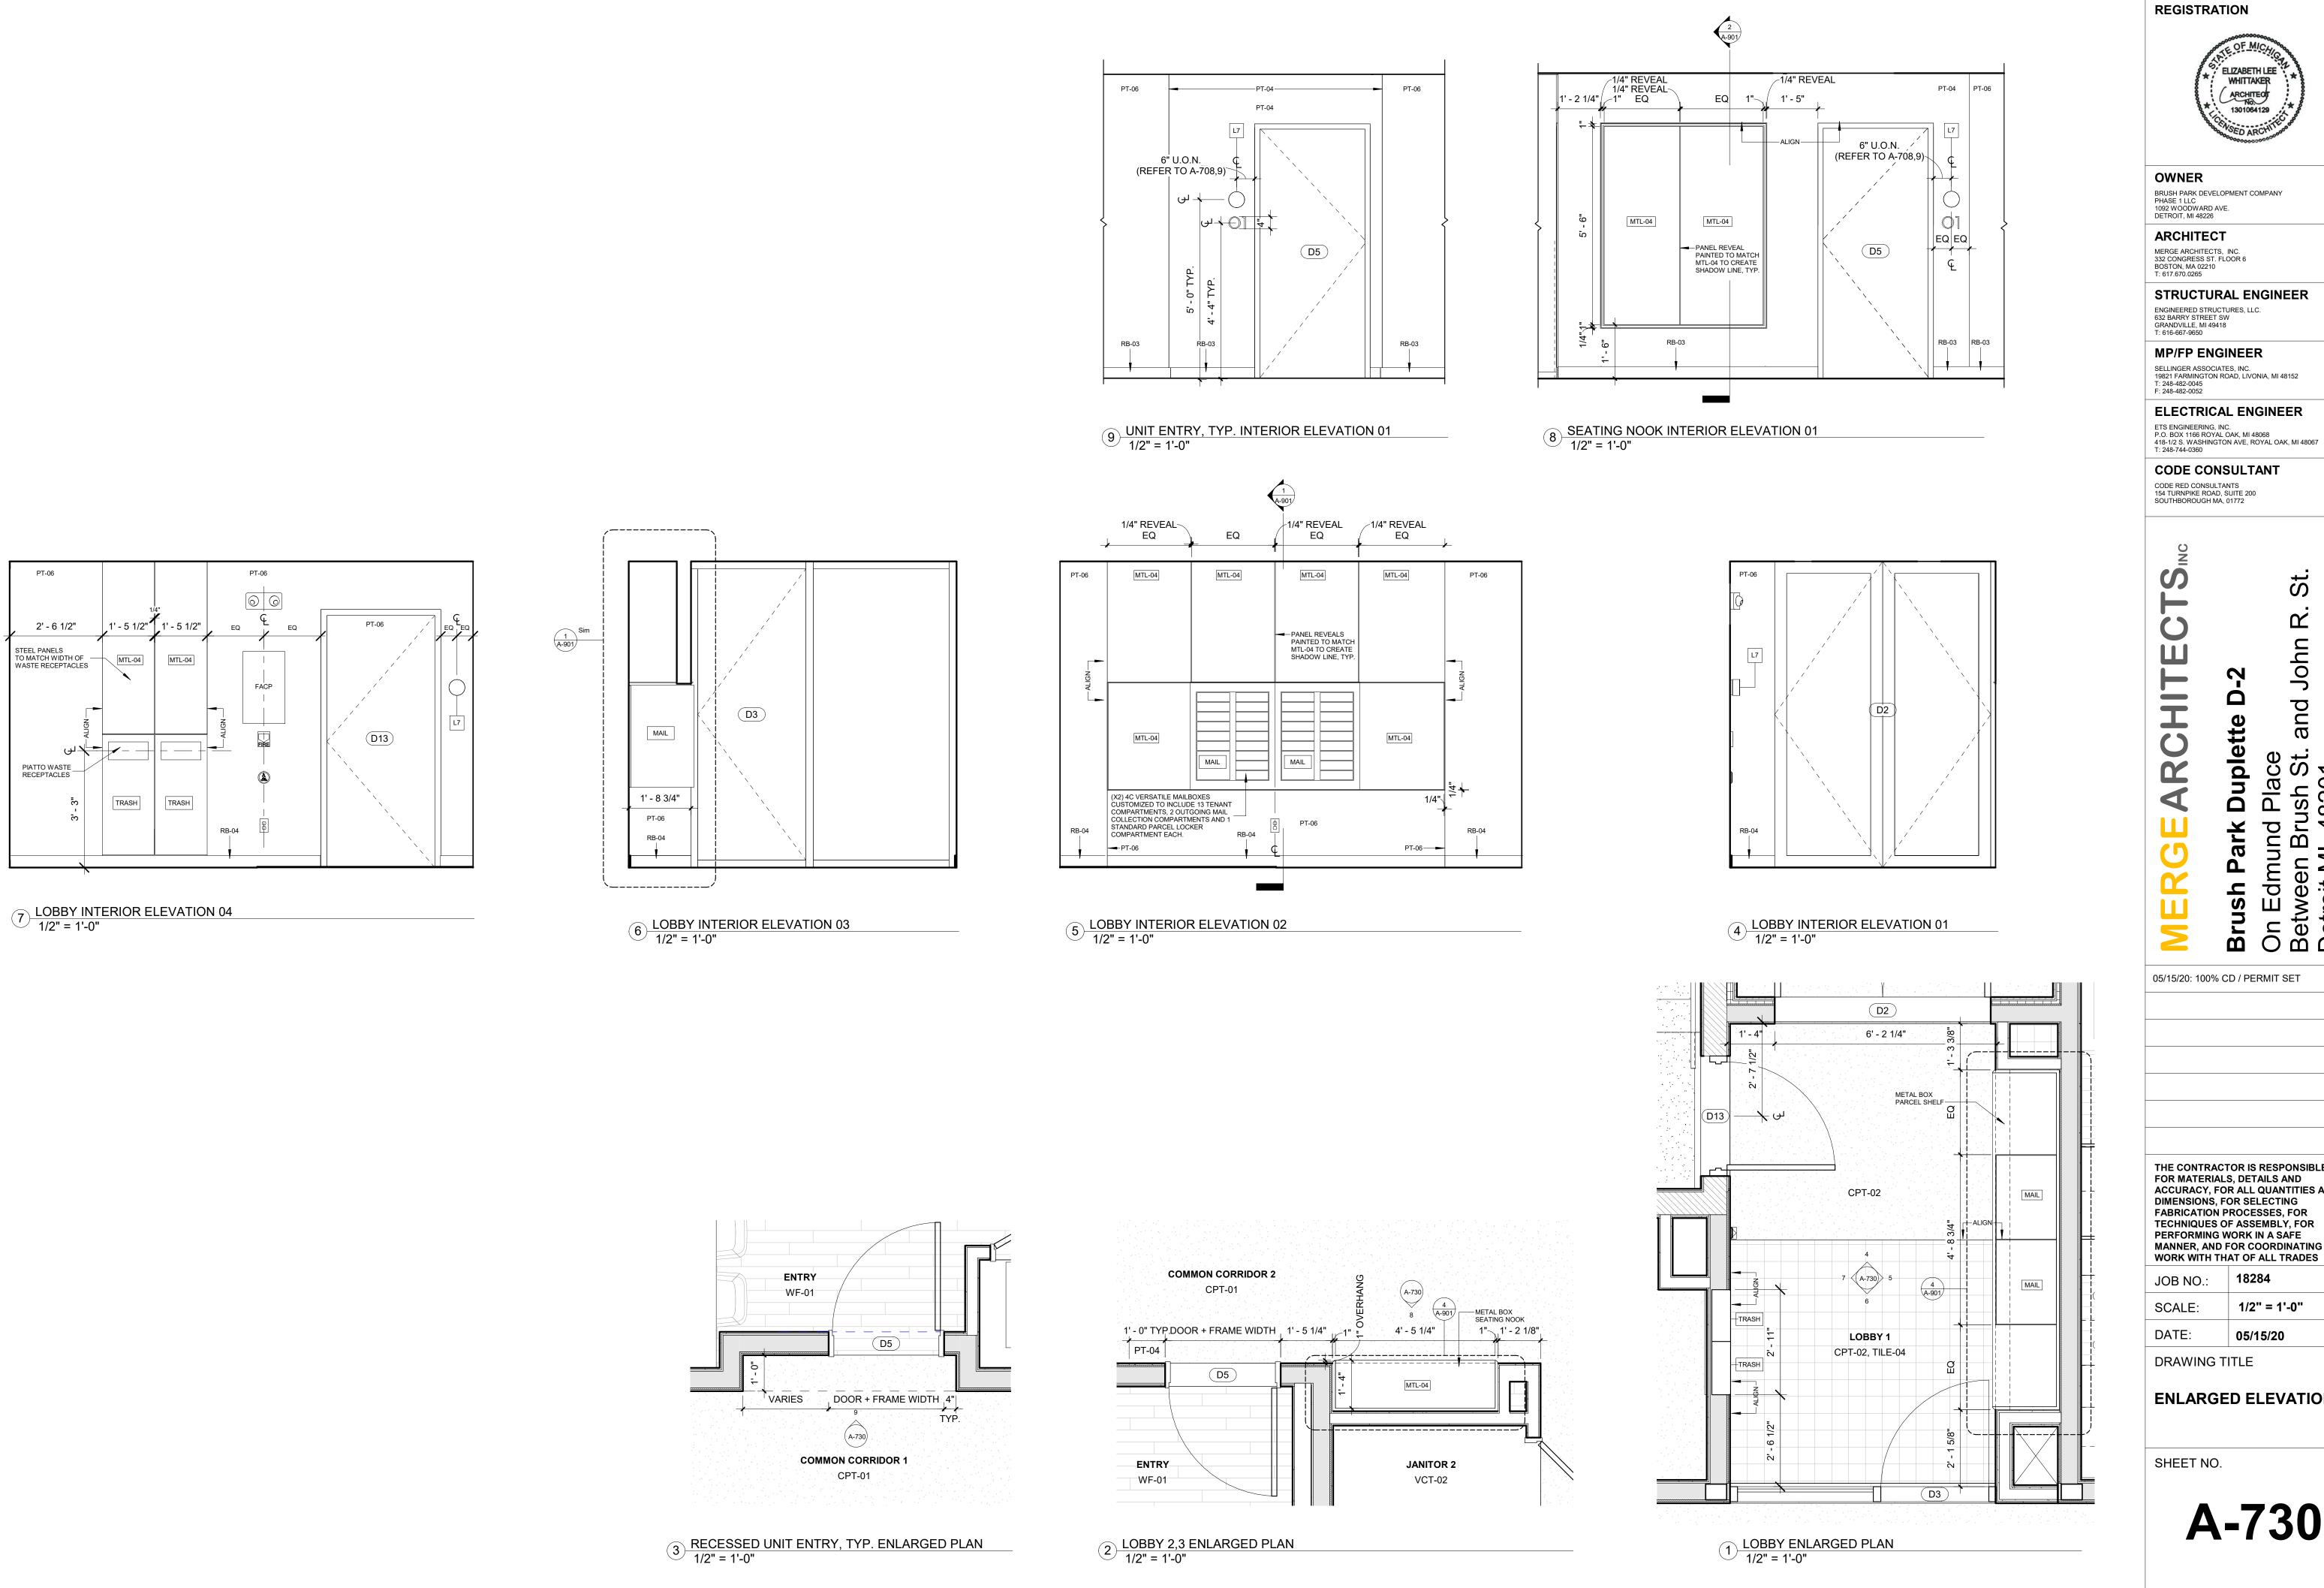
18284 1/2" = 1'-0" 02/07/20 DATE:

DRAWING TITLE

BATHROOMS, UNIT G, I

SHEET NO.

A-725





OWNER BRUSH PARK DEVELOPMENT COMPANY PHASE 1 LLC 1092 WOODWARD AVE. DETROIT, MI 48226

ARCHITECT MERGE ARCHITECTS, INC. 332 CONGRESS ST. FLOOR 6 BOSTON, MA 02210 T: 617.670.0265

STRUCTURAL ENGINEER ENGINEERED STRUCTURES, LLC.

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ELECTRICAL ENGINEER

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CODE CONSULTANT

CODE RED CONSULTANTS 154 TURNPIKE ROAD, SUITE 200 SOUTHBOROUGH MA, 01772

ohn and Duplette d Place srush St. 48201 Park р On Edmunc Between Br Detroit MI, ⁴ Brush

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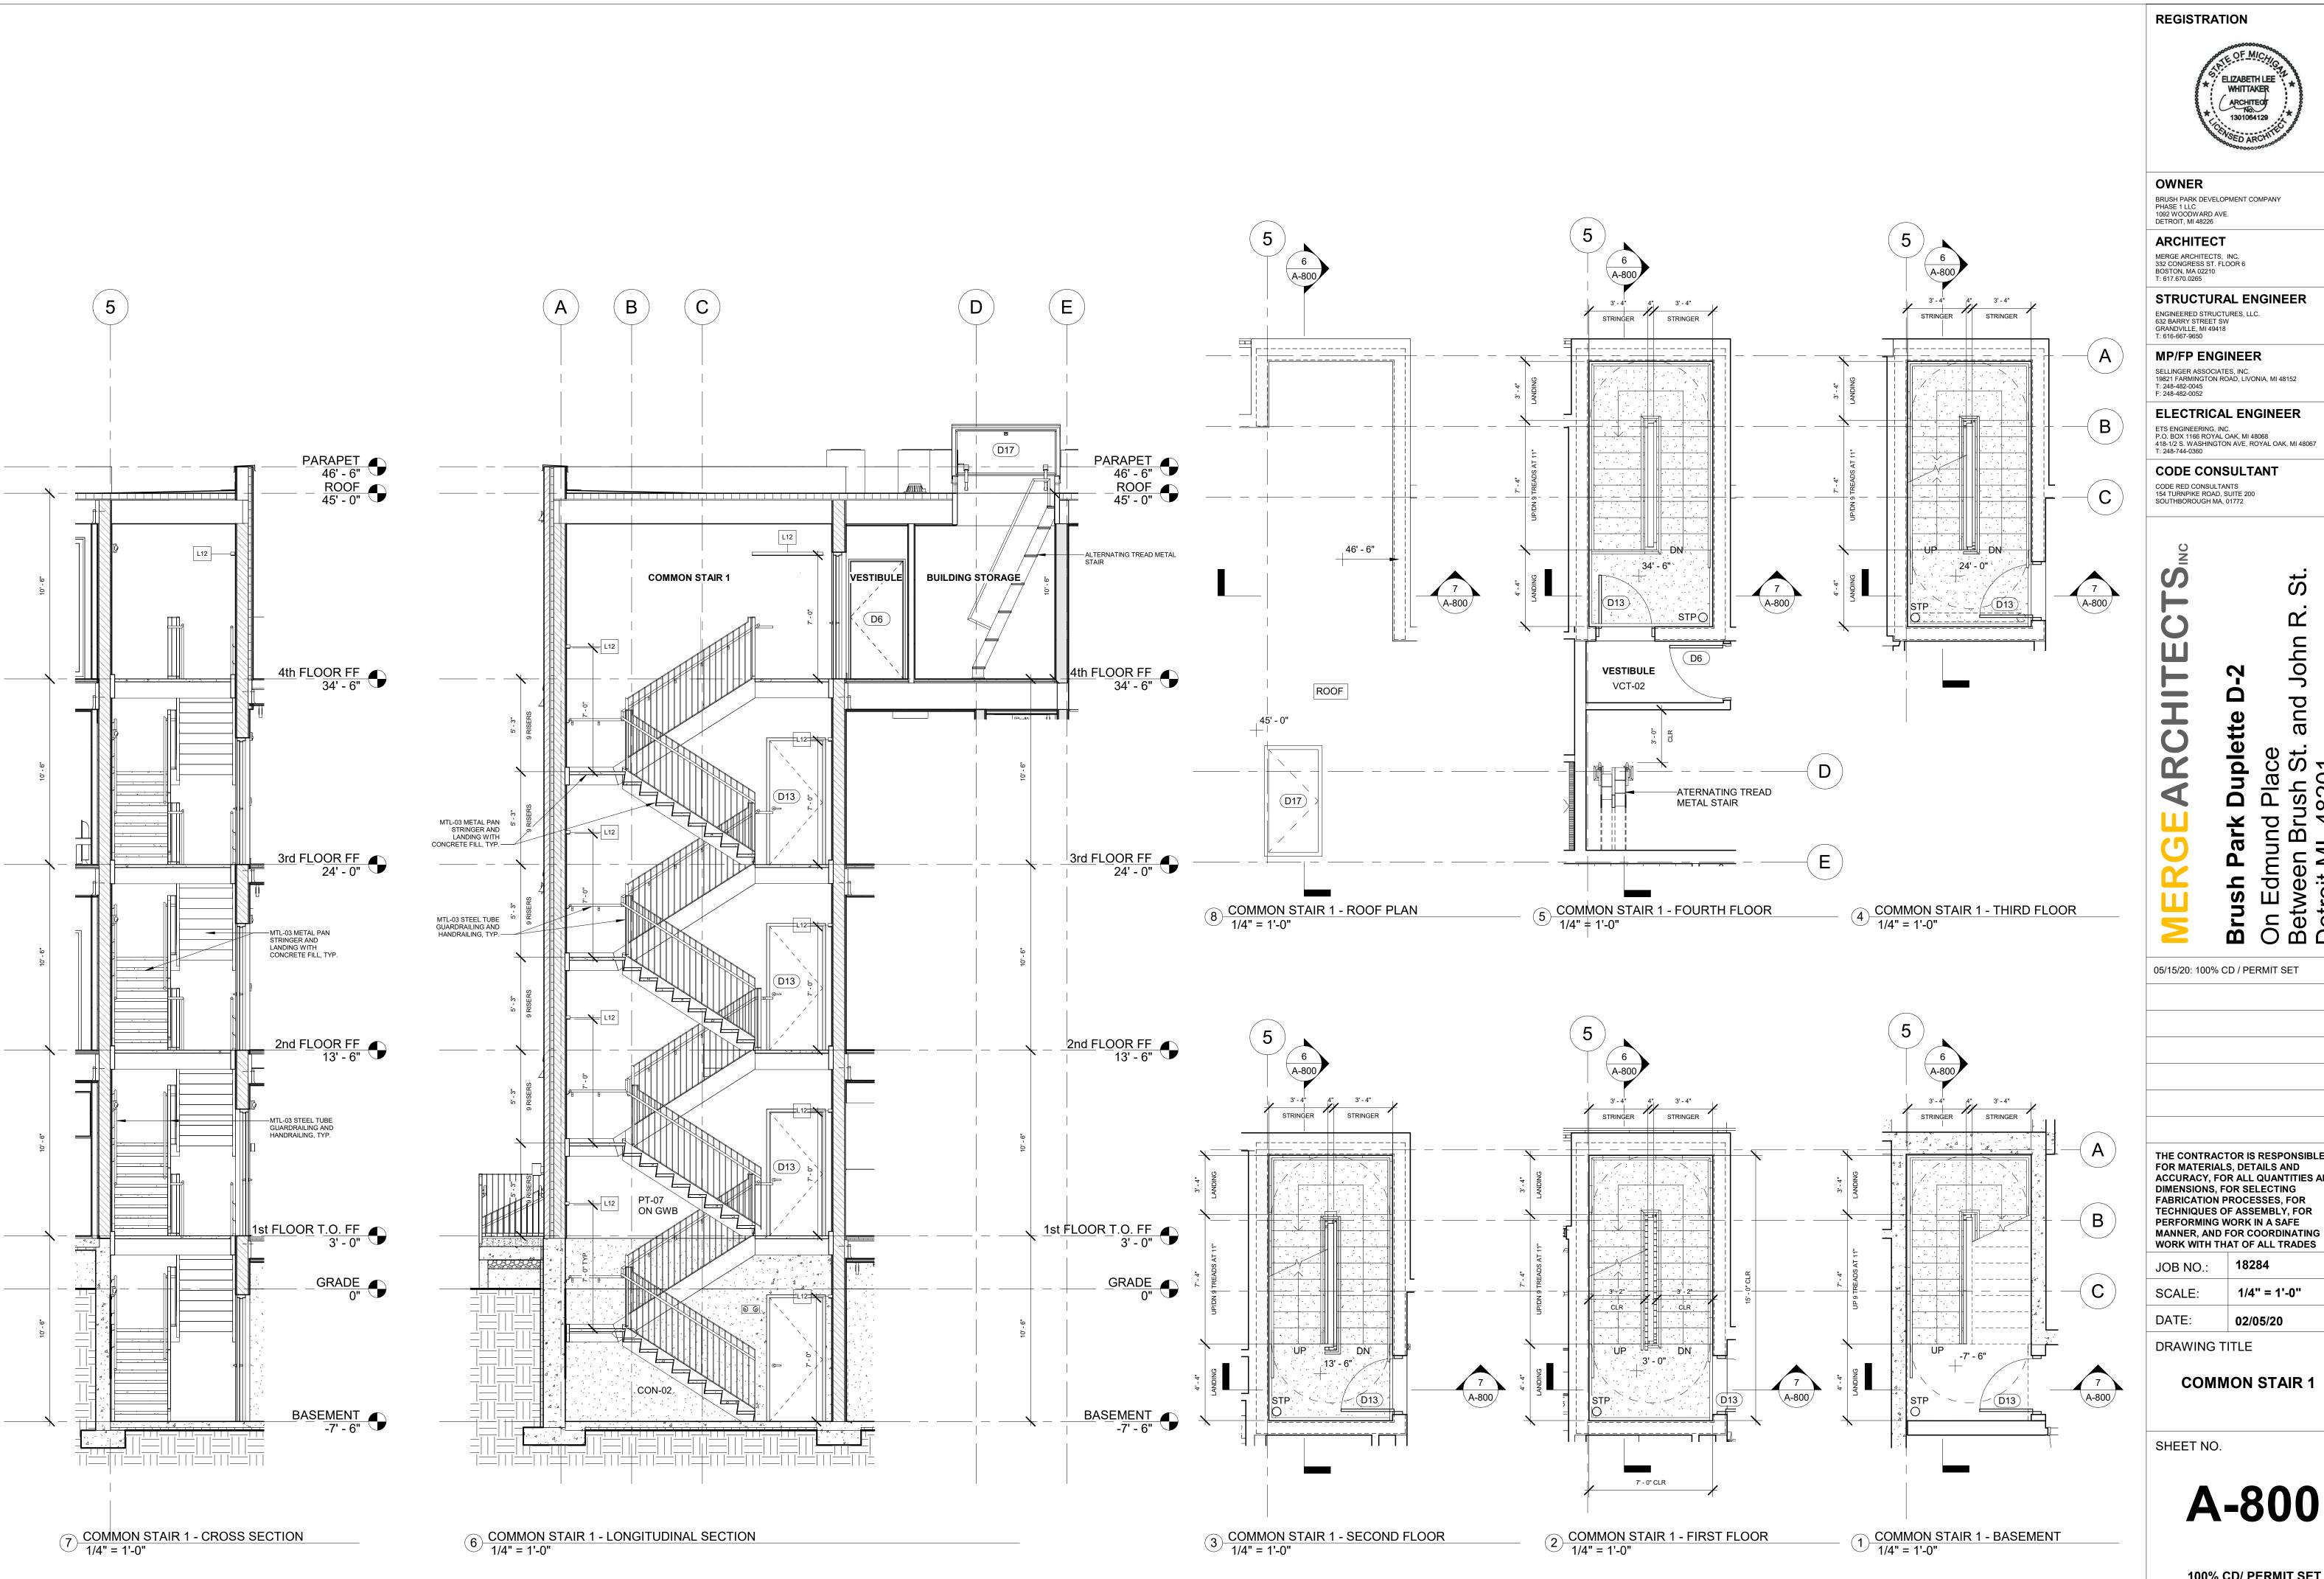
18284 JOB NO.: SCALE: 1/2" = 1'-0" DATE: 05/15/20

DRAWING TITLE

ENLARGED ELEVATIONS

SHEET NO.

A-730





BRUSH PARK DEVELOPMENT COMPANY PHASE 1 LLC 1092 WOODWARD AVE. DETROIT, MI 48226

ARCHITECT MERGE ARCHITECTS, INC. 332 CONGRESS ST. FLOOR 6 BOSTON, MA 02210 T: 617.670.0265

STRUCTURAL ENGINEER

ENGINEERED STRUCTURES, LLC. 632 BARRY STREET SW GRANDVILLE, MI 49418 T: 616-667-9650

MP/FP ENGINEER

SELLINGER ASSOCIATES, INC. 19821 FARMINGTON ROAD, LIVONIA, MI 48152 T: 248-482-0045 F: 248-482-0052

ELECTRICAL ENGINEER ETS ENGINEERING, INC. P.O. BOX 1166 ROYAL OAK, MI 48068 418-1/2 S. WASHINGTON AVE, ROYAL OAK, MI 48067

CODE RED CONSULTANTS 154 TURNPIKE ROAD, SUITE 200 SOUTHBOROUGH MA, 01772

CODE CONSULTANT

John and **Duplette** On Edmund Place Between Brush St. & Detroit MI, 48201 Park Brush

05/15/20: 100% CD / PERMIT SET


THE CONTRACTOR IS RESPONSIBLE
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TECHNIQUES OF ASSEMBLY, FOR
PERFORMING WORK IN A SAFE
MANNER, AND FOR COORDINATING

18284 JOB NO.: SCALE: 1/4" = 1'-0" 02/05/20

DRAWING TITLE

COMMON STAIR 1

A-800

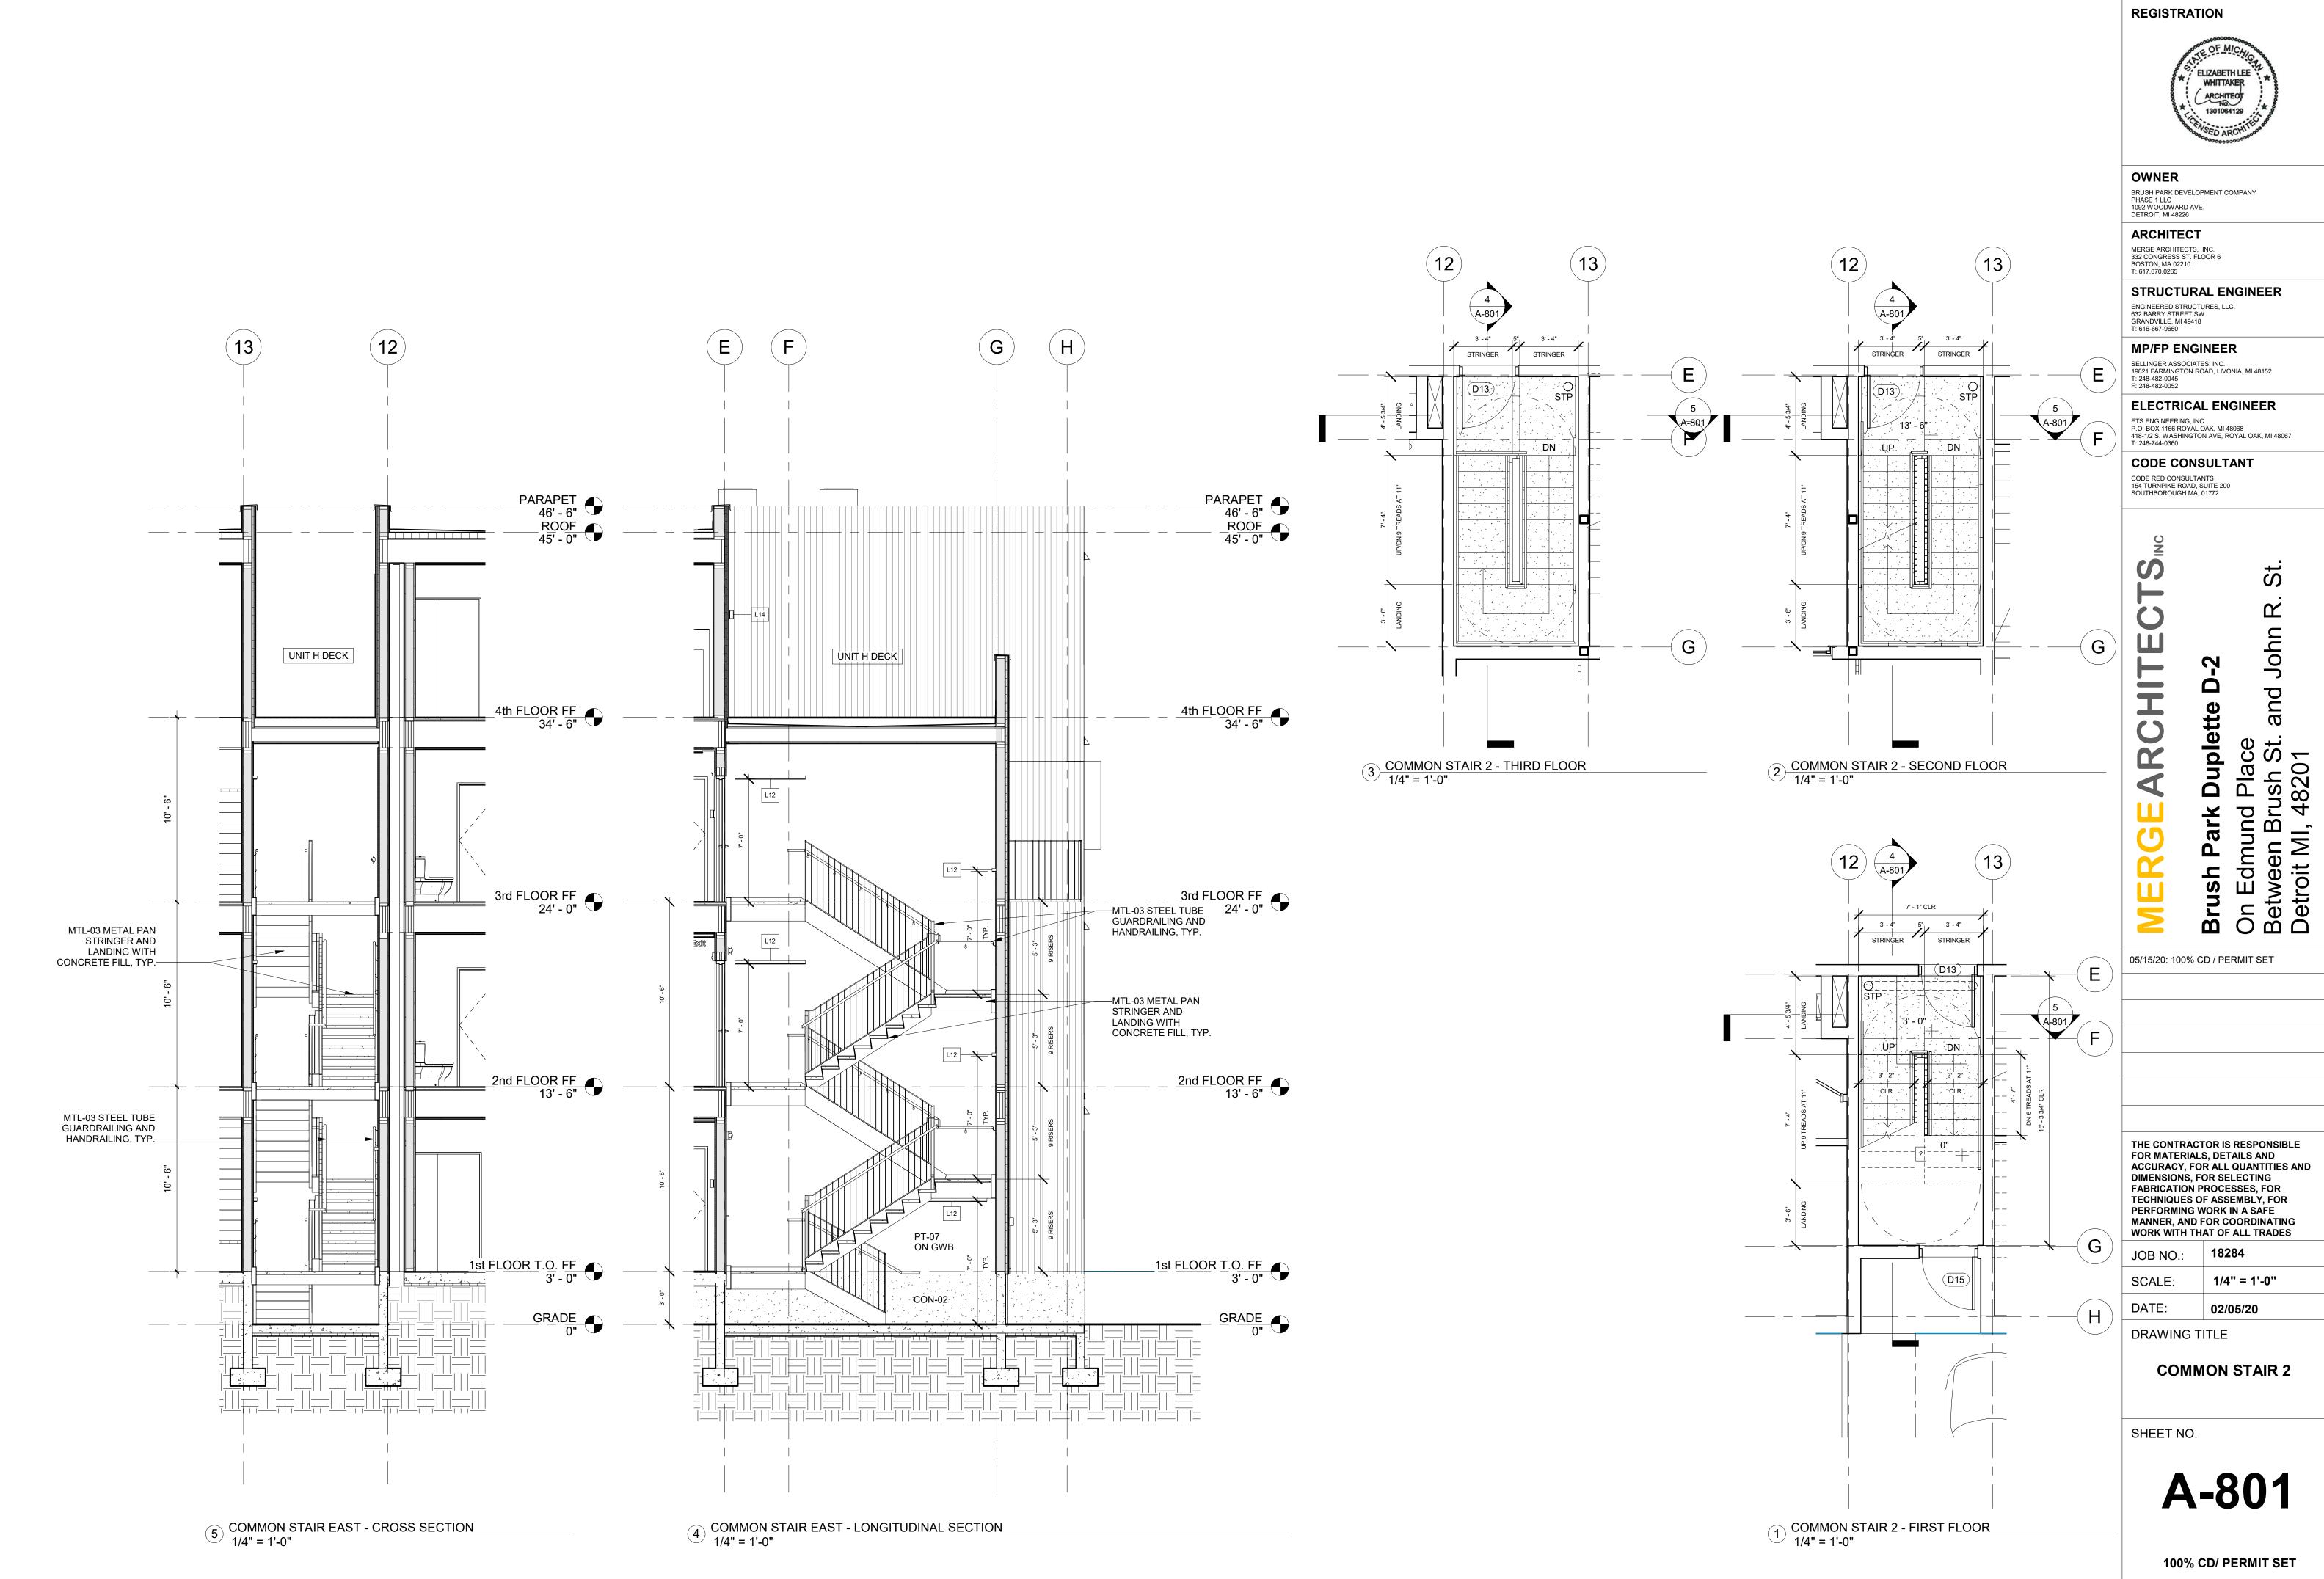



BRUSH PARK DEVELOPMENT COMPANY

ARCHITECT

STRUCTURAL ENGINEER

ENGINEERED STRUCTURES, LLC.

MP/FP ENGINEER

SELLINGER ASSOCIATES, INC. 19821 FARMINGTON ROAD, LIVONIA, MI 48152 T: 248-482-0045

ELECTRICAL ENGINEER ETS ENGINEERING, INC. P.O. BOX 1166 ROYAL OAK, MI 48068 418-1/2 S. WASHINGTON AVE, ROYAL OAK, MI 48067

CODE CONSULTANT

Duplette

John

and

d Place trush St. 48201

On Edmund Between Br Detroit MI, ²


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CODE RED CONSULTANTS 154 TURNPIKE ROAD, SUITE 200 SOUTHBOROUGH MA, 01772


18284

1/4" = 1'-0"

02/05/20

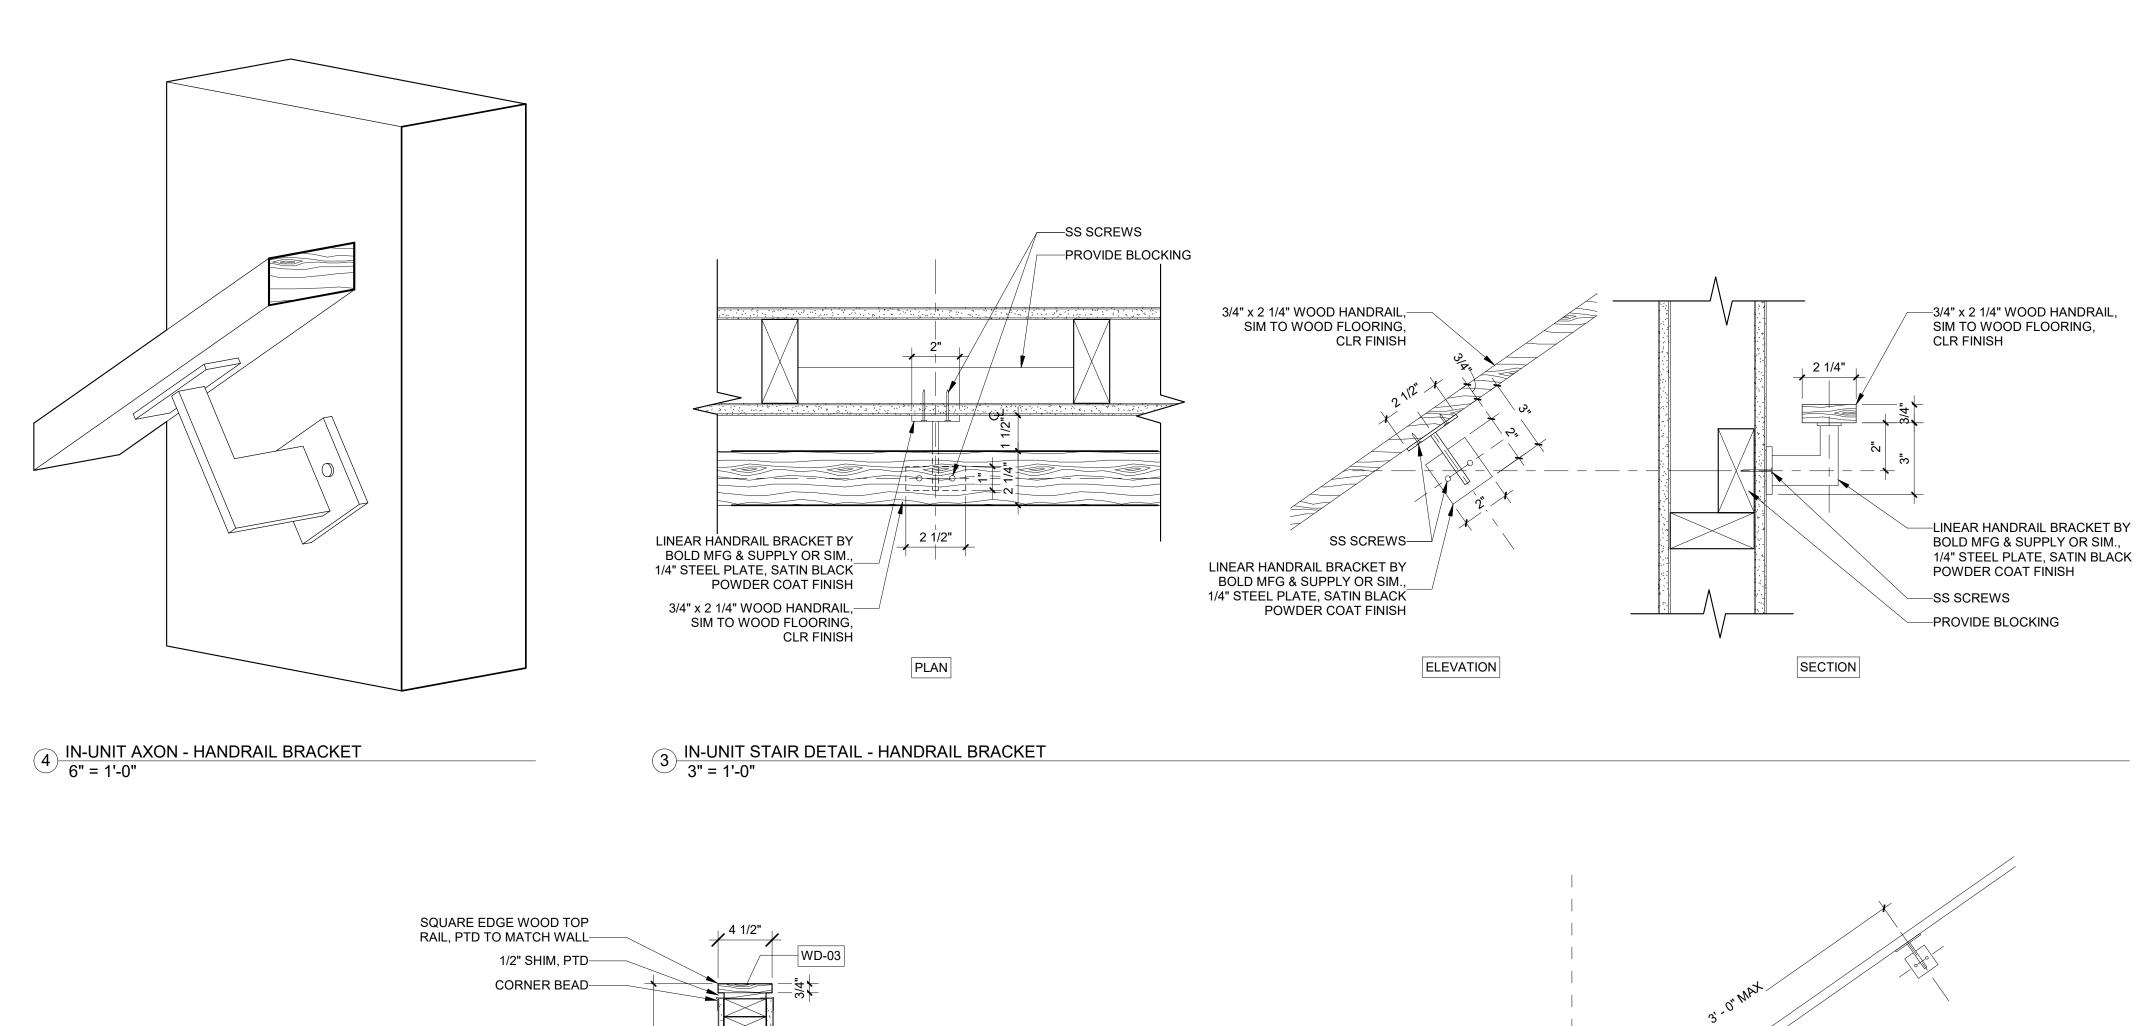

2 IN-UNIT STAIR DETAIL - KNEE WALL 1 1/2" = 1'-0"

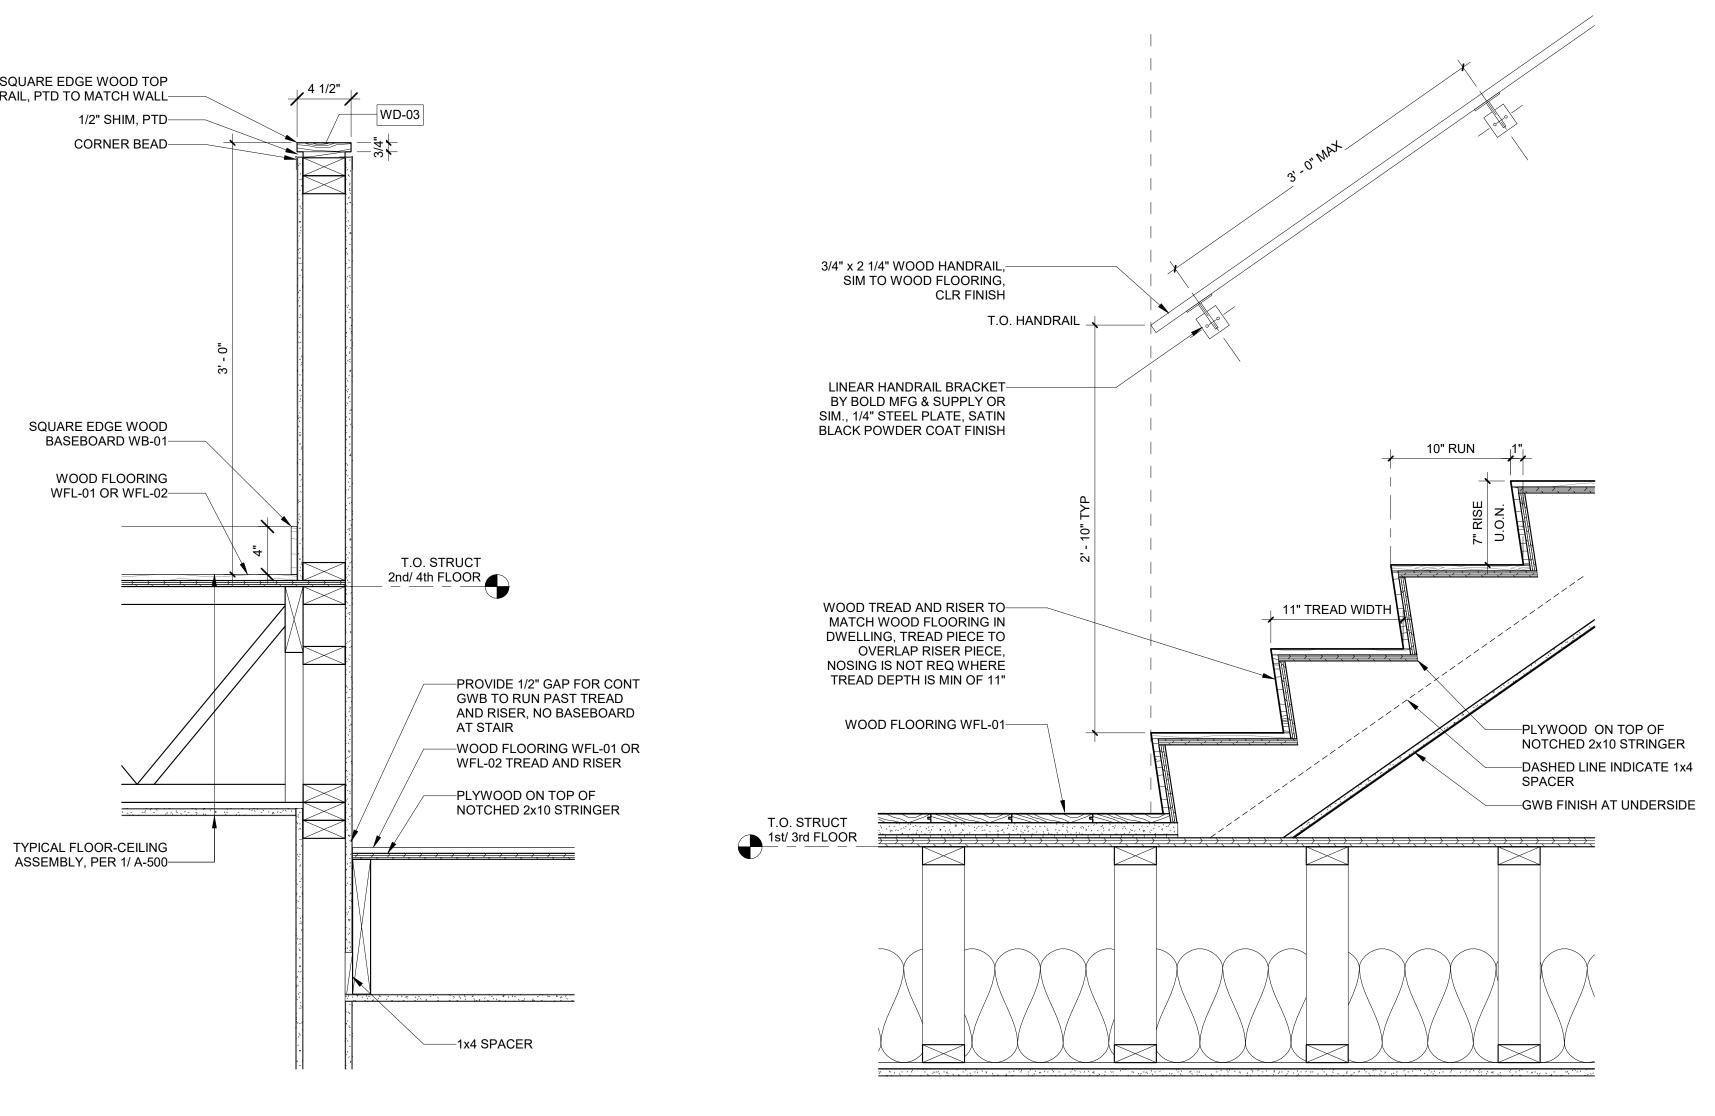

1 IN-UNIT STAIR DETAIL - TREAD AND RISER TYP. 1 1/2" = 1'-0"

REGISTRATION



OWNER BRUSH PARK DEVELOPMENT COMPANY PHASE 1 LLC 1092 WOODWARD AVE. DETROIT, MI 48226

ARCHITECT MERGE ARCHITECTS, INC. 332 CONGRESS ST. FLOOR 6 BOSTON, MA 02210 T: 617.670.0265

STRUCTURAL ENGINEER

ENGINEERED STRUCTURES, LLC. 632 BARRY STREET SW GRANDVILLE, MI 49418 T: 616-667-9650

MP/FP ENGINEER

SELLINGER ASSOCIATES, INC. 19821 FARMINGTON ROAD, LIVONIA, MI 48152 T: 248-482-0045 F: 248-482-0052

ELECTRICAL ENGINEER

ETS ENGINEERING, INC.
P.O. BOX 1166 ROYAL OAK, MI 48068
418-1/2 S. WASHINGTON AVE, ROYAL OAK, MI 48067
T: 248-744-0360

CODE CONSULTANT

CODE RED CONSULTANTS 154 TURNPIKE ROAD, SUITE 200 SOUTHBOROUGH MA, 01772

John and **Duplette** 0 On Bet Det 05/15/20: 100% CD / PERMIT SET


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18284 JOB NO.: As indicated 02/07/20

DRAWING TITLE

STAIR DETAILS

SHEET NO.



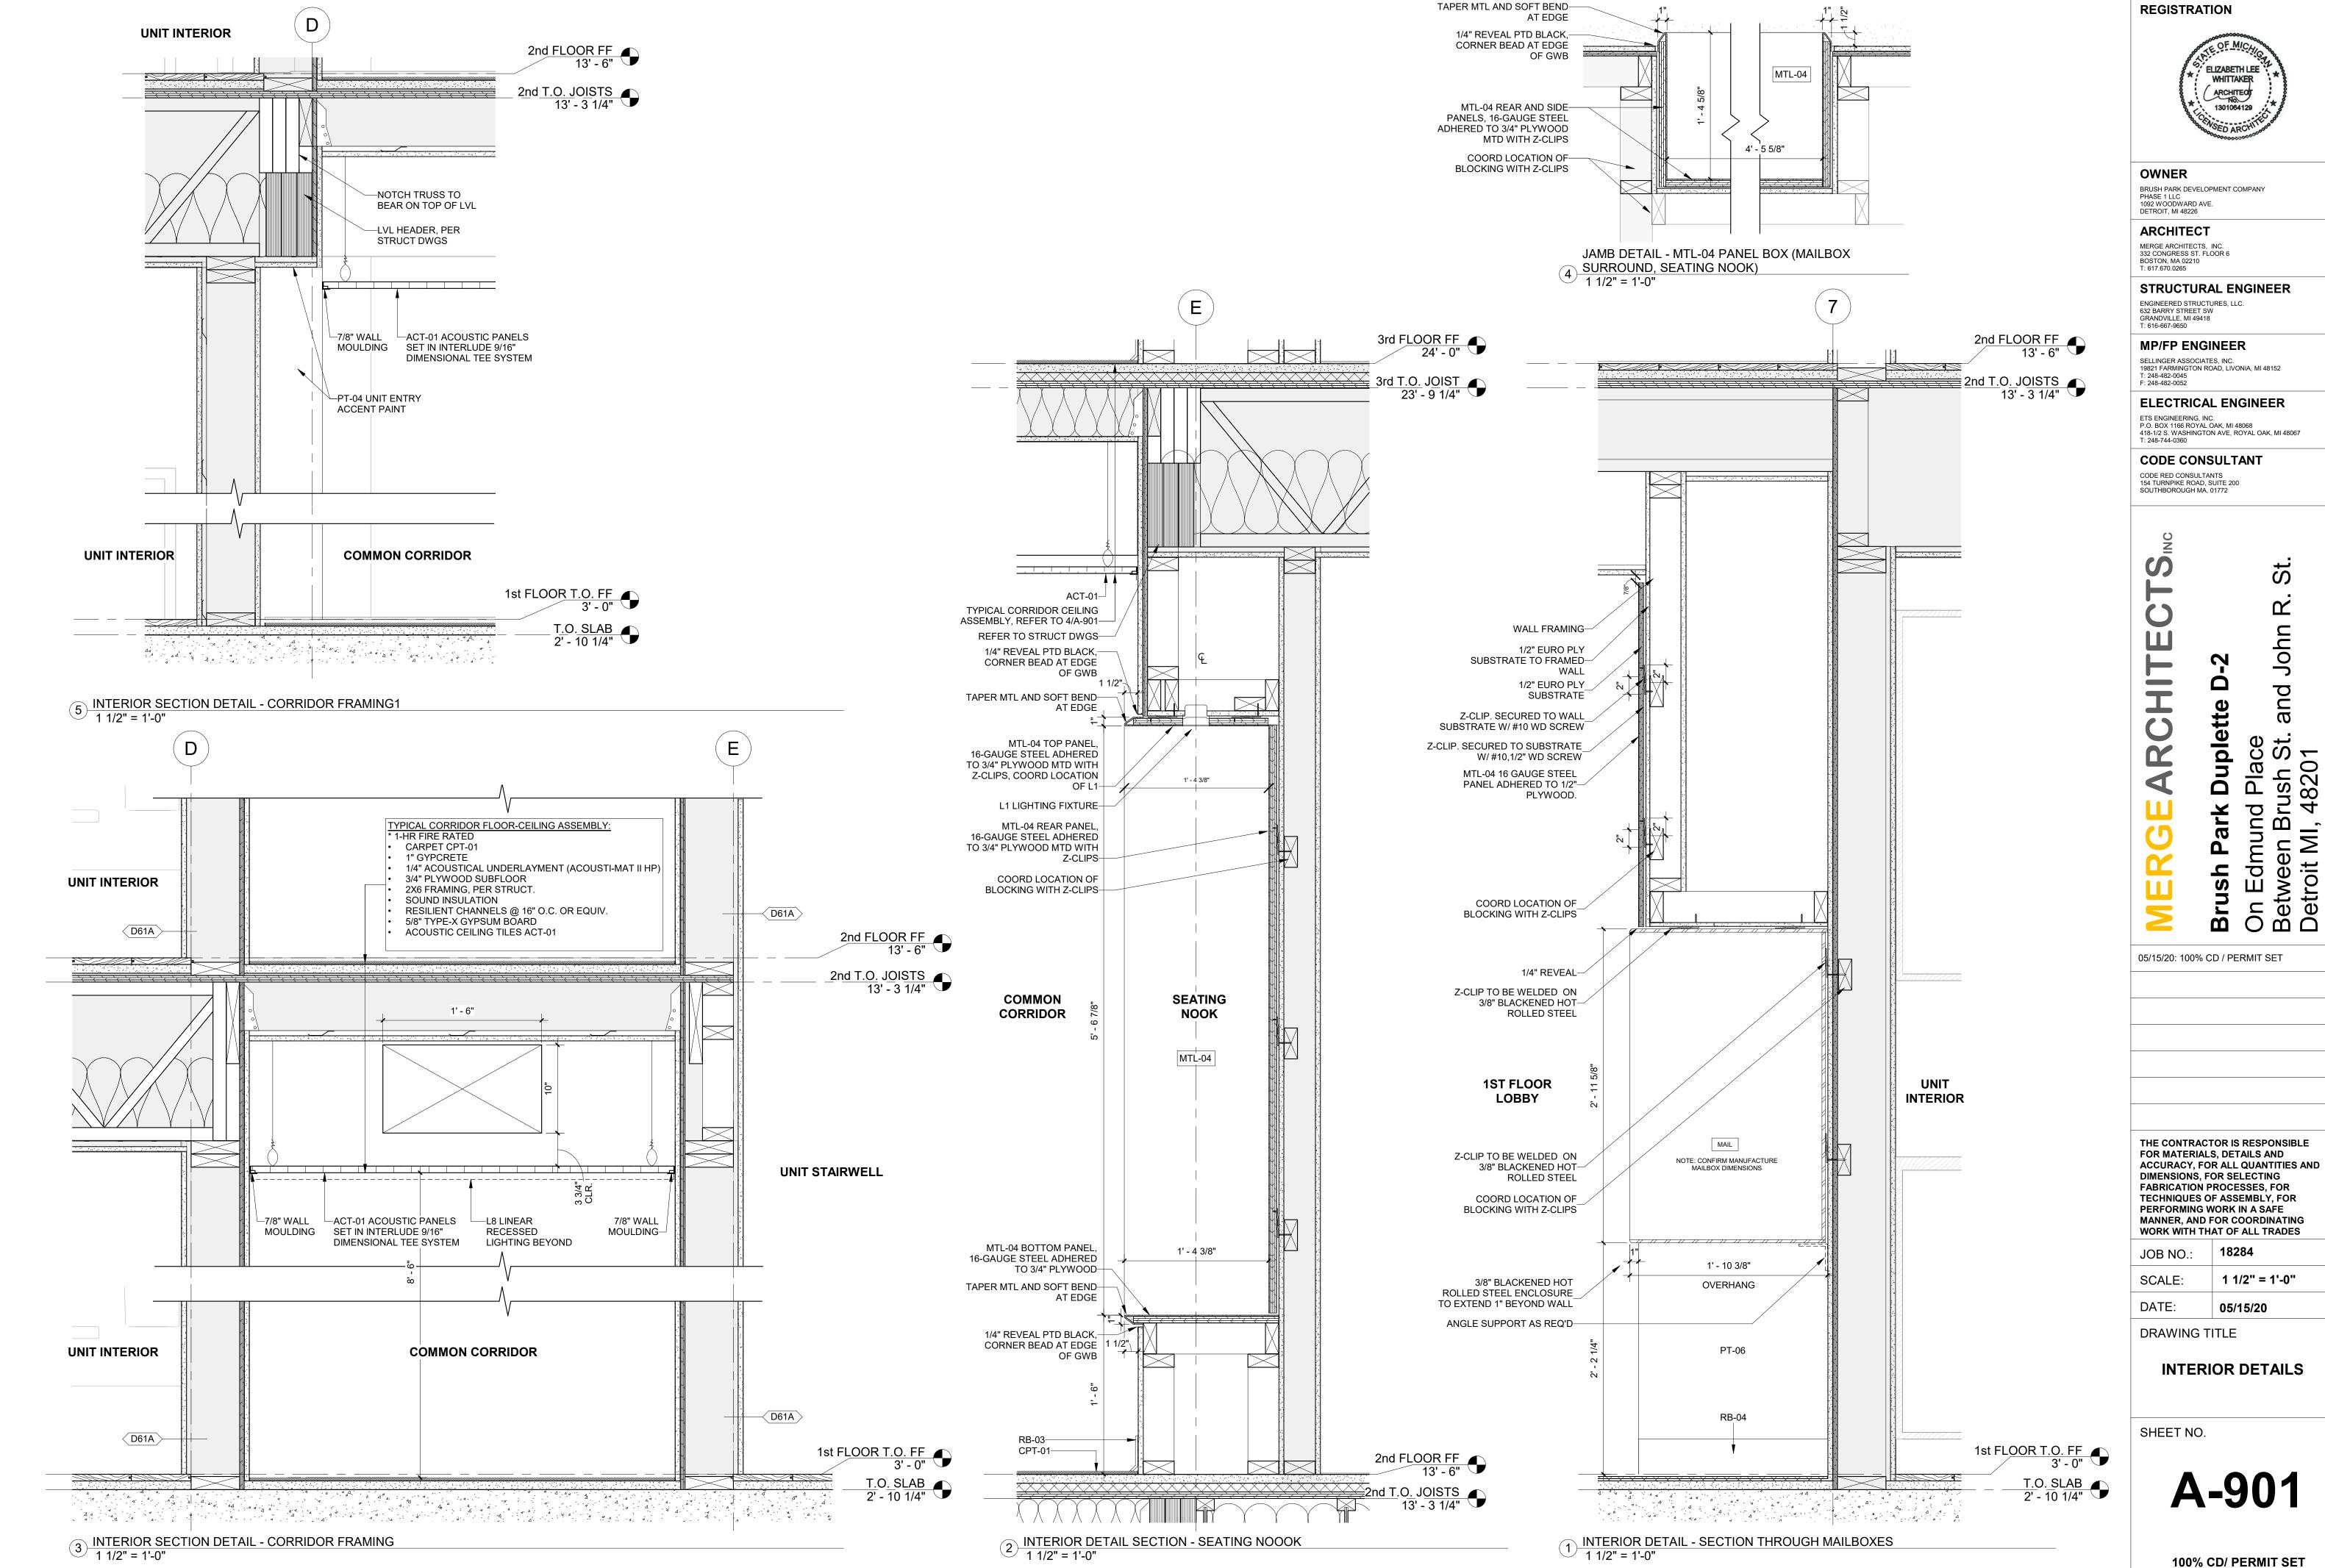

STRUCTURAL ENGINEER

SELLINGER ASSOCIATES, INC. 19821 FARMINGTON ROAD, LIVONIA, MI 48152 T: 248-482-0045

P.O. BOX 1166 ROYAL OAK, MI 48068 418-1/2 S. WASHINGTON AVE, ROYAL OAK, MI 48067

0 0 $\boldsymbol{\omega}$

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1 1/2" = 1'-0"

INTERIOR DETAILS



—TUB/ SHOWER

WATERPROOF MEMBRANE

4 PLAN DETAIL - SHOWER TILE TERMINATION 3" = 1'-0"

TILE PER FINISH

THIN SET MORTAR-

MEMBRANE

3 SECTION DETAIL - SHOWER CURB 3" = 1'-0"

SCHEDULE, BULLNOSE EDGE-

AT CORNERS OF CURB

BEYOND

1/8" GROUT-

BACKERBOARD

PIECE, TYP.

SHOWER

FRAMELESS GLASS TILED SHOWER_

WALL

PANEL AS

IN CURB


SCHEDULED


—U-CHANNEL RECESSED

TRENCH DRAIN-

BULLNOSE TILE END_

TILE-01—

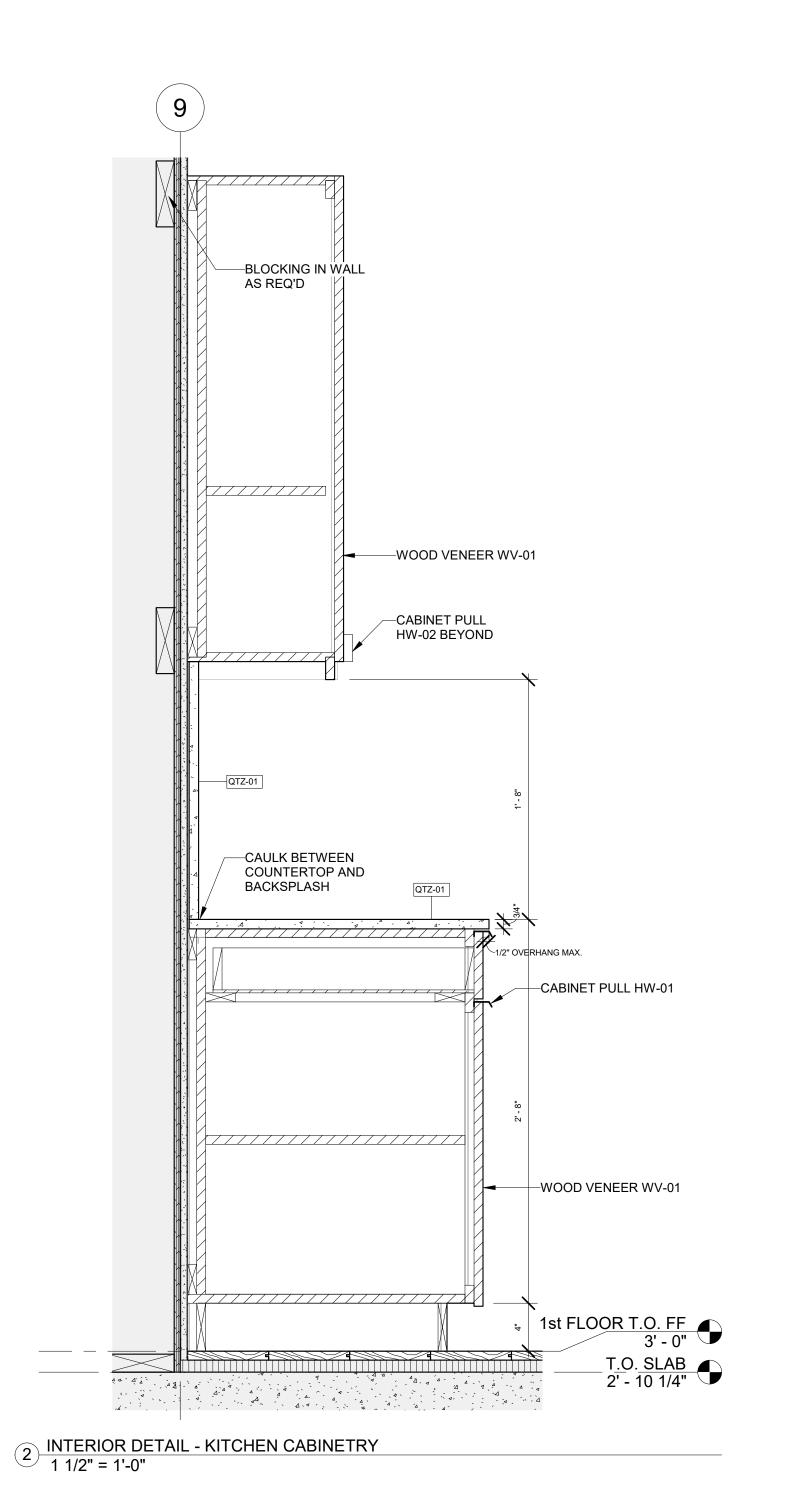

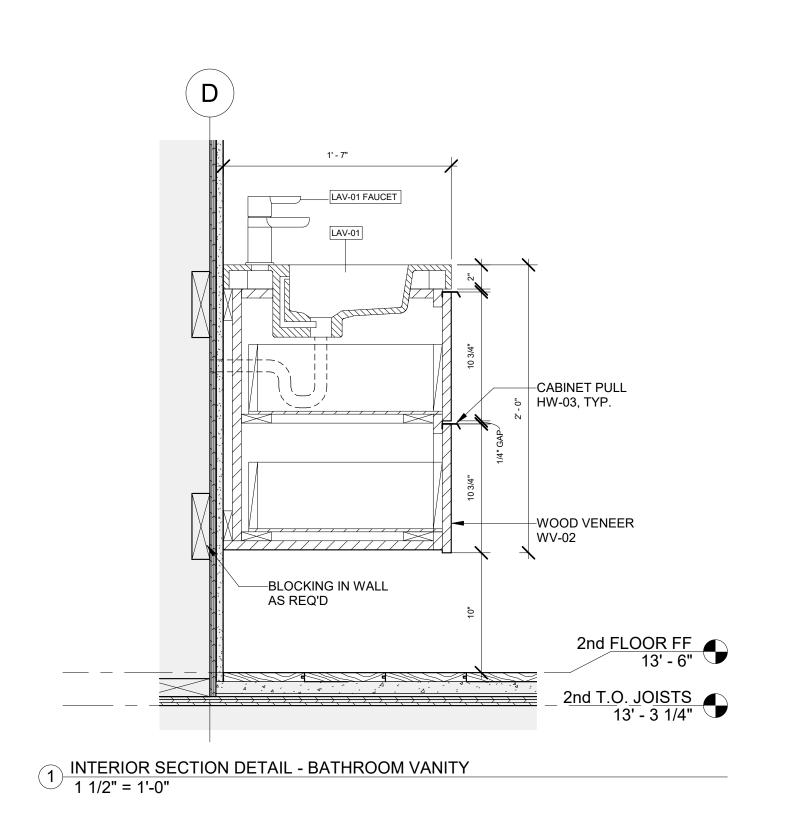

REGISTRATION



OWNER BRUSH PARK DEVELOPMENT COMPANY PHASE 1 LLC 1092 WOODWARD AVE. DETROIT, MI 48226

ARCHITECT

MERGE ARCHITECTS, INC. 332 CONGRESS ST. FLOOR 6 BOSTON, MA 02210 T: 617.670.0265

STRUCTURAL ENGINEER ENGINEERED STRUCTURES, LLC. 632 BARRY STREET SW GRANDVILLE, MI 49418 T: 616-667-9650

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CODE CONSULTANT

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ohn and ld Place srush St. 48201

Duplette On Edmund Between Br Detroit MI, ²

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18284 JOB NO.: SCALE: As indicated

02/06/20 DATE: DRAWING TITLE

INTERIOR DETAILS

SHEET NO.

PROPERTIES OF SOILS CLASSIFIED ACCORDING THE THE UNIFIED SOIL SLASSIFICATION SYSTEM

GW	WELL GRADED GRAVELS, GRAVELSAND MIXTURES, LITTLE OR NO FINES
GP	POORLY GRADED GRAVELS OR GRAVEL SAND MIXTURES, LITTLE OR NO FINE


- GP POURLY GRADED GRAVELS OR GRAVEL SAND MIXTURES, LITTLE OR NO FINES SW WELL GRADED SANDS, GRAVELLY SANDS, LITTLE OR NO FINES
- POORLY GRADED SANDS OR GRAVELLY SANDS, LITTLE OR NO FINES

FOOTING SCHEDULE				
MARK	SIZE	REINFORCING		
F4.0	4'-0" x 4'-0" x 10"	(5) #4 EACH WAY		


GENERAL FOUNDATION NOTES -

- 1. TYPICAL SLAB ON GRADE TO BE 4" CONCRETE SLAB WITH ONE LAYER 6x6 W2.1 x W2.1 WWM ON COMPACTED GRANULAR FILL. PROVIDE CONTRACTION / CONSTRUCTION JOINTS @ 10'-0" O.C. MAXIMUM. REFER TO STRUCTURAL NOTES SHEET FOR ADDITIONAL NOTES / REQUIREMENTS. ALSO REFER TO 1,2,3/F-201.
- 2. FOOTINGS HAVE BEEN DESIGNED FOR AN ALLOWABLE BEARING CAPACITY OF 3000 PSF. THIS SHALL BE VERIFIED WITH A GEOTECHNICAL REPORT PREPARED BY A GEOTECHNICAL ENGINEER LICENSED IN THE STATE OF MICHIGAN.
- 3. IF SITE SOILS ARE CLAY NOTIFY ENGINEERED STRUCTURES, LLC. FOUNDATIONS MAY REQUIRE REVISION.
- 4. DO NOT BACKFILL WALLS UNTIL LOWER LEVEL SLAB AND MAIN FLOOR JOISTS AND SHEATHING ARE INSTALLED. CLAY IS NOT AN ACCEPTABLE BACKFILL MATERIAL. ALL BACKFILL IS TO BE FREE DRAINING GRANULAR MATERIAL GW, GP, SW OR SP PER THE SOIL CLASSIFICATION CHART.
- 5. 6. U.N.O. UNLESS NOTED OTHERWISE.
- 7. BFF BELOW FINISH FLOOR.

8. PORCH SLAB ADJACENT TO BUILDING WILL BE PLACED ONTO DISTURBED FILL. THIS HAS THE POTENTIAL TO SETTLE OVER TIME AS THE FILL COMPACTS. ADD 2" LEDGE ALONG WALL FOR SLAB SUPPORT AT THE DISCRETION OF THE BUILDER.

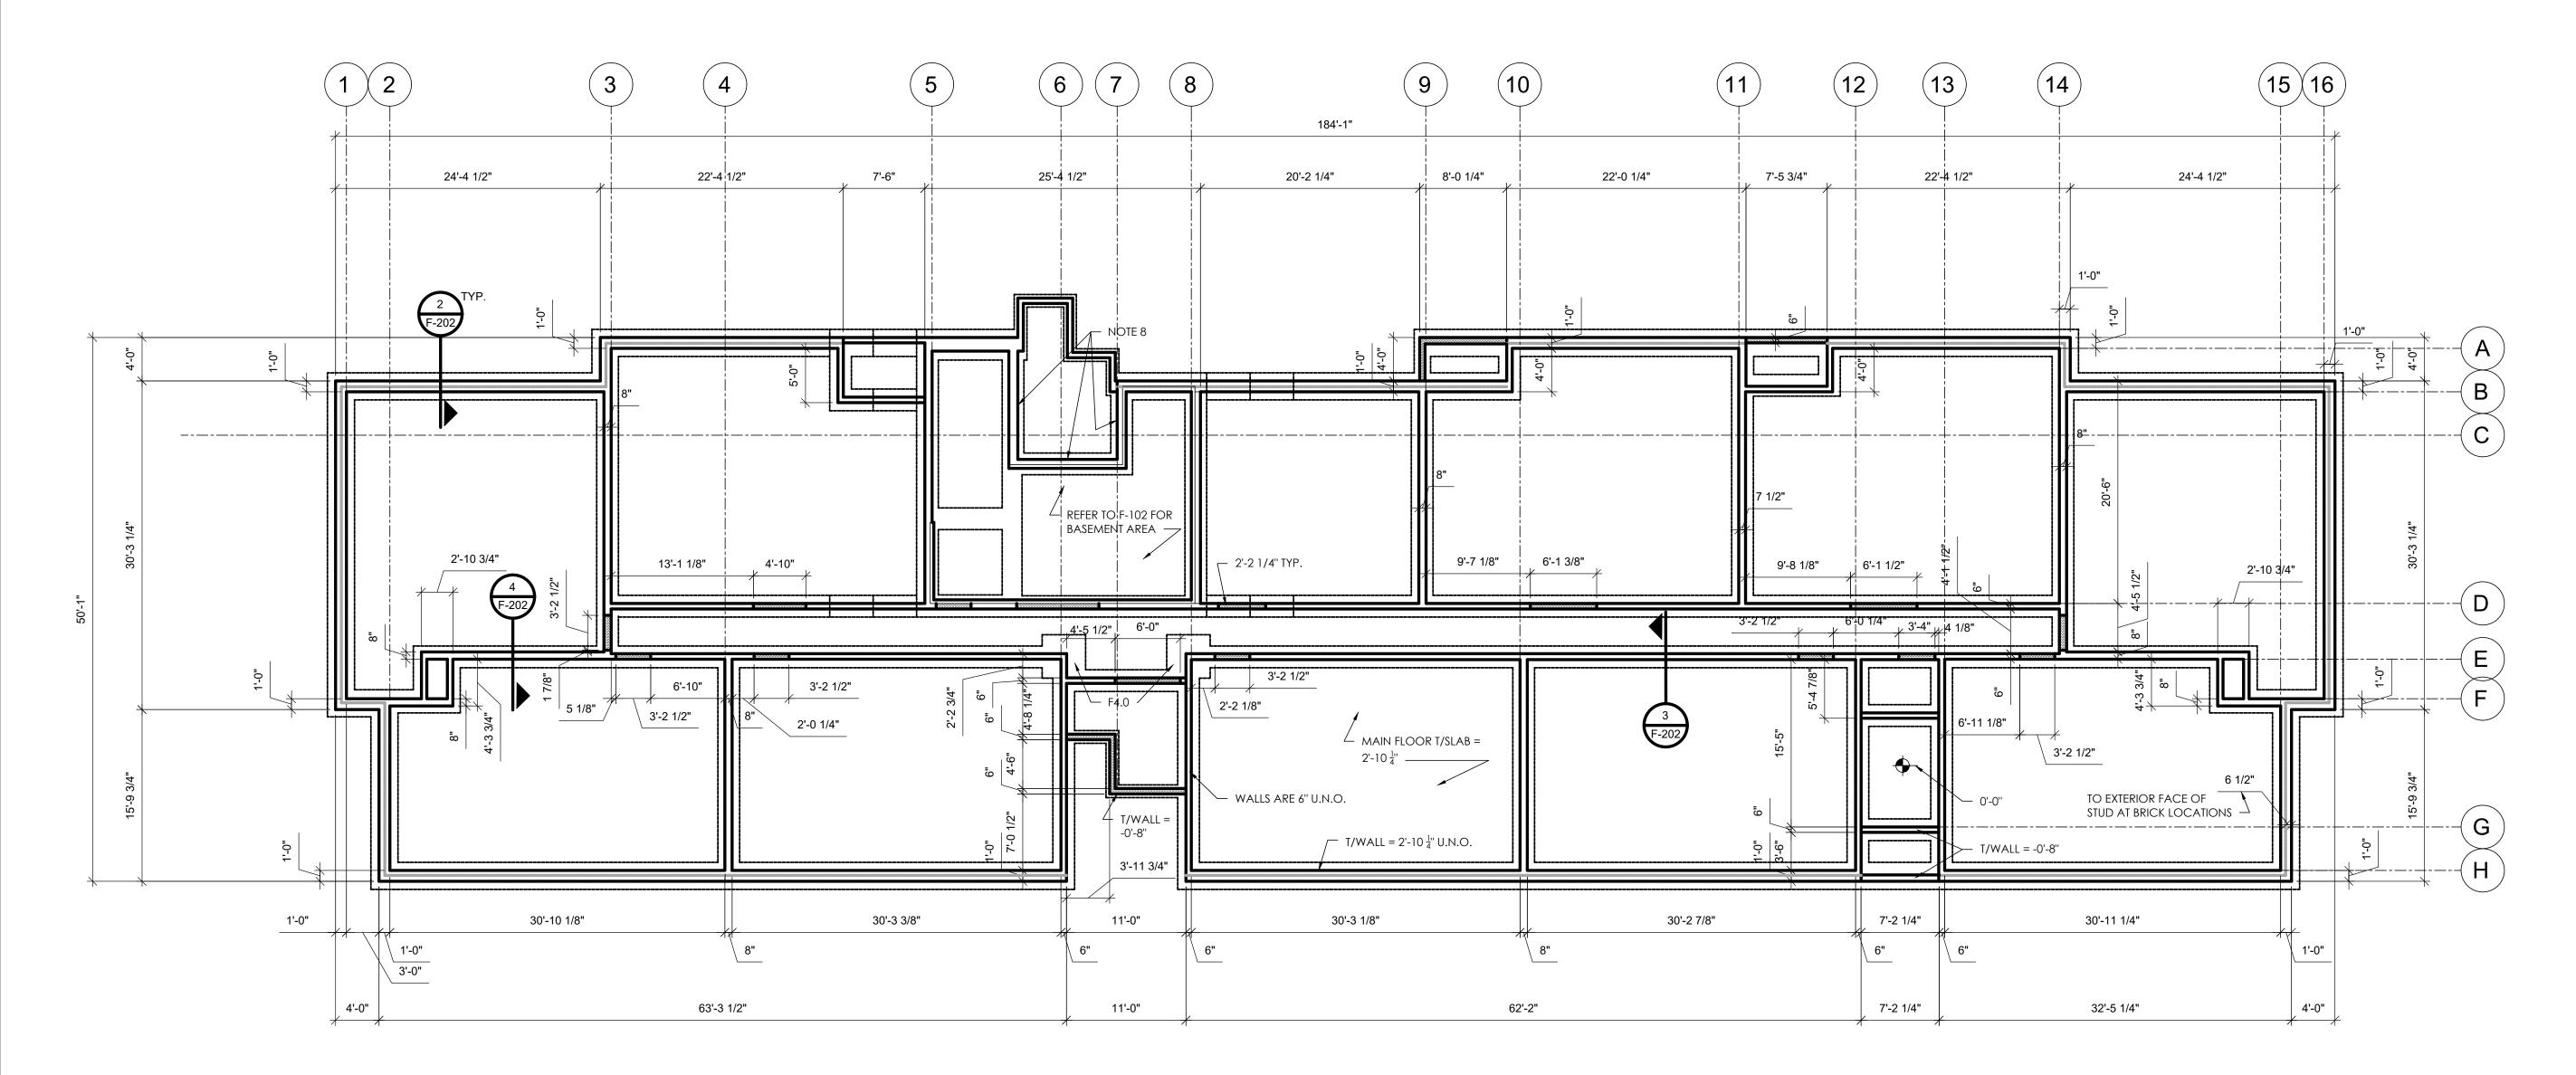


REGISTRATION

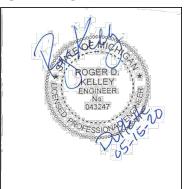

OWNER BRUSH PARK DEVELOPMENT COMPANY PHASE 1 LLC 1092 Woodward Ave. Detroit, MI 48226

ARCHITECT

MERGE ARCHITECTS, INC. 332 CONGRESS ST. FLOOR 6 BOSTON, MA 02210 T: 617.670.0265

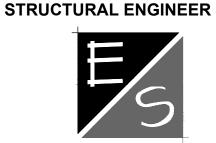

ENGINEERED STRUCTURES, LLC T: 616.667.9650

DuPlette

THE CONTRACTOR IS RESPONSIBLE
FOR MATERIALS, DETAILS AND
ACCURACY, FOR ALL QUANTITIES AND
DIMENSIONS, FOR SELECTING
FABRICATION PROCESSES, FOR
TECHNIQUES OF ASSEMBLY, FOR PERFORMING WORK IN A SAFE MANNER, AND FOR COORDINATING WORK WITH THAT OF ALL TRADES

JOB NO.:


SCALE: 1/8" = 1'-0" 05/15/20 DATE:


DRAWING TITLE

FOUNDATION PLAN

SHEET NO.

F-101

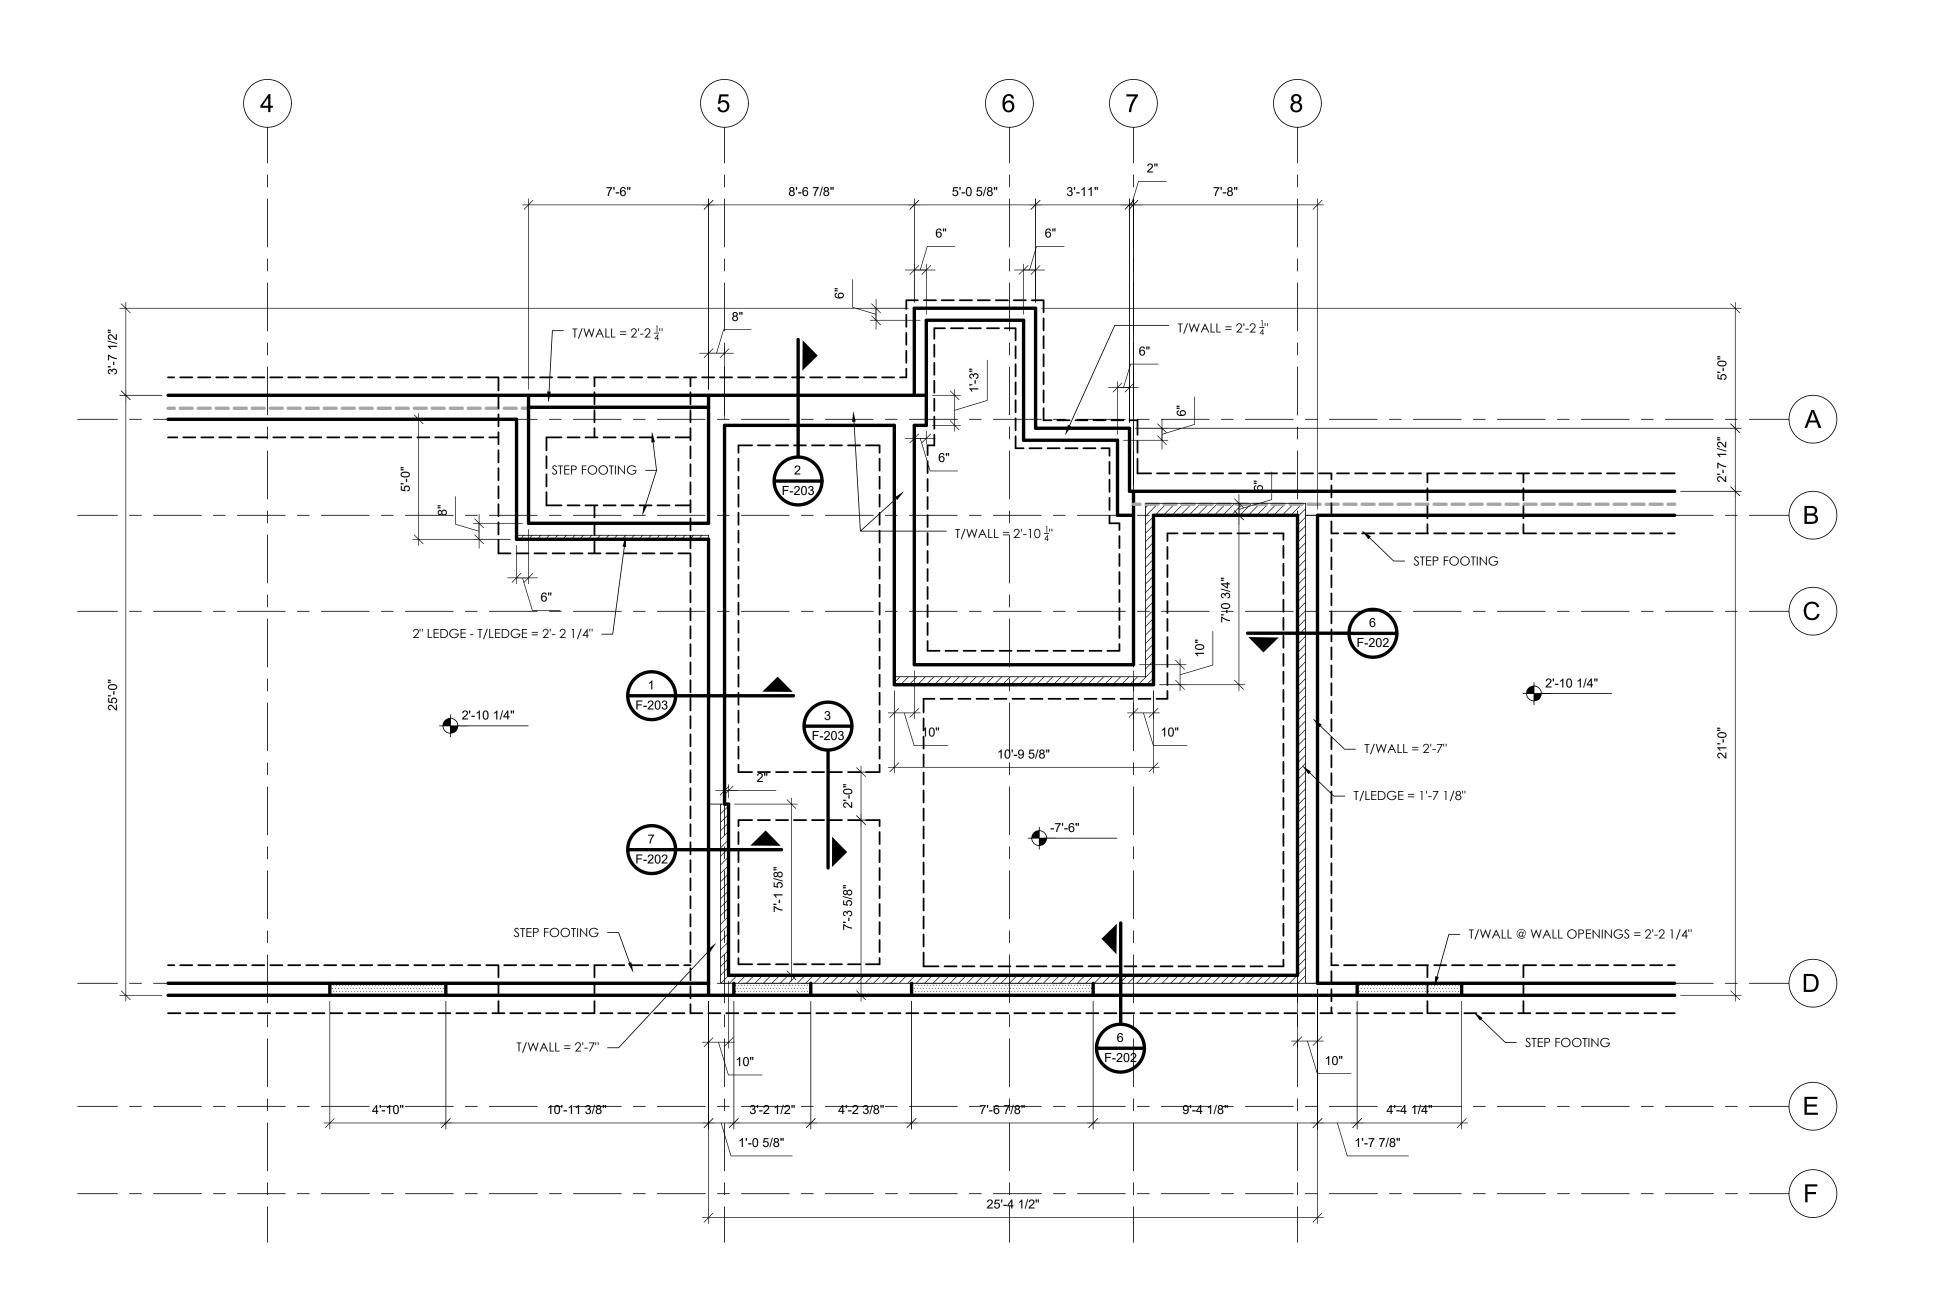

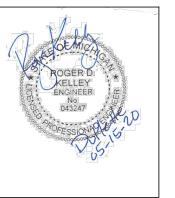

OWNER BRUSH PARK DEVELOPMENT COMPANY PHASE 1 LLC 1092 Woodward Ave. Detroit, MI 48226

ARCHITECT MERGE ARCHITECTS, INC. 332 CONGRESS ST. FLOOR 6 BOSTON, MA 02210 T: 617.670.0265



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DuPlette Brush Parlone Edmund Place, band John R. St.
Detroit, MI 48201

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PERFORMING WORK IN A SAFE
MANNIER, AND FOR COORDINATING MANNER, AND FOR COORDINATING WORK WITH THAT OF ALL TRADES

JOB NO.:

DATE:


SCALE: 1/4" = 1'-0" 05/15/20

DRAWING TITLE

BASEMENT FOUNDATION PLAN

SHEET NO.


F-102

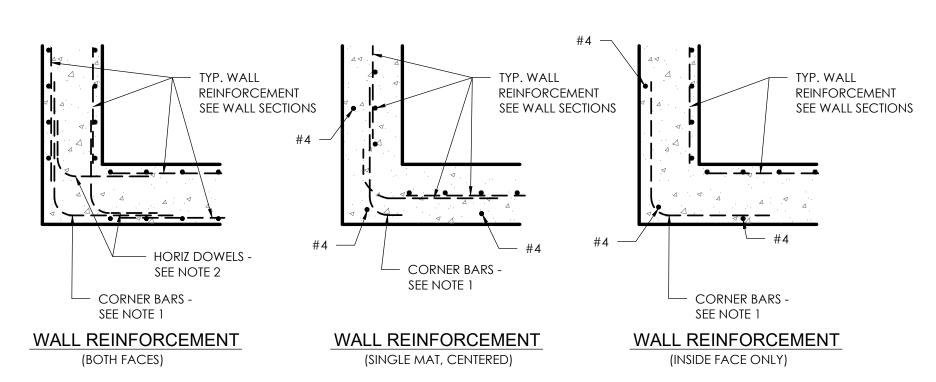

PLAN VIEWS

- 1. PROVIDE CORNER BARS AS SHOWN. MATCH HORIZONTAL WALL REINFORCEMENT SIZE AND SPACING.
- 2. PROVIDE HORIZONTAL DOWELS AS SHOWN, OR STANDARD 90 DEGREE END HOOK ON HORIZONTAL BARS.
- 3. PROVIDE LAP SPLICES PER LAP SPLICE TABLE.
- 4. SEE APPLICABLE SECTIONS FOR REINFORCING STEEL CLEARANCES.
- 5. TERMINATE HORIZONTAL WALL REINFORCEMENT 2" CLEAR FROM END OF WALL.
- 6. GRADE BEAMS: PROVIDE CORNER BARS FOR LONGITUDINAL REINFORCEMENT AT GRADE BEAM CORNERS WITHOUT A SUPPORTING CONCRETE PIER, AS SHOWN IN "WALL REINFORCEMENT - BOTH FACES".



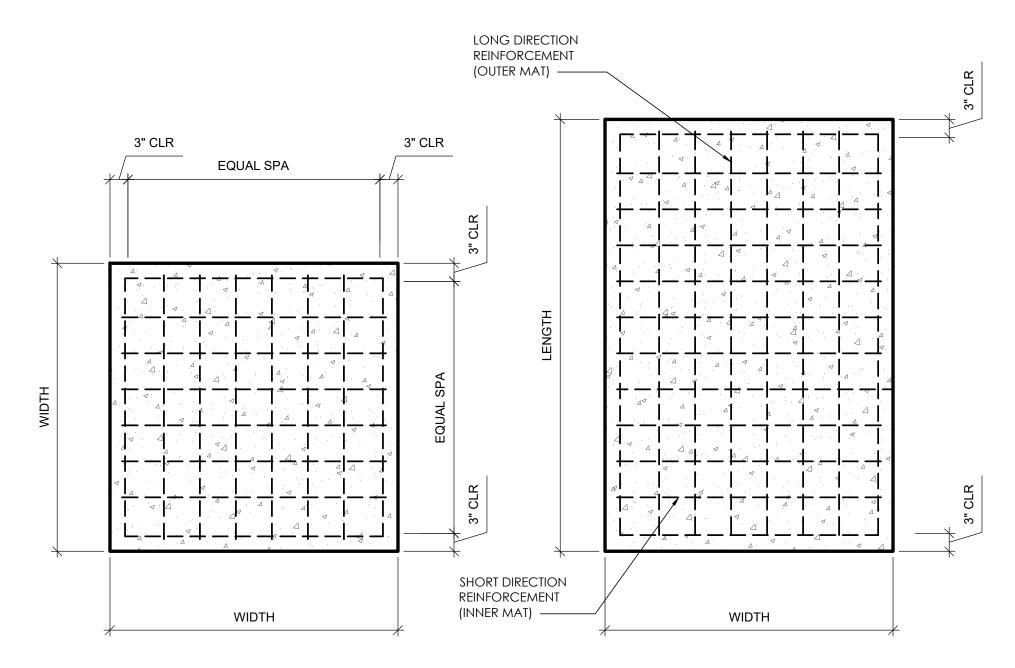


SQUARE COLUMN FOOTING


RECTANGULAR COLUMN FOOTING

FOOTING SCHEDULE NOTES:


- 1. THE GEOTECHNICAL TESTING FIRM SHALL VERIFY THAT THE SOIL BEARING CAPACITY IS ACCEPTABLE AT EACH COLUMN FOOTING AND AT 8'-0" INTERVALS ALONG WALL FOOTINGS AT THE INDICATED BEARING ELEVATIONS.
- 2. CENTER COLUMN AND WALL FOOTINGS UNDER THE COLUMN OR WALL ABOVE UNLESS OTHERWISE INDICATED.
- 3. PLACE FOOTINGS IN WOOD FORMS UNLESS OTHERWISE APPROVED BY THE ENGINEER.
- 4. SEE CONCRETE SCHEDULE AND GENERAL NOTES PERTAINING TO FOUNDATIONS, CONCRETE AND REINFORCING STEEL FOR INFORMATION RELATED TO FOUNDATION CONSTRUCTION.



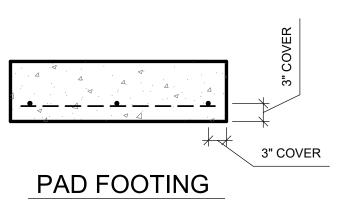


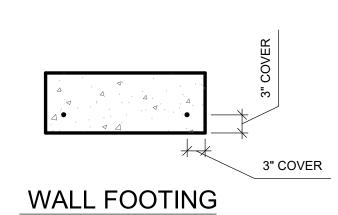


TYP. FOOTING REBAR LOCATION F-201/ SCALE: 3/4"=1'-0"

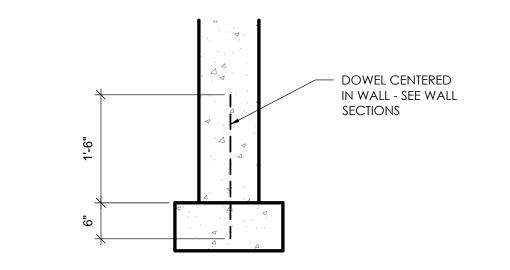

TYP. WALL DOWEL INSTALLATION \F-201 SCALE: 3/4"=1'-0"

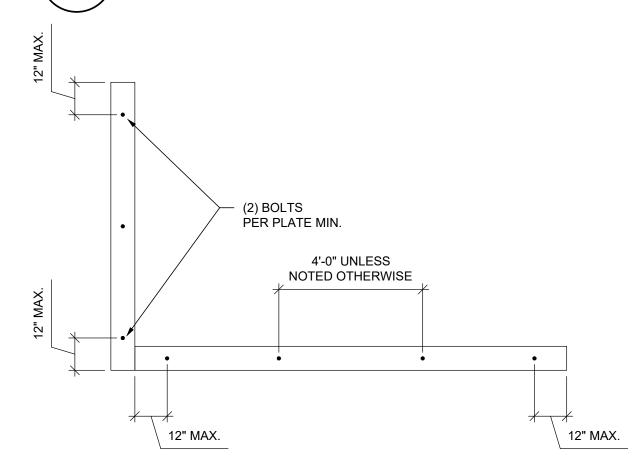


SILL PLATE ANCHORAGE SCALE: 3/4"=1'-0"

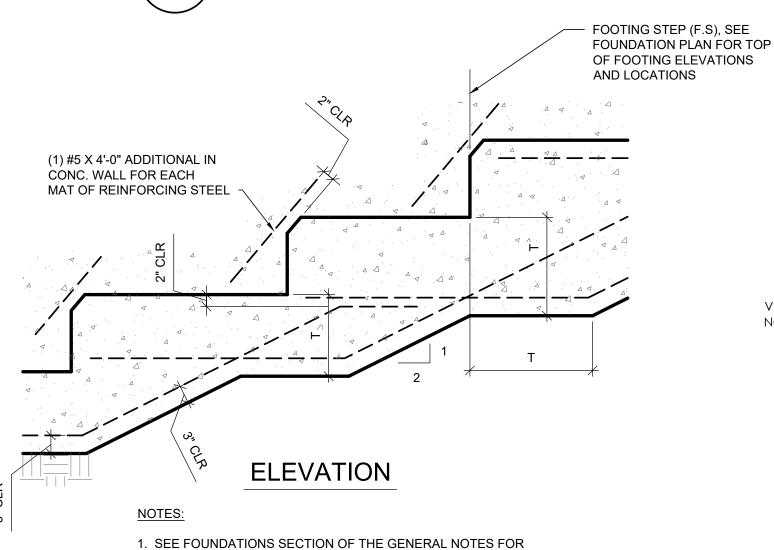

1. SEE FOUNDATIONS SECTION OF THE GENERAL NOTES FOR PREPARATION REQUIREMENTS FOR EARTH BEARING MATERIALS.




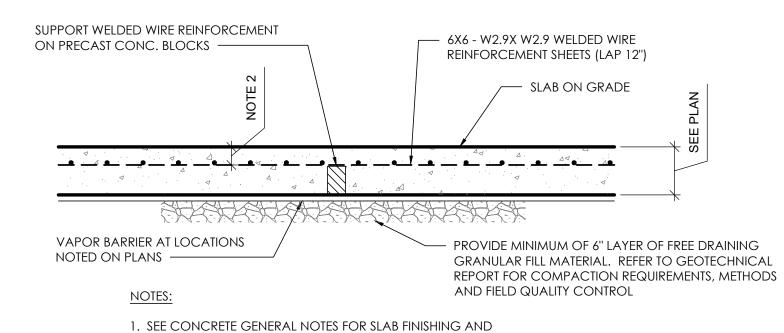

CURING REQUIREMENTS. 2. CLEAR COVER TO BE 2" AT CONC. EXPOSED TO THE ELEMENTS (PARKING

AND EXTERIOR DRIVES) AND 1" AT INTERIOR SPACES TYPICAL.



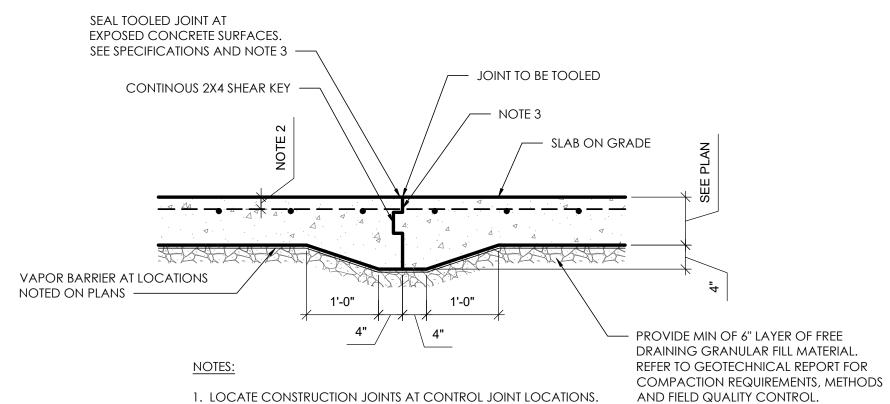


1. LOCATE CONSTRUCTION JOINTS AT CONTROL JOINT LOCATIONS. 2. CLEAR COVER TO BE 2" AT CONCRETE EXPOSED TO THE ELEMENTS AND 1" AT INTERIOR SPACES TYP.

3. APPLY LIQUID BONDBREAKER TO FULL DEPTH OF CONSTRUCTION JOINT.

4. PRIOR TO SEALING JOINT, PREPARE JOINT PER SEALANT MFR. RECOMMENDATIONS.

5. TERMINATE END OF WELDED WIRE REINFORCEMENT 3" SHORT OF CONSTRUCTION JOINT.




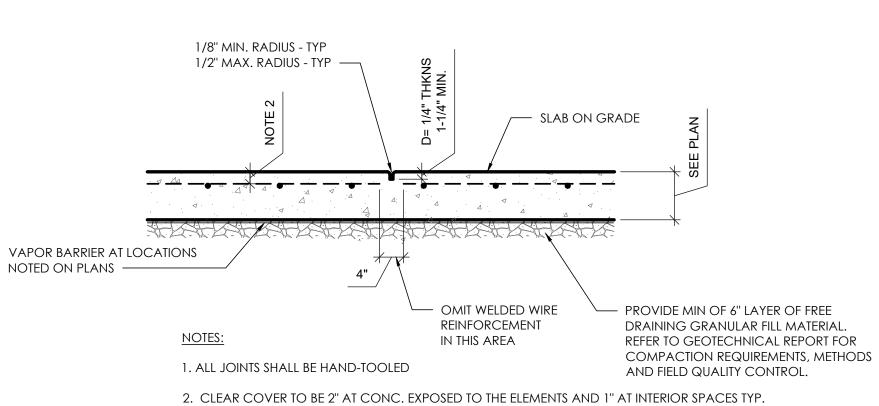

3. SEAL JOINTS AT ALL EXPOSED CONC. SURFACES (SEE SPECIFICATIONS). PROIR TO

TYPICAL SLAB ON GRADE CONTROL JOINT SCALE: 3/4"=1'-0"

SEALING JOINT, PREPARE JOINT PER SEALANT MFR'S RECOMMENDATIONS.

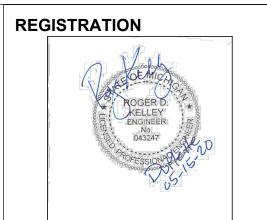

OWNER LAFAYETTE PARK LANDOWNERS LLC.

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STRUCTURAL ENGINEER



ENGINEERED STRUCTURES, LLC T: 616.667.9650

uplette a

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Detroit,

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JOB NO.:

3/4" = 1'-0" SCALE:


WORK WITH THAT OF ALL TRADES

05/15/20 DATE: DRAWING TITLE

FOUNDATION DETAILS

SHEET NO.

F-201

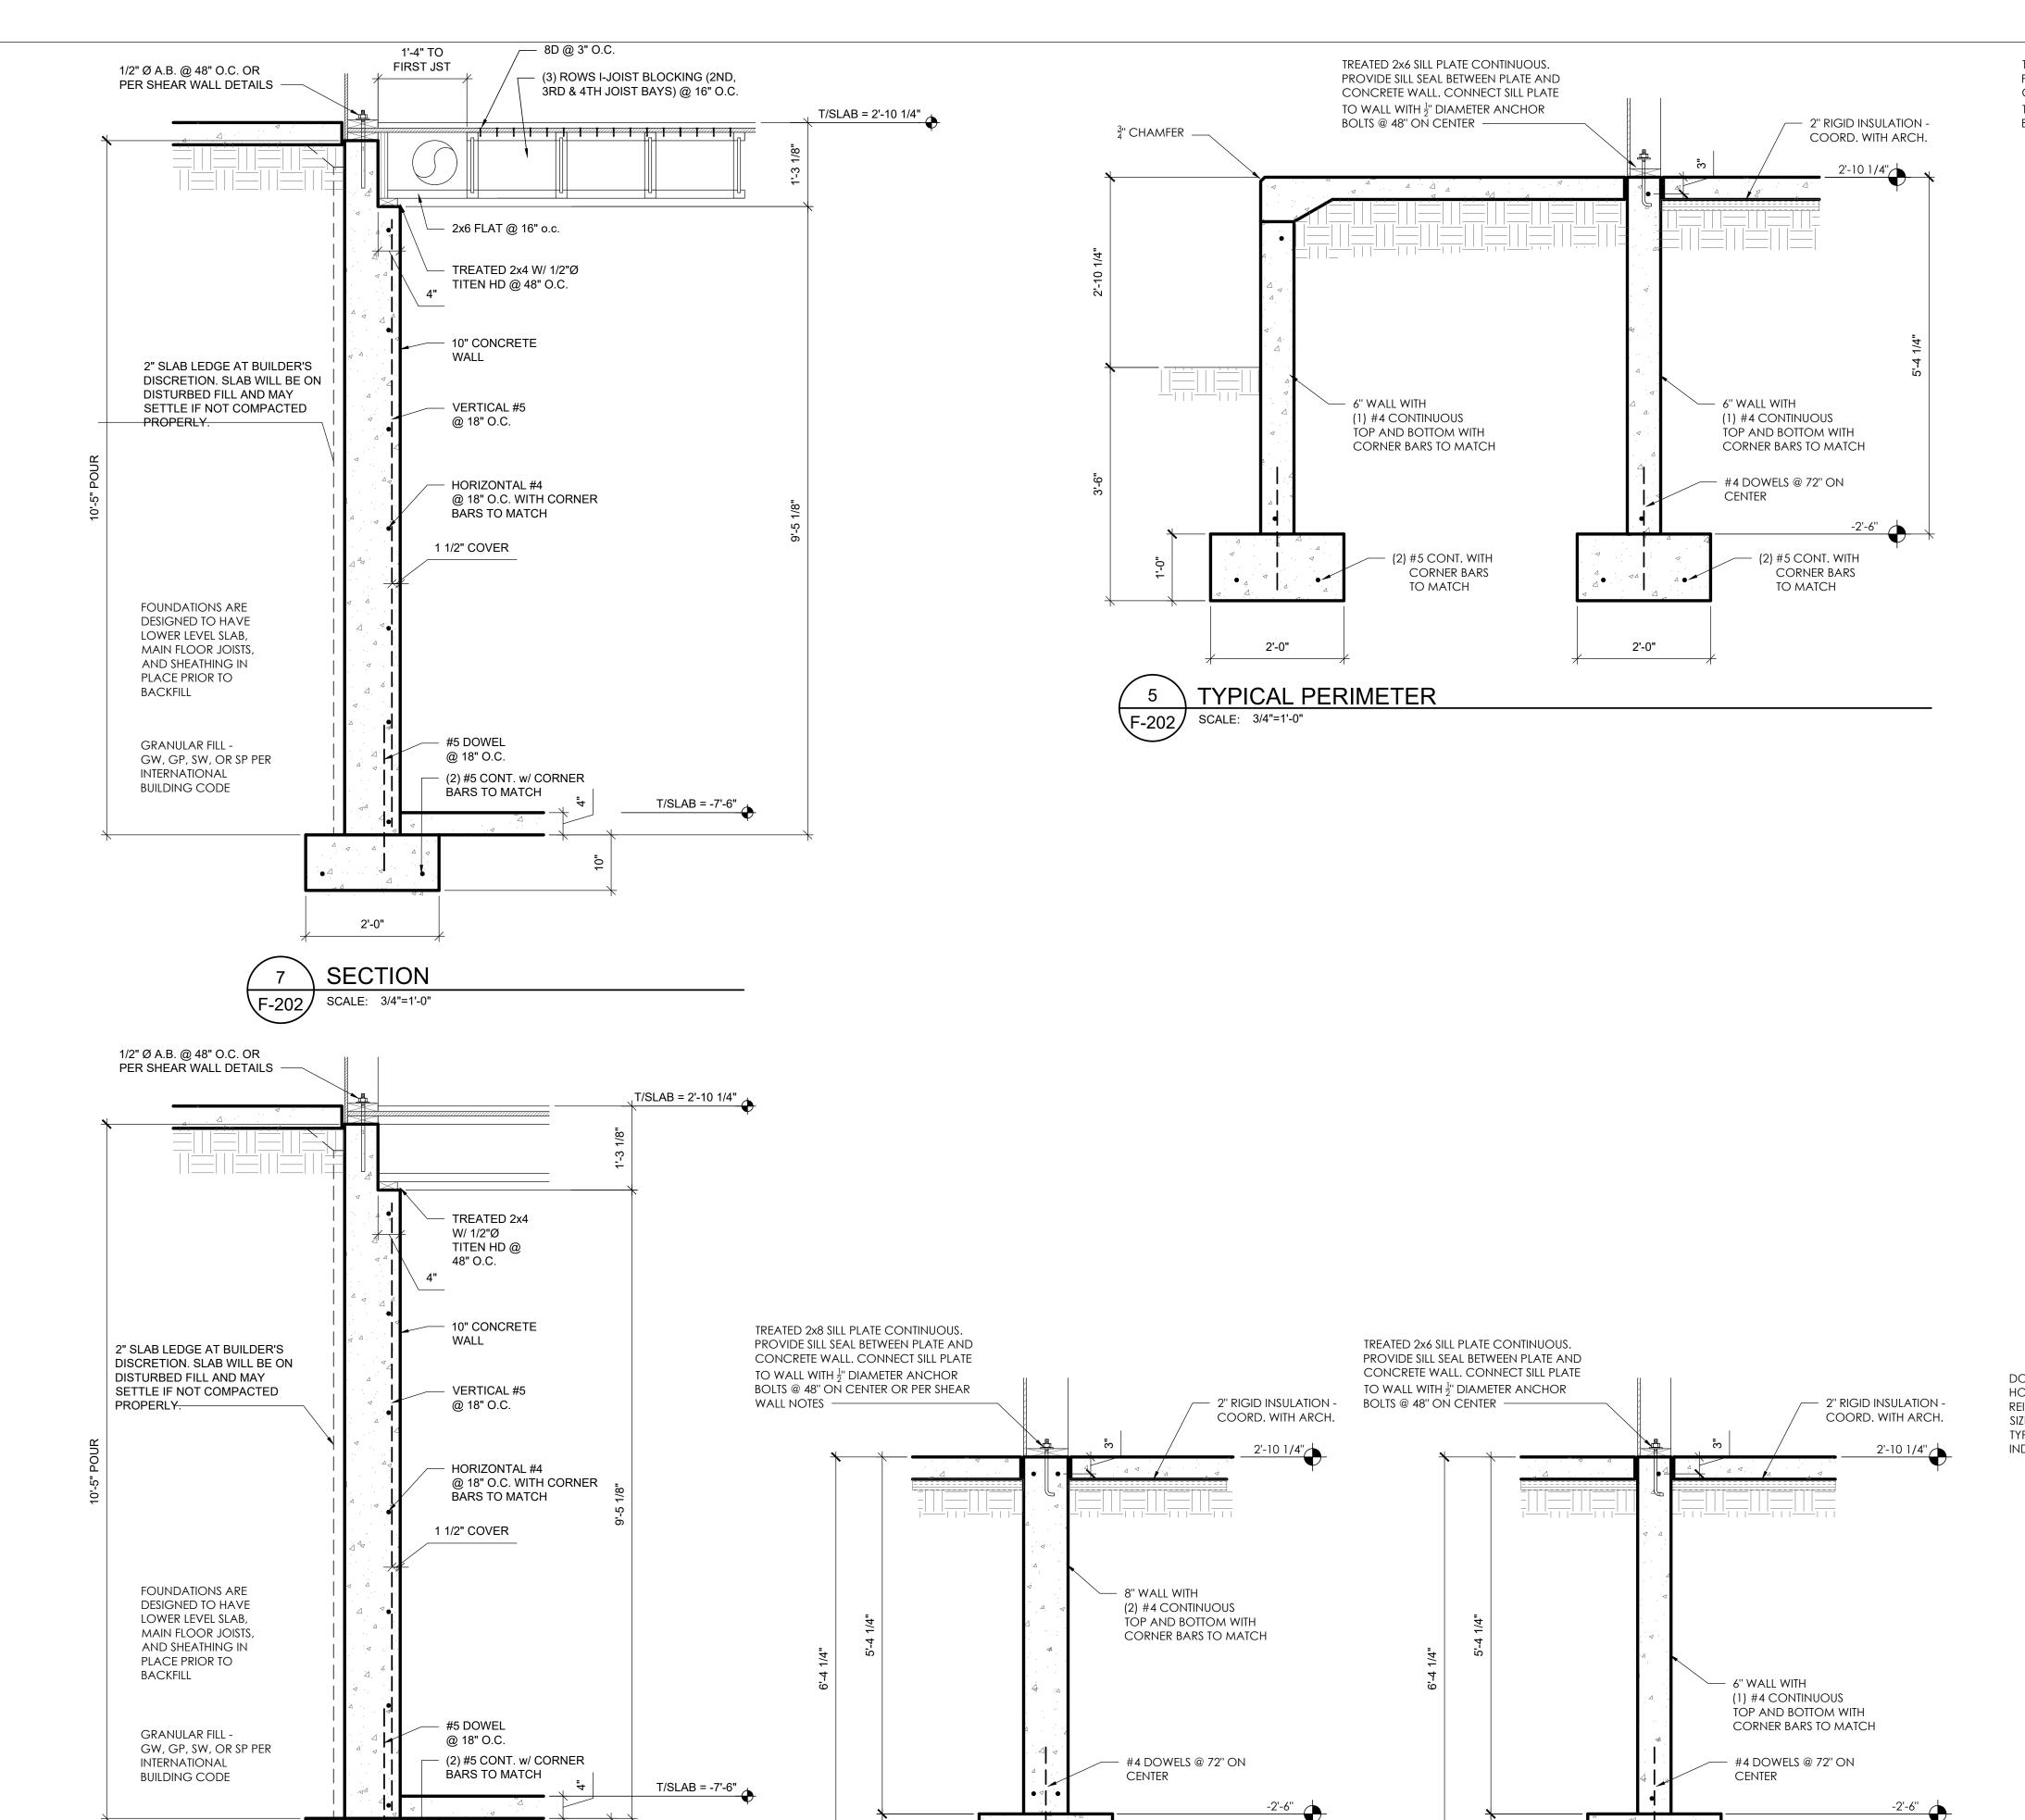

(2) #5 CONT. WITH

TO MATCH

2'-0"

F-202/


SCALE: 3/4"=1'-0"

2'-0"

SECTION


SCALE: 3/4"=1'-0"

CORNER BARS

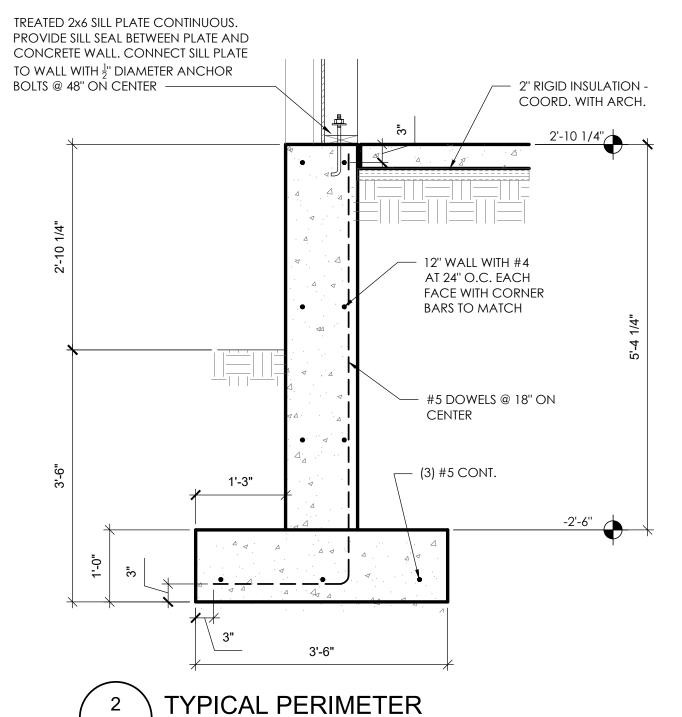

SCALE: 3/4"=1'-0"

TENSION LAP SPLICE TABLE (LAP LENGTH IN INCHES)				
BAR	F'c = 3000 PSI	F'c = 4000 PSI		
#3	18	16		
#4	24	20		
#5	34	29		
#6	40	35		
#7	55	48		
#8	70	61		

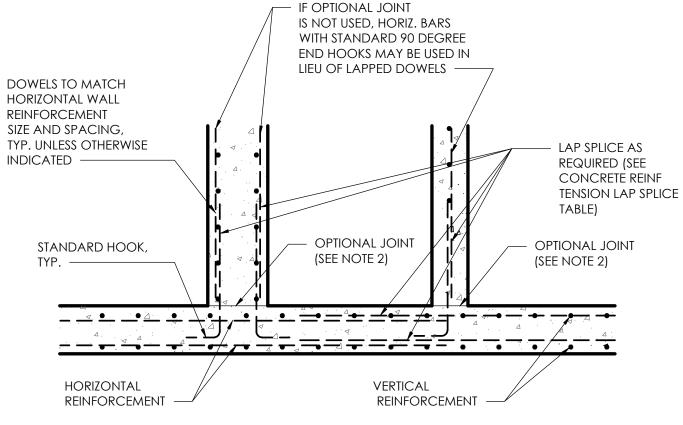

PLAN VIEW

(2) #5 CONT. WITH

TO MATCH


2'-0"

SCALE: 3/4"=1'-0"

CORNER BARS

1. SEE APPLICABLE SECTIONS FOR WALL REINFORCEMENT AND REINFORCING STEEL CLEARANCES. 2. DOWEL BAR SUBSTUTUES MAY BE PROVIDED AT INTERSECTING WALL CONSTRUCTION JOINTS, AT CONTRACTOR'S OPTION.



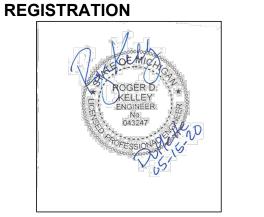

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uplette ar

201

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JOB NO.:

3/4" = 1'-0" SCALE:


05/15/20 DATE:


DRAWING TITLE

FOUNDATION DETAILS

SHEET NO.

F-202

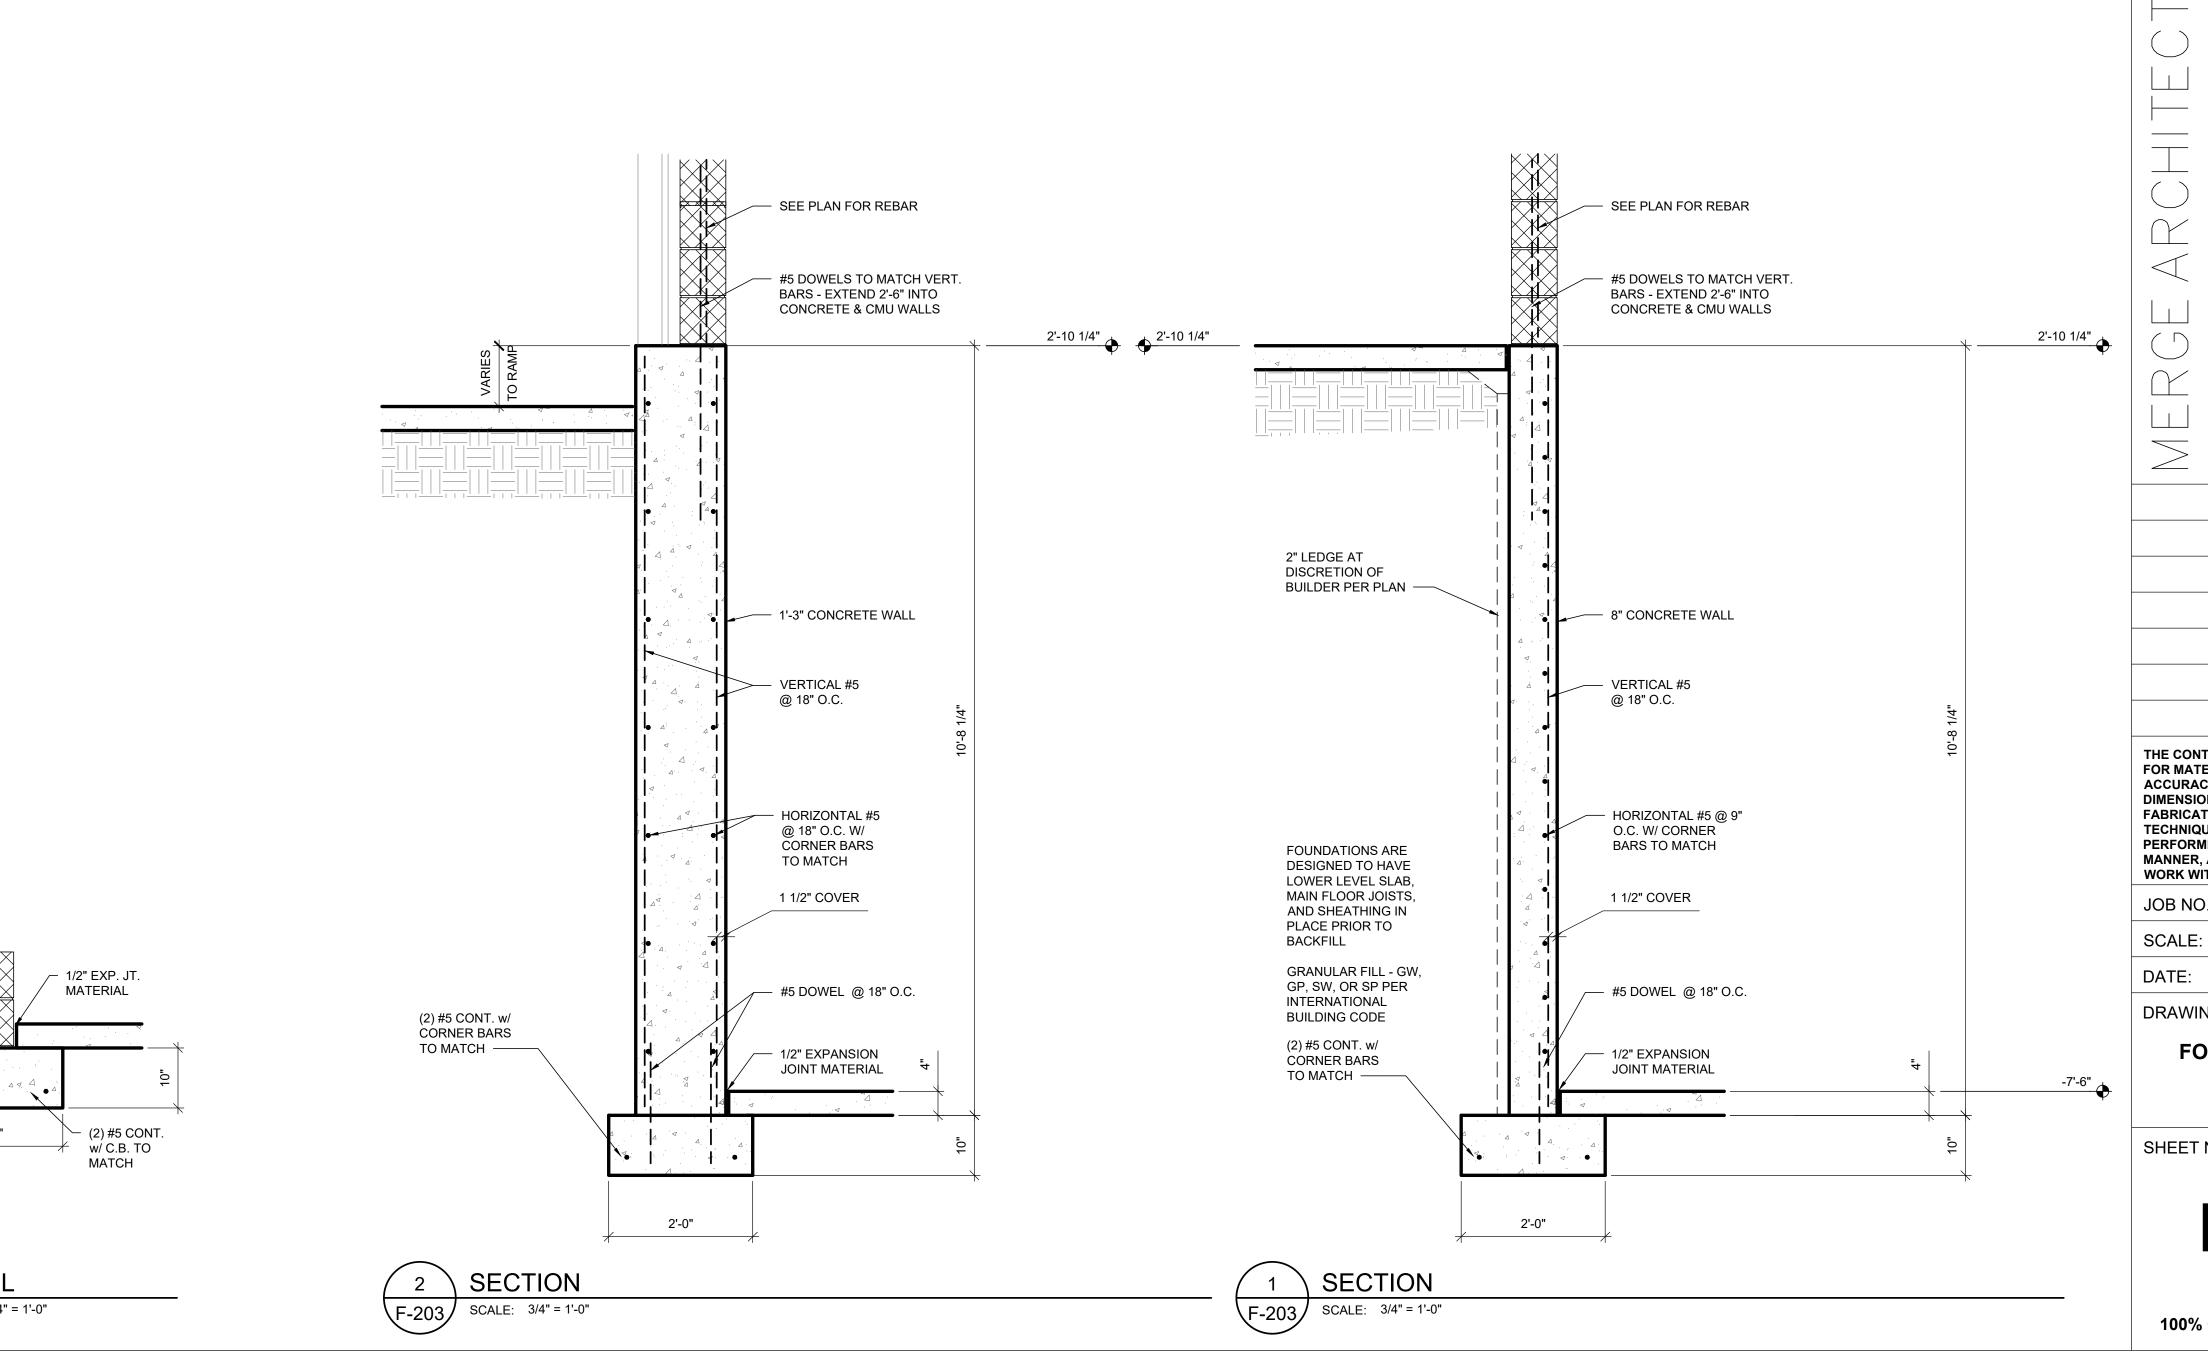

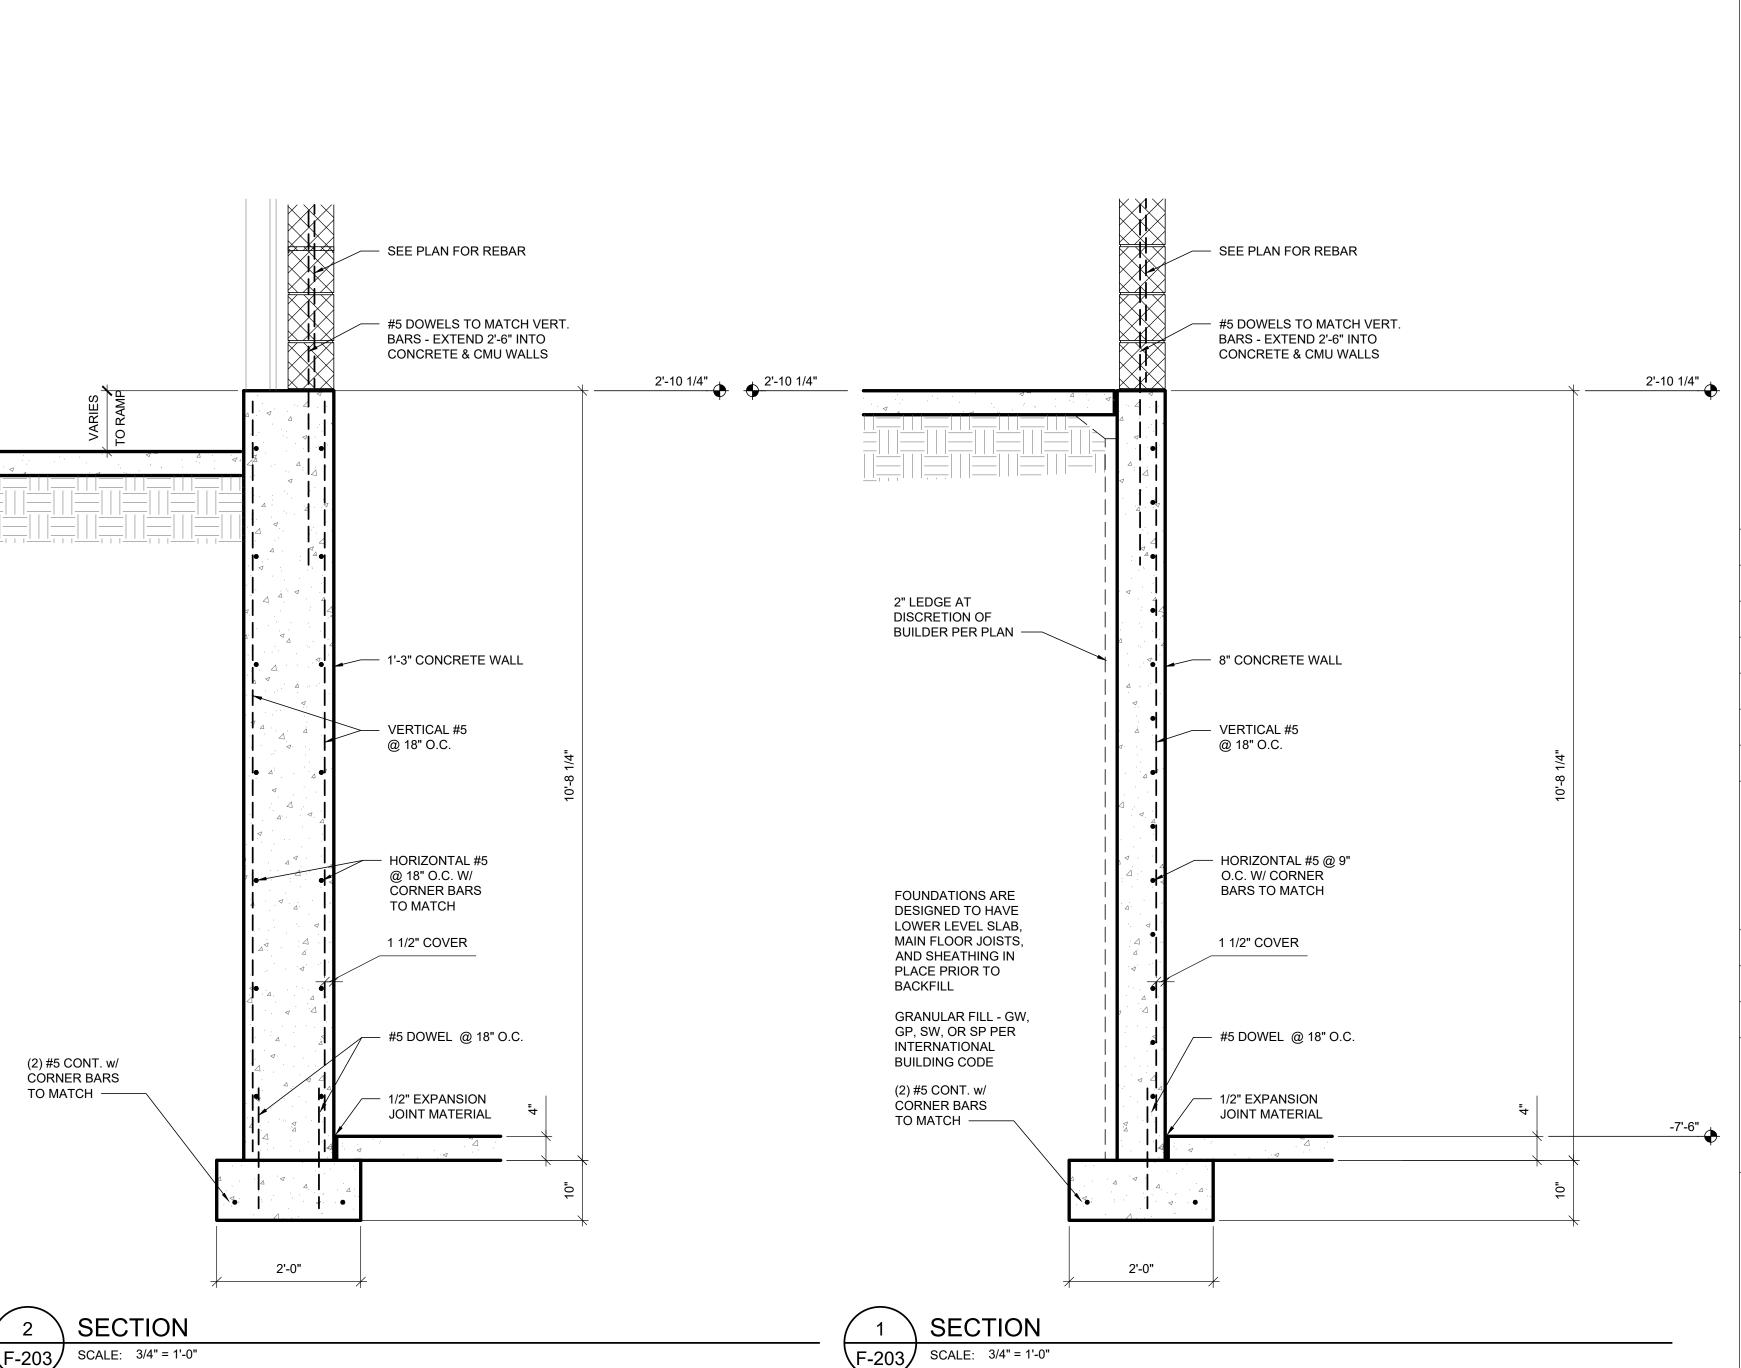

2'-0"


SCALE: 3/4" = 1'-0"

REGISTRATION

OWNER

LAFAYETTE PARK LANDOWNERS LLC.

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Detroit, MI 48
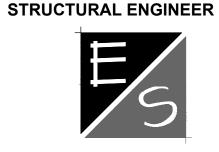
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WORK WITH THAT OF ALL TRADES

JOB NO.:

3/4" = 1'-0"

DATE: 05/15/20 DRAWING TITLE

FOUNDATION DETAILS

SHEET NO.

F-203

GENERAL NOTES -

1. TYPICAL FLOOR CONSTRUCTION TO BE 1" GYPCRETE TOPPING SLAB ON 3/4" T&G APA RATED EXPOSURE 1 SHEATHING GLUED AND SCREWED (OR NAILED) TO 11-7/8" I-JOISTS @ 16" O.C. UNLESS NOTED OTHERWISE.

2. REFER TO STRUCTURAL NOTES SHEET FOR ADDITIONAL INFORMATION / REQUIREMENTS.

3. L-1 - 8" x 16" CMU LINTEL WITH (2) #4 LOCATED AT 2" COVER FROM BOTTOM.

CODE REQUIRED LIVE LOAD DEFLECTION

THE FLOOR TRUSS SUPPLIER SHALL WORK WITH THE DEVELOPER TO DETERMINE THE APPROPRIATE FLOOR SYSTEM BASED ON THEIR BUDGET AND EXPECTATIONS OF FLOOR PERFORMANCE. THE SYSTEM WILL BE DESIGNED FOR THE MORE STRINGENT OF THE FOLLOWING:

MAXIMUM DEFLECTION OF JOISTS UNDER LIVE LOAD SHALL BE SPAN LENGTH DIVIDED BY 480. JOISTS SHALL BE DESIGNED FOR A PERFORMANCE RATING MEETING THE DEVELOPER'S EXPECTATIONS. MAXIMUM TOTAL LOAD DEFLECTION TO BE LESS THAN 0.625". (BASED ON JUDGEMENT OF BUILDER FOR AESTHÉTICS).


FLOOR JOIST SYSTEM DESIGN:

ACCEPTABLE FLOOR JOIST PERFORMANCE IS HIGHLY DEPENDANT ON THE OCCUPANT'S EXPECTATIONS. THEREFORE, FLOOR JOIST SYSTEM SHALL BE DESIGNED AS FOLLOWS:

DESIGN LOADS ARE NOTED ON THE DRAWINGS. REQUIREMENTS ARE SPAN LENGTH DIVIDED BY 360. "ACCEPTED" REQUIREMENTS FOR A "GOOD FEELING" FLOOR HAVE BEEN SET AT SPAN LENGTH DIVIDED BY

7'-4 3/4" W10x26 UPSET

REGISTRATION

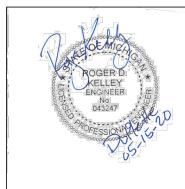

OWNER BRUSH PARK DEVELOPMENT COMPANY PHASE 1 LLC 1092 Woodward Ave. Detroit, MI 48226

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STRUCTURAL ENGINEER



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Detroit, MI 48201

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JOB NO.:

DATE:

SCALE: 1/4" = 1'-0"

05/15/20 DRAWING TITLE

MAIN FLOOR FRAMING PLAN

SHEET NO.

THE ANTICIPATED DIFFERENTIAL MOVEMENT BETWEEN THE BRICK VENEER AND THE WOOD BACK-UP SYSTEM AT THIS LEVEL IS APPROXIMATELY 0.3". THIS IS THE DIFFERENCE BETWEEN BRICK GROWTH AND WOOD

ARCHITECTURAL ITEMS MUST BE COORDINATED AND DETAILED TO ACCOMMODATE THIS MOVEMENT. THIS INCLUDES BUT MAY NOT BE LIMITED TO WINDOW PLACEMENT AND DETAILING.

	HEADER SO	CHEDULE		
MARK	SIZE	BEARING STUDS	KING STUDS	CENTER STUDS
H-1	(2) 2x6	1	1	N/A
H-2	(2) 2x10	2	1	N/A
H-3	(2) 1-3/4 x 5-1/2 LVL	1	1	N/A
H-4	(2) 1-3/4 x 5-1/2 LVL	2	1	N/A
H-5	(2) 1-3/4 x 9-1/2 LVL	2	2	N/A
H-6	(2) 1-3/4 x 5-1/2 LVL	2	1	N/A
H-7	(3) 1-3/4 x 5-1/2 LVL	2	1	N/A
H-8	(3) 1-3/4 x 9-1/2 LVL	3	1	N/A
H-9	(3) 1-3/4 x 9-1/2 LVL	4	1	N/A

GENERAL NOTES -

1. TYPICAL FLOOR CONSTRUCTION TO BE 1" GYPCRETE TOPPING ON 3/4" T&G APA RATED EXPOSURE 1 SHEATHING GLUED AND SCREWED (OR NAILED) TO 18" DEEP PRE-ENGINEERED WOOD FLOOR TRUSSES @ 16" O.C. UNLESS NOTED OTHERWISE.

2. TYPICAL EXTERIOR WALL TO BE 7/16" APA RATED EXPOSURE 1 SHEATHING ON 2x6 SPF #2 @ 16" ON CENTER UNLESS NOTED OTHERWISE. BLOCK BETWEEN STUDS AT ALL SHEET EDGES. NAIL ALL SHEET EDGES WITH 8d @ 6" O.C. UNLESS NOTED OTHERWISE. WALL STUD LAYOUT TO COORD. w/ FLOOR SYSTEM LAYOUT TO STACK FULL HEIGHT OF STRUCTURE.

3. REFER TO STRUCTURAL NOTES SHEET FOR ADDITIONAL INFORMATION / REQUIREMENTS.

4. TYPICAL CORRIDOR FRAMING TO BE 2x6 SPF #2 @ 16" O.C. U.N.O. WALL STUD LAYOUT TO COORD. w/ FLOOR SYSTEM LAYOUT TO STACK FULL HEIGHT OF STRUCTURE.

5. TYPICAL CORRIDOR WALL TO BE DRYWALL BOTH SIDES OF 2x6 SPF #2 @ 16" ON CENTER UNLESS NOTED OTHERWISE. WALL STUD LAYOUT TO COORD. w/ FLOOR SYSTEM LAYOUT TO STACK FULL HEIGHT OF STRUCTURE.


6. DOUBLE TOP PLATE ON MAIN LEVEL IS TO BE LSL MATERIAL TO HELP CONTROL SHRINKAGE.

7. L-1 - 8" x 16" CMU LINTEL WITH (2) #4 LOCATED AT 2" COVER FROM BOTTOM.

8. SHEATH CORRIDOR WALLS. REFER TO SHEAR WALL ELEVATIONS.

9. SIMPSON HGUM5.25-SDS x 11" TALL. GROUT 16" WIDE SECTION OF WALL SOLID FROM (2) COURSES ABOVE TO FOUNDATION.

10. SIMPSON HUC616 (MAX). PROVIDE (26) $\frac{1}{4}$ x 2 $\frac{3}{4}$ TITEN 2 ANCHORS TO CMU AND (12) 0.162 x 3-1/2 NAILS TO LVL. GROUT 16" WIDE SECTION OF WALL SOLID FROM (2) COURSES ABOVE TO (3) COURSES BELOW.

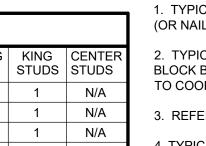


FLOOR JOIST SYSTEM DESIGN:

ACCEPTABLE FLOOR JOIST PERFORMANCE IS HIGHLY DEPENDANT ON THE OCCUPANT'S EXPECTATIONS. THEREFORE, FLOOR JOIST SYSTEM SHALL BE DESIGNED AS FOLLOWS:

DESIGN LOADS ARE NOTED ON THE DRAWINGS. CODE REQUIRED LIVE LOAD DEFLECTION REQUIREMENTS ARE SPAN LENGTH DIVIDED BY 360. "ACCEPTED" REQUIREMENTS FOR A "GOOD FEELING" FLOOR HAVE BEEN SET AT SPAN LENGTH DIVIDED BY

THE FLOOR TRUSS SUPPLIER SHALL WORK WITH THE DEVELOPER TO DETERMINE THE APPROPRIATE FLOOR SYSTEM BASED ON THEIR BUDGET AND EXPECTATIONS OF FLOOR PERFORMANCE. THE SYSTEM WILL BE DESIGNED FOR THE MORE STRINGENT OF THE FOLLOWING:

MAXIMUM DEFLECTION OF JOISTS UNDER LIVE LOAD SHALL BE SPAN LENGTH DIVIDED BY 480. JOISTS SHALL BE DESIGNED FOR A PERFORMANCE RATING MEETING THE DEVELOPER'S EXPECTATIONS. MAXIMUM TOTAL LOAD DEFLECTION TO BE LESS THAN 0.625". (BASED ON JUDGEMENT OF BUILDER FOR

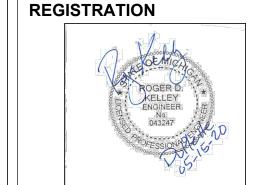

OWNER BRUSH PARK DEVELOPMENT COMPANY PHASE 1 LLC

ARCHITECT MERGE ARCHITECTS, INC.

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uPlette Brush

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JOB NO.:


1/8" = 1'-0" SCALE: DATE: 05/15/20

DRAWING TITLE

SECOND FLOOR FRAMING PLAN

SHEET NO.

S-102

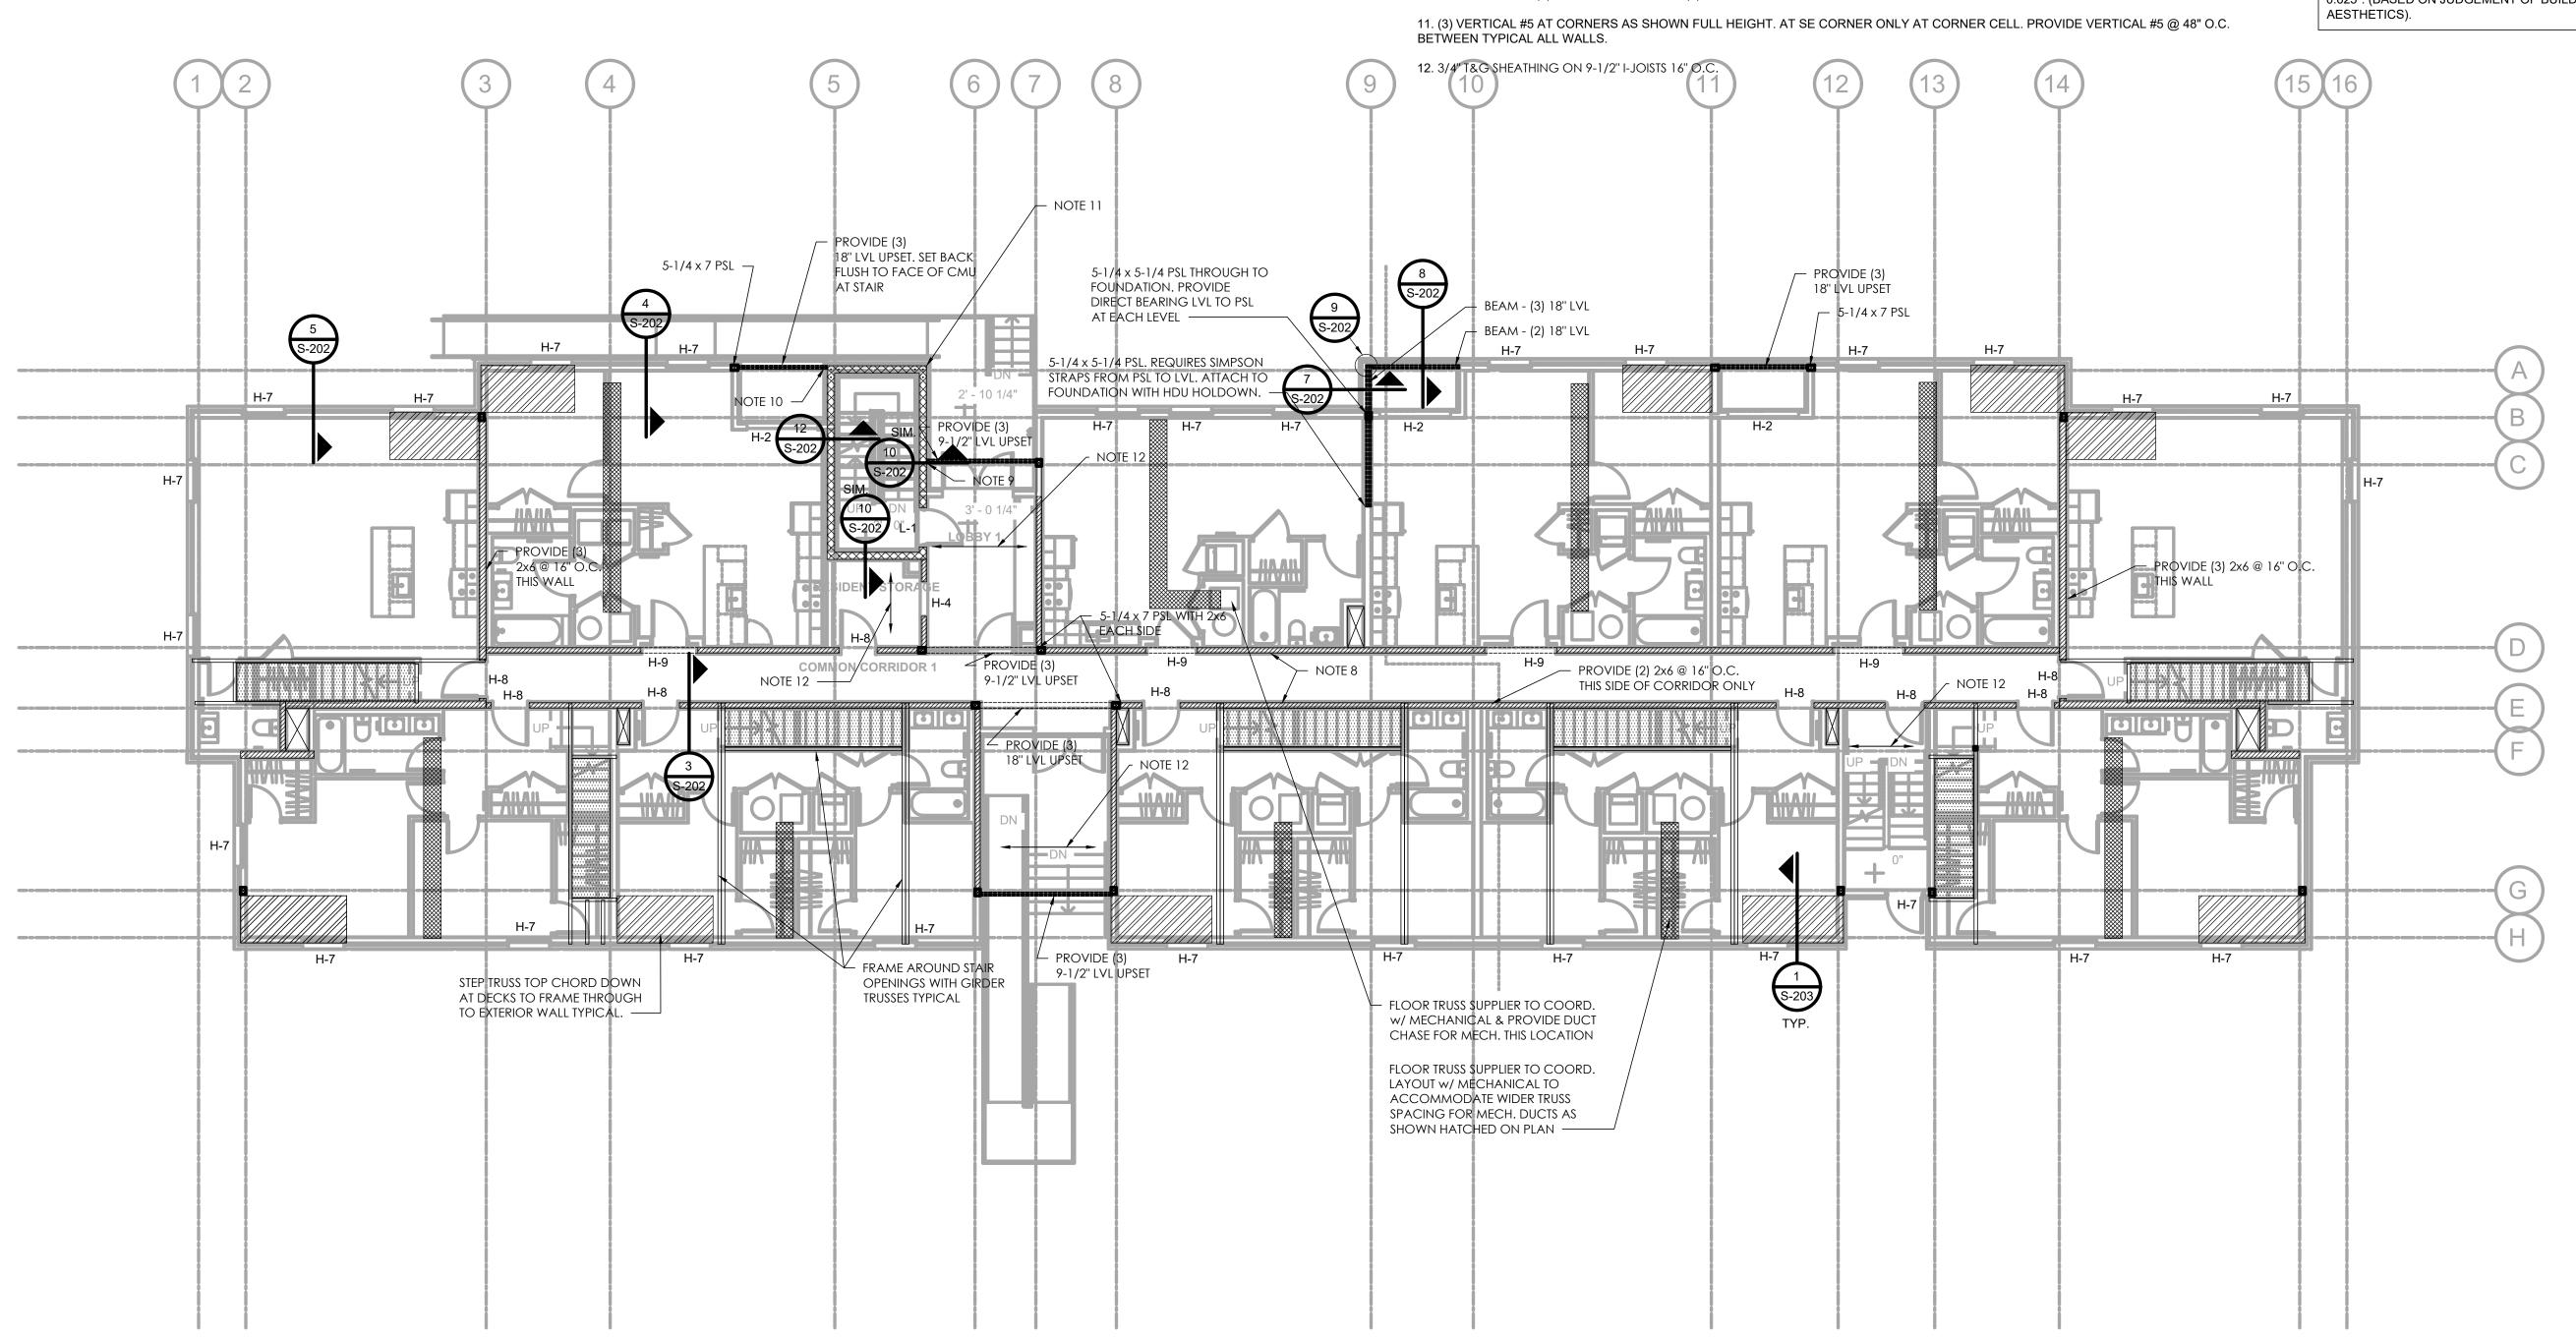

THE ANTICIPATED DIFFERENTIAL MOVEMENT BETWEEN THE BRICK VENEER AND THE WOOD BACK-UP SYSTEM AT THIS LEVEL IS APPROXIMATELY 0.6". THIS IS THE DIFFERENCE BETWEEN BRICK GROWTH AND WOOD SHRINKAGE.

ARCHITECTURAL ITEMS MUST BE COORDINATED AND DETAILED TO ACCOMMODATE THIS MOVEMENT. THIS INCLUDES BUT MAY NOT BE LIMITED TO WINDOW PLACEMENT AND DETAILING.

1. TYPICAL FLOOR CONSTRUCTION TO BE 1" GYPCRETE TOPPING ON 3/4" T&G APA RATED EXPOSURE 1 SHEATHING GLUED AND SCREWED (OR NAILED) TO 18" DEEP PRE-ENGINEERED WOOD FLOOR TRUSSES @ 16" O.C. UNLESS NOTED OTHERWISE.

> 2. TYPICAL EXTERIOR WALL TO BE 7/16" APA RATED EXPOSURE 1 SHEATHING ON 2x6 SPF #2 @ 16" ON CENTER UNLESS NOTED OTHERWISE. BLOCK BETWEEN STUDS AT ALL SHEET EDGES. NAIL ALL SHEET EDGES WITH 8d @ 6" O.C. UNLESS NOTED OTHERWISE. WALL STUD LAYOUT TO COORD. w/ FLOOR SYSTEM LAYOUT TO STACK FULL HEIGHT OF STRUCTURE.

3. REFER TO STRUCTURAL NOTES SHEET FOR ADDITIONAL INFORMATION / REQUIREMENTS.

4. TYPICAL CORRIDOR FRAMING TO BE 2x10 SPF #2 @ 16" O.C.

5. TYPICAL CORRIDOR WALL TO BE DRYWALL BOTH SIDES OF 2x6 SPF #2 @ 16" ON CENTER UNLESS NOTED OTHERWISE. WALL STUD LAYOUT TO COORD. w/ FLOOR SYSTEM LAYOUT TO STACK FULL HEIGHT OF STRUCTURE.

6. WALL DOUBLE TOP PLATE AND BOTTOM SOLE PLATE TO BE LSL MATERIAL THIS LEVEL TO HELP CONTROL SHRINKAGE.

7. L-1 - 8" x 16" CMU LINTEL WITH (2) #4 LOCATED AT 2" COVER FROM BOTTOM.

8. 3/4" T&G SHEATHING ON 9-1/2" I-JOISTS 16" O.C.

GENERAL NOTES -

ACCEPTABLE FLOOR JOIST PERFORMANCE IS HIGHLY DEPENDANT ON THE OCCUPANT'S EXPECTATIONS. THEREFORE, FLOOR JOIST SYSTEM SHALL BE DESIGNED AS FOLLOWS:


FLOOR JOIST SYSTEM DESIGN:

DESIGN LOADS ARE NOTED ON THE DRAWINGS. CODE REQUIRED LIVE LOAD DEFLECTION REQUIREMENTS ARE SPAN LENGTH DIVIDED BY 360. "ACCEPTED" REQUIREMENTS FOR A "GOOD FEELING" FLOOR HAVE BEEN SET AT SPAN LENGTH DIVIDED BY

THE FLOOR TRUSS SUPPLIER SHALL WORK WITH THE DEVELOPER TO DETERMINE THE APPROPRIATE FLOOR SYSTEM BASED ON THEIR BUDGET AND EXPECTATIONS OF FLOOR PERFORMANCE. THE SYSTEM WILL BE DESIGNED FOR THE MORE STRINGENT OF THE FOLLOWING:

MAXIMUM DEFLECTION OF JOISTS UNDER LIVE LOAD SHALL BE SPAN LENGTH DIVIDED BY 480. JOISTS SHALL BE DESIGNED FOR A PERFORMANCE RATING MEETING THE DEVELOPER'S EXPECTATIONS. MAXIMUM TOTAL LOAD DEFLECTION TO BE LESS THAN 0.625". (BASED ON JUDGEMENT OF BUILDER FOR AESTHÉTICS).

REGISTRATION

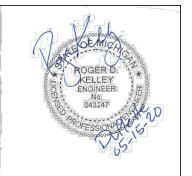

OWNER BRUSH PARK DEVELOPMENT COMPANY PHASE 1 LLC 1092 Woodward Ave.

ARCHITECT MERGE ARCHITECTS, INC.

BOSTON, MA 02210 T: 617.670.0265 STRUCTURAL ENGINEER



ENGINEERED STRUCTURES, LLC T: 616.667.9650

uPlette

Brush Pa One Edmund Plac and John R. St. Detroit, MI 48201

THE CONTRACTOR IS RESPONSIBLE FOR MATERIALS, DETAILS AND ACCURACY, FOR ALL QUANTITIES AND DIMENSIONS, FOR SELECTING FABRICATION PROCESSES, FOR TECHNIQUES OF ASSEMBLY, FOR PERFORMING WORK IN A SAFE MANNER, AND FOR COORDINATING **WORK WITH THAT OF ALL TRADES**

JOB NO.:

DATE:


1/8" = 1'-0" SCALE: 05/15/20

DRAWING TITLE

THIRD FLOOR FRAMING **PLAN**

SHEET NO.

S-103

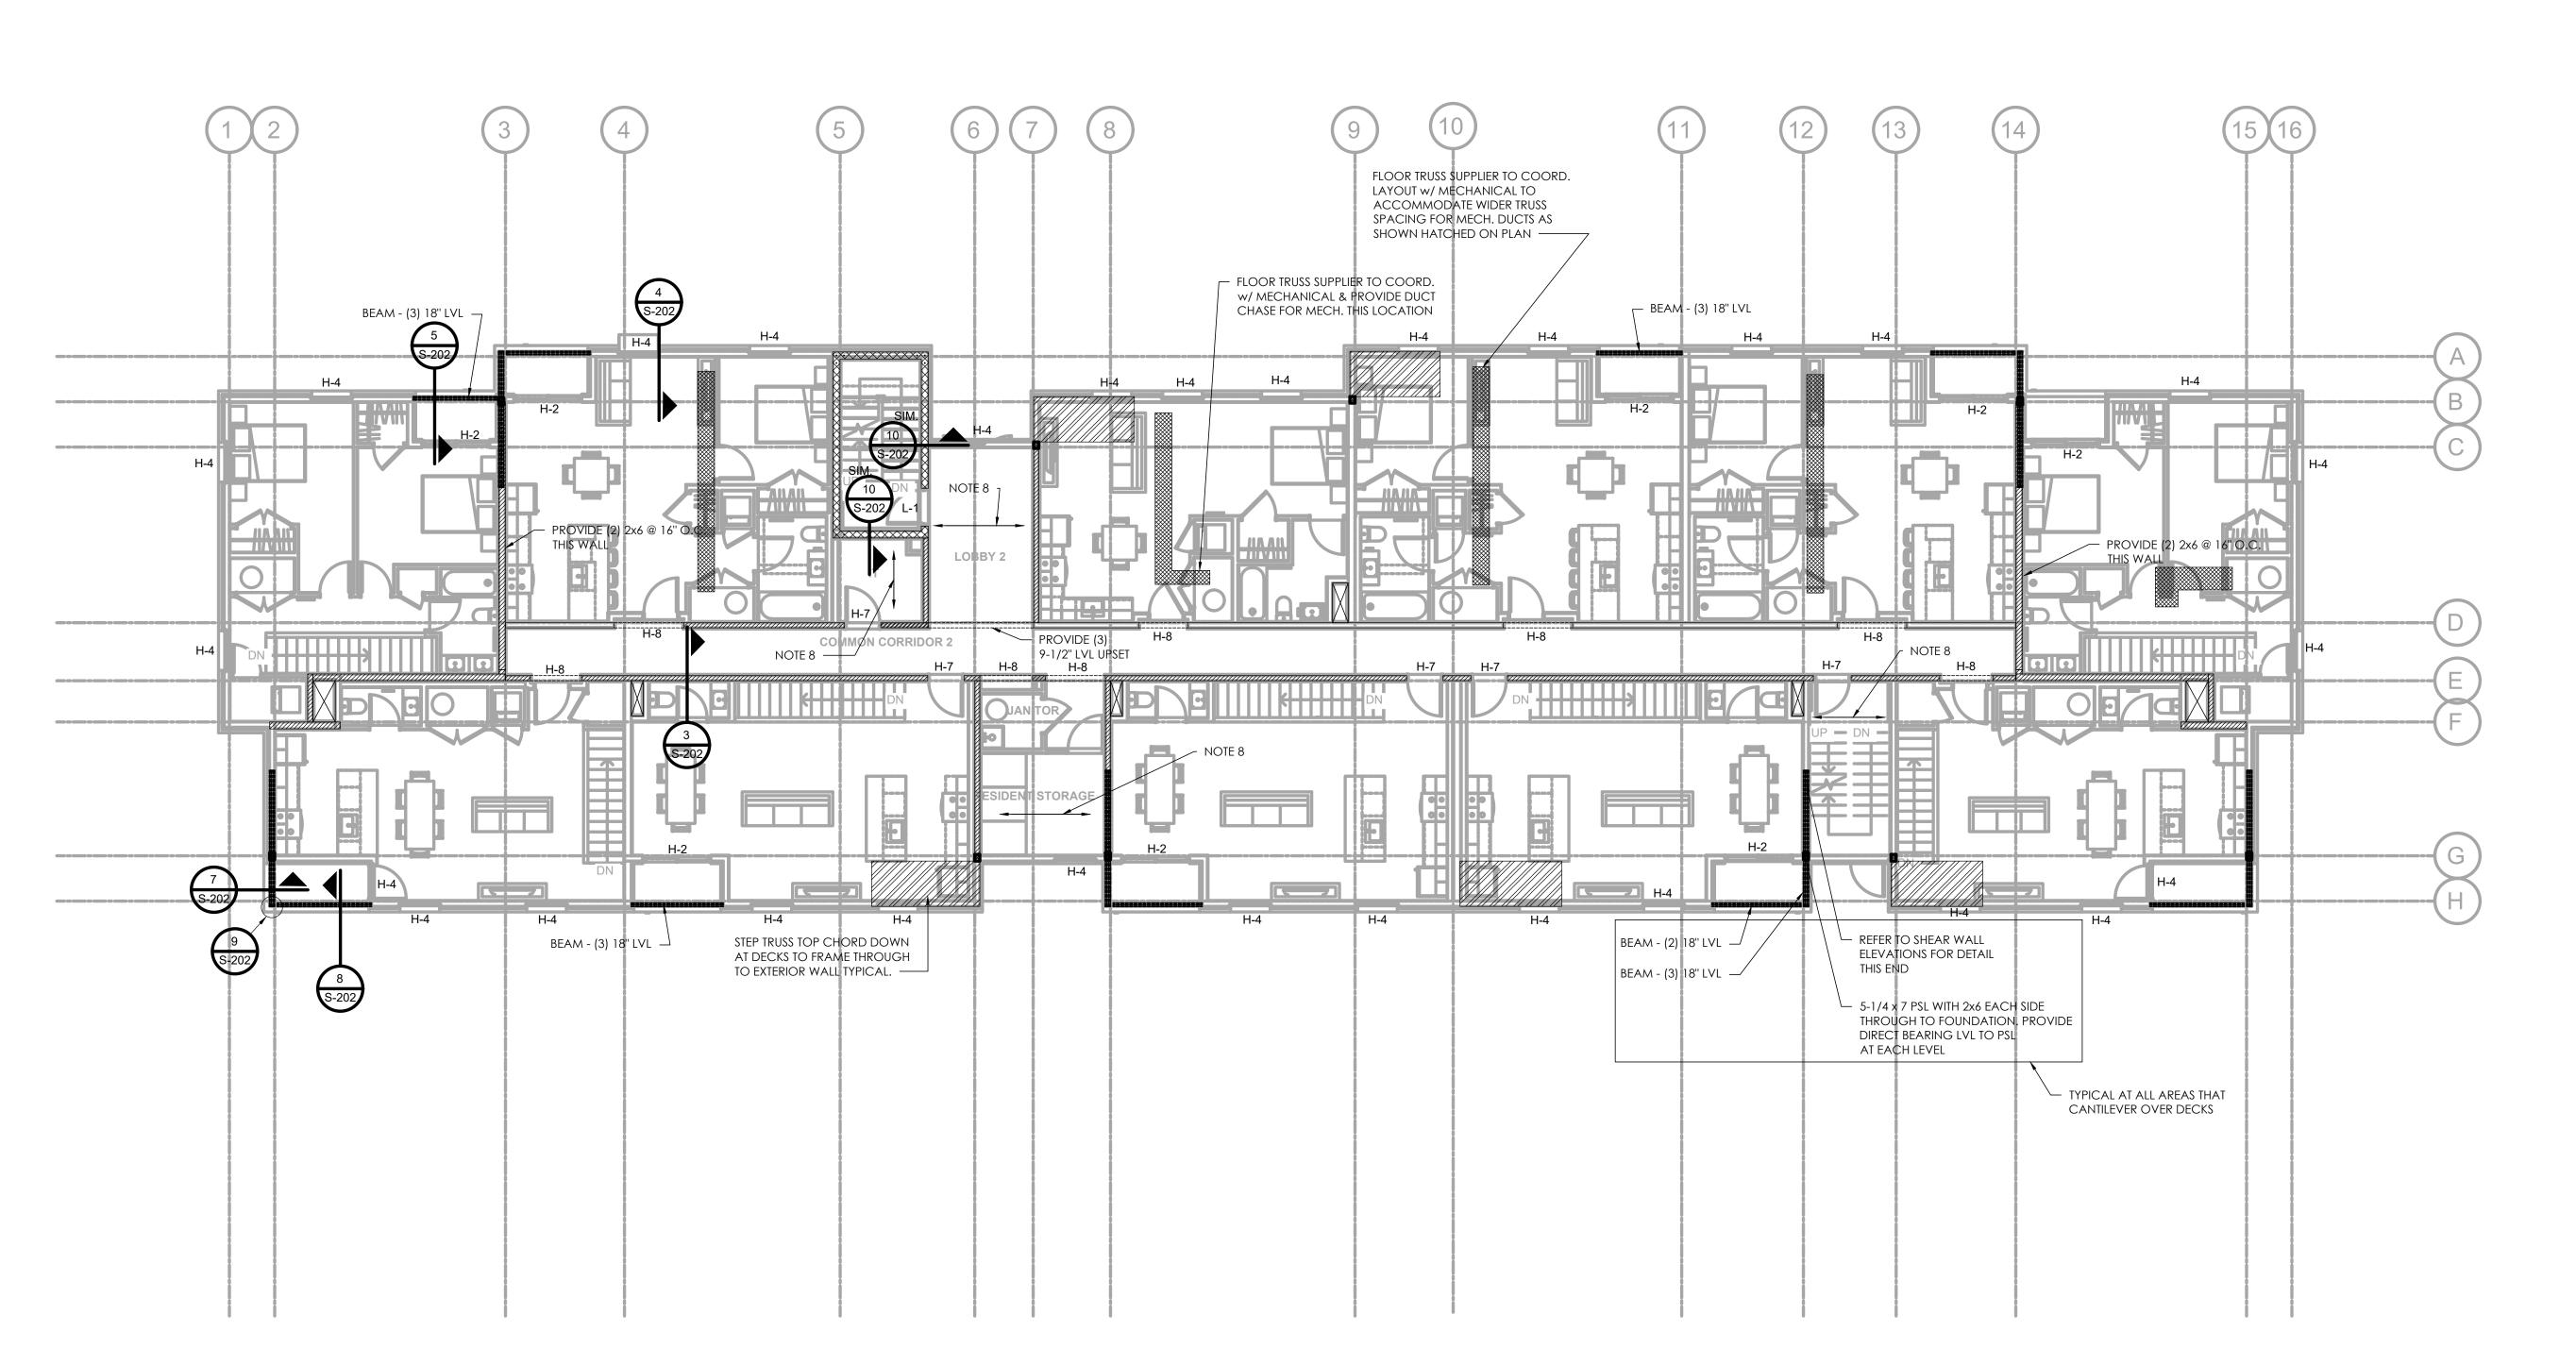

THE ANTICIPATED DIFFERENTIAL MOVEMENT BETWEEN THE BRICK VENEER AND THE WOOD BACK-UP SYSTEM AT THIS LEVEL IS APPROXIMATELY 0.9". THIS IS THE DIFFERENCE BETWEEN BRICK GROWTH AND WOOD SHRINKAGE.

ARCHITECTURAL ITEMS MUST BE COORDINATED AND DETAILED TO ACCOMMODATE THIS MOVEMENT. THIS INCLUDES BUT MAY NOT BE LIMITED TO WINDOW PLACEMENT AND DETAILING.

GENERAL NOTES -

1. TYPICAL FLOOR CONSTRUCTION TO BE 1" GYPCRETE TOPPING ON 3/4" T&G APA RATED EXPOSURE 1 SHEATHING GLUED AND SCREWED (OR NAILED) TO 18" DEEP PRE-ENGINEERED WOOD FLOOR TRUSSES @ 16" O.C. UNLESS NOTED OTHERWISE.

2. TYPICAL EXTERIOR WALL TO BE 7/16" APA RATED EXPOSURE 1 SHEATHING ON 2x6 SPF #2 @ 16" ON CENTER UNLESS NOTED OTHERWISE. BLOCK BETWEEN STUDS AT ALL SHEET EDGES. NAIL ALL SHEET EDGES WITH 8d @ 6" O.C. UNLESS NOTED OTHERWISE. WALL STUD LAYOUT TO COORD. w/ FLOOR SYSTEM LAYOUT TO STACK FULL HEIGHT OF STRUCTURE.

3. REFER TO STRUCTURAL NOTES SHEET FOR ADDITIONAL INFORMATION / REQUIREMENTS.

4. TYPICAL ROOF CONSTRUCTION TO BE 5/8" APA RATED EXPOSURE 1 SHEATHING WITH CLIPS ON PRE-ENGINEERED WOOD ROOF TRUSSES @ 24" O.C. UNLESS NOTED OTHERWISE.

5. FRAME AROUND DECK WITH GIRDER TRUSSES. ALSO DESIGN GIRDER TRUSS TO SUPPORT ROOF ABOVE.

6. 12'-0" LONG LVL AT CANTILEVERS. PROVIDE HOLDOWN AT BACKSPAN END AT EACH.

7. TYPICAL CORRIDOR FRAMING TO BE 2x10 SPF #2 @ 16" O.C. WALL STUD LAYOUT TO COORD. w/ FLOOR SYSTEM LAYOUT TO STACK FULL HEIGHT OF STRUCTURE.

8. TYPICAL CORRIDOR WALL TO BE DRYWALL BOTH SIDES OF 2x6 SPF #2 @ 16" ON CENTER UNLESS NOTED OTHERWISE.

9. L-1 - 8" x 16" CMU LINTEL WITH (2) #4 LOCATED AT 2" COVER FROM BOTTOM.

10. 3/4" T&G SHEATHING ON 9-1/2" I-JOISTS 16" O.C.; T/SHEATHING = 33'-10 3/4"

11. REFER TO 8/S203 FOR TOP RAIL CONNX. TO CMU

12. 3/4" T&G SHEATHING ON 9-1/2" I-JOISTS 16" O.C. AT TYPICAL FLOOR ELEVATION


FLOOR JOIST SYSTEM DESIGN:

ACCEPTABLE FLOOR JOIST PERFORMANCE IS HIGHLY DEPENDANT ON THE OCCUPANT'S EXPECTATIONS. THEREFORE, FLOOR JOIST SYSTEM SHALL BE DESIGNED AS FOLLOWS:

DESIGN LOADS ARE NOTED ON THE DRAWINGS. CODE REQUIRED LIVE LOAD DEFLECTION REQUIREMENTS ARE SPAN LENGTH DIVIDED BY 360. "ACCEPTED" REQUIREMENTS FOR A "GOOD FEELING" FLOOR HAVE BEEN SET AT SPAN LENGTH DIVIDED BY

THE FLOOR TRUSS SUPPLIER SHALL WORK WITH THE DEVELOPER TO DETERMINE THE APPROPRIATE FLOOR SYSTEM BASED ON THEIR BUDGET AND EXPECTATIONS OF FLOOR PERFORMANCE. THE SYSTEM WILL BE DESIGNED FOR THE MORE STRINGENT OF THE FOLLOWING:

MAXIMUM DEFLECTION OF JOISTS UNDER LIVE LOAD SHALL BE SPAN LENGTH DIVIDED BY 480. JOISTS SHALL BE DESIGNED FOR A PERFORMANCE RATING MEETING THE DEVELOPER'S EXPECTATIONS. MAXIMUM TOTAL LOAD DEFLECTION TO BE LESS THAN 0.625". (BASED ON JUDGEMENT OF BUILDER FOR AESTHETICS).

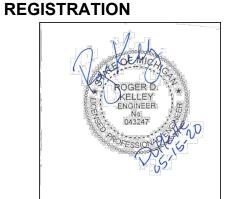

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BOSTON, MA 02210 T: 617.670.0265



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THE CONTRACTOR IS RESPONSIBLE FOR MATERIALS, DETAILS AND ACCURACY, FOR ALL QUANTITIES AND **DIMENSIONS, FOR SELECTING FABRICATION PROCESSES, FOR TECHNIQUES OF ASSEMBLY, FOR** PERFORMING WORK IN A SAFE MANNER, AND FOR COORDINATING **WORK WITH THAT OF ALL TRADES**

JOB NO.:

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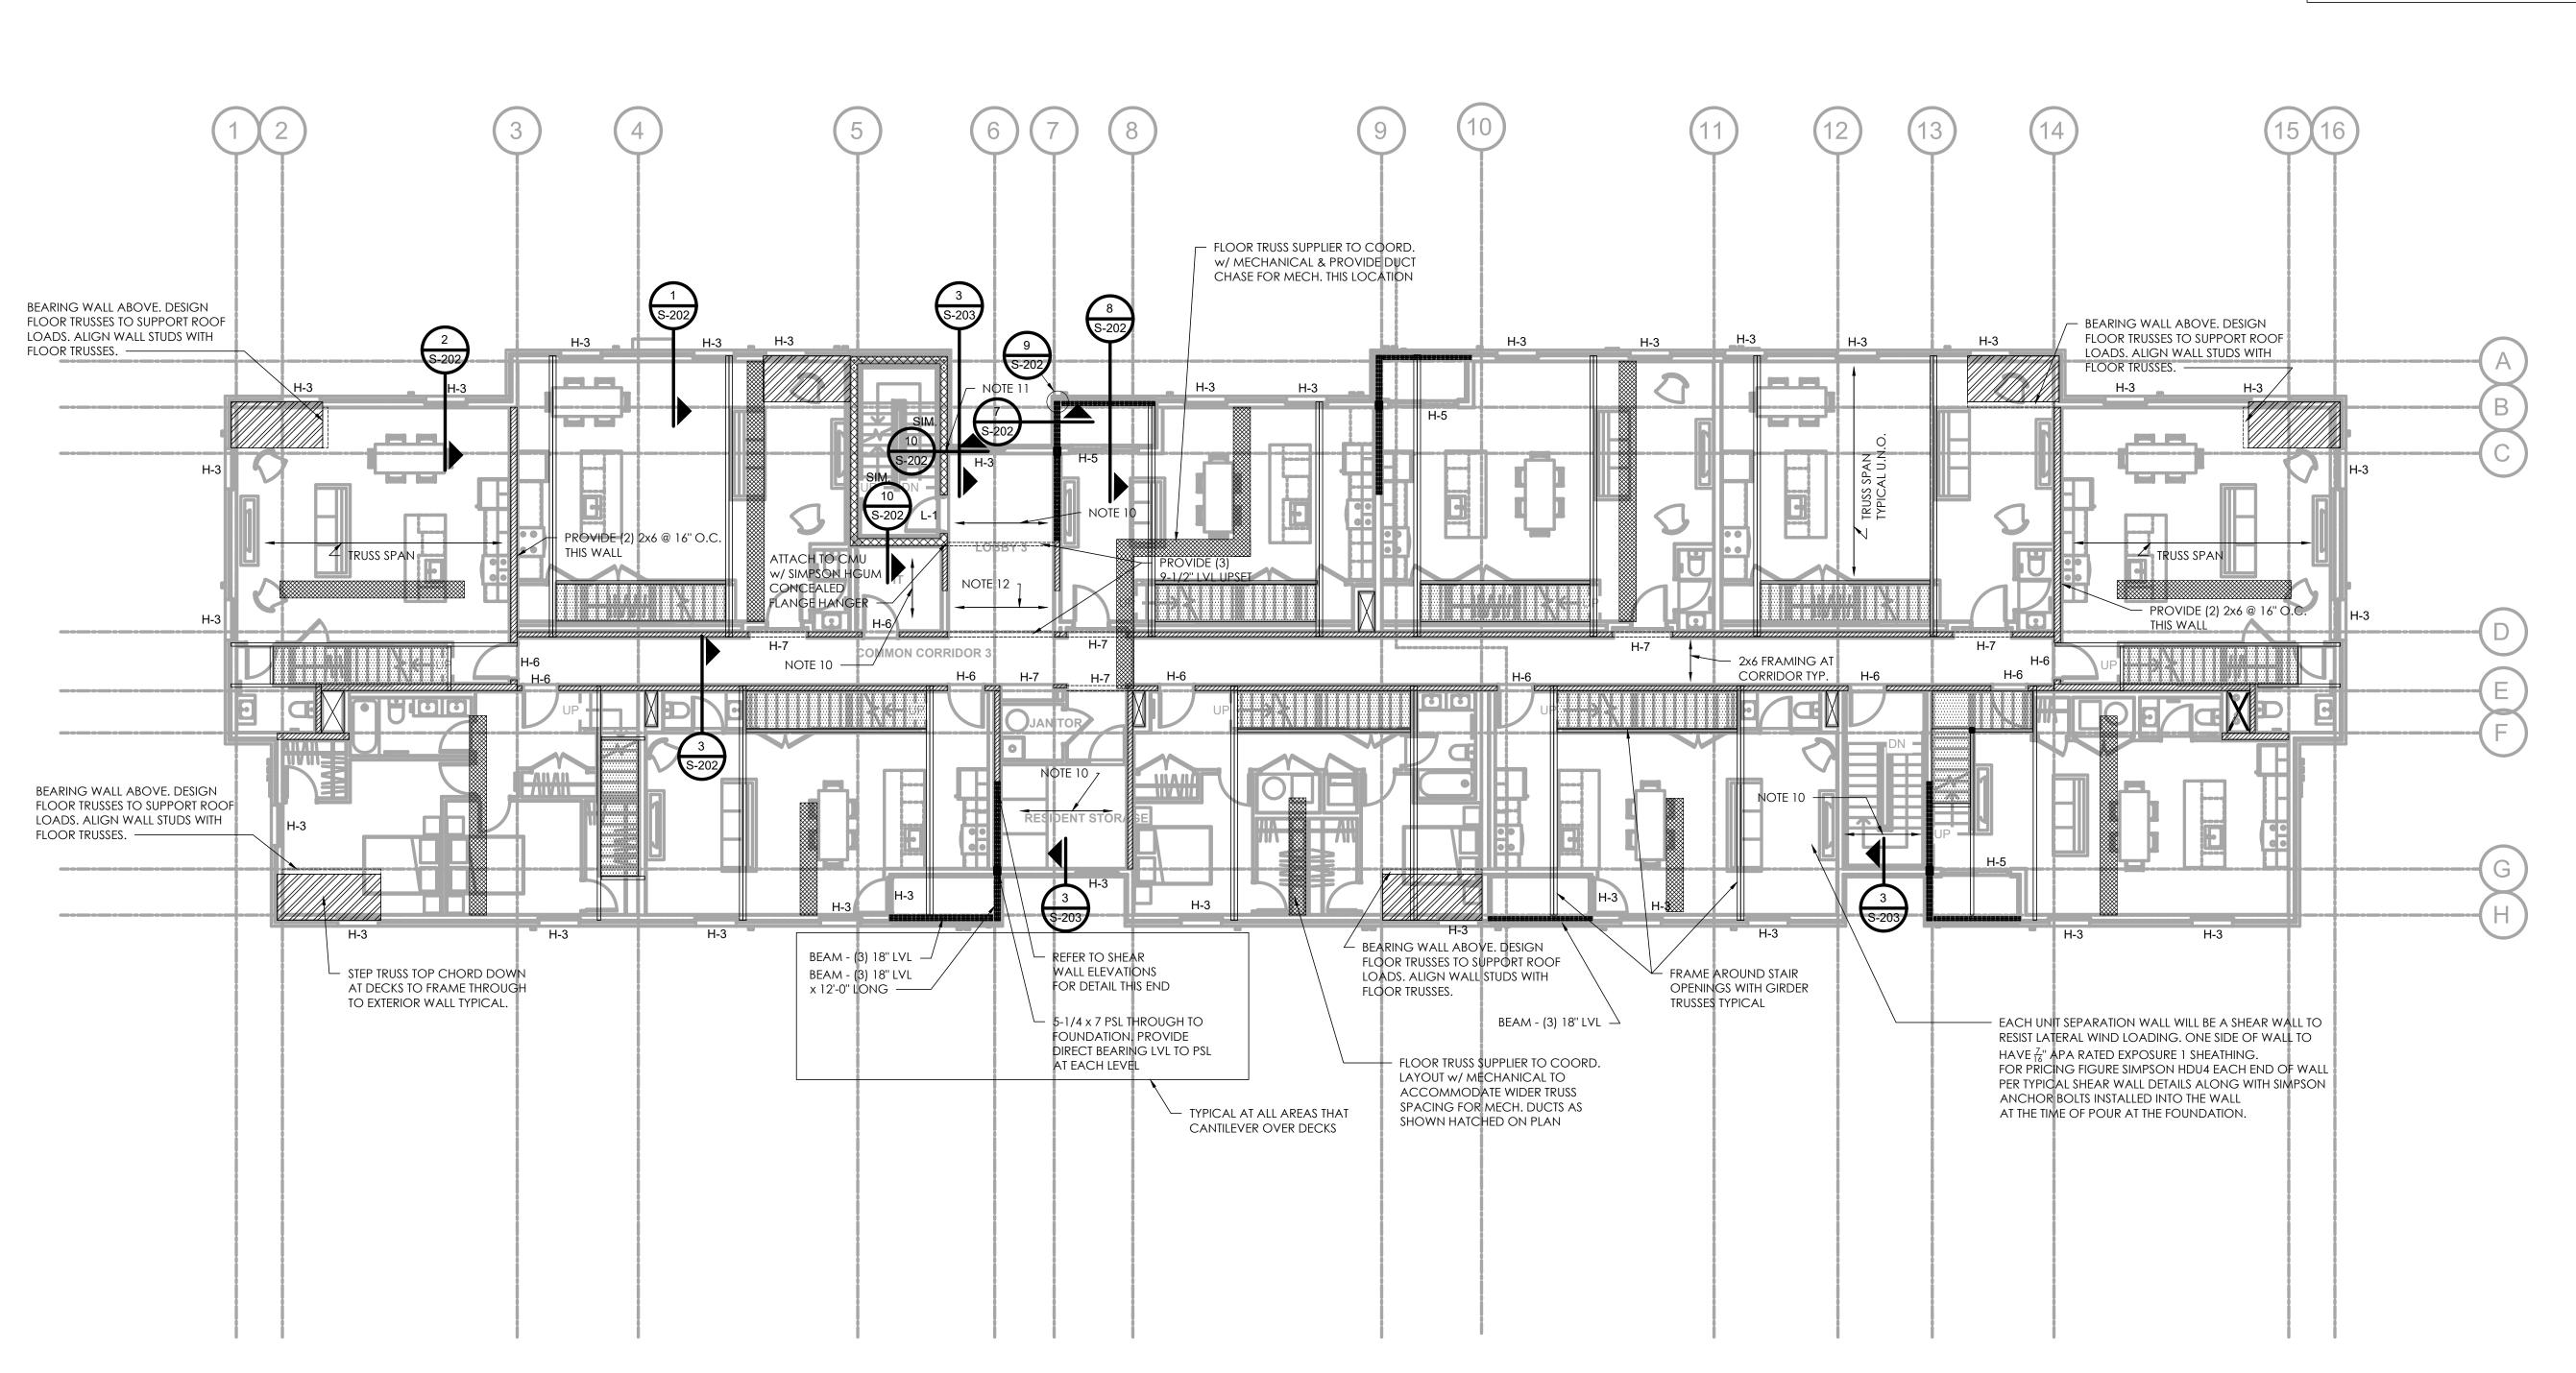
1/8" = 1'-0" SCALE:

05/15/20

DRAWING TITLE

FOURTH FLOOR FRAMING PLAN

SHEET NO.



THE ANTICIPATED DIFFERENTIAL MOVEMENT BETWEEN THE BRICK VENEER AND THE WOOD BACK-UP SYSTEM AT THIS LEVEL IS APPROXIMATELY 1.2". THIS IS THE DIFFERENCE BETWEEN BRICK GROWTH AND WOOD SHRINKAGE.

ARCHITECTURAL ITEMS MUST BE COORDINATED AND DETAILED TO ACCOMMODATE THIS MOVEMENT. THIS INCLUDES BUT MAY NOT BE LIMITED TO WINDOW PLACEMENT AND DETAILING.

1. TYPICAL EXTERIOR WALL TO BE 7/16" APA RATED EXPOSURE 1 SHEATHING ON 2x6 SPF #2 @ 16" ON CENTER UNLESS NOTED OTHERWISE. BLOCK BETWEEN STUDS AT ALL SHEET EDGES. NAIL ALL SHEET EDGES WITH 8d @ 6" O.C. UNLESS NOTED OTHERWISE. WALL STUD LAYOUT TO COORD. w/ FLOOR SYSTEM LAYOUT TO STACK FULL HEIGHT OF STRUCTURE.


2. REFER TO STRUCTURAL NOTES SHEET FOR ADDITIONAL INFORMATION / REQUIREMENTS.

3. TYPICAL ROOF CONSTRUCTION TO BE 5/8" APA RATED EXPOSURE 1 SHEATHING ON 20" DEEP PRE-ENGINEERED WOOD ROOF TRUSSES @ 24" O.C. UNLESS NOTED OTHERWISE. LUMBER SUPPLIER TO VERIFY TRUSS DEPTH AND COORDINATE WITH ENGINEERED STRUCTURES, LLC WITH ANY REQUIRED REVISIONS.

4. TYPICAL CORRIDOR WALL TO BE DRYWALL BOTH SIDES ARCHITECT OF 2x6 SPF #2 @ 16" ON CENTER UNLESS NOTED OTHERWISE. WALL STUD LAYOUT TO COORD. W/ FLOOR
SYSTEM LAYOUT TO STACK FULL HEIGHT OF STRUCTURE.

MERGE ARCHITECTS, INC.
332 CONGRESS ST. FLOOR 6
BOSTON, MA 02210
T: 617.670.0265

GENERAL NOTES -

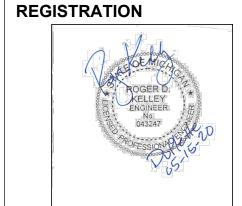

OWNER BRUSH PARK DEVELOPMENT COMPANY PHASE 1 LLC 1092 Woodward Ave. Detroit, MI 48226

STRUCTURAL ENGINEER



ENGINEERED STRUCTURES, LLC T: 616.667.9650 es2@comcast.net

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THE CONTRACTOR IS RESPONSIBLE
FOR MATERIALS, DETAILS AND
ACCURACY, FOR ALL QUANTITIES AND
DIMENSIONS, FOR SELECTING
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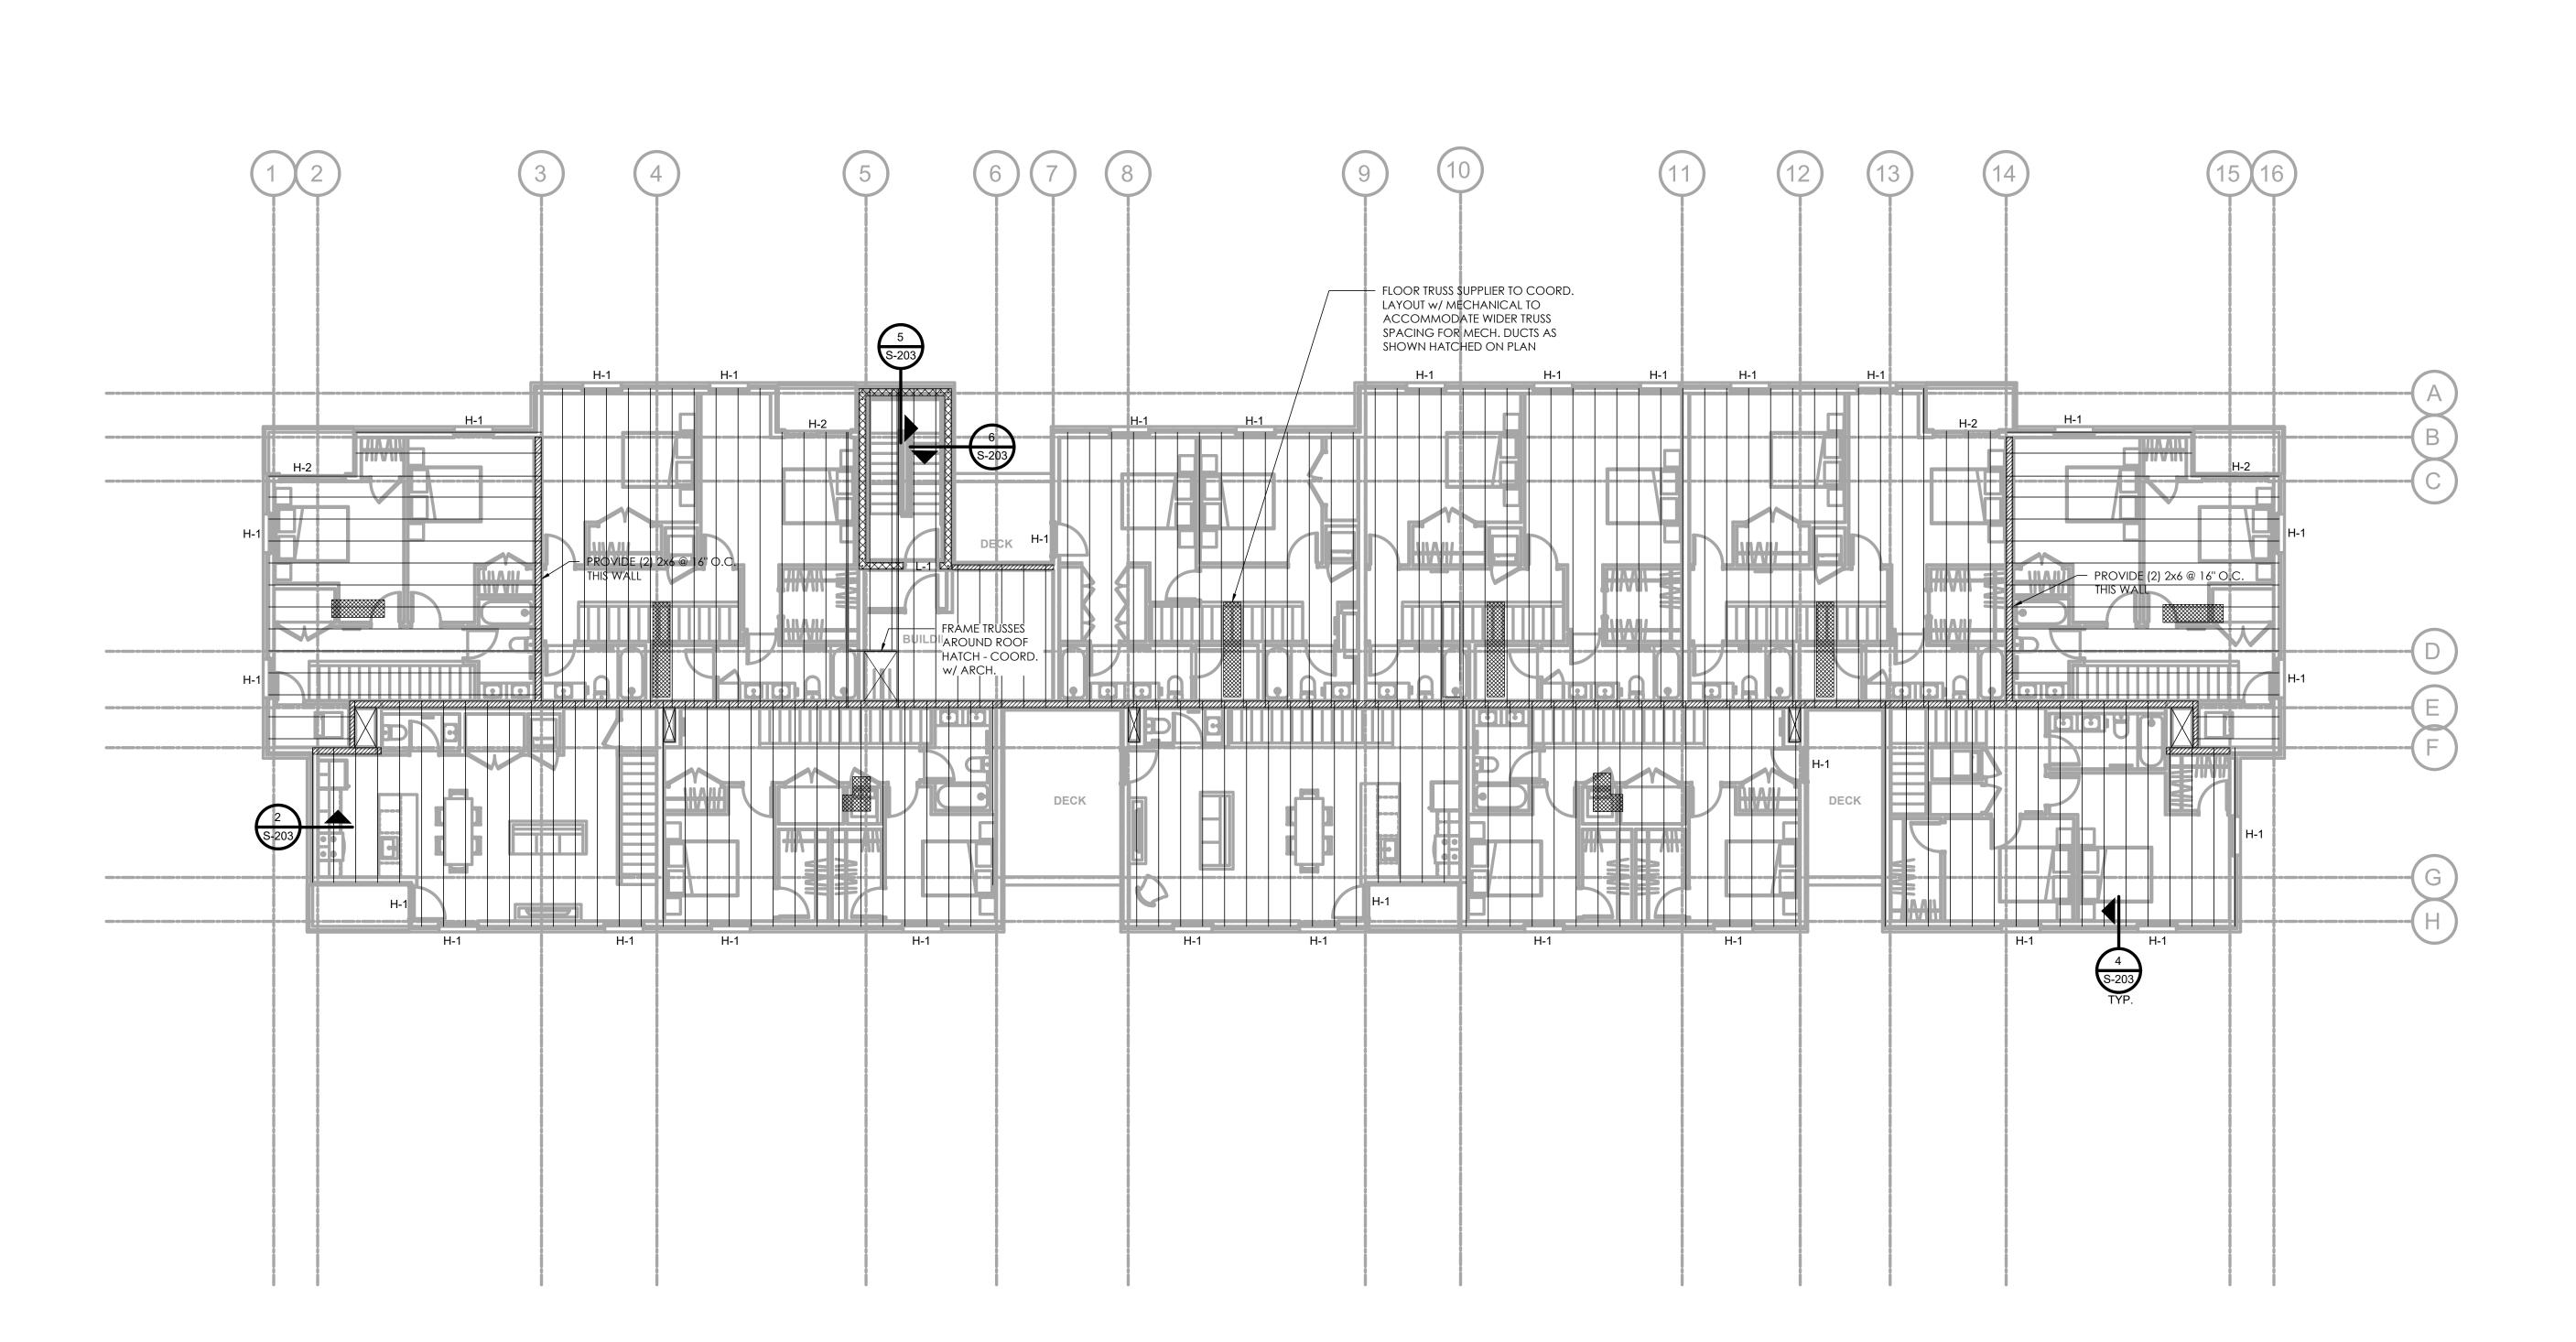
SCALE: 1/8" = 1'-0" 05/15/20

DRAWING TITLE

ROOF FRAMING PLAN

SHEET NO.

S-105



STRUCTURAL LUMBER:

1. ALLWOOD CONSTRUCTION SHALL CONFORM TO THE NATIONAL DESIGN SPECIFICATION FOR WOOD CONSTRUCTION LATEST EDITION AND THE CURRENT MICHIGAN BUILDING CODE AND/OR LATEST MICHIGAN RESIDENTIAL CODE.

2. STRUCTURAL FRAMING MEMBERS ARE SHOWN AS A GENERAL LAYOUT ONLY. EXACT PLACEMENT SHALL BE VERIFIED IN THE FIELD. HOWEVER, FRAMING PLACEMENT SHALL NOT EXCEED THE SPACING SHOWN ON THE DRAWINGS.

3. ALL ROOF SHEATHING SHALL BE APA RATED SHEATHING, EXPOSURE 1 WITH A MINIMUM THICKNESS OF $\frac{1}{2}$ " WITH CLIPS UNLESS NOTED OTHERWISE ON THE CONSTRUCTION DOCUMENTS AND A SPAN RATING MEETING OR EXCEEDING THAT REQUIRED FOR THE DESIGN LOADS AND SPACING OF SUPPORTS.

4. ALL SHEATHING SHALL BE INSTALLED CONTINUOUS OVER TWO OR MORE SPANS WITH FACE GRAIN ACROSS SUPPORTS. UNLESS OTHERWISE INDICATED, SHEATHING SHALL BE NAILED AT 6" ON CENTER ALONG PANEL EDGES AND AT 12" ON CENTER ALONG INTERMEDIATE SUPPORTS IN THE FIELD OF THE PANEL WITH 8d RING SHANK NAILS. ALLOW %" GAP AT PANEL EDGES AND ENDS.

5. NO MEMBER MAY BE MODIFIED WITHOUT WRITTEN APPROVAL FROM ENGINEERED STRUCTURES, LLC.

6. STRUCTURAL FRAMING MEMBERS SHALL BE ADEQUATELY BRIDGED TO ENSURE BEAM STABILITY AS CALLED FOR IN SECTION 4.4.1 OF THE LATEST EDITION OF THE NATIONAL DESIGN SPECIFICATION FOR WOOD CONSTRUCTION.

7. CONTRACTOR TO SUBMIT SHOP DRAWINGS TO ENGINEERED STRUCTURES, LLC FOR ENGINEERED LUMBER PRODUCTS. SHOP DRAWINGS SHALL INCLUDE A DIMENSIONED ERECTION PLAN WITH PIECE MARKS AND SCHEDLULES SHOWING PIECES MARK, SIZE AND LENGTH FOR ENGINEERED LUMBER MEMBERS. IF PRODUCT MANUFACTURER SUBSTITUTIONS HAVE BEEN MADE, ENGINEERED STRUCTURES, LLC RESERVES THE RIGHT TO BILL FOR ENGINEERING TIME REQUIRED TO VERIFY THE SUBSTITUTIONS.

8. AT SOLID SAWN MULTI-PLY HEADERS, BEAMS AND STUD ASSEMBLIES, GLUE PLYS WITH CONSTRUCTION ADHESIVE AND NAIL WITH 8d NAILS AT 6" ON CENTER LOCATED 2" FROM BOTH EDGES. STAGGER NAILS ON BOTH SIDES OF THE MEMBER.

9. AT MULTI-PLY ENGINEERED LUMBER MEMBERS, FOLLOW SUPPLIER'S RECOMMENDATIONS FOR ASSEMBLY.

10. ALL HEADERS AND BEAMS SHALL BEAR ON A MINIMUM OF (2) STUDS UNLESS NOTED OTHERWISE ON CONSTRUCTION DOCUMENTS.

11. AT MULTI-PLY FRAMING MEMBERS AND TRUSSES, PROVIDE AT LEAST ONE SUPPORTING STUD PER PLY. PROVIDE BLOCKING THROUGH FLOOR FRAMING TO TRANSFER LOAD TO FOUNDATION.

12. THE FOLLOWING SCHEDULE IS A MINIMUM CONNECTION REQUIREMENT. SEE DRAWINGS FOR POSSIBLE HIGHER REQUIREMENTS.

A. SILL PLATE TO FOUNDATION WALL
B. WOOD NAILER TO STEEL BEAM
C. ROOF TRUSS TO WALL TOP PLATE

D. ROOF GIRDER TRUSS TO WALL TOP PLATE

 $\frac{1}{2}$ " DIAMETER ANCHOR BOLTS @ 48" O.C. U.N.O. $\frac{1}{2}$ " DIAMETER BOLTS @ 24" O.C. U.N.O. OR (2) $\frac{1}{4}$ " DIA. SIMPSON SDS $\frac{1}{4}$ x1.5 @ 12" O.C. U.N.O. SIMPSON H2.5 U.N.O. (2) SIMPSON H2.5 U.N.O.

13. MINIMUM NAILED CONNECTIONS FOR WOOD FRAMING MEMBERS SHALL BE IN ACCORDANCE WITH THE NAILING SCHEDULE GIVEN IN SECTION 2304.9.1 "CONNECTIONS AND FASTENERS" OF THE CURRENT BUILDING CODE IF NO

14. WHEN OPENING SIZES REQUIRED SPACING OF FRAMING GREATER THAT THAT SHOWN ON THE DRAWINGS, CONSULT ARCHITECT AND ENGINEER.

15. ALL WOOD EXPOSED TO EXTERIOR SHALL BE PRESERVATIVE PRESSURE TREATED. ALL FASTENERS IN TREATED WOOD SHALL BE PROPER TO THE PRESERVATIVE TREATMENT USED. CONSULT WITH LUMBER SUPPLIER AND FASTENER SUPPLIER.

16. STANDARD CUT WASHERS SHALL BE PLACED BETWEEN BOLT HEAD, NUTS AND WOOD MEMBER.

17. IN ORDER TO REDUCE THE POTENTIAL FOR SHEATHING DEFLECTION, IT IS RECOMMENDED TO PROVIDE DOUBLE JOISTS BENEATH WALL OR LADDER FRAME BETWEEN JOISTS EVERY 48" AT ALL NON-BEARING WALLS ABOVE THAT ARE PARALLEL TO FLOOR JOISTS.

18. PROVIDE FULL DEPTH BLOCKING HANGERED BETWEEN JOISTS BENEATH ALL BEARING WALLS SUPPORTED BY AND PERPENDICULAR TO JOISTS.

19. IT IS RECOMMENDED THAT FLOOR JOISTS BE DOUBLED UP BENEATH CABINETS, KITCHEN ISLANDS, AND FIREPLACES. CONSULT ENGINEERED STRUCTURES, LLC FOR SPECIFIC CONDITIONS WHERE THIS IN NOT NECESSARY.

20. PROVIDE SQUASH BLOCKS TO MATCH UPPER WALL STUDS IN FLOOR SYSTEM AT WALLS WHERE JOISTS ARE PARALLEL TO A BEARING WALL ABOVE. LIKEWISE AT STACKED INTERIOR BEARING WALLS WHERE JOISTS ARE PARALLEL OR PERPENDICULAR.

21. LUMBER MATERIAL PROPERTIES:

ALL PROPERTIES TYPICAL UNLESS NOTED OTHERWISE ON DRAWINGS.

DIMENSIONAL LUMBER Fb = 875 psi, Fv = 135 psi, E = 1,400,000 psi, Fc(perp) = 425 psi, Fc(parallel) = 1,150 psi LVL MATERIAL Fb = 3100 psi, Fv = 285 psi, E = 2,000,000 psi, Fc(perp) = 750 psi 24F-V4 DF, Fb = 2400 psi, Fv = 265 psi, Fc (perp) = 650 psi Fc(perp) = 565 psi

NAIL SF	PECIFICATION CHART	Ī
NAIL SIZE	DIAMETER	LENGTH
6d	.092	1 7/8"
8d	.131	2 3/8"
10d	.142	3"
12d	.120	3 1/4"
16d	.162	3 1/2"
20d	.148	4"
SHEATI	HING SCHEDULE	
THICKNESS SPECIFIED	THICKNESS TO BE	E SUPPLIED
7/16"	7/16" OR GREATE	R
1/2"	1/2" OR GREATER	
5/8"	5/8" OR GREATER	
3/4"	3/4" OR GREATER	

AS AN EXAMPLE, PROVIDING 7/16" SHEATHING WHEN 1/2" SHEATHING IS SPECIFIED, IS NOT ACCEPTABLE.

METAL PLATE CONNECTED WOOD TRUSS:

1. METAL PLATE CONNECTED WOOD TRUSSES SHALL CONFORM TO THE SPECIFICATIONS OF THE TRUSS PLATE INSTITUTE (TPI), AMERICAN FOREST PRODUCTS ASSOCIATION (AFPA), WOOD TRUSS COUNCIL OF AMERICA (WTCA), AND NATIONAL DESIGN STANDARD (NDS) SPECIFICATIONS. ALL CONNECTOR PLATES SHALL BE GALVANIZED.

2. TRUSSES AND CONNNECTIONS SHALL BE DESIGNED BY A LICENSED ENGINEER IN THE STATE OF MICHIGAN TO SUPPORT THE LOADS AS INDICATED ON THE CONSTRUCTION DOCUMENTS WITH A MAXIMUM LIVE LOAD DEFLECTION OF L/360 OR 1" MAXIMUM AND A TOTAL DELFECTION OF L/240. HORIZONTAL DEFLECTIONS IN SCISSOR TRUSSES ARE TO BE HELD TO A LIVE LOAD DEFLECTION OF $\frac{1}{2}$ " MAXIMUM. VERTICAL DEFLECTION LIMITS MAY BE MORE STRICT FOR FINISHING. CONSULT WITH BUILDER.

3. METAL PLATE CONNECTED WOOD TRUSSES ARE PROPRIETARY AND REQUIRE DESIGN BY A MANUFACTURER. THE MANUFACTURER SHALL ENGAGE A QUALIFIED ENGINEER, LICENSED IN THE STATE OF THE PROJECT, AND EXPERIENCED IN THE DESIGN OF WOOD STRUCTURES. THE ENGINEER SHALL COMPLETE THE DESIGN OF THE TRUSS ROOF STRUCTURE, AS REQUIRED TO PROVIDE THE ROOF STRUCTURE DESCRIBED BY THE CONSTRUCTION DOCUMENTS.

4. THE CONSTRUCTION DOCUMENTS SHOW ONE POSSIBLE ROOF STRUCTURE WITH THE SUPPORTING ELEMENTS DESIGNED ACCORDINGLY. IT IS ASSUMED THAT THE MANUFACTURER'S ENGINEER WILL CLOSELY FOLLOW THIS DESIGN INTENT. SHOULD IT BE DETERMINED BY THE MANUFACTURER'S ENGINEER THAT ANOTHER POSSIBLE DESIGN IS MORE ECONOMICAL, THE PROPOSED REVISIONS SHALL BE GONE OVER WITH ENGINEERED STRUCTURES, LLC. AT THIS TIME, IT SHALL BE DETERMINED WHETHER THE PROPOSED REVISIONS REQUIRE CHANGES TO THE CONSTRUCTION DOCUMENTS AND WHAT FEE (IF ANY) WILL BE REQUIRED TO DO SO. THE PROPOSED FEES FOR ADDITIONAL SERVICES (IF ANY) WILL BE SUBMITTED TO THE CONTRACTOR AND OWNER FOR APPROVAL. WRITTEN APPROVAL OF THE ADDITIONAL FEES MUST BE RECEIVED PRIOR TO MAKING THE CHANGES.

5. WOOD FRAMING CONNECTIONS SHALL BE SEATED CONNECTIONS, UNLESS OTHERWISE NOTED. DO NOT COPE ANY MEMBER. DO NOT USE TOE NAILING TO SUPPORT VERTICAL LOADS. PROVIDE STANDARD PREFABRICATED, GALVANIZED, MANUFATURED FRAMING DEVICES PER ASTM D1761 AND IBC, DESIGNED TO SUPPOR T THE MEMBER SIZE.

6. TEMPORARY BRACING FOR TRUSS MEMBER SLENDERNESS AND STABILITY SHALL BE DESIGNED, AND SPECIFIED BY THE METAL PLATE CONNECTED WOOD TRUSS MANUFACTURER'S LICENSED ENGINEER AND BE IN COMPLIANCE WITH BUILDING COMPONENT SAFETY INFORMATION (BCSI) 1-03.

7. TEMPORARY BRACING FOR TRUSS AND BUILDING STABILITY SHALL BE INSTALLED IN SUCH A MANNER SO AS TO ALLOW FOR INSTALLATION OF SUBSEQUENT WORK WITHOUTH THE NEED TO DISRUPT THE TEMPORARY BRACING UNTIL SUCH TIME AS IT MAY BE REMOVED.

8. PERMANENT BRACING FOR OVERALL BUILDING STABILITY IS COMPLETE WHEN ROOF SHEATHING AND WALL SHEATHING IS COMPLETE WITH FASTENING. PROVIDE TEMPORARY BRACING UNTIL ROOF AND WALL SHEATHING IS COMPLETE. PERMANENT BRACING WILL BE DESIGNED BY ENGINEERED STRUCTURES, LLC AS OUTLINED IN THEIR PROJECT CONTRACT. ANY DRAWINGS REQUIRED FOR THIS BRACING WILL BE REDMARKED ON THE TRUSS LAYOUT PLAN. A PRE-CONSTRUCTION MEETING IS REQUIRED TO REVIEW THE TRUSS BRACING REQUIREMENTS. PARTIES TO BE PRESENT AT THIS MEETING ARE ENGINEERED STRUCTURES, LLC, TRUSS INSTALLER, TRUSS SUPPLIER'S REPRESENTATIVE AND ANY OTHER PARTIES REQUESTING TO BE PRESENT.

9. WHEN PIGGYBACK TRUSSES ARE REQUIRED, THE TOP CHORD OF THE MAIN TRUSSES SHALL BE SHEATHED WITH $\frac{1}{2}$ " APA RATED SHEATHING IN LIEU OF LINEAL 2x FRAMING. REFER TO STRUCTURAL DETAILS FOR MAIN TRUSS TO CAP TRUSS CONNECTION.

10. COMPLY WITH AITC TIMBER CONSTRUCTION MANUAL FOR WOOD CONSTRUCTION.

11. REFER TO DETAIL SHEETS FOR POSSIBLE REQUIREMENTS FOR TRUSS SUPPORT BLOCKING

12. NOTE BCSI REQUIREMENT OF DIAGONAL BRACING WHERE HORIZONTAL WEB BRACING IS SHOWN. DIAGONAL BRACING SHOULD OCCUR EVERY 20'-0" AND MAY BE APPLIED IN SECTIONS BETWEEN HORIZONTALS, IT SHOULD BE INSTALLED NO MORE THAN 45 DEGREES FROM HORIZONTAL. AT LEAST ONE HORIZONTAL BRACE SHOULD BE PROVIDED FOR EVERY "SET" OF TRUSSES WITH IDENTIACAL WEB LAYOUTS. IF NOT MORE THAN 3 TRUSSES ARE IDENTICAL, BRACE WEBS FOR SLENDERNESS WITH 2x6 STRONGBACK.

13. IT IS VERY IMPORTANT TO ENSURE THAT TRUSSES HAVE ADEQUATELY DRIED (BELOW 16% MOISTURE CONTENT) PRIOR TO CLOSING THE STRUCTURE IN. SHRINKING AND ARCHING

14. GENERAL CONTRACTOR SHALL SUBMIT ROOF TRUSS SHOP DRAWINGS TO ARCHITECT AND ENGINEER FOR REVIEW AND DESIGN OF REQUIRED UPLIFT CONNECTIONS PRIOR TO FABRICATION.

15. MANUFACTURER SHALL PROVIDE ERECTION DRAWINGS INDICATING ALL BRIDGING AND BRACING REQUIRED BY DESIGN AND ALL MECHANICAL TRUSS TO TRUSS CONNECTIONS.

16. WOOD TRUSSES ARE SHOWN AS A GENERAL LAYOUT ONLY. EXACT PLACEMENT SHALL BE DETERMINED BY MANUFACTURER.

STRUCTURAL DESIGN LOADS BUILDING RISK CATEGORY ROOF LIVE LOAD GENERAL 20 PSF Pg - GROUND SNOW LOAD THERMAL FACTOR IMPORTANCE FACTOR EXPOSURE FACTOR Pf - ROOF SNOW LOAD 20 PSF LOOR LIVE LOAD **GENERAL** CORRIDOR / LOBBIES 100 PSF WIND LOADS BASIC WIND SPEED 115 MPH **BUILDING CATEGORY** INTERNAL PRESSURE COEFF COMPONENTS AND CLADDING PRESSURE 25 PSF MWFRS PRESSURE 16 PSF ROOF TRUSS LOADS DESIGN FOR UNBALANCED SNOW LOADS PER CODE DESIGN FOR UNBALANCED SNOW DRIFTING PER CODE ATTIC LOADS ACCESSIBLE ATTIC - NO PLANNED STORAGE 20 PSF ACCESSIBLE ATTIC - PLANNED STORAGE ACCESSIBLE ATTIC - HEIGHT EXCEEDING 30" 20 PSF NO ACCESS PROVIDED TO ATTIC 00 PSF ASSUME NO DESIGNED STORAGE UNLESS CALLED FOR ON DRAWINGS TRUSS SUPPLIER TO DETERMINE 30" REQUIREMENT DEAD LOADS ROOF FLOOR - GENERAL **30 PSF** 40 PSF FLOOR - TILED AREAS SOIL BEARING PRESSURE PER SOIL REPORT 3000 PSF

CONCRETE:

1. MATERIAL AND WORKMANSHIP FOR ALL CONCRETE AND REINFORCING SHALL BE IN ACCORDANCE WITH THE MOST CURRENT ACI MANUAL OF STANDARD PRACTICE, THE MOST CURRENT EDITION OF THE MICHIGAN BUILDING CODE AND/OR RESIDENTIAL CODE AND THE MOST CURRENT ACI BUILDING CODE REQUIREMENTS.

2. PROVIDE ENTRAINED AIR IN ALL EXPOSED EXTERIOR CONCRETE.

3. OTHER CONCRETE ADMITURES MAY BE USED AS NECESSDAY, INCLUDING THE USE OF A PLASTICIZER TO IMPROVE WORKABILITY. HOWEVER, EXTRA WATER SHALL NOT BE ADDED BEYOND THAT WHICH IS REQUIRED FOR PROPER HYDRATION OF THE MIX DESIGN BEING USED. CHLORINE IS NOT AN ACCEPTABLE ADMIXTURE AND SHALL NOT BE USED.

4. APPROPRIATE CURING MEASURES SHALL BE TAKEN FOR NEW CONCRETE.

5. COLD WEATHER CONCRETING SHALL BE DONE IN ACCORDANCE WITH THE MOST CURRENT EDITION OF ACI 305. WARM WEATHER CONCRETING SHALL BE DONE IN ACCORDANCE WITH THE MOST CURRENT EDITION OF ACI 306.

6. SPECIAL INSPECTIONS SHALL BE PROVIDED IN ACCORDANCE WITH SECTION 1704.4 OF THE MICHIGAN BUILDING CODE.

7. GENERAL CONTRACTOR SHALL VERIFY THE LOCATIONS OF ALL OPENINGS, SLEEVES, ANCHORS, HANGERS, INSERTS, SLAB DEPRESSIONS AND OTHER ITEMS RELATED TO THE CONCRETE WORK WITH ALL SUBCONTRACTORS AND SHALL ASSUME FULL RESPONSIBILITY FOR THEIR PROPER LOCATION BEFORE PLACING CONCRETE. PITCH CONCRETE SLABS AS REQUIRED TO ALL FLOOR DRAINS. ITEMS THAT ARE NOT NOTED ON THE STRUCTURAL DRAWINGS SHALL BE REVIEWED AND APPROVED BY ENGINEERED STRUCTURES, LLC PRIOR TO FABRICATION AND CONSTRUCTION.

8. CONCRETE SLUMP SHALL CONFORM TO ASTM C143. SUBMIT MIX DESIGN AND MIX HISTORY TO ARCHITECT AND ENGINEER FOR APPROVAL PRIOR TO CONSTRUCTION.

9. CONCRETE SLABS SUPPORTED DIRECTLY ON THE GROUND SHALL BE A MINIMUM OF 4" THICK AND REINFORCED WITH A MINIMUM OF 6x6 W1.4xW1.4 W.W.M. CONFORMING TO ASTM A185 UNLESS NOTED OTHERWISE ON PLANS. INTERIOR SLABS SHALL BE INSTALLED OVER 10-MIL. POLYETHYLENE VAPOR RETARDER WITH EDGES LAPPED NOT LESS THAN 6" IN ALL DIRECTIONS. PROVIDE CONTRACTION / CONSTRUCTION JOINTS IN ALL SLABS ON GRADE AT A MAXIMUM OF 2.5 TIMES THE SLAB THICKNESS ON CENTER. FOR EXAMPLE, 4" SLAG IS A MAXIMUM OF 10'-0" (4 x 2.5) ON CENTER. MAINTAIN WIDTH TO LENGTH RATIO OF NO MORE THAN 1.5. REFER TO ARCHITECTURAL PLANS FOR ADDITIONAL INFORMATION AND REQUIREMENTS SUCH AS FINISHES.

10. PROVIDE CONCRETE COVER OVER REINFORCING BARS AS FOLLOWS (AND IN ACCORDANCE WITH THE LATEST EDITION OF ACI 318) UNLESS NOTED OTHERWISE ON PLANS: A. CAST AGAINST AND PERMANENTLY EXPOSED TO EARTH - 3".

B. PERMANENTLY EXPOSED TO EARTH OR WEATHER: #5 AND SMALLER - 1.5" #6 AND LARGER - 2"

C. NOT EXPOSED TO EARTH OR WEATHER: WALLS AND SLABS - 0.75"

BEAMS AND COLUMNS - 1.5" CORROSIVE ENVIRONMENT - 2"

11. PROVIDE CONCRETE MIXTURES AS FOLLOWS UNLESS NOTED OTHERWISE ON PLANS: A. 3,000 psi FOUNDATION WALLS, FOOTINGS, GRADE BEAMS, CONCRETE BEAMS, PIERS, RETAINING WALLS

B. 3,500 psi INTERIOR CONCRETE SLABS ON GRADE, TOPPING SLABS

C. 4,000 psi EXTERIOR CONCRETE
D. ALL EXTERIOR CONCRETE SHALL BE AIR ENTRAINED 6% MINIMUM.

12. ALL EXPOSED EDGES OF CONCRETE PIERS, BEAMS, AND WALLS SHALL BE CHAMFERED

0.75" BY 45 DEGREES.

1. ALL WORK SHALL BE PERFORMED IN ACCORDANCE WITH THE SPECIFICATIONS AND CONSTRUCTION DOCUMENTS. ANY DISCREPANCIES SHALL BE REPORTED TO THE ARCHITECT AND ENGINEER PRIOR TO COMMENCEMENT OF CONSTRUCTION.

2. THERE SHALL BE A MINIMUM OF 6" OF CLEAN GRANULAR SOIL BENEATH ALL SLABS ON GRADE. ALL FILL BENEATH SLABS AND ADJACENT TO FOUNDATION WALLS SHALL BE COMPACTED TO A MINIMUM OF 95% MODIFIED PROCTOR.

3. UNLESS NOTED OTHERWISE, A 10 MIL VAPOR RETARDER SHALL BE PLACED UNDER ALL SLABS ON GRADE AFTER ALL UNDERGROUND WORK AND COMPACTION IS COMPLETE. SEAL ALL LAPS

4. EXERCISE CARE WHEN BACKFILLING WALLS. EXCEPT FOR WALLS WITH EQUAL FILL ON BOTH SIDES, NO BACKFILLING OF WALLS SHALL BE DONE UNTIL THE WALL HAS ATTAINED ITS FULL STRENGTH AND HAS BEEN PROPERLY SUPPORTED BY BRACING OR BY A COMPLETED FLOOR OR ROOF STRUCTURE. ALTERNATE FILL WHEN BACKFILLING WALLS WITH FILL N BOTH SIDES.

5. ALL SLABS ON GRADE TO HAVE CONTRACTION / CONSTRUCTION JOINTS AT A MAXIMUM OF 2.5 TIMES THE SLAB THICKNESS ON CENTER. FOR EXAMPLE 4" SLAB IS A MAXIMUM OF 10'-0" (4 x 2.5) ON CENTER. MAINTAIN WIDTH TO LENGTH RATIO OF NO MORE THAN 1.5. REFER TO ARCHITECTURAL PLANS FOR ADDITIONAL INFORMATION AND REQUIREMENTS SUCH AS

6. LAP ALL REINFORCING AS SHOWN IN FOUNDATION DETAILS. PROVIDE CORNER BARS TO MATCH ALL HORIZONTAL REINFORCING. PROVIDE DOWELS FROM FOOTING INTO WALL EQUAL IN SIZE AND NUMBER TO VERTICAL WALL AND PIER REINFORCING. PROVIDE 6" HOOK ON END OF DOWELS UNLESS NOTED OTHERWISE.

7. REFER TO CONCRETE SECTION FOR REINFORCING COVER REQUIREMENTS.

8. PROVIDE BEAM POCKETS IN WALLS AS REQUIRED. FILL POCKET IN WITH CONCRETE ONCE BEAM IS IN PLACE.

9. COORDINATE PLACEMENT OF ANCHOR BOLTS WITH FOUNDATION REINFORCING. ALL ANCHOR BOLTS WILL BE FURNISHED BY THE STEEL FABRICATOR AND INSTALLED BY THE FOUNDATION CONTRACTOR USING TEMPLATES AND SETTINGS DRAWINGS. NO TILTED OR MISPLACED BOLTS WILL BE ACCEPTED. NOTIFY ARCHITECT AND ENGINEERED STRUCTURES, LLC FOR APPROVAL ON ANY CORRECTIVE ACTION. TOLERANCES FOR THE INSTALLATION OF THE ANCHOR BOLTS SHALL BE IN ACCORDANCE WITH AISC "CODE OF STANDARD PRACTICE" GUIDELINES.

10. SPECIAL INSPECTIONS SHALL BE PROVIDED IN ACCORDANCE WITH SECTION 1704.4 OF THE MICHIGAN BUILDING CODE.

11. FOOTINGS SHALL BEAR AT LEAST 3'-6" BELOW FINISH GRADE REGARDLESS OF DIMENSIONS SHOWN ON CONSTRUCTION DOCUMENTS. FOOTINGS MUST ALSO BEAR ON SOIL COMPACTED PER RECOMMENDATIONS OF GEOTECHNICAL ENGINEER.

12. FOUNDATION WALLS AND GRADE BEAMS SHALL HAVE A MINIMUM OF TWO (2) #5 BARS CONTINUOUS TOP AND BOTTOM OF WALL TYPICAL UNLESS NOTED OTHERWISE ON PLANS.

13. PROVIDE DIAGONAL CONCRETE REINFORCING AROUND OPENINGS IN SLABS AND WALLS OF ONE #5 BAR BY 40" LONG FOR EACH 4" OF THIDKNESS. LAP ALL SPLICES IN CONCRETE REINFORCING MINIMUM 24 BAR DIAMETERS.

14. PROVIDE CORNER BARS FOR ALL HORIZONTAL CONCRETE REINFORCING WITH LEG LENGTHS OF 48 BAR DIAMETERS MINIMUM.

15. PROVIDE DOWELS FROM FOOTING INTO WALLS EQUAL IN SIZE AND NUMBER TO MATCH VERTICAL WALL OR PIER REINFORCING UNLESS NOTED OTHERWISE ON PLANS.

GENERAL REQUIREMENTS:

1. CONSTRUCTION SHALL CONFORM TO THE LATEST EDITION OF THE MICHIGAN BUILDING CODE, LATEST EDITION OF THE MICHIGAN RESIDENTIAL CODE, AND THE LATEST EDITION OF NFPA A0A. DETAILS OF CONSTRUCTION NOT FULLY SHOWN ON THE CONSTRUCTION DOCUMENTS SHALL BE OF THE SAME NATURE AS SHOWN FOR SIMILAR CONDITIONS. ANY UNCLEAR CONDITIONS SHALL BE VERIFIED WITH THE ARCHITECT AND/OR ENGINEER PRIOR TO CONSTRUCTION.

2. THESE DOCUMENTS ARE INTENDED FOR THE WORK SHOWN ON THIS PROJECT ONLY AND ARE NOT TO BE USED FOR ADDITION(S) TO THIS PROJECT OR OTHER NEW PROJECTS.

3. SHOP DRAWINGS ARE REQUIRED FOR ALL MATERIALS AS OUTLINED IN THESE NOTES. WAIVER OF SHOP DRAWING SUBMITTAL BY THE ARCHITECT DOES NOT RELIEVE THE CONTRACTOR OR MANUFACTURER FROM THE RESPONSIBILITY OF SUPPLYING OR INSTALLING ALL NECESSARY COMPONENTS FOR A COMPLETE SYSTEM.

4. SPECIAL INSPECTIONS SHALL BE PROVIDED AS NOTED IN THE ARCHITECTURAL SPECIFICATIONS, IF ANY, AND IN ACCORDANCE WITH SECTION 1704 OF THE MICHIGAN BUILDING CODE. THE BUILDING OWNER IS SOLELY RESPONSIBLE FOR EMPLOYING THE SPECIAL INSPECTORS.

5. IF ANY NOTE CONFLICTS WITH ANY DETAIL OR NOTE ON THE PLANS OR IN THE SPECIFICATIONS, NOTIFY ARCHITECT AND ENGINEER FOR CLARIFICATION.

6. THE STRUCTURAL DRAWINGS ARE FOR THE PLACEMENT AND SIZE OF STRUCTURAL COMPONENTS ONLY. OSHA, DNR AND SAFETY CODE REQUIREMENTS ARE DETERMINED AND PROVIDED BY OTHERS. ENGINEERED STRUCTURES, LLC IS NOT RESPONSIBLE FOR JOBSITE SAFETY, CONSTRUCTION SEQUENCE, OR ERECTION PROCEDURES.

7. THE STRUCTURE IS DESIGNED TO BE SELF SUPPORTING AND STABLE AFTER IT IS FULLY COMPLETED. IT IS THE CONTRACTOR'S SOLE RESPONSIBILITY TO DETERMINE ERECTION PROCEDURE AND SEQUENCE, AND TO ENSURE THE SAFETY OF THE STRUCTURE AND ITS COMPONENT PARTS DURING ERECTION. THIS INCLUDES, BUT IS NOT LIMITED TO, THE ADDITION OF TEMPORARY BRACING, GUYS OR TIE DOWNS IF NECESSARY. THIS ALSO INCLUDES BRACING EXCAVATIONS TO PREVENT CAVE IN. SUCH MATERIAL SHALL REMAIN THE CONTRACTOR'S PROPERTY AFTER COMPLETION OF THE PROJECT.

8. USE OF THE STRUCTURAL CONSTRUCTION DOCUMENTS AS ERECTION DRAWINGS BY THE CONTRACTOR IS STRICTLY PROHIBITED.

9. ANY QUESTIONABLY PLACED ITEMS SUCH AS MISALIGNED ANCHOR BOLTS, OFF CENTER BEARING PLATES, ETCETERA SHALL BE BROUGHT TO THE ATTENTION OF THE ENGINEER IMMEDIATELY FOR REVIEW.

10. ALTHOUGH EVERY ATTEMPT HAS BEEN MADE TO COVER ALL POSSIBLE CONDITIONS, THERE MAY BE CONDITIONS THAT WERE NOT DETAILED. SUCH CONDITIONS ARE TO BE OF THE SAME NATURE AS SIMILAR CONDITIONS. IF THERE IS ANY QUESTION, NOTIFY THE ENGINEER IMMEDIATELY BEFORE PROCEEDING WITH CONSTRUCTION.

11. ANY DIMENSIONS THAT ARE NOTED AS "FIELD VERIFY" ON THE CONSTRUCTION DOCUMENTS AS WELL AS EXISTING CONDITIONS AND THEIR RELATED DIMENSIONS SHALL BE VERIFIED BY THE CONTRACTOR AND SUBMITTED TO THE ARCHITECT AND ENGINEER FOR REVIEW PRIOR TO FABRICATION, ERECTION, AND COMMENCEMENT OF CONSTRUCTION. WORK MAY CONTINUE ONCE APPROVAL AND/OR ANY REVISIONS ARE RETURNED TO THE CONTRACTOR.

12. THE STRUCTURAL DRAWINGS HAVE BEEN DRAWN TO SHOW THE PROPER SIZES, MATERIAL PROPERTIES, METHODS OF CONNECTION, ETC TO WITHSTAND THE REQUIRED GRAVITY AND LATERAL LOADS AS OUTLINED IN THESE NOTES. ANY DEVIATION FROM OR ALTERATION TO THESE, WITHOUT WRITTEN CONSENT FROM ENGINEERED STRUCURES, LLC, RESOLVES ENGINEERED STRUCTURES, LLC FROM ANY RESPONSIBILITY. ANY REVISIONS OR ALTERATIONS MUST BE APPROVED BY ENGINEERED STRUCTURES, LLC PRIOR TO COMMENCING WITH THE PROPOSED WORK.

13. ENGINEERED STRUCTURES, LLC MUST APPROVE ANY MODIFICATIONS, SUCH AS OPENINGS OR PENETRATIONS, TO STRUCTURAL MEMBERS THAT ARE NOT SHOWN ON THE CONSTRUCTION DOCUMENTS PRIOR TO COMMENCEMENT OF CONSTRUCTION.

SITE WORK:

1. FOUNDATIONS HAVE BEEN DESIGNED IN ACCORDANCE WITH THE GEOTECHNICAL REPORT PREPARED BY McDOWELL & ASSOCIATES DATED DECEMBER 21, 2017.

2. ANY FROZEN SOIL, SOFT SOIL, AND/OR FILL ZONES ENCOUNTERED AT THE BEARING LEVELS OF THE FOUNDATIONS SHALL BE REMOVED AND REWORKED, UNDER THE DIRECTION OF A GEOTECHNICAL ENGINEER, TO PROVIDE SUITABLE BEARING MATERIAL.

STRUCTURAL STEEL:

1. STEEL DESIGN, FABRICATION AND ERECTION IS TO BE IN ACCORDANCE WITH THE LATES AISC SPECIFICATION FOR STRUCTURAL STEEL FOR BUILDINGS.

2. BEAMS WITHOUT A SPECIFIED CAMBER SHALL BE ORIENTED SUCH THAT ANY INCIDENTAL CAMBER IS UPWARD. TOLERANCE FROM NOTED CAMBER SHALL BE +0 TO -½".

3. BOLTED CONNECTIONS NOT SPECIFIED AS SLIP CRITICAL (SC) SHALL BE TIGHTENED SNUG

4. STRUCTURAL STEEL SHALL BE INSPECTED AS REQUIRED BY SECTION 1704.3 OF THE MICHIGAN BUILDING CODE.

5. ALL SHOP AND FIELD WELDING SHALL BE MADE IN ACCORDANCE WITH A.W.S. D1.1 "STRUCTURAL WELDING CODE" AND SHALL BE MADE BY QUALIFIED "CERTIFIED" WELDERS. TYPICAL ELECTRODE USED SHALL BE E70XX UNLESS NOTED OTHERWISE.

6. FABRICATOR SHALL BE RESPONSIBLE FOR THE DESIGN AND ADEQUACY OF ALL CONNECTIONS THAT ARE NOT DESIGNED OR FULLY DETAILED ON THE DRAWINGS. SHOP DRAWINGS SHALL BE SUBMITTED TO THE ARCHITECT AND ENGINEER FOR REVIEW PRIOR TO STEEL FABRICATION.

7. TYPICAL BEAM CONNECTIONS SHALL BE STANDARD AISC FRAMED BEAM CONNECTIONS, TYPICAL UNLESS NOTED OTHERWISE. ALL FIELD CONNECTIONS, EXCEPT WHERE SHOWN WELDED, SHALL BE BOLTED WITH $^3\!4$ " DIAMETER ASTM A325N HIGH STRENGTH BOLTS TYPICAL UNLESS NOTED OTHERWISE.

8. ALL COPED BEAMS TO BE DESIGNED IN ACCORDANCE WITH THE AISC STEEL CONSTRUCTION MANUAL LATEST EDITION. PROVIDE WEB REINFORCING AS REQUIRED. ALL RE-ENTRANT CORNERS TO BE SHAPED, NOTCH FREE, WITH A $\frac{1}{2}$ " RADIUS MINIMUM.


9. STRUCTURAL STEEL SHALL MEET THE FOLLOWING MINIMUM YIELD STRENGTHS AND SPECIFICATIONS:

A. WIDE FLANGE BEAMS 50 ksi ASTM A992
B. STRUCTURAL STEEL TUBING (HSS) 46 ksi ASTM A500 GRADE B
C. ANCHOR RODS 36 ksi ASTM A307

C. ANCHOR RODS 36 ksi ASTM A307
D. HEADED STUD ANCHORS 50 ksi ASTM A108 (GRADES 1010-1020)

E. STRUCTURAL BOLTS ASTM A325N
F. BARS AND PLATES 36 ksi ASTM A36

REGISTRATION

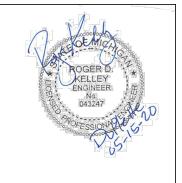

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THE CONTRACTOR IS RESPONSIBLE
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TECHNIQUES OF ASSEMBLY, FOR
PERFORMING WORK IN A SAFE
MANNER. AND FOR COORDINATING

JOB NO.:

SCALE: 1/8" = 1'-0"

WORK WITH THAT OF ALL TRADES

DATE: 05/15/20
DRAWING TITLE

STRUCTURAL NOTES

SHEET NO.


S-106

GENERAL SHEAR WALL NOTES -

1. $\frac{7}{16}$ " APA RATED EXPOSURE 1 SHEATHING ONE SIDE OF WALL AS SHOWN UNLESS NOTED OTHERWISE. BLOCK BETWEEN STUDS AT ALL SHEET EDGES. NAIL ALL SHEET EDGES WITH 8d @ 3" O.C. UNLESS NOTED OTHERWISE ON ELEVATIONS.

2. $\frac{1}{2}$ " DIAMETER ANCHOR BOLTS @ 48" O.C. UNLESS NOTED OTHERWISE.

3. TYPICAL EPOXY ANCHOR TO BE $\frac{5}{8}$ " DIAMETER F1554 GRADE 36 THREADED ROD EPOXIED WITH 6" EMBEDMENT INTO A CLEAN - DRY HOLE USING HILTI HIT HY200 ADHESIVE FOLLOWING HILTI'S WRITTEN INSTALLATION INSTRUCTIONS.

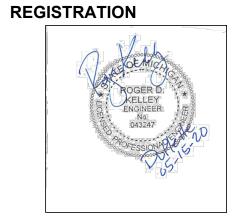

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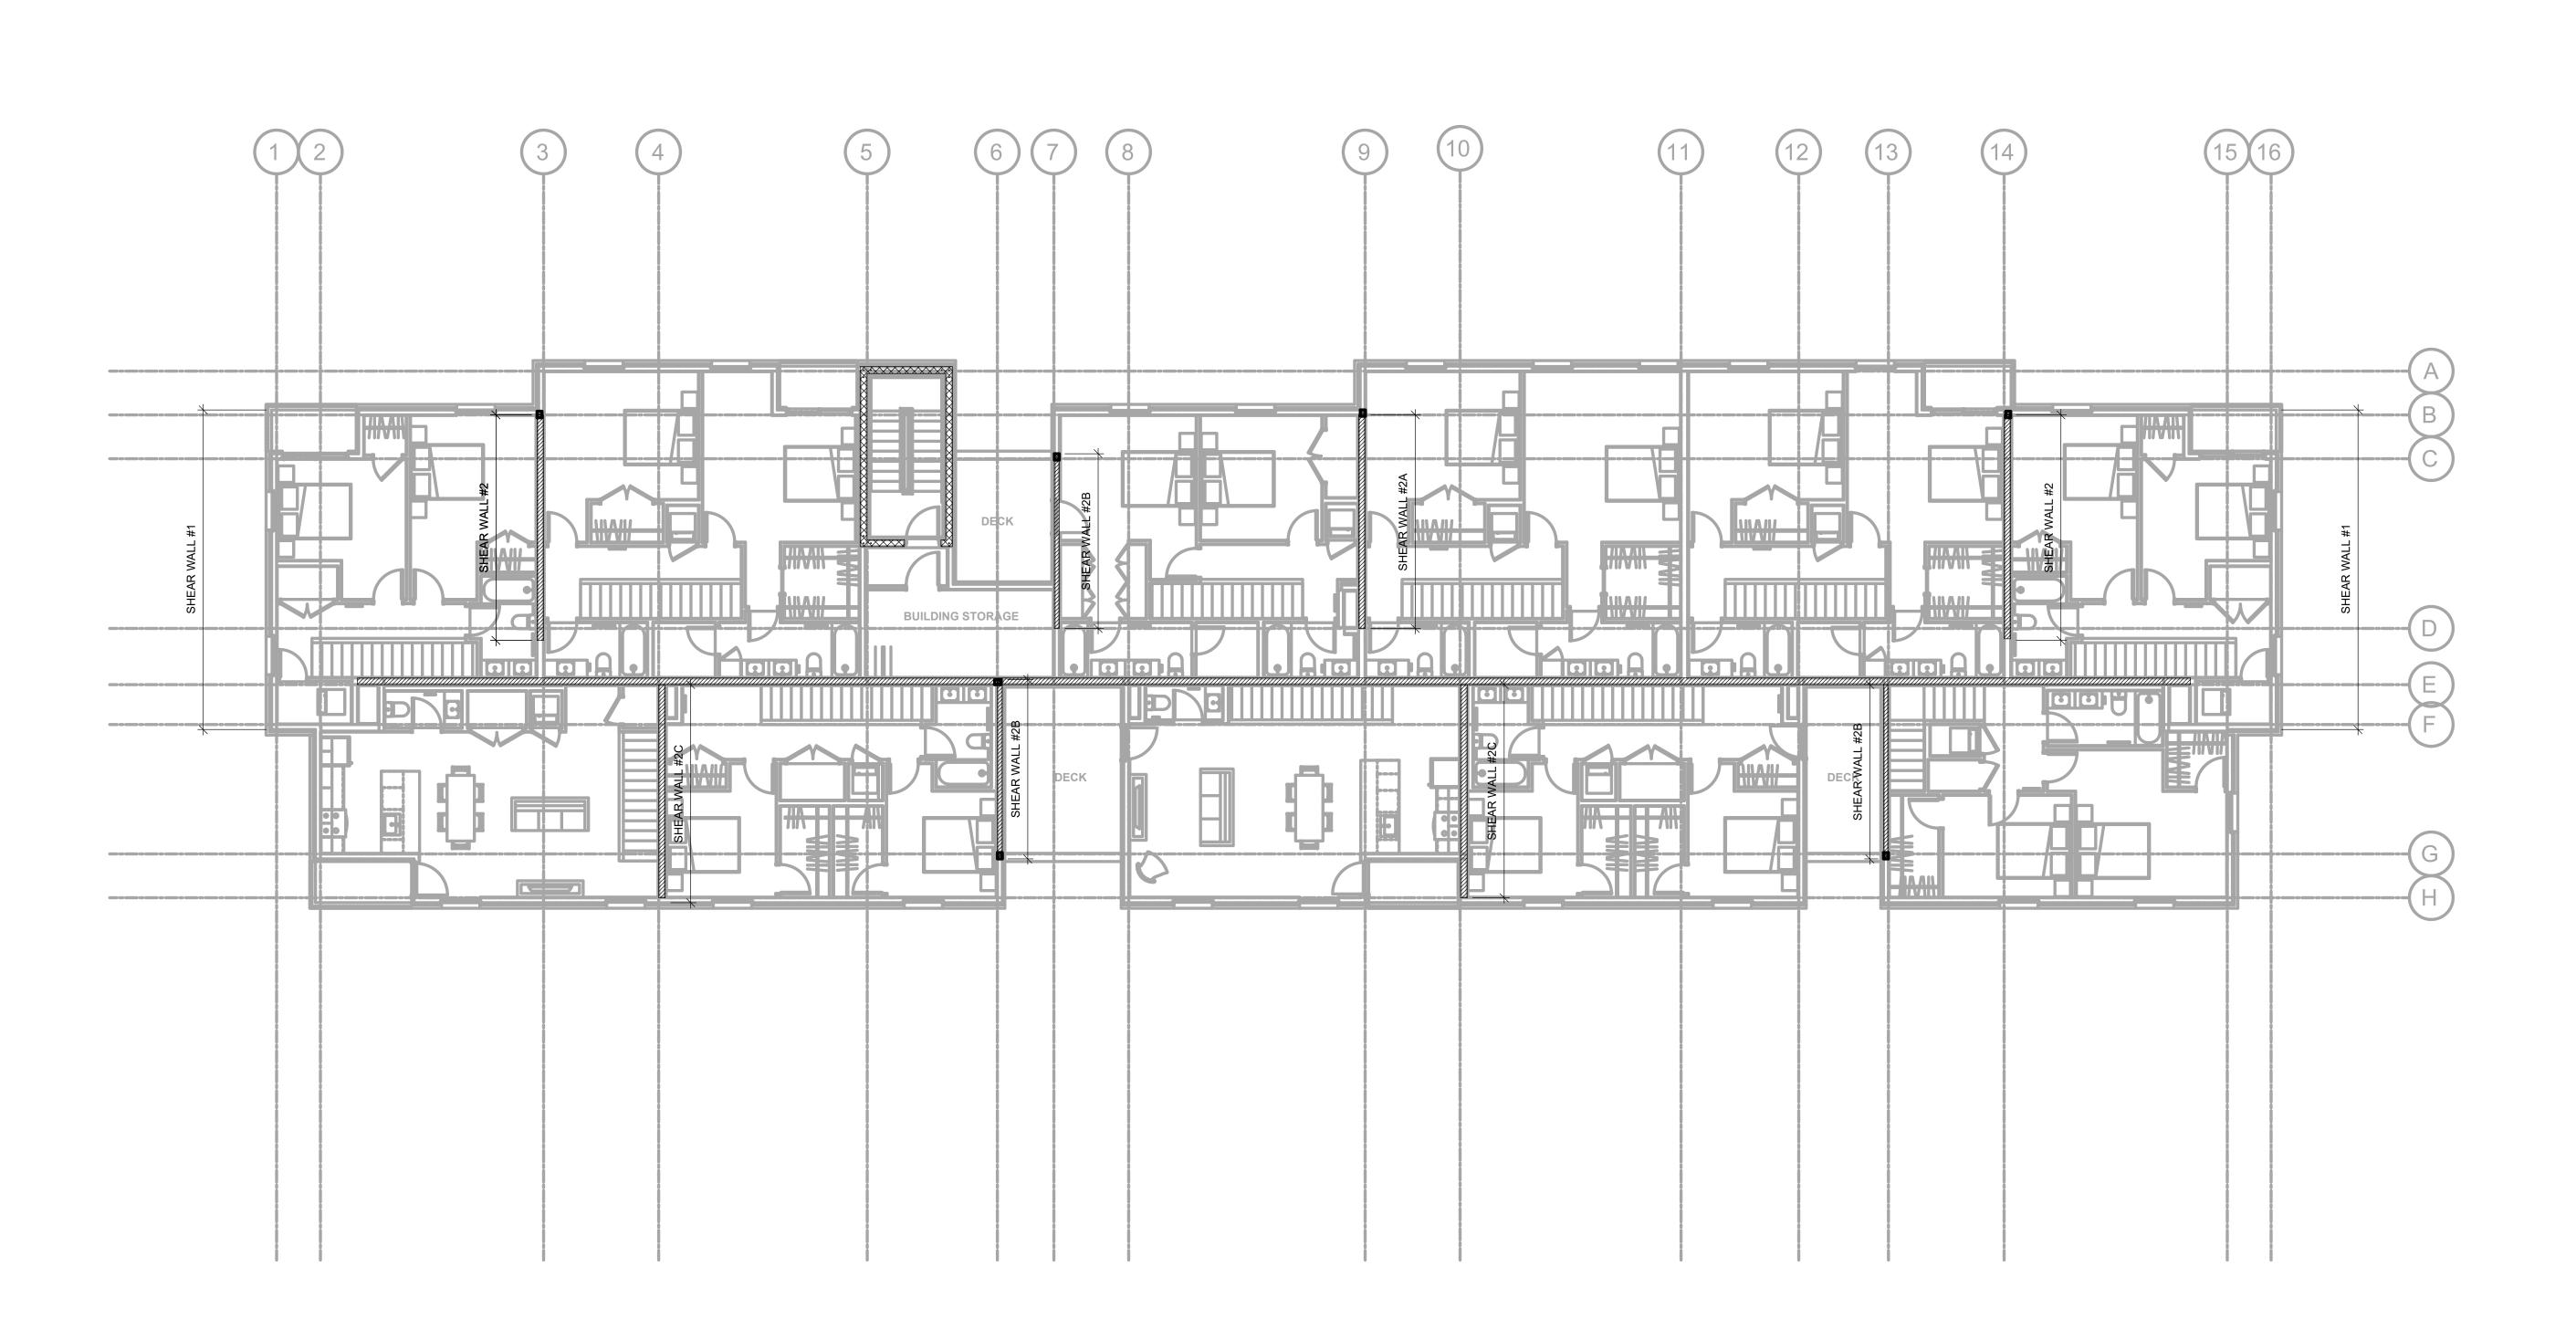
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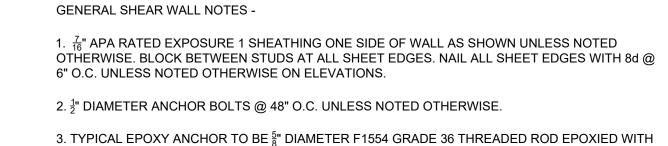
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SHEAR WALL LOCATION **PLAN 4TH FLOOR**

SHEET NO.

S-107





WRITTEN INSTALLATION INSTRUCTIONS.

6" EMBEDMENT INTO A CLEAN - DRY HOLE USING HILTI HIT HY200 ADHESIVE FOLLOWING HILTI'S

OWNED

OWNER

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SCALE: 1/8" = 1'-0"


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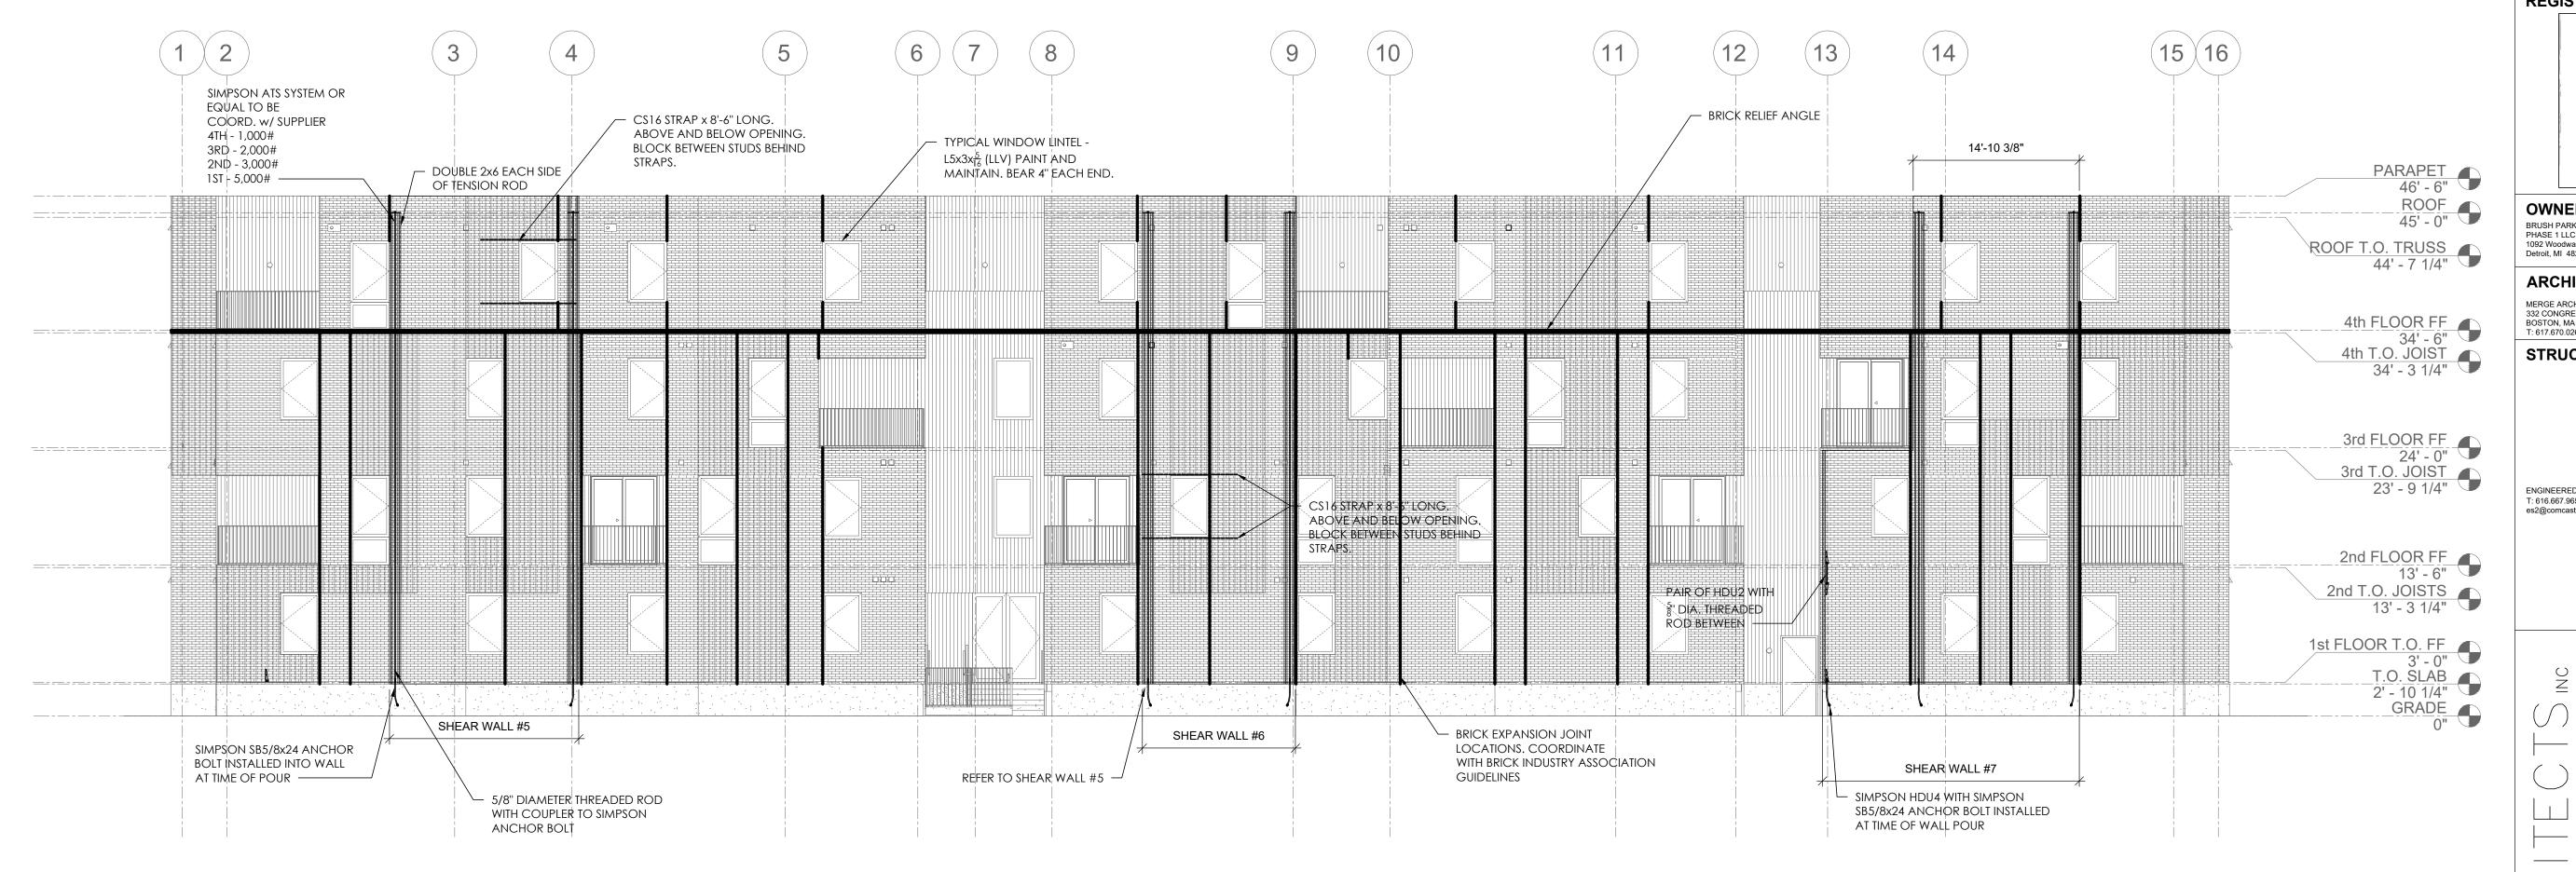
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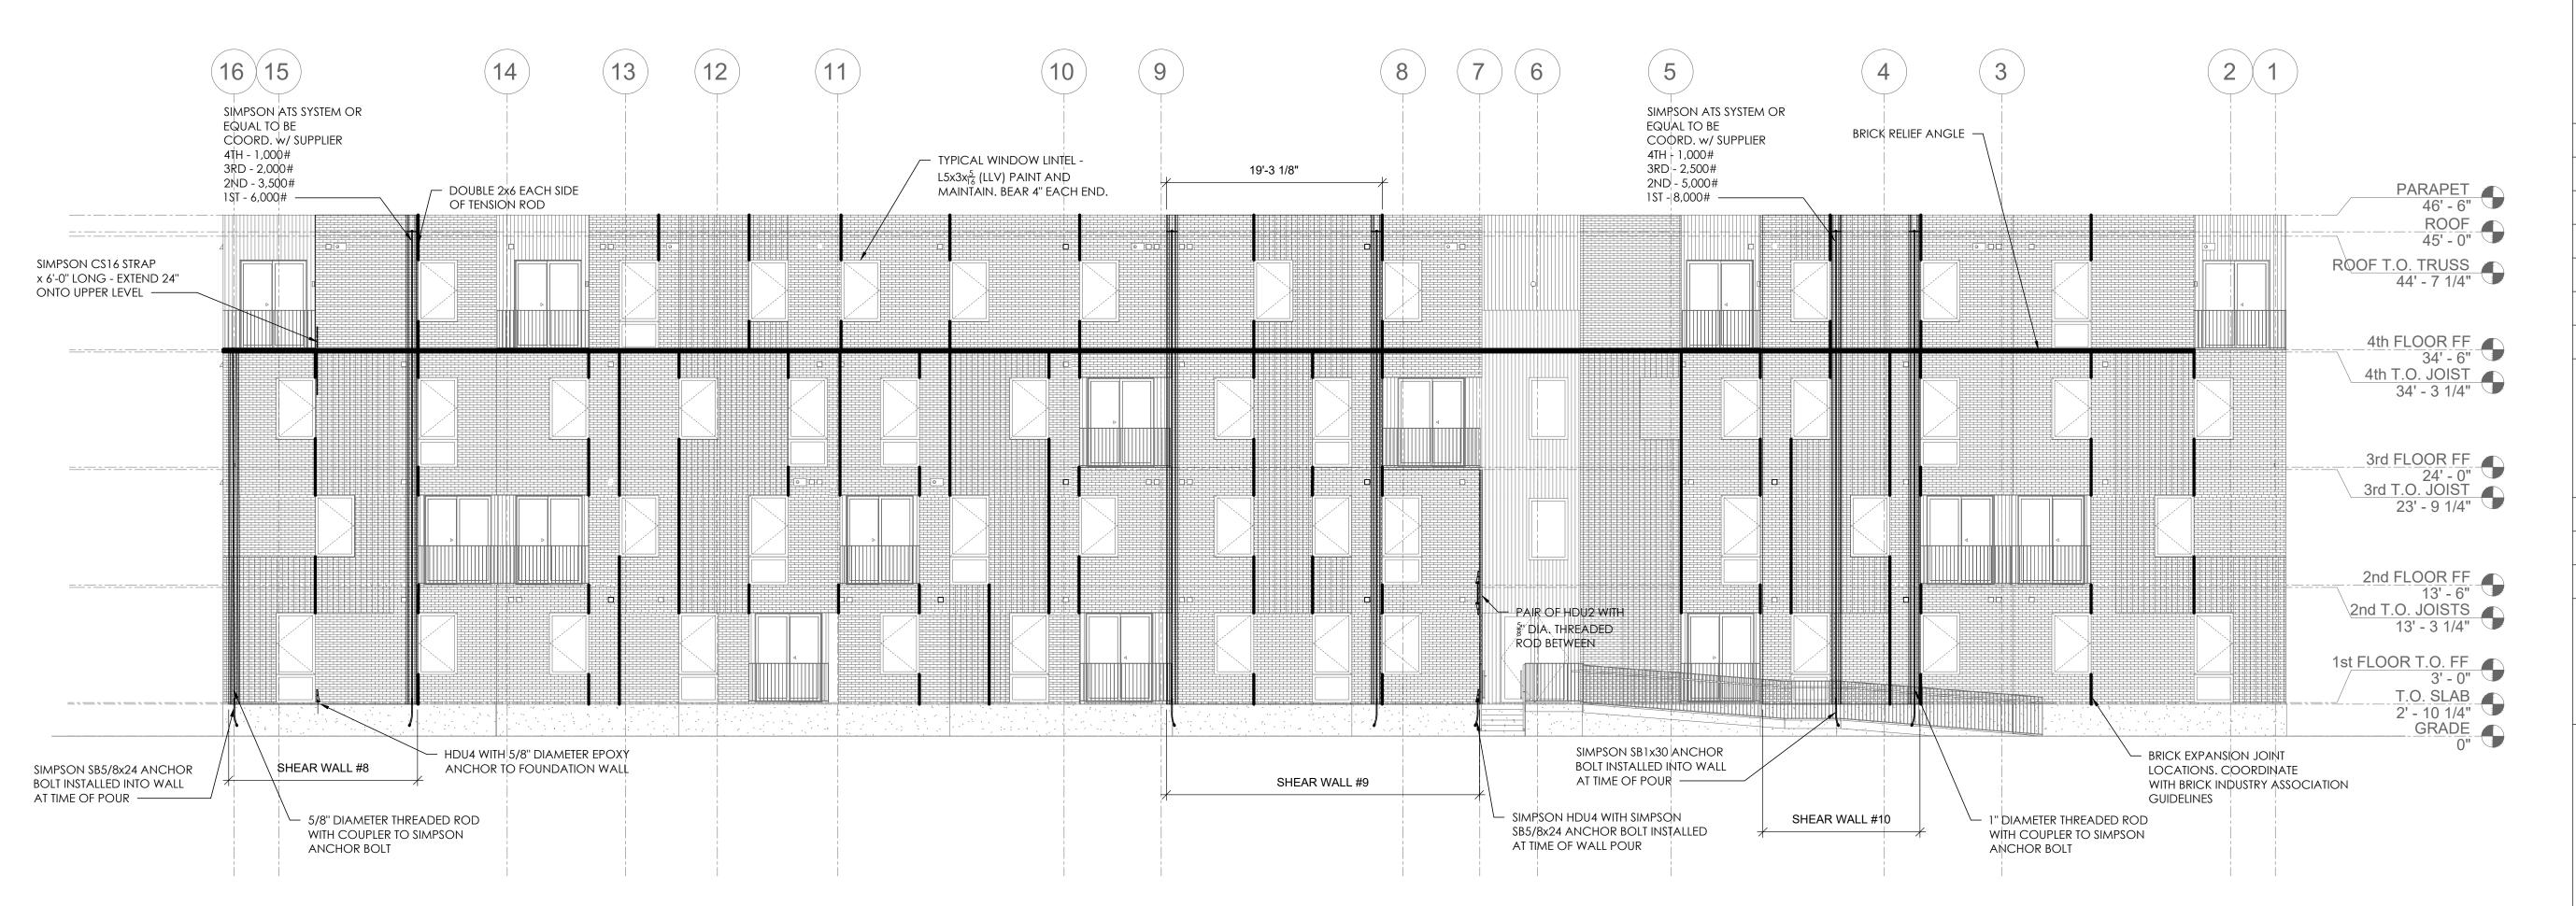
SHEAR WALL LOCATION PLAN FLOORS 1, 2, 3

SHEET NO.


S-108





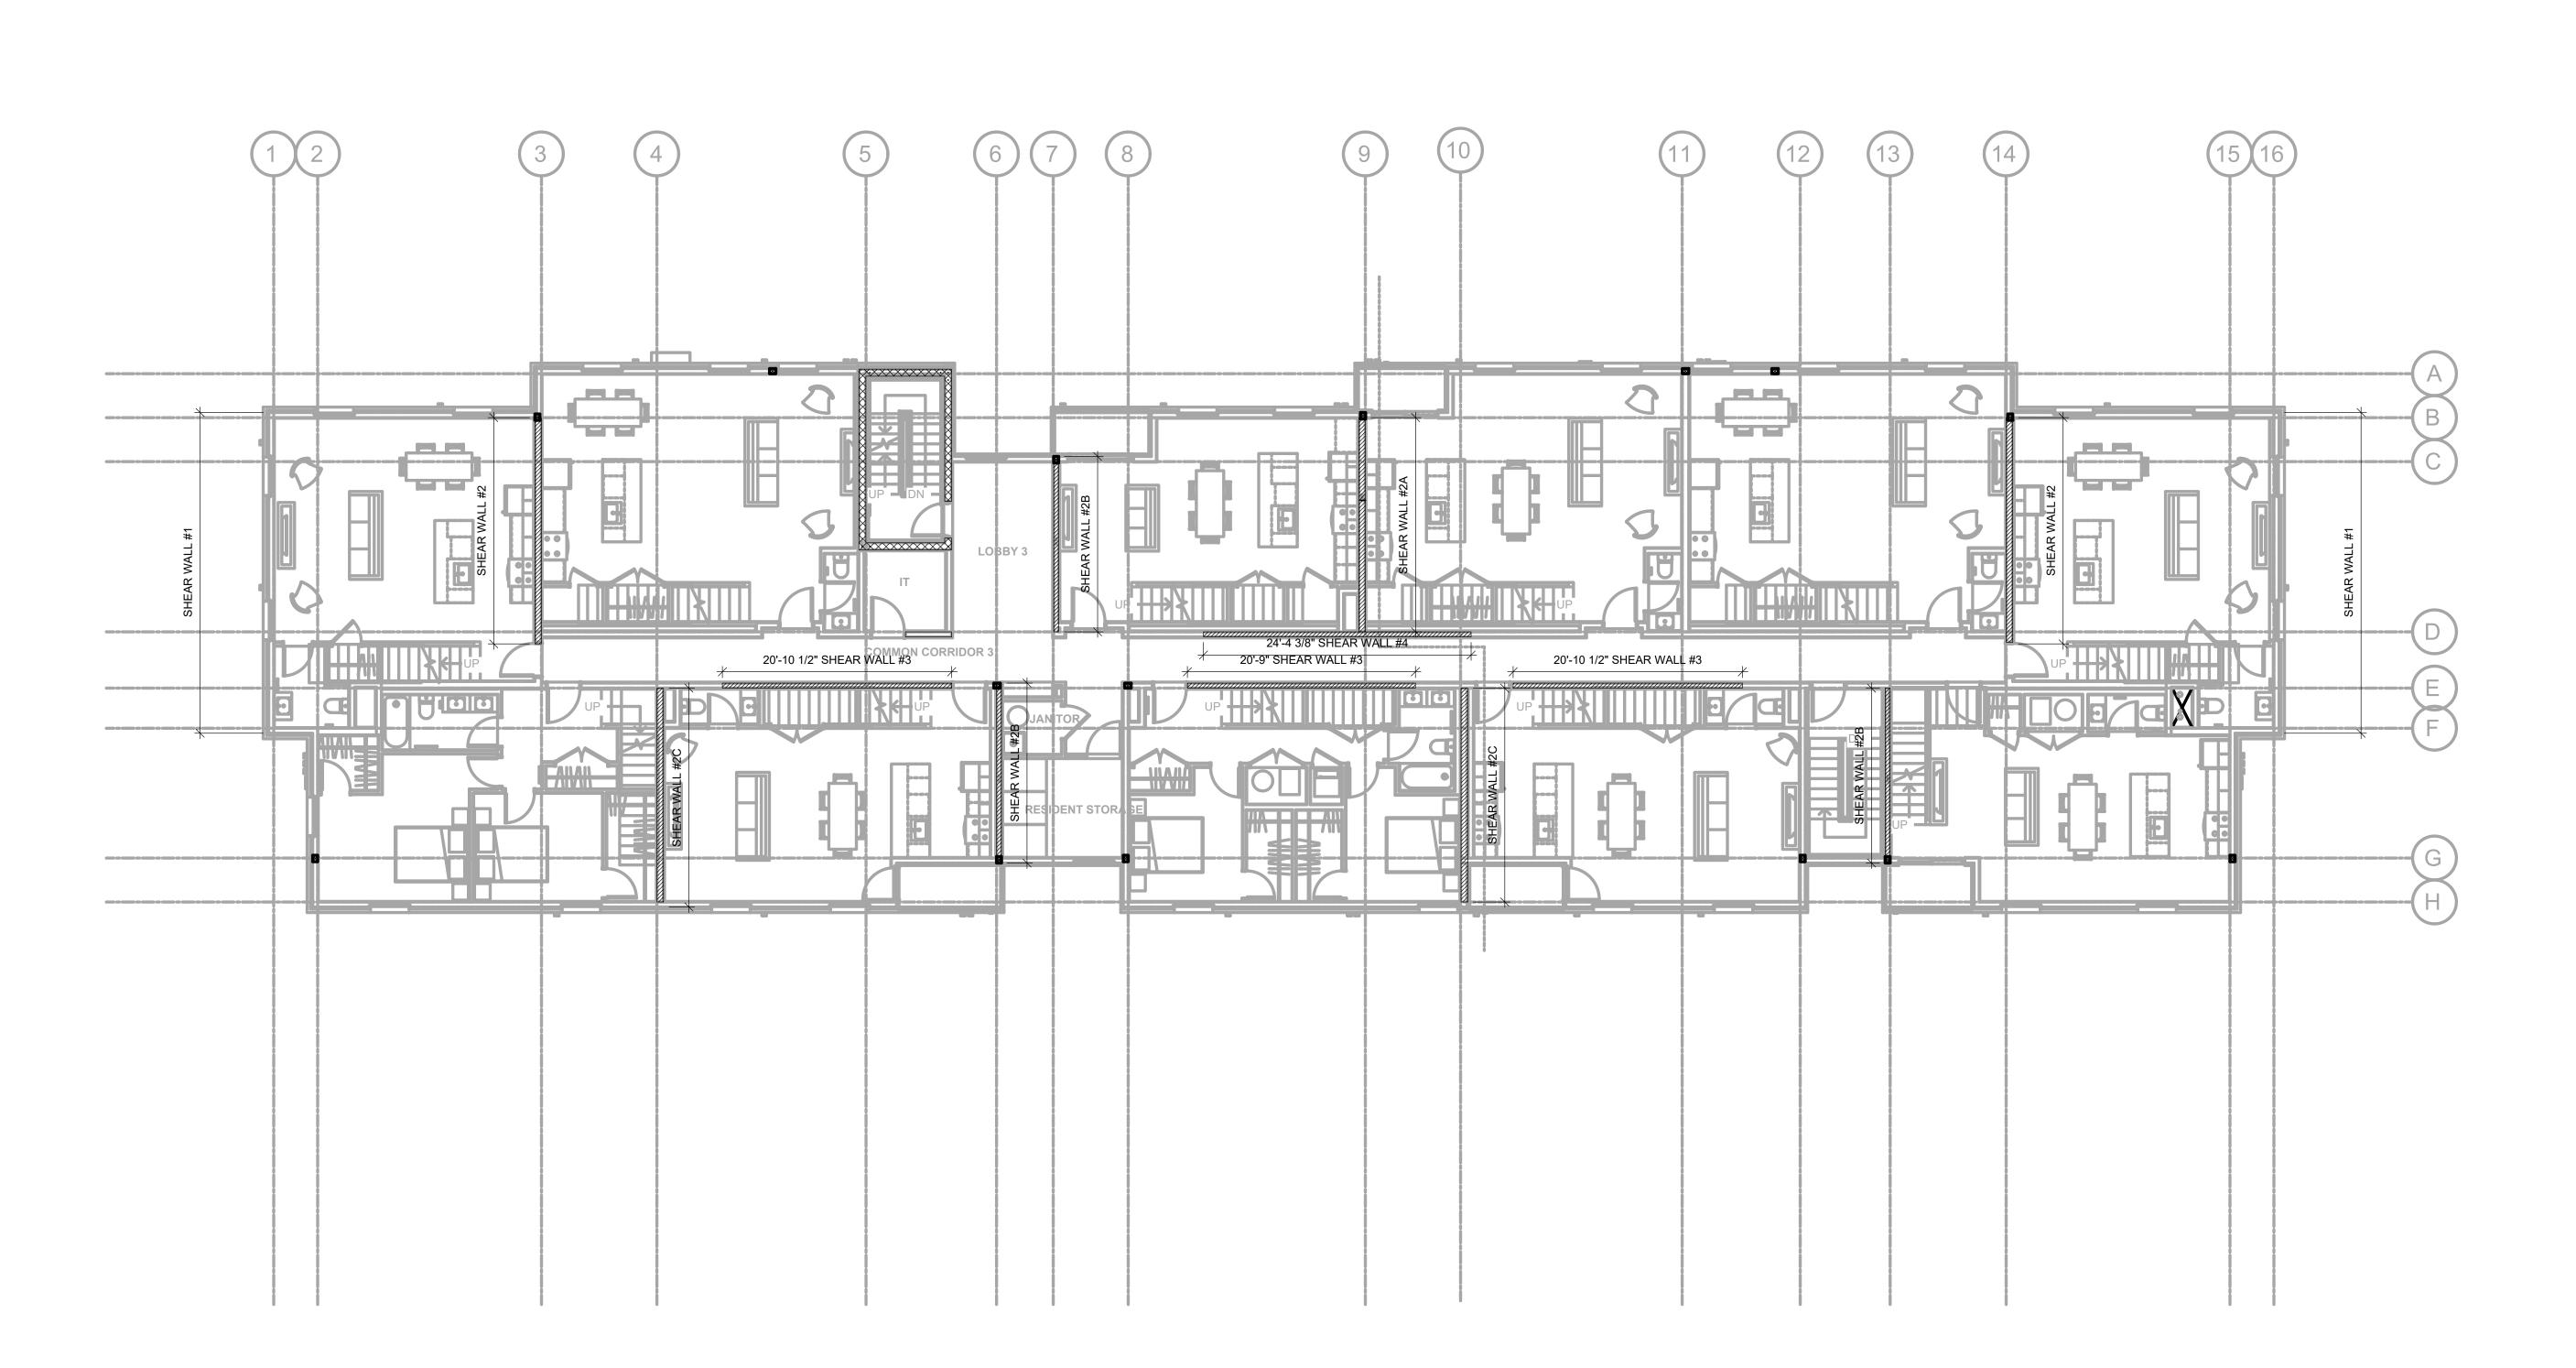

REGISTRATION

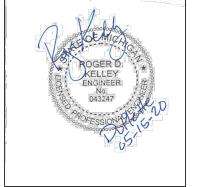

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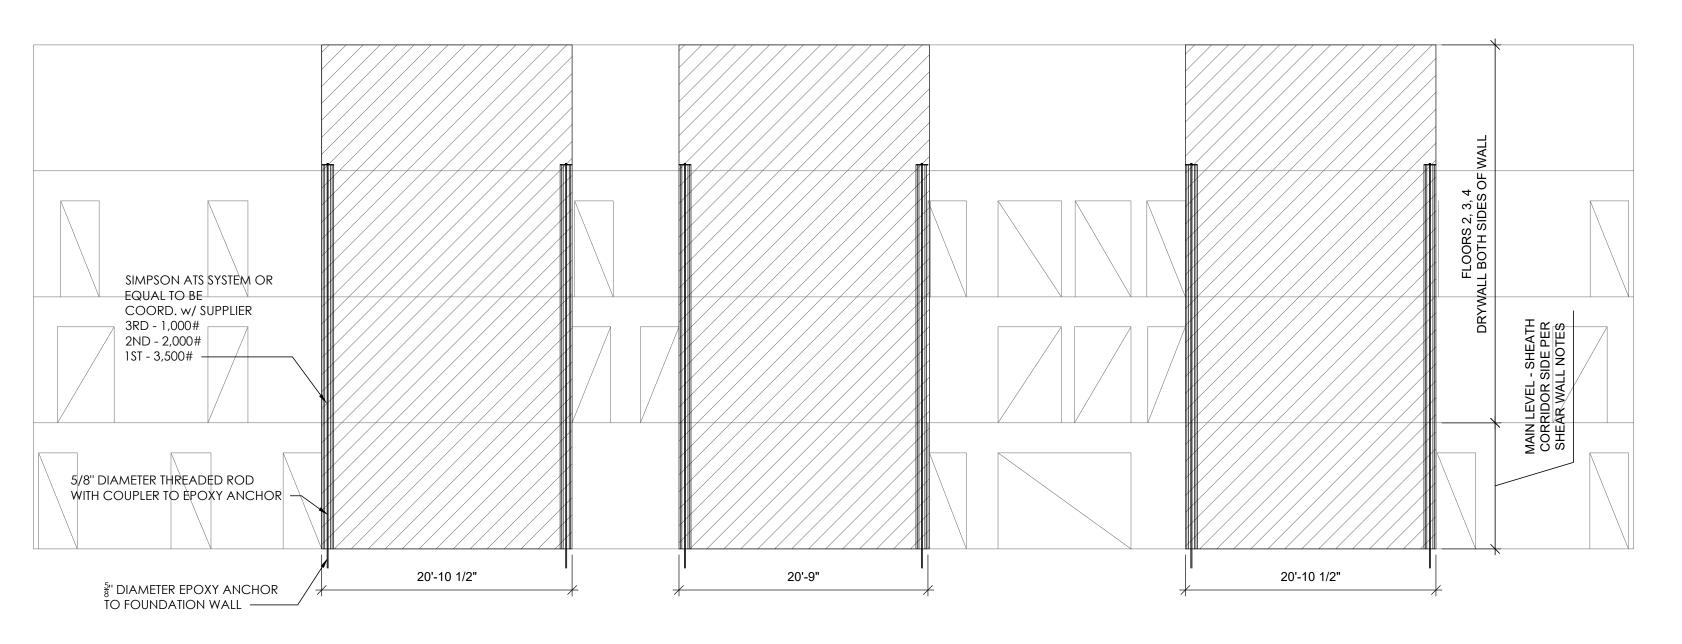
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05/15/20 DATE:


DRAWING TITLE

SHEAR WALL AND LINTEL ELEVATIONS

SHEET NO.



SHEAR WALL #3 ELEVATION LOOKING SOUTH

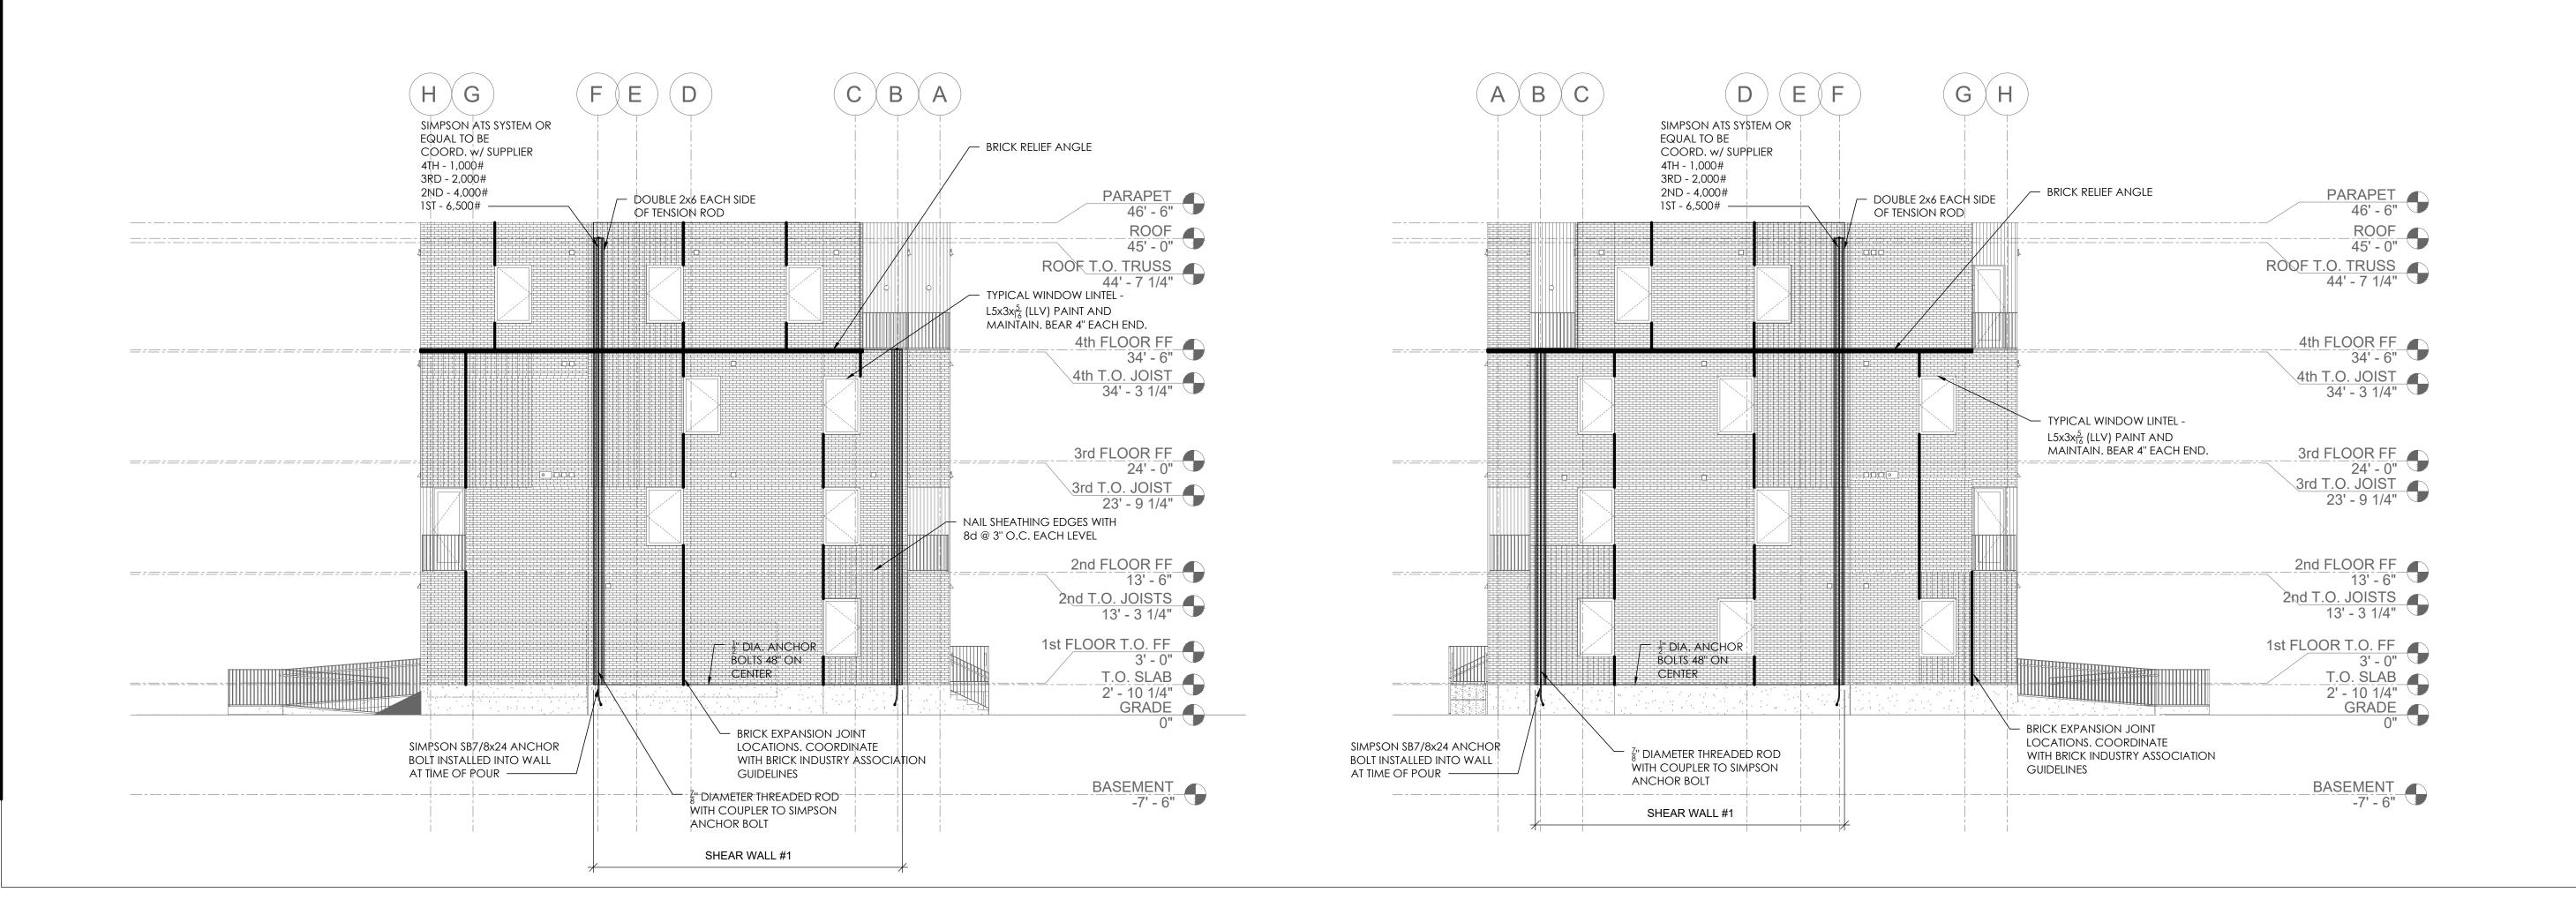

REGISTRATION

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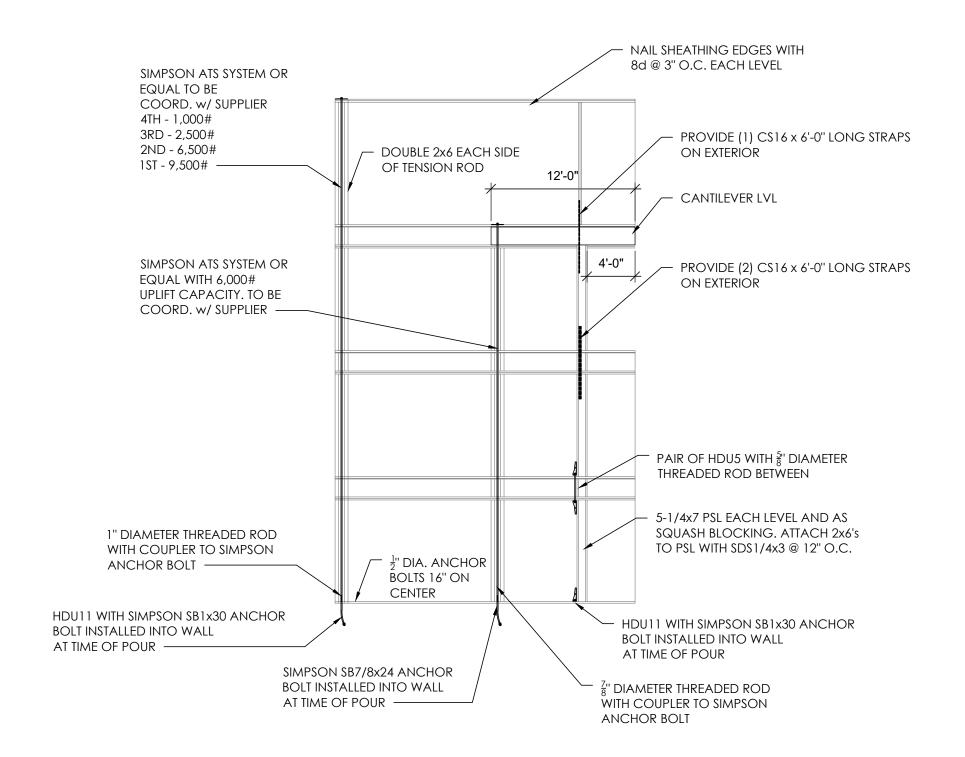
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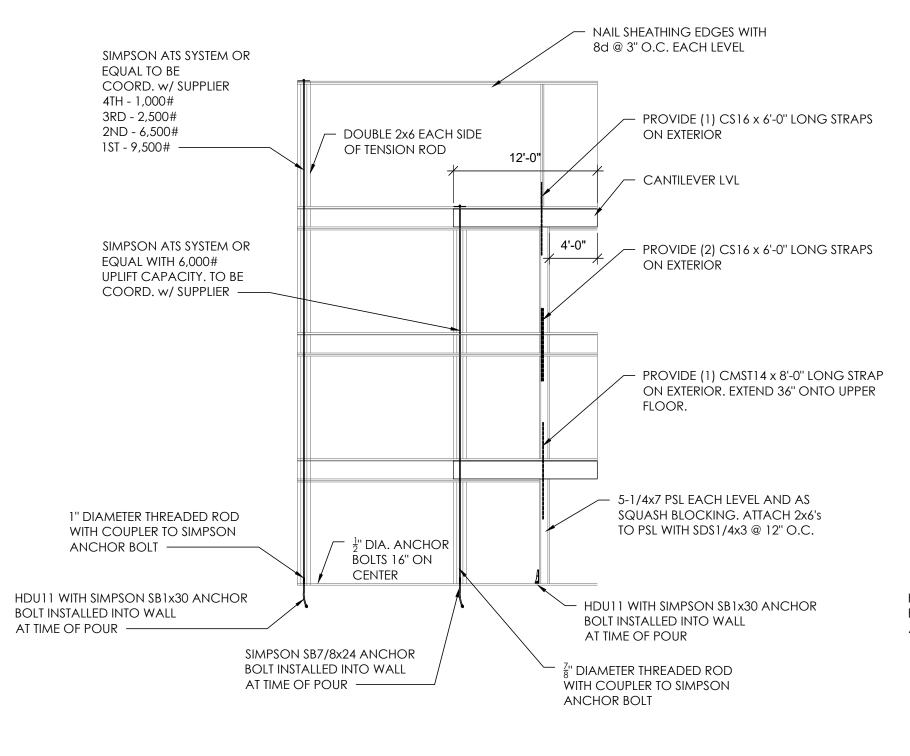
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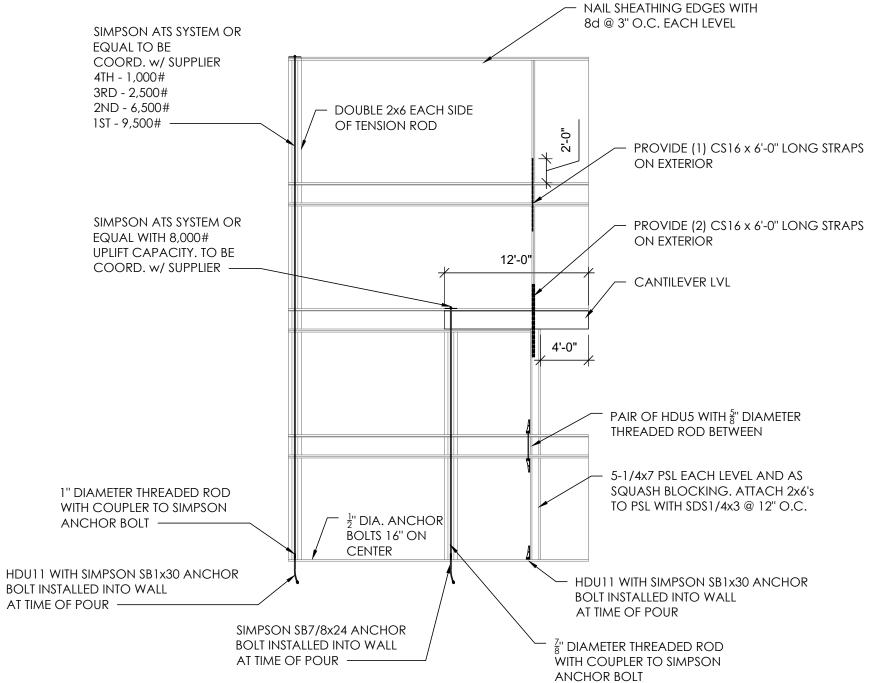
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SHEAR WALL AND LINTEL ELEVATIONS

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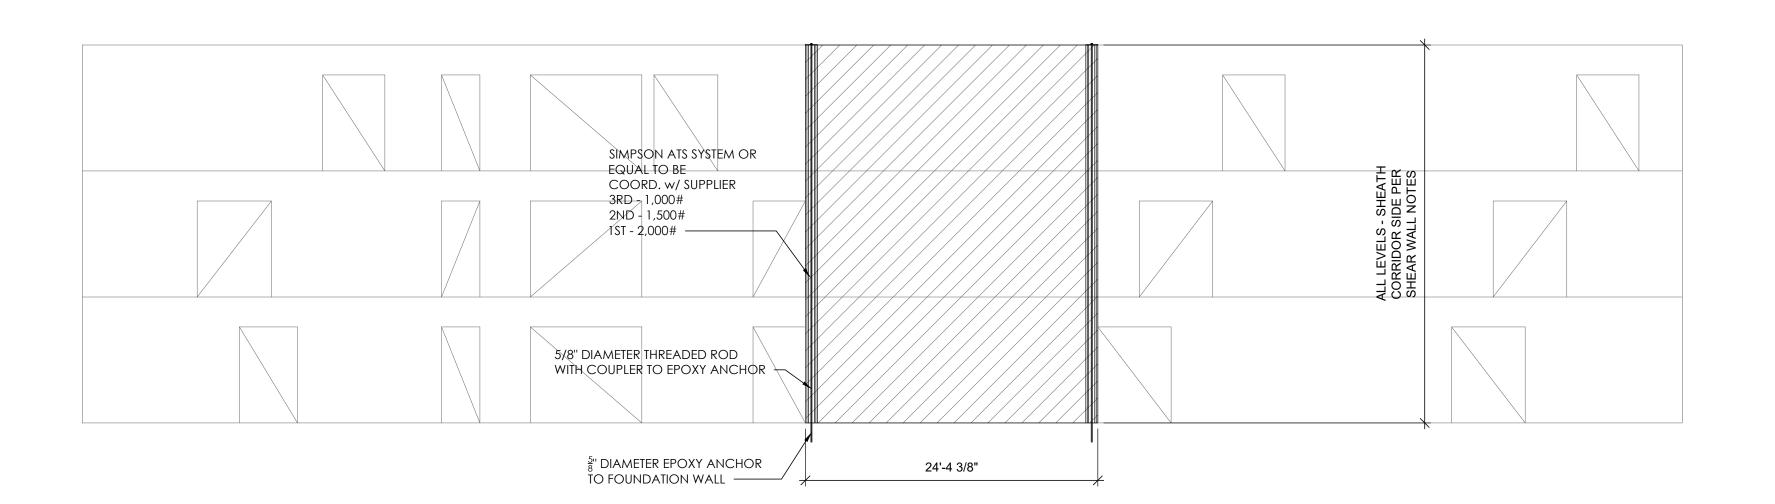





SHEAR WALL #2B ELEVATION

SHEAR WALL #2A ELEVATION

SHEAR WALL #2 ELEVATION




SHEAR WALL #4 ELEVATION LOOKING NORTH

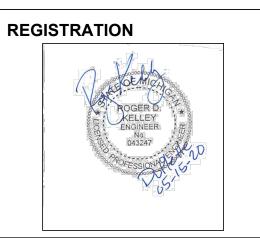

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JOB NO.:

DATE:


1/8" = 1'-0" SCALE: 05/15/20

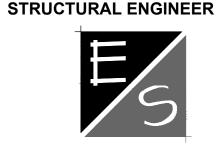DRAWING TITLE

SHEAR WALL ELEVATIONS

SHEET NO.

S-111

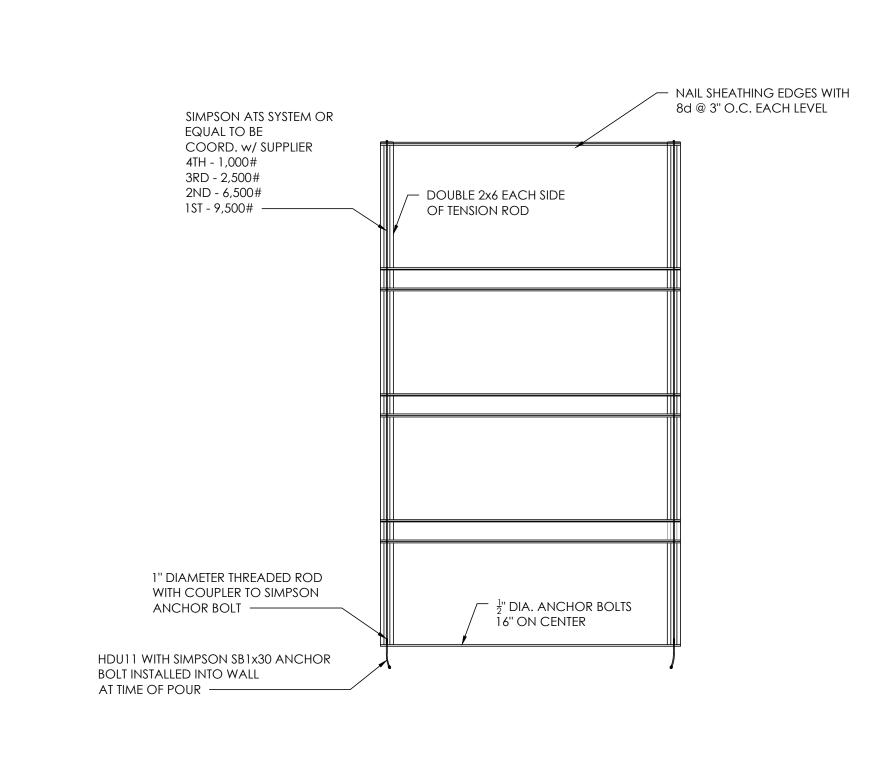

SHEAR WALL #2C ELEVATION

REGISTRATION

ROGER D.

ROGER D.

RELLEY
ENGINEER

043247

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JOB NO.:

SCALE: 1/8" = 1'-0"


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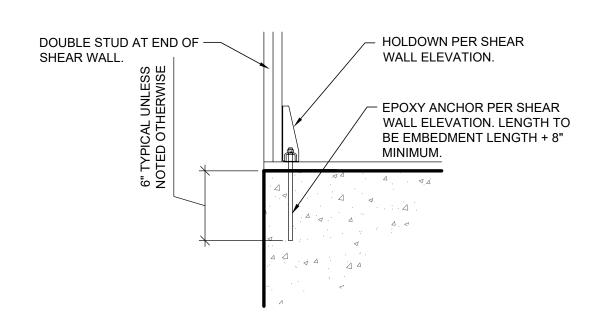
SHEAR WALL ELEVATIONS

SHEET NO.


S-112




SECTION AT FLOOR TO FLOOR HOLDOWN SCALE: 3/4"=1'-0"

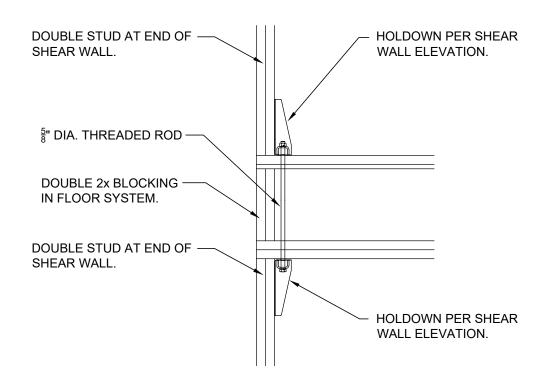



SECTION AT HOLDOWN TO FOUNDATION SCALE: 3/4"=1'-0"

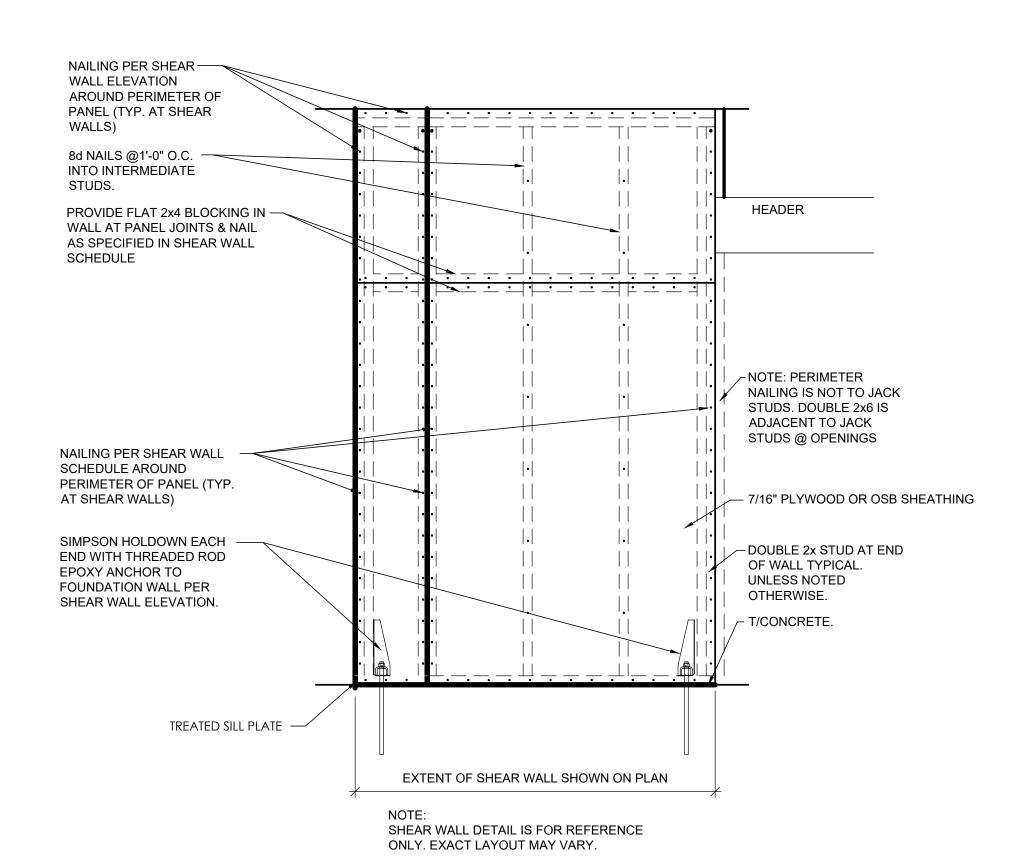


GENERIC SHEAR WALL ELEVATION SCALE: 3/4"=1'-0"

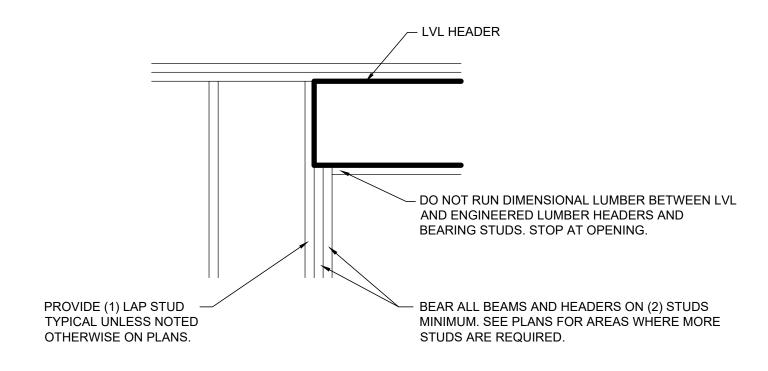

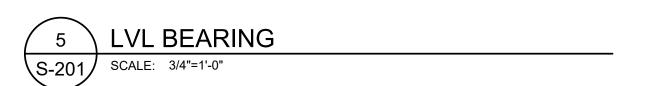

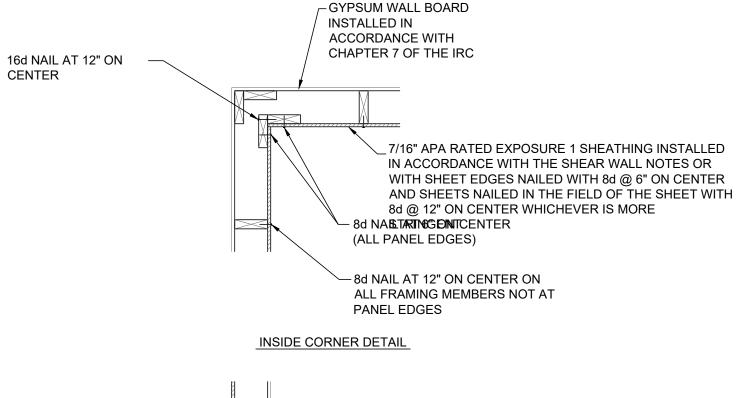

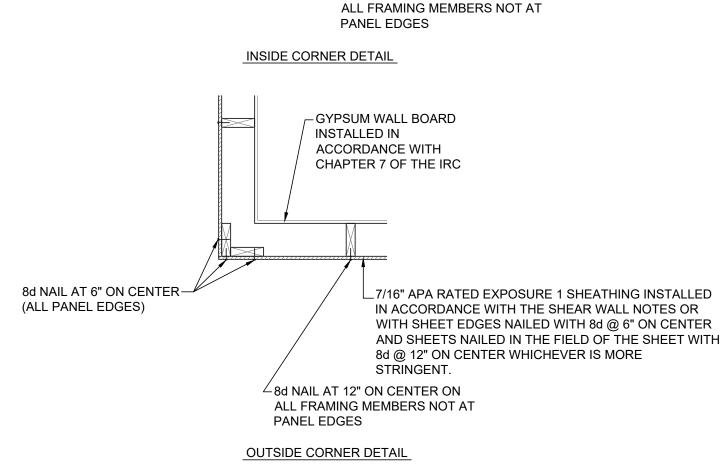


GENERAL NOTES:


1. PROVIDE 7/16" APA RATED EXPOSURE 1 SHEATHING ONE SIDE OF WALL. PLACE ON SAME SIDE AS EXTERIOR SHEATHING WHEN WALL LINE IS INTERIOR AND EXTERIOR.

2. NAIL ALL SHEET EDGES WITH 8d @ 6" ON CENTER.


3. PROVIDE SHEATHING ON ENTIRE SURFACE OF THE WALL INCLUDING ABOVE AND BELOW OPENINGS.

4. CONSULT ENGINEER FOR HEADERING OF ALL ENGINEERED LUMBER.

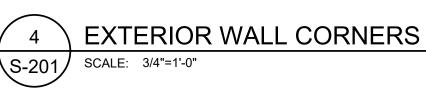


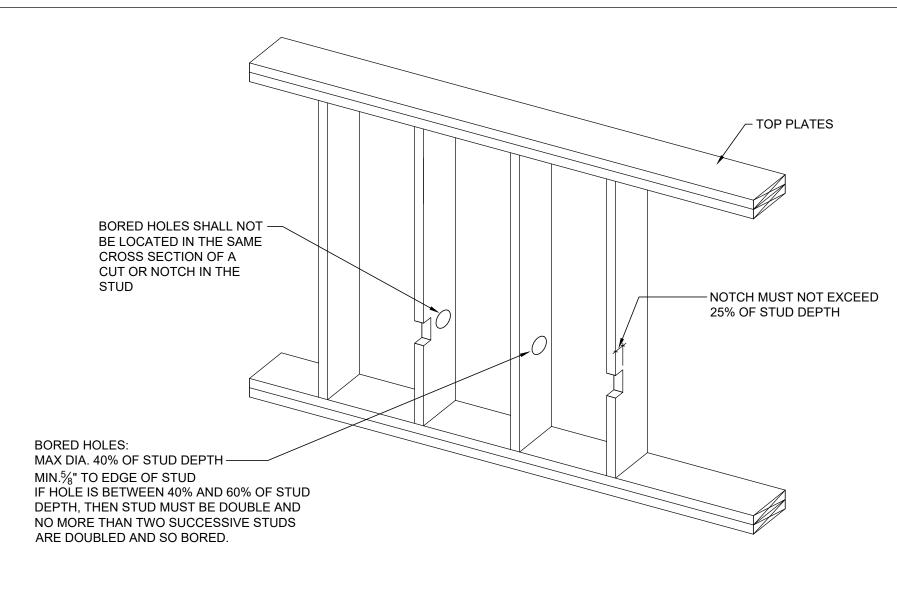

NOTCHING AND HOLES - R602.6(1) **EXTERIOR WALLS AND BEARING WALLS** SCALE: 3/4"=1'-0"

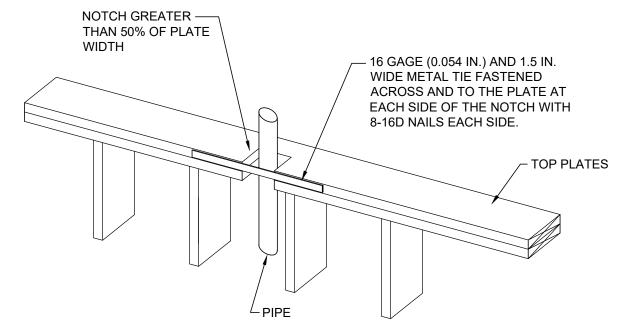

TOP PLATE PIPING ACCOMODATION R602.6.1 SCALE: 3/4"=1'-0"

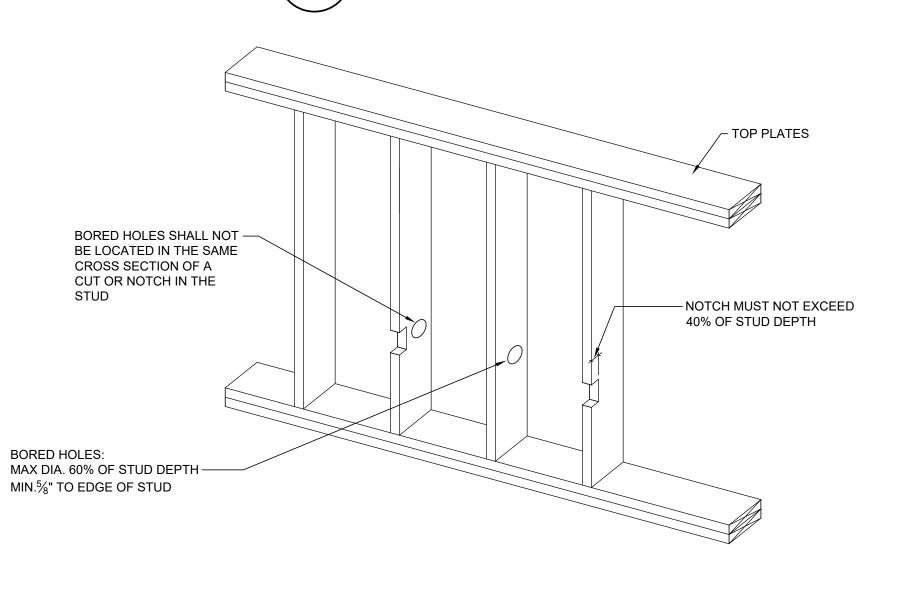

NOTCHING AND HOLES - R602.6(2) **INTERIOR NON-BEARING WALLS** SCALE: 3/4"=1'-0" \S-201/

REGISTRATION

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STRUCTURAL ENGINEER



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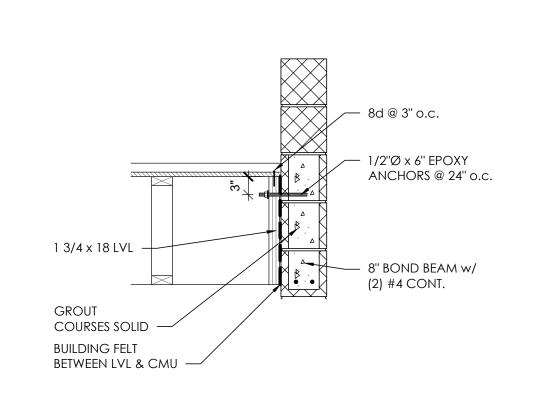
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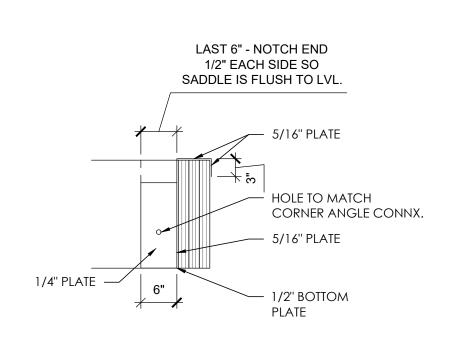
DATE: 05/15/20 DRAWING TITLE


FRAMING DETAILS

SHEET NO.








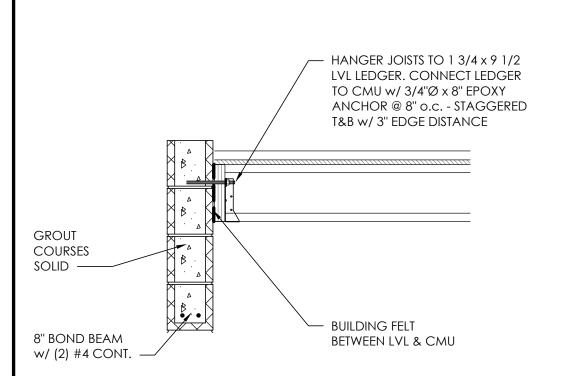



SECTION


SCALE: 3/4"=1'-0"


S-202

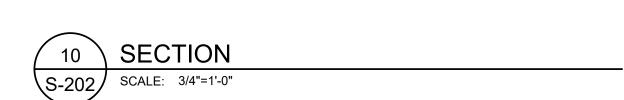

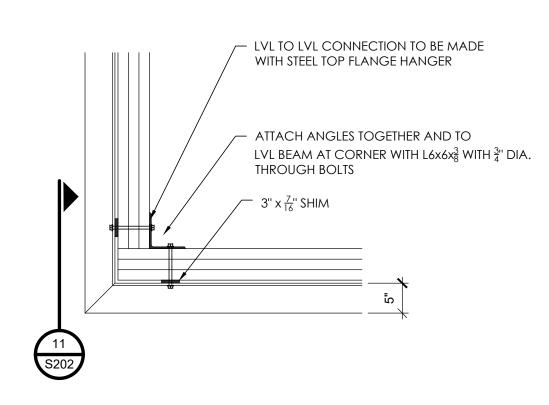


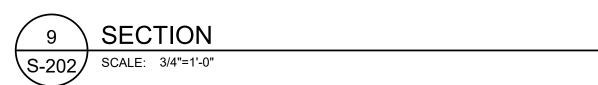

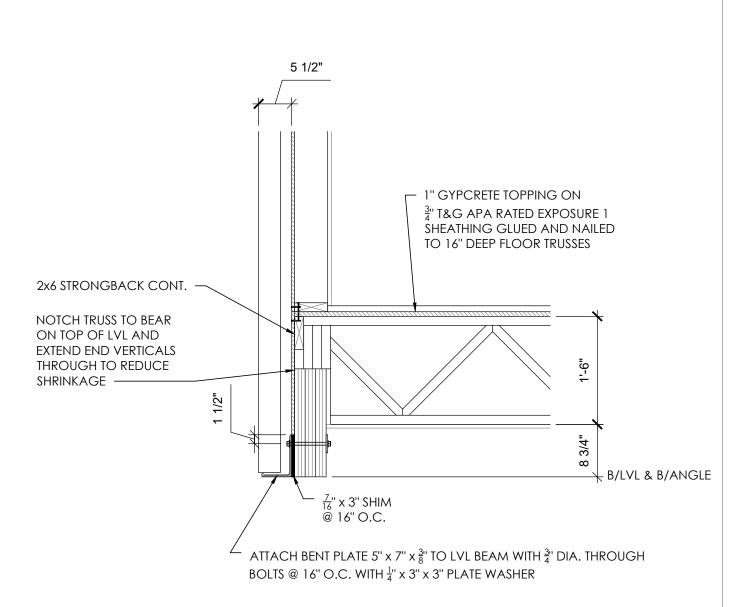


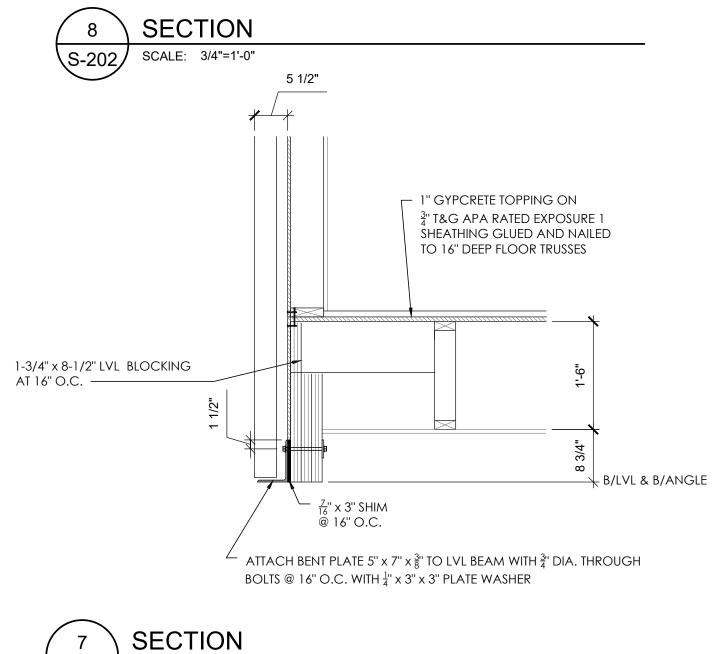



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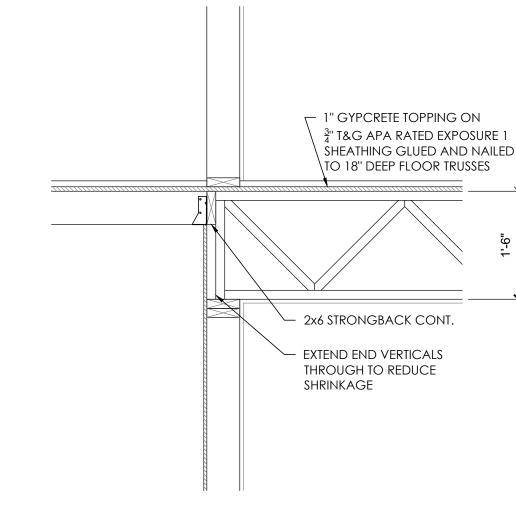


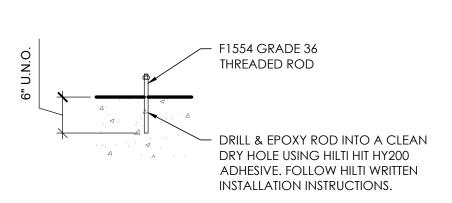





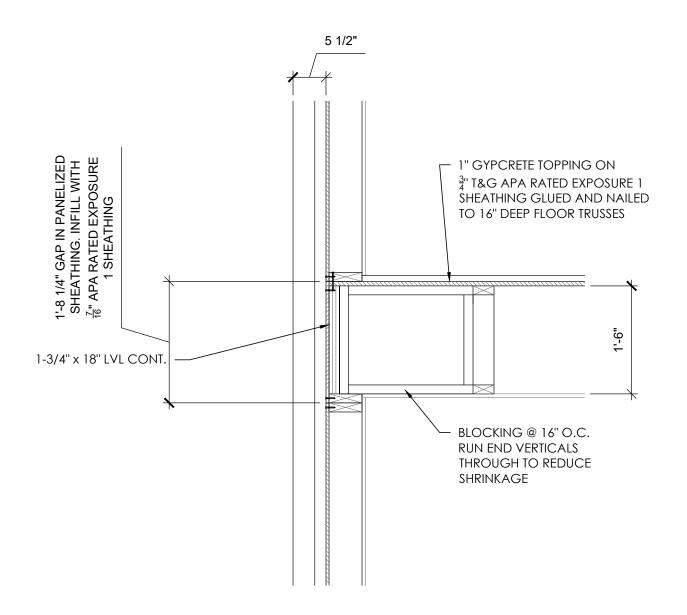


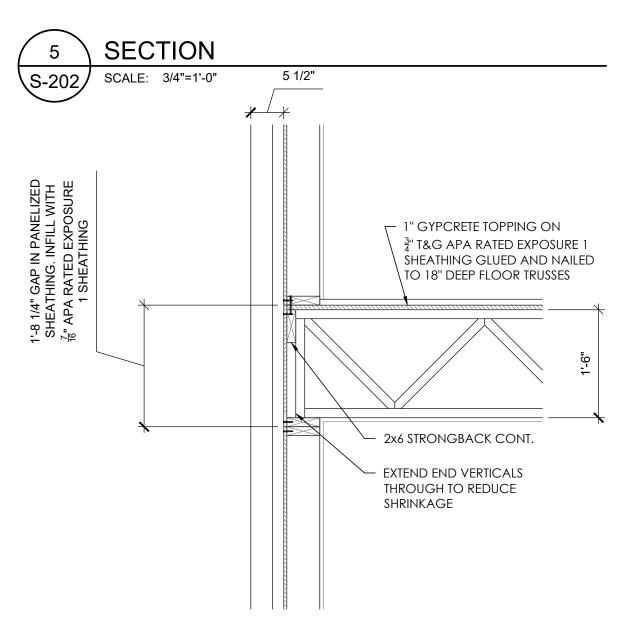
S-202 SCALE: 3/4"=1'-0"

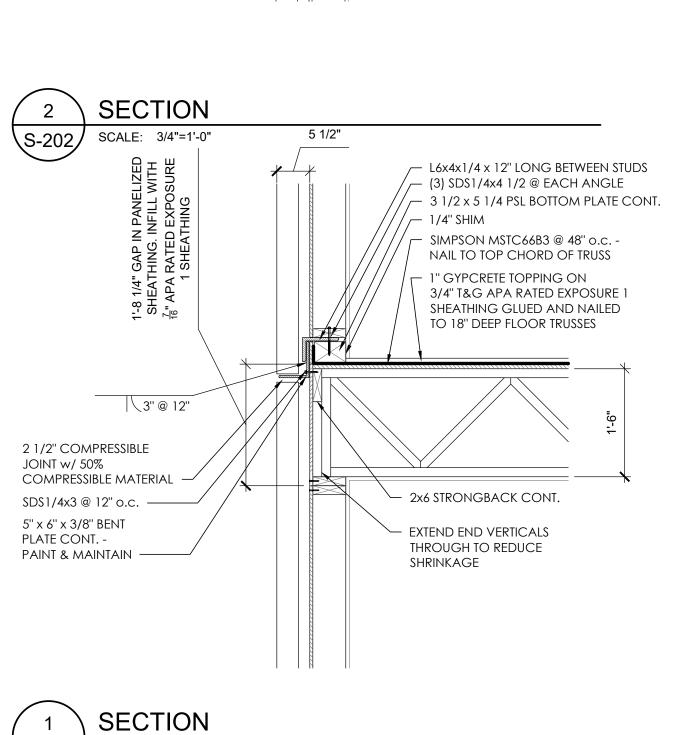

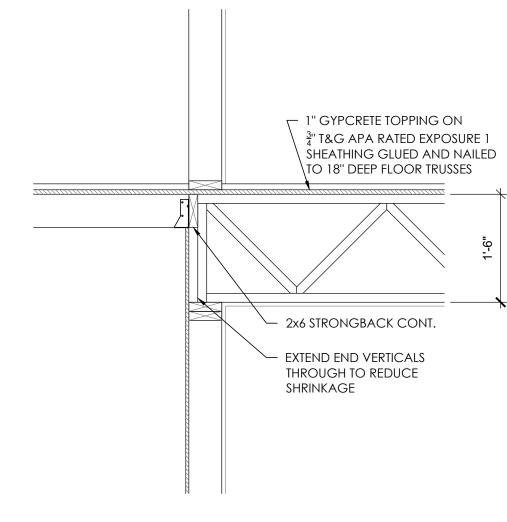

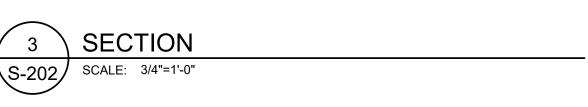

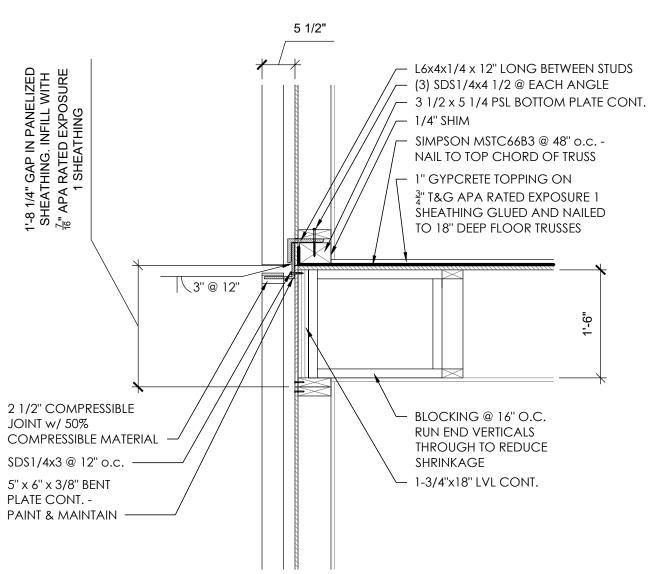

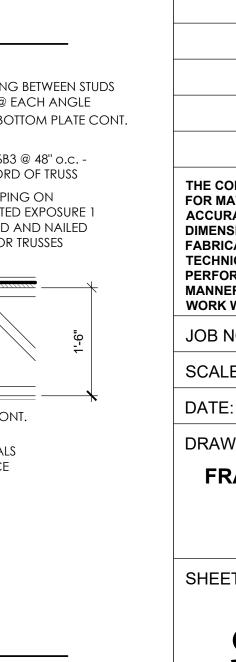

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FABRICATION PROCESSES, FOR
TECHNIQUES OF ASSEMBLY, FOR
PERFORMING WORK IN A SAFE MANNER, AND FOR COORDINATING **WORK WITH THAT OF ALL TRADES** JOB NO.:

Duplette

Brush

48

REGISTRATION

OWNER

ARCHITECT

MERGE ARCHITECTS, INC. 332 CONGRESS ST. FLOOR 6 BOSTON, MA 02210 T: 617.670.0265

ENGINEERED STRUCTURES, LLC

T: 616.667.9650 es2@comcast.net

STRUCTURAL ENGINEER

LAFAYETTE PARK LANDOWNERS LLC.

3/4" = 1'-0"

SCALE: 05/15/20


DRAWING TITLE

FRAMING DETAILS


SHEET NO.

S-202

100% CD / PERMIT SET

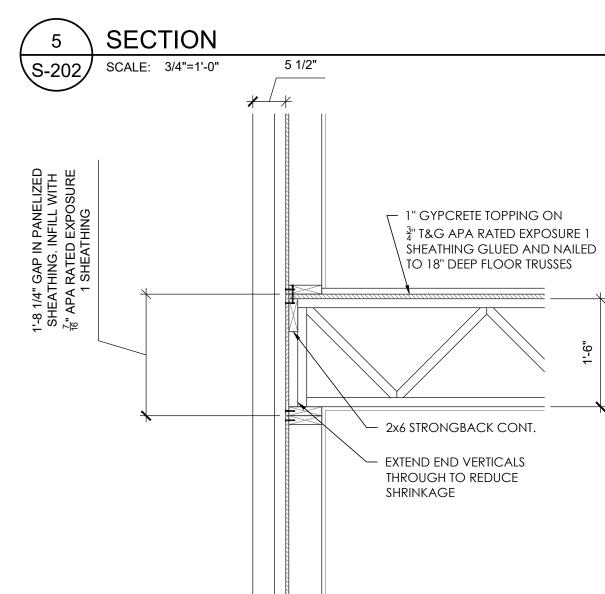

SCALE: 3/4"=1'-0"

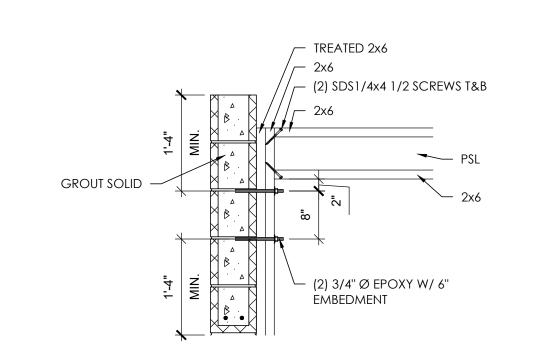


7/16" APA RATED EXP. 1

PLYWOOD SHEATHING

─ 2x4 STRONGBACK

CONT.

SDS1/4x4 1/2 @ EACH TRUSS

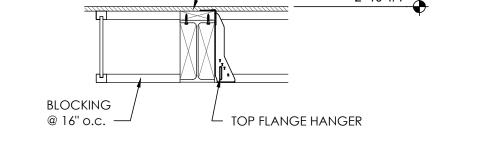



_ 2x RIPPED TO MATCH BEAM WIDTH.

CONNECT w/ (2) SD\$1/4x1 1/2 @ 24" o.c.






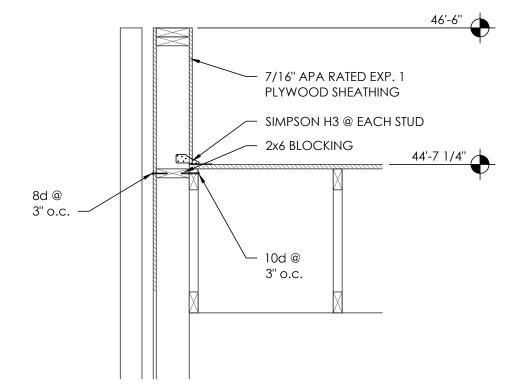

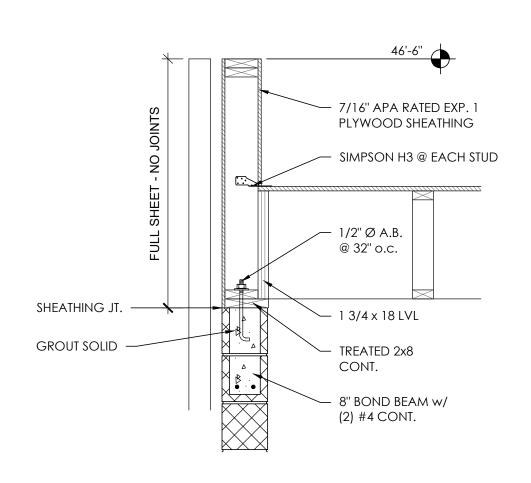


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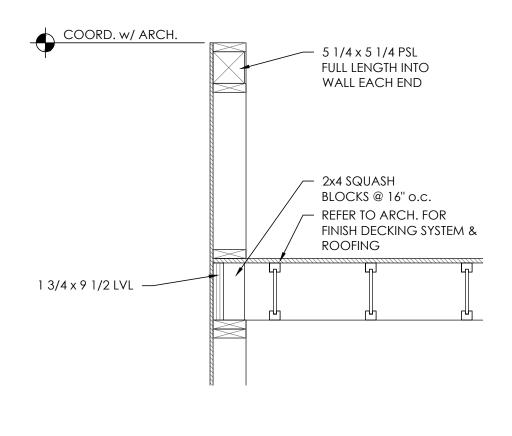
SCALE: 3/4" = 1'-0"

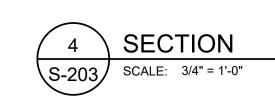


SHEATHING JT.






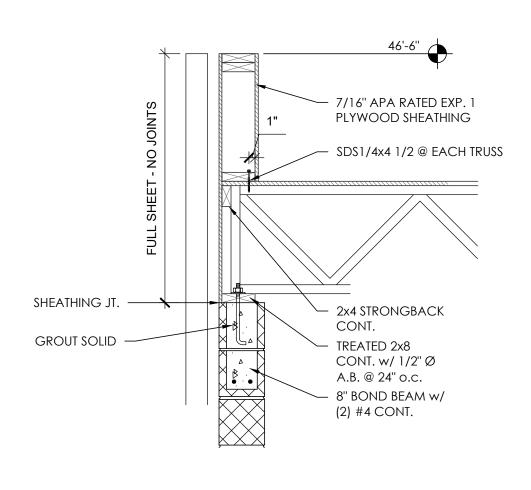

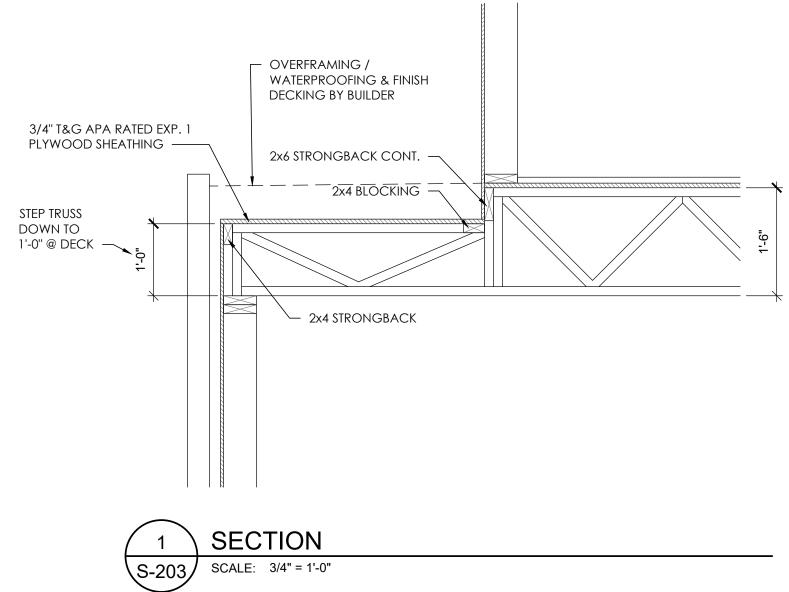





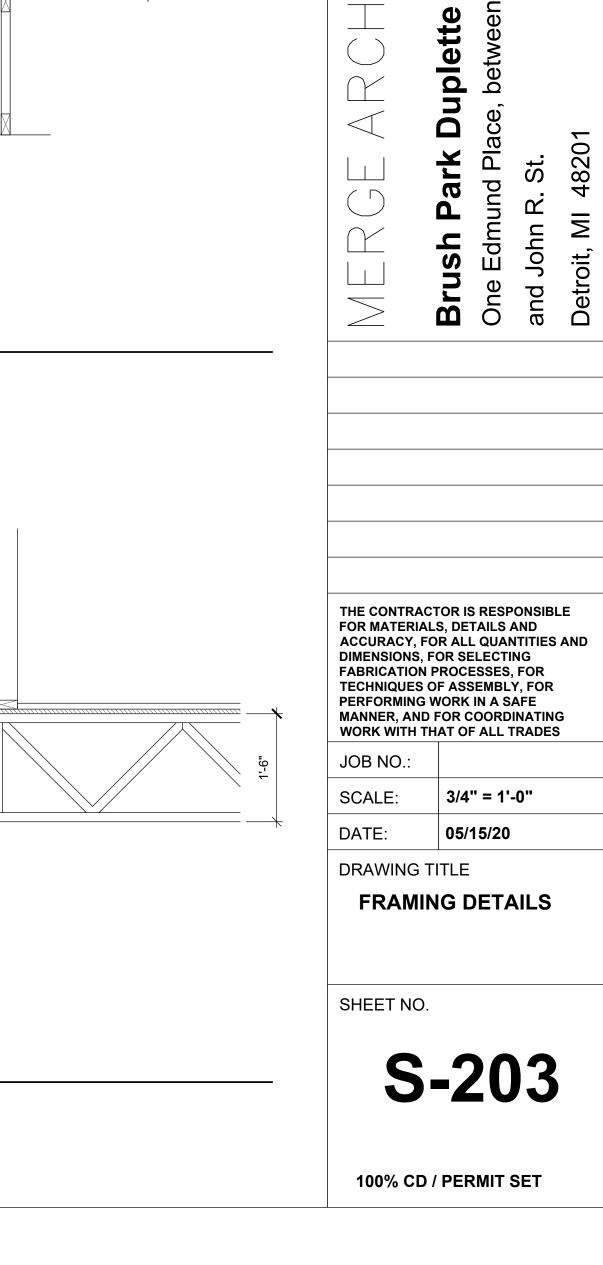

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LAFAYETTE PARK LANDOWNERS LLC.

STRUCTURAL ENGINEER

Detroit, MI 48

MECHANICAL ARREVIATIONS

HEATING HOT WATER PUMP

W.C.O.

WALL CLEANOUT WATER HEATER

HHWP

MECHANICAL SYMBOLS

NOTE: ALL SYMBOLS MAY NOT BE USED ON THIS PROJECT.

<u>SYMBOL</u>

─

DESCRIPTION

GATE VALVE

GLOBE VALVE

BALL VALVE

CHECK VALVE

BALANCING VALVE

& FLOW METER

SOLENOID VALVE

PLUG VALVE

CONTROL VALVE

BUTTERFLY VALVE

THERMOMETER

STRAINER

UNION

REMOVE

COMBINATION BALANCE VALVE

MOTOR OPERATED VALVE

THREE WAY CONTROL VALVE

PRESSURE REGULATOR VALVE

PRESSURE GAGE WITH COCK

FLEXIBLE CONNECTOR

CONNECT TO EXISTING

PIPE TURNED UP

PIPE OUT TOP

PIPE OUT BOTTOM

PIPE TURNED DOWN

CAP OFF EXISTING

PRESSURE RELIEF VALVE

ADDDE (IATIO	MECHANICAL ABBREVIATIONS IN CENERAL ARE LISTED OF		AFNT TO 0 4		MECHANICAL SY
	ONS USED ON DRAWINGS IN GENERAL ARE LISTED E EMBER 1986 FOR ANY ABBREVIATION USED ON THE				
AC	AIR CONDITIONING	HP	HORSEPOWER		
ACCU	AIR COOLED CONDENSING UNIT	HPR	HIGH PRESSURE STEAM RETURN	SYMBOL	DESCRIPTION
ACU	AIR CONDITIONING UNIT	HPS	HIGH PRESSURE STEAM SUPPLY		DETUDNI AID ODILLE
AFF	ABOVE FINISHED FLOOR	HRU HTR	HEAT RECOVERY UNIT HEATER		RETURN AIR GRILLE
AFMS	AIR FLOW MEASURING STATION	HVAC	HEATING/VENTILATING/AIR CONDITIONING	M	SUPPLY AIR DIFFUSER
AHU	AIR HANDLING UNIT	HW	HOT WATER (DOMESTIC)	K 3	SOFFEI AIN DITTOSEN
A.L.	2" THICK ACOUSTIC DUCT LINER	ID	INSIDE DIAMETER		
ALT	ALTERNATIVE	INCIN	INCINERATOR		HORIZONTAL FIRE DAMPER
AMB	AMBIENT	INSUL IV	INSULATION/INSULATE INTAKE VENT		
AP	ACCESS PANEL	INTR	INTERIOR		VERTICAL FIRE DAMPER
APPROX	APPROXIMATE	INV	INVERT		VERTICAL FIRE DAMPER
AR	ACID RESISTANT	KIT	KITCHEN		
ARCH	ARCHITECT(URAL)	KW	KILOWATT		VOLUME DAMPER
ARV	AIR RELIEF VALVE	L	LENGTH/LONG		
AT ATR	AIR TRANSFER AIR TEMPERATURE RISE	LAV	LAVATORY		VERTICAL SMOKE DAMPER
ATV	AIR TURNING VANES	LP LPR	LIQUID PETROLEUM LOW PRESSURE STEAM RETURN		VERTICALE CINCINE DAMM EX
AUTO	AUTOMATIC	LPS	LOW PRESSURE STEAM SUPPLY		TEMPER (TURE OF MORE)
AVE	AIR VOLUME EXTRACTOR	LVR	LOUVER	®	TEMPERATURE SENSOR
3-# 35	BOILER	M	METER	lacktriangle	THERMOSTAT OR SENSOR
BD BDD	BAROMETRIC DAMPER BACKDRAFT DAMPER	MAX MECH	MAXIMUM MECHANICAL	•	
BHP	BREAK HORSEPOWER	MFR	MANUFACTURER	M	DAMPER MOTOR
BLDG	BUILDING	MH	MANHOLE		
BOD	BOTTOM OF DUCT	MIN	MINIMUM	SP	STATIC PRESSURE PROBE
BOT C	BOTTOM CONVECTOR	MISC	MISCELLANEOUS		
C CAB	CONVECTOR	MPR MPS	MEDIUM PRESSURE STEAM RETURN MEDIUM PRESSURE STEAM SUPPLY		COMPINATION FIRE / CHOICE DAMPED
CD-#	CEILING DIFFUSER	MPS MTD	MOUNTED		COMBINATION FIRE / SMOKE DAMPER
CIA	COMBUSTION INTAKE AIR	NIC	NOT IN CONTRACT	1	
CFM	CUBIC FEET PER MINUTE	NO/#	NUMBER		COMBINATION FIRE / SMOKE DAMPER
CHWR CHWS	CHILLED WATER RETURN CHILLED WATER SUPPLY	NOM	NOMINAL		
CHWP	CHILLED WATER PUMP	NTS	NOT TO SCALE		
CL	CENTERLINE	OA OO	OUTSIDE AIR	<u>SYMBOL</u>	DESCRIPTION
CLG	CEILING	OC OD	ON CENTER OUTSIDE DIAMETER		. SUPPLY AIR ELBOW UP
CMP	CORRUGATED METAL PIPE	OPNG	OPENING	N /	DIMENSION DESCRIPTION: 1ST FIGURE = SIDE SHOWN
C.O. COL	CLEAN OUT COLUMN	ORD-#	OVERFLOW ROOF DRAIN	36"x24"	2ND FIGURE = SIDE NOT SHOWN
CONC	CONCRETE	OS	OIL SUPPLY		1 ALL SIZES IN INCHES
COND	CONDENSER(ATE)	OSD	OPEN SITE DRAIN	N 4	4
CRTN	LOW PRESSURE STEAM CONDENSATE	PE	PNEUMATIC/ELECTRIC	[x]	SUPPLY AIR ELBOW DOWN
CONSTR	CONSTRUCTION	PREFAB PRV	PREFABRICATED PRESSURE REDUCING VALVE	V N	1
CONTR CPD	CONTRACTOR CONDENSATE PUMP DISCHARGE	PSF	POUNDS PER SQUARE FOOT		1
CP	CIRC PUMP	PSI	POUNDS PER SQUARE INCH] >
CT-#	COOLING TOWER	PTAC	PACKAGE TERMINAL AIR CONDITIONING UNIT	<u> </u>	
CUH-#	CABINET UNIT HEATER	PVC	POLYVINYL CHLORIDE		
CW CWP	COLD WATER (DOMESTIC) CONDENSER WATER PUMP	R/RAD	RADIUS		4
CWR	CONDENSER WATER RETURN	RA RACU	RETURN AIR ROOM AIR CONDITIONING UNIT	[/]	EXHAUST/RETURN AIR ELBOW DOWN
CWS	CONDENSER WATER SUPPLY	RADN	RADIATION		1
D	DEPTH/DEEP	RG-#	RETURN AIR GRILLE	1	DOUBLE SIDE TRANSITION
DB	DRY BULB TEMPERATURE	RCP	REINFORCED CONCRETE PIPE	36"x12" 24"x12" 3	TRANSITION SLOPE SPECIFICATION: MINIMUM SLOPE = 15°
DIA/ø DIFF	DIAMETER DIFFUSER	RD-#	ROOF DRAIN	30 X12 24 X12	MAXIMUM SLOPE = 45° ALL SIZES IN INCHES
DISCH	DISCHARGE	REG REQ'D	REGISTER REQUIRED		ALL SIZES IN INCHES
DLR	DOUBLE LOUVER REGISTER	RHW	RECIRCULATED HOT WATER (DOMESTIC)		
OWG	DRAWING	RL	REFRIGERANT LIQUID	736"x12" 24"x12" 3	SINGLE SIDE TRANSITION
DUC	DOOR UNDER CUT	RL48	RETURN LINEAR SLOT DIFFUSER (48" LONG)	7 36 X 12 24"x12" 3	1
F-#	EXHAUST FAN	RM	ROOM		
:FF :G-#	EFFICIENCY EXHAUST GRILLE	RP RPM	RADIANT PANEL REVOLUTIONS PER MINUTE	 	1
i.o " IL	ELEVATION	RS	REFRIGERANT SUCTION	する"x18" 36"x12"*	TOP TRANSITION (SLOPE ON TOP)
ELEC	ELECTRIC(AL)	RSD	ROUND SUPPLY DIFFUSER	 	1
ELEV	ELEVATOR	SA	SUPPLY AIR		1
EMD EMER	END OF MAIN DRIP	SCHED	SCHEDULE	7 36"x18" 36"x12"] 7 BOTTOM TRANSITION (SLOPE ON BOTTOM)
EP	EMERGENCY ELECTRIC/PNEUMATIC	SD-#	SUPPLY DIFFUSER		
-i EQUIP	EQUIPMENT	SG-#	SUPPLY AIR GRILLE		
XH	EXHAUST	SHT SIM	SHEET SIMILAR		
XIST	EXISTING	SL48	SUPPLY LINEAR SLOT DIFFUSER (48" LONG)	36"x18" 18"ø	RECTANGULAR TO ROUND TRANSITION
XP	EXPANSION	SP	STATIC PRESSURE	ı	
XT XTN	EXTERIOR EXTENSION	SPEC(S)	SPECIFICATION(S)	14"ø	ELBOW UP
-X11 1	FLOAT AND THERMOSTATIC TRAP	STD	STANDARD		DIMENSION DESCRIPTION: 14"ø = ROUND DUCT
CU-#	FAN COIL UNIT	T.A.D. TC	TRANSFER AIR DUCT TEMPERATURE CONTROL		24"x12" FO = FLAT OVAL DUCT
/SD	COMBINATION FIRE/SMOKE DAMPER	TCC	TEMPERATURE CONTROL CONTRACTOR	1	
D D1	FLOOR DRAIN FIRE DAMPER TYPE	TD	TEMPERATURE DIFFERENCE	+	- ELBOW DOWN
D1 EV	FLUE EXHAUST VENT	TEMP	TEMPERATURE	\	
IN FL/FF	FINISH FLOOR	TXV	THERMAL EXPANSION VALVE		
LR ,	FLOOR	TYP	TYPICAL UNIT HEATER		_ ELBOW — RADIUS (R) = 1.5 TIMES DIAMETER OF DUCT
Ā	FRESH AIR	UH-# UON	UNIT HEATER UNLESS OTHERWISE NOTED		THE THE DIMMETER OF DOOL
P	FIRE PROTECTION	UV	UNIT VENTILATOR	∏ R	
PM T	FEET PER MINUTE	٧	VENT	4	1 FEELCIENCY TAMPOFF
T 'UR-#	FEET FURNACE	VAC	VACUUM	, W/D	I EFFICIENCY TAKEOFF AMPER. TYPICAL FOR
∪K <i>−#</i> ;	GAS (NATURAL)	VAV VB	VACILIM RREAKER	TVT / ALL	FLEX AND RIGID T TAKEOFFS.
S A	GAUGE	AD AR	VACUUM BREAKER VOLUME DAMPER	Thumas.	
GAL	GALLON	VTR	VENT-THRU-ROOF	Himmu	
SALV	GALVANIZE(D)	WB	VARIABLE VOLUME BOX	上, 上	CEILING
GPM J	GALLONS PER MINUTE	W/	WITH	FLEXIBLE DUCTWORK	DIFFUSER
H HHWR	HEIGHT/HIGH HEATING HOT WATER RETURN	W/O	WITHOUT	FLEXIBLE DUCTWORK—/ MAX. 5' IN LENGTH	
HHWS	HEATING HOT WATER SUPPLY	WB WC-#	WET BULB TEMPERATURE WATER CLOSET		NOTE: ALL SYMBOLS MAY NOT BE USED
		vv <i>─#</i>			ON THIS PROJECT

	MECHANICAL DRAWING INDEX	
SHT No.	SHEET TITLE	SCALE
M-000	MECHANICAL LEGEND, SYMBOLS, AND ABBREVIATIONS	NO SCALE
M-101	MECHANICAL BASEMENT PLAN	1/8"=1'-0"
M-102	MECHANICAL FIRST FLOOR PLAN	1/8"=1'-0"
M-103	MECHANICAL SECOND FLOOR PLAN	1/8"=1'-0"
M-104	MECHANICAL THIRD FLOOR PLAN	1/8"=1'-0"
M-105	MECHANICAL FOURTH FLOOR PLAN	1/8"=1'-0"
M-106	MECHANICAL ROOF PLAN	1/8"=1'-0"
M-300	TEMPERATURE CONTROLS	NO SCALE
M-400	MECHANICAL DETAILS	NO SCALE
M-401	MECHANICAL DETAILS	NO SCALE
M-500	MECHANICAL SCHEDULES	NO SCALE
M-501	MECHANICAL SCHEDULES	NO SCALE

- 1. COORDINATE NEW DUCTWORK & PIPING WITH EXISTING SITE CONDITIONS, EQUIPMENT
- 2. PROVIDE ACCESS AROUND ALL NEW EQUIPMENT PER MANUFACTURERS
- TO AVOID INTERFERENCES. ISOLATION VALVES, BALANCING VALVES, AND CONTROL VALVES SHALL BE NO MORE THAN 3'-6" ABOVE FINISHED CEILING.
- 6. DUCT SIZES TO DIFFUSERS SHALL MATCH NECK SIZE OF EACH.
- REFER TO SCHEDULE SHEET M-500.
- 8. ALL PIPING AND DUCTWORK SHALL BE CONCEALED IN WALLS AND/OR CEILING SPACE UNLESS OTHERWISE INDICATED.
- 9. SEAL ALL PENETRATIONS THROUGH WALLS PER SPECIFICATIONS.
- WITH ARCHITECTURAL AND ELECTRICAL REFLECTED CEILING PLAN.
- 11. COORDINATE ROOM SENSOR(S) & T-STAT(S) LOCATIONS WITH ARCHITECT.
- 12. ALL FIRE DAMPERS SHALL BE DYNAMIC UNLESS OTHERWISE NOTED.
- 13. ALL FLEXIBLE DUCTWORK SHALL BE LIMITED TO 5'-0" MAXIMUM LENGTH FROM HARD DUCT CONNECTION TO ROUND NECK SUPPLY AIR DIFFUSERS.

MECHANICAL GENERAL NOTES:

- MANUFACTURERS, AND ALL OTHER TRADES TO AVOID INTERFERENCES.
- RECOMMENDATIONS.
- 3. ALL CORING THROUGH FLOORS SHALL BE BY MECHANICAL CONTRACTOR.
- 4. ALL DUCTWORK & PIPING SHALL BE ROUTED AS HIGH AS POSSIBLE, UNLESS OTHERWISE NOTED. COORDINATE ROUTING WITH OTHER TRADES
- 5. BALANCE AIR SYSTEMS TO INDICATED FLOW RATES.
- 7. ALL PIPING AND DUCTWORK SHALL BE INSULATED PER SPECIFICATIONS.

- 10. COORDINATE EXACT LOCATIONS OF DIFFUSERS AND RETURN/EXHAUST GRILLES

SELLINGER

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ARCHITECT MERGE ARCHITECTS. INC

BOSTON, MA 02210 T: 617.670.0265 STRUCTURAL ENGINEER

MECHANICAL ENGINEER

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19821 FARMINGTON ROAD LIVONIA, MI 48152 T: 248 482 0045

ELECTRICAL ENGINEER ETS ENGINEERING, INC.

418-1/2 S. WASHINGTON BLVD. ROYAL OAK, MI 48067 T: 248 744 0360

CIVIL ENGINEER

nple

Place ısh Si 8201 p Brush Park On Edmund Between Br Detroit MI, 4

05/15/2020 100% CD / PERMIT SET

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JOB NO.: AS NOTED 05/15/2020

DRAWING TITLE

MECHANICAL LEGEND, SYMBOLS, AND **ABBREVIATIONS**

SHEET NO.

PROVIDE COMBINATION FIRE SMOKE DAMPER GREENHECK MODEL FSDR-512. COORDINATE EXACT SIZE IN FIELD PRIOR TO ORDERING. 120 VOLT DAMPER ACTUATOR. DAMPER BY MECHANICAL TRADES, DETECTION DEVICE AND ALL WIRING BY ELECTRICAL. COORDINATE WITH ELECTRICIAN.

KEYED NOTES.

(1) 6"ø SUPPLY DUCT WITH COMBINATION F/S DAMPER UP THRU FLOOR. (2) 6"ø EXHAUST DUCT WITH COMBINATION F/S DAMPER UP THRU FLOOR.



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Duplette Brush ParkOn Edmunc
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05/15/2020 100% CD / PERMIT SET

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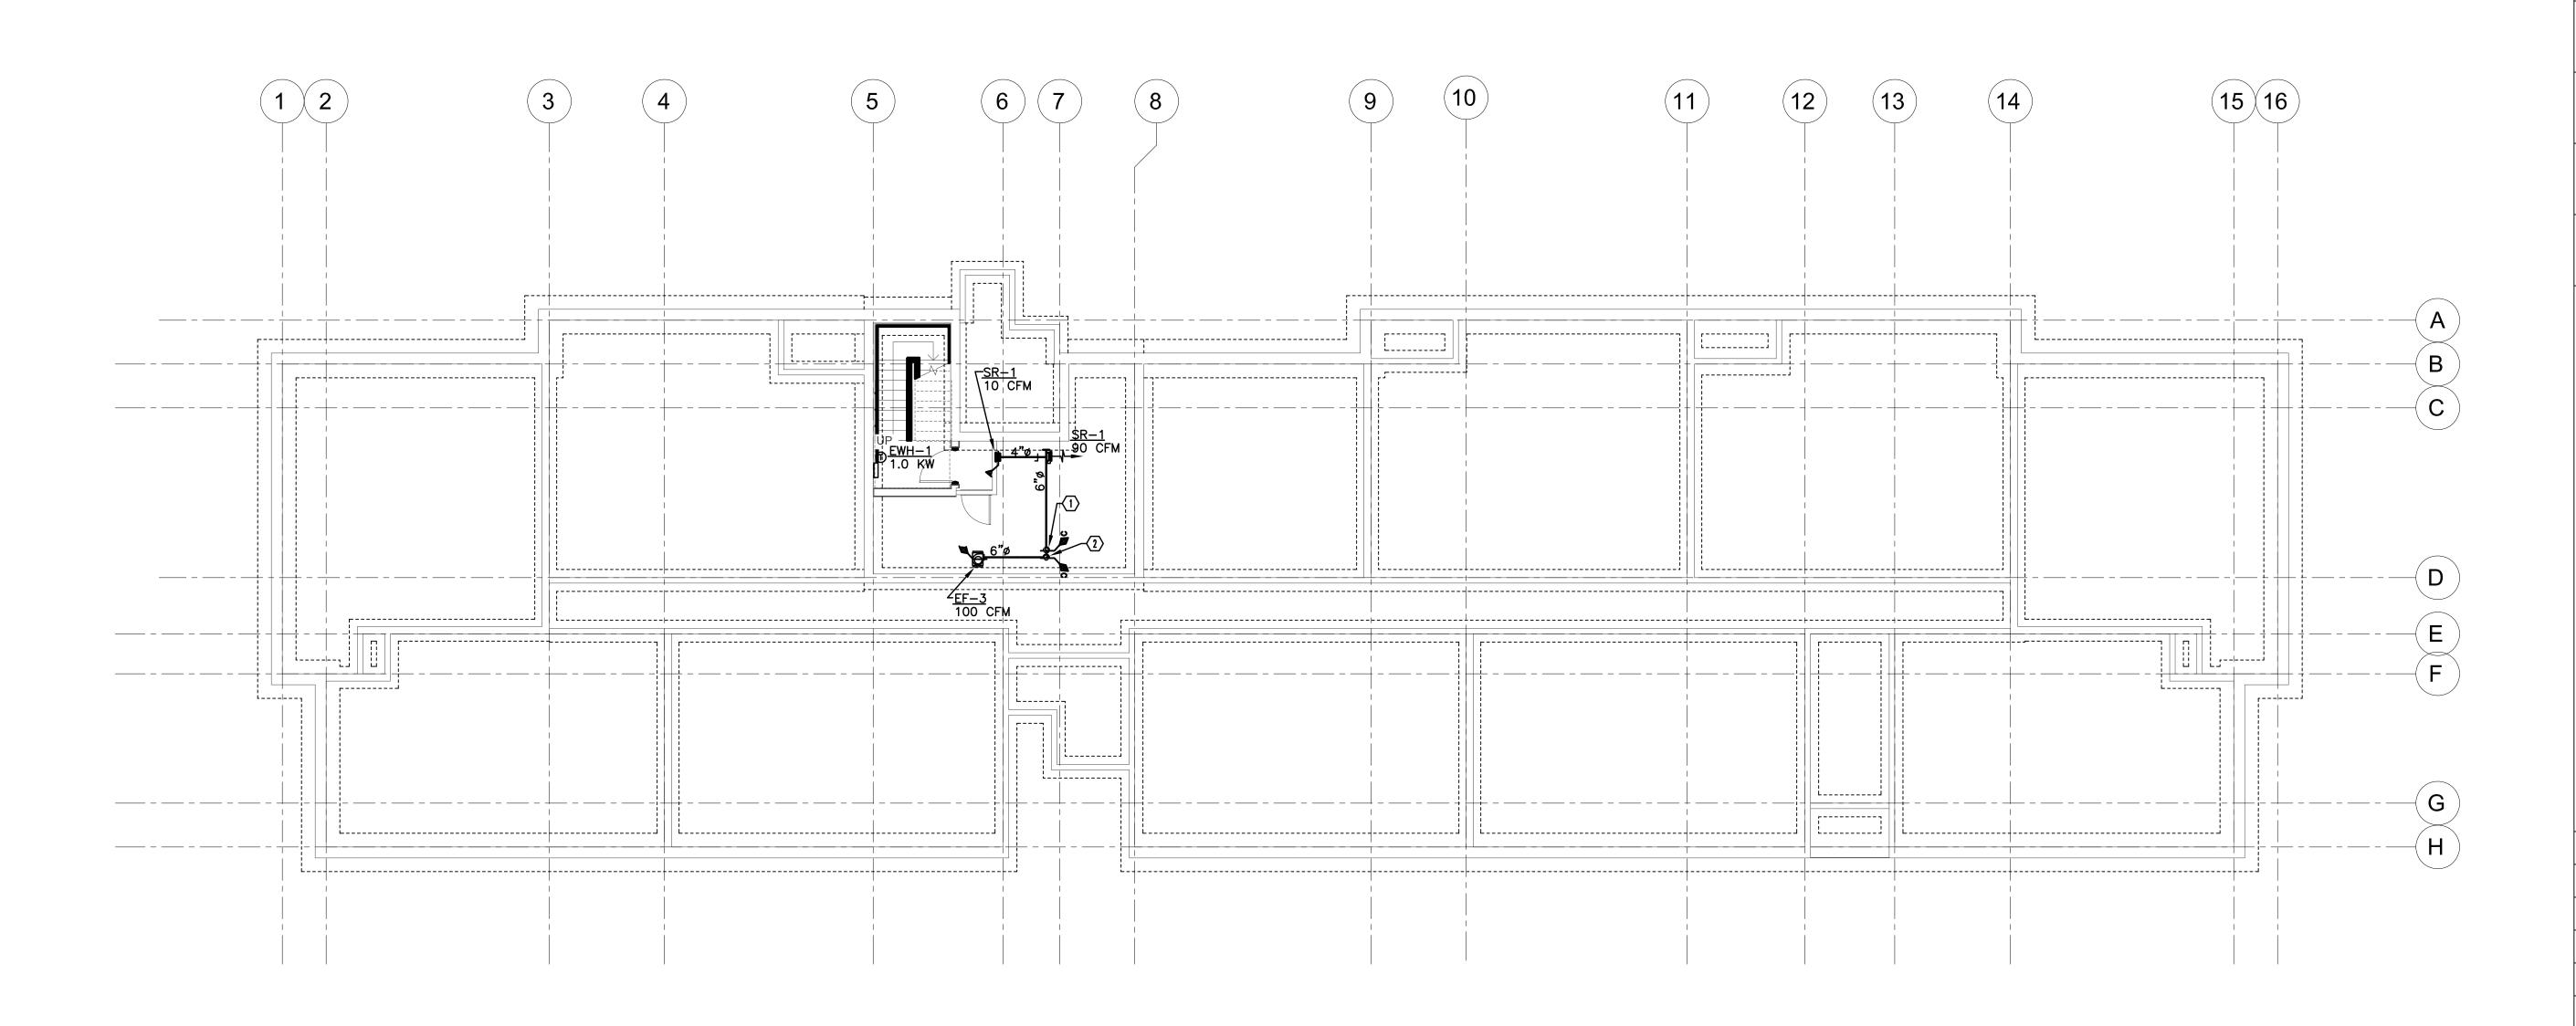
JOB NO.: AS NOTED SCALE: 05/15/2020

DRAWING TITLE

MECHANICAL BASEMENT PLAN

SHEET NO.

M-101






MECHANICAL CONTRACTOR TO COORDINATE EXACT LOCATION OF SIDE WALL PENETRATIONS WITH ARCHITECTURAL ELEVATIONS — REFER TO ARCHITECTURAL DRAWINGS. OA INTAKE MUST BE 10 FEET AWAY FROM FLUE OR EXHAUST PER

PROVIDE COMBINATION FIRE SMOKE DAMPER GREENHECK MODEL FSDR-512. COORDINATE EXACT SIZE IN FIELD PRIOR TO ORDERING. 120 VOLT DAMPER ACTUATOR. DAMPER BY MECHANICAL TRADES, DETECTION DEVICE AND ALL WIRING BY ELECTRICAL. COORDINATE WITH ELECTRICIAN.

KEYED NOTES

- 6"ø TOILET EXHAUST WITH EXHAUST WC−2.
- 2 4"ø DRYER EXHAUST DUCT WITH WC-1 AND BACKDRAFT DAMPER. 3 6"ø OUTSIDE AIR DUCT WITH EXTERNAL INSULATION.
- REF'G PIPING (SIZED BY FUR/ACCU MANU)
- (5) 6"ø SUPPLY DUCT DOWN THRU FLOOR WITH COMB F/S DAMPER (6) 6"ø EXHAUST DUCT DOWN THRU FLOOR WITH COMB F/S DAMPER
- (7) 12"ø SUPPLY DUCT UP THRU FLOOR ABOVE
- 12"ø SUPPLY DUCT FROM SHAFT WITH COMB F/S DAMPER.
- 6"ø KITCHEN EXHAUST WITH EXHAUST WC-2.
- (10) NOT USED
- 1 PROVIDE CONCENTRIC WALL VENT KIT/TERMINAL.
- 6"ø EXHAUST WITH EXHAUST WC−2.
- PROVIDE 1" ACOUSTICAL LINER ON THE FIRST 10 FEET OF RETURN DUCT.
- TEXTURED BRICK AREA AVOID ANY MECHANICAL WALL PENETRATIONS IN THIS AREA. COORDINATE WIRH ARCHITECT.

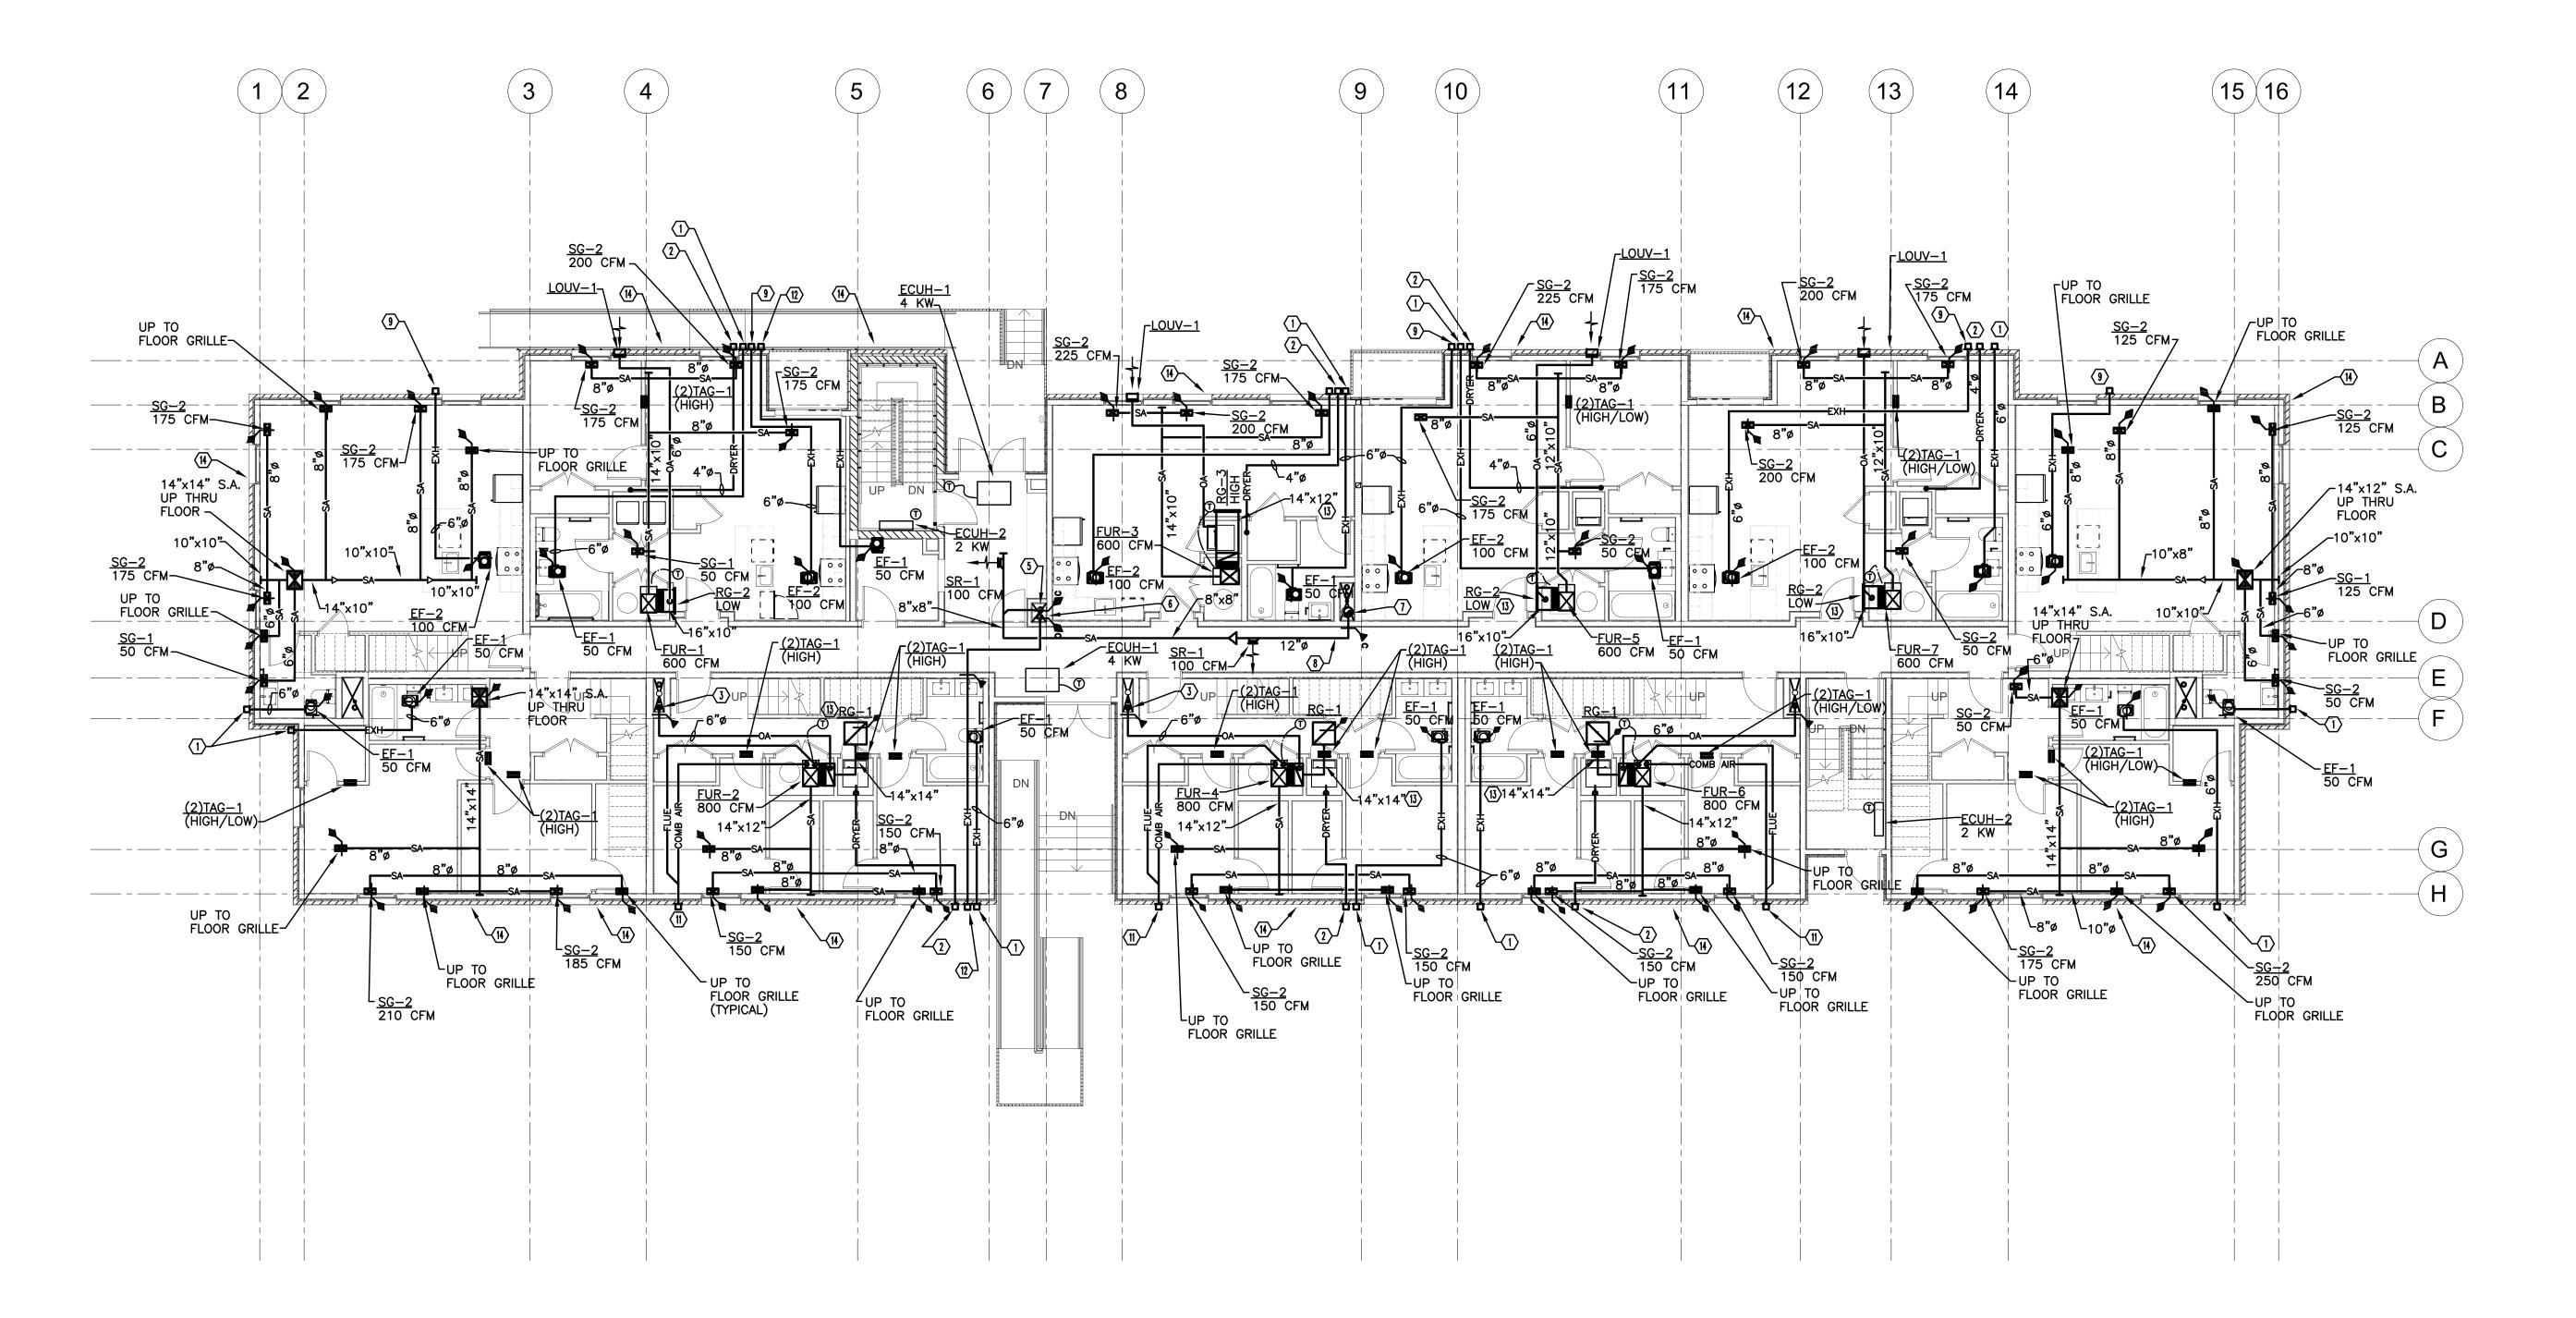



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IVIL LIVOINLLIX

N N

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05/15/2020 100% CD / PERMIT SE

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MANNER, AND FOR COORDINATING
WORK WITH THAT OF ALL TRADES

JOB NO.:	18284
SCALE:	AS NOTED
DATE:	05/15/2020

DRAWING TITLE

MECHANICAL FIRST FLOOR PLAN

SHEET NO.

M-102


KEYED NOTES

PROVIDE COMBINATION FIRE SMOKE DAMPER GREENHECK

MODEL FSDR-512. COORDINATE EXACT SIZE IN FIELD PRIOR TO ORDERING.

120 VOLT DAMPER ACTUATOR. DAMPER BY MECHANICAL TRADES, DETECTION DEVICE AND ALL WIRING BY ELECTRICAL. COORDINATE WITH ELECTRICIAN.

- (1) 6"ø TOILET EXHAUST WITH EXHAUST WC-2.
- 4"ø DRYER EXHAUST DUCT WITH WC-1 AND BACKDRAFT DAMPER.
- (3) 6"\$\phi\$ OUTSIDE AIR DUCT WITH EXTERNAL INSULATION.
- REF'G PIPING (SIZED BY FUR/ACCU MANU)
- (5) 12"ø SUPPLY DUCT DOWN THRU FLOOR
- > 12"ø SUPPLY DUCT DOWN UP FLOOR ABOVE
- (7) 6"ø SUPPLY DUCT FROM SHAFT WITH COMB F/S DAMPER
- 8 6"ø KITCHEN EXHAUST WITH EXHAUST WC-2. 9 PROVIDE CONCENTRIC WALL VENT KIT/TERMINAL.
- (10) ROUTE REFRIGERANT PIPING UP TO ASSIGNED OU-2 (ON ROOF). SIZE AND INSTALL PER MANUFACTURER INSTRUCTION. ROUTE PUMPED CONDENSATE TO NEAREST FLOOR DRAIN, FLOOR SINK AND SPILL INDIRECTLY.
- 1 6"ø EXHAUST WITH EXHAUST WC-2.
- PROVIDE 1" ACOUSTICAL LINER ON THE FIRST 10 FEET OF RETURN DUCT.
- (13) TEXTURED BRICK AREA AVOID ANY MECHANICAL WALL PENETRATIONS IN THIS AREA. COORDINATE WIRH ARCHITECT.

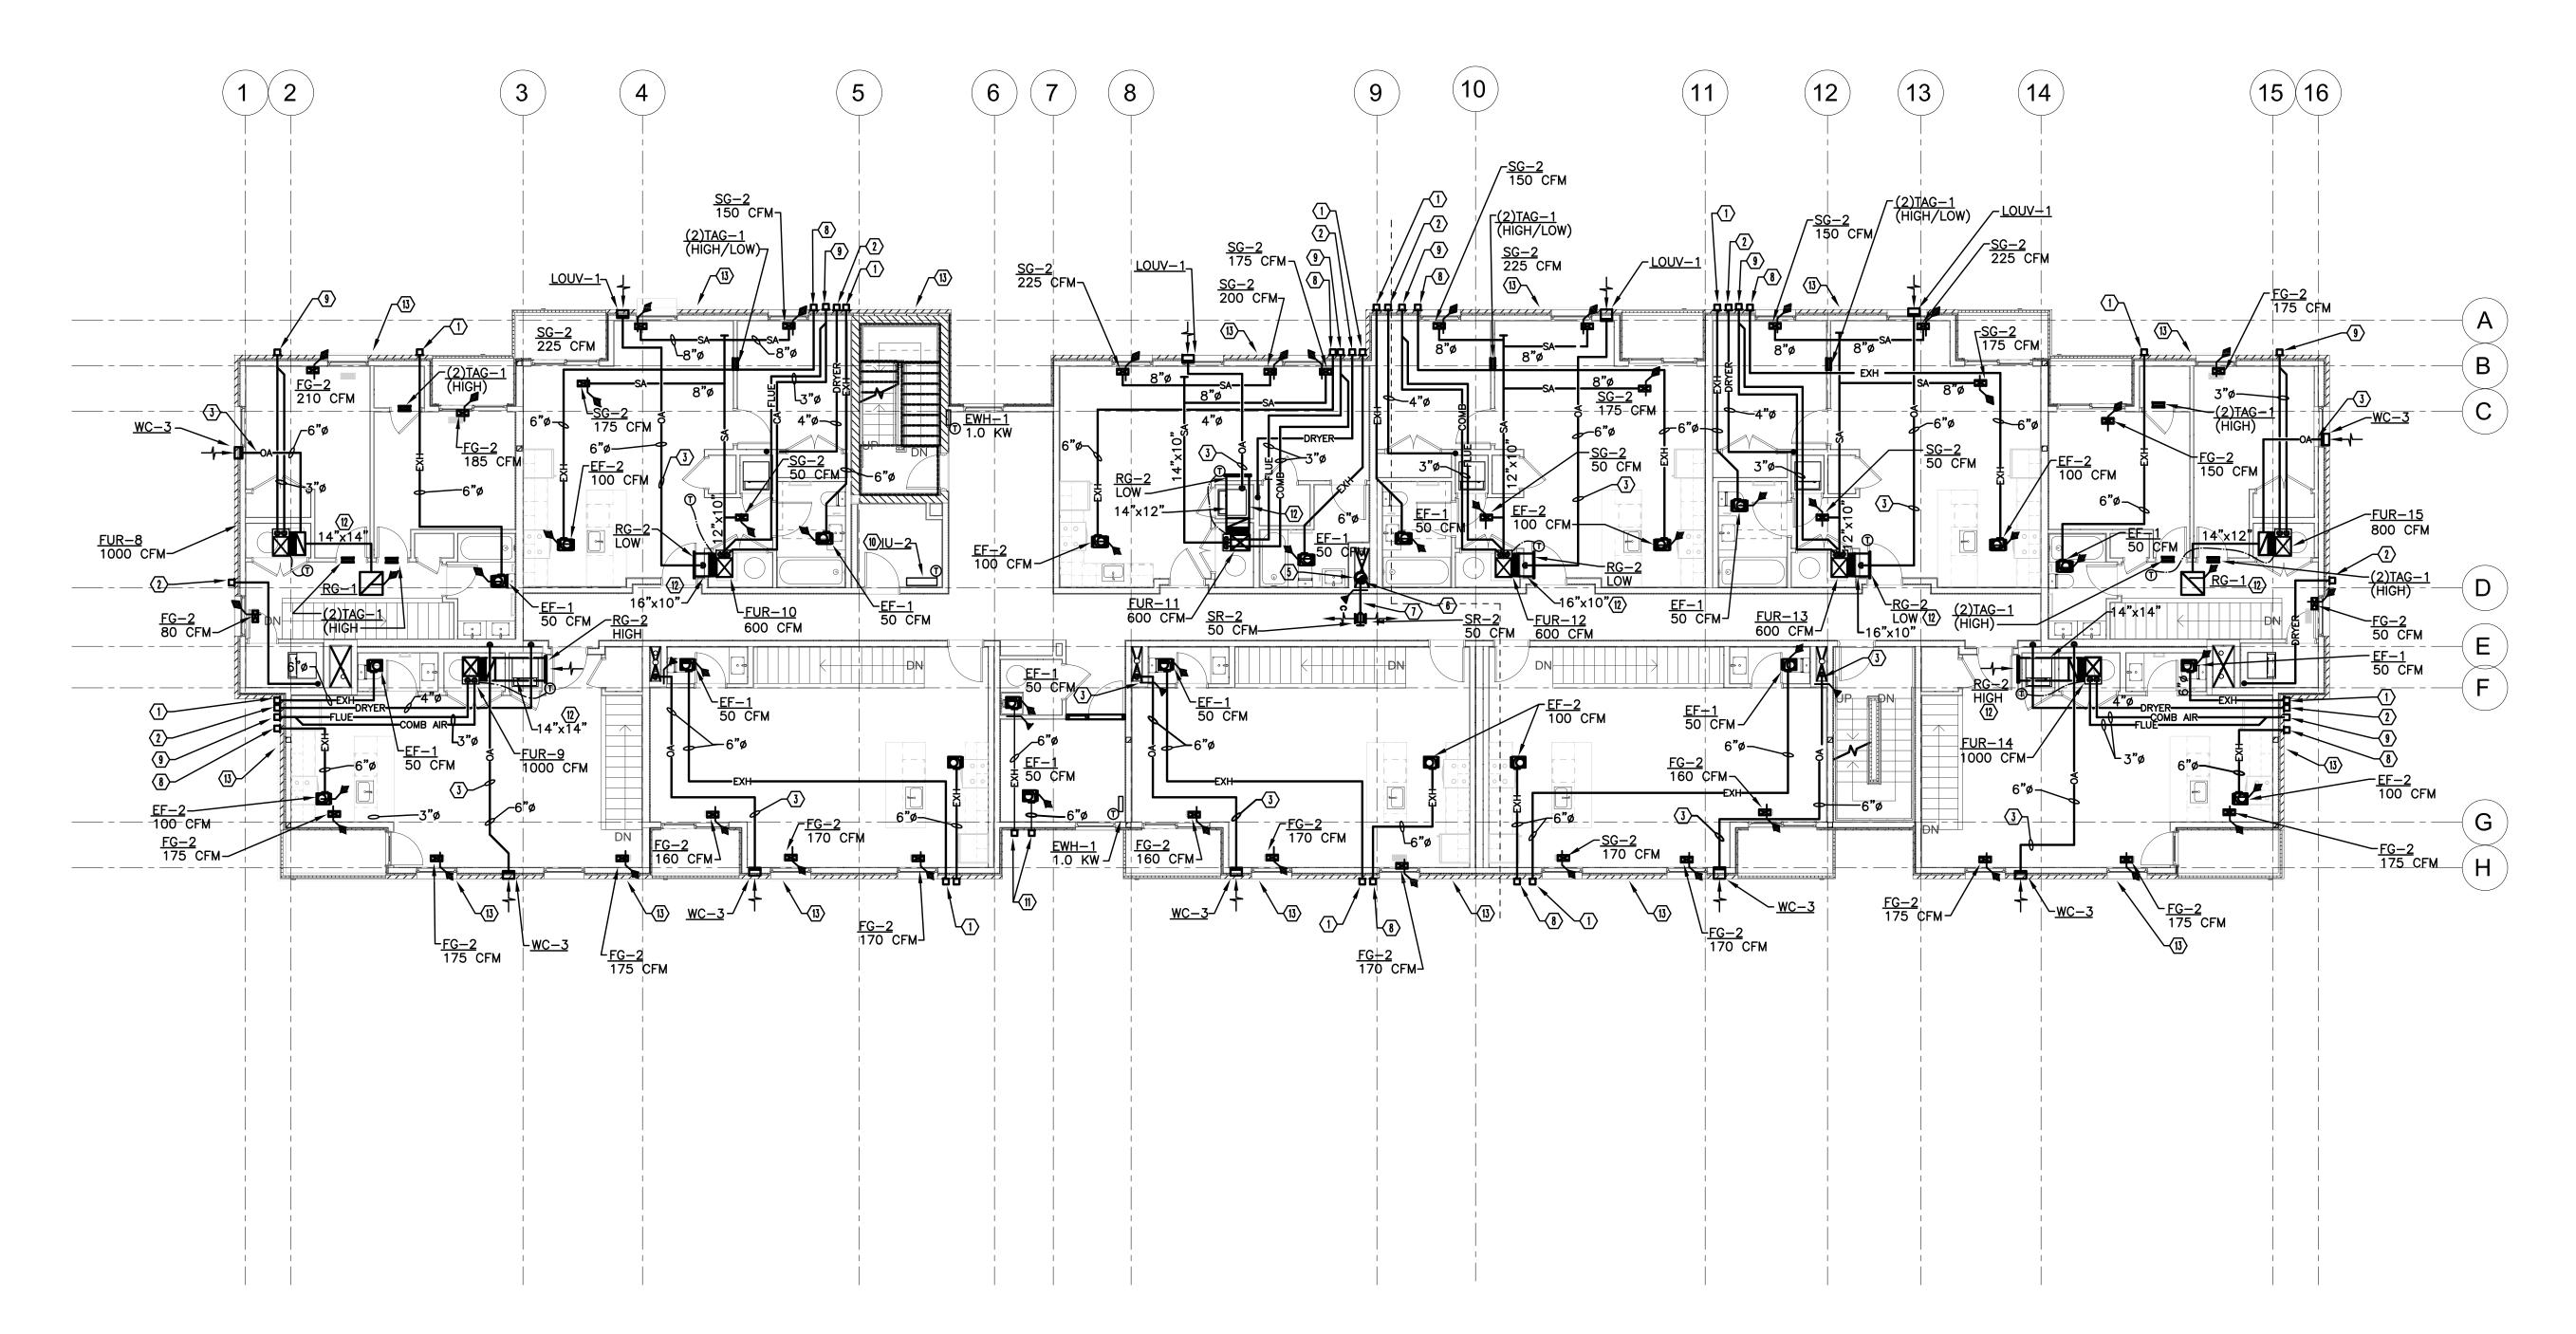

MECHANICAL CONTRACTOR TO COORDINATE EXACT LOCATION OF SIDE WALL

PENETRATIONS WITH ARCHITECTURAL ELEVATIONS - REFER TO ARCHITECTURAL

DRAWINGS. OA INTAKE MUST BE 10 FEET AWAY FROM FLUE OR EXHAUST PER



REGISTRATION



OWNER BRUSH PARK DEVELOPMENT COMPANY PHASE 1 LLC 1092 Woodward Ave. Detroit, MI 48226

ARCHITECT MERGE ARCHITECTS, INC. 332 CONGRESS ST. FLOOR 6 BOSTON, MA 02210 T: 617.670.0265

STRUCTURAL ENGINEER

MECHANICAL ENGINEER

SELLINGER ASSOCIATES, INC. 19821 FARMINGTON ROAD LIVONIA, MI 48152 T: 248 482 0045

ELECTRICAL ENGINEER

ETS ENGINEERING, INC. 418-1/2 S. WASHINGTON BLVD. ROYAL OAK, MI 48067 T: 248 744 0360

CIVIL ENGINEER

Duplette D **Brush** On Edn Betwee Detroit

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THE CONTRACTOR IS RESPONSIBLE
FOR MATERIALS, DETAILS AND
ACCURACY, FOR ALL QUANTITIES AND
DIMENSIONS, FOR SELECTING
FABRICATION PROCESSES, FOR
TECHNIQUES OF ASSEMBLY, FOR
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MANNER, AND FOR COORDINATING MANNER, AND FOR COORDINATING WORK WITH THAT OF ALL TRADES

JOB NO.:	18284
SCALE:	AS NOTED
DATE:	05/15/2020

DRAWING TITLE

MECHANICAL SECOND FLOOR PLAN


SHEET NO.

M-103

KEYED NOTES:

- $\langle 1 \rangle$ 6"ø TOILET EXHAUST WITH EXHAUST WC-2.
- (1) 4"ø DRYER EXHAUST DUCT WITH WC-1 AND BACKDRAFT DAMPER.
- (3) 6"ø OUTSIDE AIR DUCT WITH EXTERNAL INSULATION.
- REF'G PIPING (SIZED BY FUR/ACCU MANU) (5) 12"ø SUPPLY DUCT DOWN THRU FLOOR
- (6) 12"ø SUPPLY DUCT UP THRU FLOOR
- (7) 6"ø SUPPLY DUCT FROM SHAFT WITH COMB F/S DAMPER 8 PROVIDE CONCENTRIC WALL VENT KIT/TERMINAL.
- (9) 6"ø KITCHEN EXHAUST WITH EXHAUST WC-2.
- (10) ROUTE REFRIGERANT PIPING UP TO ASSIGNED OU-1 (ON ROOF). SIZE AND INSTALL PER MANUFACTURER INSTRUCTION. ROUTE PUMPED CONDENSATE TO NEAREST FLOOR DRAIN, FLOOR SINK AND SPILL INDIRECTLY.
- 1 PROVIDE 1" ACOUSTICAL LINER ON THE FIRST 10 FEET OF RETURN DUCT. | STRUCTURAL ENGINEER
- 12 UP TO FLOOR GRILLE.
- 13 TEXTURED BRICK AREA AVOID ANY MECHANICAL WALL PENETRATIONS IN THIS AREA. COORDINATE WIRH ARCHITECT.

PROVIDE COMBINATION FIRE SMOKE DAMPER GREENHECK MODEL FSDR-512. COORDINATE EXACT SIZE IN FIELD PRIOR TO ORDERING. 120 VOLT DAMPER ACTUATOR. DAMPER BY MECHANICAL TRADES, DETECTION DEVICE AND ALL WIRING BY ELECTRICAL. COORDINATE WITH ELECTRICIAN.

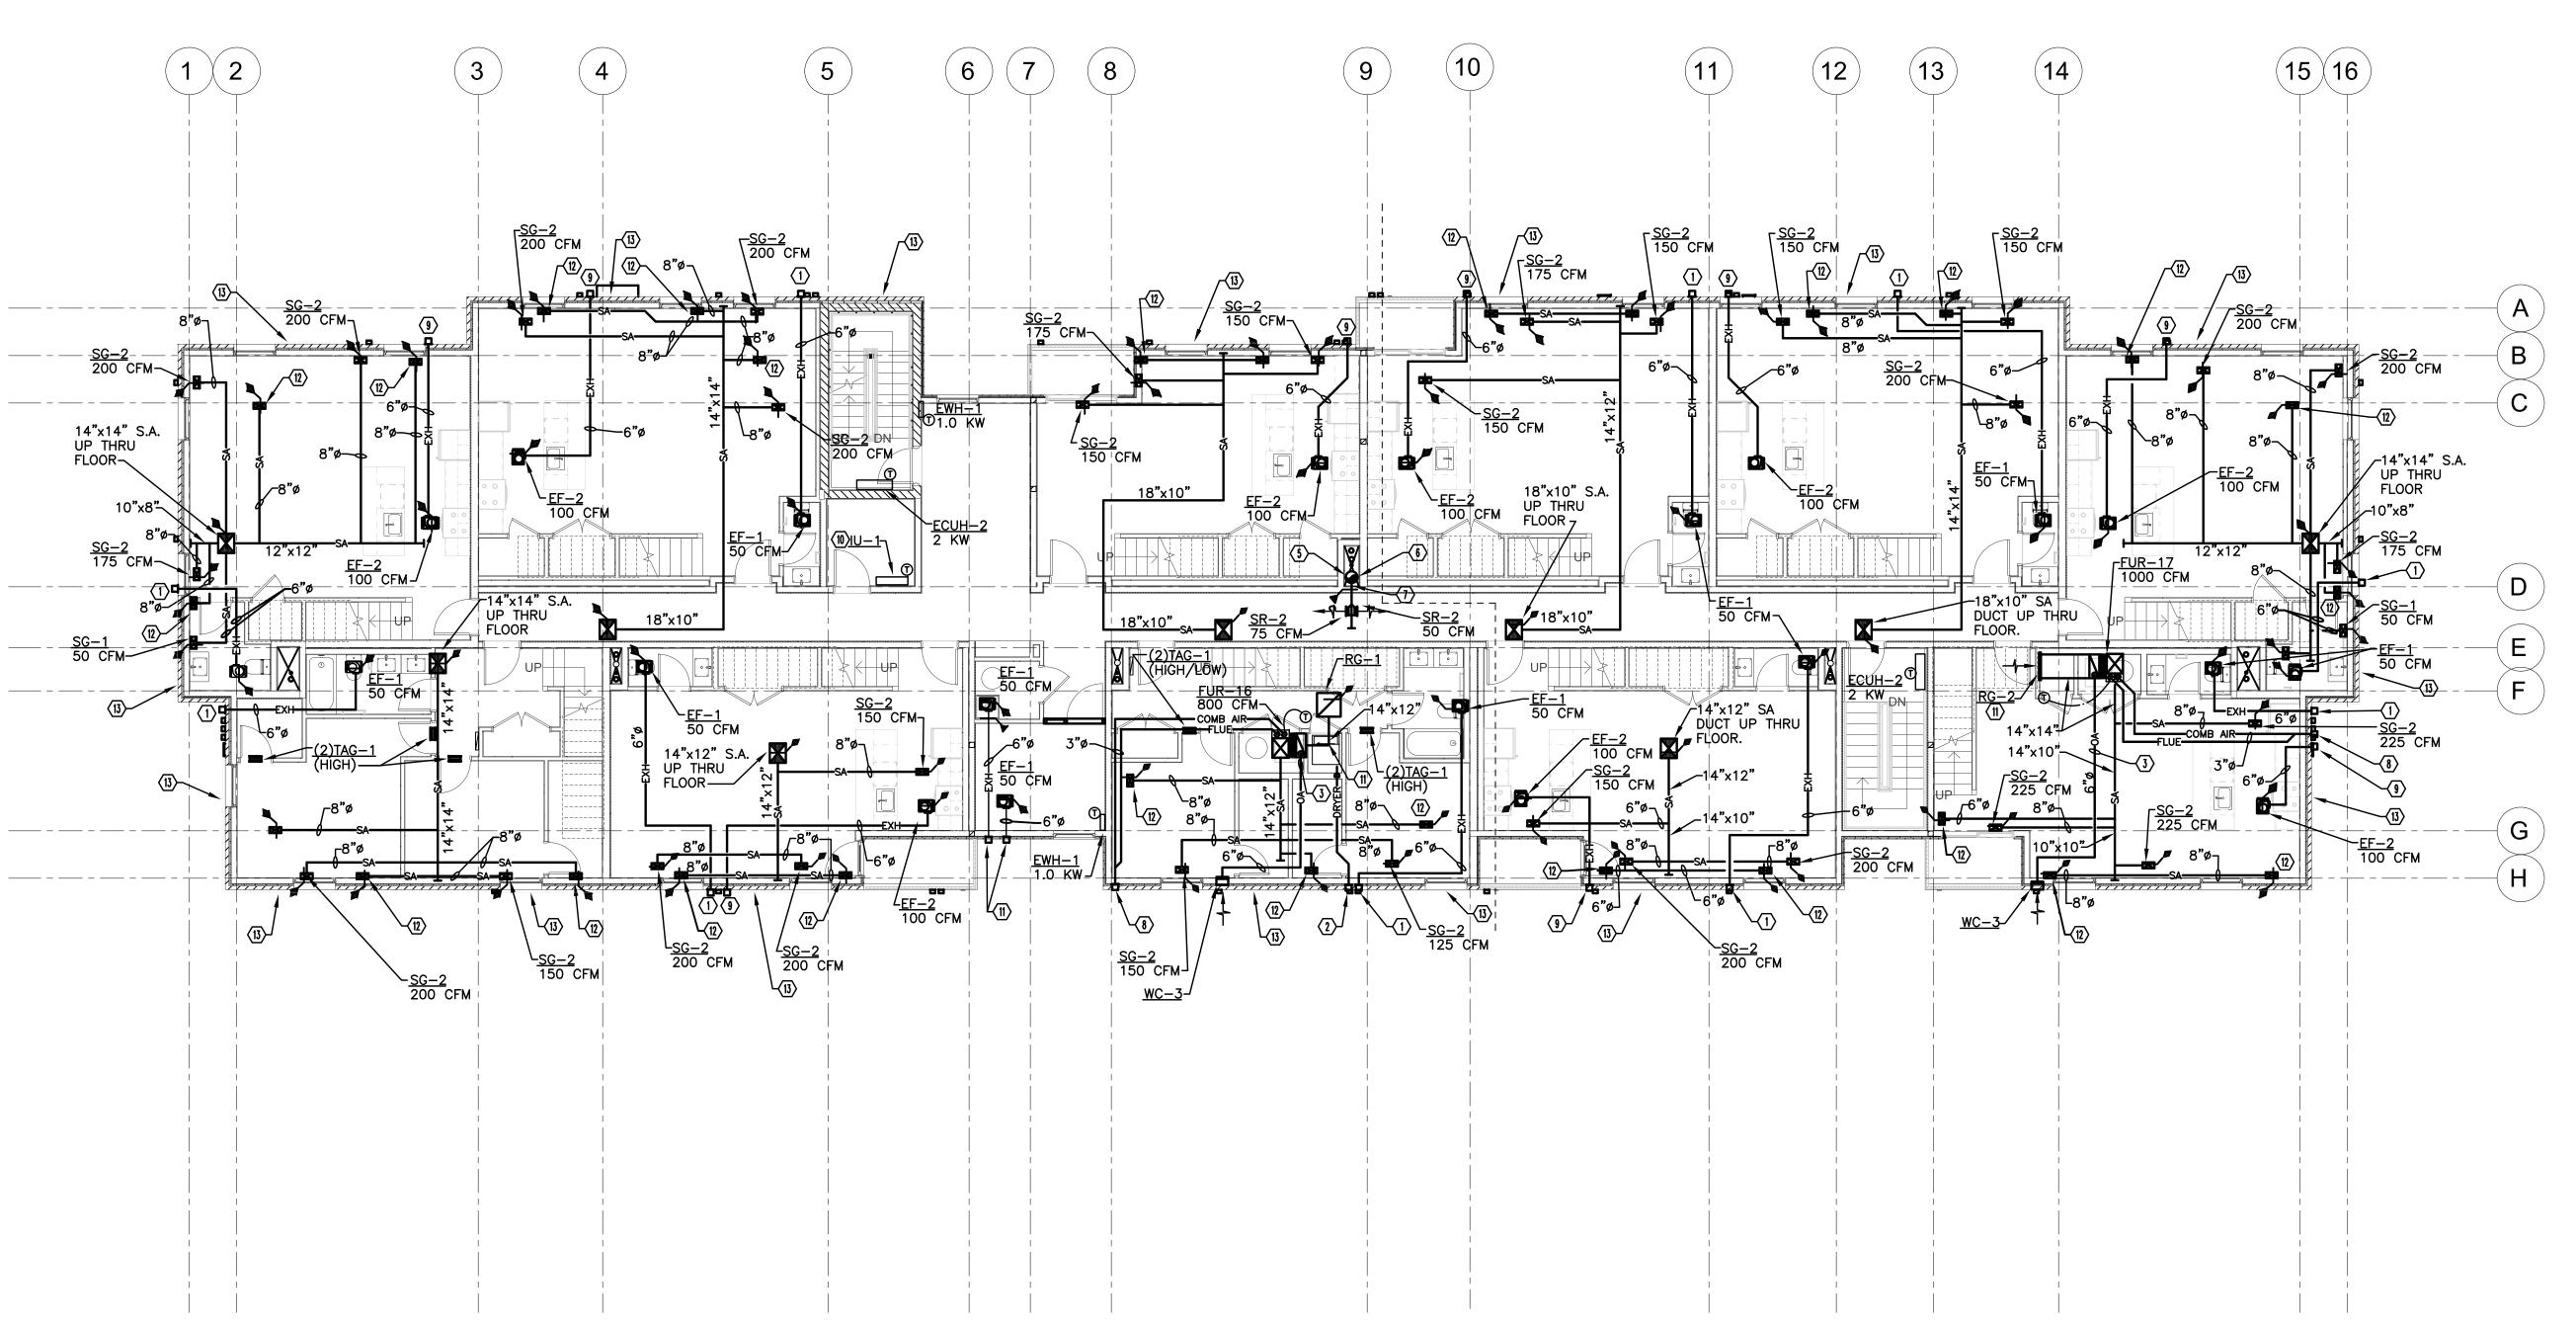

MECHANICAL CONTRACTOR TO COORDINATE EXACT LOCATION OF SIDE WALL

PENETRATIONS WITH ARCHITECTURAL ELEVATIONS - REFER TO ARCHITECTURAL

DRAWINGS. OA INTAKE MUST BE 10 FEET AWAY FROM FLUE OR EXHAUST PER



REGISTRATION



BRUSH PARK DEVELOPMENT COMPANY

ARCHITECT MERGE ARCHITECTS, INC. 332 CONGRESS ST. FLOOR 6 BOSTON, MA 02210 T: 617.670.0265

MECHANICAL ENGINEER

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ELECTRICAL ENGINEER

ETS ENGINEERING, INC. 418-1/2 S. WASHINGTON BLVD. ROYAL OAK, MI 48067 T: 248 744 0360

CIVIL ENGINEER

and Duplette

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JOB NO.:	18284
SCALE:	AS NOTED
DATE:	05/15/2020

DRAWING TITLE

MECHANICAL THIRD FLOOR PLAN


SHEET NO.

M-104

MECHANICAL CONTRACTOR TO COORDINATE EXACT LOCATION OF SIDE WALL PENETRATIONS WITH ARCHITECTURAL ELEVATIONS — REFER TO ARCHITECTURAL DRAWINGS. OA INTAKE MUST BE 10 FEET AWAY FROM FLUE OR EXHAUST PER PROVIDE COMBINATION FIRE SMOKE DAMPER GREENHECK MODEL FSDR-512. COORDINATE EXACT SIZE IN FIELD PRIOR TO ORDERING. 120 VOLT DAMPER ACTUATOR. DAMPER BY MECHANICAL TRADES, DETECTION DEVICE AND ALL WIRING BY ELECTRICAL. COORDINATE WITH ELECTRICIAN.

KEYED NOTES:

- $\langle 1 \rangle$ 6"ø TOILET EXHAUST WITH EXHAUST WC-2.
- (2) 4"ø DRYER EXHAUST DUCT WITH WC-1 AND BACKDRAFT DAMPER.
- (3) 6"0 OUTSIDE AIR DUCT WITH EXTERNAL INSULATION.
- (4) REF'G PIPING (SIZED BY FUR/ACCU MANU) (5) 12"ø SUPPLY DUCT UP AND DOWN THRU FLOOR IN SHAFT
- PROVIDE CONCENTRIC WALL VENT KIT/TERMINAL.
- 6"ø KITCHEN EXHAUST WITH EXHAUST WC-2.
- 8 3"Ø INSULATED DUCT WITH 24 VOLT MOTORIZED DAMPER INTERLOCKED WITH EXHAUST FAN SERVING THIS ROOM.
- 9 TEXTURED BRICK AREA AVOID ANY MECHANICAL WALL PENETRATIONS IN THIS AREA. COORDINATE WIRH ARCHITECT.

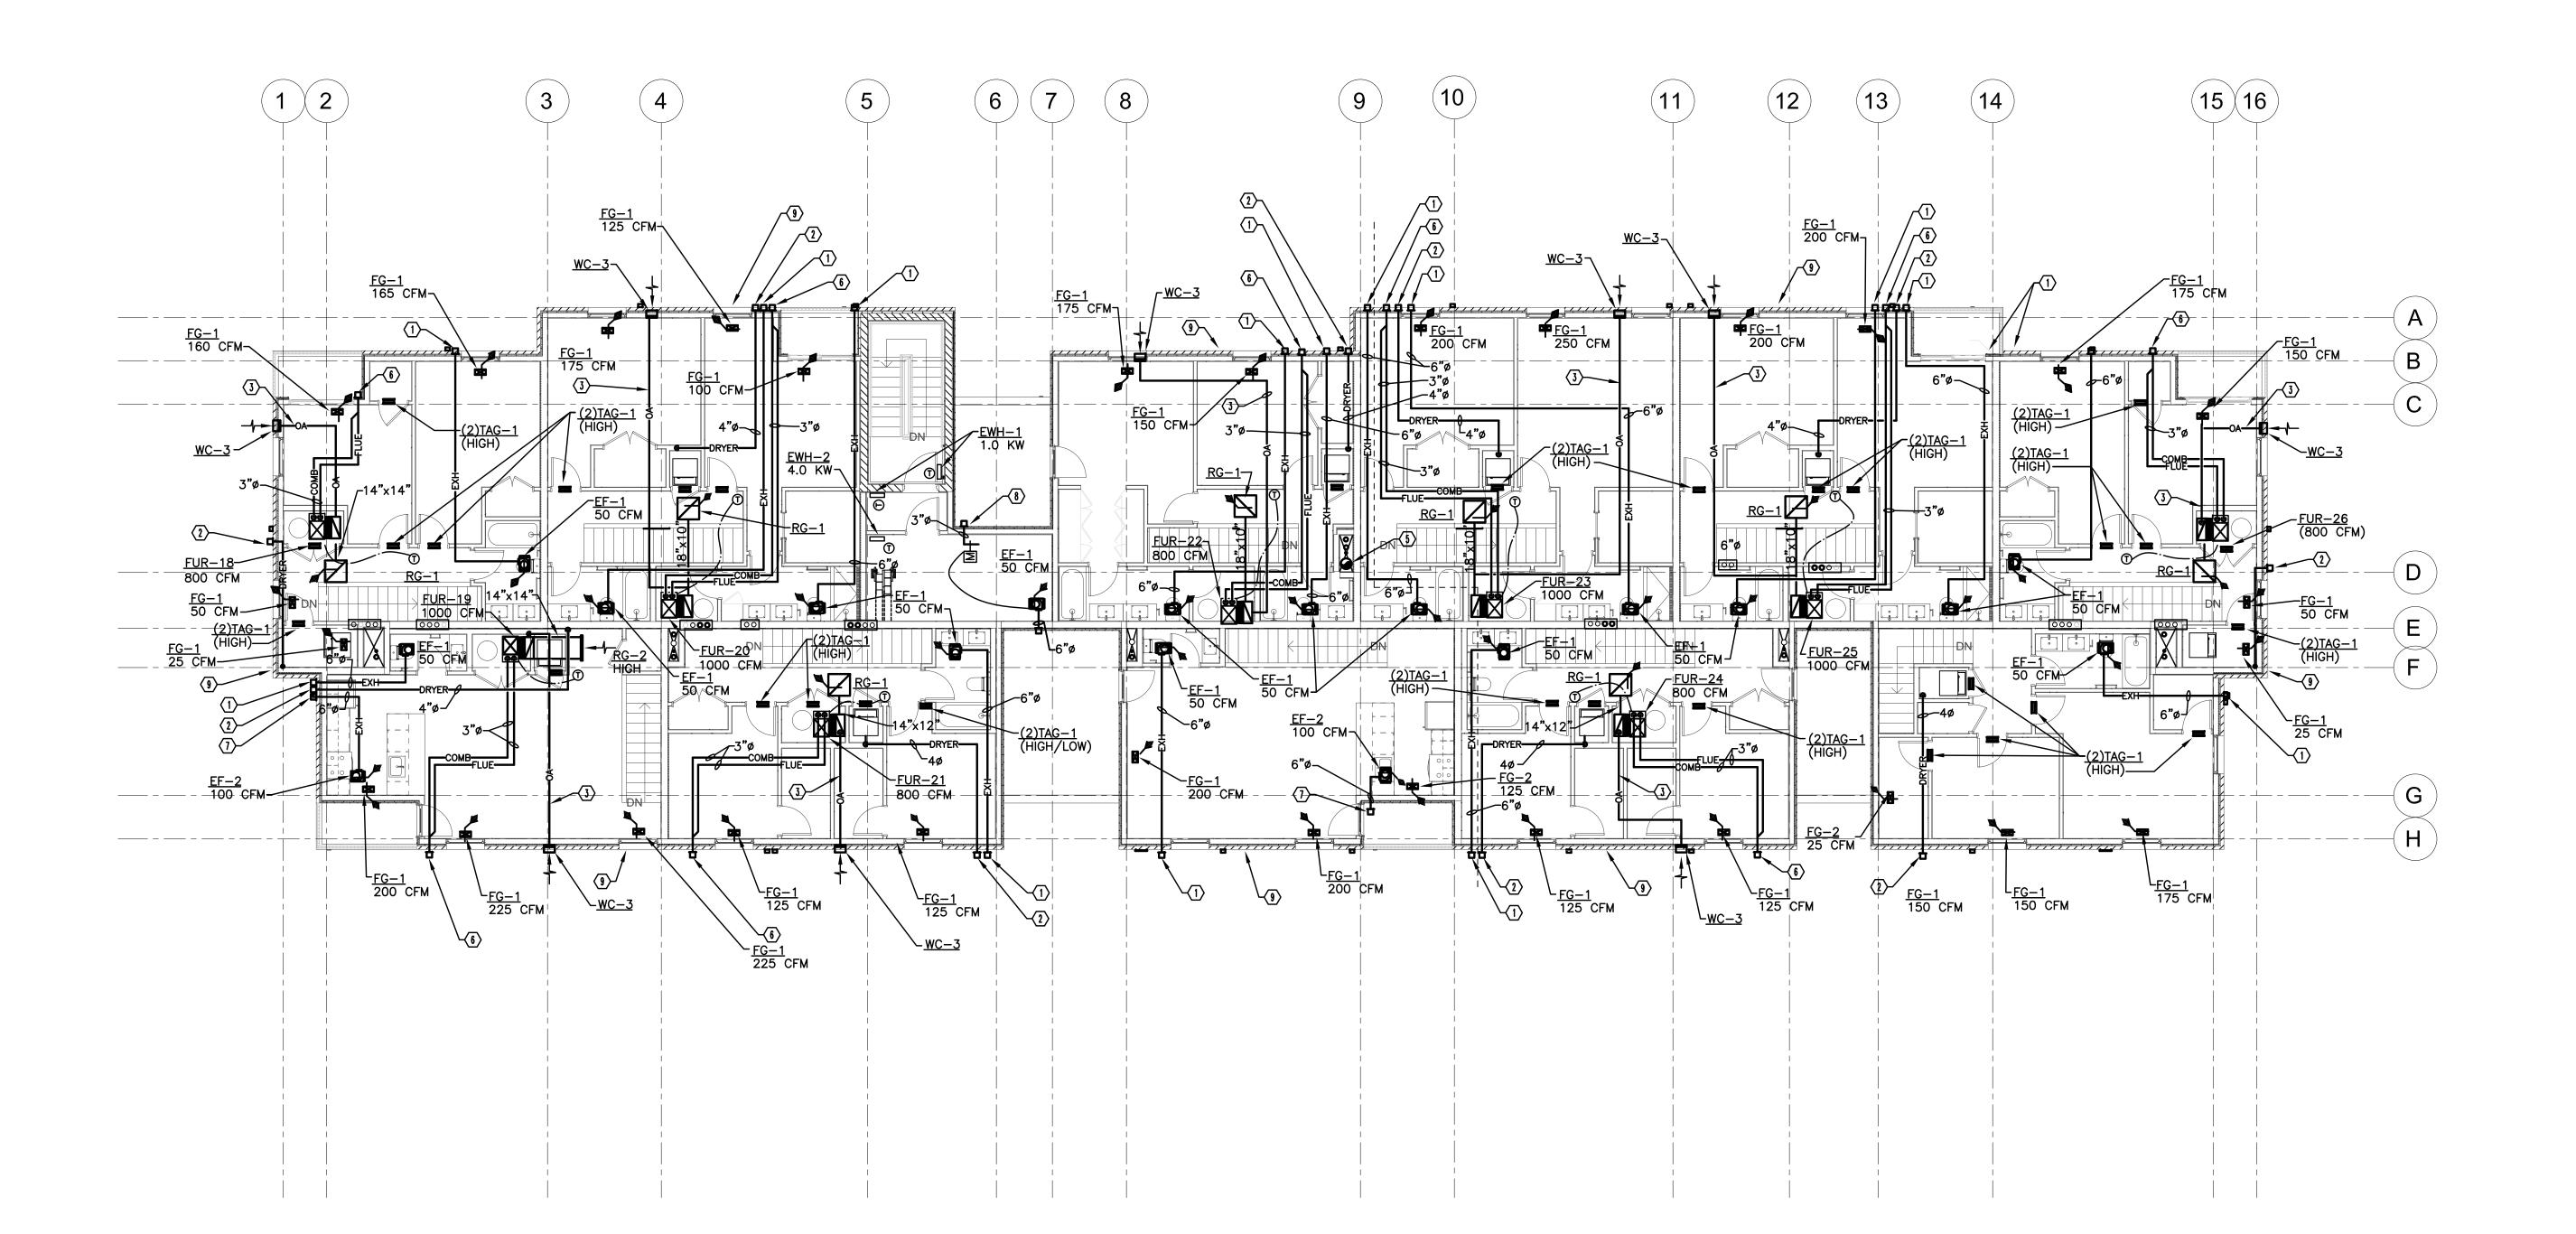



REGISTRATION



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ARCHITECT

MERGE ARCHITECTS, INC. 332 CONGRESS ST. FLOOR 6 BOSTON, MA 02210 T: 617.670.0265

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MECHANICAL ENGINEER

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ELECTRICAL ENGINEER

ETS ENGINEERING, INC. 418-1/2 S. WASHINGTON BLVD. ROYAL OAK, MI 48067 T: 248 744 0360

CIVIL ENGINEER

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JOB NO.:	18284
SCALE:	AS NOTED
DATE:	05/15/2020

DRAWING TITLE


MECHANICAL FOURTH FLOOR PLAN

SHEET NO.

M-105

NOTE: SEE M-000 FOR MECHANICAL GENERAL NOTES REGISTRATION KEYED NOTES:

- (1) REF'G PIPING DOWN THRU ROOF (SIZED BY FUR/ACCU MANU) PROVIDE PATTE PIPE CURB SEAL REFER TO DETAIL.
- ROUTE/SIZE REFRIGERANT PIPING TO IU-X PER MANUFACTURER INSTRUCTION.
 PROVIDE PATTE PIPE CURB SEAL REFER TO DETAIL.
- PROVIDE CONDENSING UNIT 24" HIGH SUPPORT-REFER TO DETAIL.

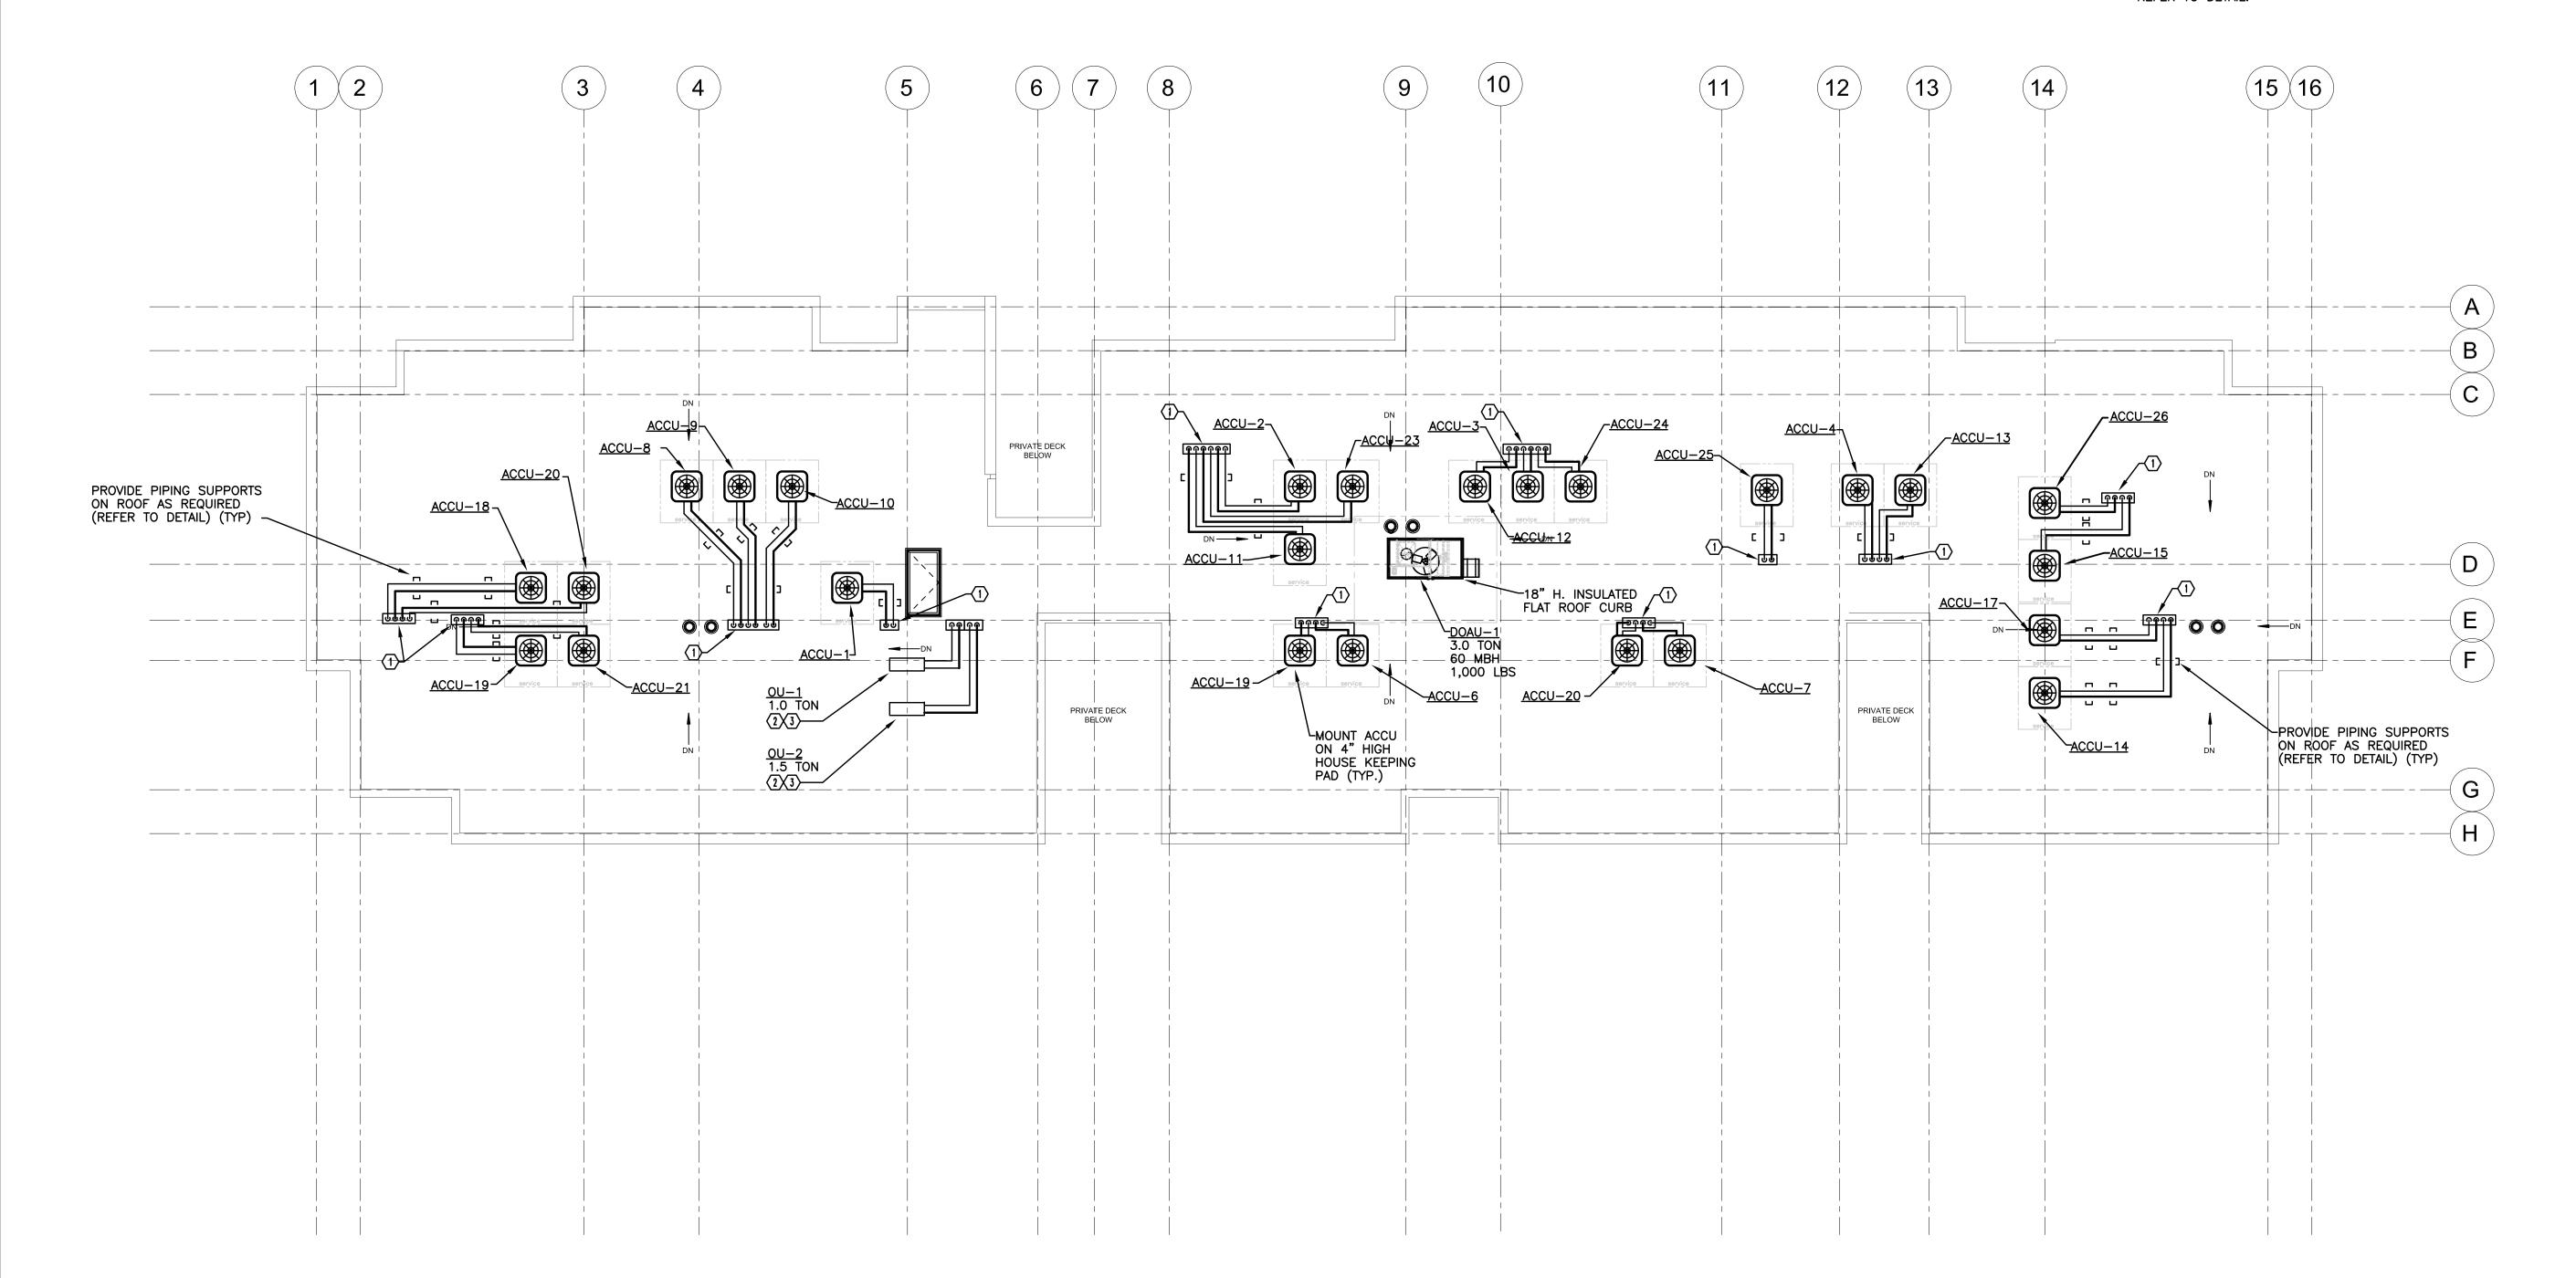





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ELECTRICAL ENGINEER ETS ENGINEERING, INC. 418-1/2 S. WASHINGTON BLVD. ROYAL OAK, MI 48067 T: 248 744 0360

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JOB NO.: AS NOTED SCALE: DATE: 05/15/2020

DRAWING TITLE

MECHANICAL ROOF PLAN

SHEET NO.

M-106

SEQUENCE OF OPERATION, DOAU-1

THIS UNIT IS CONSTANT VOLUME, 100% OA, SINGLE ZONE UNIT, WHICH WILL OPERATE CONTINUOUSLY WHENEVER THE BUILDING IS OCCUPIED (24/7). THE UNIT SHALL BE PROVIDED WITH PROPRIETARY DDC CONTROLS TO ACCOMPLISH THE FOLLOWING SEQUENCE.


FAN START - SUPPLY FAN SHALL START ON A SIGNAL FROM THE PROGRAMMABLE T-STAT WHEN THE FAN "HAND-OFF-AUTO" (H-O-A) SWITCH IS IN THE "AUTO" POSITION. WHEN THE FAN START, THE OUTDOOR AIR DAMPER MOVE TO MINIMUM OUTDOOR AIR POSITION.

HEATING AND COOLING - WHEN THE SUPPLY AIR TEMPERATURE SENSOR CANNOT MAINTAIN THE REQUIRED SUPPLY AIR OR SPACE TEMPERATURE, MECHANICAL HEATING AND COOLING WILL OCCUR.

HEATING MODE: IN THE HEATING MODE, A PRE-PURGE, POST-PURGE, FLAME SUPERVISION, PROOF OF IGNITION SHALL OCCUR. THE GAS VALVE SHALL MODULATE TO SATISFY SPACE SETPOINT.

COOLING MODE: WHEN THE SUPPLY AIR TEMPERATURE EXCEEDS ITS SETPOINT, MECHANICAL COOLING WILL OCCUR. THE REFRIGERANT SOLENOID VALVE WILL OPEN. ALLOWING REFRIGERANT TO THE COOLING COIL. IF AIRFLOW THROUGH THE AIR HANDLER IS PROVEN, AS INDICATED BY AN AIR FLOW SENSOR COMPRESSOR OPERATION WILL BE ENABLED. THE HIGHER PRESSURE IN THE SUCTION LINE WILL START THE COOLING COMPRESSORS. A SUPPLY AIR TEMPERATURE SENSOR IN THE SUPPLY AIR DUCT WILL CONTROL THE REFRIGERANT SOLENOID VALVE. A HOT GAS BYPASS VALVE WILL ALLOW THE REFRIGERATION SYSTEM TO OPERATE AT LOW COOLING LOADS.

 $\underline{\mathsf{SAFETIES}}$ — A REMOTE FREEZESTAT (LOCATED IN DUCT INSIDE BLDG) WILL TRIP THE SUPPLY FAN WHEN ITS SETPOINT IS REACHED.

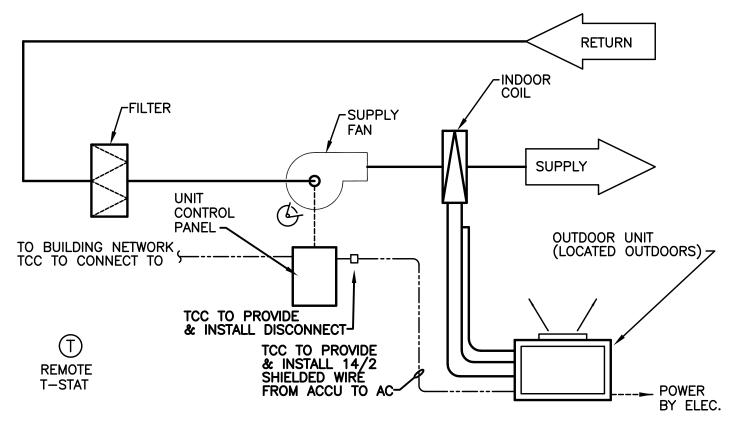

INDOOR & OUTDOOR HEAT PUMP UNIT CONTROL DIAGRAM


SEQUENCE OF OPERATION. (IU-1 & OU-1)


THESE UNIT ARE CONSTANT VOLUME, SINGLE ZONE UNIT, WHICH WILL OPERATE BASED ON TIME CLOCK (INTERNALLY TO UNIT). THE T-STAT SHALL HAVE A 24-HOUR TIME CLOCK ENABLING ONE ON/OFF TIME TO BE SET IN A 24-HOUR PERIOD. (UNITS TO RUN 24/7)

FAN START - SUPPLY FAN SHALL START ON A SIGNAL FROM THE T-STAT.

COOLING - WHEN THE SPACE TEMPERATURE SENSOR CANNOT MAINTAIN THE REQUIRED SPACE TEMPERATURE SETPOINT, MECHANICAL COOLING WILL OCCUR.


COOLING MODE: WHEN THE SPACE TEMPERATURE EXCEEDS ITS SETPOINT, MECHANICAL COOLING WILL OCCUR. THE OUTDOOR UNIT SHALL BE ACTIVATED AND ALLOW REFRIGERANT TO FLOW TO THE COOLING COIL. HEATING MODE: WHEN THE SPACE TEMPERATURE DROPS BELOW ITS SETPOINT, MECHANICAL HEATING WILL OCCUR. THE OUTDOOR UNIT SHALL BE ACTIVATED AND ALLOW REFRIGERANT TO FLOW TO THE HEATING COIL.

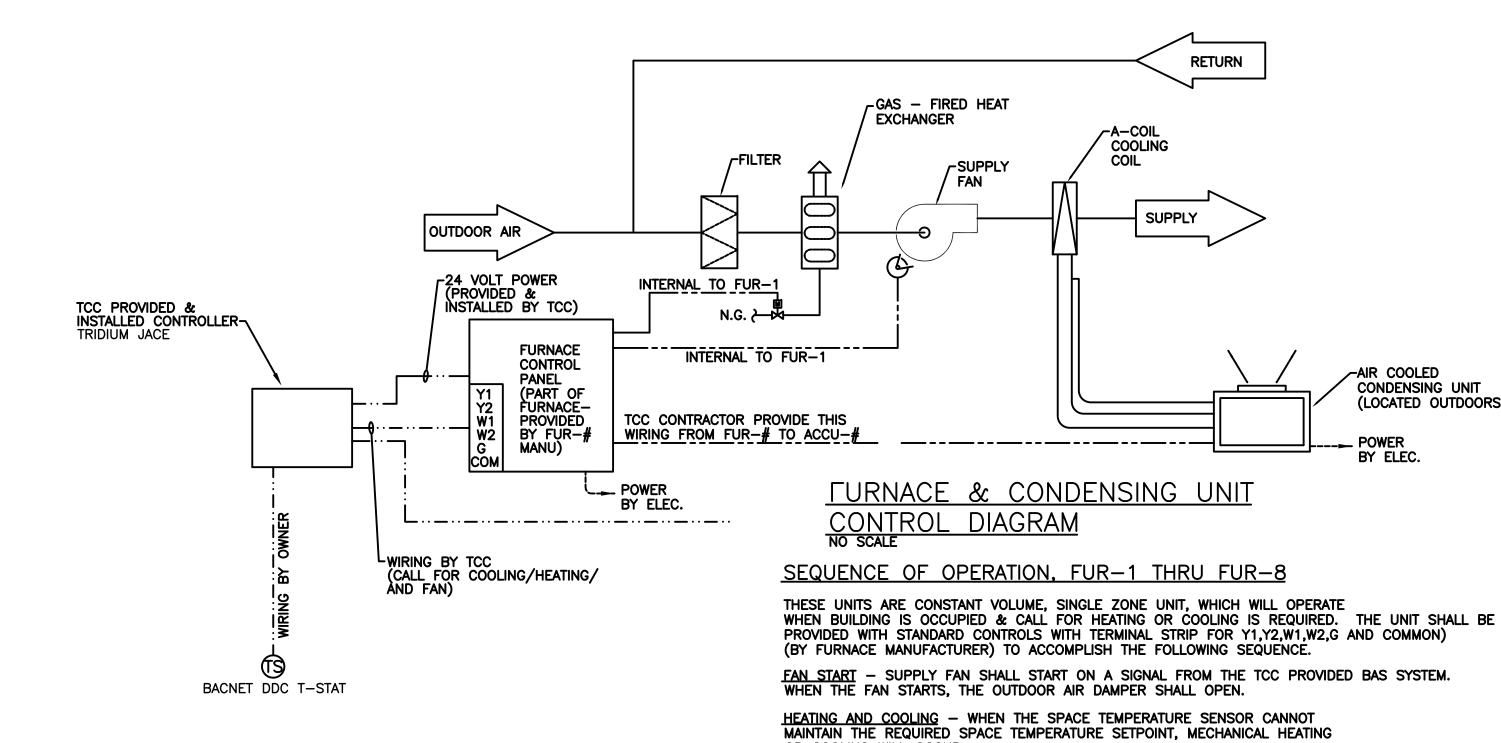

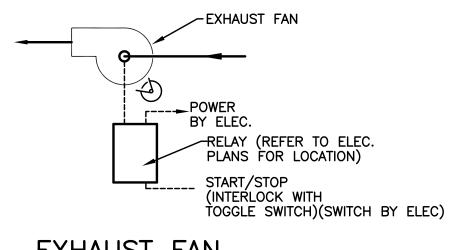


EXHAUST FAN

SEQUENCE OF OPERATION (EF-X) RESIDENT TOILET ROOM / KITCHEN: THE FAN SHALL BE STARTED/STOPPED BY TOGGLE SWITCH BY (SWITCH BY ELECTRICAL)

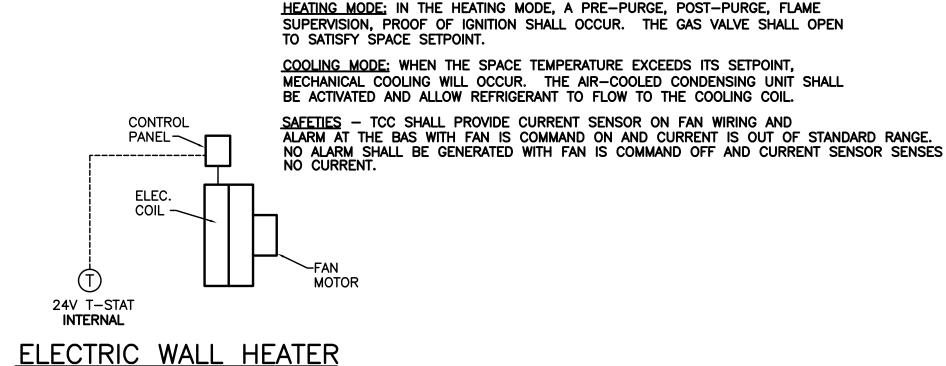


OR COOLING WILL OCCUR.

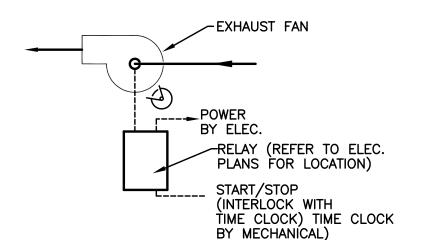

EXHAUST FAN, EF-X STORAGE ROOMS AND JC CLOSETS CONTROL DIAGRAM


SEQUENCE OF OPERATION:

THE FAN SHALL BE STARTED/STOPPED BY TIME CLOCK (BY MECH) RUNS 24/7.

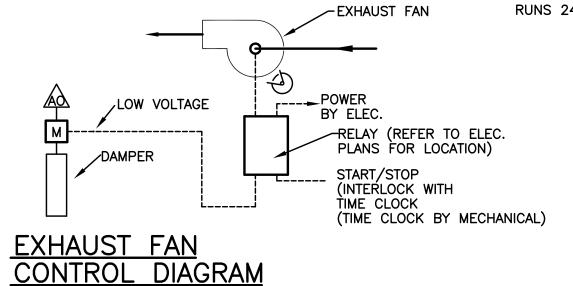

SEQUENCE OF OPERATION (EF-X) 4TH FLOOR STORAGE ROOM: THE FAN SHALL RUN 24/7.

AN INTERLOCKING END SWITCH SHALL OPEN DAMPER WHEN ASSOCIATED FAN IS RUNNING.

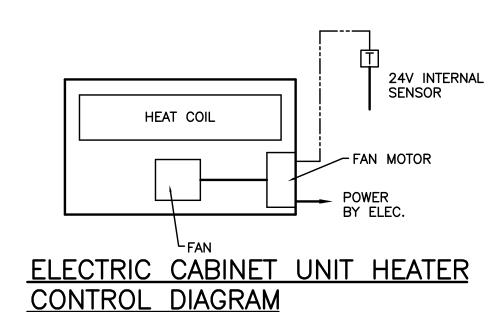

CONTROL DIAGRAM


ELECTRIC T-STAT SHALL CYCLE FAN ON/OFF AND STAGE

ELEC. HEAT AS REQUIRED TO MAINTAIN SETPOINT.

SEQUENCE OF OPERATION

SEQUENCE OF OPERATION

WHEN THE SPACE TEMPERATURE FALLS BELOW SETPOINT, AS SENSED BY THE TEMPERATURE SENSOR, THE SUPPLY FAN(S) AND ELECTRIC HEATING COIL SHALL START THROUGH A CONTROL RELAY. WHEN SPACE IS SATISFIED, FAN AND COIL SHALL STOP.

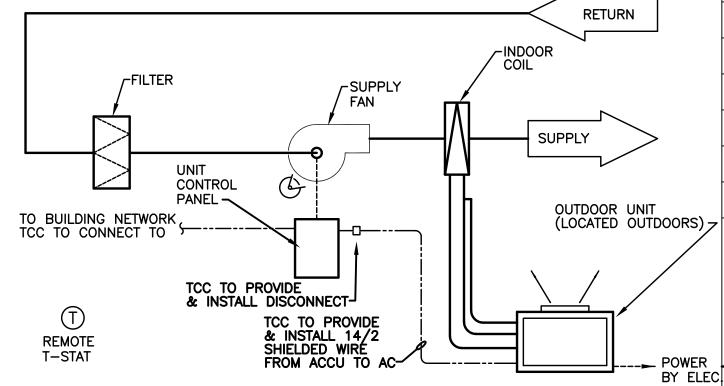

INDOOR & OUTDOOR HEAT PUMP UNIT CONTROL DIAGRAM

SEQUENCE OF OPERATION. (IU-1 & OU-1)

THESE UNIT ARE CONSTANT VOLUME, SINGLE ZONE UNIT, WHICH WILL OPERATE BASED ON TIME CLOCK (INTERNALLY TO UNIT). THE T-STAT SHALL HAVE A 24-HOUR TIME CLOCK ENABLING ONE ON/OFF TIME TO BE SET IN A 24-HOUR PERIOD. (UNITS TO RUN 24/7)

FAN START - SUPPLY FAN SHALL START ON A SIGNAL FROM THE T-STAT.

COOLING - WHEN THE SPACE TEMPERATURE SENSOR CANNOT MAINTAIN THE REQUIRED SPACE TEMPERATURE SETPOINT, MECHANICAL COOLING WILL OCCUR.

COOLING MODE: WHEN THE SPACE TEMPERATURE EXCEEDS ITS SETPOINT, MECHANICAL COOLING WILL OCCUR. THE OUTDOOR UNIT SHALL BE ACTIVATED AND ALLOW REFRIGERANT TO FLOW TO THE COOLING COIL. HEATING MODE: WHEN THE SPACE TEMPERATURE DROPS BELOW ITS SETPOINT, MECHANICAL HEATING WILL OCCUR. THE OUTDOOR UNIT SHALL BE ACTIVATED AND ALLOW REFRIGERANT TO FLOW TO THE HEATING COIL.

REGISTRATION MICHAEL (SELLINGER

OWNER BRUSH PARK DEVELOPMENT COMPANY 1092 Woodward Ave

ARCHITECT MERGE ARCHITECTS. INC

BOSTON, MA 02210 T: 617.670.0265

AIR COOLED **CONDENSING UNIT**

BY ELEC.

(LOCATED OUTDOORS)

STRUCTURAL ENGINEER

MECHANICAL ENGINEER

SELLINGER ASSOCIATES, INC. 19821 FARMINGTON ROAD LIVONIA, MI 48152 T: 248 482 0045

ELECTRICAL ENGINEER

418-1/2 S. WASHINGTON BLVD. ROYAL OAK, MI 48067 T: 248 744 0360

CIVIL ENGINEER

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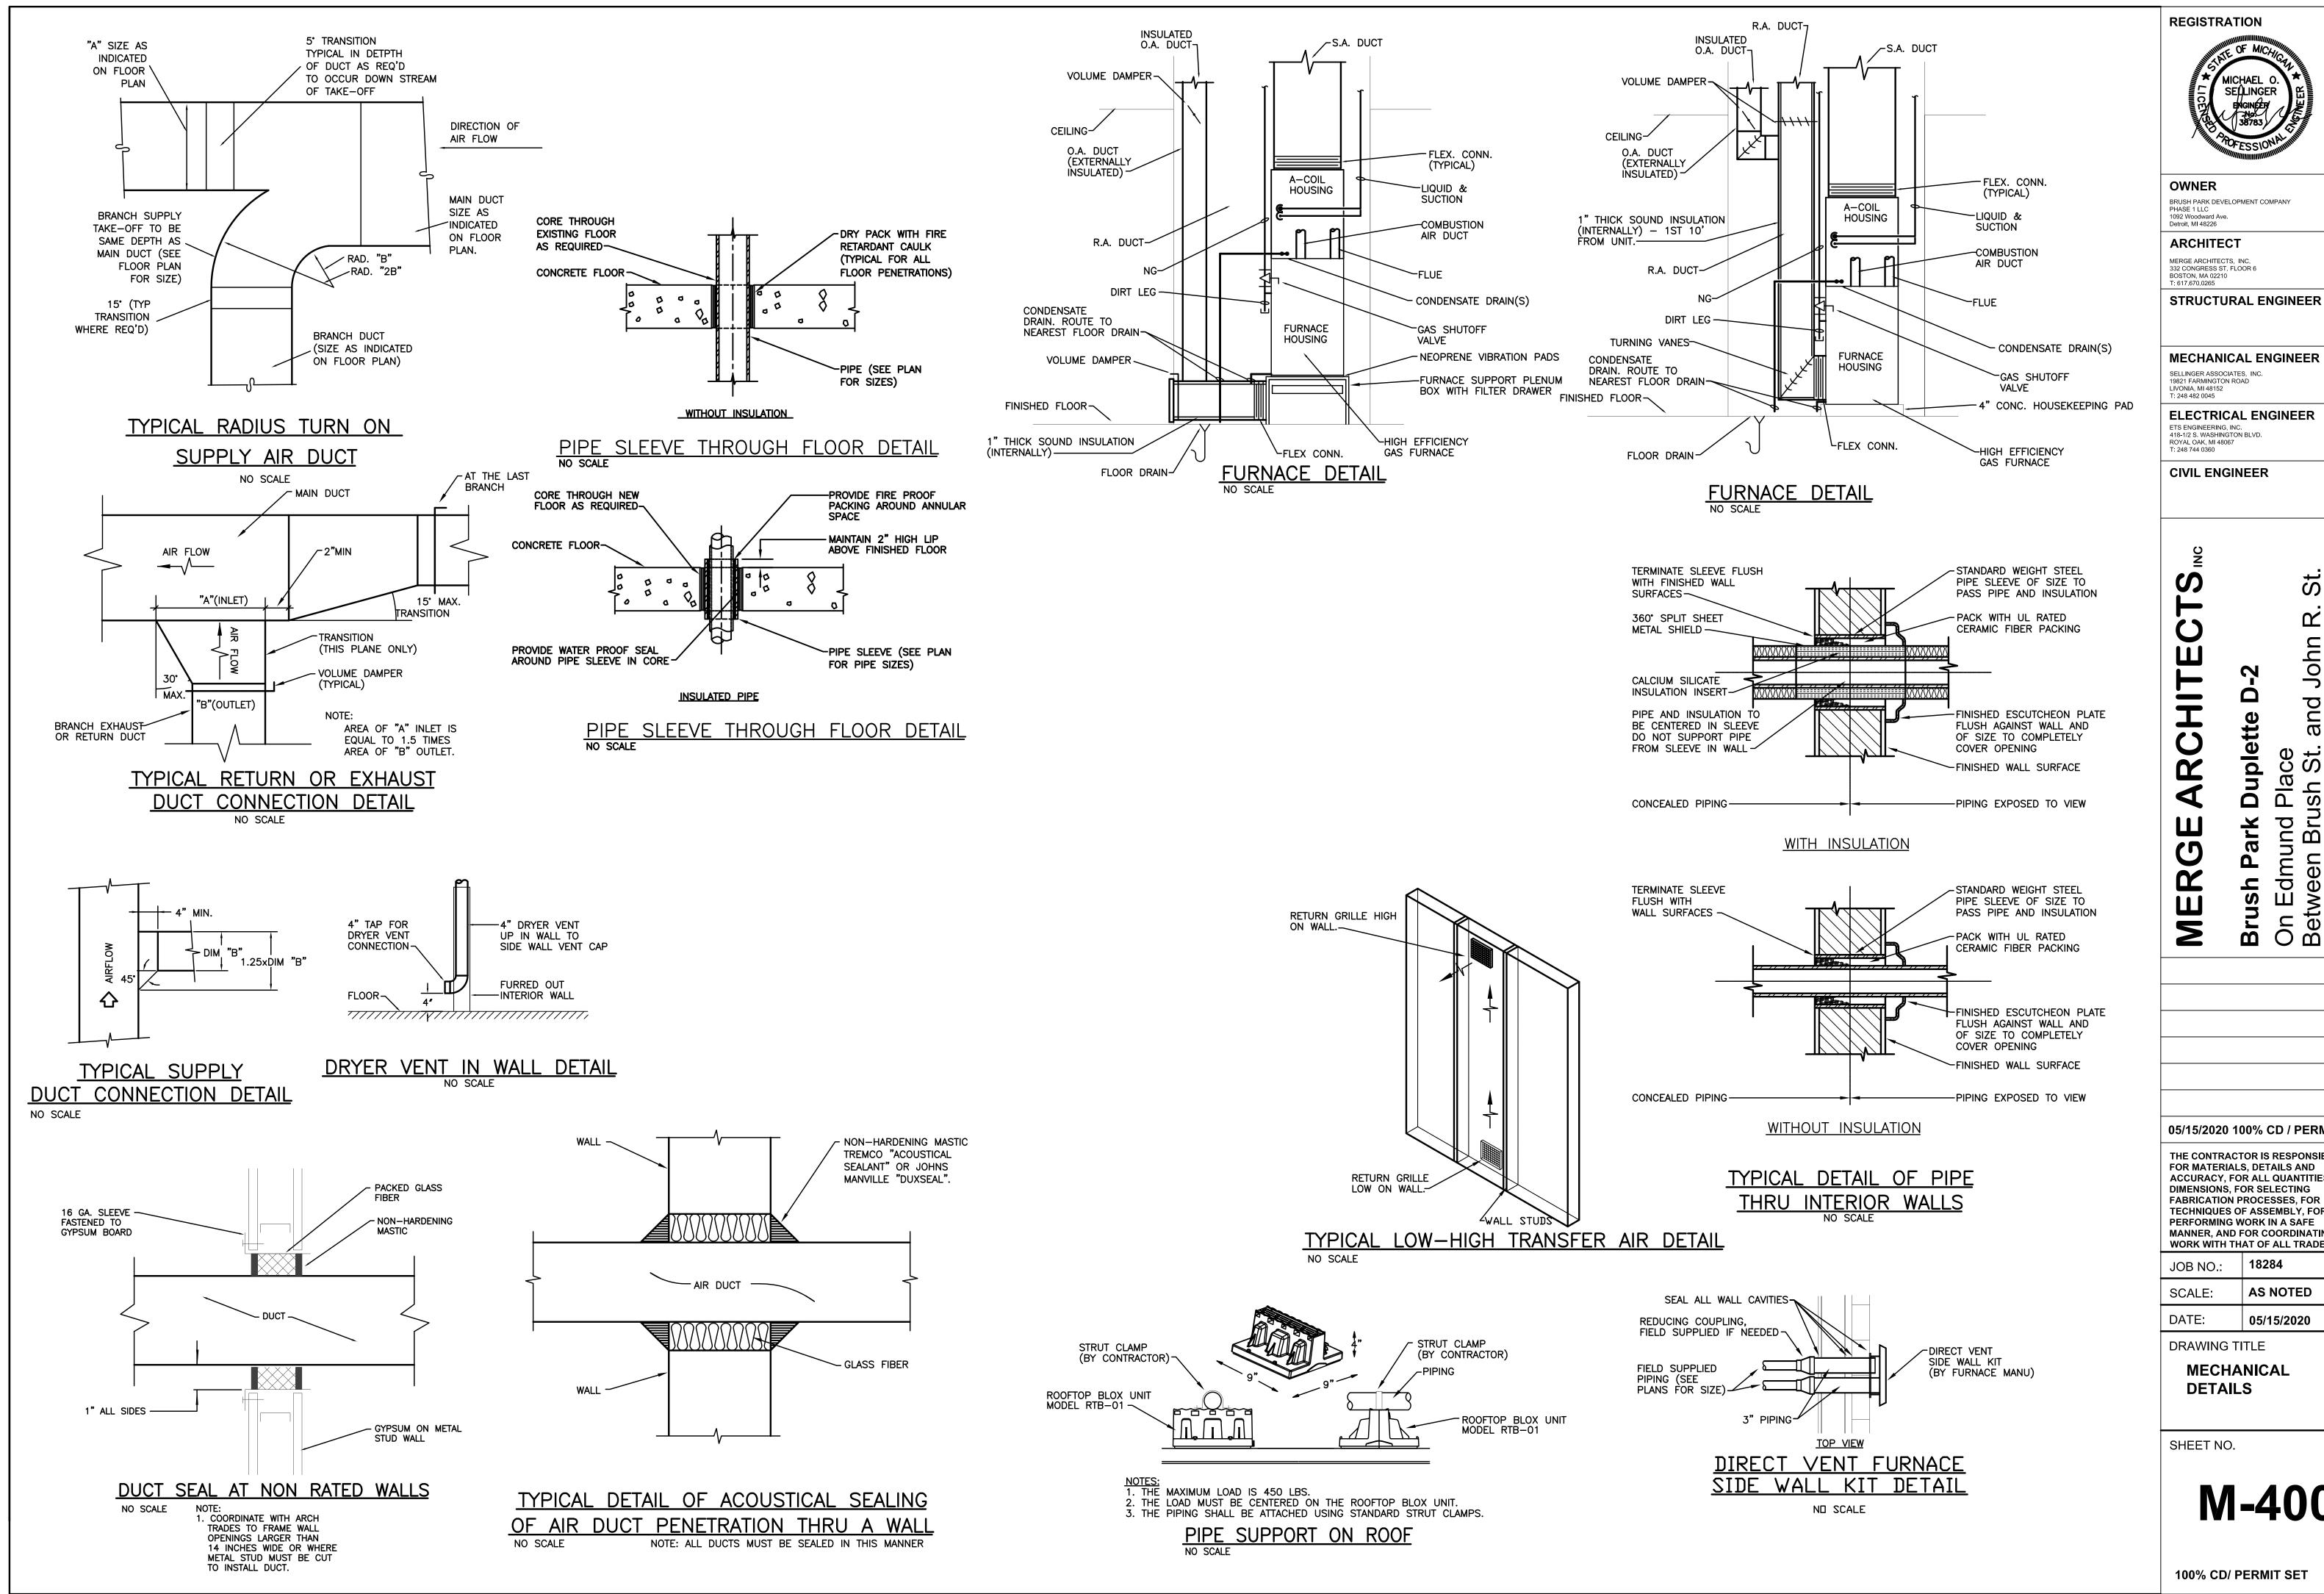
18284 JOB NO.: AS NOTED SCALE: DATE: 05/15/2020

DRAWING TITLE

TEMPERATURE CONTROLS

SHEET NO.

M - 300



BRUSH PARK DEVELOPMENT COMPANY

MECHANICAL ENGINEER

ELECTRICAL ENGINEER


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AS NOTED 05/15/2020

M-400



SELLINGER

OWNER BRUSH PARK DEVELOPMENT COMPANY 1092 Woodward Ave.

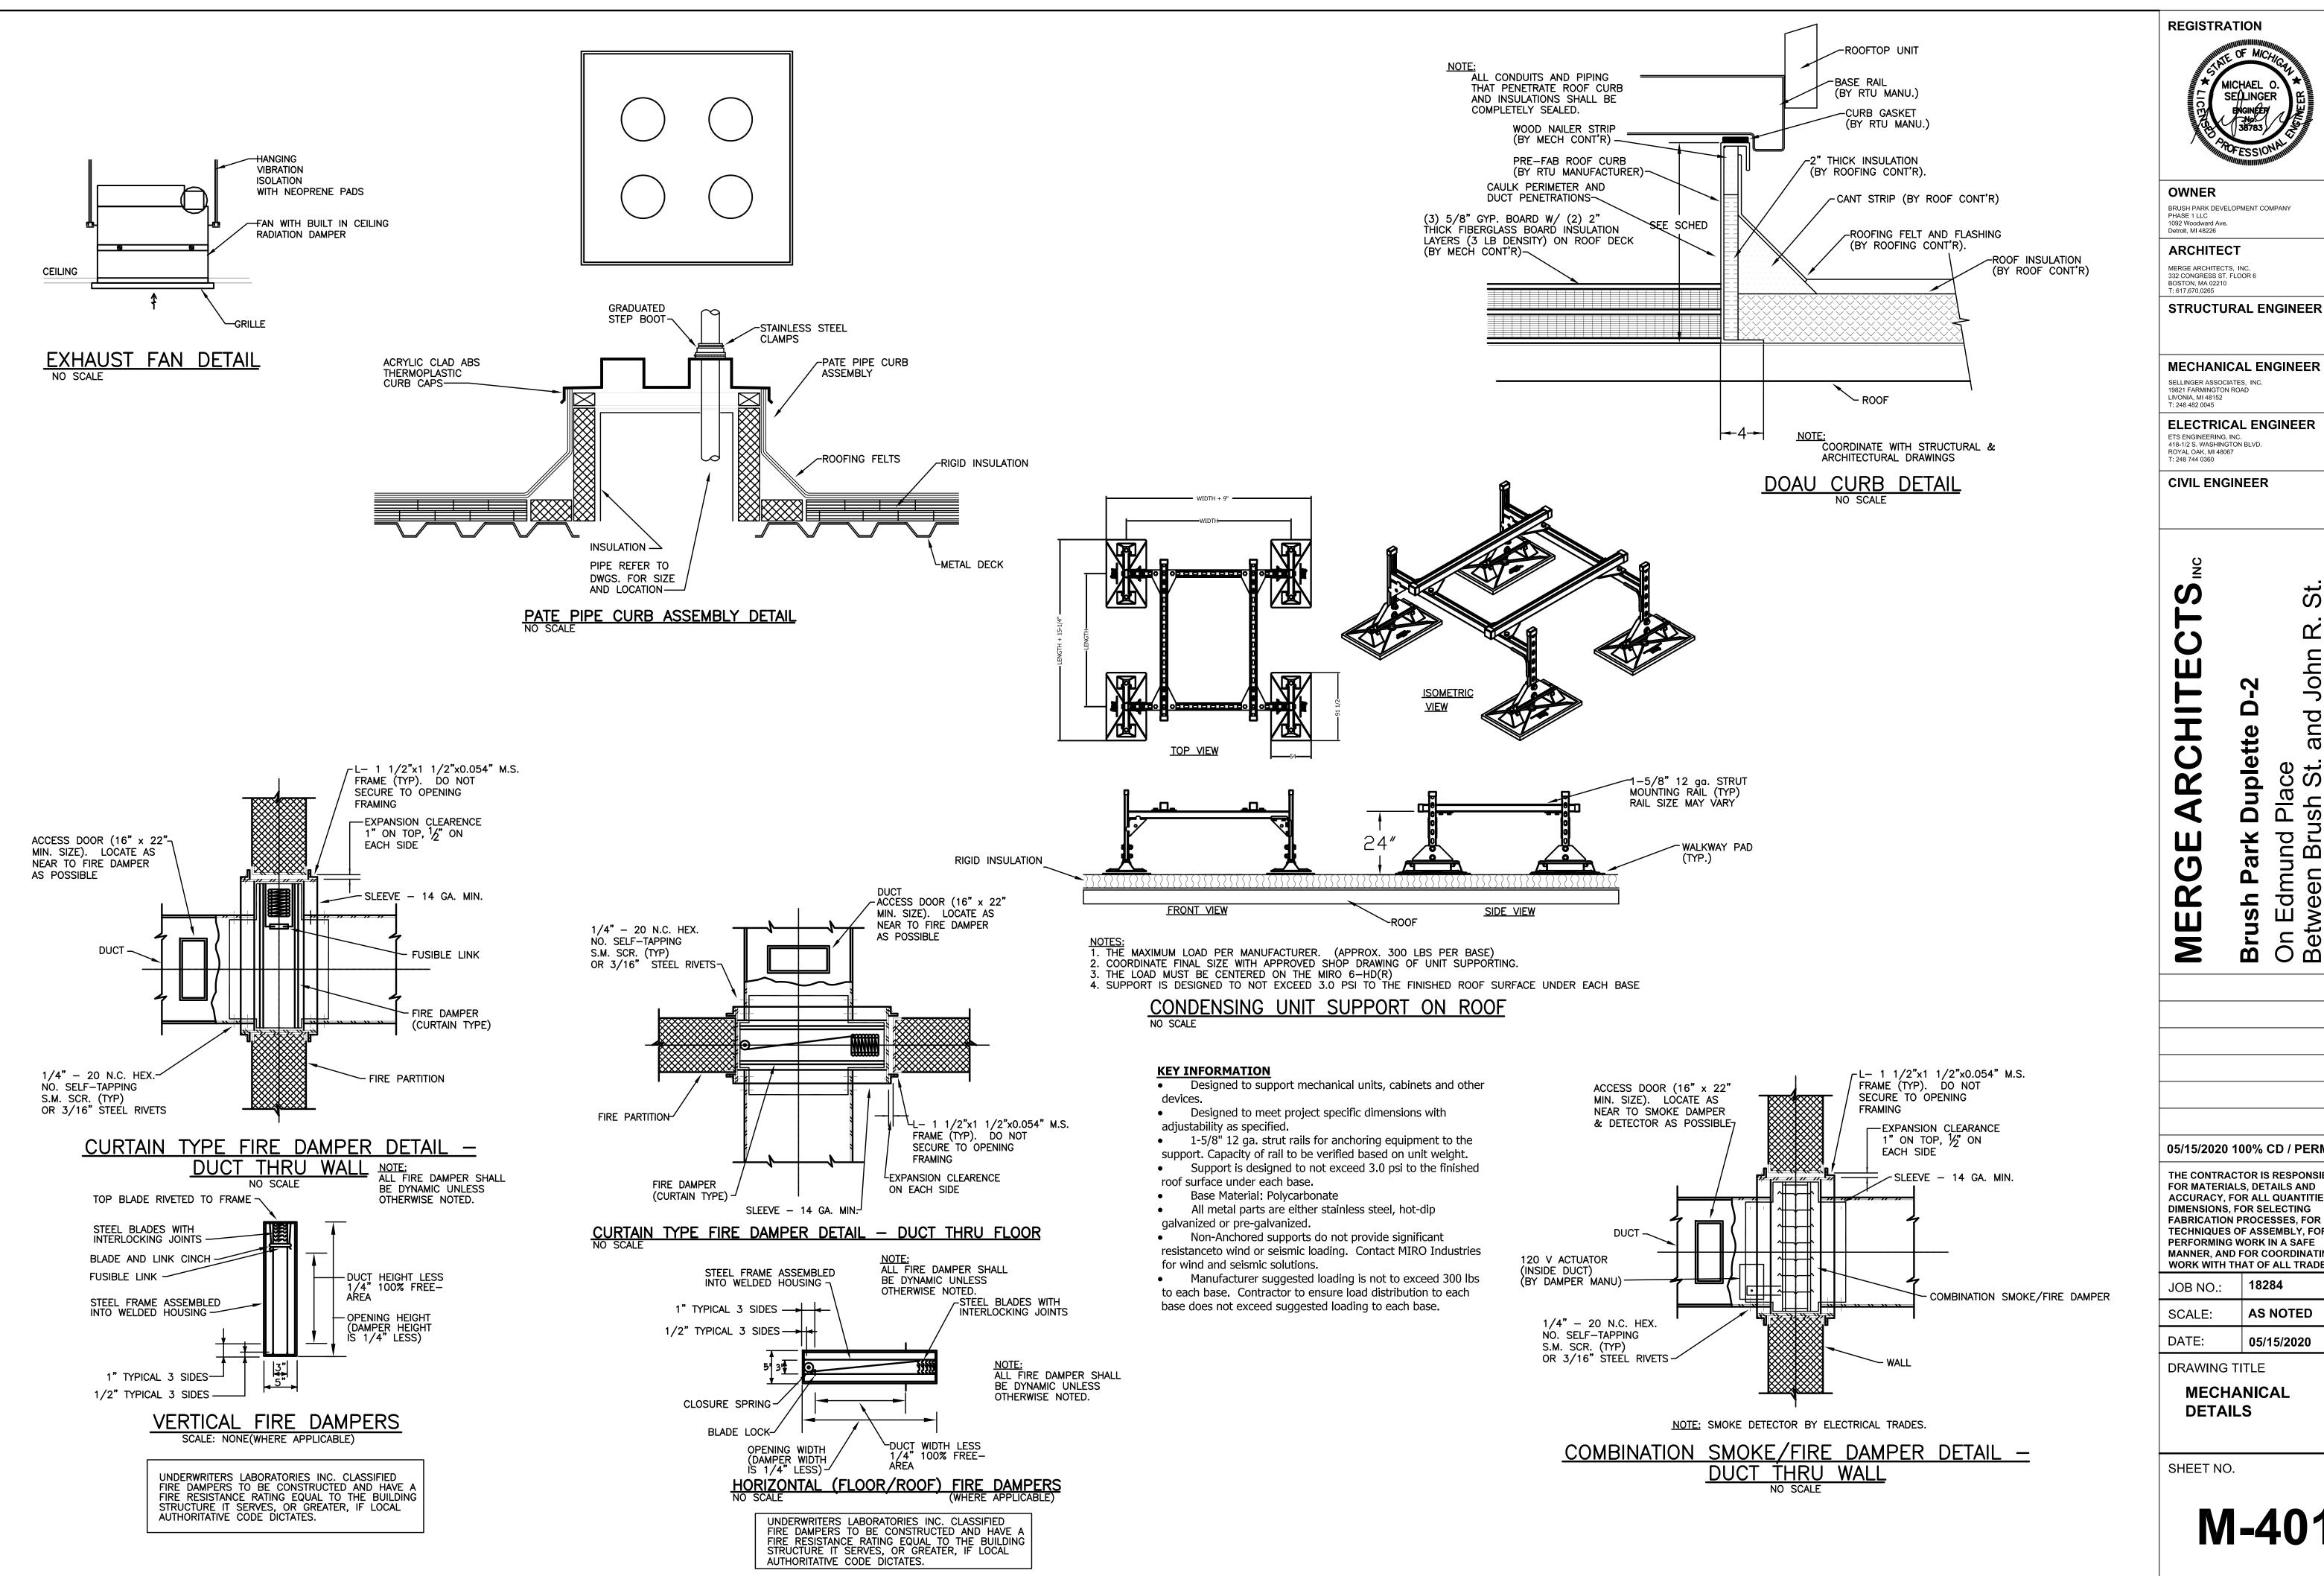ARCHITECT MERGE ARCHITECTS. INC

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MECHANICAL ENGINEER

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ELECTRICAL ENGINEER

T: 248 744 0360

CIVIL ENGINEER

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18284 JOB NO.: **AS NOTED** SCALE: DATE: 05/15/2020

DRAWING TITLE

MECHANICAL DETAILS

SHEET NO.

M-401

														FU	RNACE SC	HED	ULE																	
			FAN	SECTION							COOLING (OIL DATA	\						СОМВ	JSTION	FAN		HIGH EF	FICIENCY H	HEATING SI	ECTION (NA	Г.)	F	ILTER		ELECT	RICAL DATA	,,,от	DUEEN
MARK	CFM	O.A. CFM	E.S.P. IN. WG.	FAN SPEED	NO. N	MOTOR HP	E.A.T. DB/WB(*F)	CAPACITY (BTUH)	ROWS	F.P.I.	AREA SQ. FT.	LIQUID	SUCTION	DRAIN	RHEEM MODEL #	NOM. TONS	WGT. LBS.	PRESS. DROP	FAN SPEED	NO. FANS	MOTOR HP	E.A.T. (°F)	L.A.T. (°F)	INPUT MBH	OUTPUT MBH	FLUE DIAMETER	O.A. DIAMETER	TYPE	NO.	AREA IN^2	VOLTS/PH/HZ	MAX OVERCURRENT PROTECTION (AMPS)	WGT. LBS.	RHEEM MODEL #
FUR-1	600	35	0.8"	VARIABLE	1	1/2	76/67	18,000	2	16	4.56	3/8"	3/4"	3/4"	RCF1817STAMCA	1.5	43	0.12"	SINGLE	1	PER MFG	67.8	130	42	41	3"ø	3"ø	1" MERV 8	1	400	120/1/60	15	128	R96VA0402317MSA
FUR-2	800	60	0.8"	VARIABLE	1	1/2	76/67	24,000	2	16	4.56	3/8"	3/4"	3/4"	RCF2417STAMCA	2.0	43	0.12"	SINGLE	1	PER MFG	67.7	114	42	41	3"ø	3"ø	1" MERV 8	1	400	120/1/60	15	128	R96VA0402317MSA
FUR-3	600	35	0.8"	VARIABLE	1	1/2	76/67	18,000	2	16	4.56	3/8"	3/4"	3/4"	RCF1817STAMCA	1.5	43	0.12"	SINGLE	1	PER MFG	67.8	130	42	41	3"ø	3"ø	1" MERV 8	1	400	120/1/60	15	128	R96VA0402317MSA
FUR-4	800	60	0.8"	VARIABLE	1	1/2	76/67	24,000	2	16	4.56	3/8"	3/4"	3/4"	RCF2417STAMCA	2.0	43	0.12"	SINGLE	1	PER MFG	67.7	114	42	41	3"ø	3"ø	1" MERV 8	1	400	120/1/60	15	128	R96VA0402317MSA
FUR-5	600	35	0.8"	VARIABLE	1	1/2	76/67	18,000	2	16	4.56	3/8"	3/4"	3/4"	RCF1817STAMCA	1.5	43	0.12"	SINGLE	1	PER MFG	67.8	130	42	41	3"ø	3"ø	1" MERV 8	1	400	120/1/60	15	128	R96VA0402317MSA
FUR-6	800	60	0.8"	VARIABLE	1	1/2	76/67	24,000	2	16	4.56	3/8"	3/4"	3/4"	RCF2417STAMCA	2.0	43	0.12"	SINGLE	1	PER MFG	67.7	114	42	41	3"ø	3"ø	1" MERV 8	1	400	120/1/60	15	128	R96VA0402317MSA
FUR-7	600	35	0.8"	VARIABLE	1	1/2	76/67	18,000	2	16	4.56	3/8"	3/4"	3/4"	RCF1817STAMCA	1.5	43	0.12"	SINGLE	1	PER MFG	67.8	130	42	41	3"ø	3"ø	1" MERV 8	1	400	120/1/60	15	128	R96VA0402317MSA
FUR-8	1000	65	0.8"	VARIABLE	1	1/2	76/67	30,000	2	16	5.70	3/8"	3/4"	3/4"	RCF3617STAMCA	2.5	49	0.12"	SINGLE	1	PER MFG	67.7	118	56	55	3"ø	3"ø	1" MERV 8	1	400	120/1/60	15	128	R96VA0602317MSA
FUR-9	1000	70	0.8"	VARIABLE	1	1/2	76/67	30,000	2	16	5.70	3/8"	3/4"	3/4"	RCF3617STAMCA	2.5	49	0.12"	SINGLE	1	PER MFG	67.7	118	56	55	3"ø	3"ø	1" MERV 8	1	400	120/1/60	15	128	R96VA0602317MSA
FUR-10	600	35	0.8"	VARIABLE	1	1/2	76/67	18,000	2	16	4.56	3/8"	3/4"	3/4"	RCF1817STAMCA	1.5	43	0.12"	SINGLE	1	PER MFG	67.8	130	42	41	3"ø	3"ø	1" MERV 8	1	400	120/1/60	15	128	R96VA0402317MSA
FUR-11	600	35	0.8"	VARIABLE	1	1/2	76/67	18,000	2	16	4.56	3/8"	3/4"	3/4"	RCF1817STAMCA	1.5	43	0.12"	SINGLE	1	PER MFG	67.8	130	42	41	3"ø	3 " ø	1" MERV 8	1	400	120/1/60	15	128	R96VA0402317MSA
FUR-12	600	35	0.8"	VARIABLE	1	1/2	76/67	18,000	2	16	4.56	3/8"	3/4"	3/4"	RCF1817STAMCA	1.5	43	0.12"	SINGLE	1	PER MFG	67.8	130	42	41	3"ø	3"ø	1" MERV 8	1	400	120/1/60	15	128	R96VA0402317MSA
FUR-13	600	35	0.8"	VARIABLE	1	1/2	76/67	18,000	2	16	4.56	3/8"	3/4"	3/4"	RCF1817STAMCA	1.5	43	0.12"	SINGLE	1	PER MFG	67.8	130	42	41	3"ø	3"ø	1" MERV 8	1	400	120/1/60	15	128	R96VA0402317MSA
FUR-14	1000	70	0.8"	VARIABLE	1	1/2	76/67	30,000	2	16	5.70	3/8"	3/4"	3/4"	RCF3617STAMCA	2.5	49	0.12"	SINGLE	1	PER MFG	67.7	118	56	55	3"ø	3"ø	1" MERV 8	1	400	120/1/60	15	128	R96VA0602317MSA
FUR-15	800	65	0.8"	VARIABLE	1	1/2	76/67	24,000	2	16	4.56	3/8"	3/4"	3/4"	RCF2417STAMCA	2.0	43	0.12"	SINGLE	1	PER MFG	67.7	114	42	41	3"ø	3"ø	1" MERV 8	1	400	120/1/60	15	128	R96VA0402317MSA
FUR-16	800	60	0.8"	VARIABLE	1	1/2	76/67	24,000	2	16	4.56	3/8"	3/4"	3/4"	RCF2417STAMCA	2.0	43	0.12"	SINGLE	1	PER MFG	67.7	114	42	41	3"ø	3"ø	1" MERV 8	1	400	120/1/60	15	128	R96VA0402317MSA
FUR-17	1000	70	0.8"	VARIABLE	1	1/2	76/67	30,000	2	16	5.70	3/8"	3/4"	3/4"	RCF3617STAMCA	2.5	49	0.12"	SINGLE	1	PER MFG	67.7	118	56	55	3"ø	3"ø	1" MERV 8	1	400	120/1/60	15	128	R96VA0602317MSA
FUR-18	800	65	0.8"	VARIABLE	1	1/2	76/67	24,000	2	16	4.56	3/8"	3/4"	3/4"	RCF2417STAMCA	2.0	43	0.12"	SINGLE	1	PER MFG	67.7	114	42	41	3"ø	3"ø	1" MERV 8	1	400	120/1/60	15	128	R96VA0402317MSA
FUR-19	1000	70	0.8"	VARIABLE	1	1/2	76/67	30,000	2	16	5.70	3/8"	3/4"	3/4"	RCF3617STAMCA	2.5	49	0.12"	SINGLE	1	PER MFG	67.7	118	56	55	3"ø	3"ø	1" MERV 8	1	400	120/1/60	15	128	R96VA0602317MSA
FUR-20	1000	75	0.8"	VARIABLE	1	1/2	76/67	30,000	2	16	5.70	3/8"	3/4"	3/4"	RCF3617STAMCA	2.5	49	0.12"	SINGLE	1	PER MFG	67.7	118	56	55	3"ø	3"ø	1" MERV 8	1	400	120/1/60	15	128	R96VA0602317MSA
FUR-21	800	60	0.8"	VARIABLE	1	1/2	76/67	24,000	2	16	4.56	3/8"	3/4"	3/4"	RCF2417STAMCA	2.0	43	0.12"	SINGLE	1	PER MFG	67.7	114	42	41	3"ø	3 " ø	1" MERV 8	1	400	120/1/60	15	128	R96VA0402317MSA
FUR-22	800	60	0.8"	VARIABLE	1	1/2	76/67	24,000	2	16	4.56	3/8"	3/4"	3/4"	RCF2417STAMCA	2.0	43	0.12"	SINGLE	1	PER MFG	67.7	114	42	41	3"ø	3 " ø	1" MERV 8	1	400	120/1/60	15	128	R96VA0402317MSA
FUR-23	1000	75	0.8"	VARIABLE	1	1/2	76/67	30,000	2	16	5.70	3/8"	3/4"	3/4"	RCF3617STAMCA	2.5	49	0.12"	SINGLE	1	PER MFG	67.7	118	56	55	3"ø	3"ø	1" MERV 8	1	400	120/1/60	15	128	R96VA0602317MSA
FUR-24	800	60	0.8"	VARIABLE	1	1/2	76/67	24,000	2	16	4.56	3/8"	3/4"	3/4"	RCF2417STAMCA	2.0	43	0.12"	SINGLE	1	PER MFG	67.7	114	42	41	3"ø	3"ø	1" MERV 8	1	400	120/1/60	15	128	R96VA0402317MSA
FUR-25	1000	75	0.8"	VARIABLE	1	1/2	76/67	30,000	2	16	5.70	3/8"	3/4"	3/4"	RCF3617STAMCA	2.5	49	0.12"	SINGLE	1	PER MFG	67.7	118	56	55	3"ø	3"ø	MERV 8	1	400	120/1/60	15	128	R96VA0602317MSA
FUR-26	800	65	0.8"	VARIABLE	1	1/2	76/67	24,000	2	16	4.56	3/8"	3/4"	3/4"	RCF2417STAMCA	2.0	43	0.12"	SINGLE	1	PER MFG	67.7	114	42	41	3"ø	3"ø	1" MERV 8	1	400	120/1/60	15	128	R96VA0402317MSA

ACCESSORIES: A. PROVIDE PVC FLUE AND COMBUSTION CONCENTRIC SIDEWALL/ROOF KIT. C. PROVIDE WITH FURNACE INTEGRAL CONTROLLER WITH D. PROVIDE A-COIL WITH DRAIN PANS. F. PROVIDE (2) SETS OF FILTERS FOR FURNACE PROVIDE TRIANGLE TUBE PRESTIGE STAINLESS TERMINATION KIT TERMINAL STRIP (Y1,Y2,W1,W2,G,COMMON) (PART OF E. DISCONNECT BY ELECTRICAL. PACKAGED FURNACE UNIT) (SEE TCC DRAWINGS) B. REFRIGERANT TO BE R-410A.

					E	XHAUS	ST FAN	N SCI	HEDULE					
								MOTOR						
MARK	AREA SERVED	C.F.M.	E.S.P.	FAN RPM	TYPE	HP	VOLTS/W	PHASE	FREQ (HZ)	TYPE DRIVE	WGT. LBS.	INTERLOCKED WITH	MAKE & MODEL NO.	NOTES
EF-1	TOILET ROOM	50	0.25	1100	CEILING EXHAUST FAN	12.5 W	115	1	60	DIRECT	60	w/ switch	DELTA BREEZ - GBR80-CRD	A – E
EF-2	KITCHEN	100	0.25	1100	CEILING EXHAUST FAN	12.6 W	115	1	60	DIRECT	60	w/ switch	DELTA BREEZ - GBR100-CRD	A – E
EF-3	SEE DWGS	100	0.70	1100	CEILING EXHAUST FAN	128 W	115	1	60	DIRECT	60	RUNS 24/7	GREENHECK - SP-B200	A — E

- A. PROVIDE W/ SAFETY DISCONNECT SWITCH B. PROVIDE W/ GRAVITY BACKDRAFT DAMPER
- C. UNIT SHALL HAVE AMCA SEAL & BE U.L. CERTIFIED D. HANG FROM STRUCTURE ABOVE WITH NEOPRENE PADS.
- E. PROVIDE ALL ACCESSORIES REQUIRED FOR CEILING MOUNT
- WITH CEILING RADIATION DAMPER CRD. PROVIDE ALL CONTROLS PER MANUFACTURE. PROVIDE SSR SPEED CONTROL SWITCH.

			EL	ECTRIC	CABINE	ET UN	T HEA	TER S	SCHEDU	JLE		
MARK	AREA SERVED	TYPE	# OF ELEMENTS	1ST STAGE KW (LO)	2ND STAGE KW (HI)	TOTAL KW	VOLTS/ PHASE	BLOWER MOTOR CFM HI/LO	BLOWER MOTOR RPM HI/LO	WEIGHT LBS	MANUFACTURER & MODEL NO.	REMARKS
ECUH-1	SEE DWGS	2-STAGE	4	2.0	4.0	4.0	208V/1ø	250/230	1550/1400	120	MARKEL – 6333D042013B30D0F	A, B, C, D
ECUH-2	SEE DWGS	2-STAGE	4	1.0	2.0	2.0	208V/1ø	250/230	1550/1400	120	MARKEL – 6333D022013B30D0F	C, D, E, F
. PROVIDE	WITH SEMI RE	CESSED CE	ILING MOUI	NTING KIT -	COORDINATE	WITH ARC	HITECT ANI) FIRE RA	TING. D CC	OPDINATE (COLOR WITH ARCHITECTURAL	DRAWINGS /ARCHITE

ATING. D. COORDINATE COLOR WITH ARCHITECTURAL DRAWINGS/ARCHITECT.

MED E. PROVIDE WITH SEMI RECESSED WALL MOUNTING KIT — COORDINATE WITH ARCHITECT. CONTRACTOR SHALL COORDINATE CEILING OPENING IN FIELD.

PROVIDE WITH SEMI RECESSED CEILING MOONTING KIT — COORDINATE WITH AND AND ADDRESSED WALL MOUNTING KIT — COORDINATE WALL MOUNTING KIT — COORDINATE WALL MOUNTING KIT — COORDINATE WALL OPENING IN FIELD.

F. CONTRACTOR SHALL COORDINATE WALL OPENING IN FIELD. AND REMOTE WALL MOUNT T-STAT 24 VOLT FOR ECUH-1.

								Al	RC	OOL	ED (COND	ENS		UN	П					
		(COMPRES	SORS	(CONDE	NSER F	ANS		CONDEN	ISER CO	IL	ELEC	TRICAL	CHARA	ACTERIS	TICS			T RHEEM MODEL NO.	
MARK	UNIT SERVING	NO.	TYPE	RLA/LRA EACH	NO.	DIA.	CFM	HP EACH	ROWS	F.P.I.	AREA SQ.FT.	REFG	UNIT MCA	MAX. FUSE	VOLTS	PHASE	Hz	NOMINAL TONS	WEIGHT LBS		OPTIONS
ACCU-1	FUR-1	1	SCROLL	9.7/48	1	20	2225	1/10	1	22	9.1	R410A	13	20	208	1	60	1.5	175	RA1418A	A,B,C,D
ACCU-2	FUR-2	1	SCROLL	11.2/60.8	1	20	2505	1/8	1	22	11.1	R410A	15	25	208	1	60	2.0	175	RA14224A	A,B,C,D
ACCU-3	FUR-3	1	SCROLL	9.7/48	1	20	2225	1/10	1	22	9.1	R410A	13	20	208	1	60	1.5	175	RA1418A	A,B,C,D
ACCU-4	FUR-4	1	SCROLL	11.2/60.8	1	20	2505	1/8	1	22	11.1	R410A	15	25	208	1	60	2.0	175	RA14224A	A,B,C,D
ACCU-5	FUR-5	1	SCROLL	9.7/48	1	20	2225	1/10	1	22	9.1	R410A	13	20	208	1	60	1.5	175	RA1418A	A,B,C,D
ACCU-6	FUR-6	1	SCROLL	11.2/60.8	1	20	2505	1/8	1	22	11.1	R410A	15	25	208	1	60	2.0	175	RA14224A	A,B,C,D
ACCU-7	FUR-7	1	SCROLL	9.7/48	1	20	2225	1/10	1	22	9.1	R410A	13	20	208	1	60	1.5	175	RA1418A	A,B,C,D
ACCU-8	FUR-8	1	SCROLL	12.8/64	1	20	2605	1/8	1	22	12.1	R410A	17	25	208	1	60	2.5	175	RA1430A	A,B,C,D
ACCU-9	FUR-9	1	SCROLL	12.8/64	1	20	2605	1/8	1	22	12.1	R410A	17	25	208	1	60	2.5	175	RA1430A	A,B,C,D
ACCU-10	FUR-10	1	SCROLL	9.7/48	1	20	2225	1/10	1	22	9.1	R410A	13	20	208	1	60	1.5	175	RA1418A	A,B,C,D
ACCU-11	FUR-11	1	SCROLL	9.7/48	1	20	2225	1/10	1	22	9.1	R410A	13	20	208	1	60	1.5	175	RA1418A	A,B,C,D
ACCU-12	FUR-12	1	SCROLL	9.7/48	1	20	2225	1/10	1	22	9.1	R410A	13	20	208	1	60	1.5	175	RA1418A	A,B,C,D
ACCU-13	FUR-13	1	SCROLL	9.7/48	1	20	2225	1/10	1	22	9.1	R410A	13	20	208	1	60	1.5	175	RA1418A	A,B,C,D
ACCU-14	FUR-14	1	SCROLL	12.8/64	1	20	2605	1/8	1	22	12.1	R410A	17	25	208	1	60	2.5	175	RA1430A	A,B,C,D
ACCU-15	FUR-15	1	SCROLL	11.2/60.8	1	20	2505	1/8	1	22	11.1	R410A	15	25	208	1	60	2.0	175	RA14224A	A,B,C,D
ACCU-16	FUR-16	1	SCROLL	11.2/60.8	1	20	2505	1/8	1	22	11.1	R410A	15	25	208	1	60	2.0	175	RA14224A	A,B,C,D
ACCU-17	FUR-17	1	SCROLL	12.8/64	1	20	2605	1/8	1	22	12.1	R410A	17	25	208	1	60	2.5	175	RA1430A	A,B,C,D
ACCU-18	FUR-18	1	SCROLL	11.2/60.8	1	20	2505	1/8	1	22	11.1	R410A	15	25	208	1	60	2.0	175	RA14224A	A,B,C,D
ACCU-19	FUR-14	1	SCROLL	12.8/64	1	20	2605	1/8	1	22	12.1	R410A	17	25	208	1	60	2.5	175	RA1430A	A,B,C,D
ACCU-20	FUR-14	1	SCROLL	12.8/64	1	20	2605	1/8	1	22	12.1	R410A	17	25	208	1	60	2.5	175	RA1430A	A,B,C,D
ACCU-21	FUR-21	1	SCROLL	11.2/60.8	1	20	2505	1/8	1	22	11.1	R410A	15	25	208	1	60	2.0	175	RA14224A	A,B,C,D
ACCU-22	FUR-22	1	SCROLL	11.2/60.8	1	20	2505	1/8	1	22	11.1	R410A	15	25	208	1	60	2.0	175	RA14224A	A,B,C,D
ACCU-23	FUR-23	1	SCROLL	12.8/64	1	20	2605	1/8	1	22	12.1	R410A	17	25	208	1	60	2.5	175	RA1430A	A,B,C,D
ACCU-24	FUR-24	1	SCROLL	11.2/60.8	1	20	2505	1/8	1	22	11.1	R410A	15	25	208	1	60	2.0	175	RA14224A	A,B,C,D
ACCU-25	FUR-25	1	SCROLL	12.8/64	1	20	2605	1/8	1	22	12.1	R410A	17	25	208	1	60	2.5	175	RA1430A	A,B,C,D
ACCU-26	FUR-26	1	SCROLL	11.2/60.8	1	20	2505	1/8	1	22	11.1	R410A	15	25	208	1	60	2.0	175	RA14224A	A,B,C,D

A. MOUNT CONDENSING UNIT ON A 4" NEOPRENE HOUSEKEEPING PAD B. DISCONNECT BY ELECTRICAL.

	DEDICA'	TED (DUTSID	E AIR	UNIT	SCHE	DUL																										
		s	UPPLY FAN SE	CTION			MOTOR	DATA	EVAPO	RATOR SECT	ION (DX)	BASED ON 95	5°F AMBIEN	ΙΤ	COMPRESSOR	DATA	COND. FA	N HEAT	ING SECTION			PREFILTER	SECTION	RET	URN/POWE	R EXH SECTION		ELEC	TRICAL (AM	S)			
MARK	AREA	SUPPLY	MIN. O.A.	SUPPLY E.S.P.	TOTAL E.S.P.	FAN	рир ир	VOLTS	TOTAL	SENSIBLE	EAT	(°F) L	AT (°F)	MIN SF/	O. TYPE	NO.	NO. HF	INPU	T OUTPUT	EAT	LAT	TYPE :	SIZE EFF.	C.F.M.	E.S.P.	MOTOR BHP	HP NOW	1. FLA	MCA N	IOP WG	MANUFACTURER		ACCESSORIES
	SERVED	CFM	CFM			RPM	впг пг	PHASE	МВН	МВН	DB	WB DB	WB	ROWS/FPI '		STEPS	EAC	н мвн	н мвн	TF	7					R.P.M.	"" TONS	S		LB:	& MODEL NUMBER		(SEE BELOW)
DOAU-1	CORRIDOR / LOBBY	500	500	0.8"	-	1,040	- 1	208/3	36.56	19.92	92.00	76.00 53.3	52.78	2 / 14 FPI	I SCROLL	-	1 0.3	33 60	48.6	0	90	MERV 8	2" 30%			N/A	3	22	24	35 100	AAON - RQ-003-9-V-FA09-319:M000-	-U00-PKB-000-C0D000F-00-0000000VB	1–18

ACCESSORIES:

- UNIT CAPACITIES SHALL BE BASED ON ABOVE DATA.
- THERMOSTATICALLY CONTROLLED CRANKCASE HEATER. FILTER DRYER ON COMPRESSOR REFRIGERANT SYSTEM.
- BACNET CARD AND T-SENSOR PER BEDROCK SMART CONTROLS (COORDINATE WITH TCC)
- 5. R-410 REFRIGERANT
- 5-YEAR COMPRESSOR WARRANTY.
- ANTI-SHORT CYCLING CONTROLS ON COMPRESSOR.
- 8. HIGH & LOW PRESSURE SWITCHES ON REFRIGERANT SYSTEMS. 9. PROVIDE WITH SINGLE DISCONNECT BY RTU MANU.
- 10. CONSTANT AIR VOLUME SYSTEM (DIRECT DRIVE) 11. STAINLESS STEEL HEAT EXCHANGER - MODULATING GAS 12. PROVIDE S/S CONDENSATE DRAIN PAN.
- 13. PROVIDE WITH DOWNFLOW

- 14. HINGED ACCESS DOORS 15. DIGITAL MODULATING SCROLL COMPRESSOR.
- 16. PROVIDE WITH 18" H. INSULATED FLAT FILTERED ROOF CURB (COORD WITH
- ROOF PITCH). 17. DOUBLE WALL

18. MOTORIZED OA DAMEPR.

OWNER BRUSH PARK DEVELOPMENT COMPANY 1092 Woodward Ave. Detroit, MI 48226

REGISTRATION

ARCHITECT MERGE ARCHITECTS, INC. BOSTON, MA 02210 T: 617.670.0265

STRUCTURAL ENGINEER

MECHANICAL ENGINEER SELLINGER ASSOCIATES, INC. 19821 FARMINGTON ROAD LIVONIA, MI 48152 T: 248 482 0045

ELECTRICAL ENGINEER ETS ENGINEERING, INC. 418-1/2 S. WASHINGTON BLVD. ROYAL OAK, MI 48067 T: 248 744 0360

CIVIL ENGINEER

0 an **Duplette** nd Place Brush St. , 48201 Brush Park
On Edmunc
Between Br
Detroit MI, 4

05/15/2020 100% CD / PERMIT SET

THE CONTRACTOR IS RESPONSIBLE FOR MATERIALS, DETAILS AND ACCURACY, FOR ALL QUANTITIES AND DIMENSIONS, FOR SELECTING FABRICATION PROCESSES, FOR TECHNIQUES OF ASSEMBLY, FOR PERFORMING WORK IN A SAFE MANNER, AND FOR COORDINATING **WORK WITH THAT OF ALL TRADES**

JOB NO.: AS NOTED SCALE: 05/15/2020 DATE:

DRAWING TITLE

MECHANICAL SCHEDULES

SHEET NO.

W	ALL CA	AP SCI	HEDULE	=		
MARK	UNIT SERVING	USE	SIZE	MANUFACTURER & MODEL NO.	BACK DRAFT DAMPER	BIRD SCREEN
WC-1	SEE DWGS	DRYER	4"	LUXURY METALS	YES	NO
WC-2	SEE DWGS	EXH	6"	LUXURY METALS	YES	YES
WC-3	SEE DWGS	INT	6"	LUXURY METALS	NO	YES

NOTE: COLOR SELECTED BY ARCHITECT FROM STANDARD COLOR CHART - STAINLESS STEEL.

	G	RILLE, RE	GISTER A	ND DI	FFUSER	SCHED	NULE	
MARK	NECK SIZE	MODULE SIZE	СҒМ	FINISH	MOUNTING TYPE	CONST.	MANUFACTURER & MODEL No.	REMARKS
SG-1	10"x6"	11.75"x7.75"	SEE DRAWING	WHITE	SURFACE	STEEL	METAL FAB - MFASC_W2	PROVIDE W/ O.B.D.
SG-2	14"x6"	15.75"x7.75"	SEE DRAWING	WHITE	SURFACE	STEEL	METAL FAB - MFASC_W2	PROVIDE W/ O.B.D.
RG-1	20"x25"	21.75"x26.75"	SEE DRAWING	WHITE	SURFACE	STEEL	METAL FAB — MFRG	PROVIDE W/ O.B.D.
RG-2	18"x30"	19.75"x31.75"	SEE DRAWING	WHITE	SURFACE	STEEL	METAL FAB — MFRG	PROVIDE W/ O.B.D.
RG-3	26"x18"	27.75"x19.75"	SEE DRAWING	WHITE	SURFACE	STEEL	METAL FAB — MFRG	PROVIDE W/ O.B.D.
TAG-1	14"x6"	15.75"x7.75"	SEE DRAWING	WHITE	SURFACE	STEEL	METAL FAB — MFRG	_
FG-1	14"x6"	15.5"x7.5"	SEE DRAWING	WHITE	FLOOR	STEEL	METAL FAB — MFFR	PROVIDE W/ O.B.D.
FG-2	8"x6"	9.5"x7.5"	SEE DRAWING	WHITE	FLOOR	STEEL	METAL FAB — MFFR	PROVIDE W/ O.B.D.
SG-1	10"x6"	11.75"x7.75"	SEE DRAWING	WHITE	SURFACE	ALUMINUM	PRICE - 620D	PROVIDE W/ O.B.D.
SG-2	8"x6"	9.75"x7.75"	SEE DRAWING	WHITE	SURFACE	ALUMINUM	PRICE - 620D	PROVIDE W/ O.B.D.

	LOUVEF	1 SC	HED	ULE									
MARK	UNIT SERVING	USE	CFM	LENGTH (IN.)	HEIGHT (IN.)	DEPTH (IN.)	FACE AREA (SF)	FREE AREA (SF)	FACE VELOCITY (FPM)	FREE VELOCITY (FPM)	PRESSURE DROP (IN. OF WC)	MANUFACTURER & MODEL NO.	BIRD SCREEN
LOUV-1	SEE DWGS	INT	35-75	8.125"	4.75"	4	0.27	0.08	277	937	0.08	GREENHECK - BVE	YES

NOTE: COLOR SELECTED BY ARCHITECT FROM STANDARD COLOR CHART — CLASSIC BRONZE.

	ELECTRIC WALL HEATER SCHEDULE											
				VOLTS/		FAN		MOTOR	MARKEL			
MARK	LOCATION	TYPE	KW	PHASĖ	AMPS	R.P.M.	CFM	HP	MODEL NO.			
EWH-1	SEE PLANS	WALL	1.0	120/1	8.3	600	175	PER MFG	E3383DP-RP			
EWH-2	SEE PLANS	WALL	4.0	208/3	11.1	600	245	PER MFG	J3424T			

1. PROVIDE ALL ACCESSORIES FOR MOUNTING.

- 2. PROVIDE UNIT WITH FACTORY INSTALLED DISCONNECT SWITCH AND INTERNAL THERMOSTAT.
- UNIT SHALL BE U.L. LISTED.
 COORDINATE COLOR WITH ARCHITECTURAL DRAWINGS/ARCHITECT.

MMC 2015 VENTILATION RATES - AC/HR										
		AREA								
	UNIT	(SQUARE	CEILING		AC/HR	DESIGN				
UNIT TYPE		FT)	HEIGHT	AC/HR RATE	CFM	CFM				
1 BEDROOM	Α	672	8.5	0.35	33.32	35				
1 BEDROOM	В	672	8.5	0.35	33.32	35				
2 BEDROOM	С	1229	8.5	0.35	60.93792	65				
2 BEDROOM	D	1333	8.5	0.35	66.09458	70				
2 BEDROOM	Е	1188	8.5	0.35	58.905	60				
2 BEDROOM	F	1180	8.5	0.35	58.50833	60				
2 BEDROOM	G	1477	8.5	0.35	73.23458	75				
2 BEDROOM	Н	1157	8.5	0.35	57.36792	60				
2 BEDROOM	I	1426	8.5	0.35	70.70583	70				

Zone Iden	tification					Standar	d Case: MMC	2015				Г	Design Ca	ise			
Zone	Occupancy	Area	People	Area	Occupant	Breathing	Table 6-2	Zone	Table 6-3	Outdoor	Outdoor	Zone	Primary	Meets	SA	% OA	OA
20110	Category	71100	Outdoor	Outdoor	Density	Zone	Zone Air	Outdoor		Air Intake			Outdoor		- C, (70 071	0,1
	- category		Air Rate	Air Rate	_ ,	Outdoor	Distribution	Air Flow	Ventilation	Flow	Flow	Air Flow	Air	O tan iaan a			
						Airflow	Effectiveness		Efficiency			Fraction	Fraction				
						Vbz/	Ez	Voz/	Ev	Vot/	(CFM)	Vpz/	Zp=Voz/				
		(sf)	(cfm/person)	(cfm/sf)	(#/1000 sf)	(CFM)		(CFM)		(CFM)	,	(CFM)	Vpz				
			· · · · ·	,	,	, ,		,		, ,							
Basement	Storage	503	0	0.12	0	60.4	0.8	75.5	1	75.5	100	100	0.75	YES	100	100.0%	100
1st Floor Lobby	Lobby	151	7.5	0.06	30	43.0	0.8	53.8	1	53.8	100	100	0.54	YES	100	100.0%	100
1st Floor Corridor	Corridor	558	0	0.06	0	33.5	0.8	41.9	1	41.9	100	100	0.42	YES	100	100.0%	100
2nd Floor Corridor	Corridor	866	0	0.06	0	52.0	0.8	65.0	1	65.0	100	100	0.65	YES	100	100.0%	100
3rd Floor Corridor	Corridor	870	0	0.06	0	52.2	0.8	65.3	1	65.3	100	100	0.65	YES	100	100.0%	100
4th Floor Corridor	Corridor	0	0	0.06	0	0.0	0.8	0.0	1	0.0	0	0	-	NO	0	-	0

			IND	OC	R	UNIT - I	HEAT	PUM	P SCH	EDULE						
		SUPPLY FAN	EVAP	ORATO	R SEC	TION (DX) BAS	ED ON 95°F	AMBIENT		HEAT	ING SECTION					
MARK	AREA SERVED	CFM HI/MED/LOW	COOLING MBH	EAT DB	(°F) WB	MOISTURE REMOVAL	DISCHARGE	REF'G	FILTERS	ENTERING DB (*F)	TOTAL CAP. (BTUH)		ELECTRICAL MOP	VOLTS PHASE	dBA HI	MANUFACTURER & MODEL NUMBER
U-1	IT CLOSET	459/317/194	12.6	80	67	2.7 PT/HR	PER MFG	R-410A	WASHABLE	70.0	11.1	30	SEE ACCU	SEE OU	41	LG-LSN090HSV5
U-2	IT CLOSET	706/547/494	18.0	80	67	5.5 PT/HR	PER MFG	R-410A	WASHABLE	70.0	21.6	35	SEE ACCU	SEE OU	45	LG-LSN180HSV5

NOTES: 1. PROVIDE WITH MANUFACTURER'S CRC1 BACNET CONTROLLER, STARTER, AND CONDENSATE PUMP.

2. MECHANICAL CONTRACTOR / TEMPERATURE CONTROLS CONTRACTOR TO PROVIDE 14GA/2 SHIELDED WIRE BETWEEN IU AND OU (IU-1 -& IU-2).

3. MECHANICAL /CONTRACTOR / TEMPERATURE CONTROLS CONTRACTOR TO PROVIDE UNIT DISCONNECT.

٥.	MILCI	INITIONL /
4.	LOW	AMBIENT

	OUTDOO	R UN	IIT -	HEAT	PU	MP	SC	HEC	ULE	(10	OUTDOOR UNIT - HEAT PUMP SCHEDULE (105 F AMBIENT)										
				COMPRES	SSORS	FAN	NS	ELECTR	ICAL CHAR	ACTER	ISTICS										
MARK	ROOMS SERVING	UNIT SERVED	CAP. MBH	NUMBER	RLA	w	CFM	VOLTS	PHASE	Hz	SEER	MCA	МОР	NOMINAL TONS	WEIGHT LBS	MANUFACTURER & MODEL NUMBER					
0U-1	IT CLOSET	IU-1	12.6	1	7		PER MFG	208	1	60	23.5	10	15	1.0	90	LG-LSU090HSV5					
0U-2	IT CLOSET	IU-1	18.0	1	9.6		PER MFG	208	1	60	23.5	13	20	1.5	130	LG-LSU180HSV5					

NOTES: 1. PROVIDE W/ BEAR FOOT ROOF STANDS (FOR OU-1)
2. PROVIDE W/ MANUFACTURER'S CRC1 BACNET CONTROLLER, STARTER, UNIT DISCONNECT, AND OUTDOOR MOUNTING APPLICATION.
3. PROVIDE W/ LOW AMBIENT (0°F) — WIND BAFFLE.

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CIVIL ENGINEER

and Duplette **Brush Park Duplet**On Edmund Place
Between Brush St. a
Detroit MI, 48201

05/15/2020 100% CD / PERMIT SET

THE CONTRACTOR IS RESPONSIBLE FOR MATERIALS, DETAILS AND ACCURACY, FOR ALL QUANTITIES AND DIMENSIONS, FOR SELECTING FABRICATION PROCESSES, FOR TECHNIQUES OF ASSEMBLY, FOR PERFORMING WORK IN A SAFE MANNER, AND FOR COORDINATING WORK WITH THAT OF ALL TRADES

JOB NO.: AS NOTED SCALE: 05/15/2020 DATE:

DRAWING TITLE

MECHANICAL SCHEDULES

SHEET NO.

M-501

MECHANICAL ABBREVIATIONS

AC	AIR CONDITIONING	ID	INSIDE DIAMETER
ACCU	AIR COOLED CONDENSING UNIT	INSUL	INSULATION/INSULATE
ACU	AIR CONDITIONING UNIT	INV	INVERT
AFF	ABOVE FINISHED FLOOR		
AHU	AIR HANDLING UNIT	KIT	KITOLIEN
		KW	KITCHEN KILOWATT
ALT	ALTERNATIVE	13.00	NEO WATT
AMB	AMBIENT	ı	LENOTH /LONG
AP	ACCESS PANEL	L LAV	LENGTH/LONG LAVATORY
APPROX	APPROXIMATE	LP	LIQUID PETROLEUM
AR	ACID RESISTANT	LPR	LOW PRESSURE STEAM RETURN
ARCH	ARCHITECT(URAL)	LPS	LOW PRESSURE STEAM SUPPLY
ARV	AIR RELIEF VALVE	LVR	LOUVER
ATV AUTO	AIR TURNING VANES AUTOMATIC		
B-#	BOILER		
BD	BAROMETRIC DAMPER	M	METER
BDD	BACKDRAFT DAMPER	MAX MECH	MAXIMUM MECHANICAL
BHP	BREAK HORSEPOWER	MFR	MANUFACTURER
BLDG	BUILDING	MIN	MINIMUM
BOD	BOTTOM OF DUCT	MISC	MISCELLANEOUS
вот	ВОТТОМ	MPR	MEDIUM PRESSURE STEAM RETURN
CA	COMPRESSED AIR	MPS	MEDIUM PRESSURE STEAM SUPPLY
CAB CD-#	CABINET CEILING DIFFUSER	MTD	MOUNTED
CIA	COMBUSTION INTAKE AIR	NIC	NOT IN CONTRACT
CFM	CUBIC FEET PER MINUTE	NO/#	NUMBER
CHWR	CHILLED WATER RETURN	NOM	NOMINAL
CHWS	CHILLED WATER SUPPLY	NTS	NOT TO SCALE
CHWP	CHILLED WATER PUMP	(N)	NEW
CL	CENTERLINE	OA	OUTSIDE AIR
CLG	CEILING	OC	ON CENTER
C.O.	CLEAN OUT	OD	OUTSIDE DIAMETER
COL CONC	COLUMN CONCRETE	ORD-#	OVERFLOW ROOF DRAIN
COND	CONDENSER(ATE)	O.E.D.	OPEN END DUCT
	·	PREFAB	PREFABRICATED
C.O.T.G.	CLEANOUT TO GRADE	PRV	
CRTN	LOW PRESSURE STEAM CONDENSATE	PSI	POUNDS PER SQUARE INCH
CPD	CONDENSATE PUMP DISCHARGE	PVC	
CPRSR	COMPRESSOR	P.E.	POLYETHYLENE
CT-#	COOLING TOWER		
CUH-#		R/RAD	RADIUS
CWD	COLD WATER (DOMESTIC)	RA	RETURN AIR
CWP CWR	CONDENSER WATER PUMP CONDENSER WATER RETURN	RG-#	RETURN AIR GRILLE
CWS	CONDENSER WATER SUPPLY	RD-#	
D	DEPTH/DEEP	REQ'D	
DB	DRY BULB TEMPERATURE	RL RM	REFRIGERANT LIQUID ROOM
DIA/ø	DIAMETER	RM RP	RADIANT PANEL
DIFF	DIFFUSER	RPM	
DISCH	DISCHARGE	RS	REFRIGERANT SUCTION
DWG	DRAWING	(R)	
DWH	DOMESTIC WATER HEATER	RC	RAIN CONDUCTOR
EF-#	EXHAUST FAN	SA	SUPPLY AIR
EFF	EFFICIENCY	SCHED SD-#	SCHEDULE SUPPLY DIFFUSER
EG-#		SG-#	
EL ELEC	ELEVATION ELECTRIC(AL)	SP	
ELEV	ELEVATOR		SPECIFICATION(S)
EMER	EMERGENCY	STD	STANDARD
EQUIP	EQUIPMENT		
EXH	EXHAUST	TC	TEMPERATURE CONTROL
EXIST	EXISTING	TEMP	TEMPERATURE
EXP	EXPANSION	TYP	TYPICAL
EXT (E)	EXTERIOR EXISTING		
		UH-#	UNIT HEATER
	FLOAT AND THERMOSTATIC TRAP	UON	UNLESS OTHERWISE NOTED
**	FAN COIL UNIT COMBINATION FIRE/SMOKE DAMPER	UV	UNIT VENTILATOR
	FLOOR DRAIN	U/G	UNDERGROUND
••	FIRE DAMPER	V	VENT
	FLUE EXHAUST VENT	V VA	VALVE
•	FINISH FLOOR	VAC	VACUUM
FLR	FLOOR	VAV	VARIABLE AIR VOLUME
FP	FIRE PROTECTION	VB	VACUUM BREAKER
FPM	FEET PER MINUTE	VD	VOLUME DAMPER
FT FUR-#	FEET FURNACE	VEL	VELOCITY
ruk-# G	GAS (NATURAL)	VIF VTR	VERIFY IN FIELD VENT-THRU-ROOF
G GA	GAUGE	VIR WB	VARIABLE VOLUME BOX
GAL	GALLON	WF	VARIABLE VOLUME—FAN POWERED
GALV	GALVANIZE(D)	WR .	VARIABLE VOLUME—REHEAT
GPM	GALLONS PER MINUTE		
		w	WIDE/WIDTH
Н	HEIGHT/HIGH	w W/	WITH
HHWR	HEATING HOT WATER RETURN	w/o	WITHOUT
HHWS	HEATING HOT WATER BUNAR	WB	WET BULB TEMPERATURE
HHWP HP	HEATING HOT WATER PUMP HORSEPOWER	WC-#	WATER CLOSET
HPR	HIGH PRESSURE STEAM RETURN	W.C.O.	WALL CLEANOUT
HPS	HIGH PRESSURE STEAM SUPPLY	WCC	WATER COOLED CHILLER
HRU	HEAT RECOVERY UNIT	WH-#	WATER HEATER
HVAC	HEATING/VENTILATING/AIR CONDITIONING		
HW	HOT WATER (DOMESTIC)		

HOT WATER RETURN (DOMESTIC)

PLUMBING/PIPING SYMBOLS

SYMBOL	DESCRIPTION
——XX	GLOBE VALVE
—⊣б⊢—	FULL PORT BALL VALVE
$\overrightarrow{\nabla}$	CHECK VALVE
$\overline{\hspace{1cm}}$	BALANCING VALVE
	BALANCE VALVE W/ TEST PORTS
<u>s</u>	SOLENOID VALVE
<u> </u>	MOTOR OPERATED VALVE
— − − − − − − − − − − − − − − − − − − −	PLUG VALVE
<u> </u>	THREE WAY CONTROL VALVE
────	TWO WAY CONTROL VALVE
——————————————————————————————————————	BUTTERFLY VALVE
X	PRESSURE REGULATOR VALVE
	PRESSURE RELIEF VALVE
	THERMOMETER
- 	STRAINER
	UNION
<u> </u>	PRESSURE GAGE WITH COCK
	FLEXIBLE CONNECTOR
'///////////////////////////////////	REMOVE EXISTING SERVICE
•	CONNECT TO EXISTING
•	CAP OFF EXISTING
<u> </u>	PIPE TURNED UP
<u> </u>	PIPE TURNED DOWN
	PIPE OUT TOP
<u></u>	PIPE OUT BOTTOM
	DOMESTIC COLD WATER PIPING
	DOMESTIC HOT WATER PIPING
	DOMESTIC HOT WATER RETURN PIPIN
	VENT PIPING
——FP——	FIRE PROTECTION PIPING
——FDCP——	FIRE DEPARTMENT CONNECTION PIPI
——NG——	NATURAL GAS PIPING
ORC	OVERFLOW RAIN CONDUCTOR PIPING
RC	RAIN CONDUCTOR PIPING
——SAN——	SANITARY PIPING
——st——	STORM PIPING
—— AW ——	ACID WASTE PIPING
AW	ACID VENT PIPING



CAUTION !!!

THE LOCATIONS AND ELEVATIONS OF EXISTING UNDERGROUND UTILITIES AS SHOWN ON THIS DRAWING ARE ONLY APPROXIMATE. NO GUARAN-TEE IS EITHER EXPRESSED OR IMPLIED AS TO THE COMPLETENESS OR ACCURACY THEREOF. THE CONTRACTOR SHALL BE EXCLUSIVELY RE-SPONSIBLE FOR DETERMINING THE EXACT UTIL-ITY LOCATIONS AND ELEVATIONS PRIOR TO THE START OF CONSTRUCTION.

	PLUMBING DRAWING INDEX	
SHT No.	SHEET TITLE	SCALE
P-000	PLUMBING LEGEND, SYMBOLS, AND ABBREVIATIONS	NO SCALE
P-100	PLUMBING UNDERGROUND PLAN	1/8"=1'-0"
P-101	PLUMBING BASEMENT PLAN	1/8"=1'-0"
P-102	PLUMBING FIRST FLOOR PLAN	1/8"=1'-0"
P-103	PLUMBING FIRST FLOOR PLAN	1/8"=1'-0"
P-104	PLUMBING FIRST FLOOR PLAN	1/8"=1'-0"
P-105	PLUMBING FIRST FLOOR PLAN	1/8"=1'-0"
P-106	PLUMBING ROOF PLAN	1/8"=1'-0"
P-200	ENLARGED PLAN	1/8"=1'-0"
P-300	NATURAL GAS PLANS	1/16"=1'-0"
P-400	PLUMBING DETAILS	NO SCALE
P-500	PLUMBING DIAGRAMS	NO SCALE
P-600	PLUMBING SCHEDULES	NO SCALE
P-601	PLUMBING SCHEDULES	NO SCALE
P-700	FIRE PROTECTION PLAN	1/16"=1'-0"

PLUMBING GENERAL NOTES.

- 1. SEE ARCHITECTURAL DRAWINGS FOR EXACT LOCATION OF ALL PLUMBING FIXTURES.
- 2. COORDINATE ALL LOCATION, SIZE AND ELEVATIONS OF ALL SLEEVES THROUGH WALLS AND SLABS WITH STRUCTURAL AND ARCHITECTURAL DRAWINGS.
- 3. COORDINATE NEW PIPING WITH EXISTING SITE CONDITIONS, EQUIPMENT MANUFACTURERS, AND ALL OTHER TRADES TO AVOID INTERFERENCES.
- 4. PROVIDE ACCESS AROUND ALL NEW EQUIPMENT PER MANUFACTURERS
- RECOMMENDATIONS.
- 5. ALL CORING THROUGH FLOORS SHALL BE BY MECHANICAL CONTRACTOR.
- 6. ALL PIPING SHALL BE ROUTED AS HIGH AS POSSIBLE, UNLESS OTHERWISE NOTED. COORDINATE ROUTING WITH OTHER TRADES TO AVOID INTERFERENCES.
- 7. ALL PIPING SHALL BE INSULATED PER SPECIFICATIONS.
- 8. ALL PIPING SHALL BE CONCEALED IN WALLS AND/OR CEILING SPACE.
- 9. SEAL ALL PENETRATIONS THROUGH WALLS AND FLOORS. REFER TO SPECIFICATIONS.
- 10. THE LOCATIONS AND ELEVATIONS OF EXISTING UNDERGROUND UTILITIES AS SHOWN ON THIS DRAWING ARE APPROXIMATE. NO GUARANTEE IS EITHER EXPRESSED OR IMPLIED AS TO THE COMPLETENESS OR ACCURACY THEREOF.
- 11. CONTRACTOR SHALL MAINTAIN ADEQUATE CLEARANCES (PER N.E.C.) ABOVE AND AROUND ELECTRICAL PANELS, EQUIPMENT AND TRANSFORMERS WHEN ROUTING OVERHEAD DOMESTIC WATER, SANITARY AND STORM PIPING.
- 12. FAUCETS AND PLUMBING FIXTURES SHALL BE OF WATER CONSERVATION TYPE AND COMPLY WITH THE STATE ENERGY STANDARDS.
- 13. RUN ALL SANITARY PIPING LARGER THAN 2" AT 1/8" PER FOOT, MINIMUM SLOPE, UNLESS NOTED OTHERWISE.
- 14. COORDINATE INTERRUPTIONS OF SERVICES INCLUDING WATER, SEWER AND NATURAL GAS WITH OWNER AND UTILITY COMPANIES A MINIMUM OF 72 HOURS IN ADVANCE OF ALTERATIONS.
- 15. ALL CONTROL, ISOLATION, AND BALANCE VALVES MUST BE NO MORE THAN 3'-6" FROM TOP OF CEILING TO BOTTOM OF VALVES.
- 16. PEX LINES ARE TO BE USED FOR WATER SUPPLY WITHIN WALLS, AND COPPER MAINS AND WHERE PIPING IS VISIBLE OUTSIDE OF WALL.

FIRE PROTECTION NOTES:

- 1. THE FIRE PROTECTION CONTRACTOR SHALL DESIGN, FABRICATE, INSTALL, AND SECURE REQUIRED APPROVALS OF A COMPLETE FIRE PROTECTION AUTOMATIC SPRINKLER SYSTEM IN ACCORDANCE WITH PERTINENT REQUIREMENTS OF THE FIRE RATING BUREAU AND GOVERNMENTAL AGENCIES HAVING JURISDICTION. (SYSTEM SHALL INCLUDE BOTH WET AND DRY SPRINKLERS)
- 2. PROVIDE A HYDRAULICALLY DESIGNED AUTOMATIC SPRINKLER SYSTEM BASED ON THE MOST RECENT FLOW TESTS. CONTRACTOR SHALL PERFORM FLOW TEST (WITNESSED BY FIRE MARSHALL) PRIOR TO ANY CALCULATIONS. ALL COSTS ASSOCIATED WITH FLOW TESTING SHALL BE INCLUDED IN CONTRACTOR'S BASE BID.
- 3. THE ENTIRE BUILDING SHALL BE PROTECTED WITH A WET PIPE SPRINKLER AND DRY PIPE SYSTEM DESIGNED FOR A DENSITY OF 0.10 GPM/SQ. FT. FOR THE MOST REMOTE 1,500 SQUARE FEET FOR LIGHT HAZARD OCCUPANCY. MECHANICAL ROOMS AND STORAGE ROOMS SHALL BE DESIGNED FOR A DENSITY OF 0.2 GPM/S.F. FOR THE MOST REMOTE 1,500 S.F. FOR ORDINARY HAZARD.
- 4. PIPING ELEVATIONS MUST BE COORDINATED WITH ALL OTHER TRADES.
- 5. COORDINATE SPRINKLER HEAD LOCATIONS WITH ARCHITECTURAL REFLECTED CEILING PLANS.
- 6. ALL WORK SHALL COMPLY WITH NATIONAL, STATE AND LOCAL CODES, ORDINANCES AND REGULATIONS.
- 7. SUBMIT SHOP DRAWINGS SHOWING PIPING LAYOUT AND PROPOSED HEAD
- LOCATIONS FOLLOWING REVIEW AND APPROVAL BY LOCAL FIRE MARSHAL.
- 8. FIRE PROTECTION CONTRACTOR MAY HAVE TO OVERSIZE MAIN PIPING IN ORDER TO PROVIDE RESIDUAL REQUIRED AT MOST REMOTE SPRINKLER HEAD.
- 9. SPRINKLERS SHALL BE 1/2" ORIFICE CONCEALED PENDENT TYPE IN ALL AREAS WITH CEILINGS AND UPRIGHT TYPE WHERE NO CEILING IS INSTALLED.
- 10. PROVIDE CONCEALED TYPE PENDANT HEADS IN ALL CEILINGS (HARD OR LAY-IN) COORDINATE SPRINKLER HEAD LOCATIONS WITH CEILING DIFFUSERS, GRILLES, REGISTERS, SPEAKERS AND LIGHTING FIXTURES.
- 11. AREAS WITH LAY-IN CEILING TO HAVE CONCEALED SPRINKLER HEADS LOCATED
- AT CENTER OF TILE. 12. CONTRACTOR SHALL FURNISH AS-BUILT DRAWINGS OF FINAL INSTALLATION.
- 13. CONTRACTOR SHALL BE RESPONSIBLE DURING INSTALLATION AND TESTING FOR ANY DAMAGE CAUSED BY LEAKS.

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MECHANICAL ENGINEER

CIVIL ENGINEER

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05/15/2020 100% CD / PERMIT SET


THE CONTRACTOR IS RESPONSIBLE FOR MATERIALS, DETAILS AND ACCURACY, FOR ALL QUANTITIES AND DIMENSIONS, FOR SELECTING **FABRICATION PROCESSES, FOR** TECHNIQUES OF ASSEMBLY, FOR PERFORMING WORK IN A SAFE MANNER, AND FOR COORDINATING WORK WITH THAT OF ALL TRADES

JOB NO.: AS NOTED 05/15/2020

DRAWING TITLE

PLUMBING LEGEND, SYMBOLS, AND **ABBREVIATIONS**

SHEET NO.

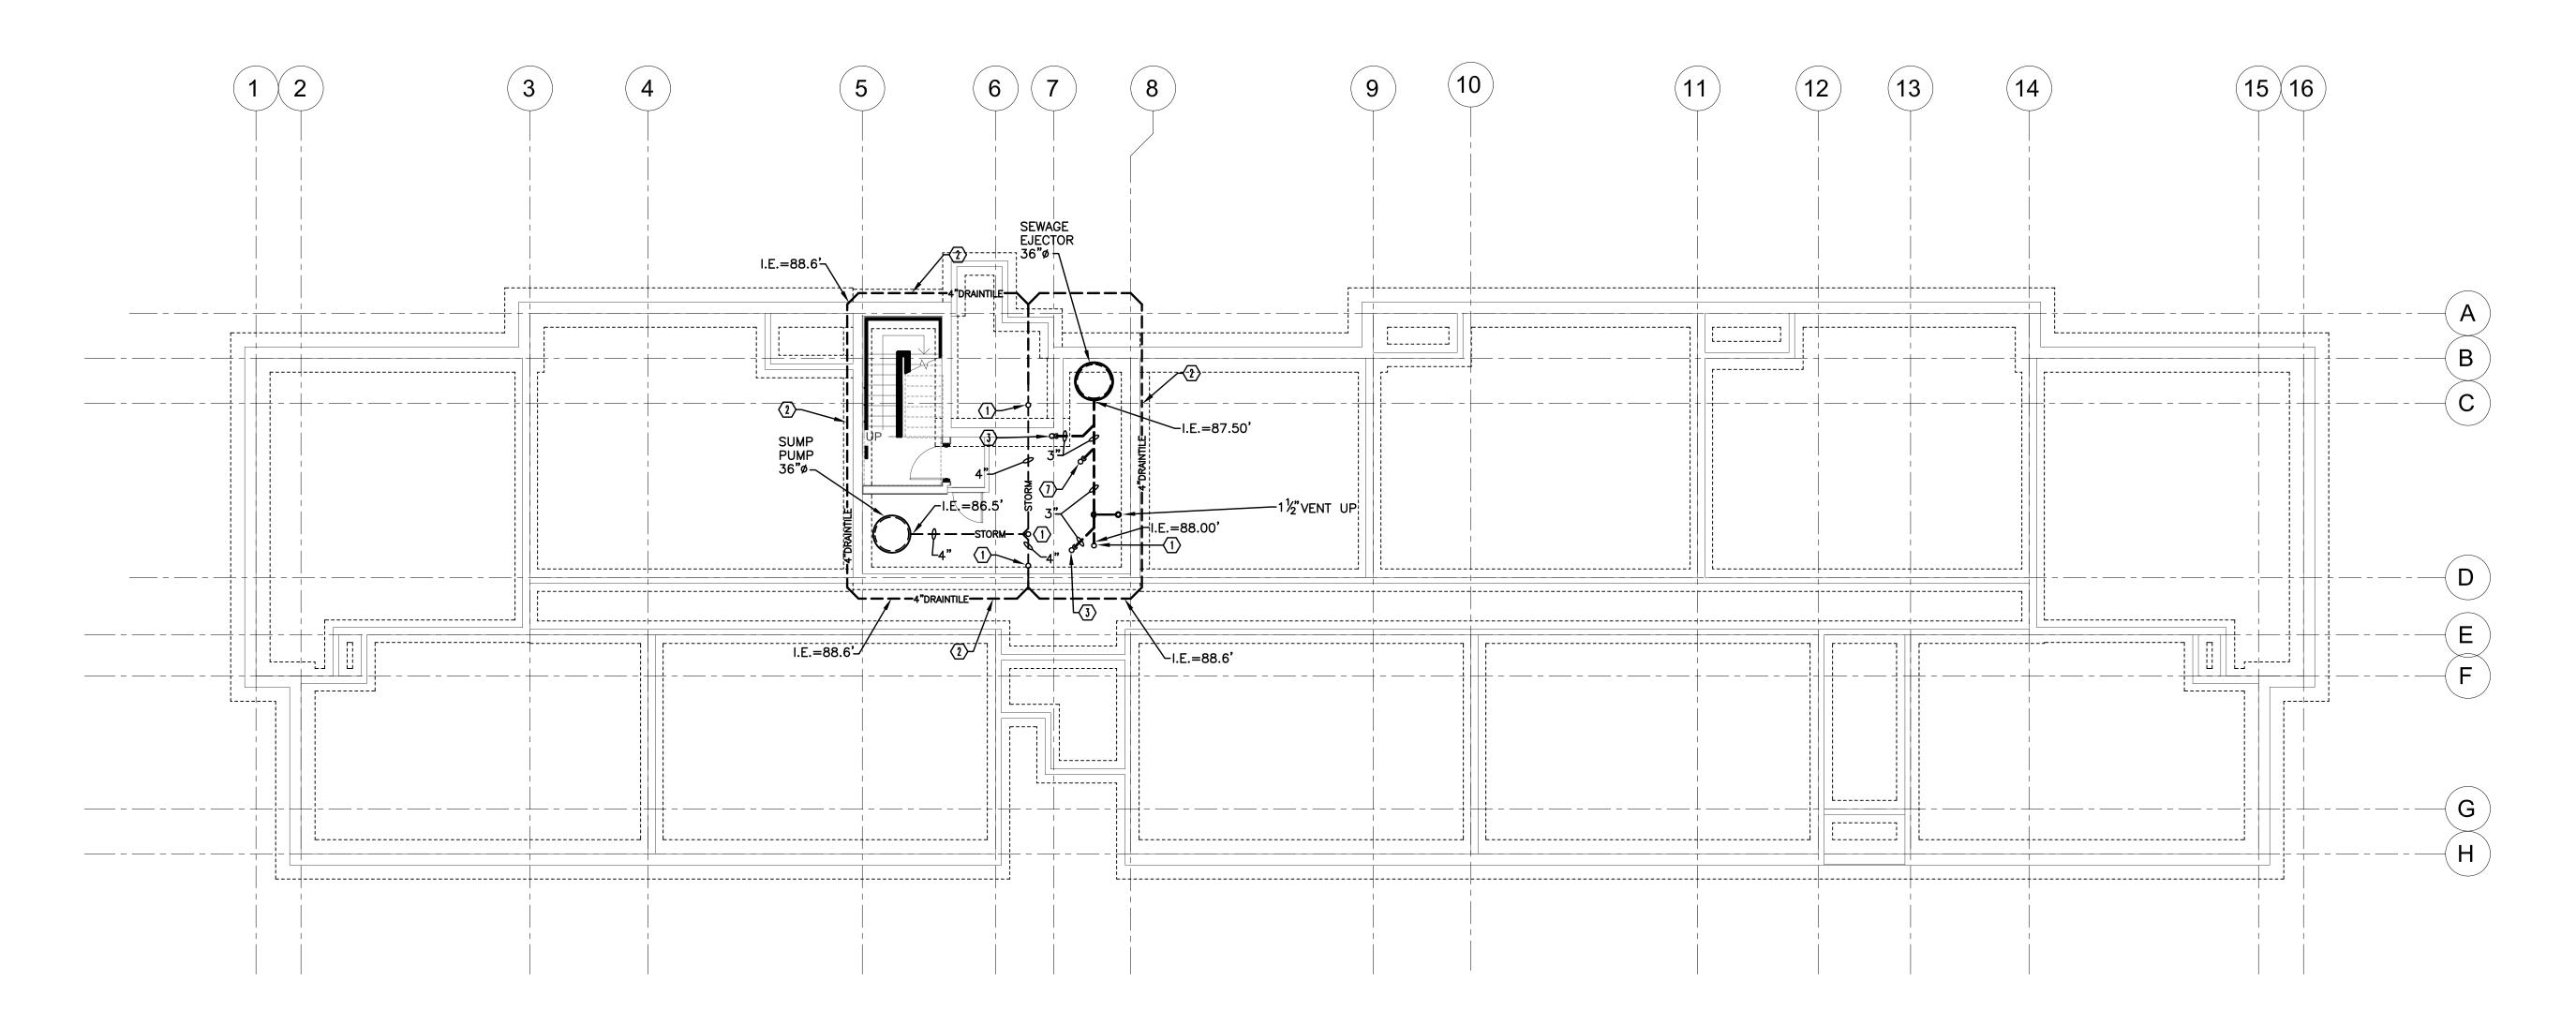

KEYED NOTES:

- 1 FLOOR CLEANOUT, FULL LINE SIZE BELOW 4" AND 4" SIZE ON PIPES 4" AND LARGER. COORDINATE COVER TYPE WITH ARCHITECTURAL ROOM FINISH SCHEDULE.
- 4" DRAIN TILE (BY PLUMBER) AROUND FOOTING AT BASEMENT FOOTING (REFER TO ARCHITECTURAL/STRUCTURAL FOR SECTION)
- 3 WASTE UP TO FD.



ASSUMED FINISHED FLOOR ELEV.=89.50" BASEMENT ASSUMED FINISHED FLOOR ELEV.=100.00' REGISTRATION



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Brush Park On Edmunc Between Br Detroit MI, ⁴

05/15/2020 100% CD / PERMIT SET

THE CONTRACTOR IS RESPONSIBLE FOR MATERIALS, DETAILS AND ACCURACY, FOR ALL QUANTITIES AND DIMENSIONS, FOR SELECTING FABRICATION PROCESSES, FOR TECHNIQUES OF ASSEMBLY, FOR PERFORMING WORK IN A SAFE MANNER, AND FOR COORDINATING **WORK WITH THAT OF ALL TRADES**


JOB NO.: AS NOTED SCALE: 05/15/2020

DRAWING TITLE

PLUMBING UNDERGROUND PLAN

SHEET NO.

P-100

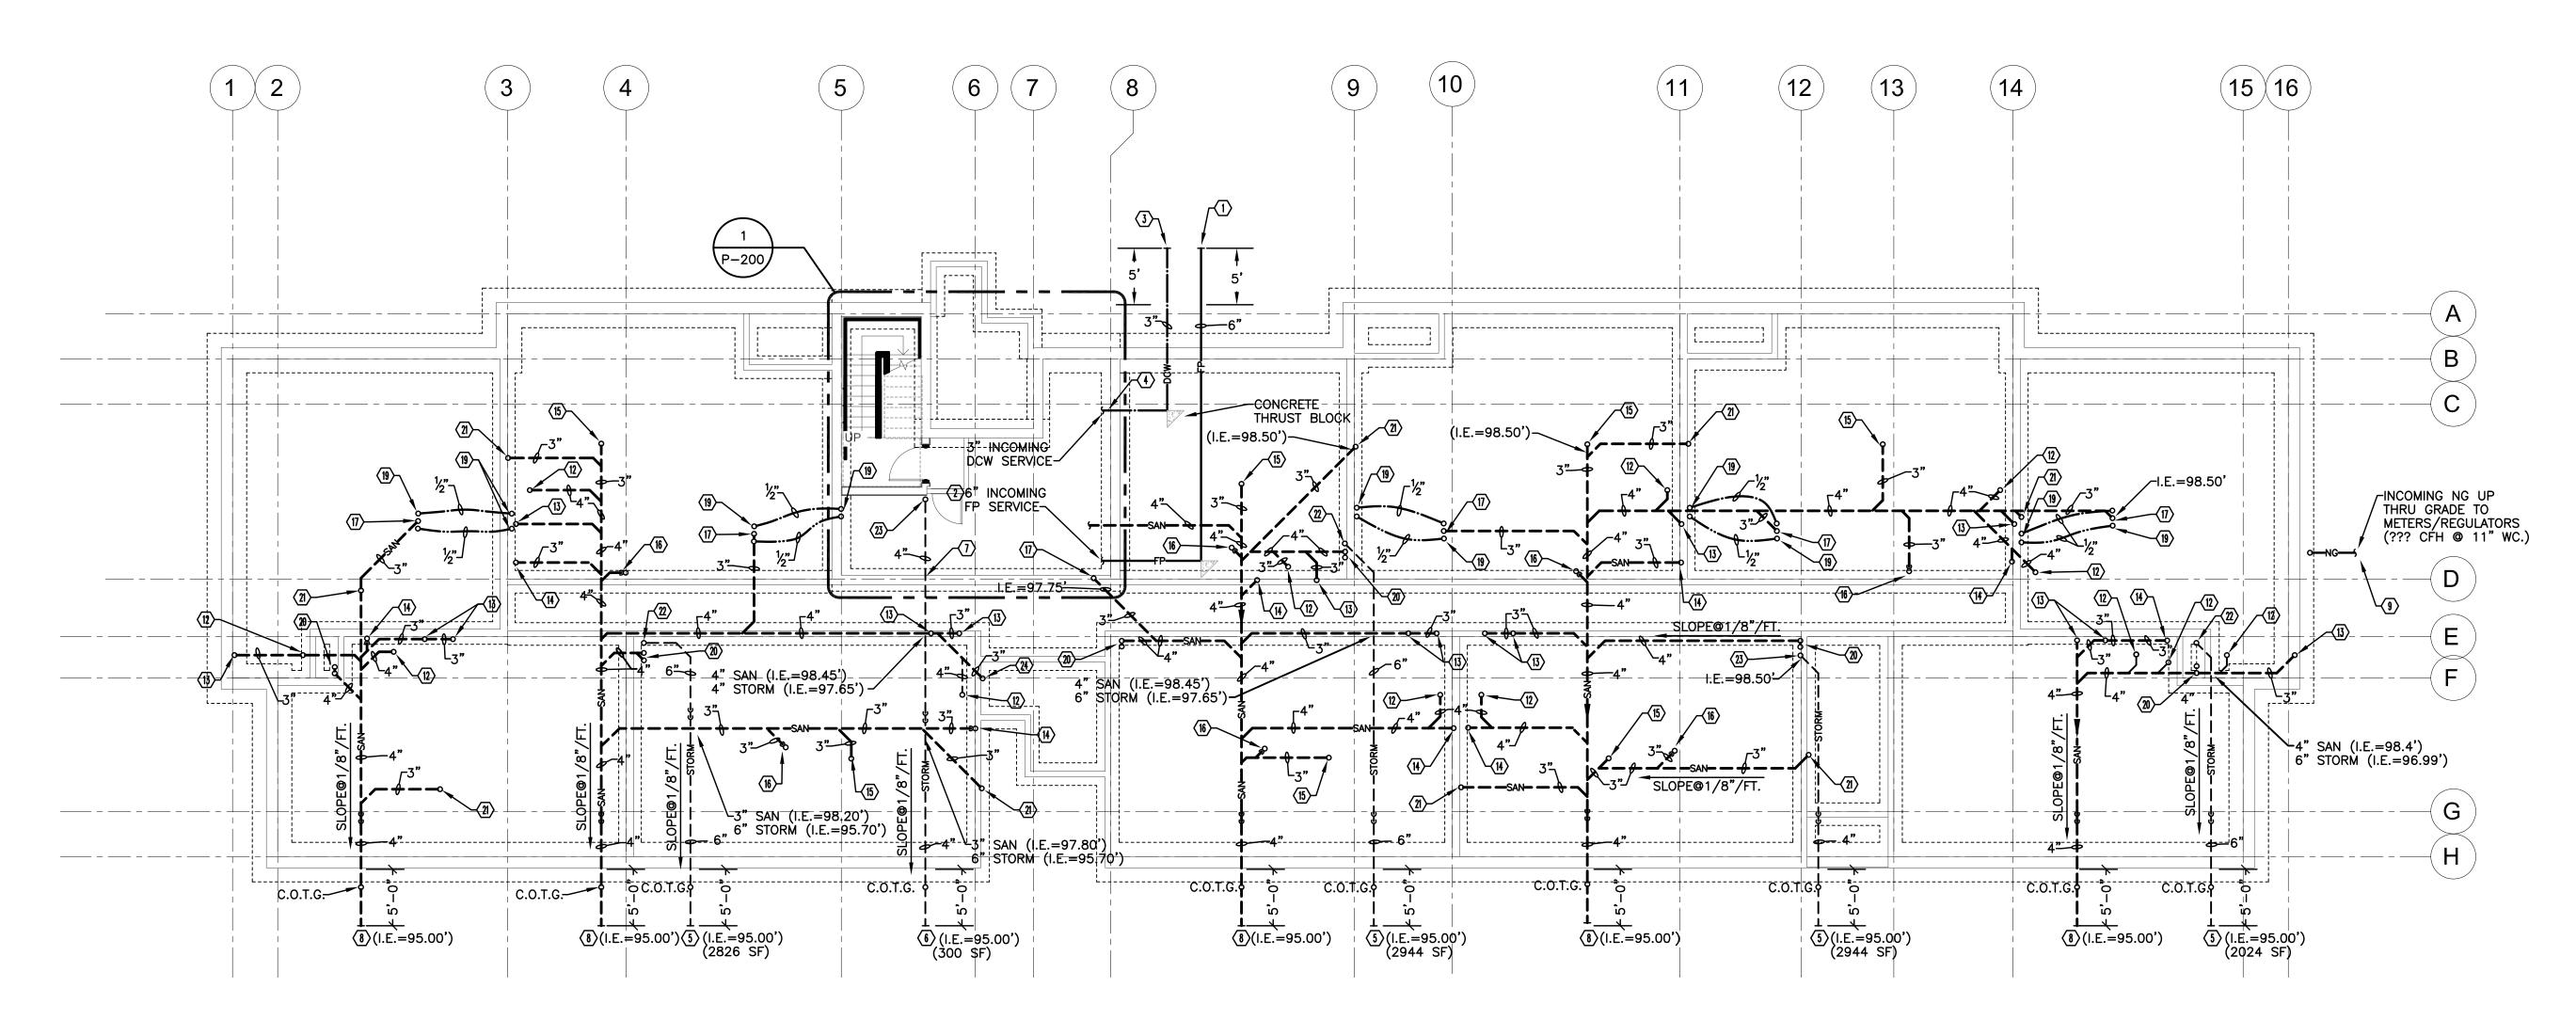

KEYED NOTES:

- (1) 6" UNDERGROUND DUCTILE IRON, CLASS 54, DOUBLE CEMENT LINED FIRE PROTECTION MAIN. COORDINATE EXACT LOCATION WITH CIVIL SITE UTILITIES PLAN AND MAINTAIN 5'-0" MINIMUM COVER OVER TOP OF PIPE.
- (2) 6" FP THRU SIDEWALL WITH LINK SEAL.
- 3 4" UNDERGROUND DUCTILE IRON, CLASS 54, DOUBLE CEMENT LINED DOMESTIC WATER SERVICE. COORDINATE EXACT LOCATION WITH CIVIL SITE UTILITIES PLAN AND MAINTAIN 5'-0" MINIMUM COVER OVER TOP OF PIPE.
- 3" DCW THRU SIDEWALL WITH LINK SEAL.
- 6" STORM TO 5'-0" FROM BUILDING. FINAL CONNECTION BY SITE CONTRACTOR. (I.E. & SF AS NOTED) PLUMBER TO PROVIDE (2)45° ELBOWS TO DROP ELEVATION AS NECESSARY TO MATCH SITE UTILITY LOCATION. COORD IN FIELD.
- 6 4" STORM TO 5'-0" FROM BUILDING. FINAL CONNECTION BY SITE CONTRACTOR. (I.E. & SF AS NOTED) PLUMBER TO PROVIDE (2)45° ELBOWS TO DROP ELEVATION AS NECESSARY TO MATCH SITE UTILITY LOCATION. COORD IN FIELD.
- (7) 4" STORM THRU SIDEWALL WITH LINK SEAL.
- 4" SANITARY SEWER TO 5'-0" FROM BLDG FINAL CONNECTION BY SITE CONTRACTOR. (DFU AND I.E. AS NOTED).
 PLUMBER TO PROVIDE (2)45 ELBOWS TO DROP ELEVATION AS NECESSARY TO MATCH SITE UTILITY LOCATION. COORD IN FIELD.
- UNDERGROUND NATURAL GAS SERVICE PIPING. PROVIDED BY LOCAL GAS PROVIDER.

- (11) FLOOR CLEANOUT, FULL LINE SIZE BELOW 4" AND 4" SIZE ON PIPES 4" AND LARGER. COORDINATE COVER TYPE WITH
- (11) 4" SANITARY THRU SIDEWALL WITH LINK SEAL.
- (12) 4" WASTE UP TO WC.
- (15) 2" WASTE UP TO WMO.
- 2" WASTE UP TO KS.
- (B) 3" WASTE UP TO SS.
- (20) 4" WASTE/2" VENT STACK
- 2 WASTE UP
- (24) 3" WASTE UP

- ARCHITECTURAL ROOM FINISH SCHEDULE.
- 3 2" WASTE UP TO LAV.
- (4) 2" WASTE UP TO SH/BT.
- (6) 2" WASTE UP TO FD.

- (19) 1/2" H. & CW UP
- ⟨22⟩ 6" RC UP
- ②3 3" RC UP

Duplette

a **1**

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and

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SELLINGER

05/15/2020 100% CD / PERMIT SET

THE CONTRACTOR IS RESPONSIBLE FOR MATERIALS, DETAILS AND ACCURACY, FOR ALL QUANTITIES AND DIMENSIONS, FOR SELECTING FABRICATION PROCESSES, FOR **TECHNIQUES OF ASSEMBLY, FOR** PERFORMING WORK IN A SAFE MANNER, AND FOR COORDINATING **WORK WITH THAT OF ALL TRADES**


18284 JOB NO.: **AS NOTED** SCALE: DATE: 05/15/2020

DRAWING TITLE

PLUMBING **BASEMENT PLAN**

SHEET NO.



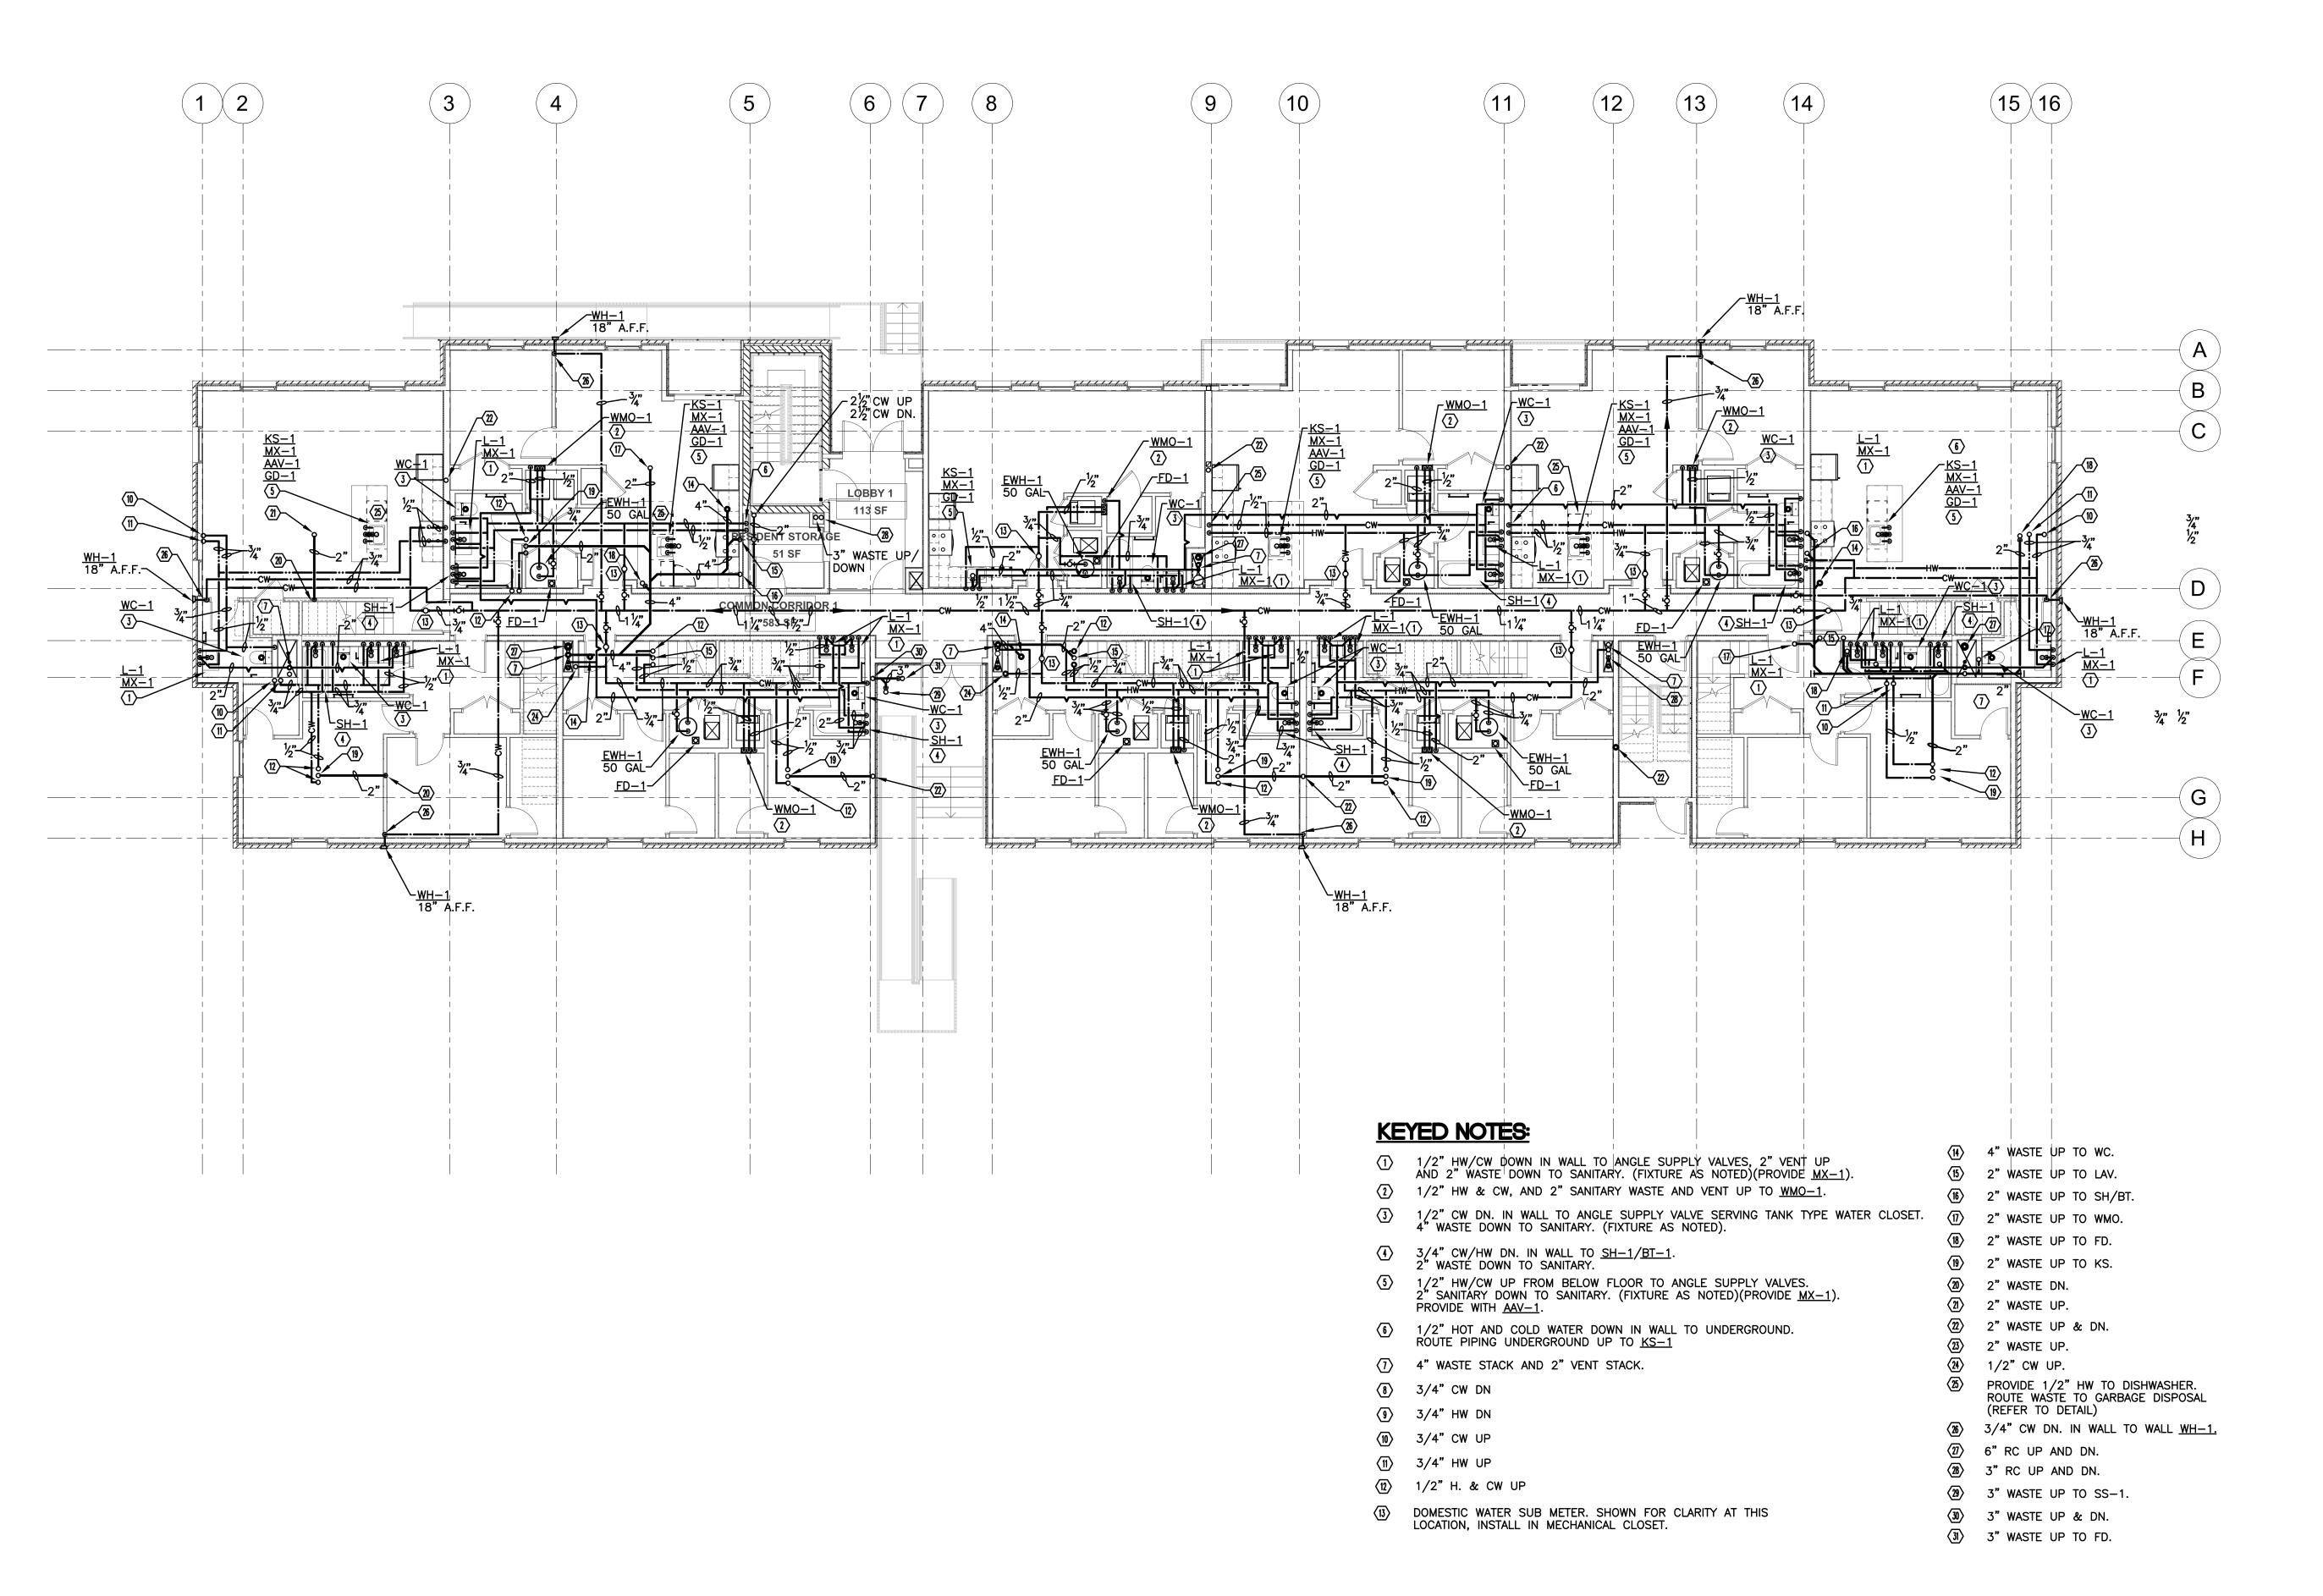

REGISTRATION



OWNER BRUSH PARK DEVELOPMENT COMPANY PHASE 1 LLC 1092 Woodward Ave. Detroit, MI 48226

ARCHITECT MERGE ARCHITECTS, INC. 332 CONGRESS ST. FLOOR 6 BOSTON, MA 02210 T: 617.670.0265

STRUCTURAL ENGINEER

MECHANICAL ENGINEER

SELLINGER ASSOCIATES, INC. 19821 FARMINGTON ROAD LIVONIA, MI 48152 T: 248 482 0045

ETS ENGINEERING, INC. 418-1/2 S. WASHINGTON BLVD. ROYAL OAK, MI 48067 T: 248 744 0360

CIVIL ENGINEER

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JOB NO.: AS NOTED 05/15/2020 DATE:

DRAWING TITLE

PLUMBING FIRST **FLOOR PLAN**

SHEET NO.


P-102

100% CD/ PERMIT SET



ASSUMED FINISHED FLOOR ELEV .= XXXX'

REFER TO ARCHITECTURAL DRAWINGS FOR BALCONY SCUPPER LOCATIONS.

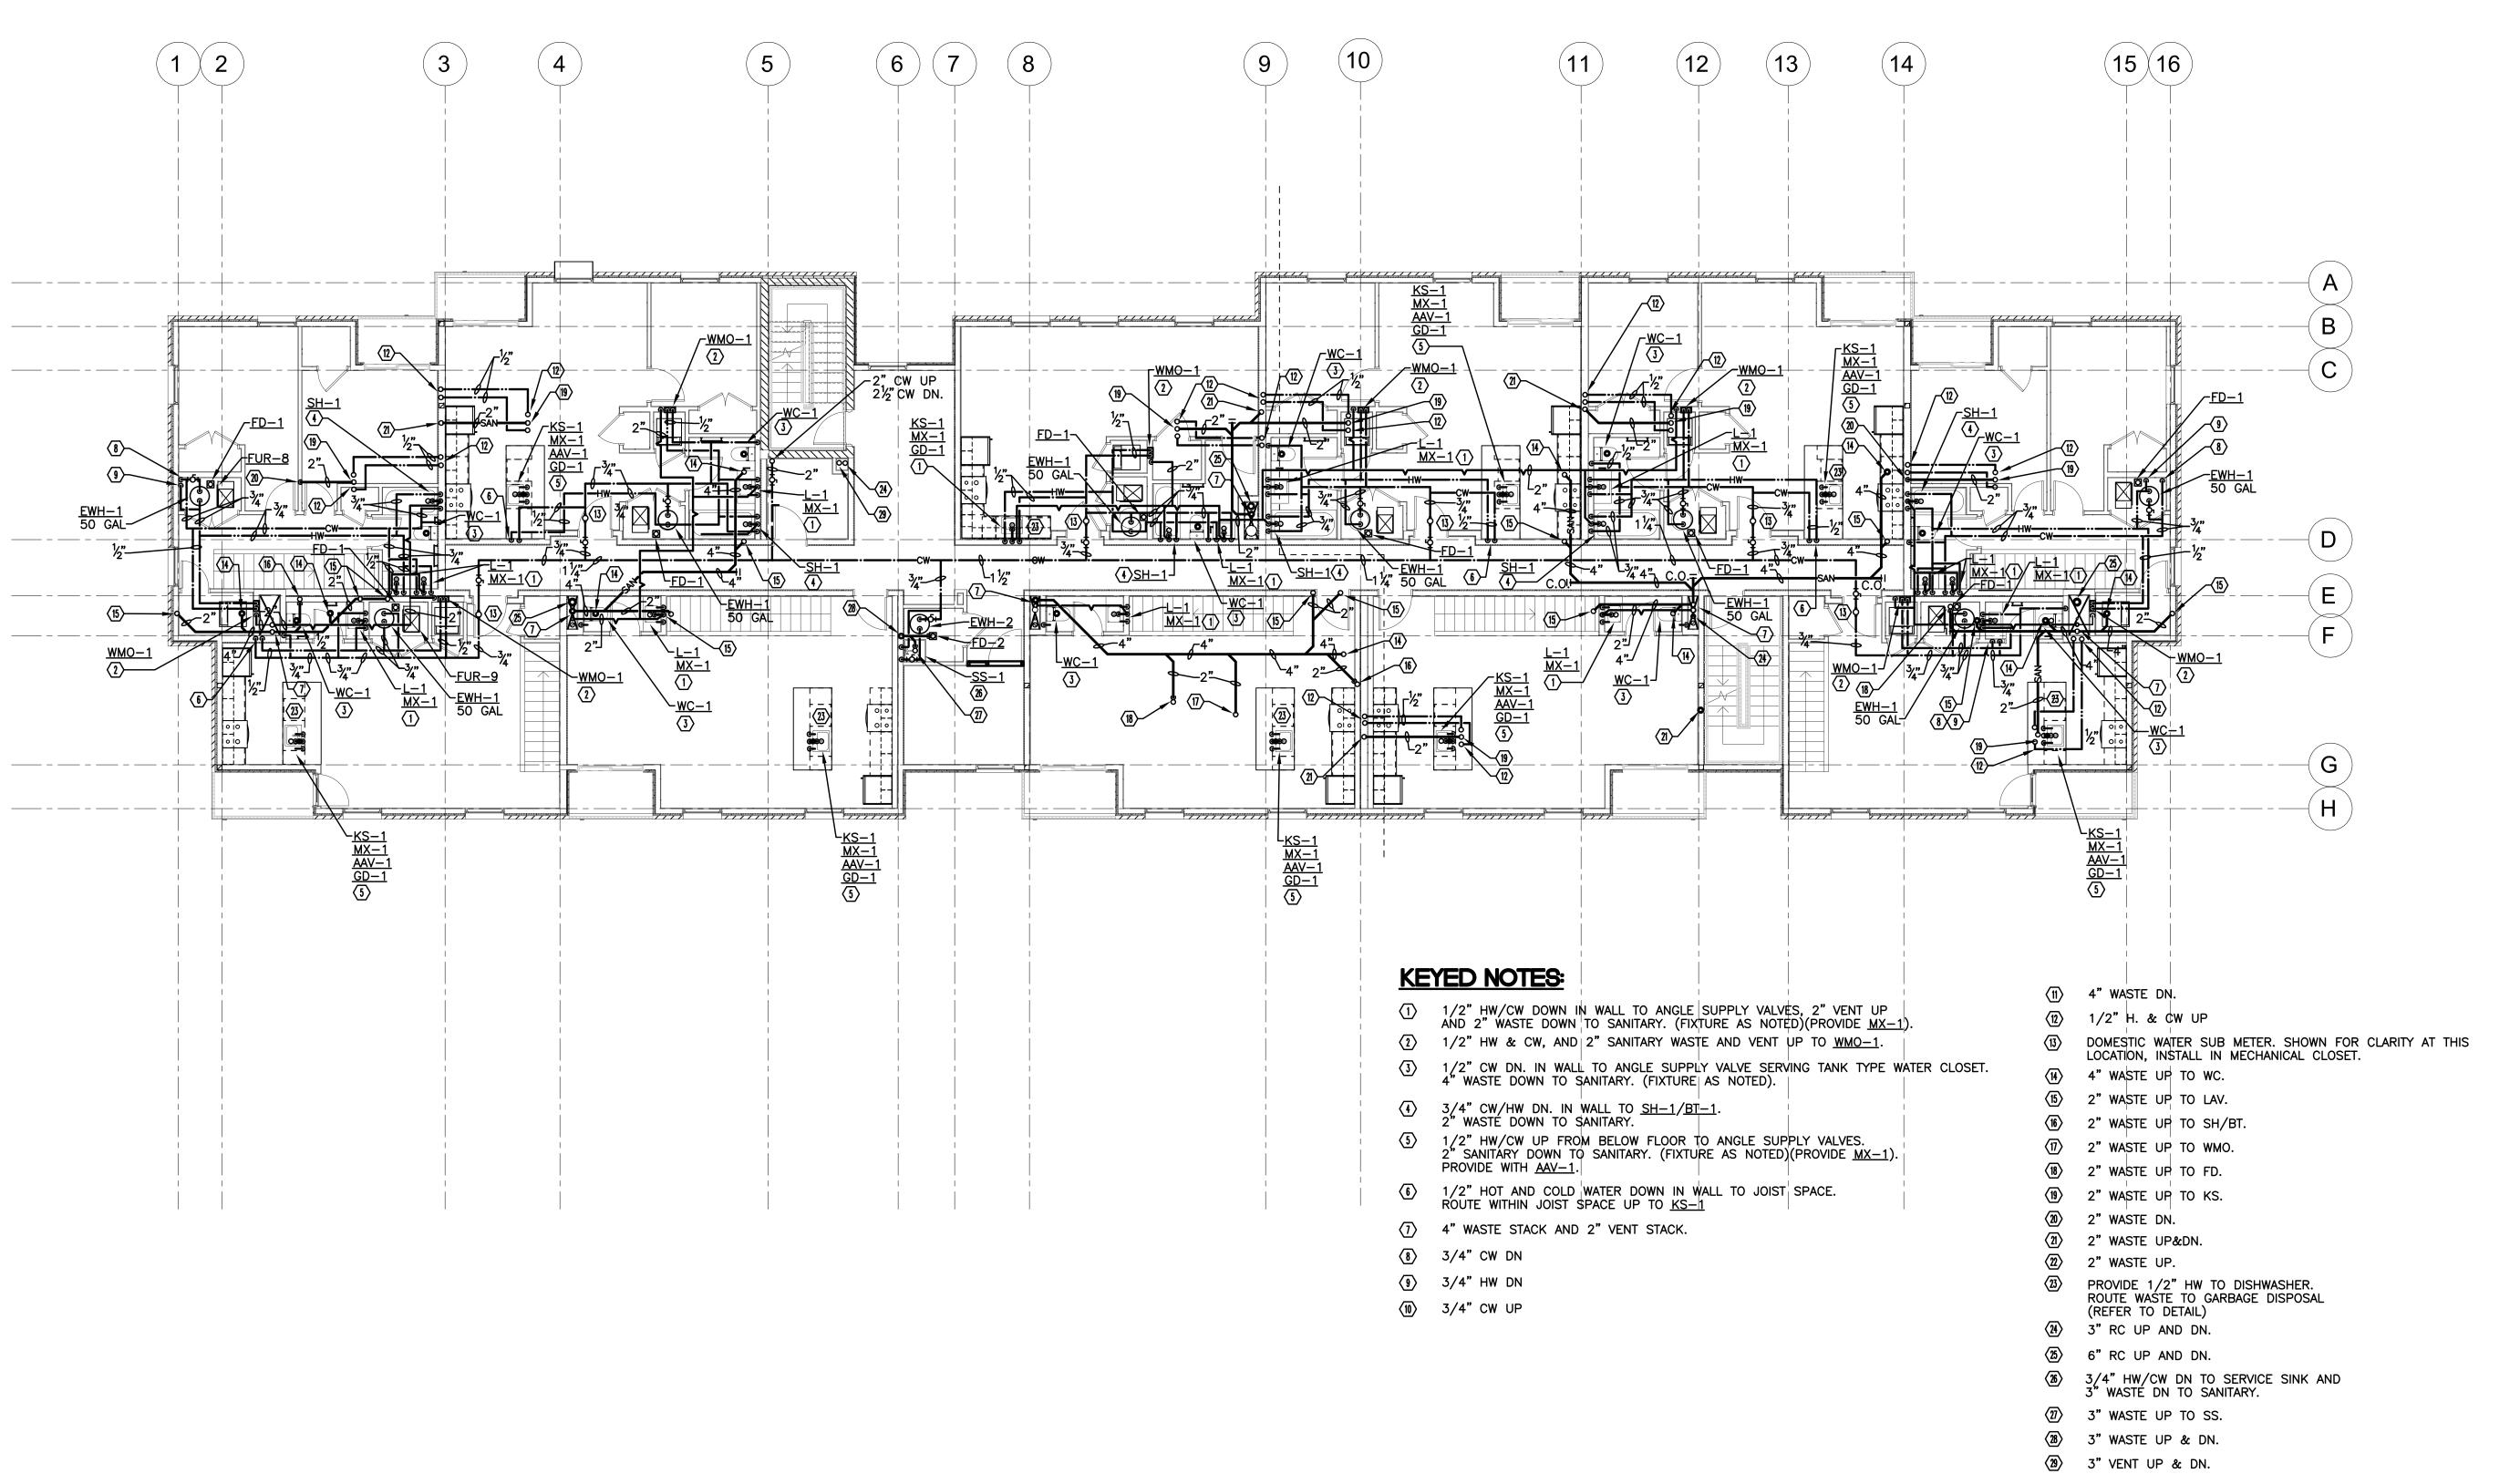





BRUSH PARK DEVELOPMENT COMPANY

ARCHITECT

MERGE ARCHITECTS, INC. 332 CONGRESS ST. FLOOR 6 BOSTON, MA 02210 T: 617.670.0265

STRUCTURAL ENGINEER

MECHANICAL ENGINEER

SELLINGER ASSOCIATES, INC. 19821 FARMINGTON ROAD LIVONIA, MI 48152 T: 248 482 0045

ETS ENGINEERING, INC. 418-1/2 S. WASHINGTON BLVD. ROYAL OAK, MI 48067 T: 248 744 0360

CIVIL ENGINEER

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JOB NO.: AS NOTED SCALE: 05/15/2020 DATE:


DRAWING TITLE

PLUMBING SECOND **FLOOR PLAN**

SHEET NO.

P-103

REFER TO ARCHITECTURAL DRAWINGS FOR BALCONY SCUPPER LOCATIONS.

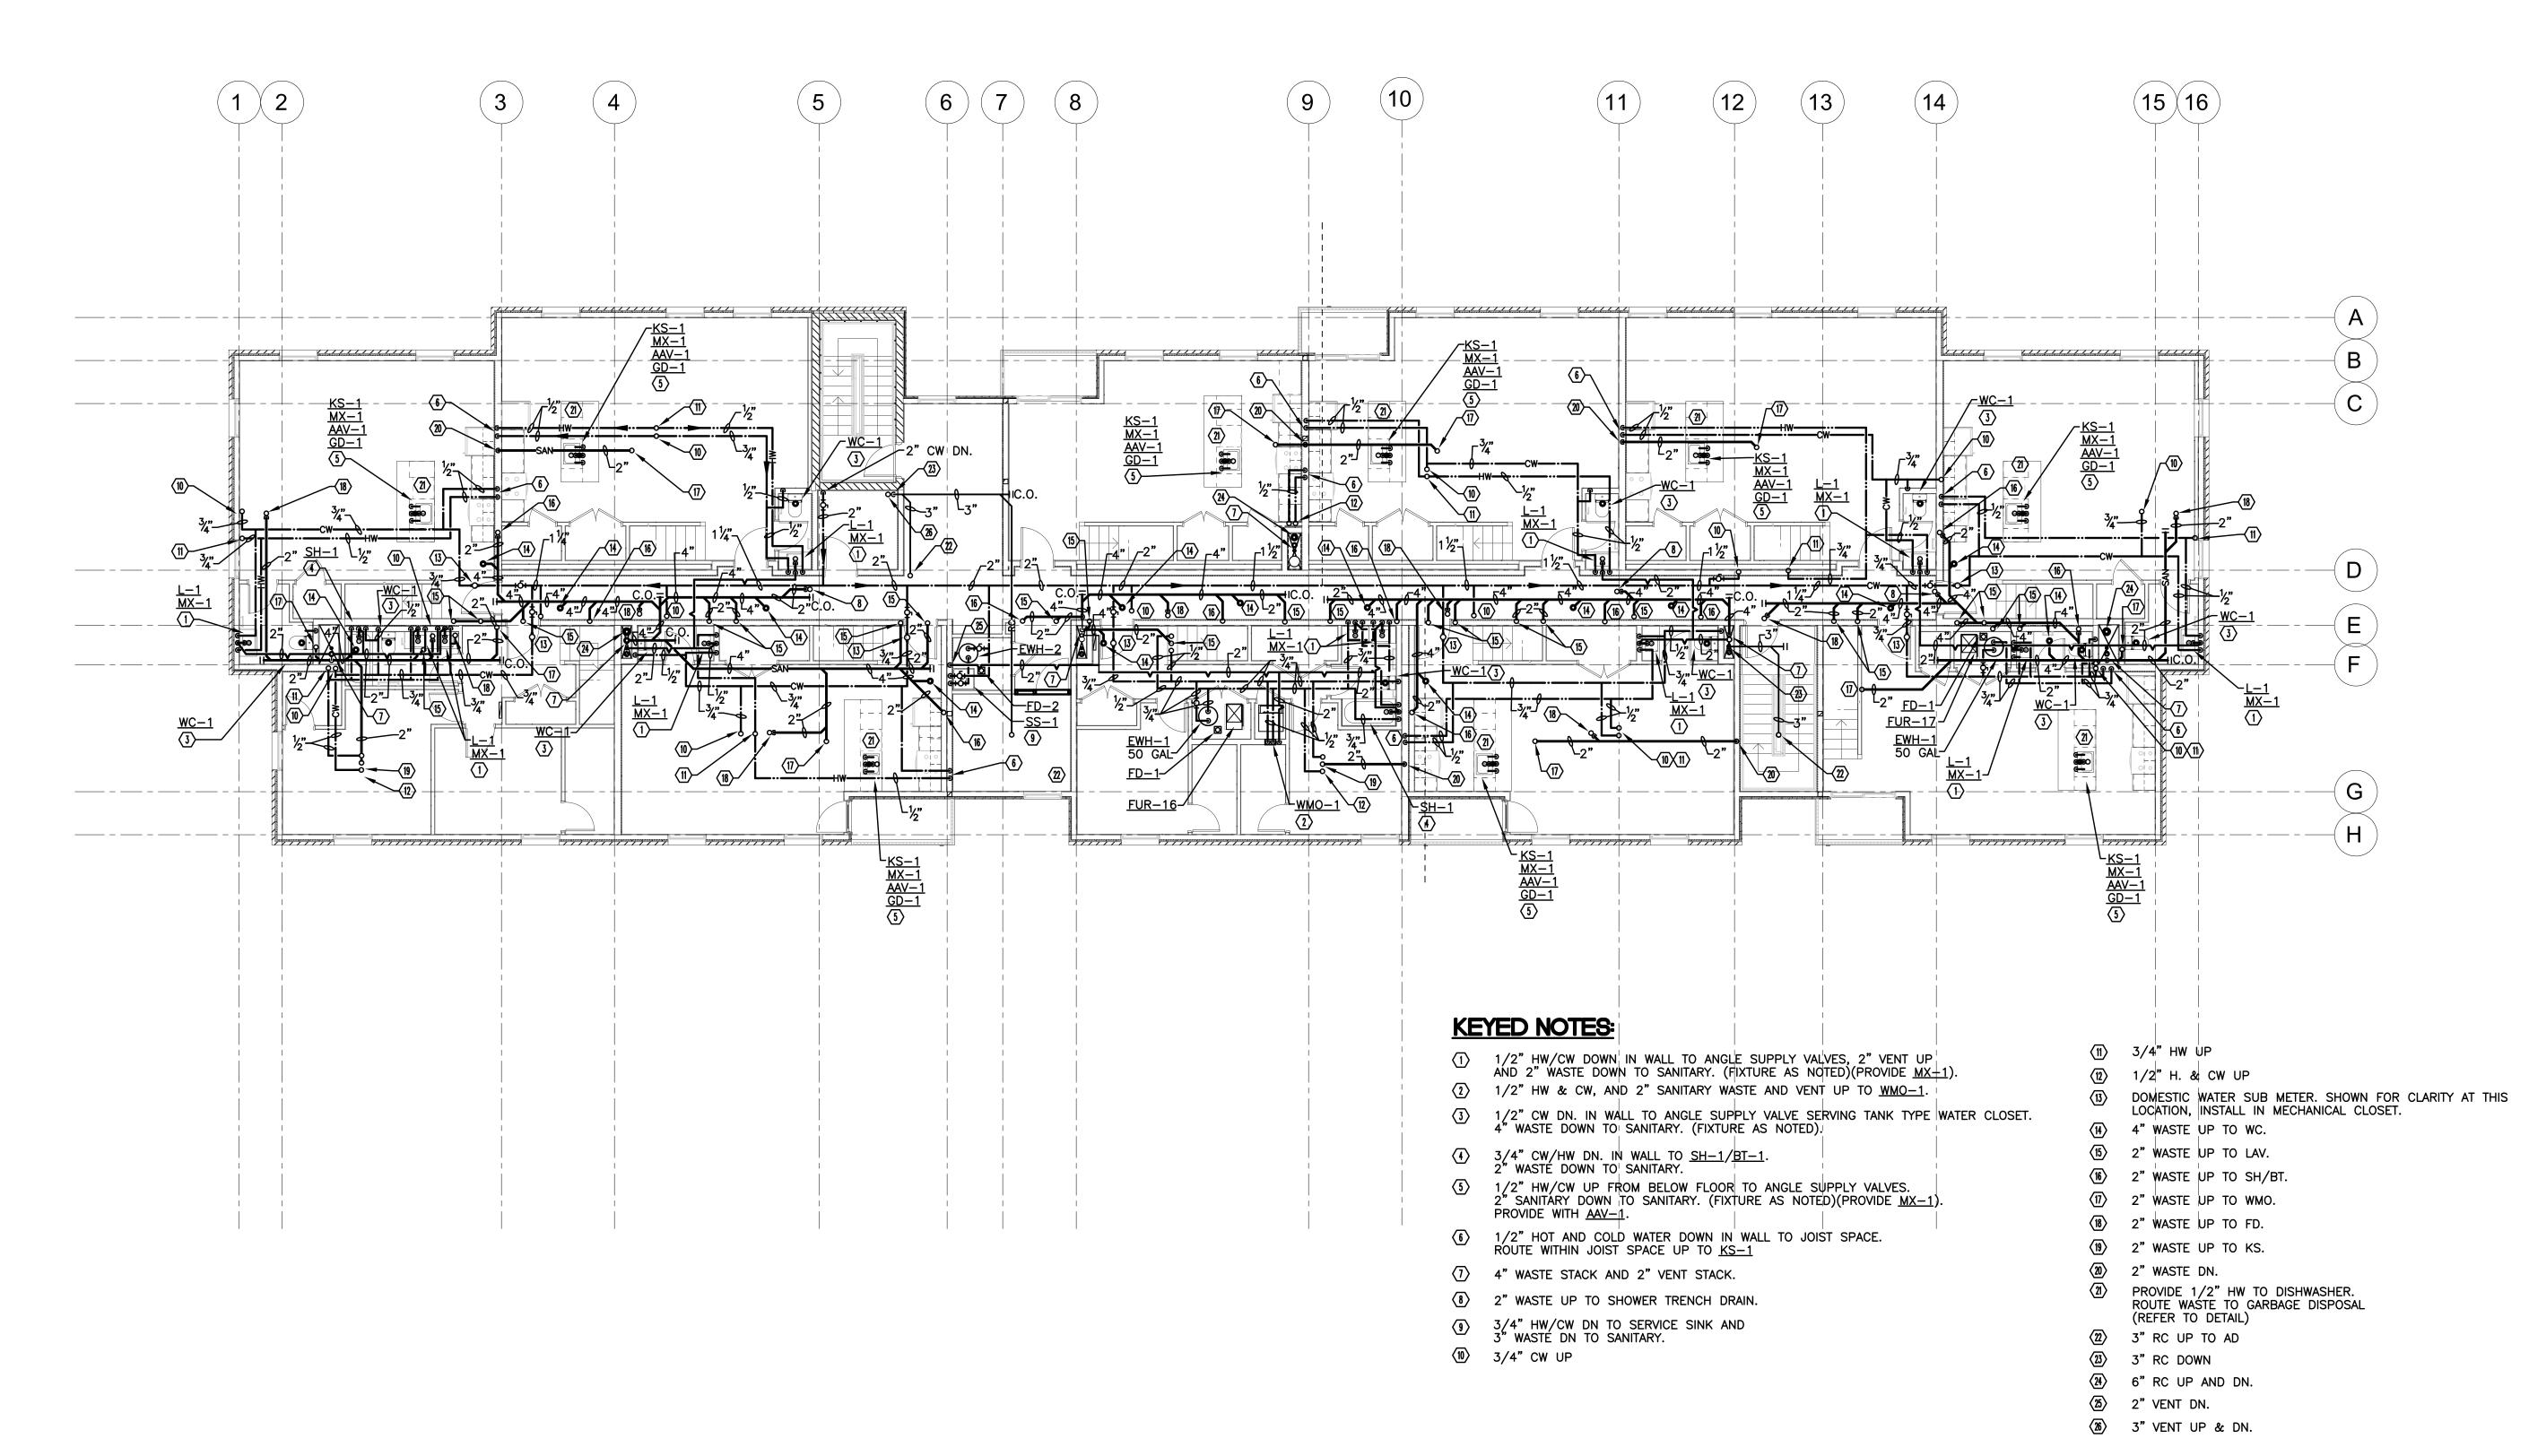



OWNER BRUSH PARK DEVELOPMENT COMPANY 1092 Woodward Ave.

ARCHITECT MERGE ARCHITECTS, INC. 332 CONGRESS ST. FLOOR 6

BOSTON, MA 02210 T: 617 670 0265 STRUCTURAL ENGINEER

MECHANICAL ENGINEER

SELLINGER ASSOCIATES, INC. 19821 FARMINGTON ROAD LIVONIA, MI 48152 T: 248 482 0045

ETS ENGINEERING, INC. 418-1/2 S. WASHINGTON BLVD. ROYAL OAK, MI 48067 T: 248 744 0360

CIVIL ENGINEER

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JOB NO.: AS NOTED SCALE: DATE: 05/15/2020

DRAWING TITLE


PLUMBING THIRD **FLOOR PLAN**

SHEET NO.

P-104



REFER TO ARCHITECTURAL DRAWINGS FOR BALCONY SCUPPER LOCATIONS.

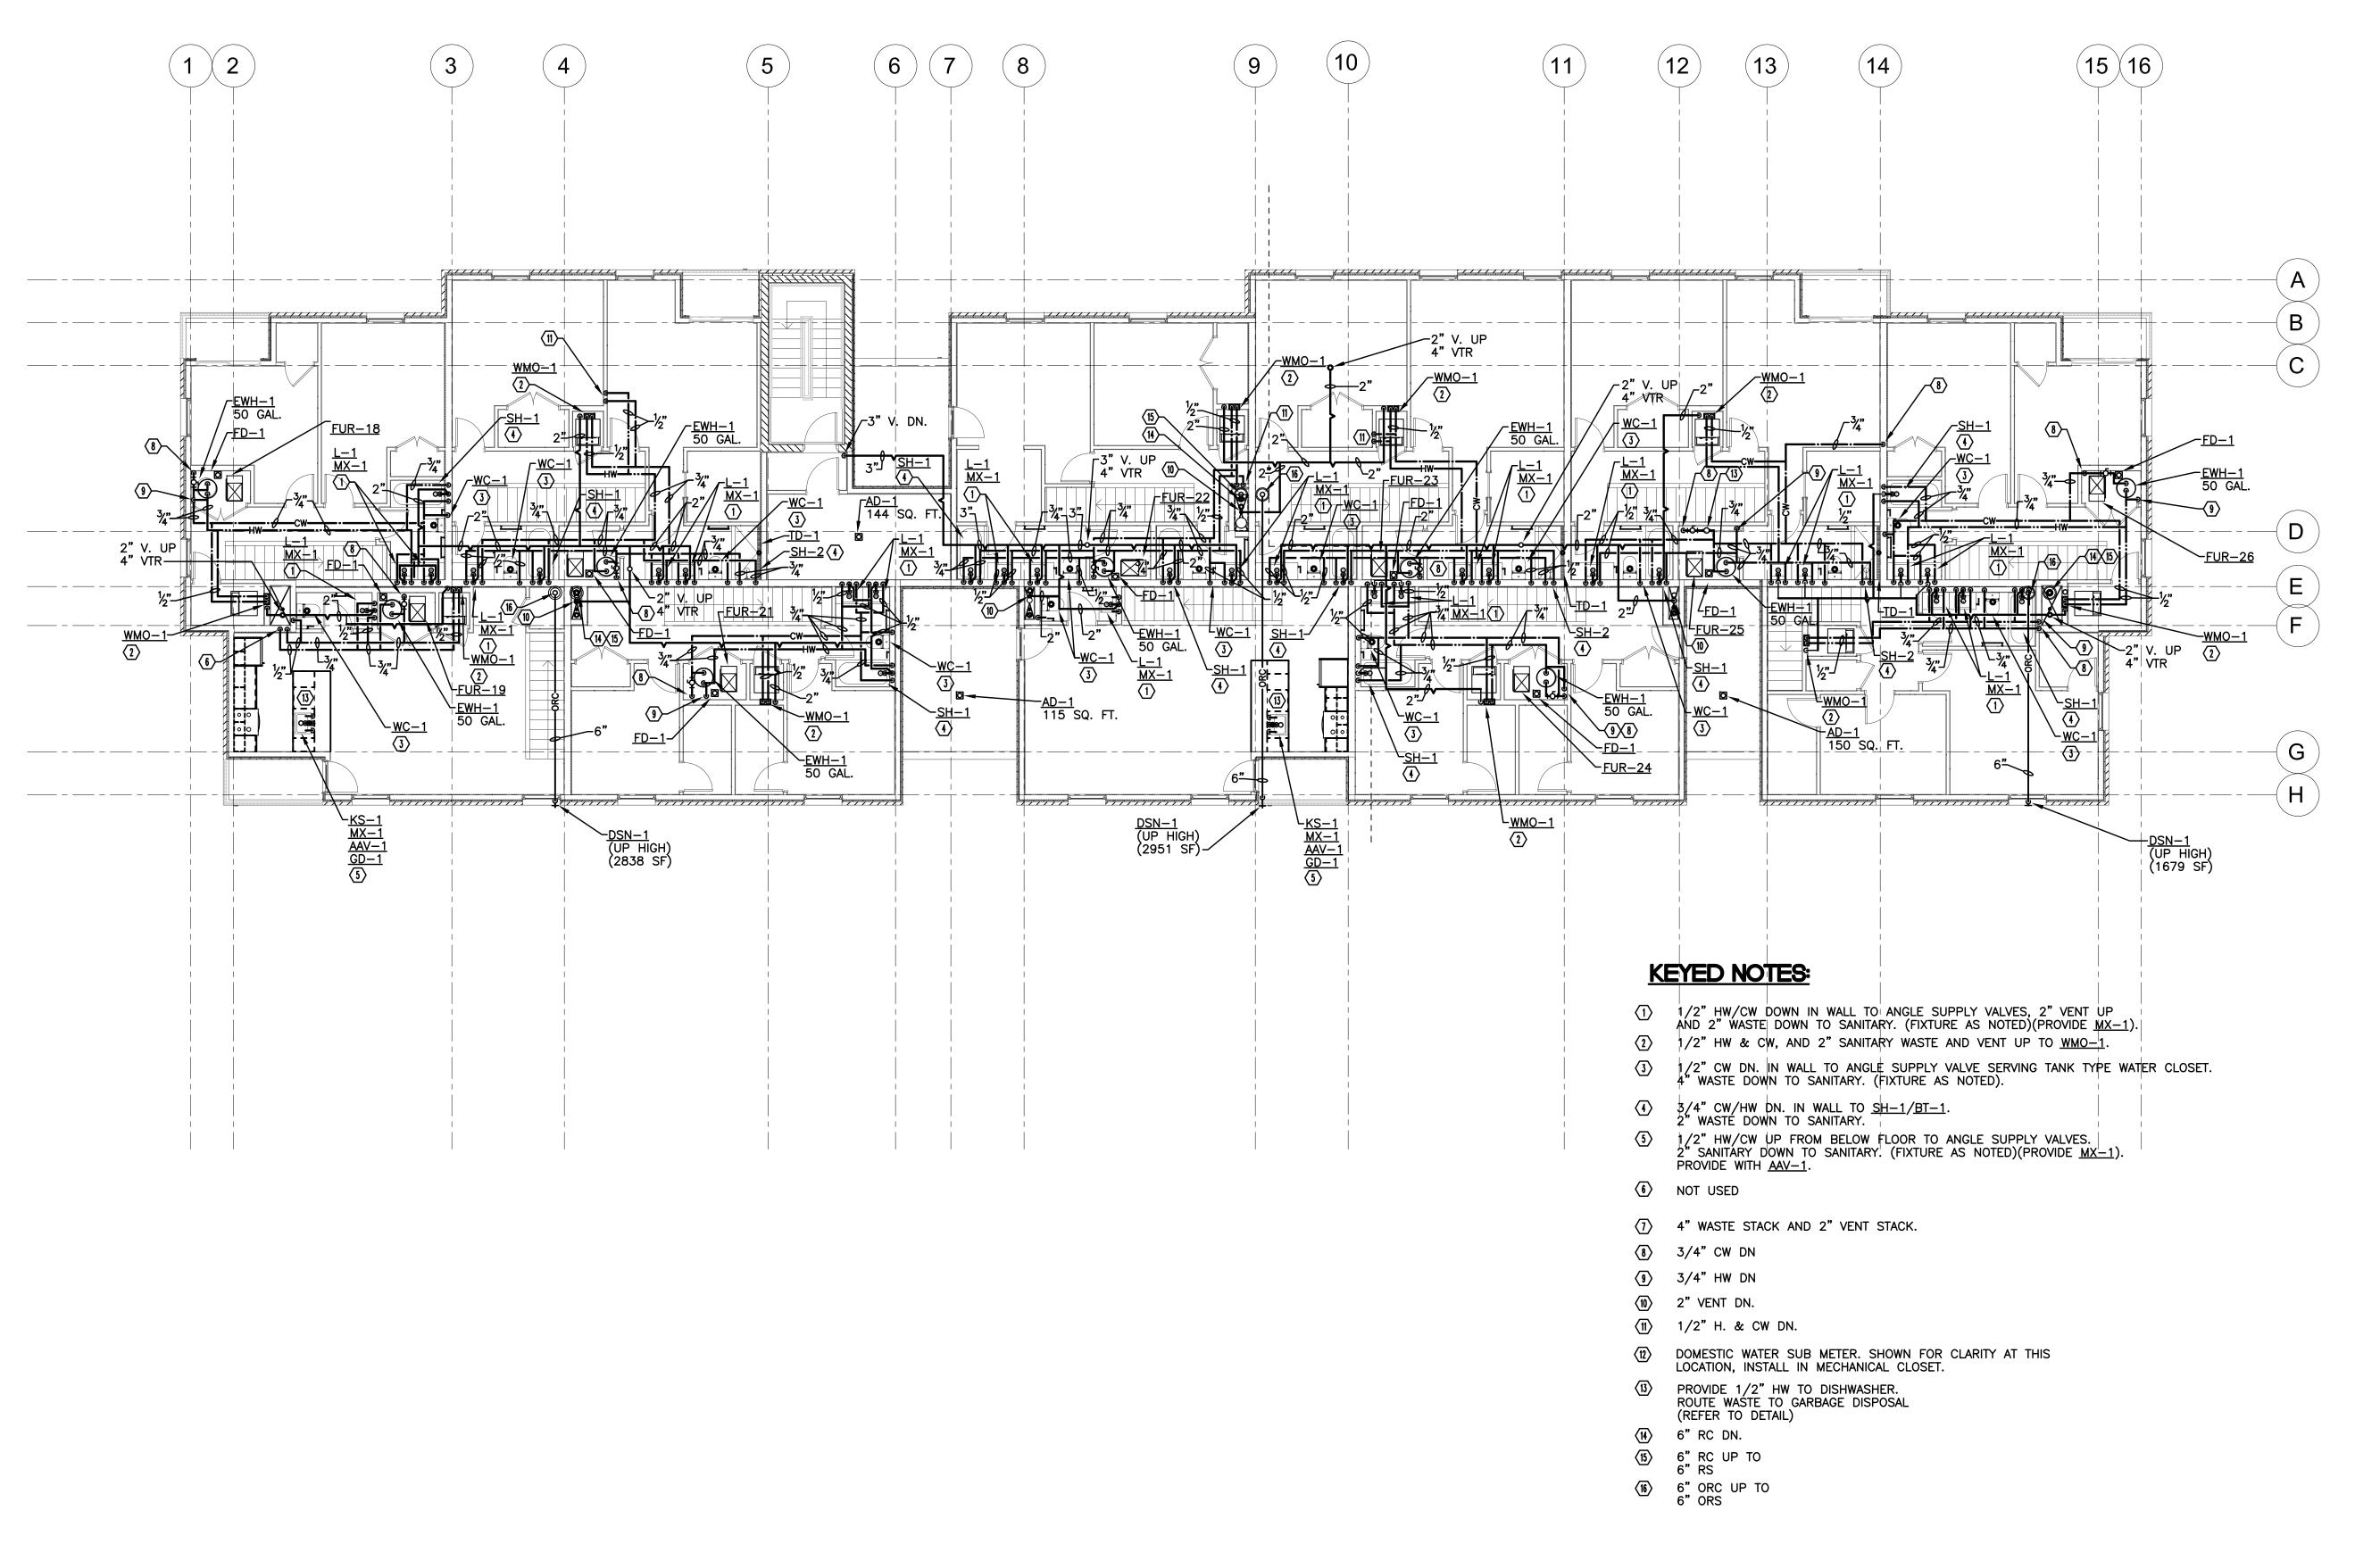



REGISTRATION



OWNER
BRUSH PARK DEVELOPMENT COMPANY
PHASE 1 LLC
1092 Woodward Ave.
Detroit, MI 48226

ARCHITECT

MERGE ARCHITECTS, INC.

MERGE ARCHITECTS, INC. 332 CONGRESS ST. FLOOR 6 BOSTON, MA 02210 T: 617.670.0265

STRUCTURAL ENGINEER

MECHANICAL ENGINEER
SELLINGER ASSOCIATES, INC.

SELLINGER ASSOCIATES, INC. 19821 FARMINGTON ROAD LIVONIA, MI 48152 T: 248 482 0045

ELECTRICAL ENGINEER
ETS ENGINEERING, INC.
418-1/2 S. WASHINGTON BLVD.
ROYAL OAK, MI 48067
T: 248 744 0360

CIVIL ENGINEER

OIVIL LIVOINLLI

Brush Park Duplette D-2On Edmund Place
Between Brush St. and John R. St
Detroit MI, 48201

05/15/2020 100% CD / PERMIT SET

THE CONTRACTOR IS RESPONSIBLE FOR MATERIALS, DETAILS AND ACCURACY, FOR ALL QUANTITIES AND DIMENSIONS, FOR SELECTING FABRICATION PROCESSES, FOR TECHNIQUES OF ASSEMBLY, FOR PERFORMING WORK IN A SAFE MANNER, AND FOR COORDINATING WORK WITH THAT OF ALL TRADES

JOB NO.: 18284

SCALE: AS NOTED

DATE: 05/15/2020

DRAWING TITLE

PLUMBING FOURTH FLOOR PLAN


SHEET NO.

P-105

NOTE: SEE P-000 FOR PLUMBING GENERAL NOTES REGISTRATION

KEYED NOTES:

PROVIDE GAS PIPE, GAS SHUTOFF VALVE, UNION, AND DIRT LEG. PROVIDE PIPE REDUCER AS REQUIRED.

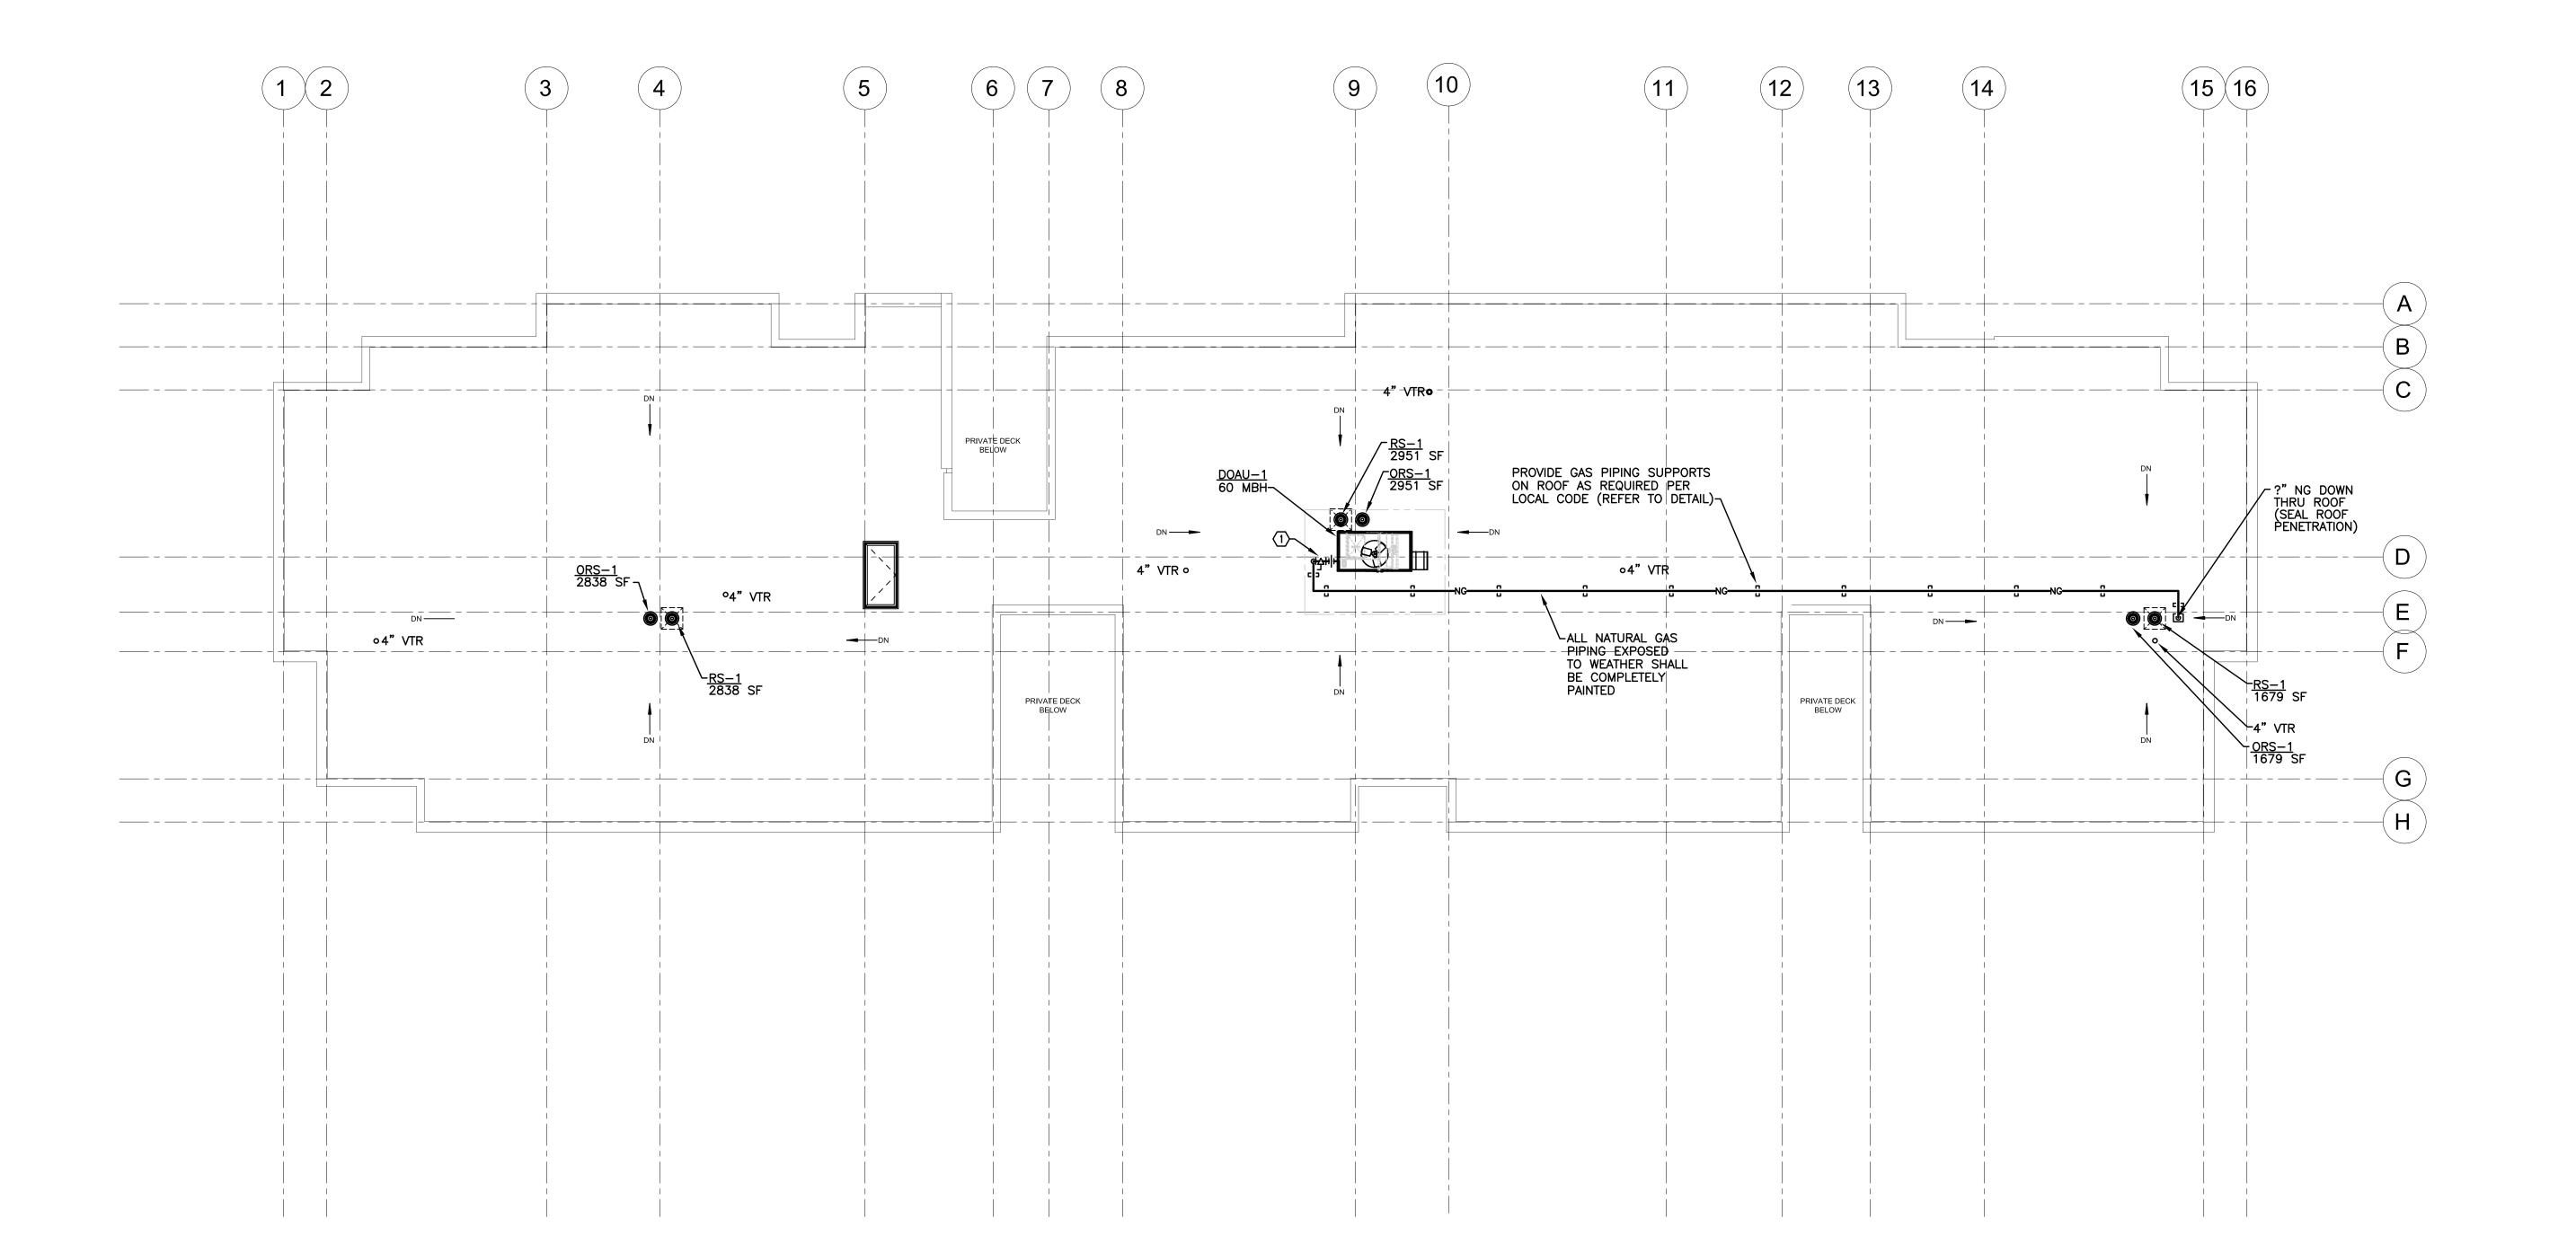





OWNER BRUSH PARK DEVELOPMENT COMPANY PHASE 1 LLC 1092 Woodward Ave. Detroit, MI 48226

ARCHITECT MERGE ARCHITECTS, INC. 332 CONGRESS ST. FLOOR 6 BOSTON, MA 02210 T: 617.670.0265

STRUCTURAL ENGINEER

MECHANICAL ENGINEER

SELLINGER ASSOCIATES, INC. 19821 FARMINGTON ROAD LIVONIA, MI 48152 T: 248 482 0045

ELECTRICAL ENGINEER ETS ENGINEERING, INC. 418-1/2 S. WASHINGTON BLVD. ROYAL OAK, MI 48067 T: 248 744 0360

CIVIL ENGINEER

Duplette

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THE CONTRACTOR IS RESPONSIBLE
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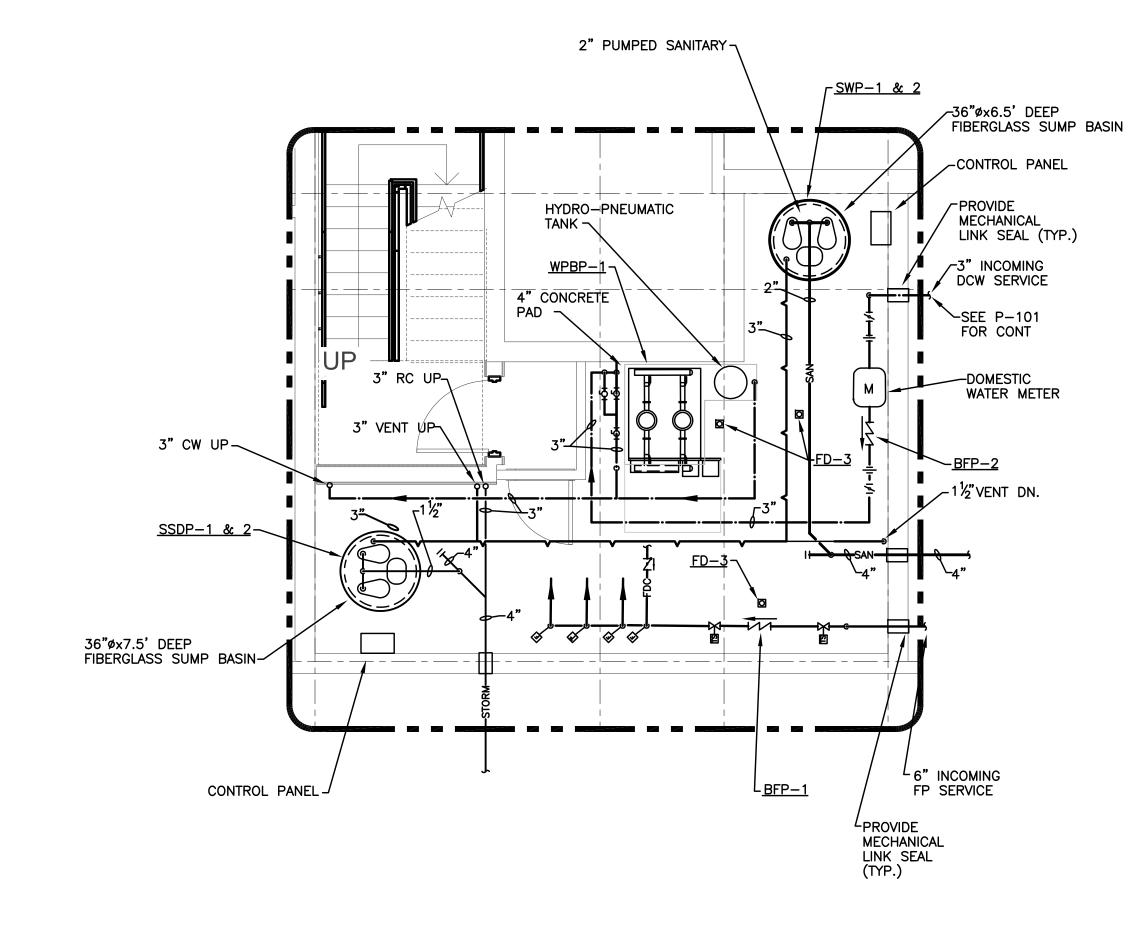
JOB NO.: AS NOTED 05/15/2020

DRAWING TITLE

PLUMBING ROOF PLAN

SHEET NO.

P-106



MERGE ARCHITECTS INC

REGISTRATION

OWNER

ARCHITECT

MERGE ARCHITECTS, INC. 332 CONGRESS ST. FLOOR 6 BOSTON, MA 02210 T: 617.670.0265

SELLINGER ASSOCIATES, INC. 19821 FARMINGTON ROAD LIVONIA, MI 48152 T: 248 482 0045

ETS ENGINEERING, INC. 418-1/2 S. WASHINGTON BLVD. ROYAL OAK, MI 48067 T: 248 744 0360

CIVIL ENGINEER

BRUSH PARK DEVELOPMENT COMPANY PHASE 1 LLC 1092 Woodward Ave. Detroit, MI 48226

STRUCTURAL ENGINEER

MECHANICAL ENGINEER

ELECTRICAL ENGINEER

MICHAEL O. SELLINGER

Brush Park Duplette D-2
On Edmund Place
Between Brush St. and John
Detroit MI, 48201

05/15/2020 100% CD / PERMIT SET

THE CONTRACTOR IS RESPONSIBLE
FOR MATERIALS, DETAILS AND
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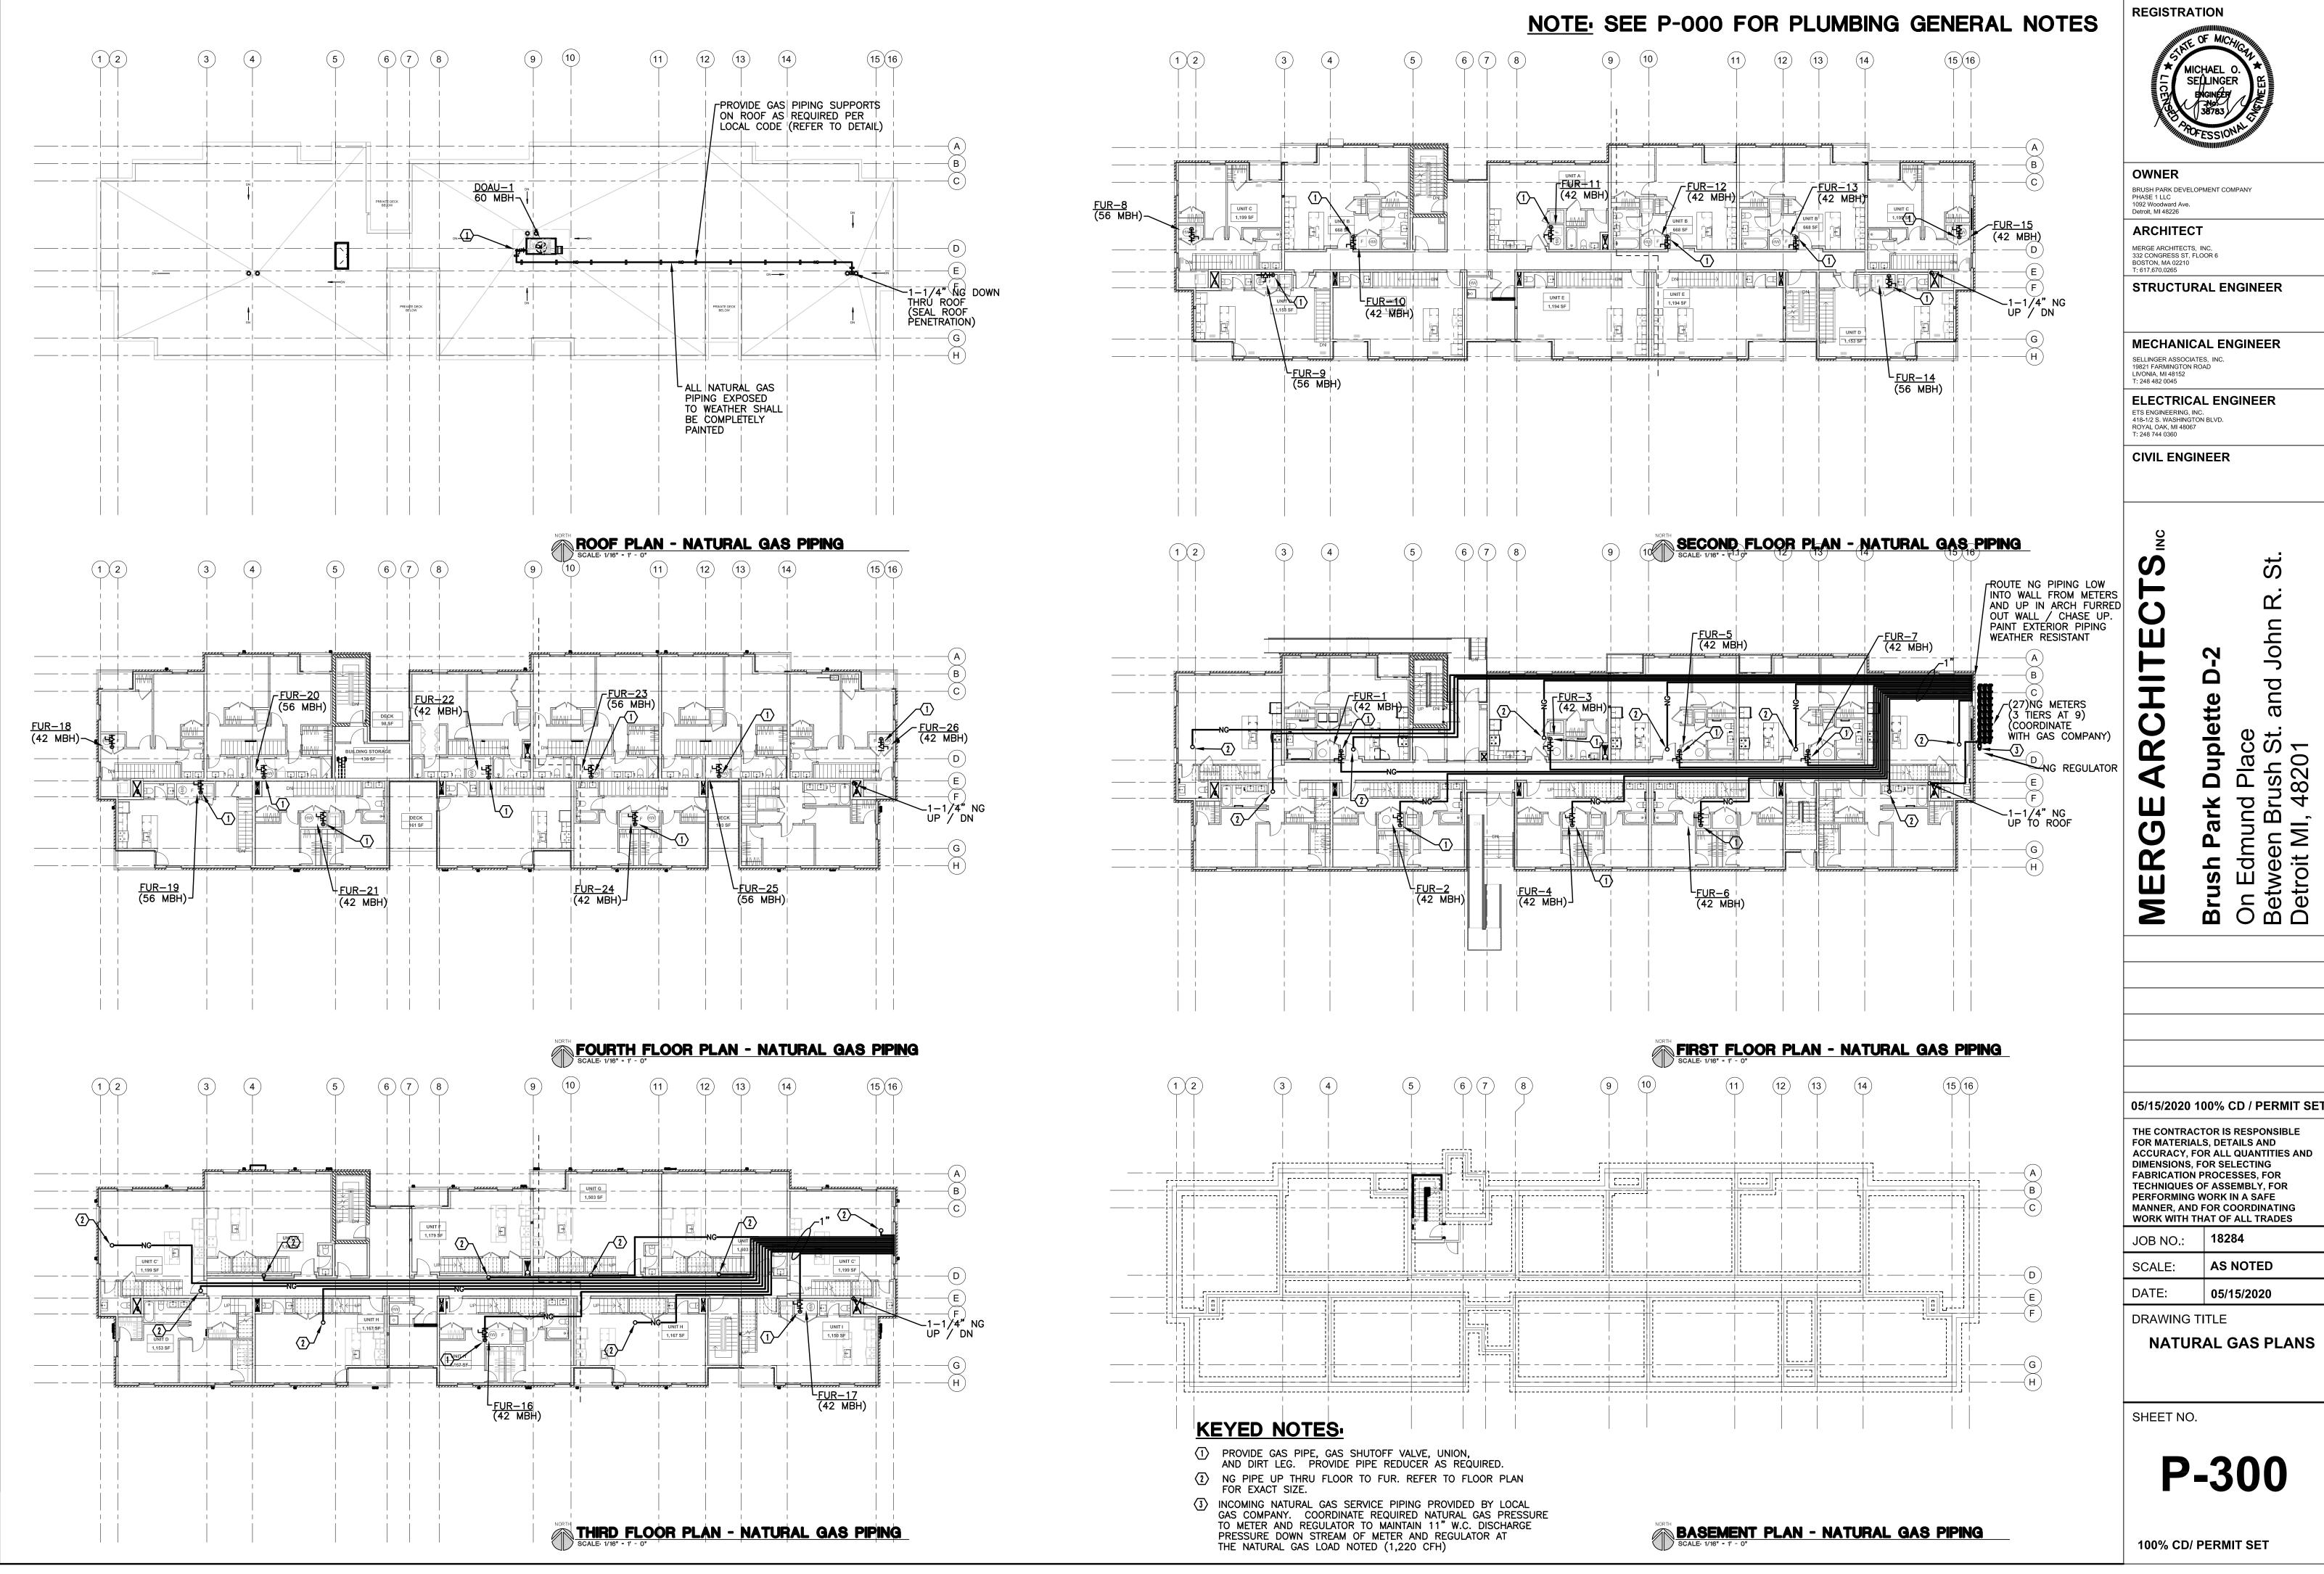
JOB NO.:	18284
SCALE:	AS NOTED
DATE:	05/15/2020

DRAWING TITLE

ENLARGED PLAN

SHEET NO.

P-200



SELLINGER

BRUSH PARK DEVELOPMENT COMPANY

STRUCTURAL ENGINEER

MECHANICAL ENGINEER

ELECTRICAL ENGINEER

CIVIL ENGINEER


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THE CONTRACTOR IS RESPONSIBLE FOR MATERIALS, DETAILS AND ACCURACY, FOR ALL QUANTITIES AND DIMENSIONS, FOR SELECTING FABRICATION PROCESSES, FOR **TECHNIQUES OF ASSEMBLY, FOR** PERFORMING WORK IN A SAFE MANNER, AND FOR COORDINATING WORK WITH THAT OF ALL TRADES

AS NOTED 05/15/2020

NATURAL GAS PLANS

P-300

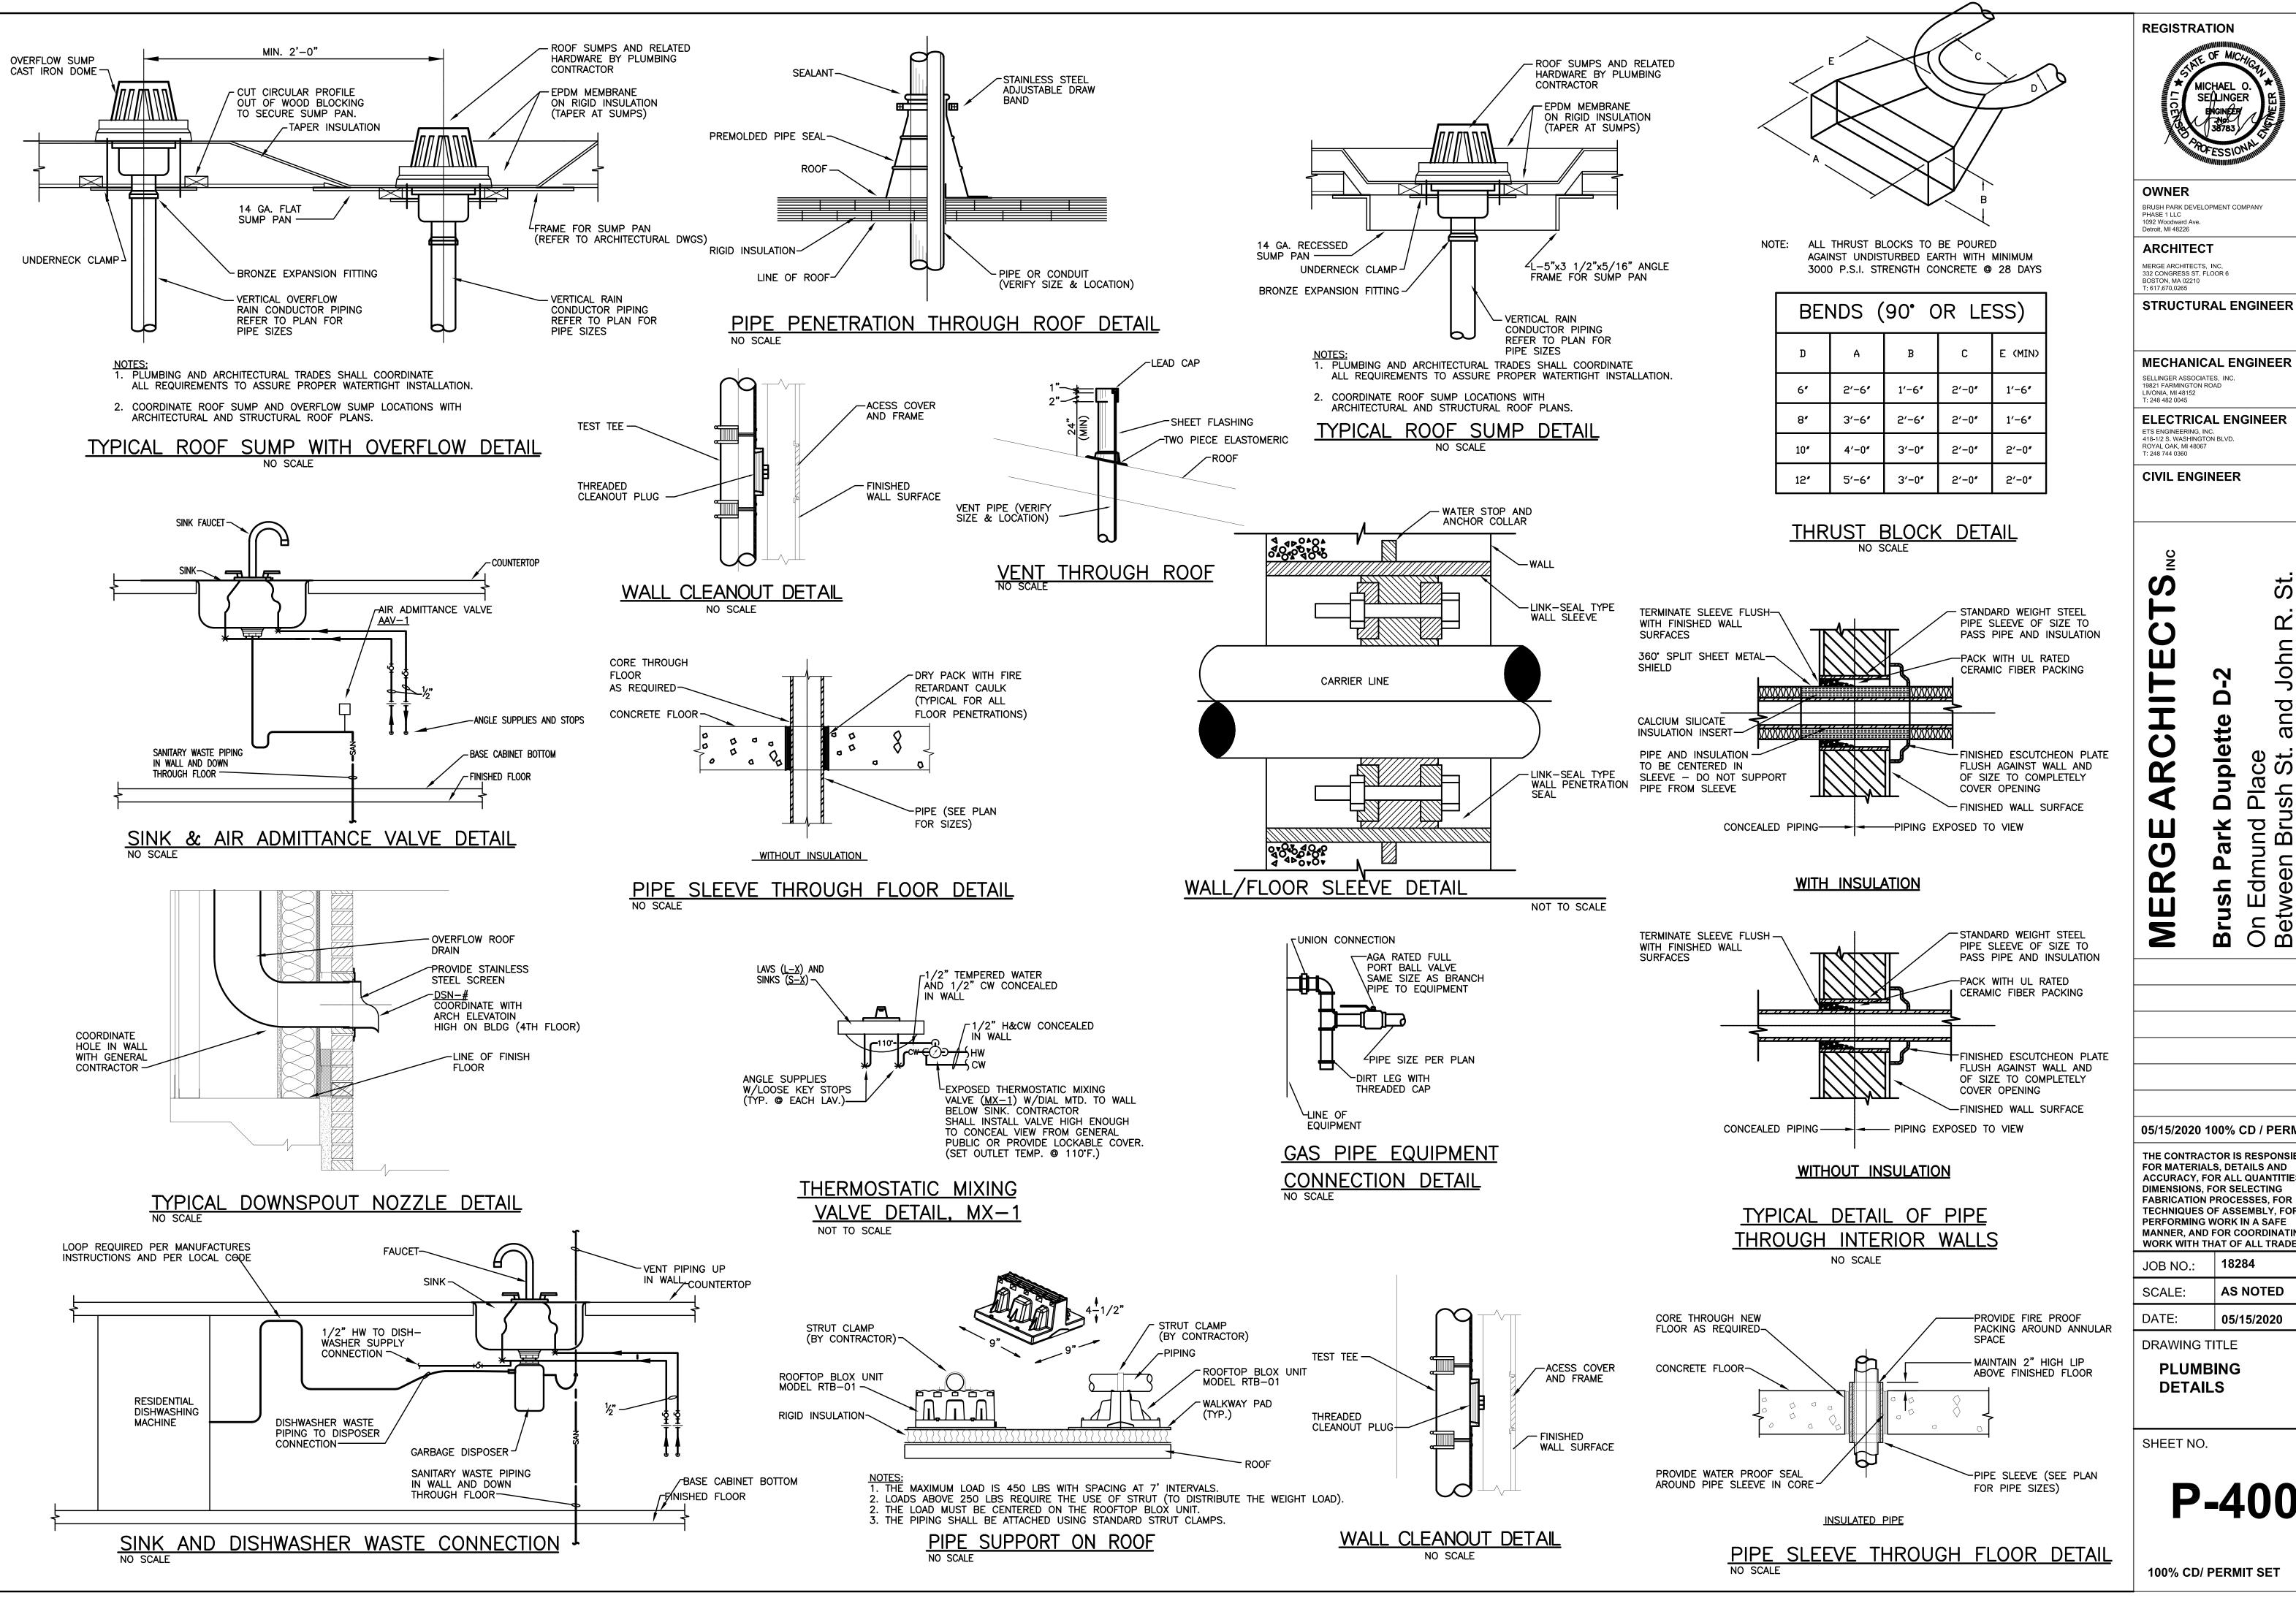

SELLINGER

OWNER BRUSH PARK DEVELOPMENT COMPANY 1092 Woodward Ave.

ARCHITECT MERGE ARCHITECTS. INC

BOSTON, MA 02210 T: 617.670.0265

MECHANICAL ENGINEER

SELLINGER ASSOCIATES, INC. 19821 FARMINGTON ROAD LIVONIA, MI 48152 T: 248 482 0045

ELECTRICAL ENGINEER 418-1/2 S. WASHINGTON BLVD. ROYAL OAK, MI 48067

CIVIL ENGINEER

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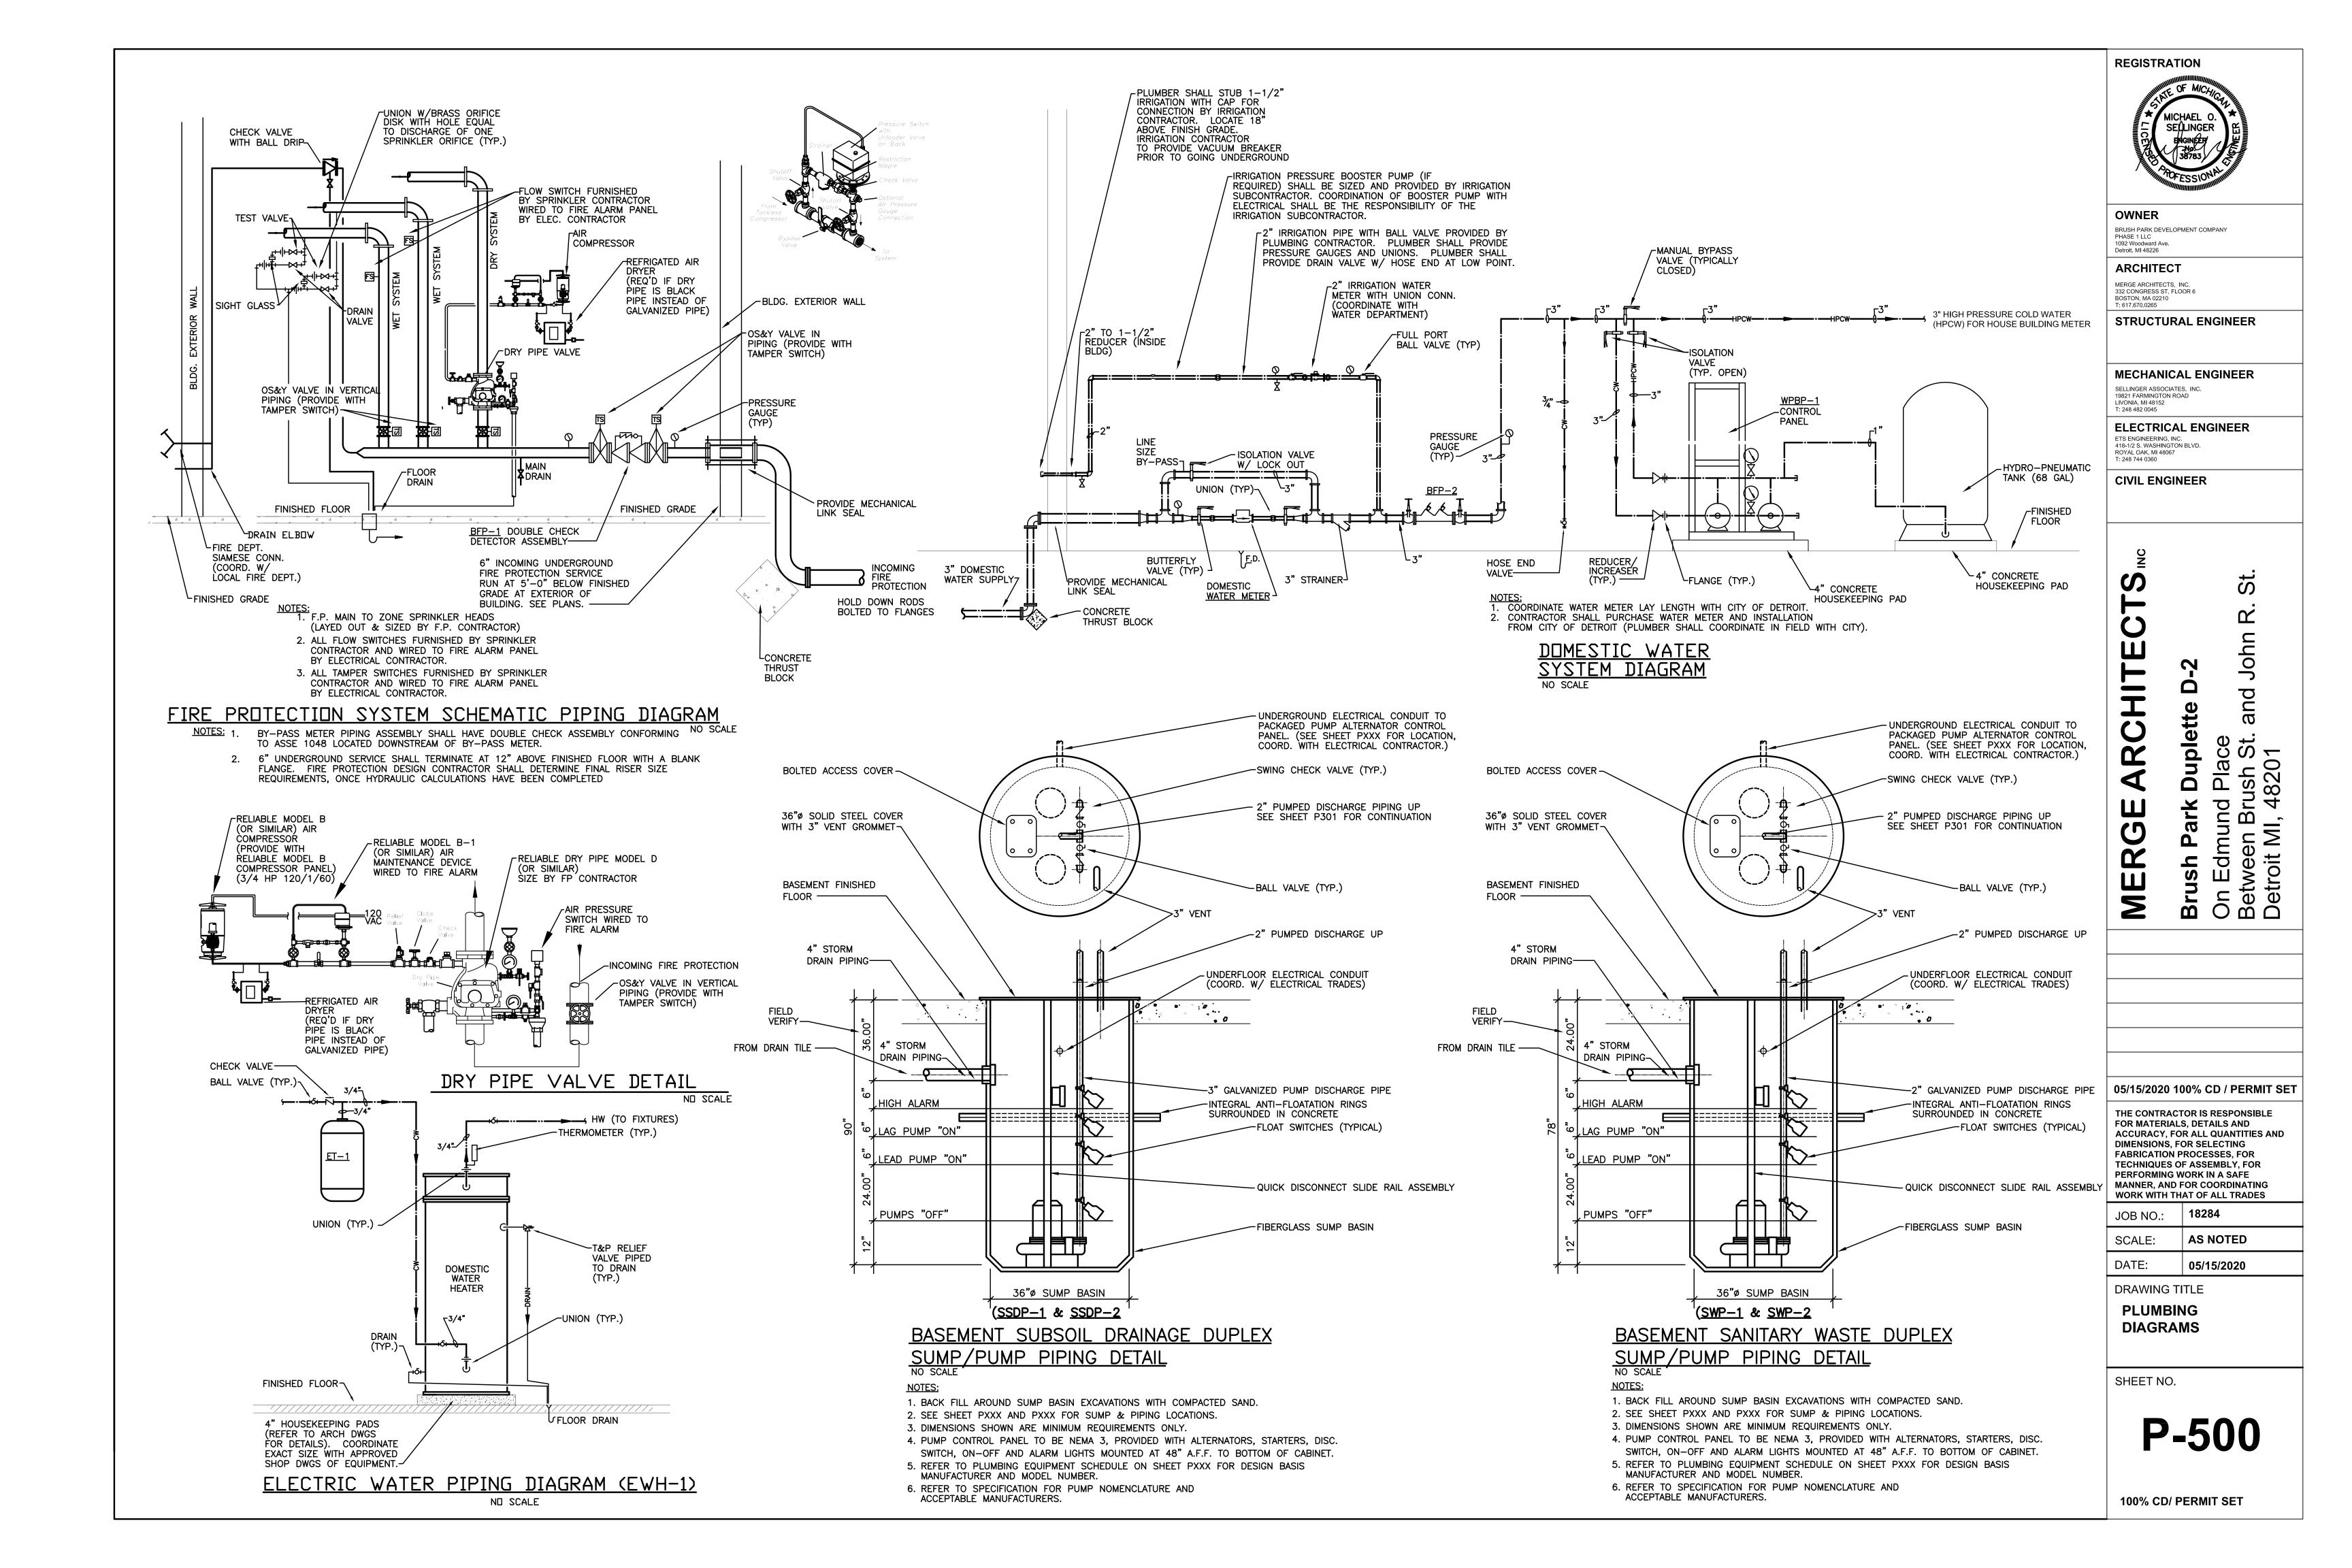
18284 JOB NO.: AS NOTED SCALE: DATE: 05/15/2020

DRAWING TITLE

PLUMBING DETAILS

SHEET NO.

P-400



	PLUMBING FIXTURE SCHEDULE									
TAG ITEM MAKE MODEL				MODEL	PIPE CONNECTION SIZES			IZES		
TAG	IIEM	MARE	NAME	NUMBER	W	٧	CW	HW	NOTES/ACCESSORIES	
WC-1	BARRIER FREE WATER CLOSET	KOHLER	WINDHAM	403082	4"	_	1/2"	-	FLOOR MOUNTED, TANK TYPE FLUSH CONTROL (WC TO HAVE LEFT OR RIGHT—HAND TRIP LEVER — SEE PLANS)	
L-1	UNDERCOUNTER LAVATORY	KOHLER	CAXTON	K-2211	2"	1 1/2"	1/2"	1/2"	VITREOUS CHINA, UNDERCOUNTER, 4" CENTERS, SINGLE LEVER FAUCET, & ADA COMPLIANT	
KS-1	SINGLE COMPART. SINK	ELKAY	CROSSTOWN	ECTRU24179RT	2"	1 1/2"	1/2"	1/2"	SELF—RIMMING STAINLESS STEEL, SINGLE BOWL, DECKMOUNT GOOSENECK WITH SINGLE LEVER (ADA COMPLIANT)	
SH-1	SHOWER & TUB VALVE	DELTA	TRINSIC	T14459	1	_	1/2"	1/2"	SHOWER TRIM, PRESSURE BALANCED, INTEGRAL CHECKS SINGLE METAL HANDLE, SHOWERHEAD, ARM, FLANGE, TUB FILL	
SH-2	SHOWER VALVE	DELTA	TRINSIC	T14259	1	_	1/2"	1/2"	SHOWER TRIM, PRESSURE BALANCED, INTEGRAL CHECKS SINGLE METAL HANDLE, SHOWERHEAD, ARM, FLANGE	
FD-1	FLOOR DRAIN	ZURN	-	ZN-415-3NH-5B-VP	3"	_	1	-	FLOOR DRAIN WITH TYPE "B" STRAINER & VANDAL PROOF GRATE PROVIDE WITH SURESEAL 3" FLOOR DRAIN TRAP SEALER (#SS3000)	
FD-2	SQUARE FLOOR DRAIN	ZURN	-	ZN-415-3NH-5B-VP-P	2"	ı	ı	_	FLOOR DRAIN WITH TYPE "B" STRAINER & VANDAL PROOF GRATE PLUMBER TO PROVIDE WATERPROOF MEMBRANE UNDER MUD SET	
FD-3	HEAVY DUTY FLOOR DRAIN	ZURN	-	ZN-511-3NL	3"	-	-	-	9" HEAVY DUTY FLOOR DRAIN PROVIDE WITH SURESEAL 3" FLOOR DRAIN TRAP SEALER. (#SS3000)	
WCO	WALL CLEANOUT	ZURN	-	Z-1446-A-VP-"X"NL	FULL	FULL LINE SIZE, SEE PLANS		PLANS	ROUND SMOOTH S.S. COVER WITH SCREW	
FCO	FLOOR CLEANOUT	ZURN	-	ZN-1400-VP	FULL	LINE SIZ	E, SEE	PLANS	ADJUSTABLE FLOOR CLEANOUT	
GD-1	GARBAGE DISPOSAL	IN-SINK-ERATOR	BADGER 5	BADGER 5	1-1/2"	-	-	_	1/2 HP, STAINLESS STEEL GRINDING ELEMENTS, AUTO REVERSE	
WMO-1	WASHING MACHINE OUTLET BOX	GUY GRAY	-	BB200TS	2"	-	1/2"	1/2"	FULLY RECESSED BOX IN WALL, TOP DOWN WATER SUPPLY INLETS ANGLE SUPPLIES, SWEAT CONNECTIONS, 2" WASTE OUTLET	
WH-1	EXTERIOR WALL HYDRANT	WOODFORD	-	B65	-	_	3/4"	-	NON-FREEZE, ANTI SIPHON, AND AUTO DRAINING	
RS-1	ROOF SUMP	ZURN	-	ZC-100-6NH	6"	-	_	-	15"Ø DRAIN W/ LOW SILOUETTE & CAST IRON DOME	
ORS-1	ROOF SUMP	ZURN	-	ZC-100-4NH-W6	6"	_	-	-	15"Ø DRAIN W/ LOW SILOUETTE, CAST IRON DOME, & 4" INTERNAL WATER DAM	
DSN-1	DOWNSPOUT NOZZLE	MAJESTIC	HUGO 6" ROOF DRAINAGE SCUPPER	-	6"	_	-	_	STAINLESS STEEL	
AD-1	UNDER PAVER AREA DRAIN	ZURN	-	Z100-3NH-DP-EA-FG	3"	_	-	-	15" DIAMETER ALL CAST IRON ROOF DRAIN WITH FLAT GRATE, DECK PLATE, 2-1/8" TO 3-1/2" ADJUSTABLE EXTENSION AND 2" EXTERNAL WATER DAM	
OD-1	UNDER PAVER OVERFLOW DRAIN	ZURN	-	Z100-3NH-DP-EA-89-LD	3"	-	_	_	15" DIAMETER ALL CAST IRON ROOF DRAIN WITH DECK PLATE, 2-1/8" TO 3-1/2" ADJUSTABLE EXTENSION AND 2" EXTERNAL WATER DAM, LESS DOM	
SS-1	FLOOR SERVICE SINK	FLORESTONE	TERRAZZO	91-24"x24"	3"	-	3/4"	3/4"	FLOOR MOUNTED, 12" H. SQUARE TERRAZZO BASIN W/ 6" DROP FRONT	

PLUMBING FIXTURE SPECIFICATION

 WC-1: BARRIER FREE FLOOR MOUNTED TANK TYPE WATER CLOSET; KOHLER MODEL 402215 "WINDHAM" WATER CLOSET, LOW CONSUMPTION (1.6 gpf) CLOSE-COUPLED TANK WITH ELONGATED INGENIUM FLUSHING BOWL. PROVIDE KOHLER K-4636 ELONGATED CLOSED FRONT TOILET SEAT WITH QUIET CLOSE LID AND EXTERNAL CHECK HINGE WITH SEAT COVER. INSTALLATION SHALL MEET ADA REQUIREMENTS.

NOTE: WATER CLOSET TO HAVE LEFT OR RIGHT-HAND TRIP LEVER DEPENDING ON LOCATION OF WALL/GRAB BARS - SEE PLANS TO DETERMINE WHERE WALL/GRAB BARS ARE LOCATED AND ORDER THE PROPER HAND CONFIGURATION. PLUMBER SHALL BE RESPONSIBLE TO DETERMINE HAND ORIENTATION AND ORDER PROPER QUANTITY OF BOTH. FLUSH LEVER (TRIP LEVER) TO BE ON OPEN SIDE OF TOILET, AWAY FROM SIDE WALL WITH GRAB BAR.

- 2. <u>L-1</u>: UNDERCOUNTER LAVATORY; KOHLER "CAXTON" MODEL K-2211 PROVIDE DELTA MODEL 22C101 SINGLE LEVER FAUCET WITH NO POP-UP HOLE. PROVIDE CHROME PLATED, CAST BRASS GRID DRAIN STRAINER, P-TRAP WITH C.O. PLUG, QUARTER TURN ANGLE SUPPLIES AND STOP VALVES. INSULATE EXPOSED WASTE AND WATER PIPING. (PROVIDE MX-1 BELOW LAVATORY.)
- <u>KS-1</u>: SINGLE COMPARTMENT SINK: ELKAY MODEL ECTRU24179RT STAINLESS STEEL SINK, WITH STRAINER, RUBBER STOPPER, AND OFF-SET TAIL PIECE. GROHE MODEL 32665001 SINGLE LEVER DECKMOUNT FAUCET, PULL DOWN SPOUT WITH MAGNETIC DOCKING. PROVIDE CHROME PLATED CAST BRASS P-TRAP, ANGLE SUPPLIES AND STOP VALVES. (ADA COMPLIANT) INSULATE EXPOSED WASTE AND WATER PIPING.

- 4. <u>GD-1</u>: GARBAGE DISPOSAL: IN-SINK-ERATOR MODEL BADGER 5 CONTINUOUS FEED, 1/2 HP MOTOR, AND STAINLESS STEEL GRINDING ELEMENTS WITH TWO STAINLESS STEEL 360° SWIVEL LUGS (2 YEAR WARRANTY).
- <u>SH-1</u>: SHOWER/TUB: DELTA MODEL T14459 SHOWER & TUB FILL, PRESSURE BALANCED CARTRIDGE, TEMPERATURE CONTROL MANUAL, WITH ADJUSTABLE LIMIT, INTEGRAL CHECKS, NON-REMOVABLE RED/ BLUE VISUAL COVER, SINGLE METAL LEVER HANDLE, SHOWERHEAD, ARM & FLANGE. (ASSE 1016) BATHTUB: CLARION BATHWARE MODEL "7933L". 30" WIDE WITH INTEGRAL OVERFLOW, 44 GALLON CAPACITY (AT OVERFLOW).
- 6. <u>SH-2</u>: SHOWER: DELTA MODEL T14259 SHOWER, PRESSURE BALANCED CARTRIDGE, TEMPERATURE CONTROL MANUAL, WITH ADJUSTABLE LIMIT, INTEGRAL CHECKS, NON-REMOVABLE RED/ BLUE VISUAL COVER, SINGLE METAL LEVER HANDLE, SHOWERHEAD, ARM & FLANGE. (ASSE 1016) TRENCH DRAIN: INFINITY DRAIN S-AG-65 SERIES.
- 7. <u>SS-1</u>: SERVICE SINK; FLORESTONE MODEL 91-24X24, SQUARE, 24"x24"x12" TERRAZZO CONSTRUCTION WITH 6" DROP FRONT, ZURN MODEL Z843M1-RC-CS FAUCET WITH WALL BRACE, VACUUM BREAKER, CHECK STOPS, AND PAIL HOOK, JP1996-HH HOSE & BRACKET, AND MODEL JP1996-WG-24 WALL GUARD (18" HIGH) (2 WALLS).

	ELECTRIC WATER HEATER SCHEDULE											
TAG SYSTEM	SYSTEM	LOCATION	MANUFACTURER AND	C	CAPACITIES		ELEC. DATA			WGT (LBS)	NOTES/ACCESSORIES	
IAG	SERVED	LOCATION	MODEL NUMBER	REC.	NOM. STOR.	TEMP. RISE	K.W. Input	٧	ø	(LBS)	NOTES/ACCESSORIES	
EWH-1	ELECTRIC HOT WATER	SEE DWGS	AO SMITH ENT-50	21	50	90	4.5	208	1	541	PROVIDE WITH DRAIN PAN	
EWH-2	ELECTRIC HOT WATER	SEE DWGS	AO SMITH EJC-10	7.5	10	90	1.65	120	1	135	PROVIDE WITH STRUCTURALLY SUPPORTED SHELF AND DRAIN PAN	

1. DISCONNECT BY ELECTRICAL. COORDINATE ELECTRICAL WITH ELECTRICAL TRADES PRIOR TO ORDERING.

2. PROVIDE WITH WESSELS TTA-5 EXPANSION TANK FOR EWH-1.

	PLUMBING EQUIPMENT SCHEDULE									
EQUIPMENT NO.	EQUIPMENT	SIZE	STORAGE CAPACITY GALLON	ELEC.	MANUFACTURER & MOD. #					
MX-1	THERMOSTATIC MIXING VALVE	1/2 " ø	_	_	CONBRACO MODEL 34B, 1/2" INLETS, 1/2" OUTLET WITH CHECKS. LOCATED UNDER SINK OR IN CEILING SPACE. (ASSE 1016 APPROVED)					
AAV-1	AIR ADMITTANCE VALVE	MINI-VENT	_	_	STUDOR MINI-VENT					
WHA-1	WATER HAMMER ARRESTOR	1/2 " ø	_	_	SIOUX CHIEF MODEL 660 SIZE A MAX WORKING TEMP = 250°F, TESTED TO 500,000 CYCLES, SAFE WORKING PRESSURE TO 350 PSIG (FIXTURE UNITS 1-11)					
WPBP-1	WATER PRESSURE BOOSTER PUMP	36"x52"x50"	-	(2 @ 5 HP) 208 VOLT 3ø	XYLEM DUPLEX VARIABLE SPEED BOOSTER PUMP MODEL HVL2L4—15SV2GG4F60—2 (5.0 HP EACH) CAPABLE OF 43 PSI INCREASE AT 170 GPM (85/85 GPM). PROVIDE WITH 4" 316 S/S HEADER 68 GALLON HYDRO—PNEUMATIC TANK (B&G WTA 404) CONTROL PANEL (W/ ALTERNATING). VARIABLE SPEED DRIVES (FOR BOTH PUMPS) AND DISCONNECT BY WPBP MANU.					
BFP-2	BACKFLOW PREVENTER (DCW)	3 " ø			WILKINS MODEL 350AST. PROVIDE WITH TEST PORTS AND NON RISING STEM GATE VALVES ON INLET AND OUTLET.					
BFP-1	FIRE PROT. BACKFLOW PREVENTER	SIZE AS REQ'D			AMES MODEL 3000SS DOUBLE CHECK DETECTOR ASSEMBLY. ASSE LISTED 1048. HORIZONTAL OR VERTICAL INSTALLATION					
SWP-1 & SWP-2	FIBERGLASS SEWAGE BASIN & DUPLEX SANITARY WASTE SUMP PUMP (SUBMERSIBLE EFFLUENT PUMP)	-	6 GPM © 27' HEAD	115v1ø 0.33 HP 1750 RPM	BELL AND GOSSETT MODEL 2EC0311L SUBMERSIBLE EFFLUENT SUMP PUMP 36" Ø X 78" FIBERGLASS BASIN WITH ANTI-FLOAT RING, FACTORY QUICK DISCONNECT GUIDE RAIL ASSEMBLY WITH INTEGRATED ELBOW & WALL MOUNTED NEMA 3 ALTERNATING CONTROL PANEL/DISCONNECT SWITCH, & HI WATER ALARM. PROVIDE TWO PIECE BASIN. (0.33 HP, 115V, 1PH, 1750 RPM). (REFER TO DETAIL ON SHEET P-500)					
SSDP-1 & SSDP-2	FIBERGLASS SEWAGE BASIN & DUPLEX SUBSOIL DRAINAGE SUMP PUMP (SUBMERSIBLE EFFLUENT PUMP)	-	8 GPM @ 27' HEAD	115v.—1ø 0.33 HP 1750 RPM	BELL AND GOSSETT MODEL 2EC0311L SUBMERSIBLE EFFLUENT SUMP PUMP 36"Ø X 90" FIBERGLASS BASIN WITH ANTI-FLOAT RING, FACTORY QUICK DISCONNECT GUIDE RAIL ASSEMBLY WITH INTEGRATED ELBOW & WALL MOUNTED NEMA 3 ALTERNATING CONTROL PANEL/DISCONNECT SWITCH, & HI WATER ALARM. PROVIDE TWO PIECE BASIN. (0.33 HP, 115V, 1PH, 1750 RPM). (REFER TO DETAIL ON SHEET P-500)					

REGISTRATION



OWNER BRUSH PARK DEVELOPMENT COMPANY

ARCHITECT MERGE ARCHITECTS, INC.

BOSTON, MA 02210 T: 617 670 0265

MECHANICAL ENGINEER

STRUCTURAL ENGINEER

SELLINGER ASSOCIATES, INC. 19821 FARMINGTON ROAD LIVONIA, MI 48152 T: 248 482 0045

ELECTRICAL ENGINEER ETS ENGINEERING, INC. 418-1/2 S. WASHINGTON BLVD. ROYAL OAK, MI 48067 T: 248 744 0360

CIVIL ENGINEER

0 **Duplette** Place ush St. 8201 **Brush Park I**On Edmund I
Between Brus
Detroit MI, 48

05/15/2020 100% CD / PERMIT SET

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JOB NO.:	18284
SCALE:	AS NOTED
DATE:	05/15/2020

DRAWING TITLE

PLUMBING SCHEDULES

SHEET NO.

NATURAL GAS LOAD SCHEDULE								
EQUIPMENT	LOAD (MBH)	SERVES	PIPE SIZE	NOTES				
UNIT A	42	FURNACE 3	1"	7" MIN & 14" MAX.				
CFH @ EACH UNIT	42	METER TOTAL (11" WCI PRESSURE)		(BASED ON 213 LN. FT)				
TOTAL CFH @ BUILDING	42	METER TOTAL (11" WCI PRESSURE)		(BASED ON 213 LN. FT)				

NATURAL GAS LOAD SCHEDULE								
EQUIPMENT	LOAD (MBH)	SERVES	PIPE SIZE	NOTES				
UNIT A								
FUR-11	42	FURNACE 11	1"	7" MIN & 14" MAX.				
CFH @ EACH UNIT	42	METER TOTAL (11" WCI PRESSURE)		(BASED ON 275 IN FT)				
TOTAL CFH @ BUILDING	42	METER TOTAL (11" WCI PRESSURE)		(BASED ON 275 IN FT)				

NATURAL GAS LOAD SCHEDULE								
EQUIPMENT	LOAD (MBH)	SERVES	PIPE SIZE	NOTES				
UNIT B	42	FURNACE 1	1"	7" MIN & 14" MAX.				
CFH @ EACH UNIT	42	METER TOTAL (11" WCI PRESSURE)		(BASED ON 300 LN. FT)				
TOTAL CFH @ BUILDING	42	METER TOTAL (11" WCI PRESSURE)		(BASED ON 300 LN. FT)				

NATURAL GAS LOAD SCHEDULE									
EQUIPMENT	LOAD (MBH)	SERVES	PIPE SIZE	NOTES					
UNIT B									
FUR-5	42	FURNACE 5	1"	7" MIN & 14" MAX.					
CFH @ EACH UNIT	42	METER TOTAL (11" WCI PRESSURE)		(BASED ON 165 LN. FT)					
TOTAL CFH @ BUILDING	42	METER TOTAL (11" WCI PRESSURE)		(BASED ON 165 LN. FT)					

NATURAL GAS LOAD SCHEDULE								
EQUIPMENT	LOAD (MBH)	SERVES	PIPE SIZE	NOTES				
<u>UNIT B</u>								
FUR-7	42	FURNACE	1"	7" MIN & 14" MAX.				
CFH @ EACH UNIT	42	METER TOTAL (11" WCI PRESSURE)		(BASED ON 120 LN. FT)				
TOTAL CFH @ BUILDING	42	METER TOTAL (11" WCI PRESSURE)		(BASED ON 120 LN. FT)				

	NATURAL GAS LOAD SCHEDULE									
EQUIPMENT LOAD (MBH) SERVES PIPE SIZE NOTES										
UNIT B										
FUR-10	42	FURNACE 10	1"	7" MIN & 14" MAX.						
CFH @ EACH UNIT	42	METER TOTAL (11" WCI PRESSURE)		(BASED ON 254 LN. FT)						
TOTAL CFH @ BUILDING	42	METER TOTAL (11" WCI PRESSURE)		(BASED ON 254 LN. FT)						

NATURAL GAS LOAD SCHEDULE								
EQUIPMENT	LOAD (MBH)	SERVES	PIPE SIZE	NOTES				
UNIT B	42	FURNACE 12	1"	7" MIN & 14" MAX.				
CFH @ EACH UNIT	42	METER TOTAL (11" WCI PRESSURE)	'	(BASED ON 144 LN FT)				
TOTAL CFH @ BUILDING	42	METER TOTAL (11" WCI PRESSURE)		(BASED ON 144 LN FT)				

NATURAL GAS LOAD SCHEDULE								
EQUIPMENT	LOAD (MBH)	SERVES	PIPE SIZE	NOTES				
UNIT B								
FUR-13	42	FURNACE 13	1"	7" MIN & 14" MAX.				
CFH @ EACH UNIT	42	METER TOTAL (11" WCI PRESSURE)		(BASED ON 105 LN. FT)				
TOTAL CFH @ BUILDING	42	METER TOTAL (11" WCI PRESSURE)		(BASED ON 105 LN. FT)				

NATURAL GAS LOAD SCHEDULE					
EQUIPMENT	LOAD (MBH)	SERVES	PIPE SIZE	NOTES	
HOUSE					
DOAU-1	60	DEDICATED OUTSIDE AIR UNIT	1-1/4"	7" MIN & 14" MAX.	
CFH @ EACH UNIT	60	METER TOTAL (11" WCI PRESSURE)		(BASED ON 275 LN. F	
TOTAL CFH @ BUILDING	60	METER TOTAL (11" WCI PRESSURE)		(BASED ON 275 LN. F	

	NATURAL GAS LOAD SCHEDULE				
EQUIPMENT	LOAD (MBH)	SERVES	PIPE SIZE	NOTES	
UNIT C					
FUR-8	42	FURNACE 8	1"	7" MIN & 14" MAX.	
CFH @ EACH UNIT	42	METER TOTAL (11" WCI PRESSURE)		(BASED ON 350 LN. FT)	
TOTAL CFH @ BUILDING	42	METER TOTAL (11" WCI PRESSURE)		(BASED ON 350 LN. FT)	

NATURAL GAS LOAD SCHEDULE				
EQUIPMENT	LOAD (MBH)	SERVES	PIPE SIZE	NOTES
LINIT				
UNIT C			.,,	
FUR-15	42	FURNACE 15	1"	7" MIN & 14" MAX.
CFH @ EACH UNIT	42	METER TOTAL (11" WCI PRESSURE)		(BASED ON 45 LN. FT)
TOTAL CFH @ BUILDING	42	METER TOTAL (11" WCI PRESSURE)		(BASED ON 45 LN. FT)

NATURAL GAS LOAD SCHEDULE				
EQUIPMENT	LOAD (MBH)	SERVES	PIPE SIZE	NOTES
UNIT C FUR-18	42	FURNACE 18	1"	7" MIN & 14" MAX.
CFH @ EACH UNIT	42	METER TOTAL (11" WCI PRESSURE)		(BASED ON 360 LN. FT)
TOTAL CFH @ BUILDING	42	METER TOTAL (11" WCI PRESSURE)		(BASED ON 360 LN. FT)

NATURAL GAS LOAD SCHEDULE				
EQUIPMENT	LOAD (MBH)	SERVES	PIPE SIZE	NOTES
UNIT C				
FUR-26	42	FURNACE 26	1"	7" MIN & 14" MAX.
CFH @ EACH UNIT	42	METER TOTAL (11" WCI PRESSURE)		(BASED ON 60 LN. F
TOTAL CFH @ BUILDING	42	METER TOTAL (11" WCI PRESSURE)		(BASED ON 60 LN. F

NATURAL GAS LOAD SCHEDULE				
EQUIPMENT	LOAD (MBH)	SERVES	PIPE SIZE	NOTES
UNIT D				
FUR-9	56	FURNACE 9	1"	7" MIN & 14" MAX.
CFH @ EACH UNIT	56	METER TOTAL (11" WCI PRESSURE)		(BASED ON 295 LN. FT)
TOTAL CFH @ BUILDING	56	METER TOTAL (11" WCI PRESSURE)		(BASED ON 295 LN. FT)

	NATURAL GAS LOAD SCHEDULE				
EQUIPMENT	LOAD (MBH)	SERVES	PIPE SIZE	NOTES	
UNIT D					
FUR-14	56	FURNACE 14	1"	7" MIN & 14" MAX.	
CFH @ EACH UNIT	56	METER TOTAL (11" WCI PRESSURE)		(BASED ON 75 LN. FT)	
TOTAL CFH @ BUILDING	56	METER TOTAL (11" WCI PRESSURE)		(BASED ON 75 LN. FT)	

NATURAL GAS LOAD SCHEDULE					
EQUIPMENT	LOAD (MBH)	SERVES	PIPE SIZE	NOTES	
UNIT D					
FUR-19	56	FURNACE 19	1"	7" MIN & 14" MAX.	
CFH @ EACH UNIT	56	METER TOTAL (11" WCI PRESSURE)		(BASED ON 315 LN. FT)	
TOTAL CFH @ BUILDING	56	METER TOTAL (11" WCI PRESSURE)		(BASED ON 315 LN. FT)	

NATURAL GAS LOAD SCHEDULE				
EQUIPMENT	LOAD (MBH)	SERVES	PIPE SIZE	NOTES
UNITE				
FUR-2	42	FURNACE 2	1"	7" MIN & 14" MAX.
CFH @ EACH UNIT	42	METER TOTAL (11" WCI PRESSURE)		(BASED ON 270 LN. FT)
TOTAL CFH @ BUILDING	42	METER TOTAL (11" WCI PRESSURE)		(BASED ON 270 LN. FT)
	•		-	-

NATURAL GAS LOAD SCHEDULE					
EQUIPMENT	LOAD (MBH)	SERVES	PIPE SIZE	NOTES	
UNIT E					
FUR-4	42	FURNACE 4	1"	7" MIN & 14" MAX.	
CFH @ EACH UNIT	42	METER TOTAL (11" WCI PRESSURE)		(BASED ON 210 LN. FT)	
TOTAL CFH @ BUILDING	42	METER TOTAL (11" WCI PRESSURE)		(BASED ON 210 LN. FT)	

NATURAL GAS LOAD SCHEDULE					
EQUIPMENT	LOAD (MBH)	SERVES	PIPE SIZE	NOTES	
UNIT E					
FUR-6	42	FURNACE 6	1"	7" MIN & 14" MAX.	
CFH @ EACH UNIT	42	METER TOTAL (11" WCI PRESSURE)		(BASED ON 165 LN. FT)	
TOTAL CFH @ BUILDING	42	METER TOTAL (11" WCI PRESSURE)		(BASED ON 165 LN. FT)	

NATURAL GAS LOAD SCHEDULE				
EQUIPMENT	LOAD (MBH)	SERVES	PIPE SIZE	NOTES
UNIT I				
FUR-17	56	FURNACE 17	1"	7" MIN & 14" MAX.
CFH @ EACH UNIT	56	METER TOTAL (11" WCI PRESSURE)		(BASED ON 84 LN. FT)
TOTAL CFH @ BUILDING	56	METER TOTAL (11" WCI PRESSURE)		(BASED ON 84 LN. FT)

NATURAL GAS LOAD SCHEDULE						
EQUIPMENT	EQUIPMENT LOAD (MBH) SERVES PI					
<u>UNIT F</u>	UNIT F					
FUR-22	42	FURNACE 22	1"	7" MIN & 14" MAX.		
CFH @ EACH UNIT	42	METER TOTAL (11" WCI PRESSURE)		(BASED ON 210 LN. FT)		
TOTAL CFH @ BUILDING	42	METER TOTAL (11" WCI PRESSURE)		(BASED ON 210 LN. FT)		

NATURAL GAS LOAD SCHEDULE					
EQUIPMENT	LOAD (MBH)	SERVES	PIPE SIZE	NOTES	
UNIT G					
FUR-20	56	FURNACE 20	1"	7" MIN & 14" MAX.	
CFH @ EACH UNIT	56	METER TOTAL (11" WCI PRESSURE)		(BASED ON 293 LN. FT	
TOTAL CFH @ BUILDING	56	METER TOTAL (11" WCI PRESSURE)		(BASED ON 293 LN. FT	


NATURAL GAS LOAD SCHEDULE					
EQUIPMENT	LOAD (MBH)	SERVES	PIPE SIZE	NOTES	
UNIT G					
FUR-23	56	FURNACE 23	1"	7" MIN & 14" MAX.	
CFH @ EACH UNIT	56	METER TOTAL (11" WCI PRESSURE)		(BASED ON 195 LN. FT)	
TOTAL CFH @ BUILDING	56	METER TOTAL (11" WCI PRESSURE)		(BASED ON 195 LN. FT)	

NATURAL GAS LOAD SCHEDULE					
EQUIPMENT	LOAD (MBH)	SERVES	PIPE SIZE	NOTES	
UNIT G					
FUR-25	56	FURNACE 25	1"	7" MIN & 14" MAX.	
CFH @ EACH UNIT	56	METER TOTAL (11" WCI PRESSURE)		(BASED ON 135 LN. FT)	
TOTAL CFH @ BUILDING	56	METER TOTAL (11" WCI PRESSURE)		(BASED ON 135 LN. FT)	

EQUIPMENT LOAD (MBH)		SERVES	PIPE SIZE	NOTES
UNIT H				
FUR-16	42	FURNACE 16	1"	7" MIN & 14" MAX.
CFH @ EACH UNIT	42	METER TOTAL (11" WCI PRESSURE)		(BASED ON 197 LN. F
TOTAL CFH @ BUILDING	42	METER TOTAL (11" WCI PRESSURE)		(BASED ON 197 LN. F

EQUIPMENT LOAD (MBH)		SERVES	PIPE SIZE	NOTES
UNIT H				
FUR-21	42	FURNACE 21	1"	7" MIN & 14" MAX.
CFH @ EACH UNIT	42	METER TOTAL (11" WCI PRESSURE)		(BASED ON 285 LN. FT
TOTAL CFH @ BUILDING	42	METER TOTAL (11" WCI PRESSURE)		(BASED ON 286 LN. FT

NATURAL GAS LOAD SCHEDULE						
EQUIPMENT	LOAD (MBH)	SERVES	PIPE SIZE	NOTES		
UNIT H						
FUR-24	42	FURNACE 24	1"	7" MIN & 14" MAX.		
CFH @ EACH UNIT	42	METER TOTAL (11" WCI PRESSURE)		(BASED ON 176 LN' FT)		
TOTAL CFH @ BUILDING	42	METER TOTAL (11" WCI PRESSURE)		(BASED ON 176 LN. FT)		

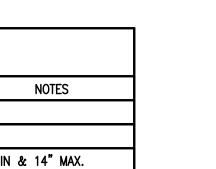

OWNER BRUSH PARK DEVELOPMENT COMPANY PHASE 1 LLC 1092 Woodward Ave. Detroit, MI 48226

REGISTRATION

ARCHITECT MERGE ARCHITECTS, INC. 332 CONGRESS ST. FLOOR 6 BOSTON, MA 02210 T: 617.670.0265

STRUCTURAL ENGINEER

MECHANICAL ENGINEER SELLINGER ASSOCIATES, INC. 19821 FARMINGTON ROAD LIVONIA, MI 48152 T: 248 482 0045

ELECTRICAL ENGINEER ETS ENGINEERING, INC. 418-1/2 S. WASHINGTON BLVD. ROYAL OAK, MI 48067 T: 248 744 0360

CIVIL ENGINEER

Duplette **Brush Park**On Edmunc
Between Br
Detroit MI, 4

05/15/2020 100% CD / PERMIT SET


THE CONTRACTOR IS RESPONSIBLE
FOR MATERIALS, DETAILS AND
ACCURACY, FOR ALL QUANTITIES AND
DIMENSIONS, FOR SELECTING
FABRICATION PROCESSES, FOR
TECHNIQUES OF ASSEMBLY, FOR
PERFORMING WORK IN A SAFE
MANNER AND FOR COORDINATING MANNER, AND FOR COORDINATING WORK WITH THAT OF ALL TRADES

JOB NO.: AS NOTED DATE: 05/15/2020

DRAWING TITLE

PLUMBING SCHEDULES

SHEET NO.

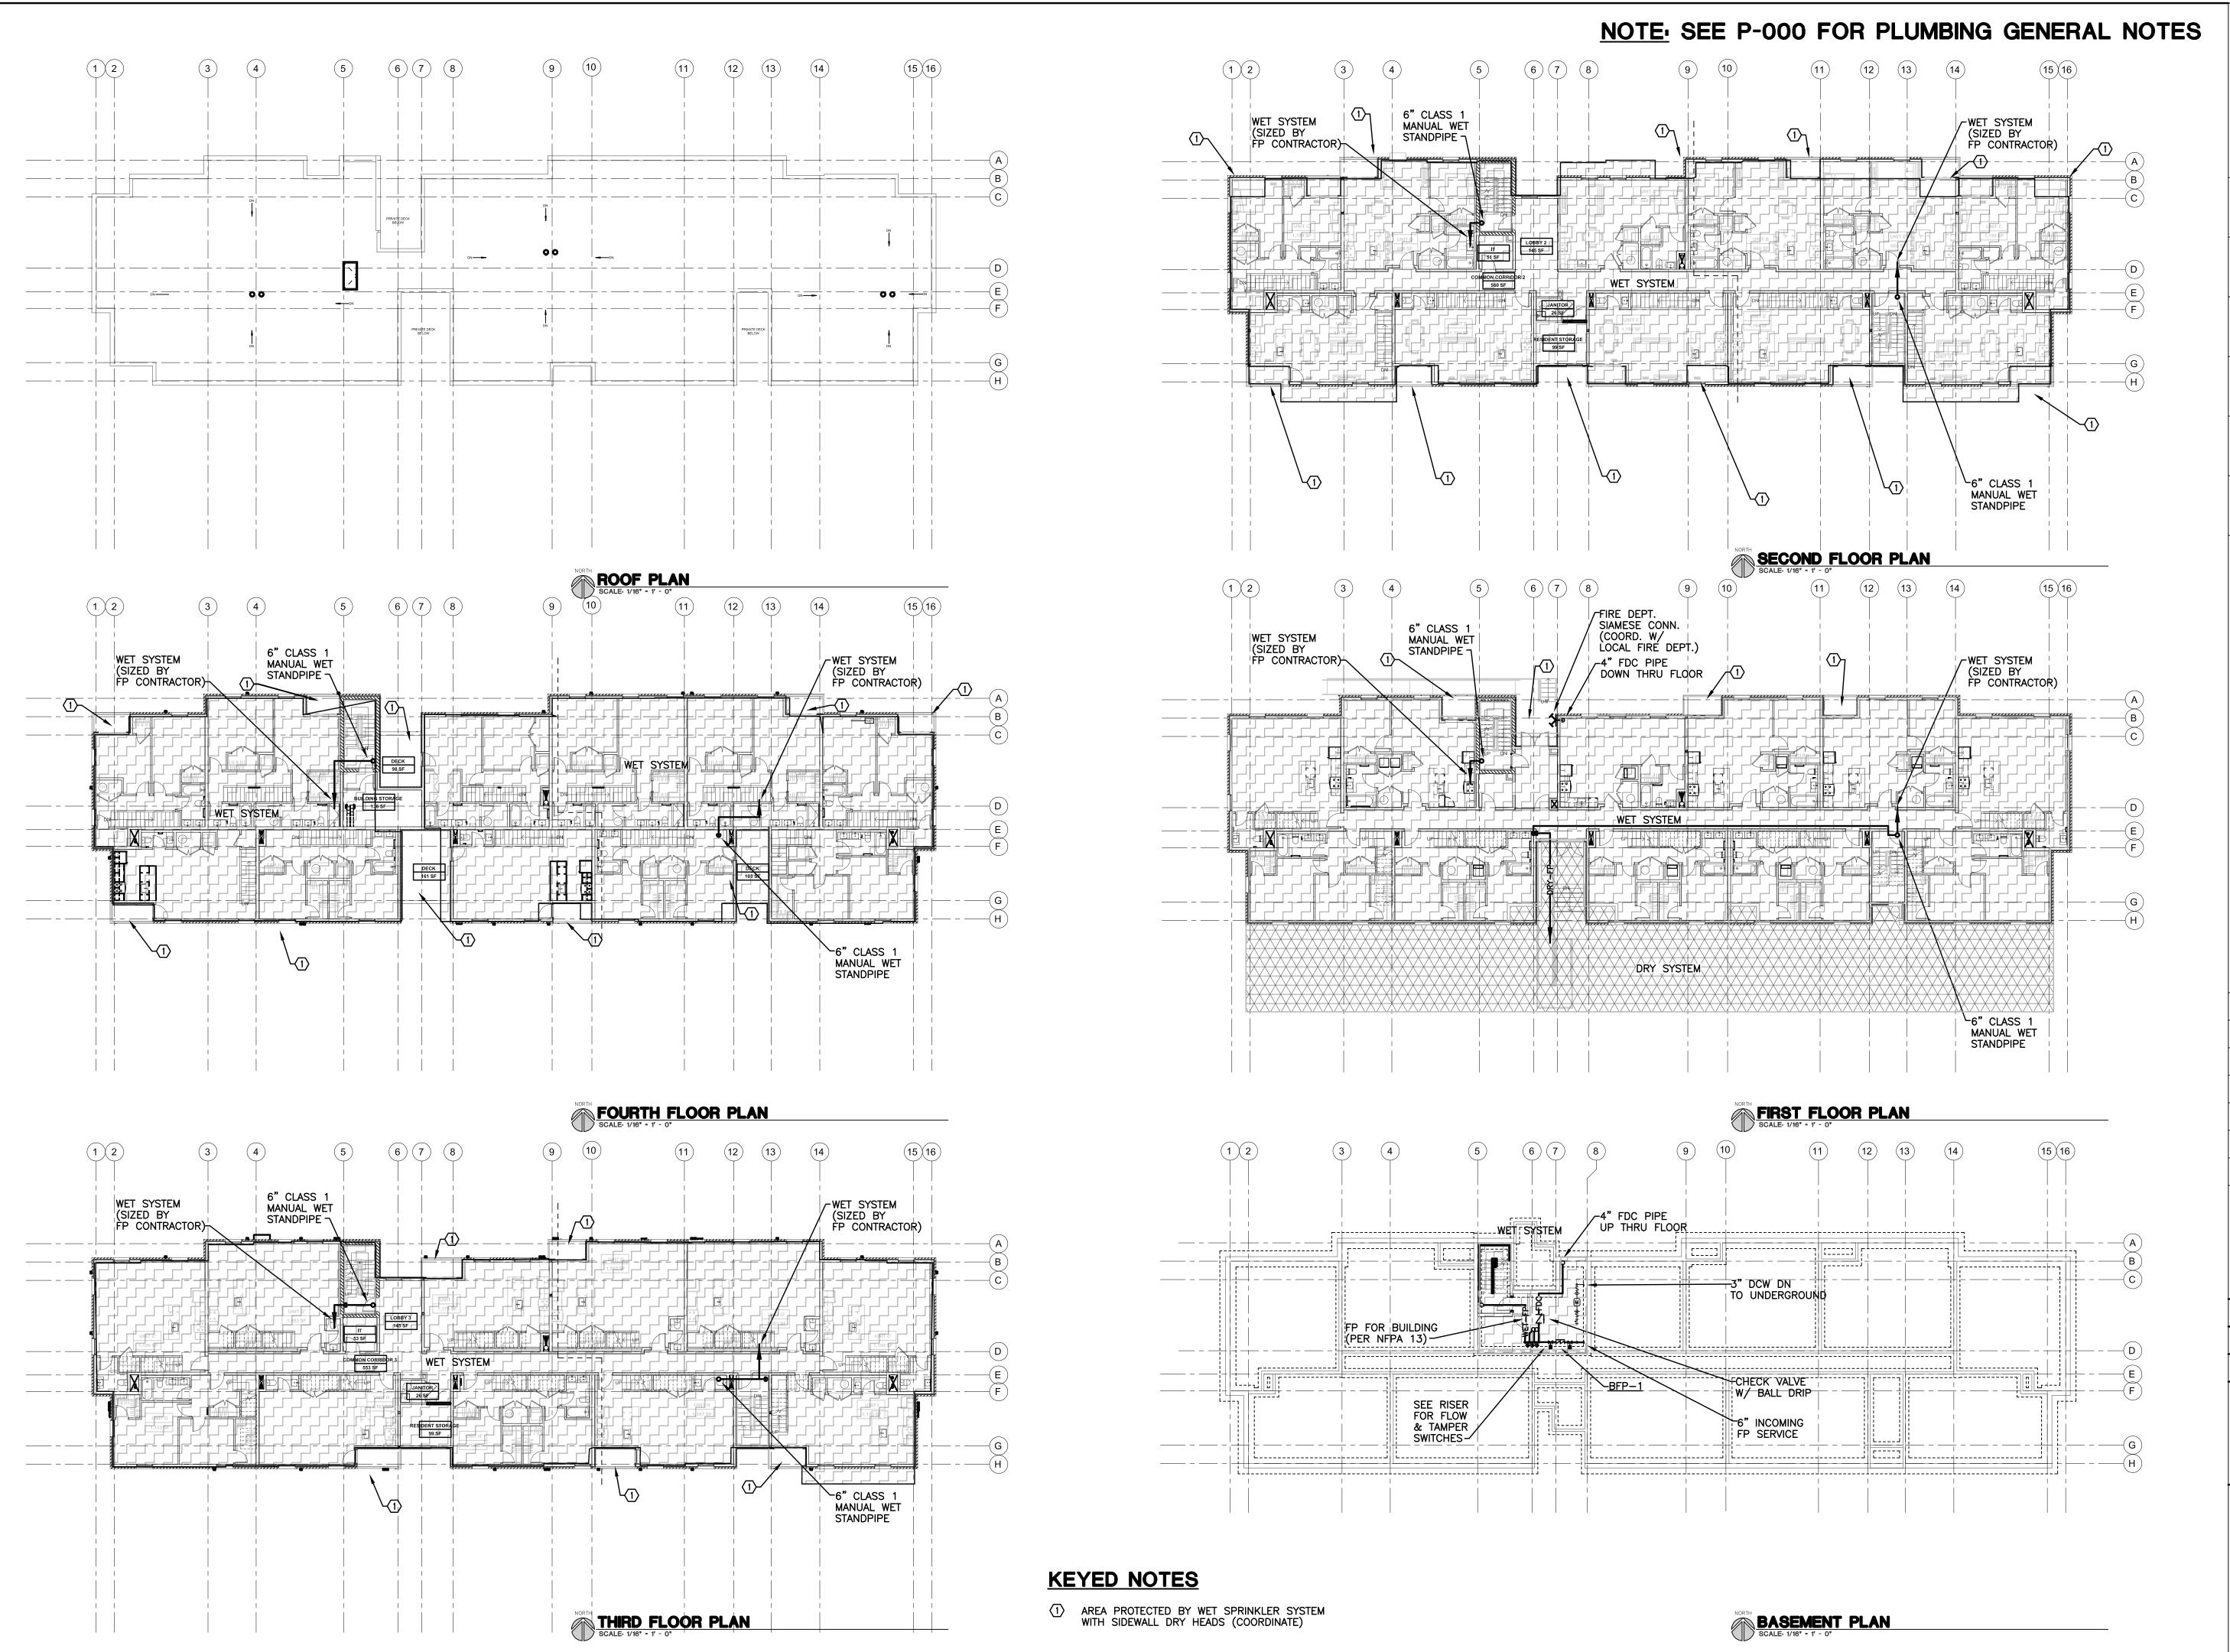



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CIVIL ENGINEER

MER

and **Duplette** Place ush St. 8201 rush (4820) O On Edmur Between E Detroit MI, Edmur Brush Pai

05/15/2020 100% CD / PERMIT SET

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JOB NO.:	18284
SCALE:	AS NOTED
DATE:	05/15/2020

DRAWING TITLE

FIRE PROTECTION **PLANS**

SHEET NO.

P-600

ELECTRICAL SYMBOL LIST

IBOL	<u>DESCRIPTION</u>	<u>SYMBOL</u>	DESCRIPTION
\$	DEVICES TO BE DECORA STYLE WITH FLAT TOGGLE SWITCHES SINGLE POLE TOGGLE SWITCH	F	QUAD FLOOR MOUNTED RECEPTACLE
\$ 2	TWO POLE TOGGLE SWITCH	₽ F	DUPLEX FLOOR MOUNTED RECEPTACLE
\$ 3	3 WAY TOGGLE SWITCH		SPECIAL RECEPTACLE—NEMA CONFIGURATION AS NOTED
\$ 4	4 WAY TOGGLE SWITCH		QUAD RECEPTACLE/LOW VOLTAGE SYSTEM FLOOR BOX
\$ K	KEY OPERATED SWITCH		GOND NECEL FACELY FOR YOUTHOU STOTEM FEOON BOX
\$ 3K	3 WAY KEY OPERATED SWITCH	♥ ▼ _F	DUPLEX RECEPTACLE/LOW VOLTAGE SYSTEM FLOOR BO
\$ 4K	4 WAY KEY OPERATED SWITCH	×	VERTICAL RISER FOR SURFACE RACEWAY
\$ D	DIMMER SWITCH MATCH LIGHTING FOR LINE OR 0-10V		PANEL 208Y/120 VOLT
\$ 3D	3 WAY DIMMER SWITCH		DISTRIBUTION PANEL
\$ P	PILOT SWITCH		MAIN DISTRIBUTION PANEL/MAIN SWITCHBOARD MOTOR CONTROL CENTER
\$ os	MANUAL ON/AUTO OFF OCCUPANCY SENSOR WALL SWITCH	T#	TRANSFORMER
\$ L	LOCKABLE SINGLE POLE SWITCH		ELECTRIC MOTOR
\$м	HORSE POWER RATED SWITCH		MANUAL MOTOR STARTER
\$D OS	MANUAL ON/AUTO OFF OCCUPANCY SENSOR WITH DIMMING — MATCH LIGHTING FOR LINE OR 0-10V	∠ P	MANUAL MOTOR STARTER WITH PILOT LIGHT
0S	CEILING MOUNTED OCCUPANCY SENSOR		MOTOR STARTER
OS D	CEILING MOUNTED DAYLIGHT SENSOR	⊠	COMBINATION MOTOR STARTER
Р	OCCUPANCY SENSOR POWER PACK	ㅁ	NON-FUSED DISCONNECT SWITCH
LC #	PROGRAMMABLE LIGHT CONTROL SWITCH	D	FUSED DISCONNECT SWITCH
BLTC	BALLAST LOAD TRANFSER CONTROL	•	PUSH BUTTON
		0	JUNCTION BOX
<u>1/c</u>	TIMER CONTROLLER	•	HARD WIRE POWER CONNECTION
□	CONTACTOR		HARD WIRE CONNECTION AT FLOOR BOX
®	PHOTOELECTRIC CONTROLLER	^	CIRCUIT BREAKER
Ф ф	SINGLE RECEPTACLE DEVICES TO BE DECORA STYLE IN RESIDENTIAL AREAS DUPLEX RECEPTACLE	, ,	SWITCH
*	QUAD RECEPTACLE		FUSE
"	DUPLEX RECEPTACLE MOUNTED 42" AFF OR 6" ABOVE COUNTER TOP. (UNLESS NOTED OTHERWISE)	ش س	TRANSFORMER
цGFI	(SIMILAR FOR EMERGENCY RECEPTACLES)	→ →	CURRENT TRANSFORMER
ф ^{GFI}	DUPLEX RECEPTACLE-GROUND FAULT INTERRUPTER	38	POTENTIAL TRANSFORMER
∯ ^{GFI}	DUPLEX RECEPTACLE MOUNTED 42" AFF OR 6" ABOVE COUNTER TOP (UNLESS NOTED OTHERWISE)	PNL	PANEL (LIGHTING OR RECEPTACLE)
	WITH GROUND FAULT INTERRUPTER	•	NODE
ф ^{usв}	COMBINATION 3.6A USB 3.0 / 15A RECEPTACLE LEVITON T5632 OR EQUAL	Ť	GROUND
USB	4-USB-3.0 (4.2A, 25W) OUTLET LEVITON USB4P OR EQUAL		

SYMBOL	<u>DESCRIPTION</u>
어┝	NORMALLY OPEN CONTACTS
어 ! ~	NORMALLY CLOSED CONTACTS
, 	N.O. PUSH BUTTON SINGLE CIRCUIT
مله	N.C. PUSH BUTTON SINGLE CIRCUIT
MD	MOTION DETECTOR
DC	DOOR CONTACT
KP	KEY PAD
	SECURITY CAMERA
CR	CARD READER
F	MANUAL FIRE ALARM STATION
SD	SMOKE DETECTOR CONNECT TO FACP
(SD)CO	COMBINATION SMOKE/CO DETECTOR CONNECT TO FACP
S4	FIRE ALARM STROBE
HS. ⊲	FIRE ALARM HORN/STROBE
DR	MAGNETIC DOOR RELEASE
TS	TAMPER SWITCH
FS	FLOW SWITCH
FACP	FIRE ALARM CONTROL PANEL

SPECIAL SYSTEMS

L STSTEMS
SINGLE GANG OUTLET BOX FOR LOW VOLTAGE SYSTEMS. STUB RACEWAY UP INTO ACCESSIBLE CEILING SPACE. PROVIDE BUSHING. PROVIDE BLANK COVERPLATE. WIRING BY OTHERS.
SINGLE GANG OUTLET BOX FOR LOW VOLTAGE SYSTEMS MOUNTED 42" AFF OR 6" ABOVE COUNTERTOP (COORDINATE WITH MILLWORK) UNLESS NOTED OTHERWISE. STUB UP RACEWAY INTO ACCESSIBLE CEILING SPACE. PROVIDE BUSHING. PROVIDE BLANK COVERPLATE. WIRING BY OTHERS.
(TBB) TELECOMMUNICATIONS BACKBOARD

FIRE ALARM ANNUNCIATOR PANEL

VERTICAL FLUSH MOUNTED 24"L x 14"W x 4"D BELDEN XRES2414 WITH VENTED COVER XRES2414VHD. PROVIDE POWER RECEPTACLE IN SIDE. LOW VOLTAGE CABLE TO BE RUN IN WOOD STUDS TO 3" SLEEVES THROUGH FLOOR..

ALL "SPECIAL SYSTEMS" (TYPICALLY TELEPHONE, TV, AND DATA) WIRING AND DEVICES BY OTHERS, UNLESS NOTED ON PLANS OR SPECIFICATIONS. E.C. TO PROVIDE BOXES, RACEWAYS, BACKBOARDS, AND COVERPLATES (PER SPECIFICATIONS IF APPLICABLE). COORDINATE EXACT REQUIREMENTS OF RACEWAY AND BOX SIZES WITH LOW VOLTAGE CONTRACTOR. PRIOR TO INSTALLATION.

ELECTRICAL ABBREVIATION LIST

4-USB-3.0 (4.2A, 25W) OUTLET MOUNTED 6" ABOVE

COUNTER LEVITON USB4P OR EQUAL

ABBREVATION	<u>DESCRIPTION</u>	ABBREVATION	<u>DESCRIPTION</u>	ABBREVATION	DESCRIPTION
A AFF	AMPHERE ABOVE FINISH FLOOR	GFI GRD	GROUND FAULT INTERRUPTER GROUND	NC NF	NORMALLY CLOSED NON-FUSIBLE
AFG	ABOVE FINISH GRADE	GRC	GALVANIZED RIGID CONDUIT	NIC	NOT IN CONTRACT
AHU	AIR HANDLING UNIT	НОА	HAND-OFF-AUTO	NL	NIGHT LIGHT
AIC	AMPS INTERRUPTING CAPACITY	HP	HORSEPOWER	NO	NORMALLY OPEN
BKR	BREAKER	HZ	HERTZ	NTS	NOT TO SCALE
BPS	BOLTED PRESSURE SWITCH	IG	ISOLATED GROUND	RECEPT. RP	RECEPTACLE RECEPTACLE PANEL
CB CIR/CKT	CIRCUIT BREAKER CIRCUIT	JB	JUNCTION BOX	RTU	ROOF TOP UNIT
CLG	CEILING	KW	KILOWATT	SD	SMOKE DETECTOR
CP	CIRCULATION PUMP	KWH	KILOWATT - HOURS	SPEC	SPECIFICATION
CUH	CABINET UNIT HEATER	KVA	KILO VOLT-AMPERES		
				TELCOM	TELECOMMUNICATIONS
DED	DEDICATED	LP	LIGHTING PANEL	TYP	TYPICAL
DISC	DISCONNECT	LO	LOCK-ON		
DP	DISTRIBUTION PANEL			UH	UNIT HEATER
DWG	DRAWING	MCA	MINIMUM CIRCUIT AMPACITY	U.O.N.	UNLESS OTHERWISE NOTED
50.		MCB	MAIN CIRCUIT BREAKER		
EBU	EMERGENCY BATTERY UNIT	MCC	MOTOR CONTROL CENTER	WP	WEATHERPROOF
EF	EXHAUST FAN	MDP	MAIN DISTRIBUTION PANEL	WG	WIRE GUARD
EM	EMERGENCY	MLO	MAIN LUGS ONLY		
EM/NL	EMERGENCY/NIGHT LIGHT	MSB	MAIN SWITCHBOARD	T#	TRANSFORMER
EUH	ELECTRIC UNIT HEATER	MTD	MOUNTED	/ r\	
EWC	ELECTRIC WATER COOLER	MUA	MAKE-UP AIR UNIT	(E)	EXISTING
EWH	ELECTRIC WATER HEATER			(R)	RELOCATED
FLA	FULL LOAD AMPS			(NI)	
F	FUSE			(N)	NEW

STANDARD MOUNTING HEIGHTS

CONVENIENCE AND SPECIAL PURPOSE RECEPTACLE OUTLETS AND LOW VOLTAGE SYSTEMS OUTLETS NOT OTHERWISE SPECIFIED	18" AFF TO CENTER OF BOX
CONVENIENCE AND SPECIAL PURPOSE RECEPTACLE OUTLETS AND LOW VOLTAGE SYSTEMS OUTLETS NOT OTHERWISE SPECIFIED IN CMU WALLS	24" AFF TO TOP OF BOX
LIGHT SWITCHES, MOTOR CONTROL DEVICES AND FIRE ALARM PULL STATIONS NOT OTHERWISE SPECIFIED	48" AFF TO TOP OF BOX
FIRE ALARM HORNS, SPEAKERS, STROBES	80" AFF OR 6" BELOW CEILING, WHICHEVER IS LESS
CLOCKS AND COMBINATION DEVICES NOT OTHERWISE SPECIFIED	96" AFF OR 6" BELOW CEILING, WHICHEVER IS LESS
GFI RECEPTACLES IN TOILET ROOMS AND JANITOR CLOSETS NOT OTHERWISE SPECIFIED	42" AFF TO CENTER OF BOX
LIGHTING AND RECEPTACLE BRANCH CIRCUIT PANELBOARDS AND LIGHTING CONTROLLERS NOT OTHERWISE SPECIFIED	6'-6" AFF TO TOP OF ENCLOSURE

** COORDINATE EXACT MOUNTING HEIGHTS WITH ARCHITECT/MILLWORK PRIOR TO ROUGH-IN. **

GENERAL POWER NOTES:

1. ALL ELECTRICAL DEVICES AND ASSOCIATED OUTLET BOXES SHALL BE FLUSH MOUNTED UNLESS OTHERWISE NOTED. ALL CONDUIT AND WIRING SHALL BE CONCEALED WHERE PHYSICALLY POSSIBLE, SURFACE RACEWAY SHALL ONLY BE PERMITTED WHERE NOTED.

2. PROVIDE AN EQUIPMENT GROUNDING CONDUCTOR WITHIN THE RACEWAYS ALONG WITH PHASE CONDUCTORS FOR ALL FEEDERS AND BRANCH CIRCUITS. CONDUIT IS NOT PERMITTED TO ACT AS AN EQUIPMENT GROUNDING CONDUCTOR UNLESS NOTED. AN ISOLATED GROUND CONDUCTOR (GREEN/WHITE) IS REQUIRED FOR ALL ISOLATED GROUND CIRCUITS.

3. WHEREVER 4 OR MORE CURRENT CARRYING CONDUCTORS ARE INSTALLED IN A SINGLE RACEWAY, E.C. SHALL INCREASE CONDUCTOR SIZE AS REQUIRED FOR DERATING PER NEC 315.B.2.9.

4. GROUND FAULT INTERRUPTING DEVICES SHALL BE INSTALLED IN ACCESSIBLE LOCATIONS AND NOT ALLOWED BEHIND FIXED IN PLACE OR UNMOVABLE EQUIPMENT. REMOTE DEVICES MAY BE REQUIRED.

5. ALL CIRCUITS SHALL USE A MINIMUM OF 14 AWG FOR 15 AMP AND 12 AWG FOR 20 AMP CIRCUITS UNLESS OTHERWISE NOTED. ELECTRICAL CONTRACTOR SHALL CONFIRM CONDUCTOR AND CONDUIT SIZES FOR VOLTAGE DROP, A MAXIMUM OF 3% FOR BRANCH AND FEEDER AND 5% OVERALL.

6. COORDINATE WITH OTHER TRADES FOR ANY ELECTRICAL DEVICE LOCATIONS PRIOR TO ROUGH-IN. COMPLY WITH ALL APPLICABLE CODES FOR PROPER MOUNTING HEIGHTS, NFPA, NEC, ADA, ETC.

7. WHERE LOW VOLTAGE DEVICES AND RECEPTACLES ARE SHOWN NEXT TO EACH OTHER, INSTALL AS CLOSE AS POSSIBLE, DO NOT SCALE DRAWINGS.

8. ALL "SPECIAL SYSTEMS" WIRING AND DEVICES (IE. TELEPHONE, DATA, TV,) SHALL BE PROVIDED AND INSTALLED BY OTHERS UNLESS NOTED ON PLANS OR SPECIFICATIONS. E.C. TO PROVIDE BOXES AND RACEWAYS PER LEGEND AND SPECIFICATIONS. COORDINATE EXACT REQUIREMENTS WITH MANUFACTURER/SUPPLIER.

9. ALL DISCREPANCIES WITH THESE DOCUMENTS SHALL BE BROUGHT TO THE ATTENTION OF THE ENGINEER FOR CLARIFICATION PRIOR TO BIDS. IN OTHERWISE DOING SO, THE ELECTRICAL CONTRACTOR SHALL BE LIABLE FOR ANY

10. E.C. TO COORDINATE EXACT EQUIPMENTS OF ALL OTHER SYSTEMS WITH MANUFACTURER AND OTHER TRADES PRIOR TO ROUGH-IN AND PURCHASE OF ANY ELECTRICAL EQUIPMENT ASSOCIATED WITH SYSTEM. ANY DISCREPANCIES WITH THIS PLAN AND MANUFACTURER REQUIREMENTS SHALL BE BROUGHT TO THE ATTENTION OF THE ARCHITECT/ENGINEER PRIOR TO PURCHASE OR ELECTRICAL ROUGH-IN OF THIS EQUIPMENT.

GENERAL FIRE ALARM NOTES:

1. THESE PLANS REPRESENT A STANDARD ADDRESSABLE FIRE ALARM SYSTEM AND ARE NOT MEANT TO ACCOUNT FOR EVERY INDIVIDUAL ELEMENT OF A COMPLETE FIRE ALARM SYSTEM. WHEREVER POSSIBLE THESE PLANS SHOW THE PROPOSED LOCATION OF DEVICES FOR PROPER COVERAGE IN THE AREA. FIRE ALARM SUPPLIER SHALL VERIFY THESE LOCATIONS MEET PROPER COVERAGE AND SUBMIT ANY DISCREPANCIES TO ARCHITECT/ENGINEER PRIOR TO BID OR THEY ASSUME COSTS FOR ANY ADDITIONAL DEVICES.

2. FIRE ALARM SUPPLIER TO PROVIDE DETAILED SUBMITTALS FOR ISSUE TO THE AUTHORITY HAVING JURISDICTION. THESE DRAWINGS SHALL INCLUDE BATTERY CALCULATIONS, CANDELA RATINGS OR DEVICES, LOCATIONS OF DEVICES (ON MINIMUM 1/16" SCALE PLANS), FIRE ALARM ANNUNCIATOR DIAGRAMS, MATRIX OF OPERATION, AND COMPLETE DATA SHEETS FOR ALL SYSTEM COMPONENTS.

3. COORDINATE CITY TIE-IN REQUIREMENTS WITH LOCAL AUTHORITY.

4. PROVIDE DUCT TYPE SMOKE DETECTORS AND REMOTE TEST STATION IN AREA SERVED AT ALL MECHANICAL UNITS OVER 2,000 CFM PER NFPA AND OTHER LOCAL CODES (MICHIGAN MECHANICAL CODE). UNITS OVER 15,000 CFM SHALL REQUIRE 2 DUCT DETECTORS (SUPPLY AND RETURN). E.C. TO PROVIDE ALL WIRING TO FACILITATE UNIT SHUTDOWN ON SMOKE DETECTION.

5. AT ALL SMOKE OR COMBINATION SMOKE/FIRE DAMPERS, E.C. SHALL PROVIDE 120V CONNECTION TO DAMPER, RELAY TO CLOSE DAMPER FROM FIRE ALARM SYSTEM, REMOTE TEST STATION IN AREA SERVED, AND DUCT DETECTOR PER NFPA AND OTHER LOCAL CODES AND MICHIGAN MECHANICAL CODE. COORDINATE ALL LOCATIONS

6. SOME DAMPERS OR MECHANICAL UNITS REQUIRE MULTIPLE DUCT DETECTORS DUE TO DUCT SIZE AND/OR DEVICE PLACEMENT LOCATION. E.C. SHALL COORDINATE WITH MECHANICAL TRADES AND INCLUDE THESE IN THEIR

7. REMOTE TEST STATIONS SHALL HAVE ENGRAVED NAMPLATE INDICATING THE NAME OF THE ASSOCIATED UNIT OR

8. THE FIRE ALARM SYSTEM PROVIDED SHALL BE BASED ON ALL STATE AND LOCAL CODES. ANY SUSPECTED ERRORS OR OMISSIONS IN THE BID/DESIGN DRAWINGS AS DETERMINED BY THE SYSTEM SUPPLIER DURING BID REVIEW SHALL BE IMMEDIATELY BROUGHT TO THE ATTENTION OF THE ARCHITECT/ENGINEER. THE SYSTEM SUPPLIERS BID COST SHALL INCLUDE ANY REQUIRED CHANGES IN THE DESIGN TO MEET CODE COMPLIANCE.

9. SMOKE DETECTORS SHALL BE PLACED A MINIMUM 3' AWAY FROM ANY HVAC DIFFUSERS OR GRILLS. SOUNDER BASES SHALL BE UNSED IN ALL SLEEPING ROOMS.


ELEVATOR ELECTRICAL NOTES:

- 1. ELECTRICAL CONTRACTOR TO SUPPLY FEEDERS AND GROUND OF COPPER CONDUCTORS AND CIRCUIT PROTECTIVE DEVICES FROM THE BUILDING SERVICE TO CONTROLLER, IN COMPLIANCE WITH THE LOCAL CODE AND MANUFACTURE REQUIRMENTS.
- 2. MOTOR SERVICE SWITCH IN EQUIPMENT ROOM SHALL BE A LOCKABLE FUSED DISCONNECT. GROUND FAULT PROTECTION IS REQUIRED AHEAD OF FUSED DISCONNECT PER NEC 620-61. INVERSE TIME GFI BREAKER MAY BE PERMITED IN PLACE OF FUSED DISCONNECT PER MANUFACTURE REQUIRMENTS, VERIFY WITH MANUFACTURE.
- 3. ONE CAR SUPPLY SHALL INCLUDE 120V MIN. 15AMPS FOR CAR
- FAN AND LIGHTS AND SHALL BE GFI PROTECTED PER NEC 620-61. 4. LIGHT, LIGHT SWITCH AND CONVENIENCE OUTLET(S) IN EACH ELEVATOR EQUIPMENT ROOM AND PIT IS REQUIRED AND SHALL BE GFI PROTECTED PER NEC 620-85.
- 5. WHERE REQUIRED PER MANUFACTURE, PROVIDE 120V 20A GFI PROTECTED CIRCUIT FOR ELEVATOR CONTROLER FOR CONNECTION OF ELEV. LOBBY SMOKE DETECTORS.
- 6. WHERE FIRE SPRINKLER IS PRESENT IN ROOM OR SHAFT, MONITORING IS REQUIRED FROM THE FIRE ALARM PANEL FOR TAMPER SWITCH. A HEAT DETECTOR IS REQUIRED WITHIN 12" OF SPRINKLER HEAD AND MONITORED BY FIRE ALARM PANEL. A RELAY IS ALSO REQUIRED FROM THE FIRE ALARM CONTROL PANEL TO CONTROL THE ELEVATOR SHUNT TRIP BREAKER.
- 7. WHERE RELIEF VENT IS REQUIRED IN SHAFT, A SMOKE DETECTOR IS REQUIRED NEAR VENT AND MONITORED BY FIRE
- 8. WHERE FIRE/SMOKE DAMPER IS REQUIRED, A SMOKE DETECTOR IS REQUIRED AND A RELAY TO CONTROL DAMPER IN THE EVENT OF FIRE OR SMOKE CONTROLLLED THROUGH FIRE ALARM PANEL.

UNIT PLAN NOTES:

1. TYPICAL UNIT PLANS HAVE BEEN SHOWN AND ARE BASED ON SIMILAR UNIT TYPES. REFER TO SPECIFIC UNIT PLANS FOR ALL UNITS TO MATCH THE TYPICAL UNIT PLANS.

REGISTRATION

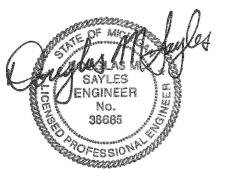

OWNER

BRUSH PARK DEVELOPMENT COMPANY Detroit, MI 48226

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11/12/18: 100% SCHEMATIC DESIGN SET 02/07/20: 100% DESIGN DEVELOPMENT SET

05/15/20: PERMIT

THE CONTRACTOR IS RESPONSIBLE

FOR MATERIALS, DETAILS AND ACCURACY, FOR ALL QUANTITIES AND DIMENSIONS, FOR SELECTING **FABRICATION PROCESSES, FOR** TECHNIQUES OF ASSEMBLY, FOR PERFORMING WORK IN A SAFE MANNER, AND FOR COORDINATING WORK WITH THAT OF ALL TRADES

JOB NO.:	18284
SCALE:	AS INDICATED
DATE:	02/07/2020

DRAWING TITLE

ELECTRICAL SYMBOLS LIST, GENERAL NOTES

SHEET NO.

		N - BASEMENT ASE, WIRE - 120/208V, 3PH	. 4W						, A	MTG -	SURFA
OLIA 200A		ASE, WIRE - 120/208V, 3PH	, 4 ۷۷				,			KR. TYPE	
CIR. NO.	BKR	DESCRIPTION	REC. VA	LTG VA	MISC.	CIR.	BKR	DESCRIPTION	REC VA	LTG VA	MIS
1	20/1	TBB-1	360			2	20/1	FACP (LOCKON)			110
3	20/1	TBB-2	360			4	20/1	LOBBY AREA LTG		350	
5	20/1	SEP (2)			792	6	15/2	ECUH			200
7	20/1	SP (2)			792	8					
9	20/1	BASEMENT RECEPT (3)	540			10	15/3	ECUH			400
11	20/1	EF-3			1200	12					
13	20/3	WPBP-1			3960	14					
15						16	20/1	1 ST FLR RECEPT. (8)	1440		
17						18	20/1	1 ST FLR LTG			
19	20/3	WPBP-1			3960	20	20/1	1 ST FLR NL/EM			
21						22	20/1	STAIR 2 LTG		1200	
23						24	15/2	ECUH			200
25	20/1	BASEMENT LTG		320		26					
27	20/1	STAIR WAY LTG		750		28	20/1	2ND FLR LOBBY AREA LTG			
29	20/1	EWH			1000	30	20/1	EWH 2ND FLR			100
31	20/1	FIRE/SMOKE DAMPERS			500	32	20/1	2ND FLR RECEPT. (4)	720		
33	20/1	EXIT/ ENTERANCE LTG		240		34	20/1	2ND FLR RECEPT. (4)	720		
35	15/3	ECUH			4000	36	15/2	ECWH			200
37						38					
39						40	20/1	2ND FLR LTG			
41	20/1	3RD FLR LOBBY AREA LTG		100		42	20/1	2ND FLR EM/NL LTG			
43	15/2	ECUH 3RD FLR			2000	44	20/1	3RD FLR LTG			
45						46	20/1	3RD FLR EM/NL LTG			
47	20/1	EWH 3RD FLR			1000	48	20/1	3RD FLR RECEPT. (3)	540		
49	20/1	ROOF DECK RECEPT.	540			50	20/1	3RD FLR RECEPT. (2)	360		
51	20/1	ROOF DECK LTG		200		52	20/1	3RD FLR RECEPT. (3)	540		
53	20/1	ROOF GFI	1080			54	20/1	EWH 3RD FLR			100
55	35/3	DOAU-1			8640	56	15/2	ECUH-6 3RD FLR			200
57						58					
59						60	20/1	IT ROOM	360		
61	15/2	OU-1/IU-1			2080	62	20/1	IT ROOM	360		
63						64	20/1	IT ROOM	360		
65	20/2	OU-2/IU-2			2704	66	20/1	IT ROOM	360		
67					2,04	68	20/1	IT ROOM	360		T
69	20/1	INTERCOM PNL			1200	70	20/1	IT ROOM	360		
71	20/1	INGRADE EXT. LTG		688	1,200	72	20/1	EWH-2 2ND FL	300		165
73	20/1	FP COMPRESSOR		000	F00	74	20/1	EWH-2 3RD FL			
75	20/1	FP PUMP			500	76	20/1	EWH-1			165
77	15/3	EWH-2			700	78	20/1	EF-1 3RD/ 4TH FL			100
79					4000	80	20/1	EF-1 2ND FL			100
81						82	20/1				100
83	20/1					84	20/1				\vdash
	***	PTACLES		<u> </u>	0.4	KVA	20/1			26.0	AMP
	LIGHT					KVA					AMP
OTAL	MISCE	ELLANEOUS			60.4	KVA				167.9	AMP
		NECTED				KVA					AMP
OTES:	DEMA	1. ALL MECHANICAL EQUIPMEN 2. AIC RATINGS SHALL BE CALC 3. ALL UNSWITCHED LIGHT LO 4. DEMAND LOAD COMPUTED RECEPTACLES: 10KVA (LIGHTING (CONTINUOL MISCELLANEOUS (NON-	CULATED A ADS TO BE AS FOLLO @ 100% (JS LOAD):	ND CONF E SERVICED WS: DVER 10KV 125% OF	JSING HAC IRMED PRIC USING SV VA @ 50% CONNECTI	OR TO C WITCH D PER TA	RDERING UTY BRE BLE 220 PER 21	0.44 0.19		130.9	O AMP

GENERAL	LIGHTING	NOTES:

1. FOR LUMINAIRES INFORMATION, REFER TO LUMINAIRES SCHEDULE UNLESS OTHERWISE NOTED.

2. SEE ARCHITECTURAL REFLECTED CEILING PLAN FOR EXACT LOCATION OF LUMINAIRES PRIOR TO INSTALLATION. COORDINATE ALL CEILING TRIMS AND MOUNTING HARDWARE WITH ARCHITECTURAL AND STRUCTURAL TRADES.

3. REFER TO ARCHITECTURAL DETAILS FOR ALL MOUNTING HEIGHTS OF LUMINAIRES IN EXPOSED CEILING AREAS . COORDINATE EXACT LOCATION AND MOUNTING HEIGHTS TO AVOID INTERFERENCE WITH MECHANICAL DUCTWORK, PIPING AND STRUCTURAL STEEL.

4. ALL EMERGENCY AND EXIT LIGHTS SHALL BE CONNECTED TO LOCAL LIGHTING CIRCUIT AHEAD OF CONTROLS, UNLESS OTHERWISE STATED. FOR LUMINAIRES SHOWN AS EMERGENCY (EM ONLY), POWER LOSS SENSING LEAD TO BE CONNECTED AHEAD OF CONTROL AND LUMINAIRES TO BE SWITCHED.

5. LUMINAIRES SHOWN AS NIGHT LIGHTS (NL ONLY) SHALL REMAIN ON 24 HOURS AND SHALL BE CONNECTED TO LOCAL CIRCUIT AHEAD OF CONTROL (UNLESS OTHERWISE NOTED).

6. LUMINAIRES SHOWN AS NL/EM OR EM/NL SHALL BE WIRED WITH EMERGENCY BALLAST AND SHALL REMAIN ON 24 HOURS CONNECTED TO LOCAL CIRCUIT AHEAD OF CONTROL (UNLESS OTHERWISE NOTED).

7. WHERE LIGHTING CONTROLLERS (LC) ARE SHOWN, REFER TO LIGHTING CONTROL DIAGRAM FOR WIRING

8. LUMINAIRES USING 4' FLUORESCENT LAMPS SHALL BE INCLUDED WITH 2, 3, OR 4 LAMP BALLASTS. WHERE DUAL LEVEL SWITCHING IS SHOWN, LUMINARIES SHALL BE WIRED IN TANDEM TO REDUCE THE NUMBER OF REQUIRED BALLASTS. SINGLE LAMP BALLASTS WILL NOT BE ALLOWED UNLESS THERE IS ONLY ONE LUMINAIRE IN A

9. WHERE LUMINAIRES ARE SHOWN WITH MULTIPLE SWITCHING ONE SWITCH SHALL CONTROL OUTER TWO (2) LAMPS; AND ONE SWITCH SHALL CONTROL INNER LAMP(S).

10. ALL DISCREPANCIES WITH THESE DOCUMENTS SHALL BE BROUGHT TO THE ATTENTION OF THE ENGINEER FOR CLARIFICATION PRIOR TO BIDS. IN OTHERWISE DOING SO, THE ELECTRICAL CONTRACTOR SHALL BE LIABLE FOR ANY

11. ALL ITEMS SHOWN ON PLAN ARE NEW UNLESS MARKED AS (E) FOR EXISTING OR (R) FOR RELOCATED.

		LUMINAIRE SCHEDUL	E						
SYMBOL	TYPE	DESCRIPTION	VOLT	LAMP	MANUFACTURER	SYMBOL	TYPE	DESCRIPTION	VO
٥	L1	7" DIA x %"D SLIM SURFACE DOWNLIGHT. VERIFY FINISH WITH ARCHITECT. RESIDENTIAL UNITS	120V	1000 LUMEN 2700K 15 WATT	LIGHTOLIER: S7R SERIES HALO: SMD6R12927WH SERIES		L21	4FT LONG WALL MOUNTED FIXTURE WITH LENS. PROVIDE BUILT-IN OCCUPANCY SENSOR TO DIM TO 10% DURING UNOCCUPIED HOURS.	120V
0	L2	5" DIA x %"D SLIM SURFACE DOWNLIGHT. VERIFY FINISH WITH ARCHITECT. BATHROOMS	120V	650 LUMEN 2700K 10 WATT	LIGHTOLIER: S5R SERIES HALO: SMD4R6927WH SERIES	1	EBU	POLYCARBONATE SURFACE MOUNTED EMERGENCY BATTERY UNIT WITH WHITE FINISH AND EMERGENCY BATTERY PACK CAPABLE OF FULL WATTAGE OUTPUT FOR A MINIMUM OF 90 MINUTES.	120V
	L3	24"L x 1¼"H ULTRA-MINIMAL LIGHT BAR VANITY SCONCE. WHITE FINISH PROVIDE DOOR JAM SWITCH FOR CLOSETS.	120V	1176 LUMENS 3000K 22 WATT	MODERN FORMS: WS-47925 SERIES AFX: ALNV 2FT SERIES		X/EBU	POLYCARBONATE SURFACE MOUNTED EMERGENCY BATTERY UNIT/EXIT SIGN WITH WHITE FINISH AND EMERGENCY BATTERY PACK CAPABLE OF FULL	120V
	L4	49"L x 1¼"H ULTRA-MINIMAL LIGHT BAR VANITY SCONCE. WHITE FINISH PROVIDE DOOR JAM SWITCH FOR CLOSETS.	120V	2284 LUMENS 3000K 44 WATT	MODERN FORMS: WS-47949 SERIES AFXL: ALNV 4FT SERIES	₩		WATTAGE OUTPUT FOR A MINIMUM OF 90 MINUTES.	
0-0-0	L5	49.5"L x 8"H (3) SHADE LINEAR CABLE SUSPENDED PENDANT, EXTRUDED ALUMINUM. VERIFY FINISH WITH ARCHITECT. REFER TO ARCHITECTURAL FOR MOUNTING HEIGHT. KITCHEN ISLANDS	120V	(3) E19 LED LAMP 60W EQUIV. 2700K	MUUTO: AMBIT RAIL LAMP SERIES AFXL: ECHP 44" SERIES	×	X	THERMOPLASTIC LED EXIT SIGN WITH UNIVERSAL MOUNTING, 6" HIGH WITH 3/4" STROKE RED LETTER, WHITE FINISH, AND EMERGENCY BATTERY PACK CAPABLE OF OPERATING EXIT WITH FULL INTENSITY FOR A MINIMUM OF 90 MINUTES.	120V
	L6	25"L x 4.3"H x 2.5"D LINEAR VANITY SCONCE, ACRYLIC SHADE. BRONZE OR SATIN NICKEL FINISH SELECTED BY ARCHITECT. REFER TO ARCHITECTURAL FOR MOUNTING HEIGHT. BATHROOM VANITY	120V	1252 LUMEN LED 3000K 90 CRI 24W	TECH LIGHTING: FINN 24 BATH MODERN FORMS: WS-21724-BN AFXL: CHV SERIES	∇	EMR	POLYCARBONATE SURFACE MOUNTED WEATHERPROOF REMOTE EMERGENCY (2) HEAD UNIT — CONNECT TO EXIT LIGHT (EXIT REQUIRES HIGH POWER BATTERY	M-VOLT
B	L7	5.25"DIA x 3.2"D FLUSH MOUNT CIRCULAR SCONCE, CAST GLASS, ANODIZED ALUMINUM. VERIFY FINIAH AND MOUNTING HEIGHT WITH ARCHITECT. COORIDORS	120V	550 LUMEN LED 2700K 80 CRI 8.5W	RICH BRILLIANT WILLING: CR-X-27-120-TR SERIES AFXL: ARLS SERIES	1	EBU/WP	WET LOCATION RATED POLYCARBONATE SURFACE MOUNTED EMERGENCY BATTERY UNIT GREY HOUSING AND EMERGENCY BATTERY PACK CAPABLE OF FULL WATTAGE OUTPUT FOR A MINIMUM OF 90 MINUTES.	120V
=	L7 (ALT)	5"W x 5"H x 3"D 'T' SQUARE SHAPED SCONCE, SOLID—CAST ALUMINUM, OPAQUE PMMA LENS. VERIFY MOUNTING HEIGHT WITH ARCHITECT.	120V	640 LUMEN LED 2700K 90 CRI 8.5W	RICH BRILLIANT WILLING: LD-S-XX-27-120-TR SERIES		X/WP	WET LOCATION RATED THERMOPLASTIC LED EXIT SIGN WITH UNIVERSAL MOUNTING, 6" HIGH WITH 3/4" STROKE RED LETTER, BLACK FINISH, AND	120V
	L8	48" LINEAR RECESSED LIGHTING DESIGNED FOR CEILING TYPE WITH REMOTE CLASS 2 DRIVER AND 120 DEGREE ASYMETRIC DISTRIBUTION. VERIFY GRID SYSTEM WITH ARCHITECTURAL. PROVIDE REMOTE 1200 LUMEN EM BATTERY WHERE REQUIRED ON DRAWINGS.	120V	881 LUMEN/FT 6.6 WATT/FT 3000K 80 CRI	VODE: ZIP TWO MICRO PROFILE: 707-Z2-SL-48-24-T1-0-RP-120- 1200 LUMEN ZZ-Z-S0-30-S3- 0-WH-0	X		EMERGENCY BATTERY PACK CAPABLE OF OPERATING EXIT WITH FULL INTENSITY FOR A MINIMUM OF 90 MINUTES.	
0	L9	10" DIA x 5%"D SLIM SURFACE DOWNLIGHT. VERIFY FINISH WITH ARCHITECT. LOBBY AREAS	120V	2200 LUMEN 2700K 23 WATT	LIGHTOLIER: S10R SERIES HALO: SMD12R209SWHE SERIES				
	L10	2' x 2' SURFACE MOUNTED, OPAL LENS BACK OF HOUSE AREAS.	120V	2700 LUMEN LED 3000K 80 CRI 22W	PHILIPS CORLINE: SM134V—W60L60—DPP				
	L12	4FT WALL MOUNTED DIRECT/INDIRECT LIGHTING. WHITE COLOR STAIRWELLS	120V	3600 LUMEN UP 2900 LUMEN DN 3000K 45 WATT	ALCON: 12100-23-W-D27-18-30K-ELV-WH				
0	L13	10" DIA x %"D SLIM SURFACE DOWNLIGHT. VERIFY FINISH WITH ARCHITECT. EXTERIOR CANOPY	120V	2200 LUMEN 2700K 23 WATT	LIGHTOLIER: S10R SERIES HALO: SMD12R209SWHE SERIES				
	L14	15"H x 3.1"W x 2.4"D VERTICAL OR HORIZONTAL WALL SCONCE, SOLID GLASS, PAINTED INTERIOR. IP65 RATED. VERIFY MOUNTING HEIGHT WITH ARCHITECT. EXTERIOR UNIT BALCONIES	120V	550 LUMEN LED 2700K 90 CRI 12W	RICH BRILLIANT WILLING: CHP-WH-27-120-TR-IP65 SERIES AFXL: FTS SERIES				
o	L15	13" DIAMETER IN-GRADE LED WITH CLEAR SAFTEY GLASS LENS. INCLUDE LOW VOLTAGE DIMMING WIRING BACK TO PANEL. EXTERIOR IN GRADE	120V	3346 LUMEN LED 36.2 WATT 3000K	BEGA: 77116				
	L16	WALL MOUNTED EXTERIOR WALL MOUNTED LED. BLACK COLOR. EXTERIOR RAMP AREAS	120V	19 WATT LED 3000K	BEGA: 33543				

3000 LUMEN LED

24 WATT

LITHONIA: ZL1N-48-3000LM-FST -120V-35K-80-WH SERIES LUMAX LIGHTING: CNLED62L4K96

-9FAF SERIES DAYBRITE: FSS8' SERIES

4FT LONG SURFACE MOUNTED FIXTURE WITH LENS

REGISTRATION



OWNER BRUSH PARK DEVELOPMENT COMPANY PHASE 1 LLC 1092 Woodward Ave. Detroit, MI 48226

ARCHITECT

4000 LUMEN LED

2-1.5 WATT LED

2-1.5 WATT LED

2-1.5 WATT LED

2-7 WATT MR16

HALOGEN

L.E.D.

L.E.D.

3500K

80 CRI 35 WATT

LITHONIA: BLWP4-40L-ADSM-120

-GZ10-LP835-NESPDT7-DIM10

METALUX: 4SWLED-40SL-LW-UNV-L835-CD1-SVPD2-U DAYBRITE: SF4C SERIES

LITHONIA: ELM2 LED SERIES SURE-LITES: SEL17 SERIES

LITHONIA: LHQM LED SERIES SURE-LITES: LPXC25R3 SERIES CHLORIDE: CLC SERIES

DAYBRITE: X SERIES

LIGHTOLIER: LT SERIES

LITHONIA: LQM SERIES

PRESCOLITE: NV3 SERIES

SURE-LITES: LPX7 SERIES

CHLORIDE: CLX-C4R SERIES

LITHONIA: ELA-T-Q SERIES

CHLORIDE: VLL2RGO SERIES

LITHONIA: WLTU-MR SERIES

CHLORIDE: 65X6 SERIES

LITHONIA: WLTE SERIES SURE-LITES: LPXW71/2RWHSD CHLORIDE: 60 SERIES

SURE-LITES: SELW29WHSD SERIES

METALUX: SRP25DWH SERIES

CHLORIDE: CLU2 SERIES

MERGE ARCHITECTS, INC. 332 CONGRESS ST. FLOOR 6 BOSTON, MA 02210 T: 617.670.0265

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ELECTRICAL ENGINEER

ETS ENGINEERING, INC. P.O. BOX 1166 ROYAL OAK, MI 48068 418-1/2 S. WASHINGTON AVE, ROYAL OAK, MI 48067 T: 248-744-0360

and **Duplette** nd Place Brush St. , 48201 **Brush Park** I On Edmund I On Edmund Between Br Detroit MI, ²

11/12/18: 100% SCHEMATIC DESIGN SET

02/07/20: 100% DESIGN DEVELOPMENT SET

05/15/20: PERMIT

THE CONTRACTOR IS RESPONSIBLE FOR MATERIALS, DETAILS AND ACCURACY, FOR ALL QUANTITIES AND DIMENSIONS, FOR SELECTING

MANNER, AND FOR COORDINATING WORK WITH THAT OF ALL TRADES JOB NO.: 18284

FABRICATION PROCESSES, FOR TECHNIQUES OF ASSEMBLY, FOR


PERFORMING WORK IN A SAFE


AS INDICATED 02/07/2020

DRAWING TITLE

LIGHT FIXTURE **SCHEDULE AND NOTES**

SHEET NO.

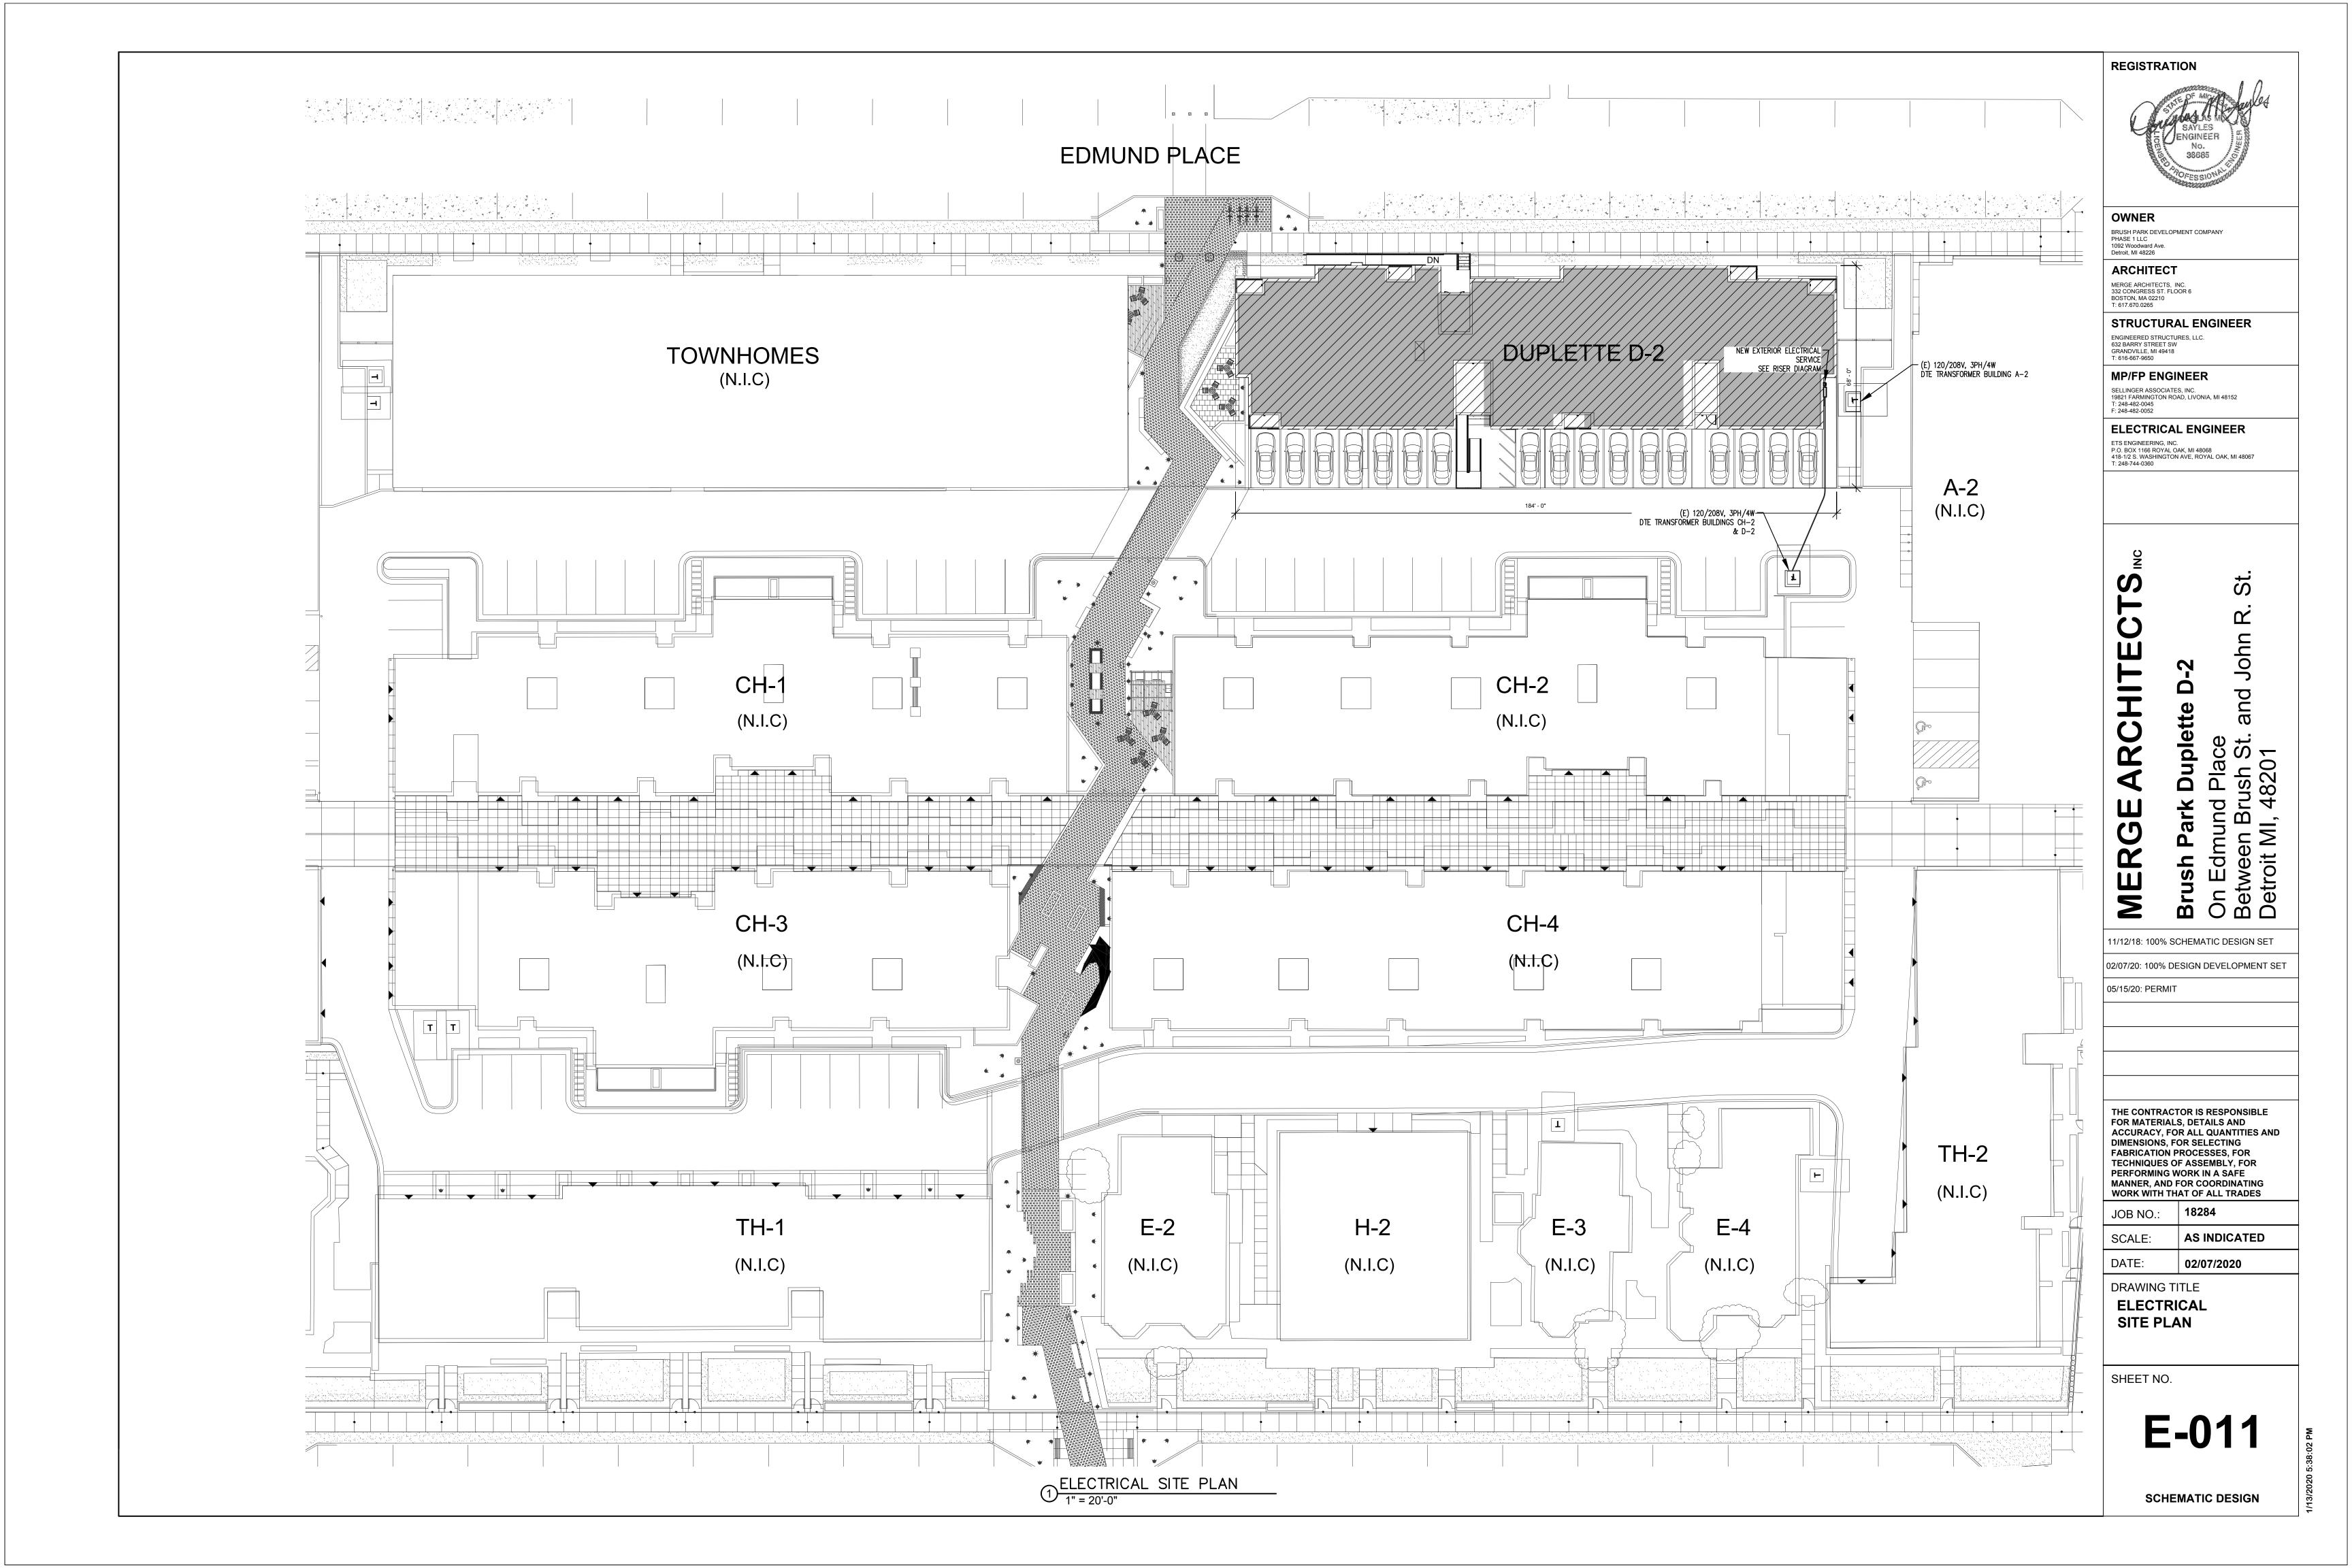

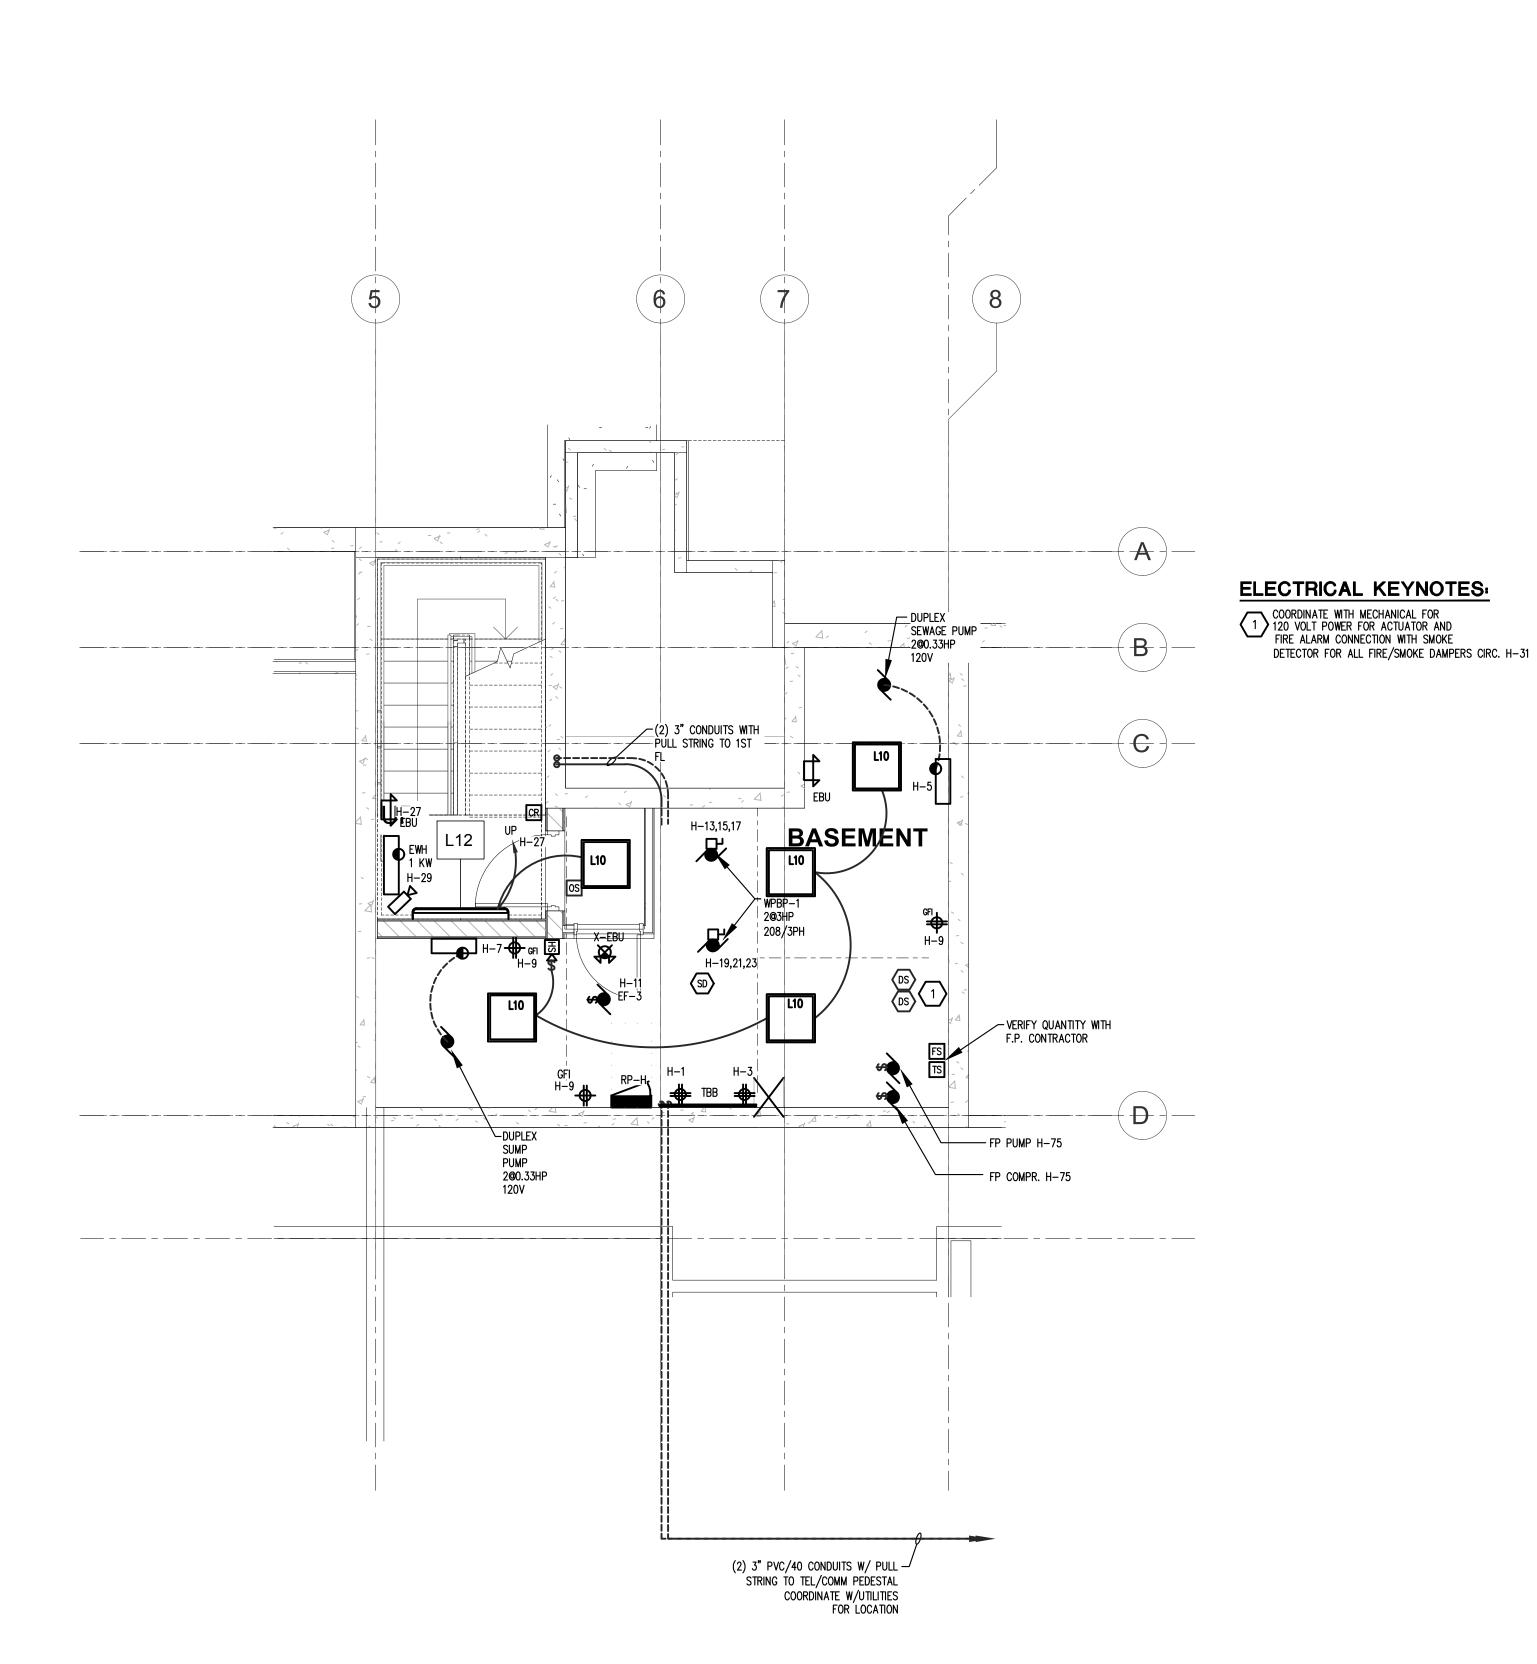



OWNER

BRUSH PARK DEVELOPMENT COMPANY PHASE 1 LLC 1092 Woodward Ave. Detroit, MI 48226

ARCHITECT

MERGE ARCHITECTS, INC. 332 CONGRESS ST. FLOOR 6 BOSTON, MA 02210 T: 617.670.0265

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Duplette MERG

Brush Parl On Edmun Between B Detroit MI,

11/12/18: 100% SCHEMATIC DESIGN SET

d Place srush St. 48201

02/07/20: 100% DESIGN DEVELOPMENT SET

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THE CONTRACTOR IS RESPONSIBLE FOR MATERIALS, DETAILS AND ACCURACY, FOR ALL QUANTITIES AND DIMENSIONS, FOR SELECTING FABRICATION PROCESSES, FOR TECHNIQUES OF ASSEMBLY, FOR PERFORMING WORK IN A SAFE MANNER, AND FOR COORDINATING WORK WITH THAT OF ALL TRADES

18284 JOB NO.: AS INDICATED 02/07/2020

DRAWING TITLE **BASEMENT**


ELECTRICAL POWER & LIGHTING PLAN


SHEET NO.

E-100

SCHEMATIC DESIGN

1 ELECTRICAL BASEMENT POWER & LIGHTING PLAN 1/8" = 1'-0"

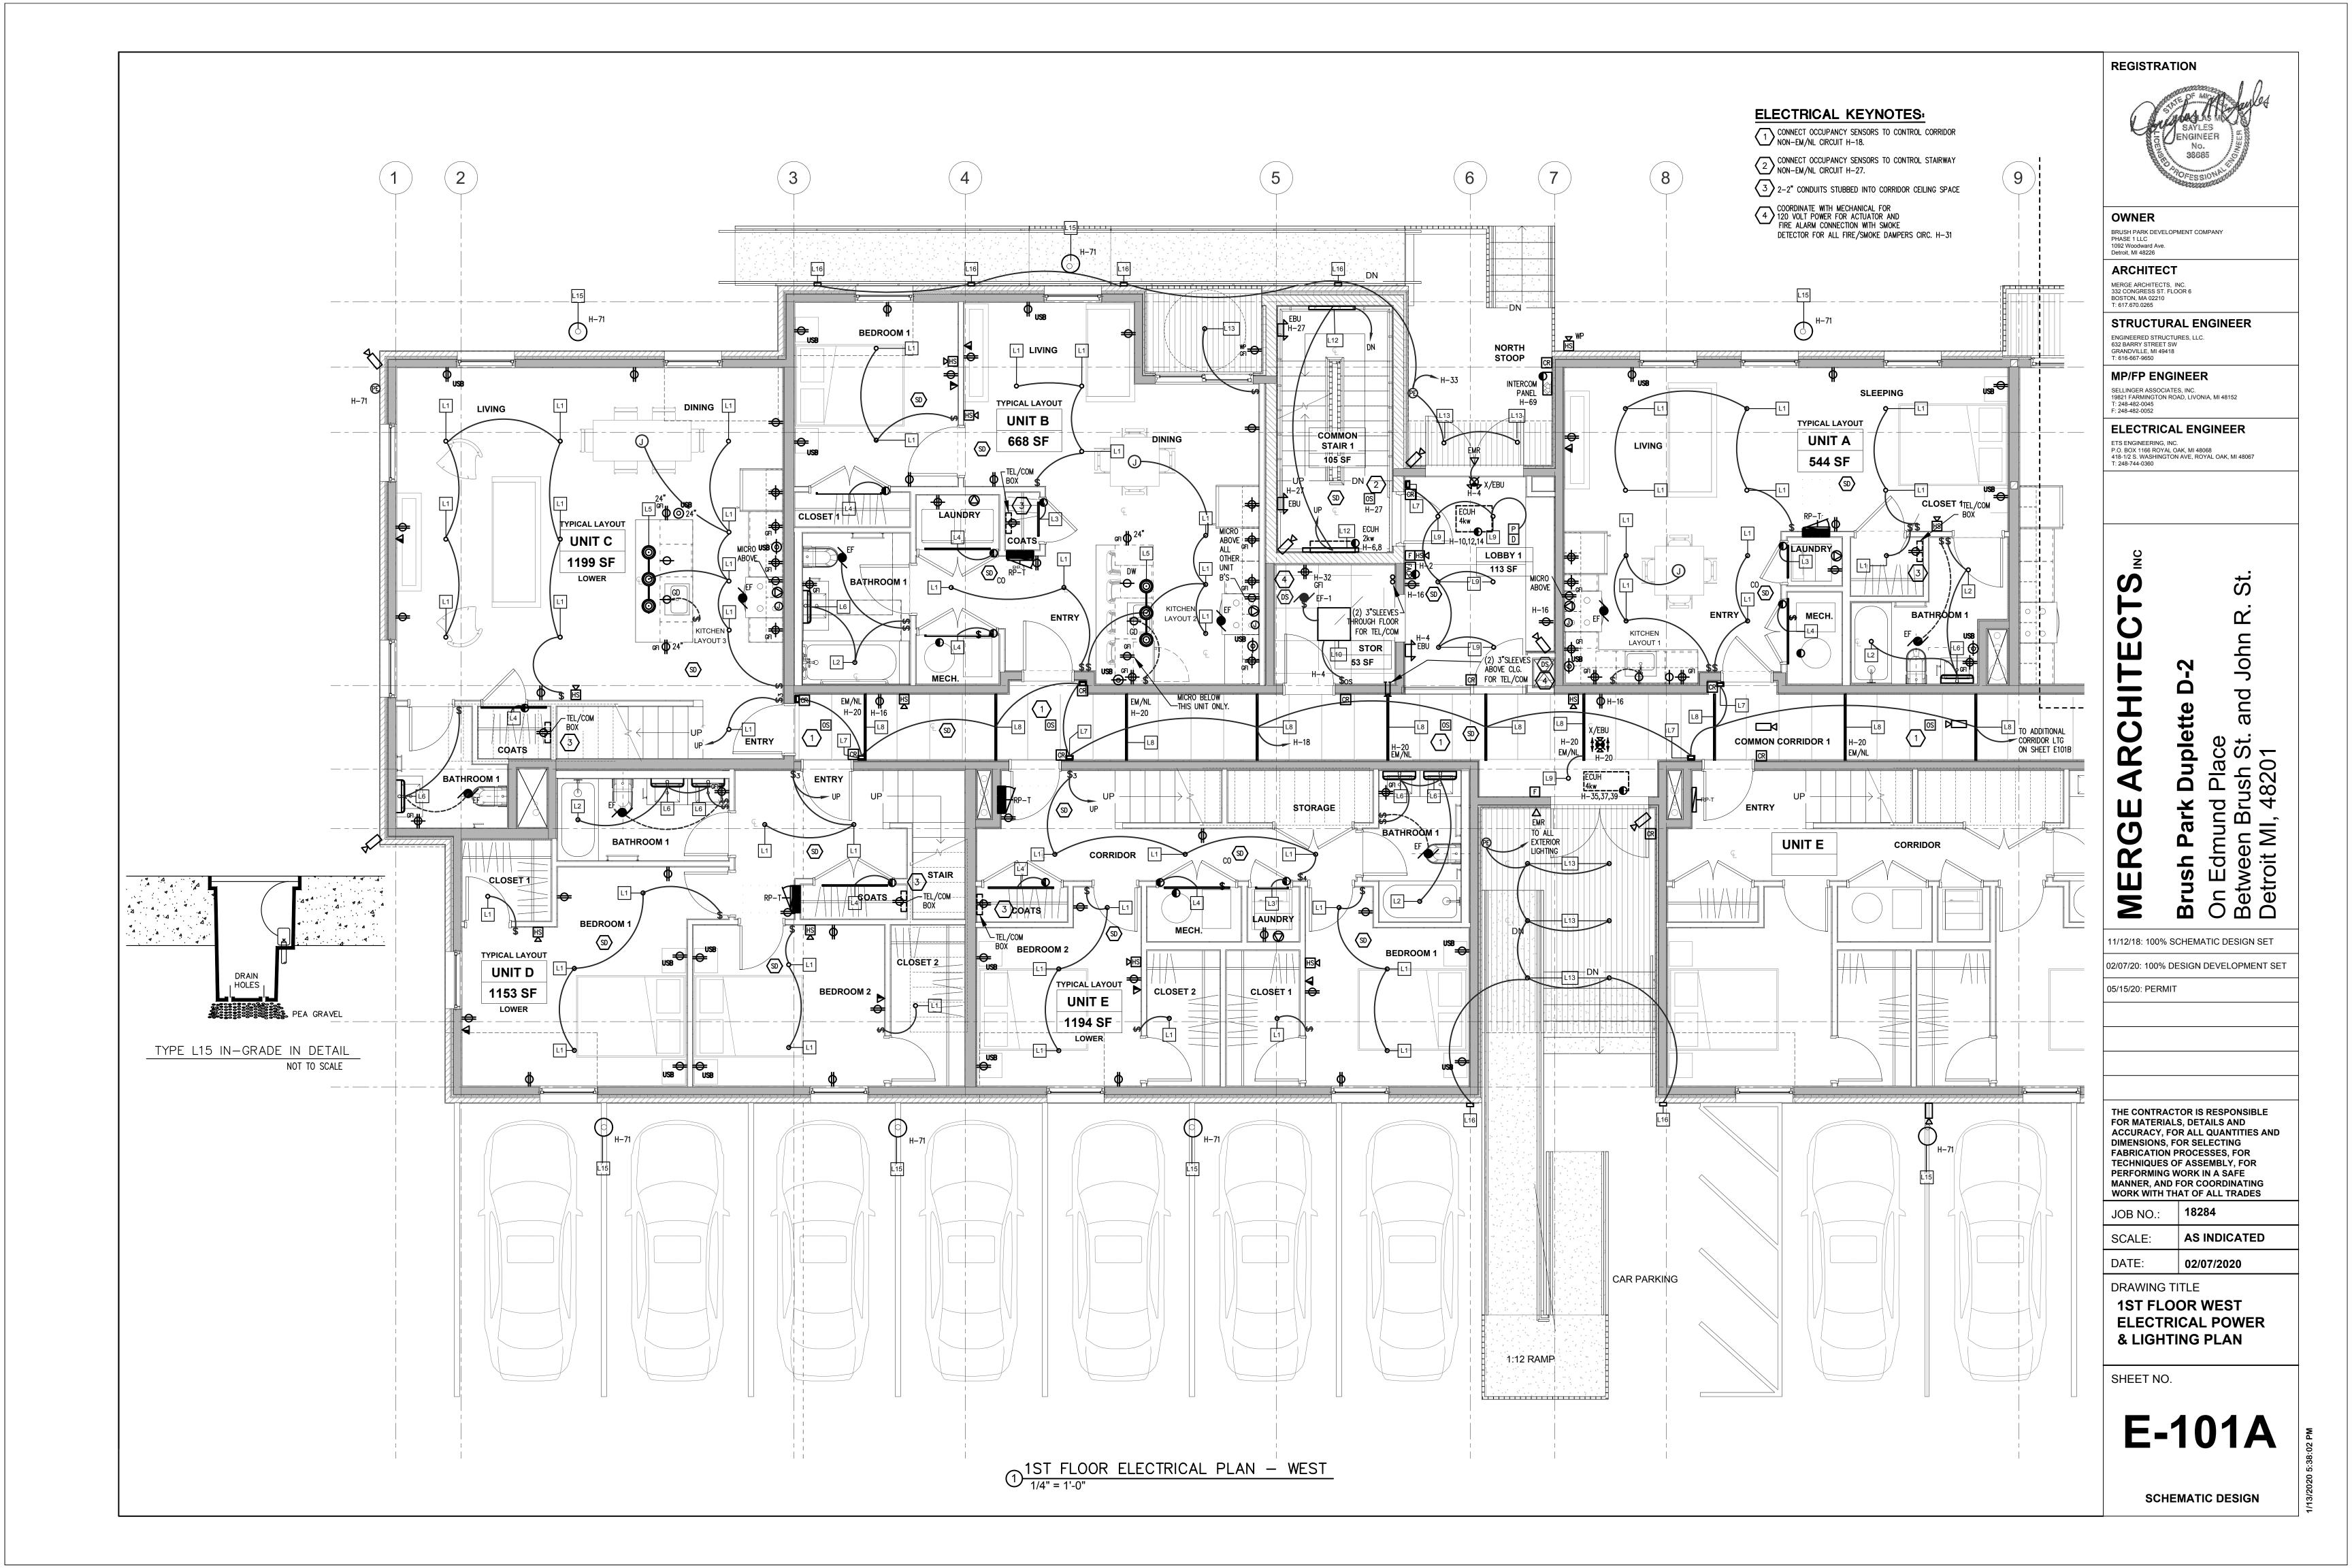

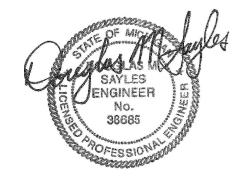

OWNER BRUSH PARK DEVELOPMENT COMPANY PHASE 1 LLC 1092 Woodward Ave. Detroit, MI 48226

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Duplette d Place srush St. 48201

Brush Par On Edmun Between B Detroit MI, MERGI 11/12/18: 100% SCHEMATIC DESIGN SET

02/07/20: 100% DESIGN DEVELOPMENT SET

05/15/20: PERMIT

THE CONTRACTOR IS RESPONSIBLE
FOR MATERIALS, DETAILS AND
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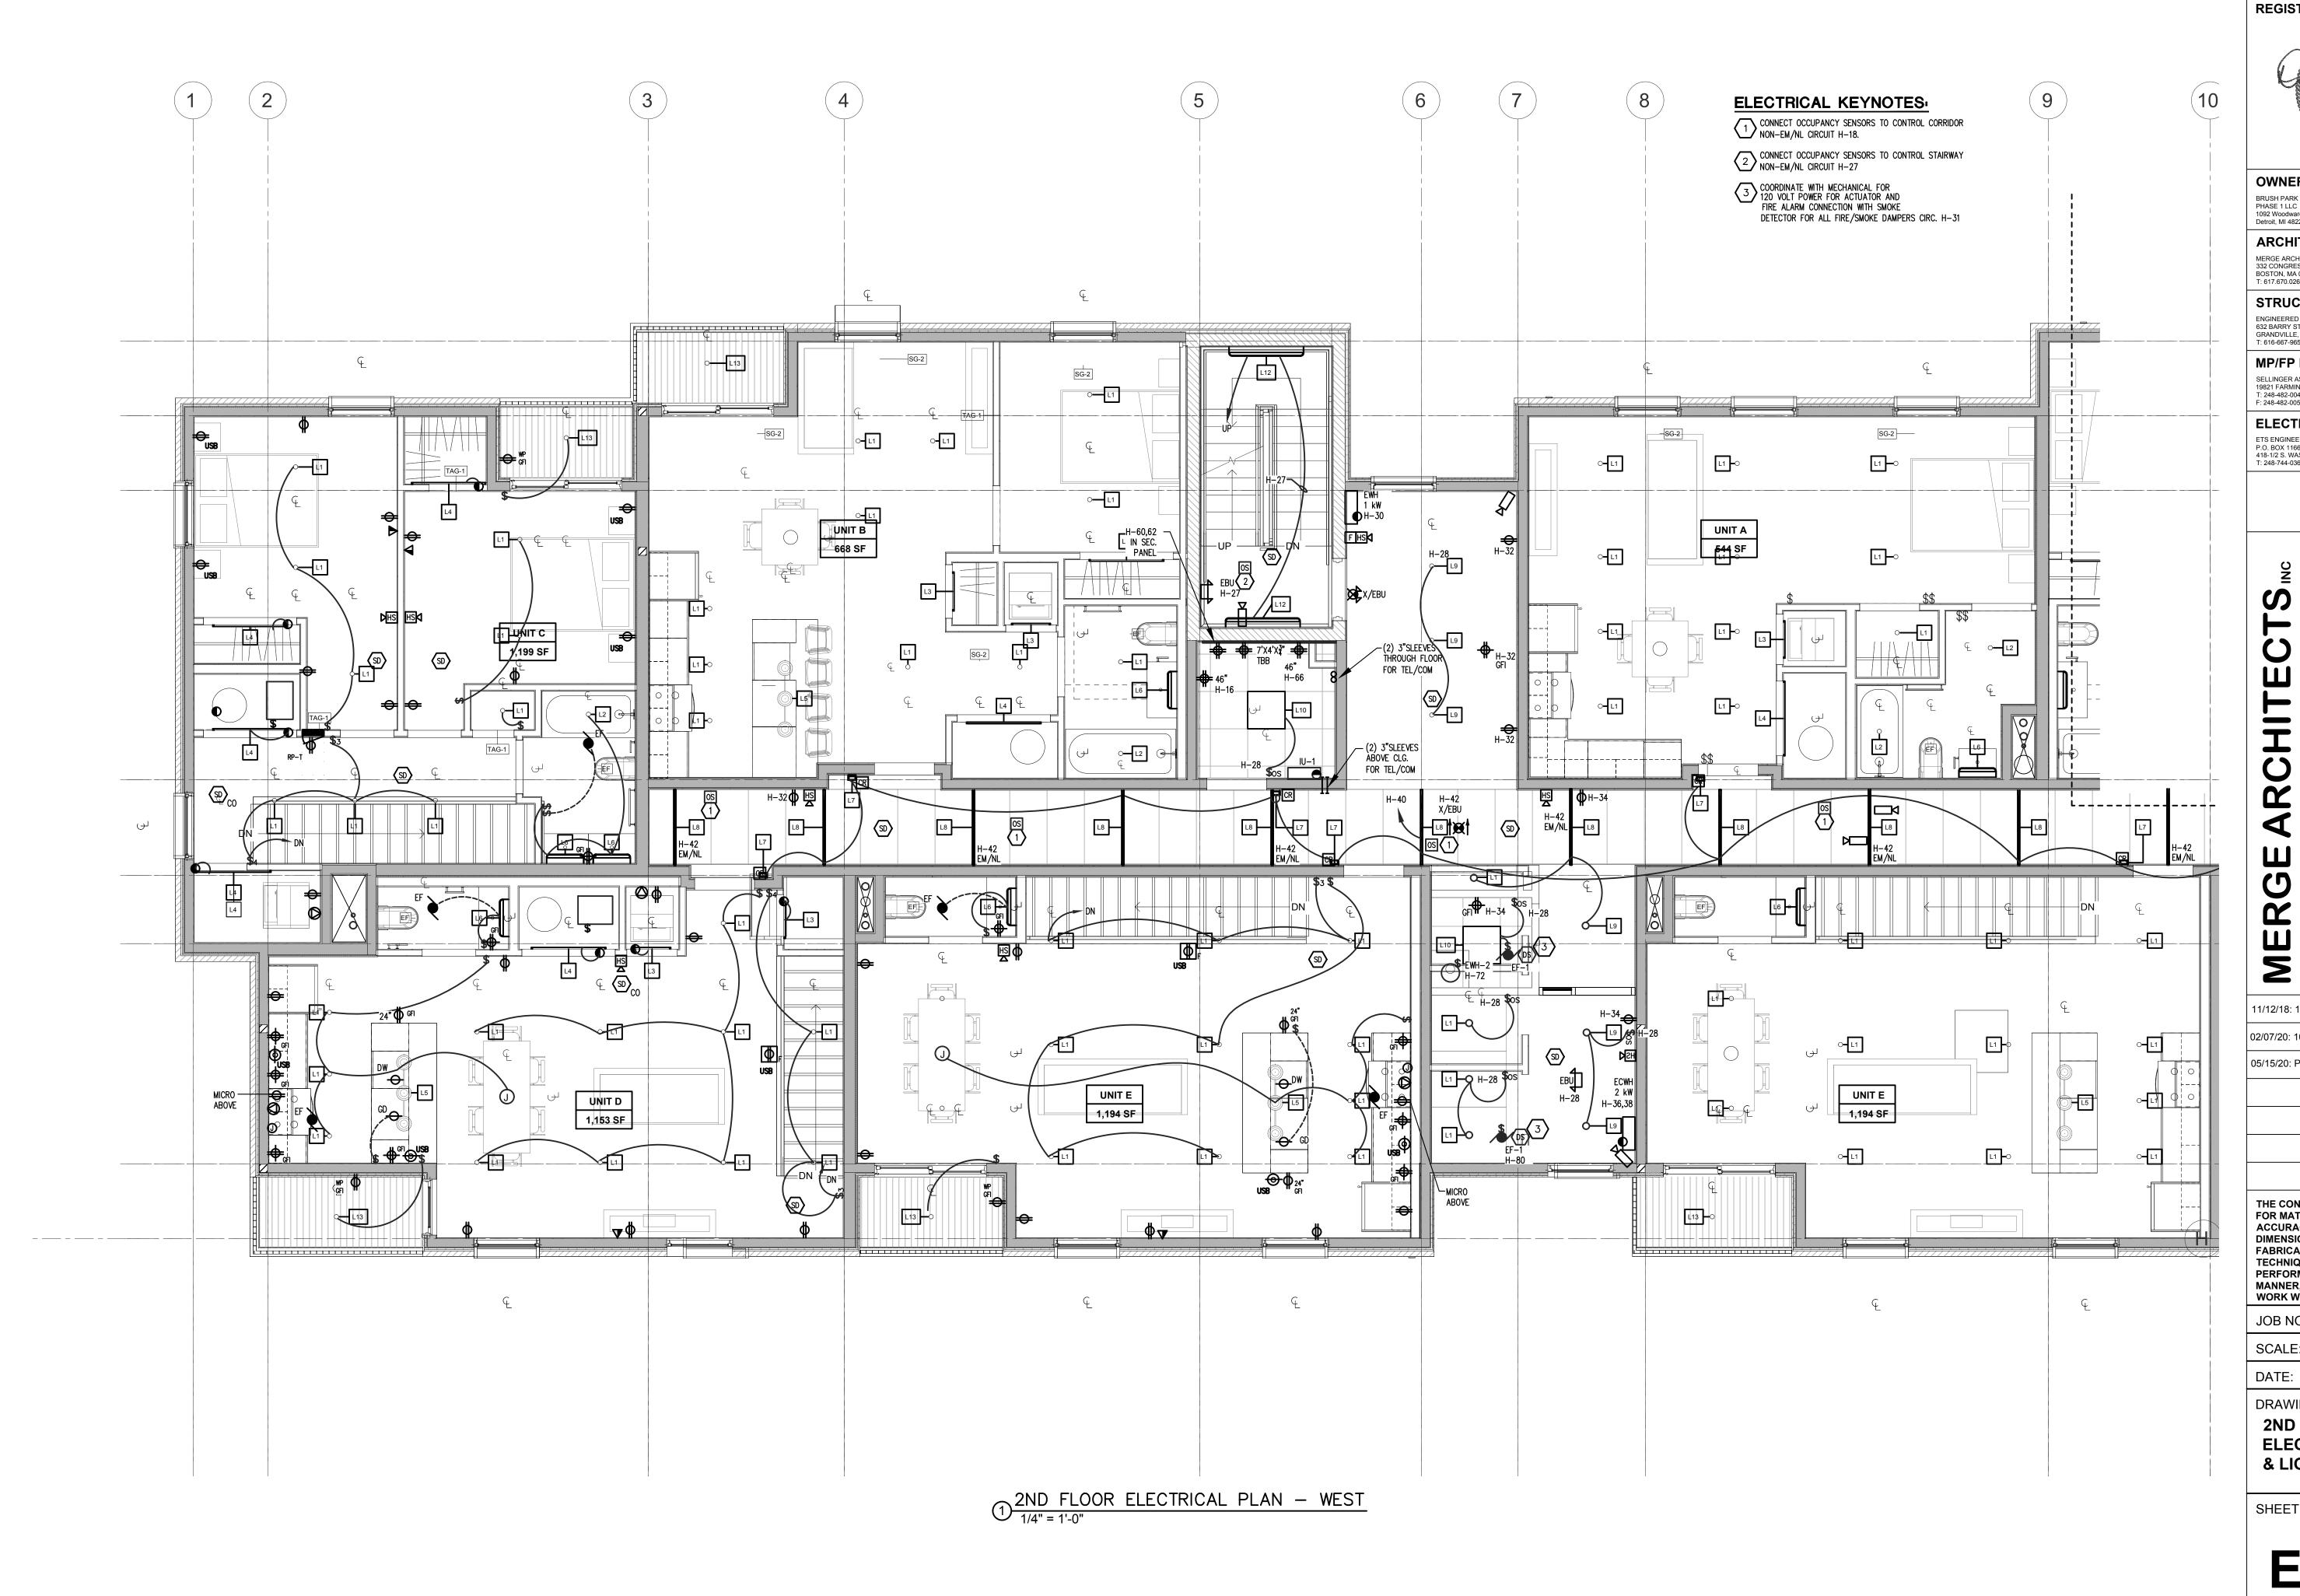
JOB NO.:	18284
SCALE:	AS INDICATED
DATE:	02/07/2020


DRAWING TITLE **1ST FLOOR EAST**

ELECTRICAL POWER & LIGHTING PLAN

SHEET NO.

E-101B



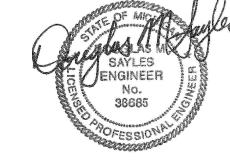

BRUSH PARK DEVELOPMENT COMPANY PHASE 1 LLC 1092 Woodward Ave. Detroit, MI 48226

ARCHITECT MERGE ARCHITECTS, INC. 332 CONGRESS ST. FLOOR 6 BOSTON, MA 02210 T: 617.670.0265

STRUCTURAL ENGINEER

ENGINEERED STRUCTURES, LLC. 632 BARRY STREET SW GRANDVILLE, MI 49418 T: 616-667-9650

MP/FP ENGINEER

SELLINGER ASSOCIATES, INC. 19821 FARMINGTON ROAD, LIVONIA, MI 48152 T: 248-482-0045 F: 248-482-0052

ELECTRICAL ENGINEER

ETS ENGINEERING, INC. P.O. BOX 1166 ROYAL OAK, MI 48068 418-1/2 S. WASHINGTON AVE, ROYAL OAK, MI 48067 T: 248-744-0360

Duplette d Place srush St. 48201

Brush ParOn Edmun
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Detroit MI, 11/12/18: 100% SCHEMATIC DESIGN SET

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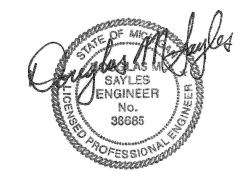
JOB NO.:	18284
SCALE:	AS INDICATED
DATE:	02/07/2020

DRAWING TITLE

2ND FLOOR WEST ELECTRICAL POWER & LIGHTING PLAN

SHEET NO.

E-102A



OWNER

BRUSH PARK DEVELOPMENT COMPANY PHASE 1 LLC 1092 Woodward Ave. Detroit, MI 48226

ARCHITECT MERGE ARCHITECTS, INC. 332 CONGRESS ST. FLOOR 6 BOSTON, MA 02210 T: 617.670.0265

STRUCTURAL ENGINEER

ENGINEERED STRUCTURES, LLC. 632 BARRY STREET SW GRANDVILLE, MI 49418 T: 616-667-9650

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Duplette Brush Par On Edmun Between B Detroit MI,

11/12/18: 100% SCHEMATIC DESIGN SET

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05/15/20: PERMIT

MERGI


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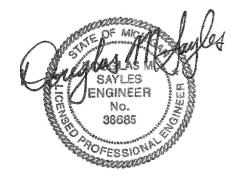
JOB NO.:	18284
SCALE:	AS INDICATED
DATE:	02/07/2020

DRAWING TITLE **2ND FLOOR EAST ELECTRICAL POWER** & LIGHTING PLAN

SHEET NO.

E-102B



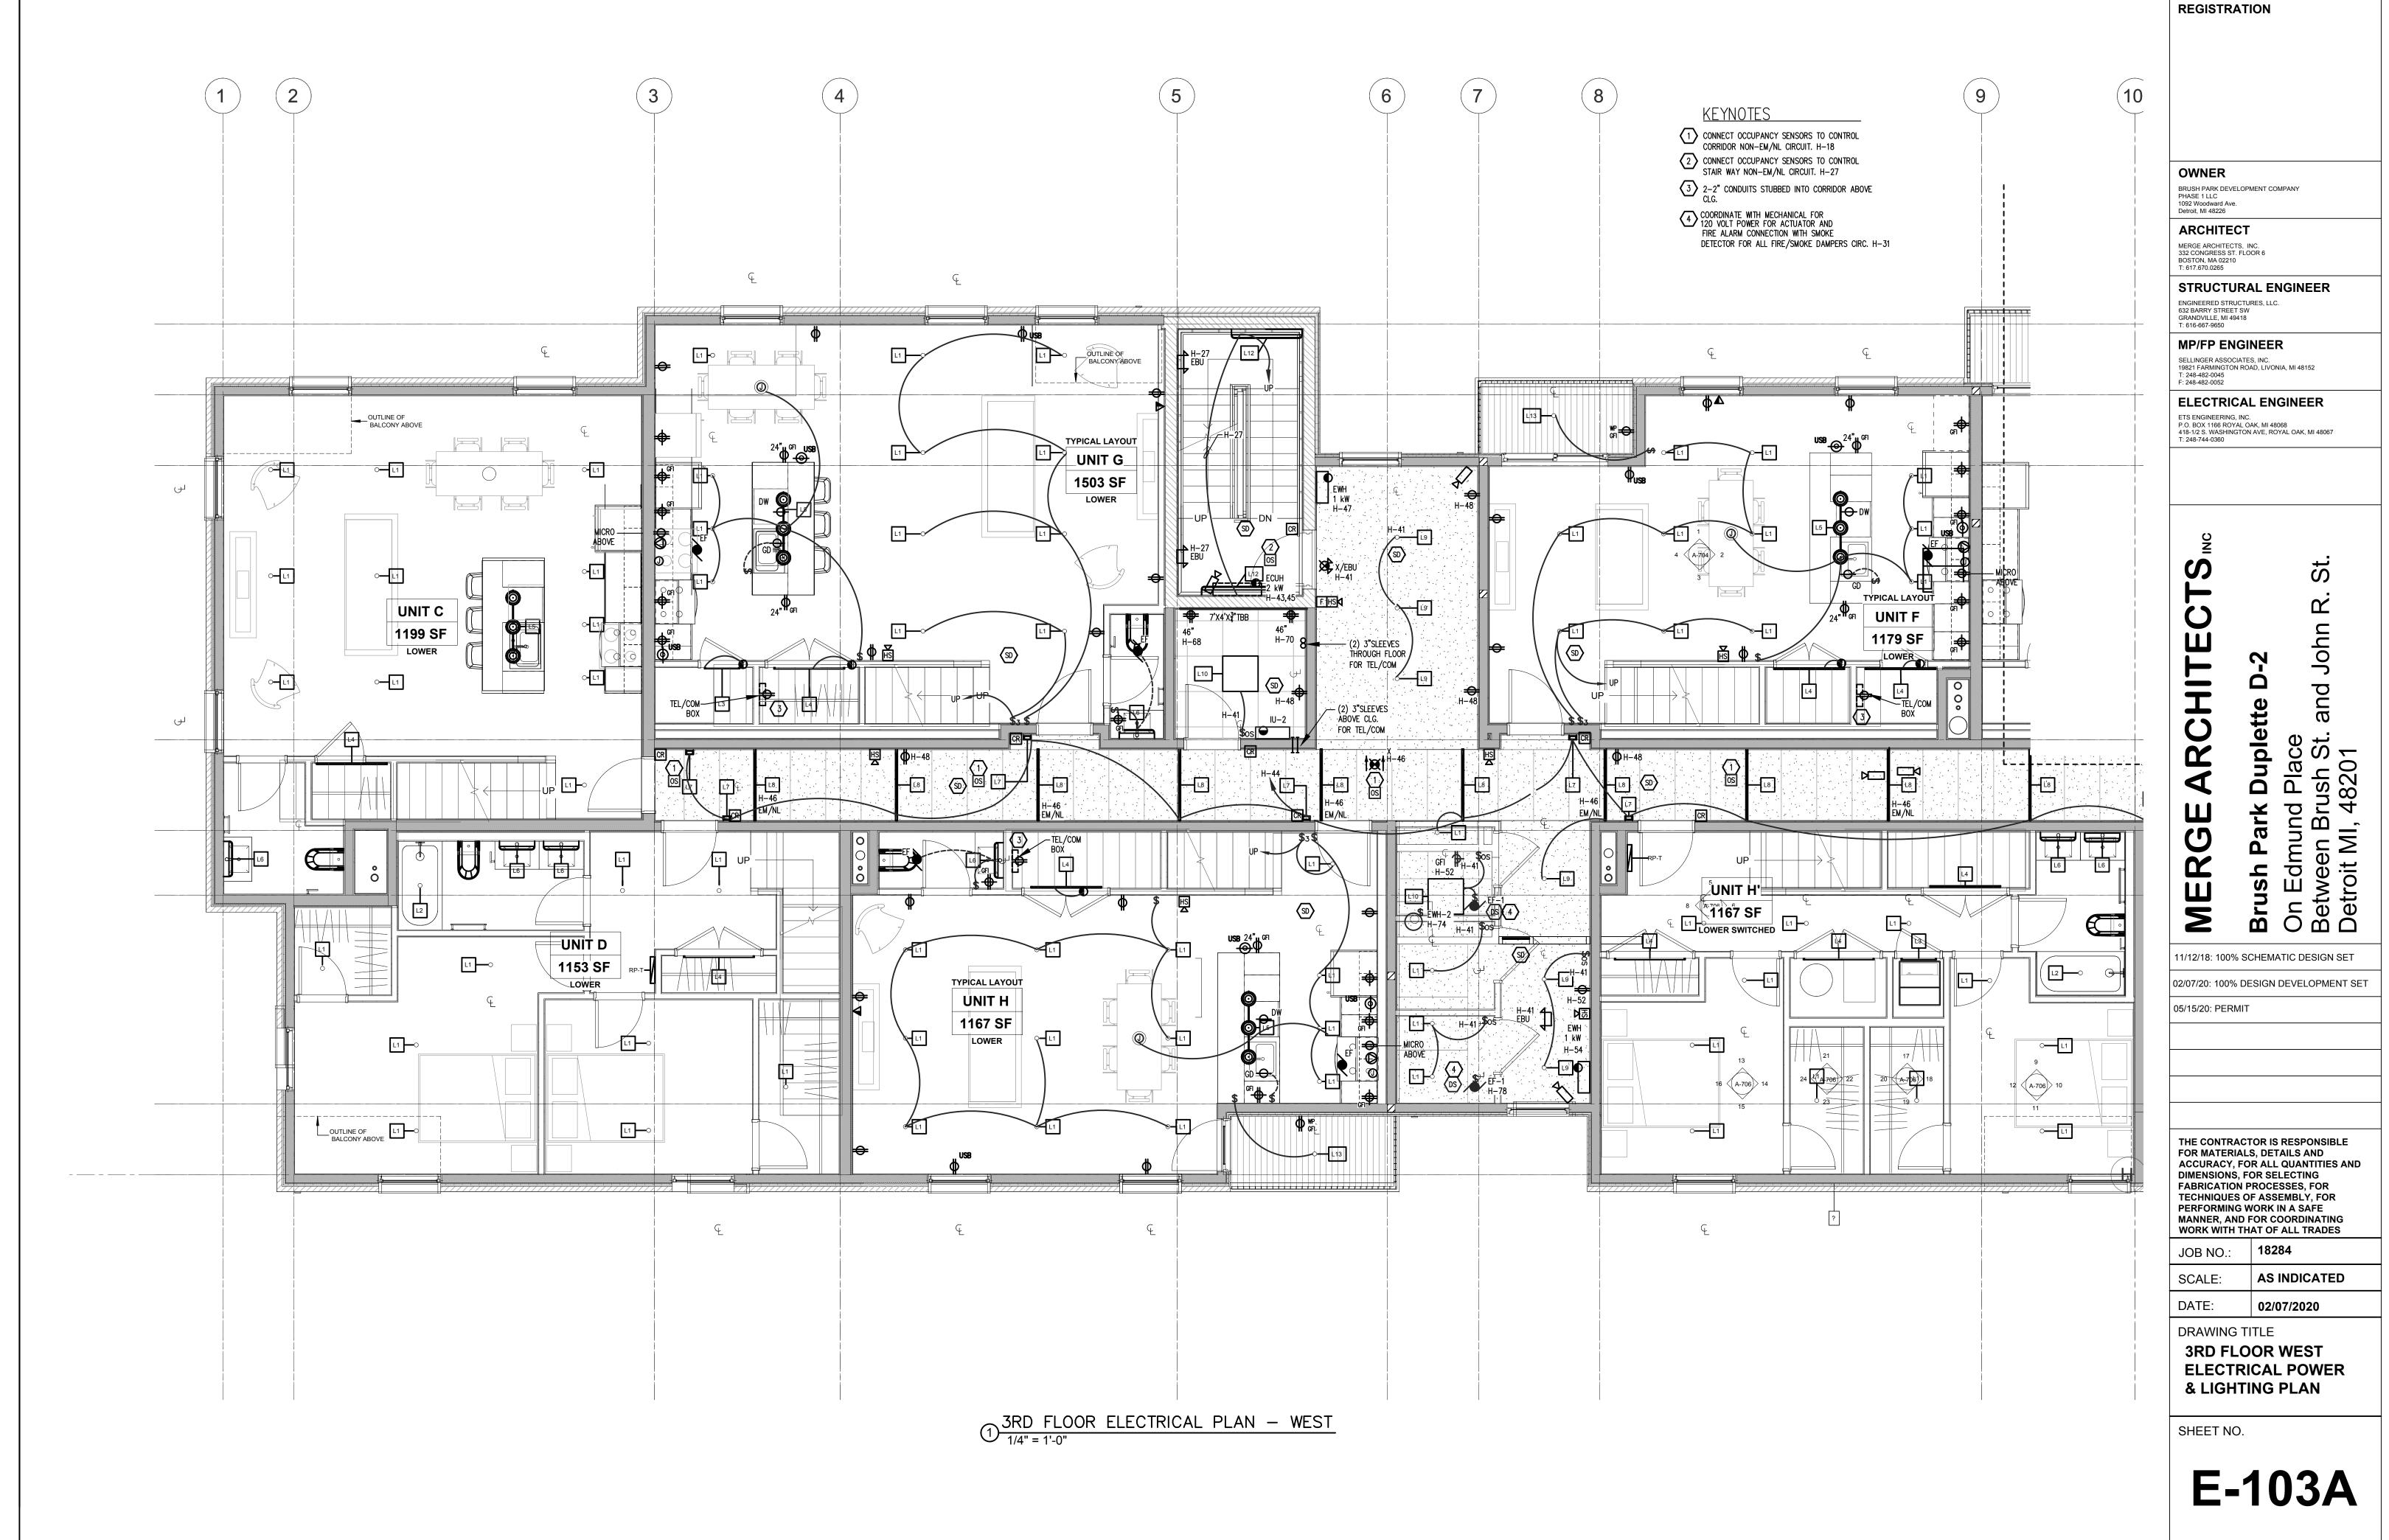

OWNER

BRUSH PARK DEVELOPMENT COMPANY PHASE 1 LLC 1092 Woodward Ave. Detroit, MI 48226

ARCHITECT

MERGE ARCHITECTS, INC. 332 CONGRESS ST. FLOOR 6 BOSTON, MA 02210 T: 617.670.0265

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ETS ENGINEERING, INC.
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T: 248-744-0360

Duplette d Place srush St. 48201

On Edmun Between B Detroit MI, MER

11/12/18: 100% SCHEMATIC DESIGN SET

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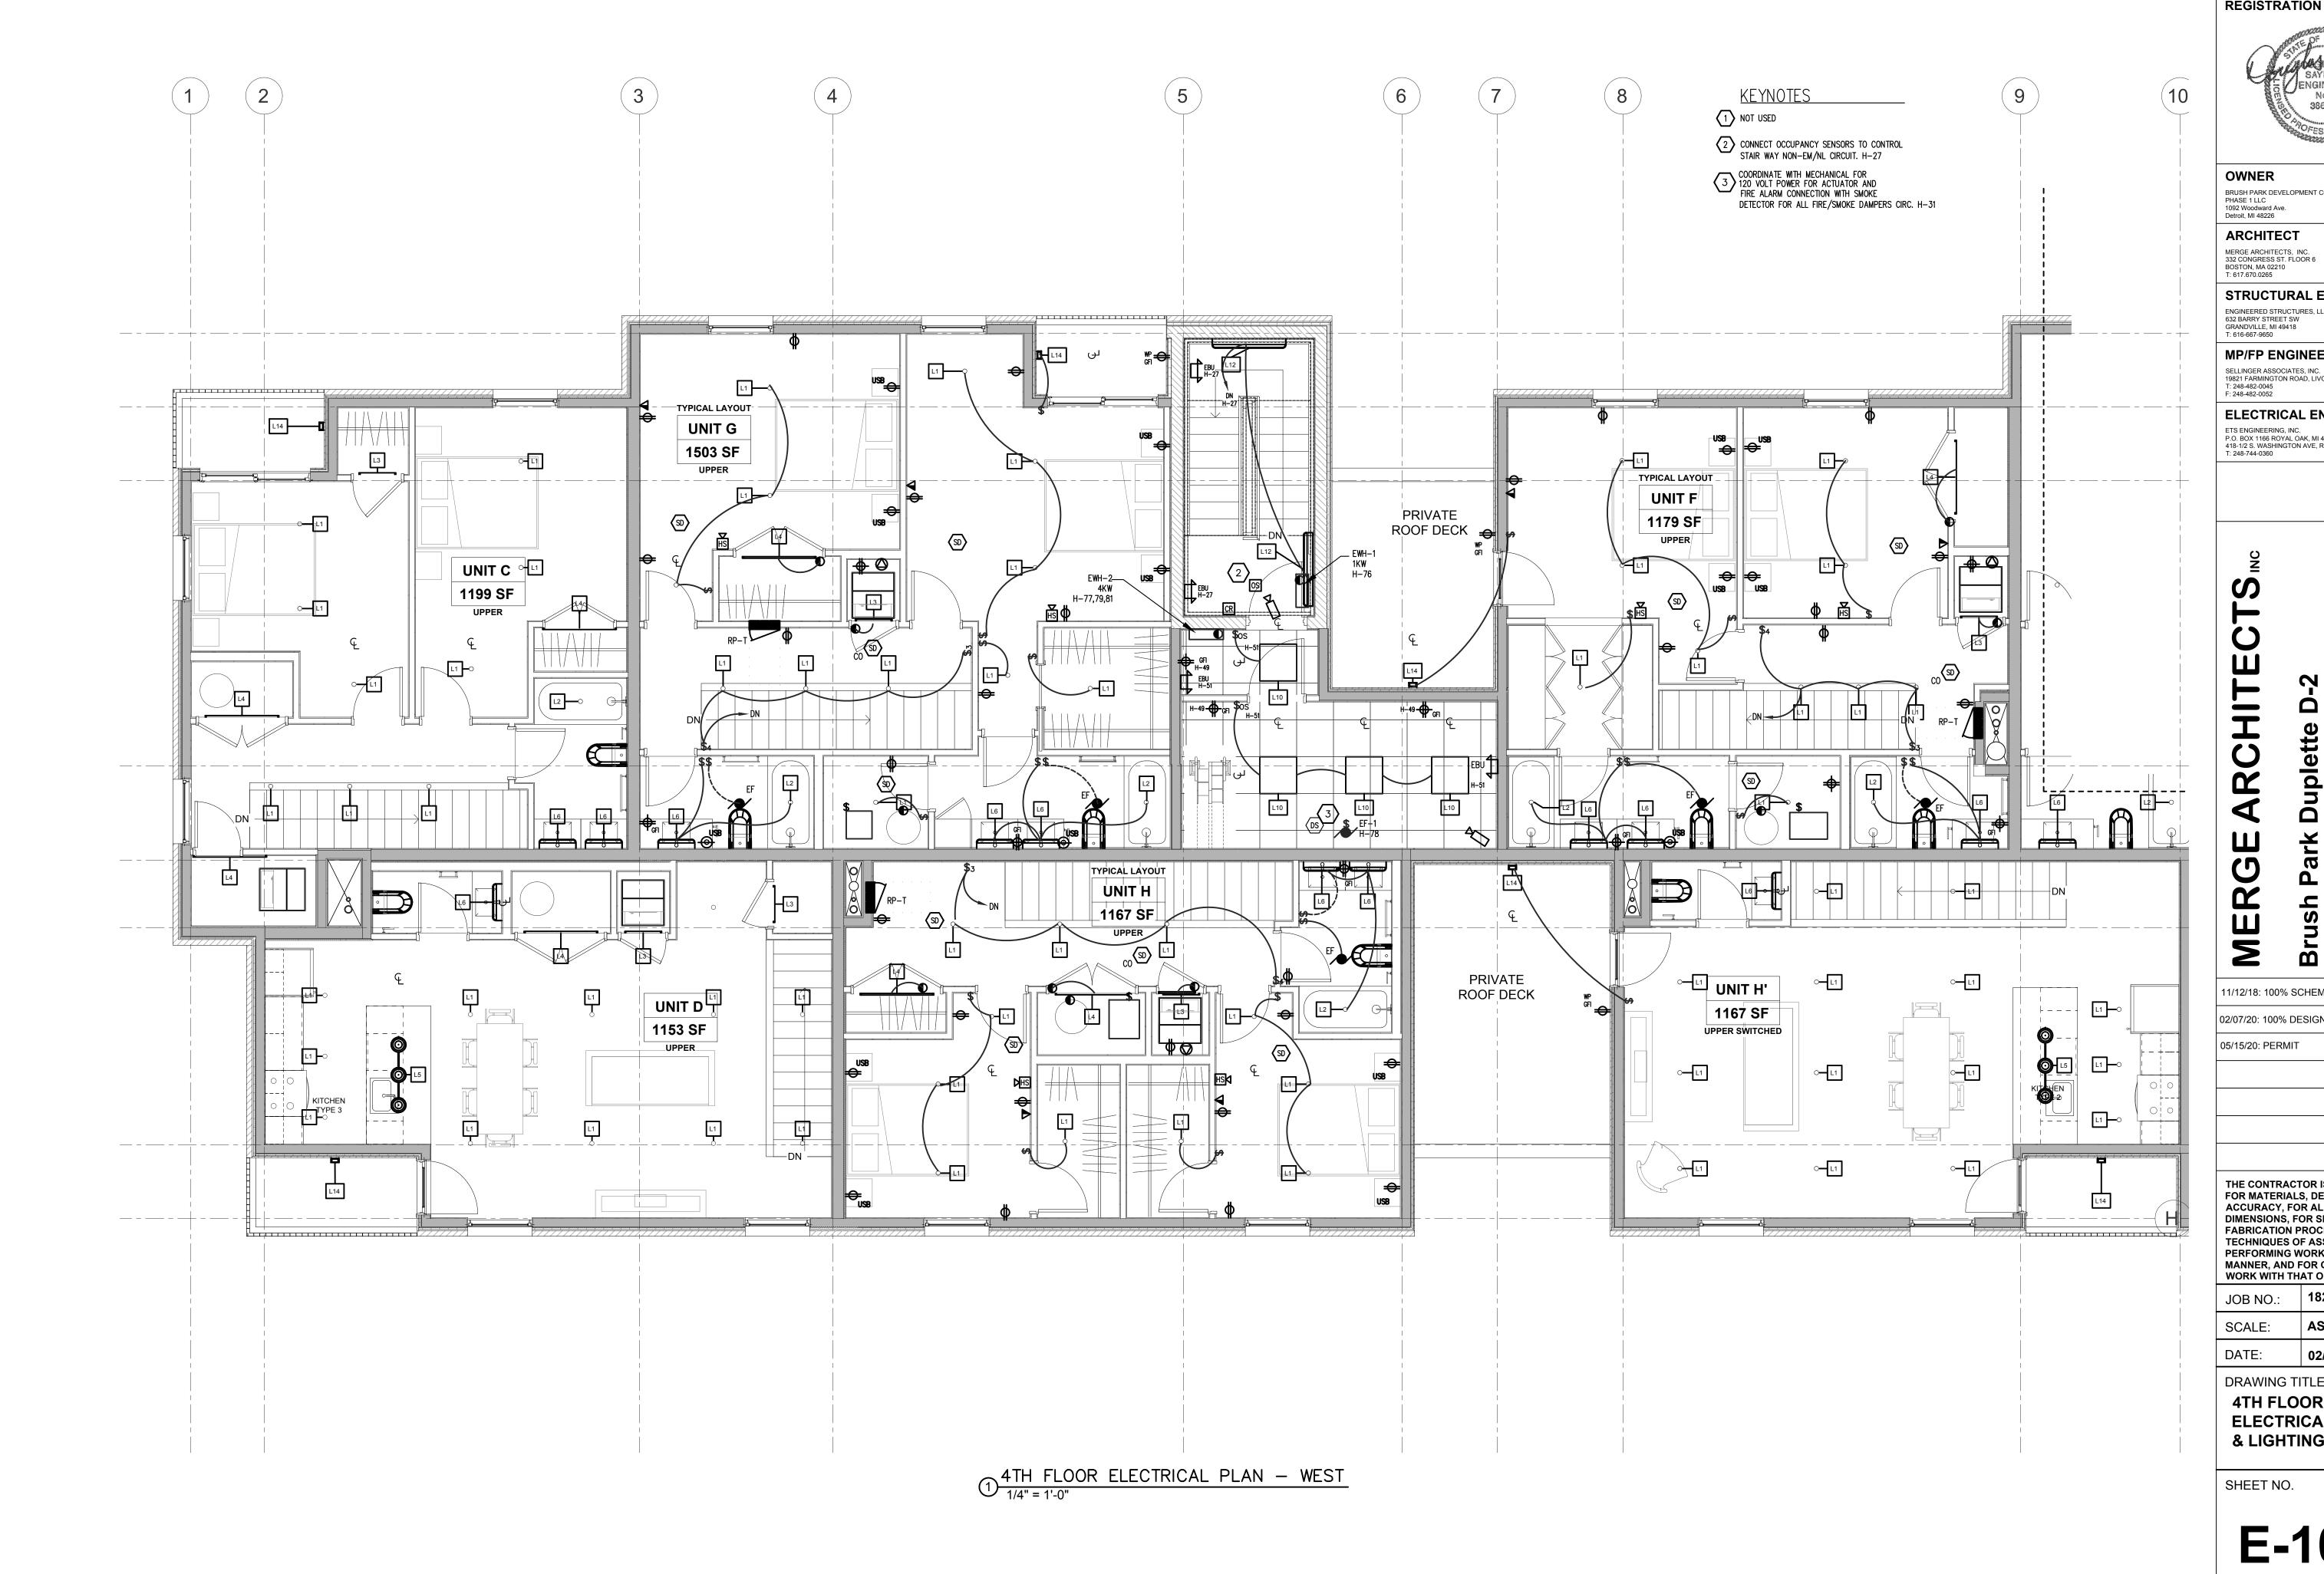
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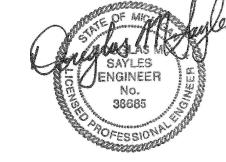
DRAWING TITLE **3RD FLOOR EAST**

ELECTRICAL POWER & LIGHTING PLAN

SHEET NO.

E-103B





BRUSH PARK DEVELOPMENT COMPANY

ARCHITECT

STRUCTURAL ENGINEER

ENGINEERED STRUCTURES, LLC. 632 BARRY STREET SW GRANDVILLE, MI 49418 T: 616-667-9650

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Duplette d Place srush St. 48201 **Brush Par** On Edmun Between B Detroit MI,

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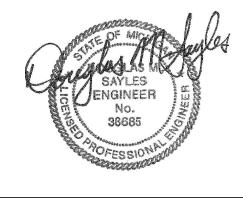
JOB NO.:	18284
SCALE:	AS INDICATED
DATE:	02/07/2020

DRAWING TITLE

4TH FLOOR WEST ELECTRICAL POWER & LIGHTING PLAN

SHEET NO.

E-104A



OWNER

BRUSH PARK DEVELOPMENT COMPANY PHASE 1 LLC 1092 Woodward Ave. Detroit, MI 48226 ARCHITECT

MERGE ARCHITECTS, INC. 332 CONGRESS ST. FLOOR 6 BOSTON, MA 02210 T: 617.670.0265

STRUCTURAL ENGINEER ENGINEERED STRUCTURES, LLC. 632 BARRY STREET SW GRANDVILLE, MI 49418 T: 616-667-9650

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T: 248-744-0360

Duplette d Place srush St. 48201 **Brush Par**On Edmun
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MERGI 11/12/18: 100% SCHEMATIC DESIGN SET

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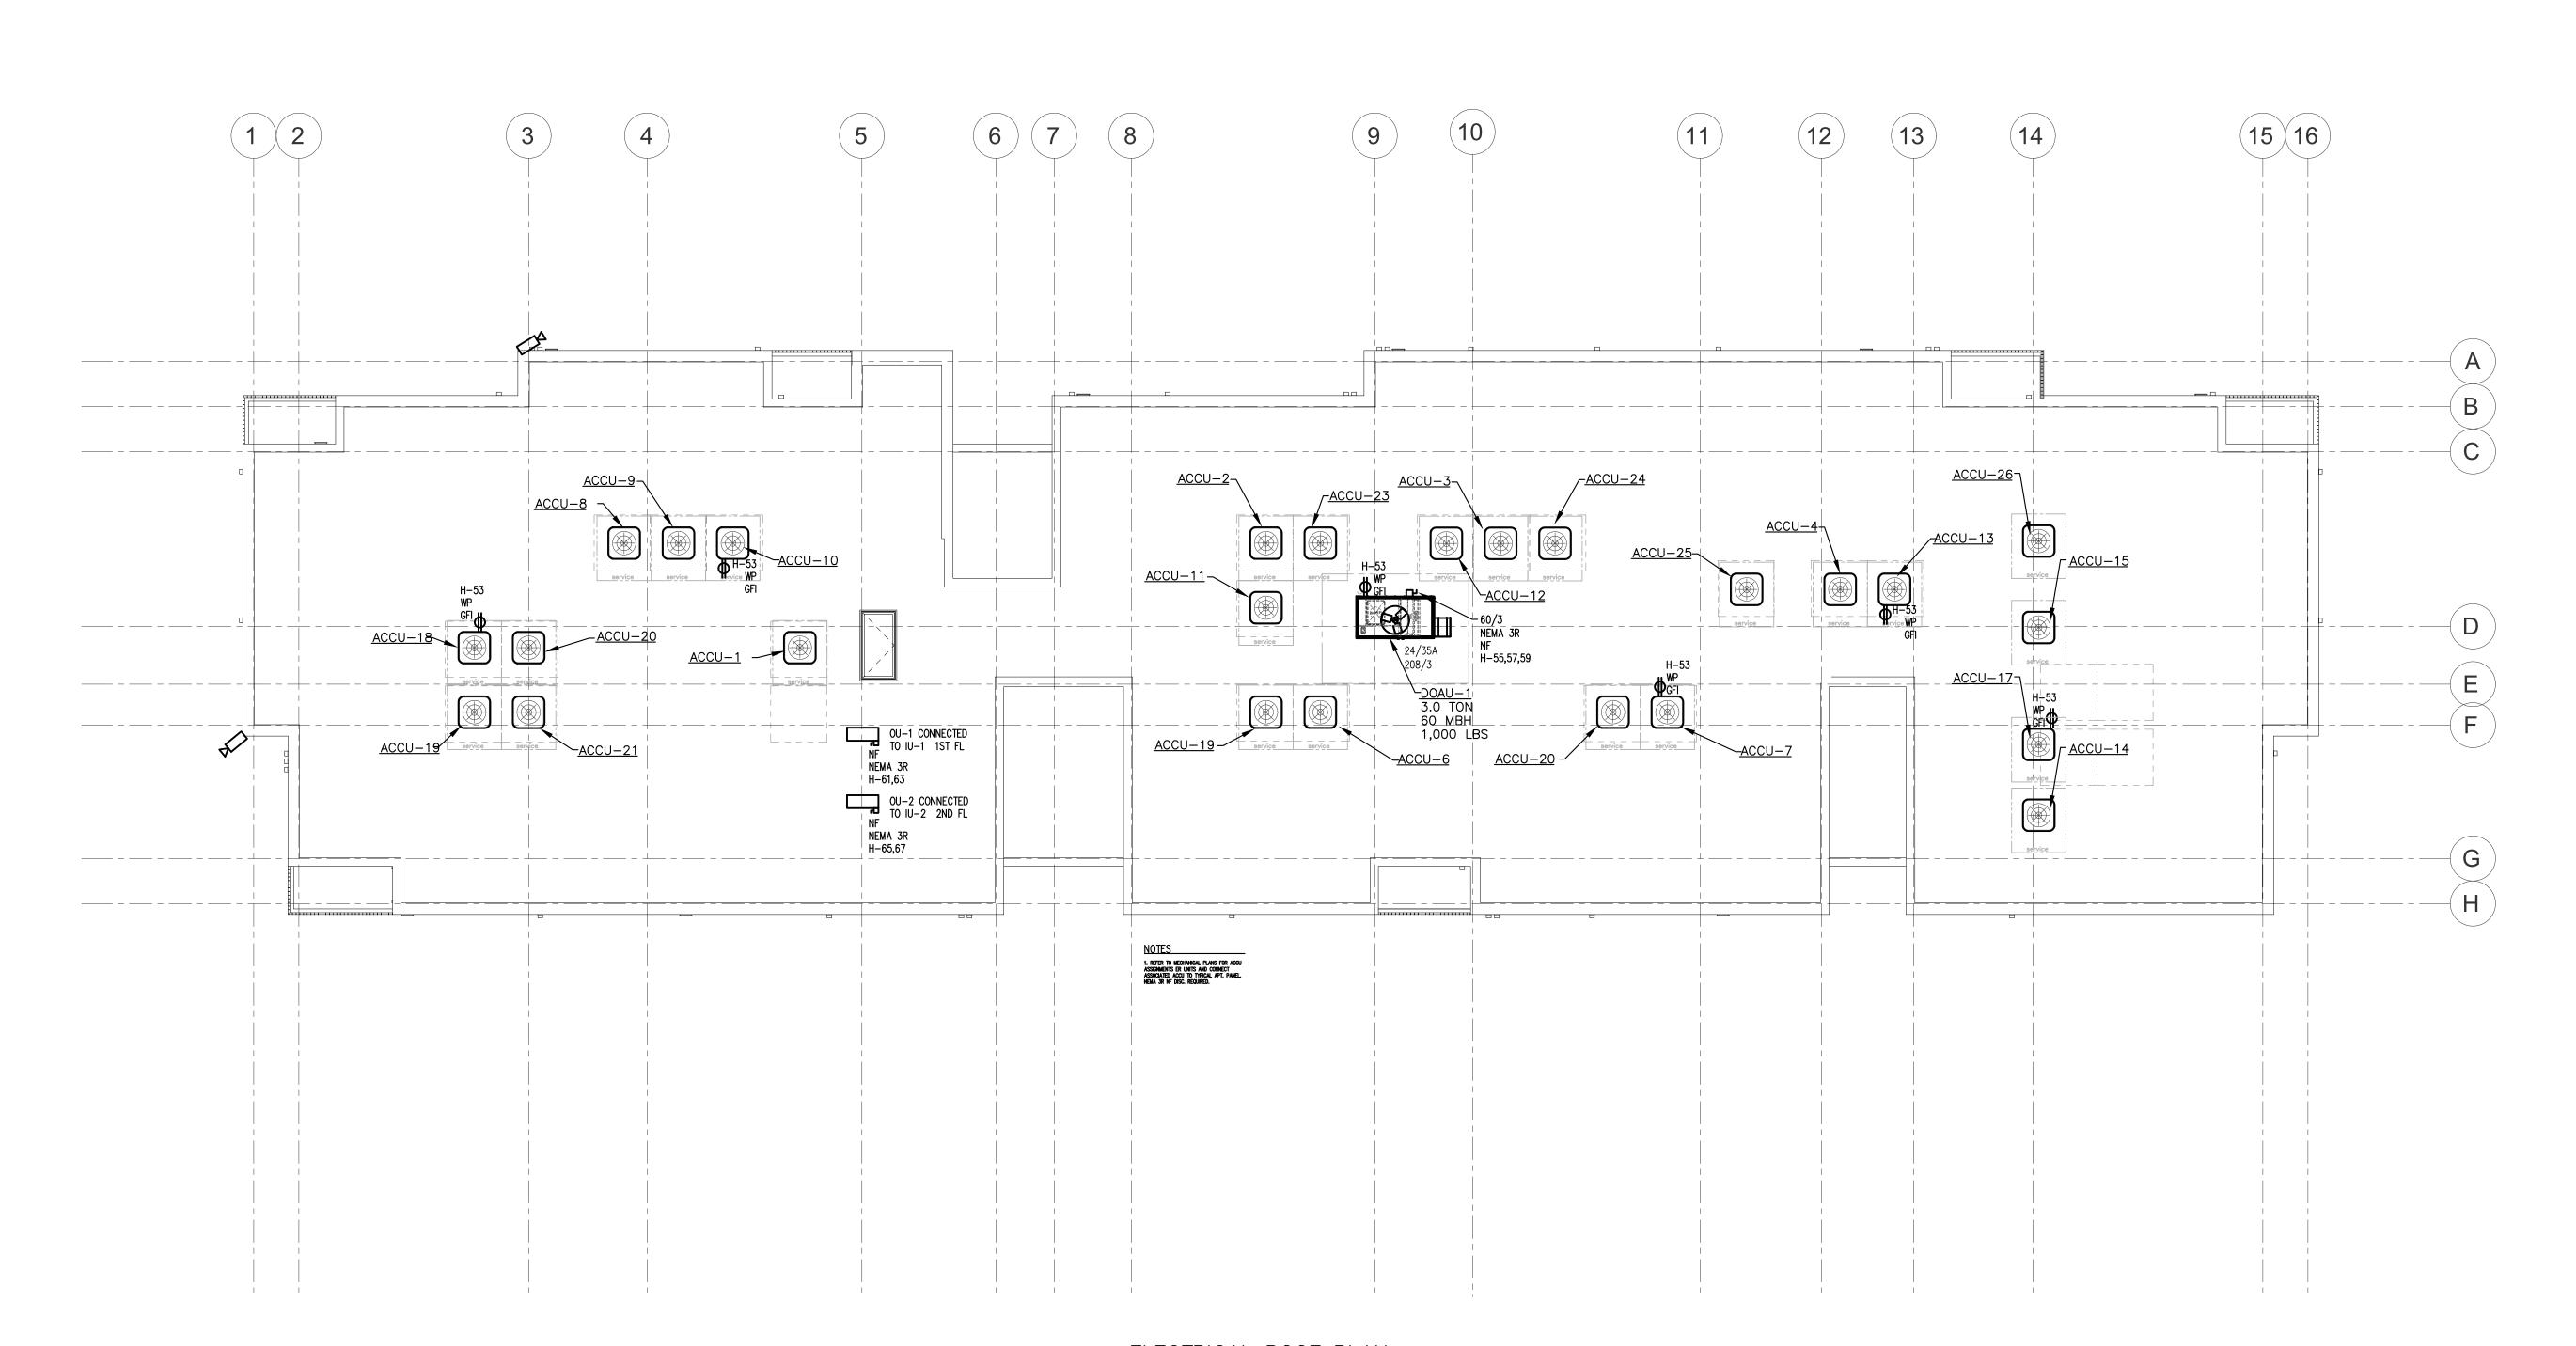
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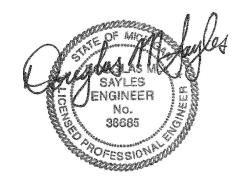
JOB NO.:	18284
SCALE:	AS INDICATED
DATE:	02/07/2020

DRAWING TITLE **4TH FLOOR EAST ELECTRICAL POWER** & LIGHTING PLAN

SHEET NO.

E-104B





OWNER

BRUSH PARK DEVELOPMENT COMPANY PHASE 1 LLC 1092 Woodward Ave. Detroit, MI 48226

ARCHITECT

MERGE ARCHITECTS, INC. 332 CONGRESS ST. FLOOR 6 BOSTON, MA 02210 T: 617.670.0265 STRUCTURAL ENGINEER

ENGINEERED STRUCTURES, LLC. 632 BARRY STREET SW GRANDVILLE, MI 49418 T: 616-667-9650

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ELECTRICAL ENGINEER

ETS ENGINEERING, INC.
P.O. BOX 1166 ROYAL OAK, MI 48068
418-1/2 S. WASHINGTON AVE, ROYAL OAK, MI 48067
T: 248-744-0360

Brush Park DupletOn Edmund Place
Between Brush St.
Detroit MI, 48201

and

11/12/18: 100% SCHEMATIC DESIGN SET

Duplette

02/07/20: 100% DESIGN DEVELOPMENT SET

05/15/20: PERMIT

MERGE

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	JOB NO.:	18284
	SCALE:	AS INDICATED
·	DATE:	02/07/2020

DRAWING TITLE **ELECTRICAL ROOF PLAN**

SHEET NO.

E-105

SCHEMATIC DESIGN

1/8" = 1'-0"

GENERAL RISER NOTES:

1. THE ELECTRICAL CONTRACTOR SHALL CONTACT THE LOCAL UTILITY COMPANY AND SUBMIT REQUIRED INFORMATION FOR PERMANENT ELECTRICAL SERVICE WHEN REQUIRED PRIOR TO CONSTRUCTION. ALL UTILITY ARRANGEMENTS SHALL BE CONFIRMED BY THE LOCAL UTILITY PRIOR TO ORDERING EQUIPMENT. ALL UTILITY EQUIPMENT LOCATIONS SHOWN ON THIS DRAWING SHALL BE VERIFIED WITH THE LOCAL UTILITY PRIOR TO INSTALLATION.

2. ALL CONCRETE PADS REQUIRED SHALL BE SUPPLIED AND INSTALLED BY THE ELECTRICAL CONTRACTOR AND MEET ALL LOCAL UTILITY AND MUNICIPALITY REQUIREMENTS.

3. ALL ITEMS SHOWN AS HATCHED SHALL BE DISCONNECTED AND REMOVED BY THE ELECTRICAL CONTRACTOR. REMOVE ASSOCIATED WIRING, TERMINATIONS AND CONDUIT BACK TO THE SOURCE.

4. ALL WIRE SIZES INDICATED ON THIS DRAWING SHALL BE COPPER WITH TEMP RATING OF 75 DEGREES C. PER 2014 NEC TABLE 310.15(B)(16) UNLESS OTHERWISE NOTED.

5. PROVIDE AND INSTALL "ARC-FLASH" LABELS IN ACCORDANCE WITH NEC 110.16.

6. ALL DISCREPANCIES WITH THESE DOCUMENTS SHALL BE BROUGHT TO THE ATTENTION OF THE ENGINEER FOR CLARIFICATION PRIOR TO BIDS. IN OTHERWISE DOING SO, THE ELECTRICAL CONTRACTOR SHALL BE LIABLE FOR ANY REQUIRED REVISIONS.

7. ALL ITEMS SHOWN ON PLAN ARE NEW UNLESS MARKED AS (E) FOR EXISTING OR (R) FOR RELOCATED.


8. WHERE MAIN G.F.I. IS SHOWN FOR PROJECT, E.C. TO PROVIDE PROPER SETTINGS FOR MAIN G.F.I. RELAY TRIP SETTINGS AND TIME DELAY PERFORMED BY AN INDEPENDENT TESTING COMPANY INCLUDED IN E.C. CONTRACT. PROVIDE ACTUAL DOCUMENTATION AT THE COMPLETION OF THE PROJECT FROM THE INDEPENDENT TESTING

9. E.C. TO COORDINATE EXACT EQUIPMENTS OF ALL OTHER SYSTEMS (INCLUDING ELEVATORS AND HVAC EQUIPMENT) WITH MANUFACTURER AND OTHER TRADES PRIOR TO ROUGH-IN AND PURCHASE OF ANY ELECTRICAL EQUIPMENT ASSOCIATED WITH SYSTEM. ANY DISCREPANCIES WITH THIS PLAN AND MANUFACTURER REQUIREMENTS SHALL BE BROUGHT TO THE ATTENTION OF THE ARCHITECT/ENGINEER PRIOR TO PURCHASE OR ELECTRICAL ROUGH-IN OF THIS EQUIPMENT.


Unit Electrical Load Calculations				
For: RP-T				
Largest Total Square Footage	1,500	sq. ft.		
Branch Circuit Requirements:			Brkr (Amp)	Spaces
General Load:				
General Lighting and Receptacles @ 3W/sq.ft.	4.5	kVA	15	4
Bathroom Receptacle AFCI/GFI	1.5	kVA	20	1
Dining AFCI	1.5	kVA	20	1
(2) Appliance counter circuits AFCI/GFI	3.0	kVA	20	2
Electric Range (4-Wire required)	8.0	kVA	40	2
Dishwasher	1.7	kVA	15	1
Microwave GFI/AFCI	1.0	kVA	15	1
Refrigerator AFCI	1.3	kVA	15	1
Washer/ Laundry	1.5	kVA	20	2
Electric Dryer	5.0	kVA	30	2
Furnace	1.1	kVA	15	1
120V Smoke Detectors (Lock on) AFCI	0.3	kVA	15	1
Dryer Booster Fan (if required)	0.1	kVA	15	1
Elec. Water Heater	4.5	kVA	30	2
Total Branch Circuit (connected):	35.0	kVA		
Application of demand factor (NEC 220.30B)				
1st 10 kVA at 100%	10.0	kVA		
Remainder of general load at 50%	12.5	kVA		
Total General Load	22.5	kVA		
Mechanical Air Conditioning vs. Heating (largest of the 2)\			
	•	kVA	20 or 25	2
Condesing unit (2.5 Ton largest - sizes vary on units)	3.0	KYA	20 01 23	
Total Mechanical Load	3.6	kVA		
Total Panelboard spaces used				24
Calculated Load for Service				
Total General Load	22.5	kVA	┥ !	
Mechanical Mechanical		kVA	-	
Total:		kVA	_	
Demand Amps at 120/208/1ph/3w		Amps		
Zomana Ampa di 120/200/191/0W	129.7	Lunka		

METER BANK CONNECTED EACH (KVA) NUMBER OF UNITS **DEMAND FACTOR** TOTAL WITH DEMAND FACTOR (KVA) RP-H (ESTIMATE KVA) DEMAND FOR METER BANK (AMPS)

ELECTRICAL LOAD DEMAND SCHEDULE

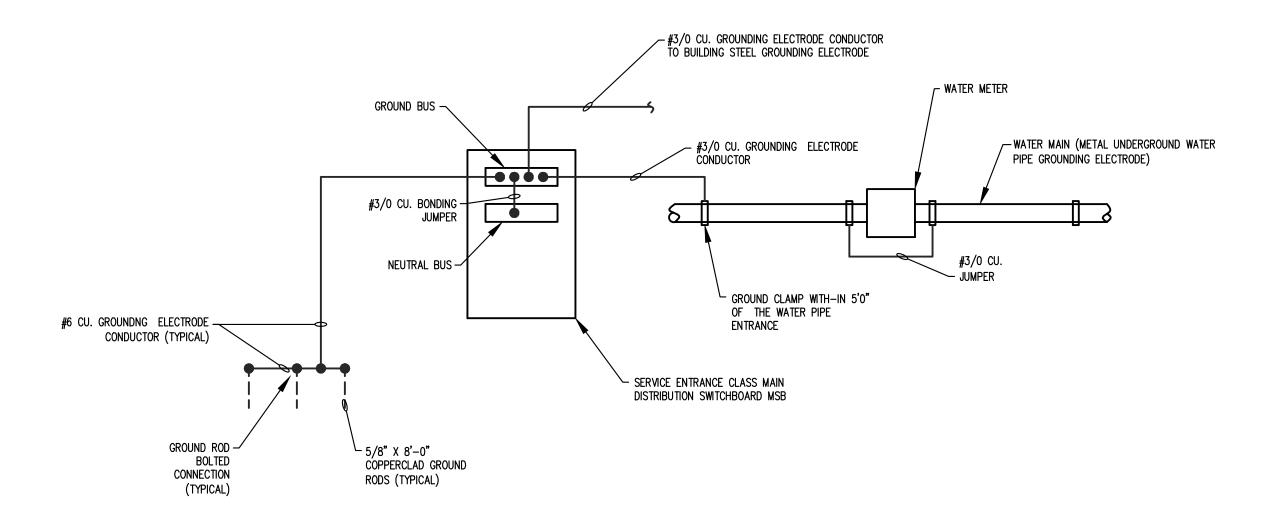


2 ELECTRICAL SYSTEM GROUND DETAIL NO SCALE

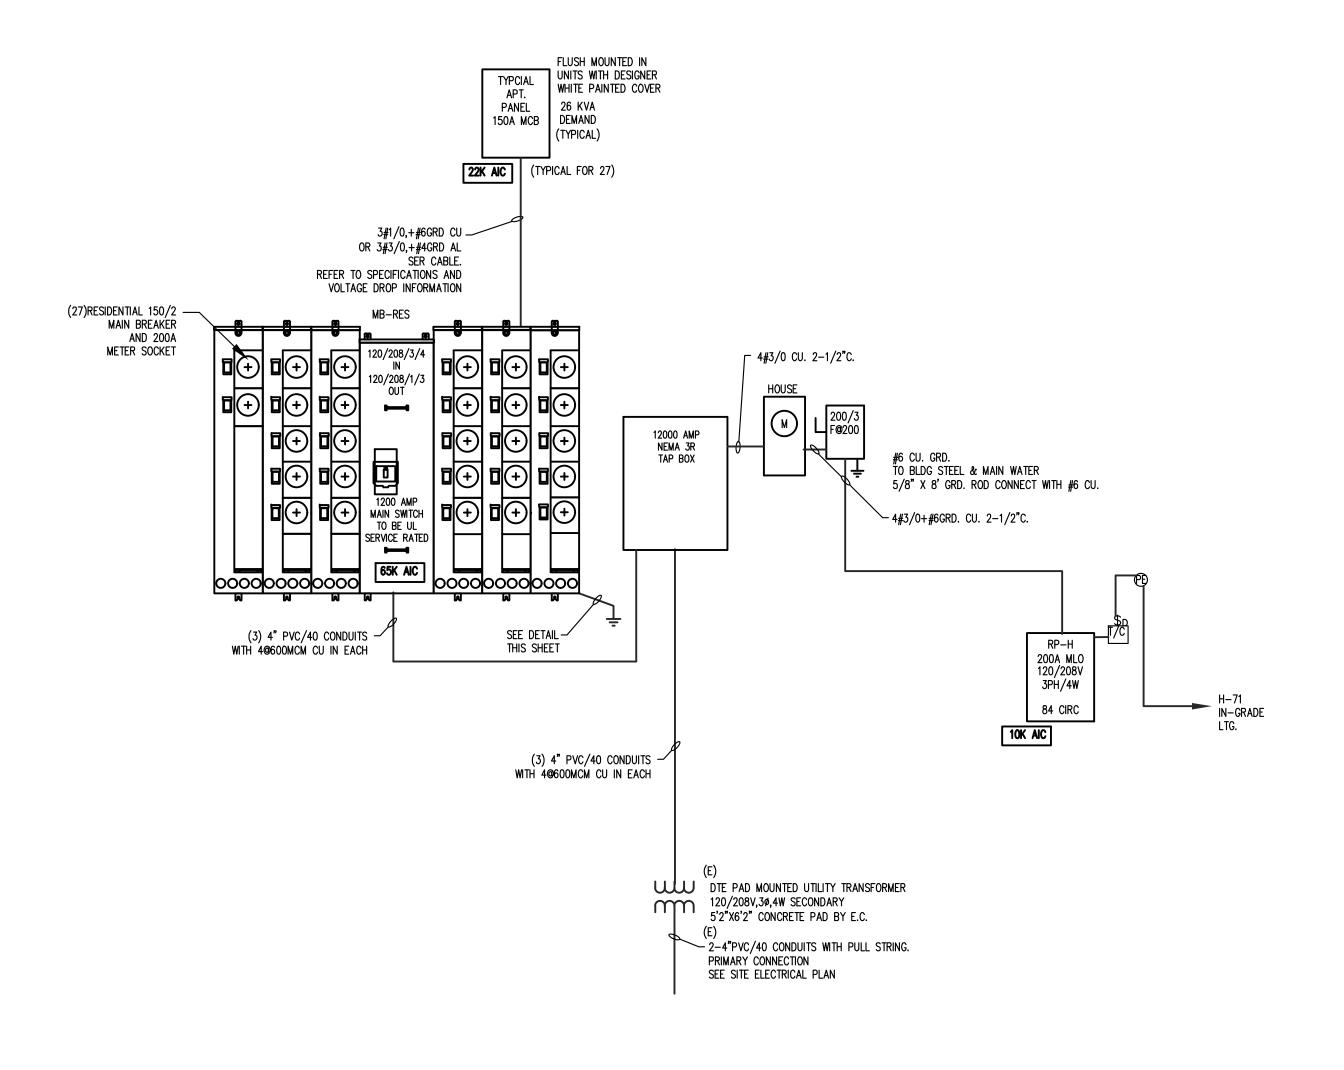

1 ELECTRICAL ONE-LINE DIAGRAM NO SCALE

REGISTRATION

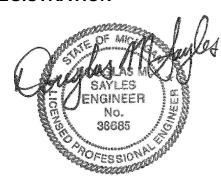

OWNER

BRUSH PARK DEVELOPMENT COMPANY PHASE 1 LLC 1092 Woodward Ave. Detroit, MI 48226

ARCHITECT

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Duplette Place ush St. 8201 On Edmun Between B Detroit MI, Par

MERG Brush

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JOB NO.:	18284
SCALE:	AS INDICATED
DATE:	02/07/2020

DRAWING TITLE **ELECTRICAL RISER DIAGRAM**

& DETAILS

SHEET NO.

E-300

THIS IS A 3-PAGE FORM - ALL INFORMATION IS REQUIRED FOR PROJECT REVIEW

HISTORIC DISTRICT COMMISSION PROJECT REVIEW REQUEST

Data.

City of Detroit - Planning & Development Department 2 Woodward Avenue, Suite 808 Detroit, Michigan 48226

Detroit, Michigan 48226			Date	
PROPERTY INFOR	RMATION			
ADDRESS:				
HISTORIC DISTRICT:_				
	Windows/ Roof/Gutters Doors Chimney	Porch/ Deck	Landscape/Fence/ General Tree/Park Rehab	
	New Construction Demolition	Addition	Other:	
APPLICANT IDEN	TIFICATION			
Property Owner/ Homeowner	Contractor	Tenant or Business Occupant	Architect/Engineer/ Consultant	
NAME:	COMP	ANY NAME:		
ADDRESS:	CITY:	STATE	: ZIP:	
PHONE:	MOBILE:	EMAIL:	:	
PROJECT REVIEW	REQUEST CHECKLIST			
	ing documentation to your re			
PLEASE KEEP FILE SIZE	E OF ENTIRE SUBMISSION UN	DER 30MB	NOTE:	
Completed Buildi	ng Permit Application (<mark>highl</mark> i	ighted portions only)	Based on the scope of work,	
	umber (only applicable if you	've already applied	additional documentation maybe required.	
for permits through	n ePLANS)		See www.detroitmi.gov/hdc for	
Photographs of ALL sides of existing building or site				
	aphs of location of proposed vow existing condition(s), design			
Description of exi	sting conditions (including n	naterials and design)		
	oject (if replacing any existing er than repairof existing and			
Detailed scope of	work (formatted as bulleted	list)		
Brochure/cut she	ets for proposed replacemen	t material(s) and/or pro	oduct(s), as applicable	
Linear vennint of this density	tation at affectil various and information	ou of the post stope toward al	otaining valur building parmit frame the	

Upon receipt of this documentation, staff will review and inform you of the next steps toward obtaining your building permit from the Buildings, Safety Engineering and Environmental Department (BSEED) to perform the work.

SUBMIT COMPLETED REQUESTS TO HDC@DETROITMI.GOV

P2 - BUILDING PERMIT APPLICATION

			Date:
PROPERTY INFORMATION			
Address:	Flo	oor:Suite	#:Stories:
AKA:			
Parcel ID#(s):			
Current Legal Use of Property:	F	Proposed Use:	
Are there any existing buildings o			
PROJECT INFORMATION			
Permit Type:	Alteration Addition	Demolition	Correct Violation
Foundation Only Change	_		
Revision to Original Permit #:			
Description of Work (Describe in			
Description of Work		, je v o je o v ojy a ood oo v v o v	
	☐ MBC	use change	No MBC use change
Included Improvements (Check	all applicable; these trade areas	require separate perm	nit applications)
HVAC/Mechanical Elec	trical Plumbing	Fire Sprinkler Sy	stem Fire Alarn
Structure Type		_ , ,	Ш
New Building Existing S	tructure Tenant Spac	ce Garage/	Accessorv Buildina
Other: Size o	 ·		
Construction involves changes to			
(e.g. interior demolition or construction t	•		,
Use Group: Type		MI Bldg Code Table 6	501)
Estimated Cost of Construction			
Structure Use	\$By Contractor	¥	By Department
Residential-Number of Units:	Office Gross Floor Area	Industria	al-Gross Floor Area
Commercial-Gross Floor Area:			
Proposed No. of Employees:	- 		
PLOT PLAN SHALL BE submitted o			
(must be correct and in detail). SHO	DW ALL streets abutting lot,	indicate front of lo	ot, show all buildings,
existing and proposed distances to			on Next Page)
	or Building Department U		
Intake By:	Date:	Fees Due:	DngBld? No
Permit Description:			
Current Legal Land Use:	Prop	oosed Use:	
Permit#:I	Date Permit Issued:	Permit Cos	t: \$
Zoning District:	Zoning G	rant(s):	
Lots Combined? Yes	No (attach zoning c	learance)	
Revised Cost (revised permit applicate	tions only) Old \$	New \$	<u> </u>
Structural:	Date:	Notes:	
Zoning:	Date:	Notes:	
Other:	Date:		

IDENTIFICATIO	N (All Fields Requ	ired)			
Property Owner/	Homeowner	Property Ov	vner/Hom	eowner is Perr	mit Applicant
Name:		Com	ipany Nan	ne:	
Address:		City:		State	:Zip:
Phone:		Mok	oile:		
Driver's License #:		Emai	l:		
Contractor	Contractor is Perm	nit Applicant			
Address:		City:		State	:Zip:
	Mobile:				
City of Detroit Lice	ense #:				
TENIANT OD DI	USINESS OCCUPA	NIT I	enant is Pe	rmit Applicant	
	Phone:				
	Thorie.				
ARCHITECT/EN	NGINEER/CONSU	LTANT	Architect/E	ngineer/Consu	ltant is Permit Applicant
Name:	St	tate Registratio	n#:	Ехрі	ration Date:
Address:		City:	ı	State:	Zip:
Phone:	Mobile:		En	nail:	
HOMEO	WNER AFFIDAVIT (Only required for i	residential p	ermits obtained	by homeowner.)
on this permit appl requirements of the inspections related	ication shall be compl e City of Detroit and ta	eted by me. I a ake full respons rk herein descri	m familiar ibility for a bed. I shal	with the appli II code compl II neither hire r	iance, fees and nor sub-contract to any
Print Name:	(Homeowner)	Signature:			Date:
					County, Michigan
Signature:	(Notary Public))	My Co	ommission Exp	oires:
		T APPLICANT			
restrictions that macertify that the proto make this applicable laws inspections are re	t the information on t ay apply to this constr posed work is authori cation as the property and ordinances of jur	his application uction and am zed by the owr owner(s) autho isdiction. I am ted within 180	is true and aware of r her of the o orized agen aware tha days of t	d correct. I have ny responsibil record and I have nt. Further I agost a permit wi	ity thereunder. I ave been authorized gree to conform to
Print Name:	(Permit Applicant)	Signature:			Date:
	rn to hefore me this				
	THE DETOTE THE UIIS	aay 01 Mv Co	— ²⁰ —	Expires:	County, Michigan
Signature:	(Notary Public)	1VIY CC	/11111133IUII		
Section	222 of the state cons	turation code	act of 10	72 1072042	20 MCI 125 1522A

Section 23a of the state construction code act of 1972, 1972PA230, MCL 125.1523A, prohibits a person from conspiring to circumvent the licensing requirements of this state relating to persons who are to perform work on a residential building or a residential structure. Visitors of Section 23a are subject to civil fines.

This application can also be completed online. Visit detroitmi.gov/bseed/elaps for more information.

