STAFF REPORT: JULY 8, 2020 MEETING PREPARED BY: B. CAGNEY

APPLICATION NUMBER: 20-6773

ADDRESS: 4125 SECOND

HISTORIC DISTRICT: WILLIS-SELDEN

APPLICANT: JOE GALLAGHER / THE GREEN GARAGE, LLC.


PROPERTY OWNER: THOMAS BRENNAN / GREEN GARAGE, LLC.

SCOPE OF WORK: ERECT EXTERIOR STAIR SYSTEM AT REAR OF BUILDING

PROVISIONAL COMPLETE DATE: 6-22-2020

DATE OF STAFF SITE VISIT: 7-1-2020



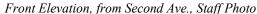



"Rear" Elevation, from W. Alexandrine, Staff Photo

Existing Conditions

The building at 4125 Second was built in 2017 after being approved by the Historic District Commission at the 12/9/2015 Meeting. The building, "Seasons Market" is set back from the Northwest corner of Second Ave and W. Alexandrine and is a part of El Moore Gardens, a "publicly accessible neighborhood garden." The building is of contemporary construction, with primarily brick and limestone on the first floor and a dark grey board and batten panel cladding on the second floor.

Proposed Exterior Modification

- The applicant proposes a new exterior staircase at the rear of the building. The intent of this staircase is to allow egress access from the second floor deck to the ground level.
 - O The proposed stairs will be constructed of steel c-channel stringers, with steel tubing and rod railings, painted black to match the exterior color of the second floor. The treads will be aluminum grate.
 - o A 44" opening will be cut in the existing brick parapet wall.
 - o The existing pergola will be modified by removing the center of rafters to provide headroom for stairs.

Staff Observations:

- <u>Location</u>: The staircase will be located at the rear of the building, not visible from Second Ave. The staircase might be visible from W. Alexandrine, however, from a distance. It is staff's opinion that the addition while not detract from the building or the Willis-Selden HD.
- Exterior Modification: The staircase will require slight modifications to the existing parapet and pergola, neither of which are historic age materials. It is staff's opinion that selected materials for the staircase are appropriate and the overall impact will not detract from any character defining features of the building or the Willis-Selden HD.

Recommendations:

• <u>Addition of New Staircase</u>: Staff recommends that the Commission issue a Certificate of Appropriateness for the proposed work based on Secretary of the Interior's Standards for Rehabilitation.



"Rear" Elevation and view of gardens, from W. Alexandrine, Staff Photo

To: Historic District Commission

RE: Seasons Building
4125 Second Ave
Detroit, MI 48201
BLD2020-01733
Willis-Seldon Historic District

To Whom it May Concern:

The Green Garage, LLC has applied for a building permit to remodel the interior of the existing Seasons Market building to accommodate a cafe and produce market. As part of this conversion, an exterior egress staircase needs to be installed from the second floor to the ground level. This will be in the rear of the building, and not visible from the front of the building.

The existing building consists of a brick and limestone exterior with a board and batten style second floor. The stairs will be constructed of steel c-channel stringers, with steel tubing and rod railings painted black to match second floor exterior color. The treads will be aluminum grate.

With the exception of the metal stairs, no new materials will be added to the exterior of the building.

Work will consist of:

- Cutting 44" wide opening in existing brick and panel parapet wall.
- Removing center of rafters of existing pergola to provide headroom for stairs.
- Installing metal stairs from existing deck to grade.

We look forward to adding this fresh produce and grocery store to the surrounding neighborhood.

If you need any additional information, please contact me at any time.

Regards,

Joe Gallagher The Green Garage, LLC 248 345 8309 jgallagher615@gmail.com























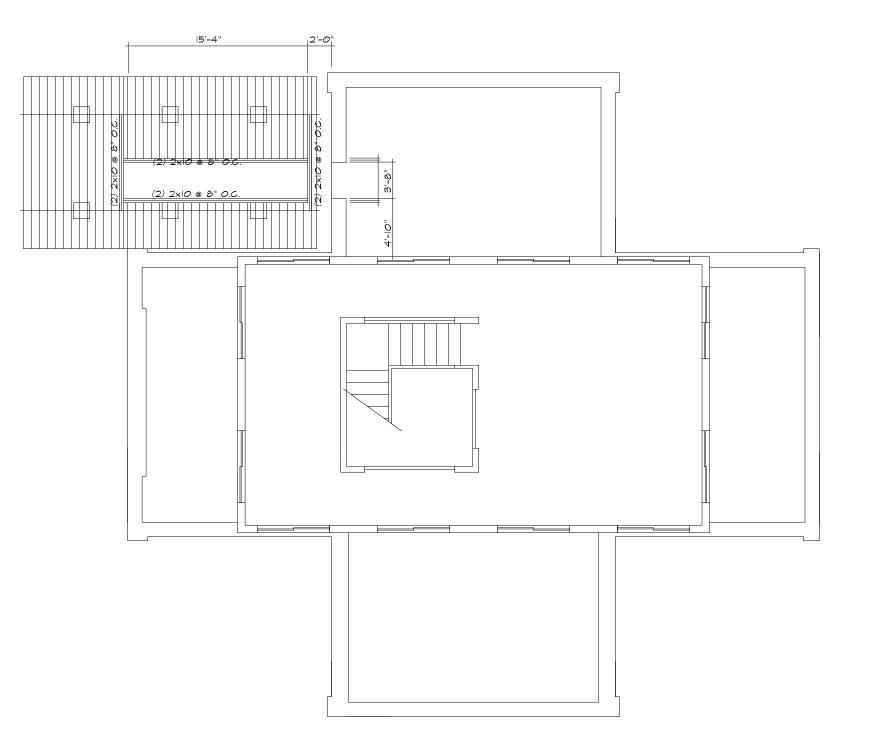

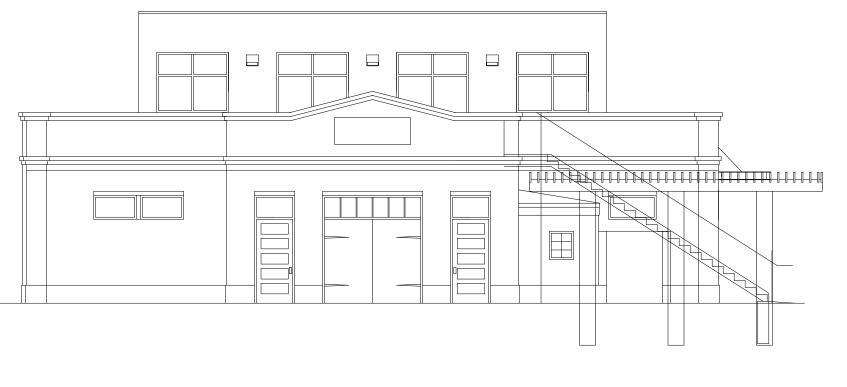






SCALE: 1/8"=1'-0"



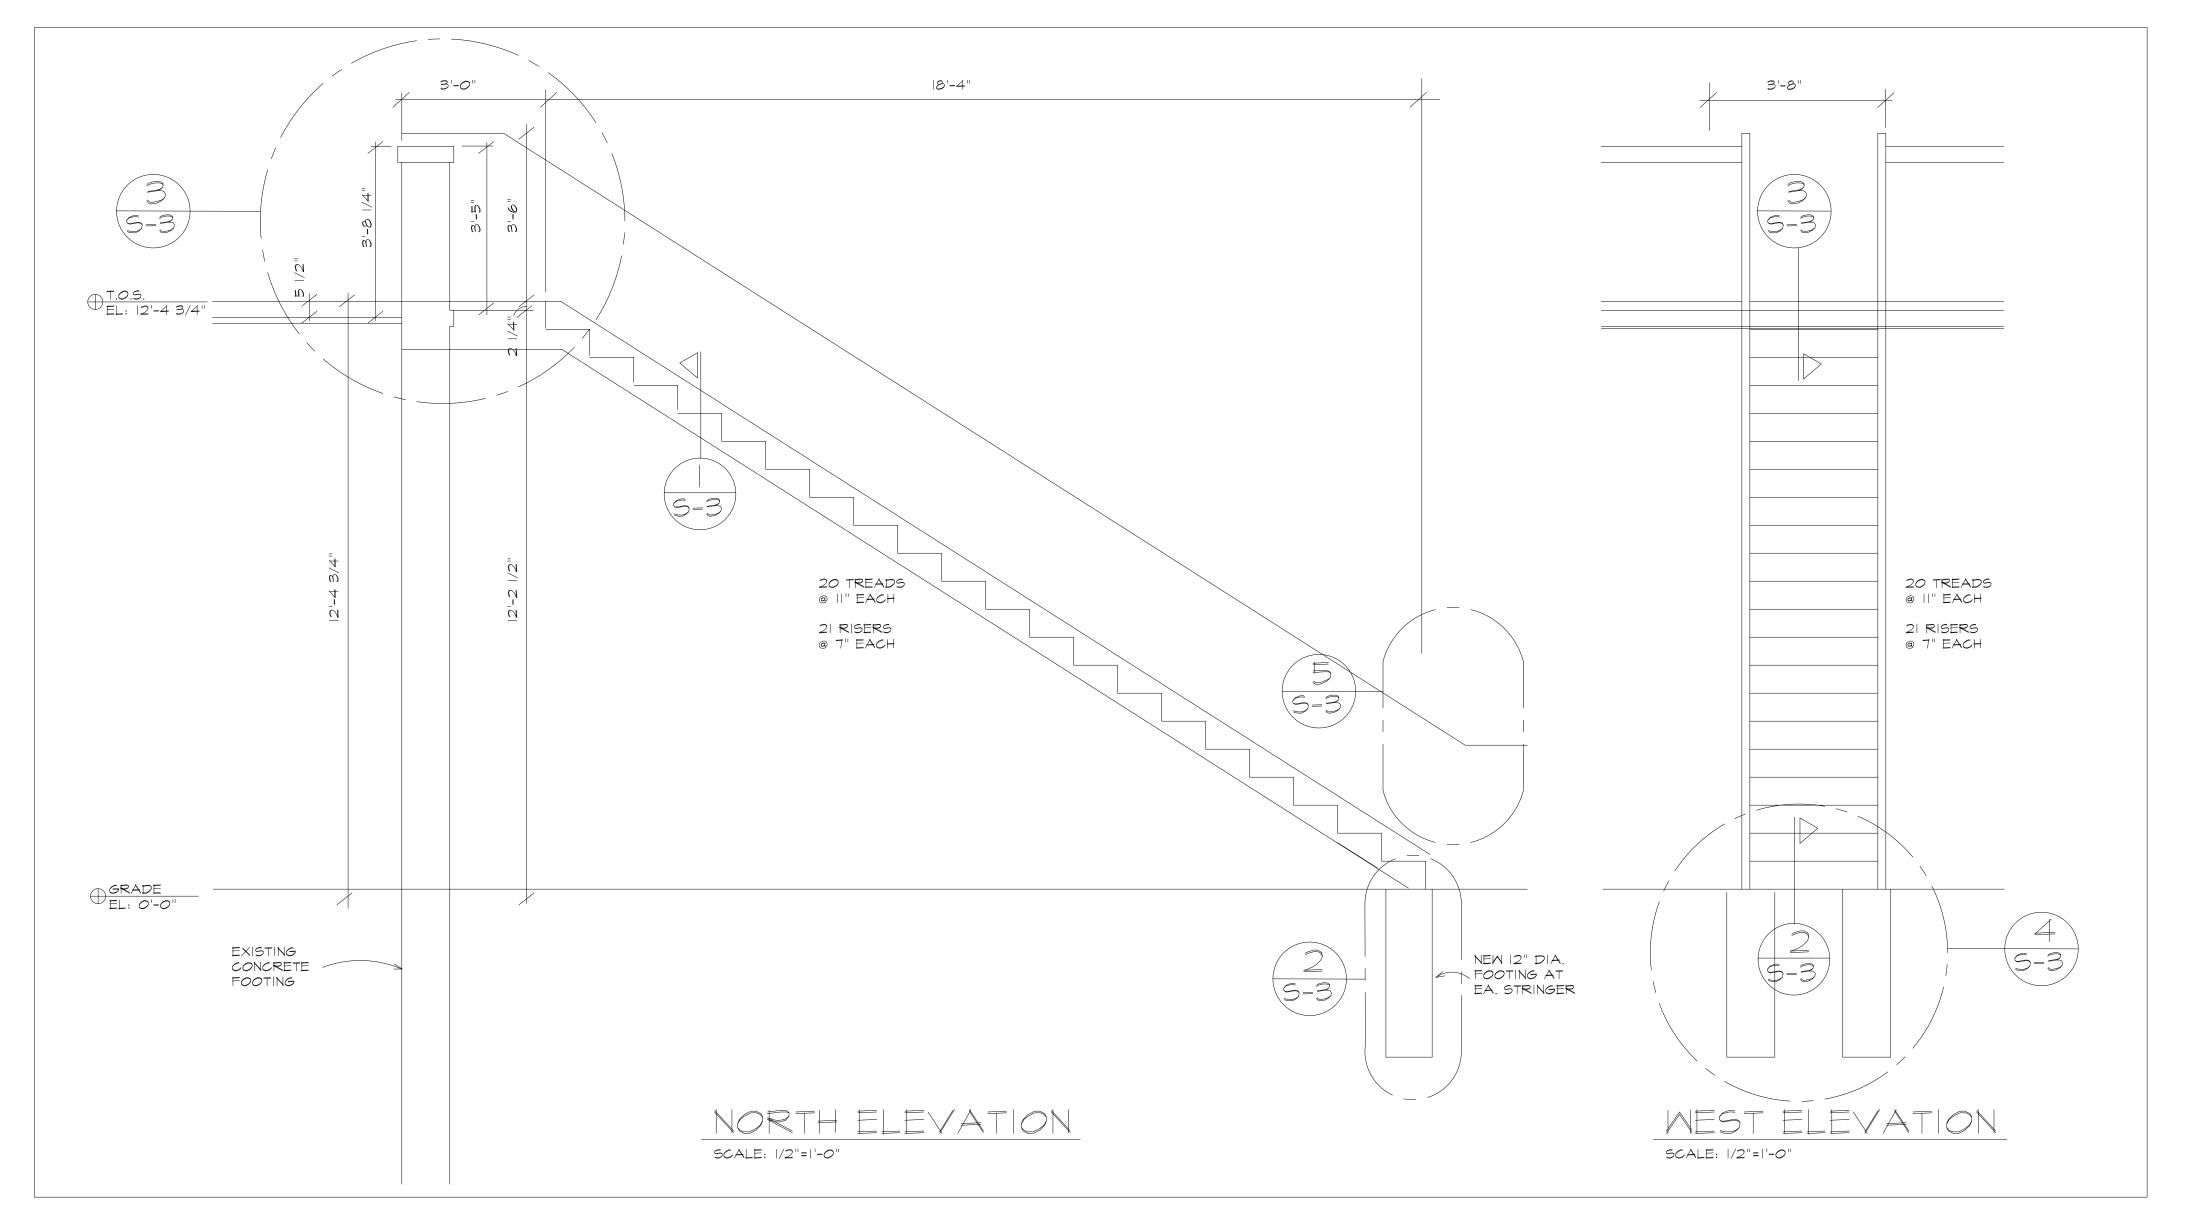





6-4-20	FOR PERMIT			
3-10-20	OWNER REVIEW	DATE	ВҮ	BULLETIN
DATE	ISSUE FOR		REVIS	IONS
SEAS	ONS MARKET			


SEASONS MARKET 4125 SECOND AVENUE DETROIT, MI 48201

Architects Planners Engineers

	373-347-7930 3-341-6944	
DESIGNED TLB		PROJECT NO
DRAWN TLB	CHECKED TLB	2003
APPROVED TLB	DATE 3-6-20	2000
SHEET TITLE		SHEET NO.
NEW EXTERIOR	STAIR PLAN	A-3

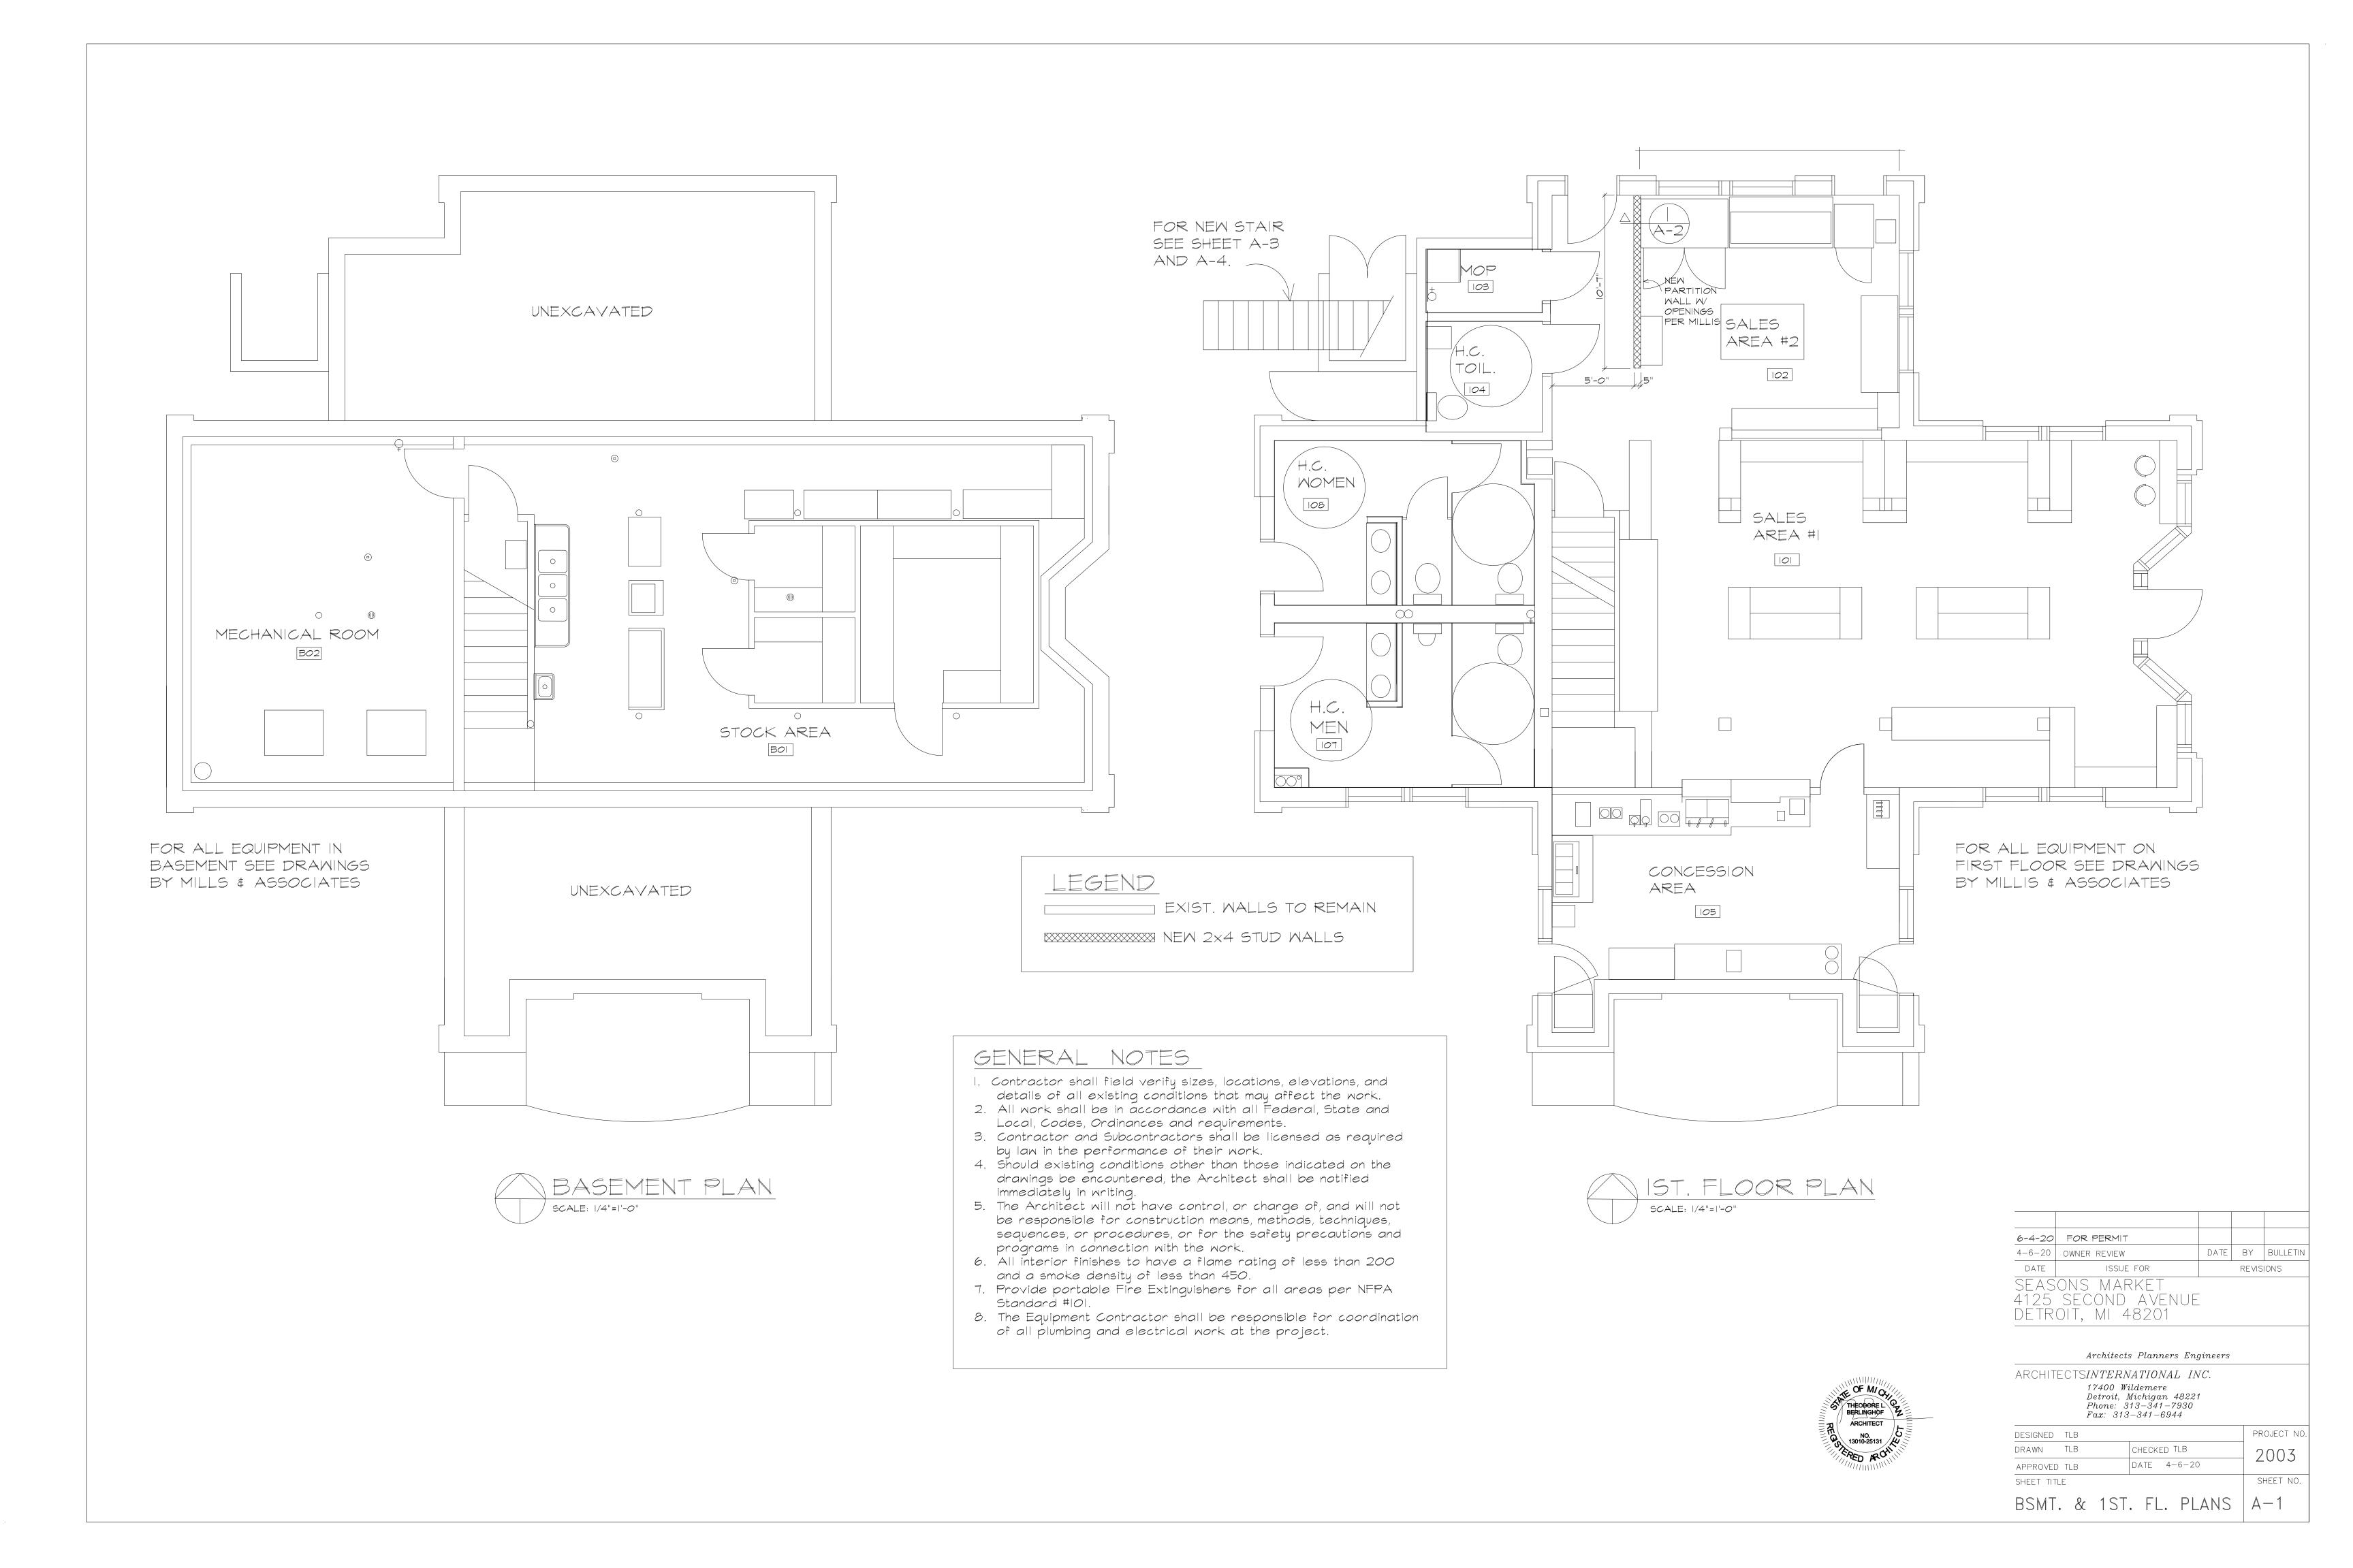

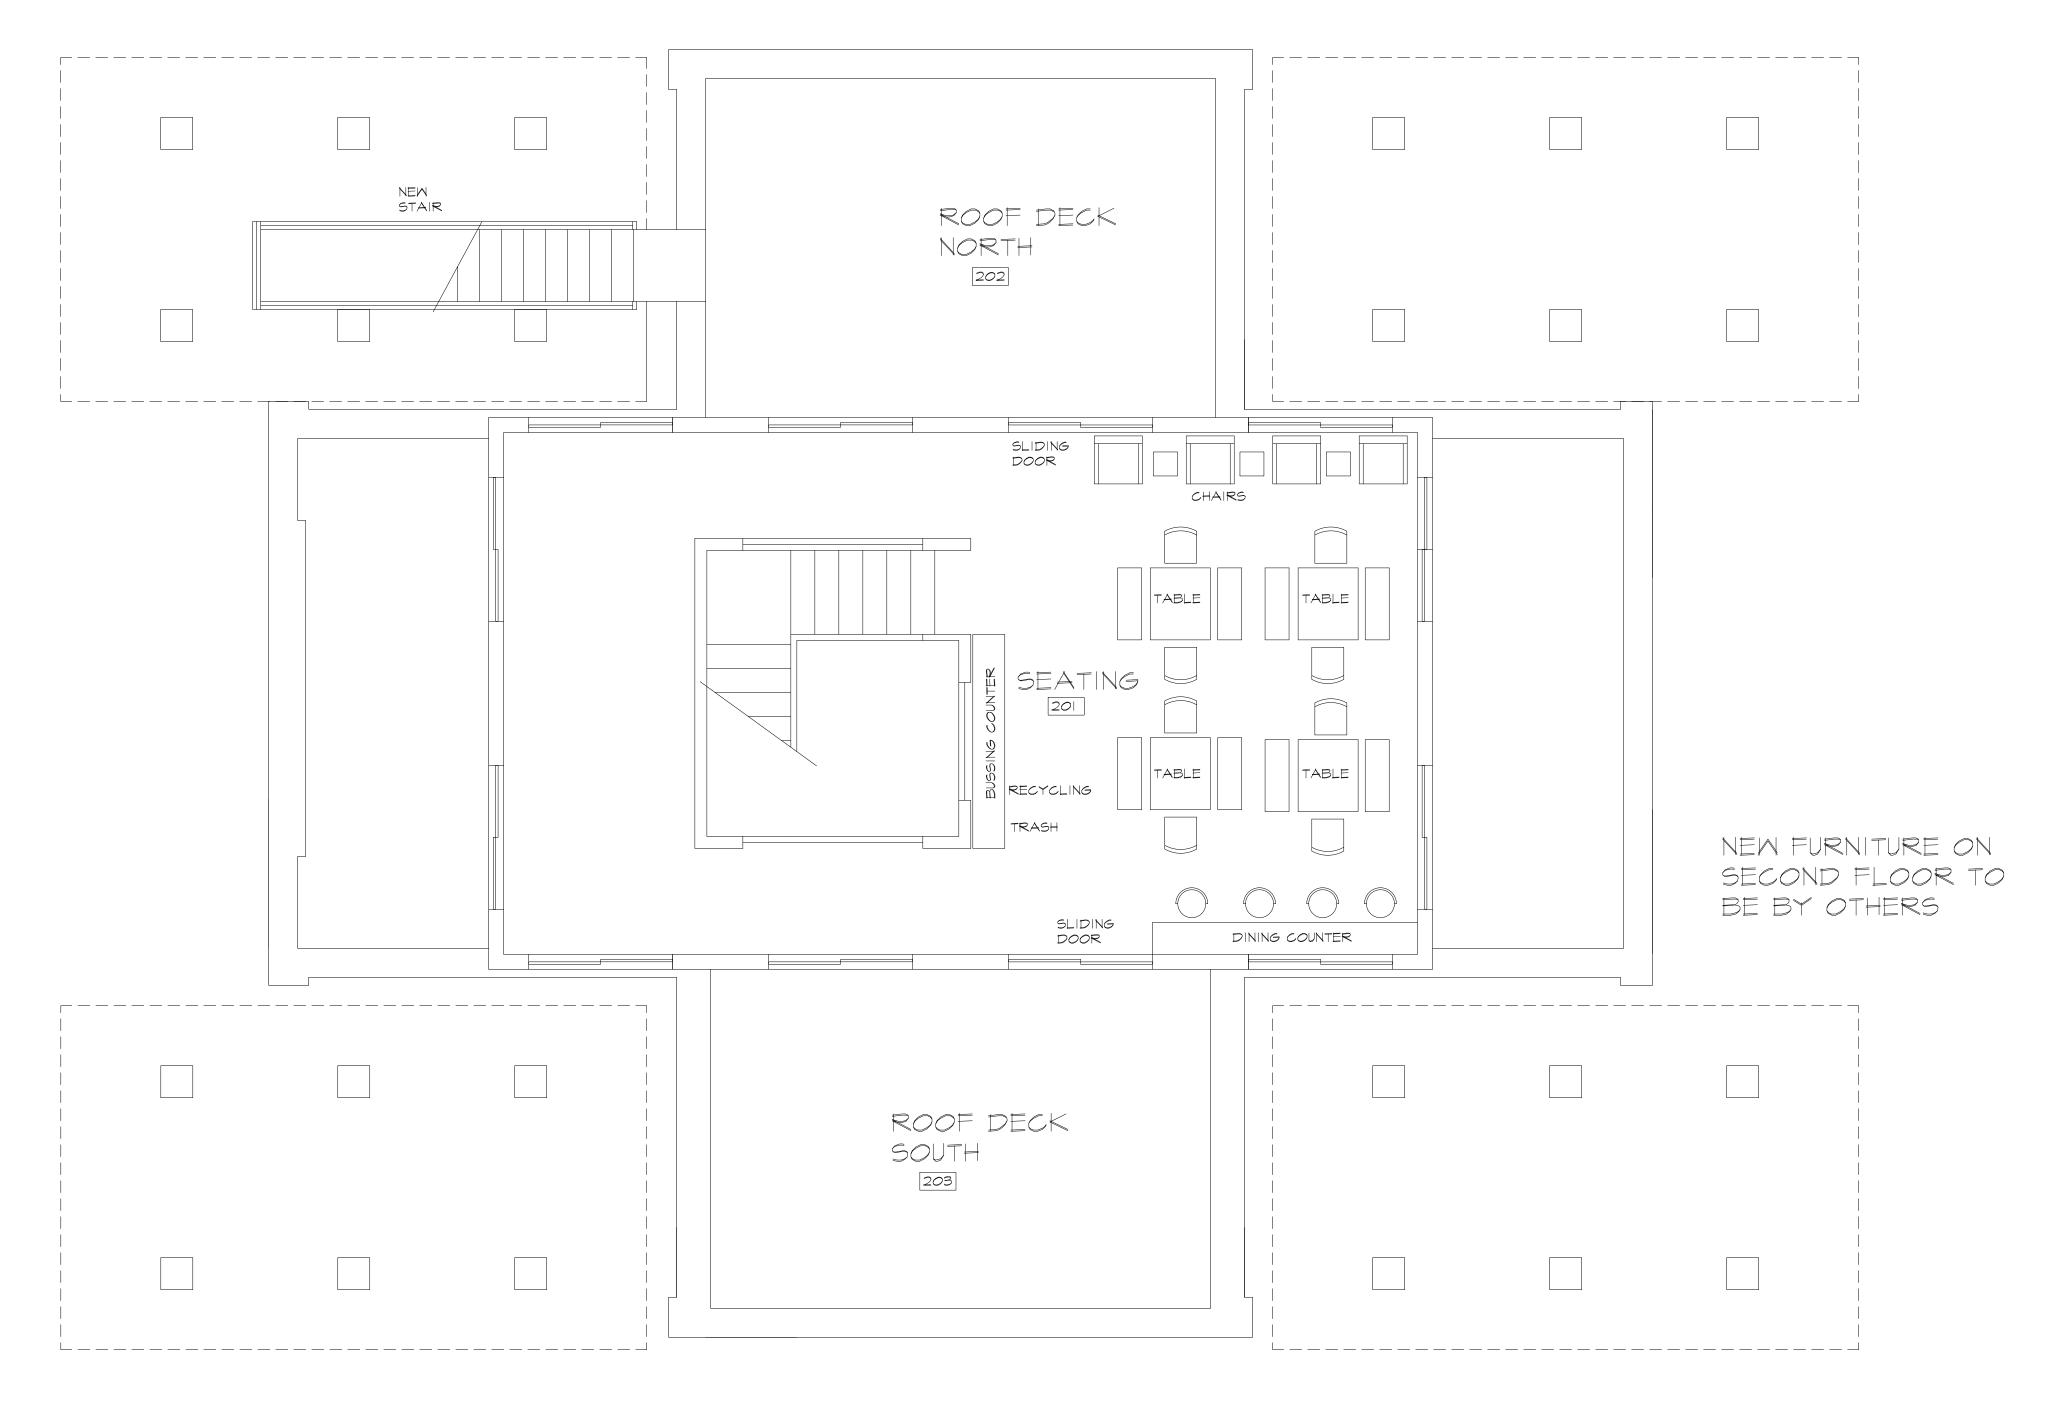

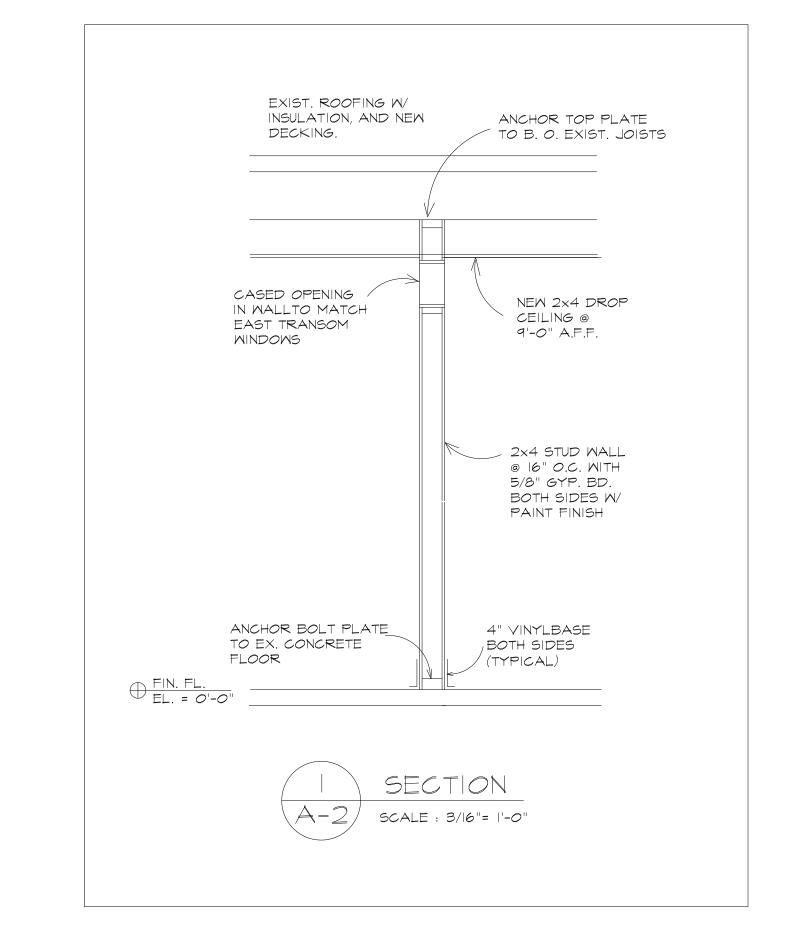

	2ND.		PLAN
	SCALE: 1/4"	= '-0"	

RDI						WALLS										
ROOM	ROOM NAME	BASE		FLOOR		NORTH		EAST		SOUTH		WEST		CEILING		REMARKS
NUMBER		MAT'L	FIN	MAT'L	FIN	MAT'L	FIN	MAT'L	FIN	MAT'L	FIN	MAT'L	FIN	MATERIAL	FIN	
B-1	BASEMENT	VIN.	F.F.	CDNC.	SEAL	HARDIE	W. PT.	HARDIE	W.PT.	HARDIE	W.PT.	GYP.BD.	W.PT.	GYP. BD.	W.PT.	
B-2	МЕСН. ВООМ			CUNC.	SEAL	HARDIE	UN.PT.	GYP.BD.	PRIMED	HARDIE	UN.PT.	HARDIE	UN.PT.	GYP, BD,	PRIMED	
101	SALES AREA #1	WD.	STN.	WD.	STN.	GYP.BD.	PT.	GYP.BD.	PT.	GYP.BD.	PT.	GYP.BD.	PT.	GYP. BD.	PT.	
102	SALES AREA #2	WD.	STN.	CDNC.	SEAL	GYP.BD.	PT.	GYP.BD.	PT.	GYP.BD.	PT.	GYP.BD.	PT.	GYP. BD.	PT.	
103	MOP ROOM	CER.	F.F.	CDNC,	SEAL	GYP.BD.	PT.	GYP.BD.	PT.	GYP.BD.	PT.	GYP.BD.	PT,	GYP, BD,	PT.	
104	INTERIOR TOILET	CER,	F.F.	CER.	F.F.	GYP.BD.	PT.	GYP.BD.	PT.	GYP.BD.	PT.	GYP.BD.	PT,	GYP, BD,	PT.	NORTH, SOUTH, EAST WALLS CER.TO 42" A.F.F.
105	CONCESSION AREA	CER.	F.F.	CDNC.	SEAL	GYP.BD.	W. PT.	GYP.BD.	W.PT.	GYP.BD.	W.PT.	GYP.BD.	CER. TILE	GYP. BD.	W.PT.	
107	H.C. MEN	CER.	F,F,	CER,	F.F.	GYP.BD.	PT.	GYP,BD,	PT,	GYP,BD,	PT.	GYP,BD,	PT.	GYP, BD,	PT.	
108	H.C. WOMEN	CER.	F.F.	CER.	F.F.	GYP.BD.	PT.	GYP,BD,	PT.	GYP.BD.	PT.	GYP.BD.	PT.	GYP, BD,	PT.	
201	SEATING AREA	WD.	STN.	WD.	STN.	GYP.BD.	PT.	GYP.BD.	PT.	GYP.BD.	PT.	GYP.BD.	PT.	GYP. BD.	PT.	
202	ROOF DECK N.			TIMBERTECH	F.F.											
203	ROOF DECK S.			TIMBERTECH												

FINISH NOTES:


CER. TILE=CERAMIC TILE, F.F.= FACTORY FINISH, CONC.= CONCRETE, VIN.=VINYL BASE, BLOCK=CONCRETE BLOCK, GYP. BD.=GYPSUM BOARD, PT=PAINT FINISH, STN.+ STAIN & SEAL, WOOD= 1x6 WOOD BASE (FCS CERT.),
HARDIE= HARDIE PANELS, BRICK= COMMON BRICK, RAIL= 36" METAL RAILING, UNFIN= UNFINISHED/NATURAL, SEALER= WASHABLE CONC. SEALER, W.PT.= GLOSS PAINT WASHABLE


FOR PERMIT			
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ISSUE FOR		REVIS	IONS
	FOR PERMIT OWNER REVIEW ISSUE FOR	OWNER REVIEW DATE	OWNER REVIEW DATE BY


SEASONS MARKET 4125 SECOND AVENUE DETROIT, MI 48201

Architects Planners Engineers

F ax: 37.	3-341-6944	
DESIGNED TLB		PROJECT NO
DRAWN TLB	CHECKED TLB	2003
APPROVED TLB	DATE 4-6-20	2000
SHEET TITLE		SHEET NO.
2ND. FLOOR	PLAN	A-2

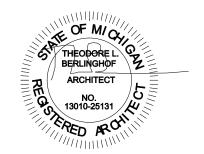

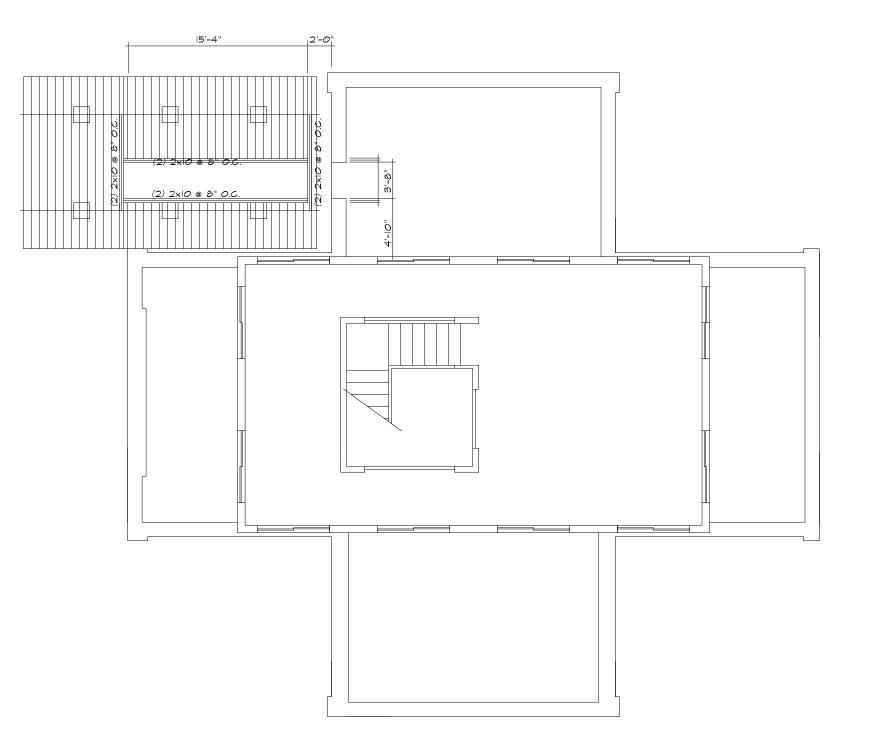

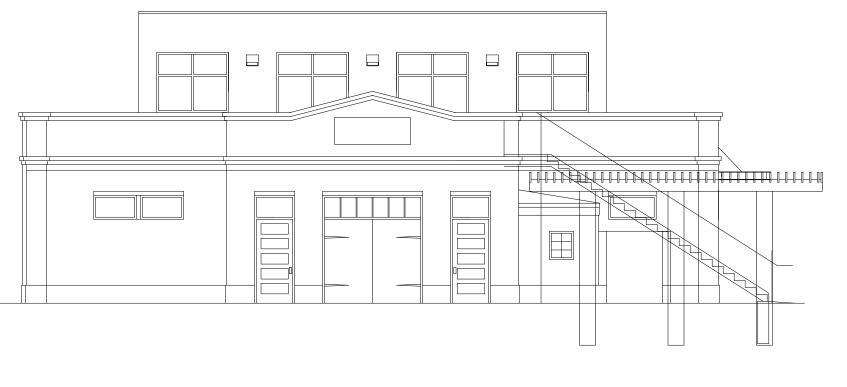






SCALE: 1/8"=1'-0"



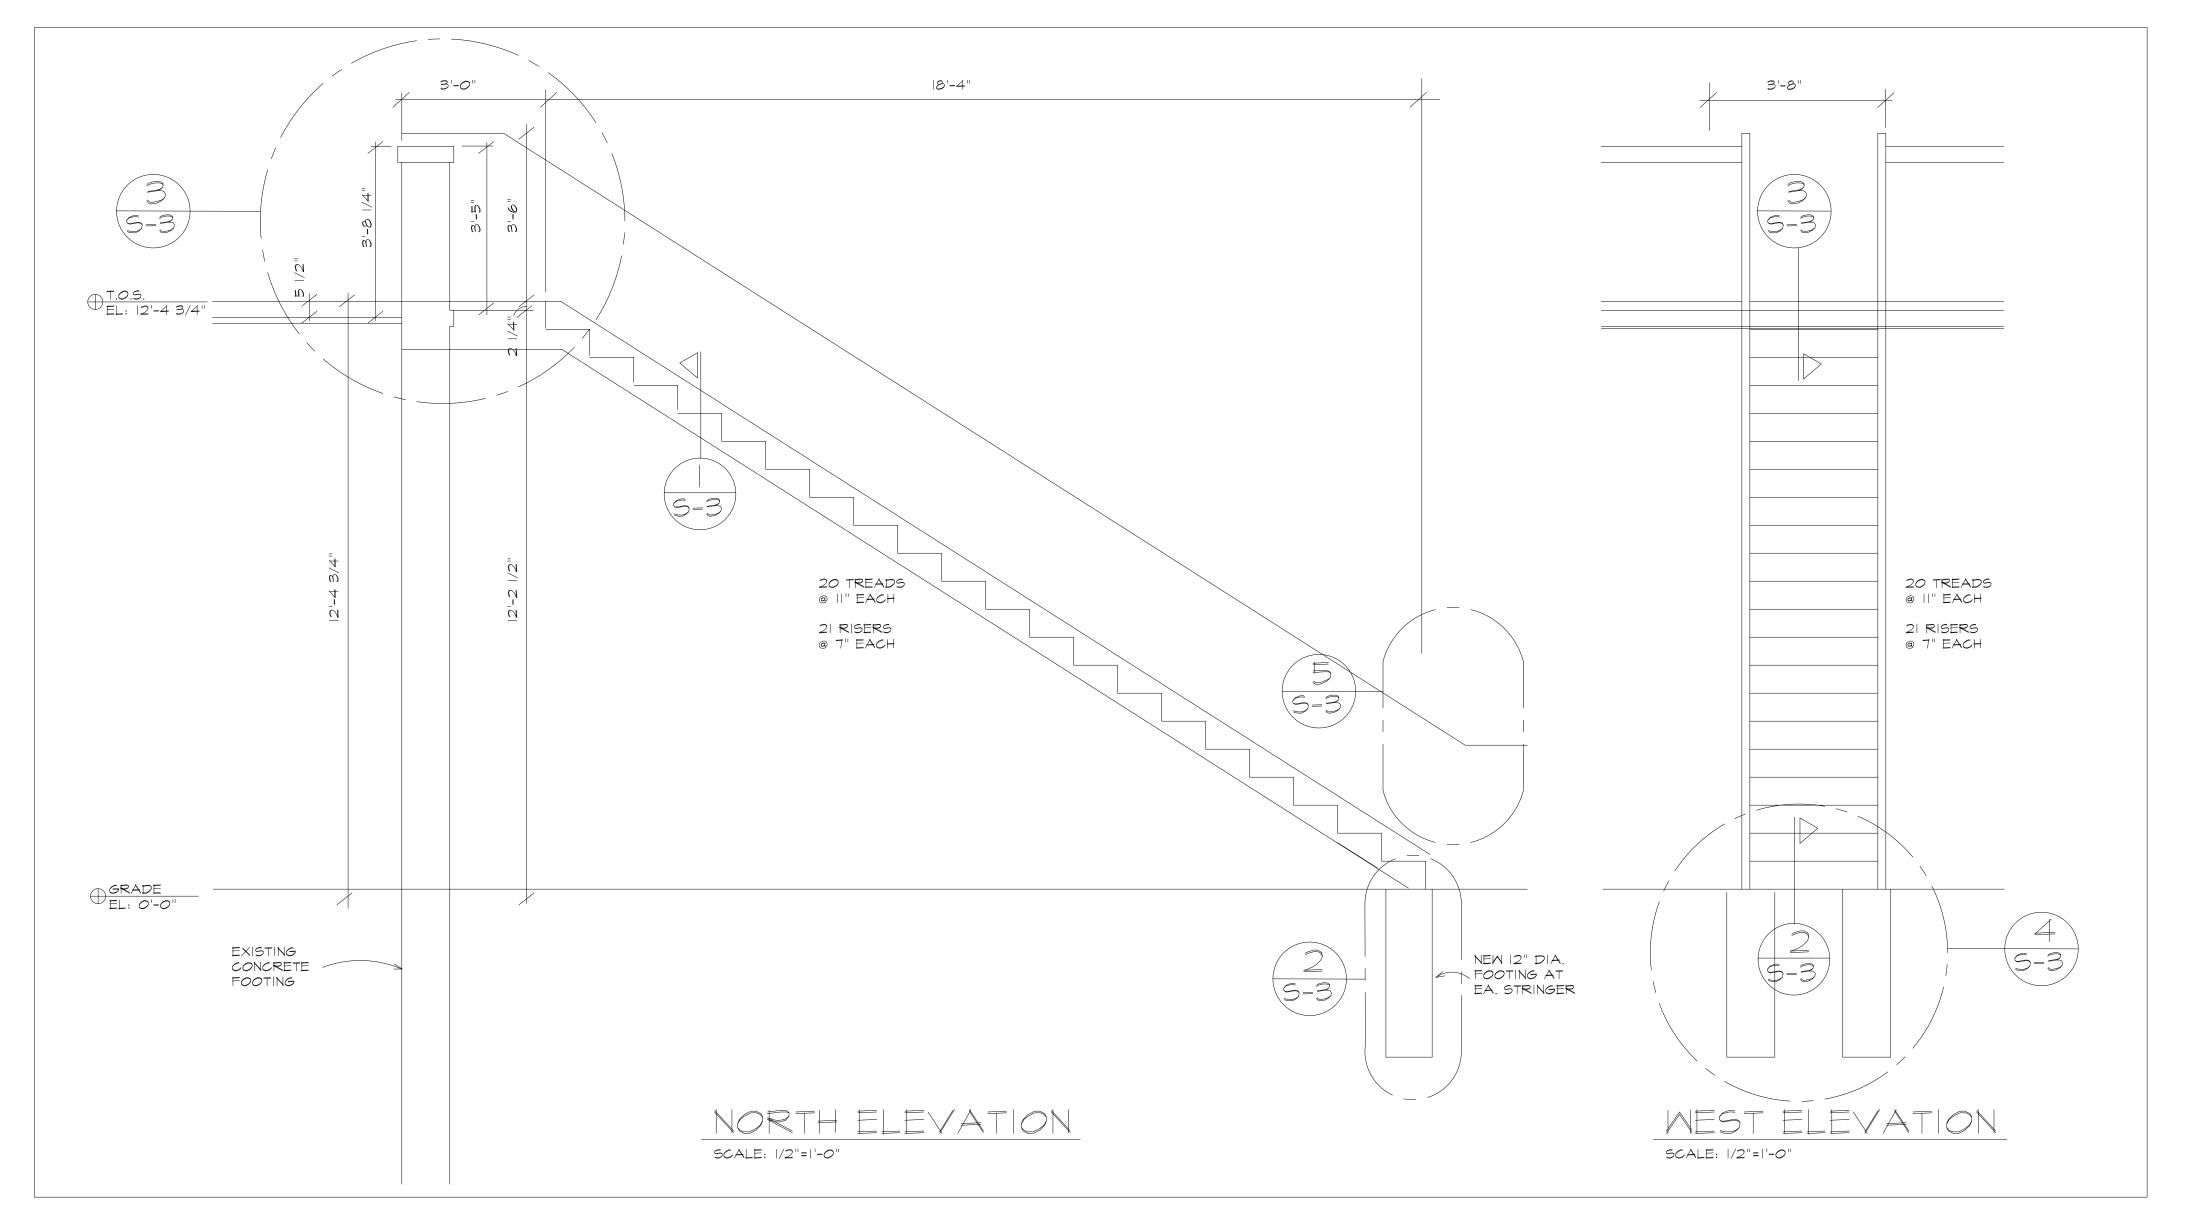




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3-10-20	OWNER REVIEW	DATE	ВҮ	BULLETIN
DATE	ISSUE FOR		REVIS	IONS
SEAS	ONS MARKET			

SEASONS MARKET 4125 SECOND AVENUE DETROIT, MI 48201

Architects Planners Engineers

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DESIGNED TLB		PROJECT NO
DRAWN TLB	CHECKED TLB	2003
APPROVED TLB	DATE 3-6-20	2000
SHEET TITLE		SHEET NO.
NEW EXTERIOR	STAIR PLAN	A-3

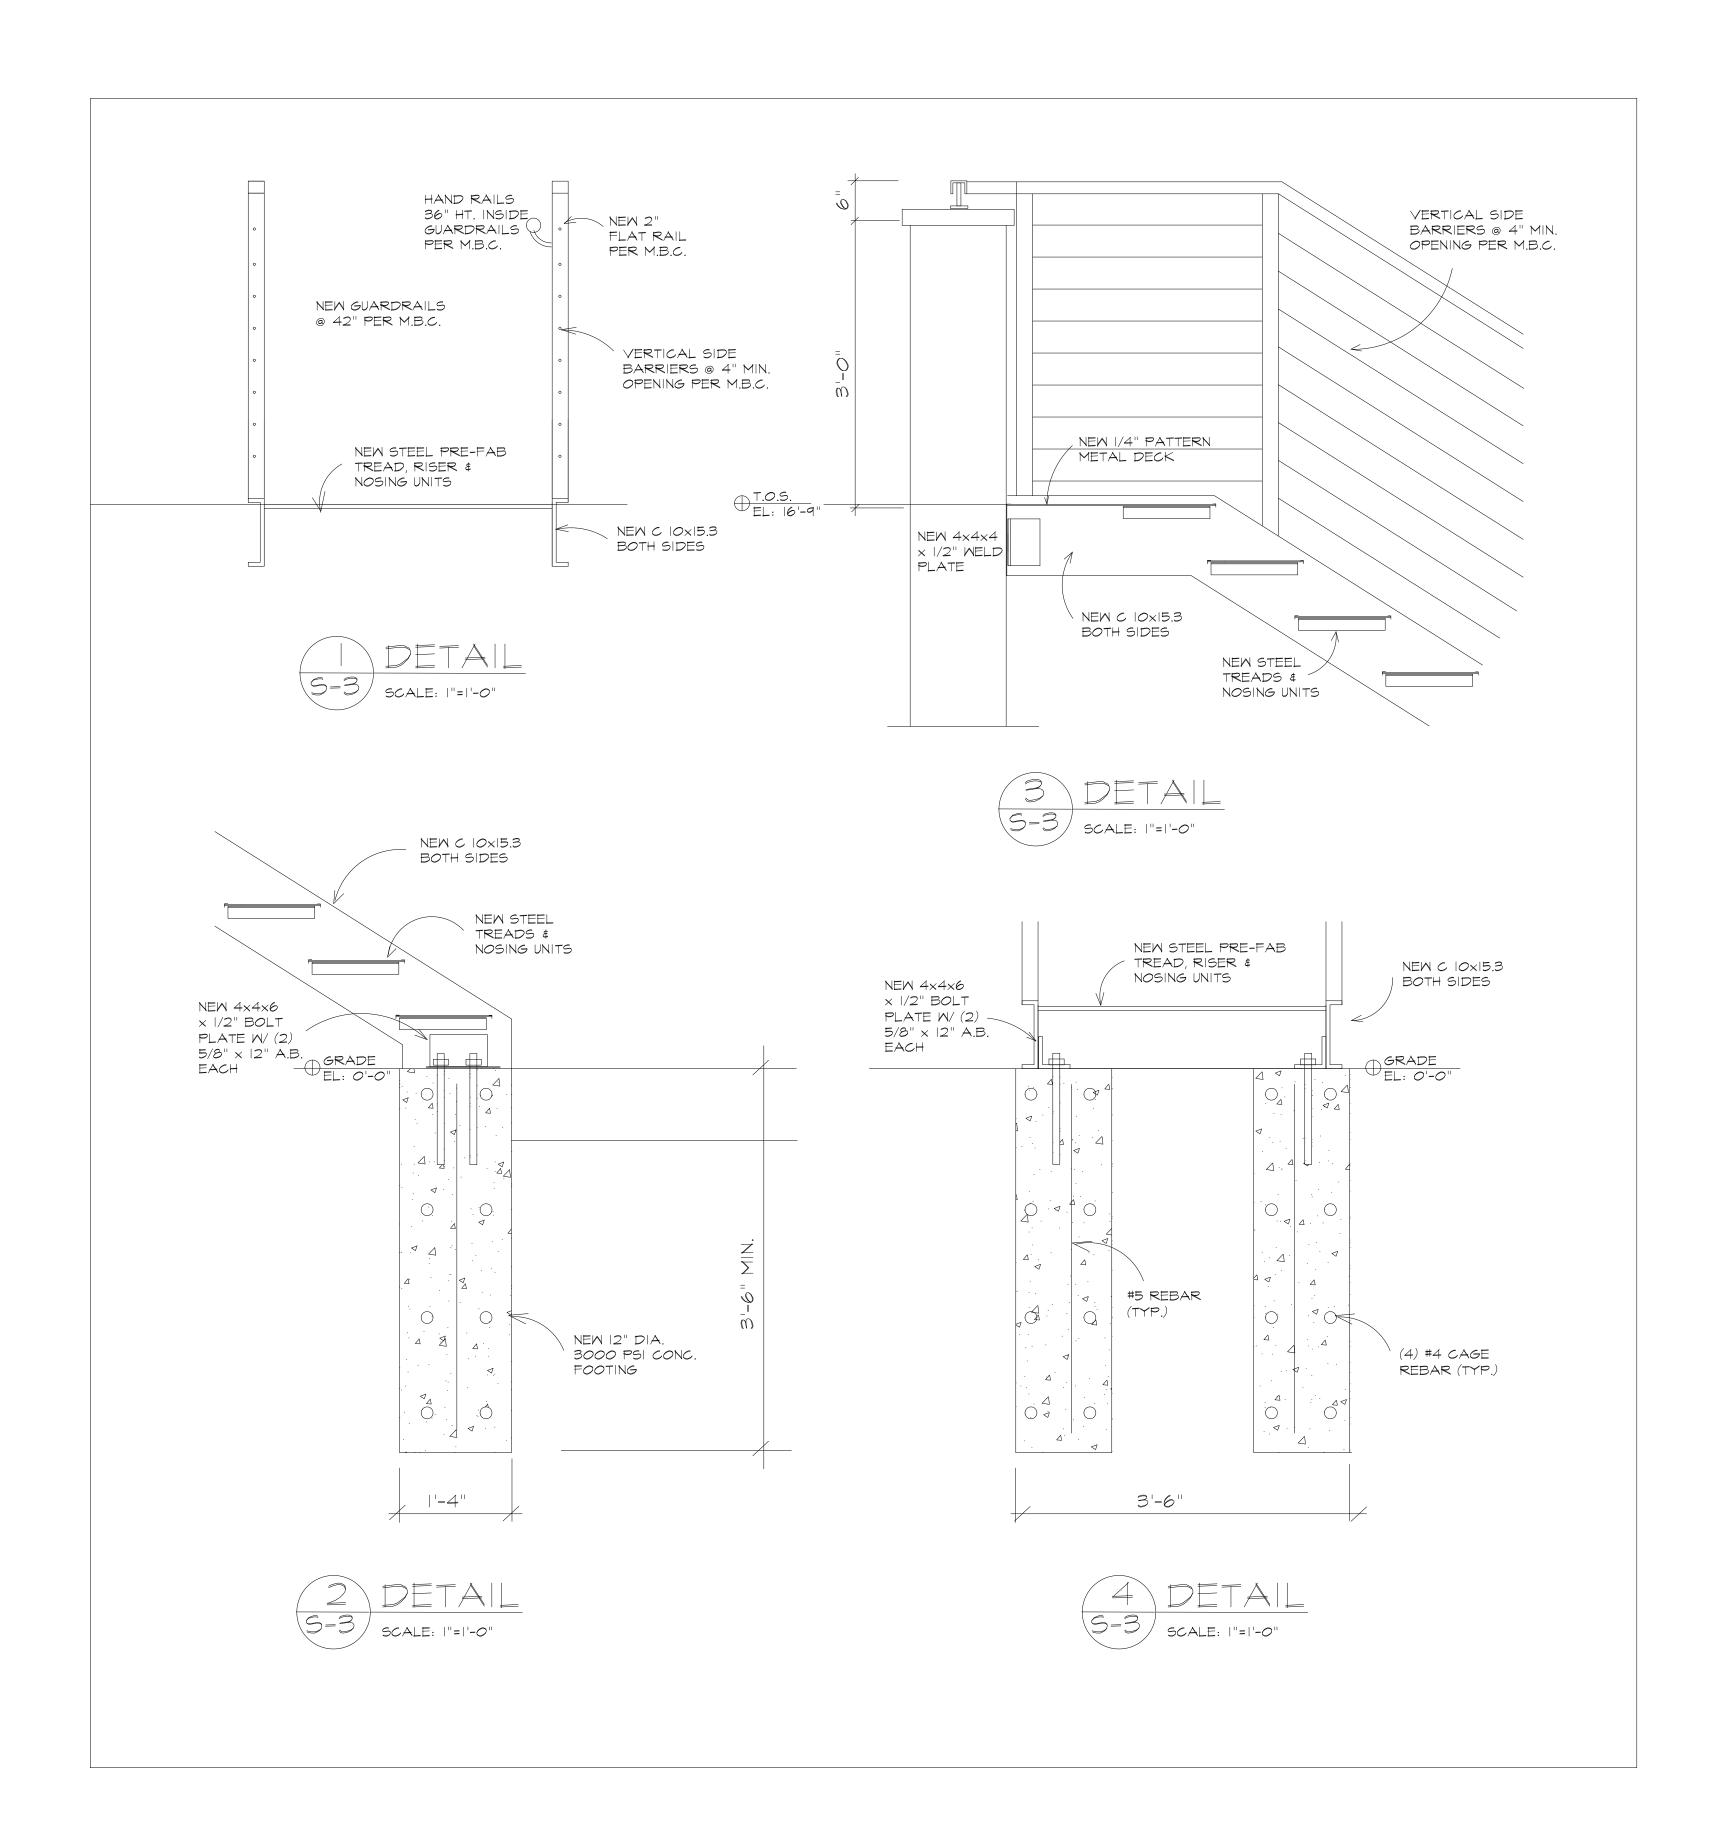

SPECIFICATIONS

CONCRETE WORK

- 1. Provide and Install Concrete in the following areas: a. Concrete Trench Footings.
- 2. Use ASTM C 150, Type | Concrete, 3000 p.s.i. Provide Concrete Tests to Owner for verification.
- 3. Use ACI Standards and Practices for Formwork and Reinforcing. ACI 301 and ACI 318.
- 4. Use ASTM A 615 Grade 60 or greater for reinforcing.

METAL FABRICATIONS

- 1. Provide miscellaneous metal work such as stair Support brackets, Steel Plates in order to complete the project.
- 2. Comply with all governmental regulations and Codes.
- 3. Fabricate the metal work with accurate angles and surfaces which are true to the required lines and levels, grinding exposed welds smooth and flush, forming exposed connections with hairline joints, and using concealed fastenings whenever possible.
- 4. Shop prime the work with "Rustoleum #5769 Primer" or equal. Where work will be inaccessible, apply two coats of primer.
- 5. After erection, grind exposed welds and touch up with Primer.


SHEET METAL FABRICATIONS

- 1. Install New Metal Decking, & prefabricated tread-risers.
- 2. Decking and stair landing to be perforated and sealed against moisture.
- 3. Use Galvanized Steel Sheet in compliance with ASTM A526. with Factory Finish.
- 4. Provide and install all necessary fasteners, clips, angles, bent metal, and trim necessary to support the Metal Fabrications to complete the project.
- 4. Steel Sheet is to be 18 Gauge minimum.
- 5. Submit Shop Drawings Metal Fabrications.

6-4-20	FOR PERMIT			
3-10-20	OWNER REVIEW	DATE	BY	BULLETI
DATE	ISSUE FOR		REVIS	IONS
	ONS MARKET SECOND AVENUE OIT, MI 48201	-		

Architects Planners Engineers

	Fax: 313	-341-	6944	
DESIGNED TL	В			PROJECT NO.
DRAWN TL	В	CHECK	ED TLB	2003
APPROVED TL	В	DATE	3-6-20	2000
SHEET TITLE				SHEET NO.
NEW FI	RE STA	4IR	DETAILS	A-4

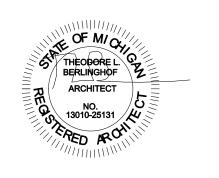

RENOVATION FOR SEASONS MARKET 4125 SECOND AVENUE, DETROIT, MI 48201

USE GROUP GROUP M - MERCANTILE

CONSTRUCTION TYPE

TYPE V-B

SQUARE FOOTAGE

2107.8 SQ. FT. FIRST FL.= <u>920.0 SQ. F</u>T. SECOND FL.= TOTAL: 3027.8 SQ. FT.

OCCUPANCY LOAD

FIRST FLOOR GENERAL 1752.9 SQ. FT. @ 1/60 S.F. = 29.22 PERSONS CONCESSION 354.9 SQ. FT. @ 1/300 S.F. = 1.18 PERSONS 30.40 PERSONS TOTAL:

SECOND FLOOR 920.0 SQ. FT. OPEN STAIR -126.0 SQ. FT.

@ 1/60 S.F.= 13.2 PERSONS BALCONIES 708 S.F. 25.0 PERSONS TOTAL=

749.0 SQ.FT.

BASEMENT 1364 SQ. FT.

4.5 PERSONS @ 1/60 S.F.= TOTAL: 59.9 PERSONS

ZONING

SD-2 SPECIAL DEVELOPMENT DISTRICT - MIXED USE


LEGAL DESCRIPTION

LOTS 15 AND 16 OF BLOCK 96 OF THE "PLAT OF SUBDIVISION OF PART OF THE CASS FARM", L. I, P. 175-177 PLATS, WAYNE COUNTY RECORDS.

PROJECT DESCRIPTION

OWNER WOULD LIKE TO RENOVATION THE EXISTING BUILDING INTO A MARKET WITH A CONCESSION STAND LOCATED IN THE SOUTH QUADRANT OF THE BUILDING.



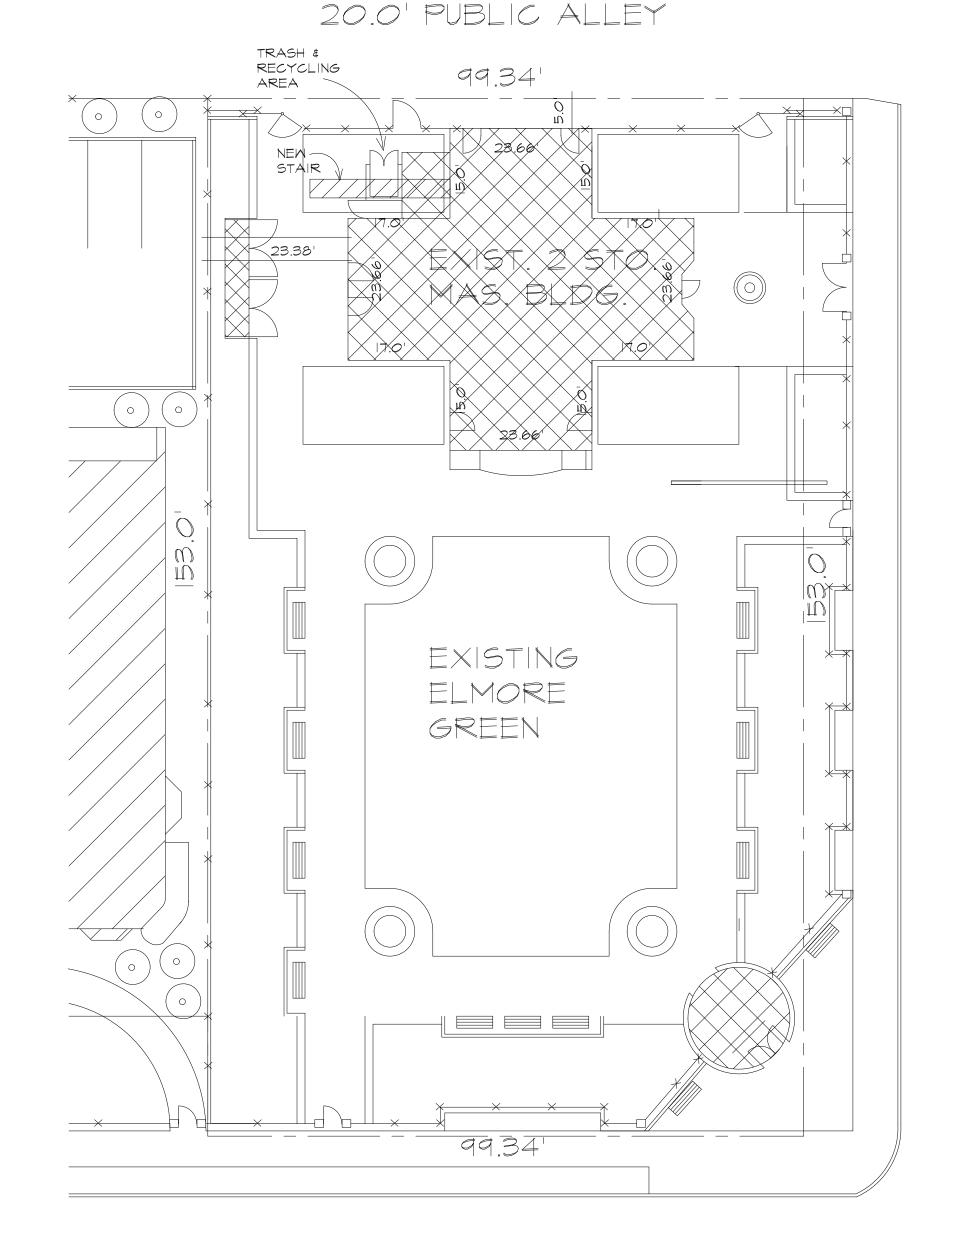

WEST ALEXANDRINE ST.



LIST OF DRAMINGS

ARCHITECTURAL PLANS SITE PLAN BSMT. & IST. FL. PLANS 2ND FLOOR PLAN NEW EXTERIOR STAIR PLAN NEW STAIR DETAILS BSMT. & IST. FL. PLUMBING PLANS PLUMBING RISERS BSMT. & IST. FL. H.V.A.C. PLANS SECOND FL. H.V.A.C. PLAN BSMT. & IST. FL. POWER PLANS SECOND FL. POWER PLAN BSMT. & IST. FL. LIGHTING PLANS SECOND FL. POWER PLAN ELECTRICAL RISER DIAGRAMS

FOOD SERVICE EQUIPMENT PLANS PSE-I IST. FL. CONCESSION PLAN PSE-2 CONCESSION MECH. PLAN PSE-3 CONCESSION ELEC. DETAILS PSE-4 CONCESSION ELEC. PLAN PSE-5 IST. FL. MARKET PLAN PSE-6 MARKET MECHANICAL PLAN PSE-7 MARKET ELECTRICAL DETAILS PSE-8 BSMT. EQUIPMENT PLAN PSE-9 BSMT MECHANICAL PLAN PSE-IO BSMT. ELEC. DETAILS PSE-II BSMT. ELEC. PLANS PAS-12 BSMT. REFRIG. DETAILS PSE-13 WALK-IN COOLERS

PSE-14 WALK-IN COOLER DETAILS

CODES USED

2015 MICHIGAN BUILDING CODE 2015 MICHIGAN MECHANICAL CODE 2015 MICHIGAN PLUMBING CODE 2017 NATIONAL ELECTRICAL CODE W/ STATE AMANDMENTS MICHIGAN BARRIER FREE DESIGN LAW AS AMMENDED AND ICC/ANSI AII7.I LOCAL ZONING ORDINANCES

6-4-20	FOR PERMIT			
4-6-20	OWNER REVIEW	DATE	BY	BULLE ⁻
DATE	ISSUE FOR		REVIS	IONS
SEVS	ONS MARKET			

SEASUNS MARKET 4125 SECOND AVENUE DETROIT, MI 48201

Architects Planners Engineers

Fax: 33	13-341-6944	
DESIGNED TLB		PROJECT N
DRAWN TLB	CHECKED TLB	2003
APPROVED TLB	DATE 4-6-20	7 2005
SHEET TITLE		SHEET NO
SITE PLAN		SP-1






(15) (16)

14 E

A ELEVATION OF BEER COUNTER







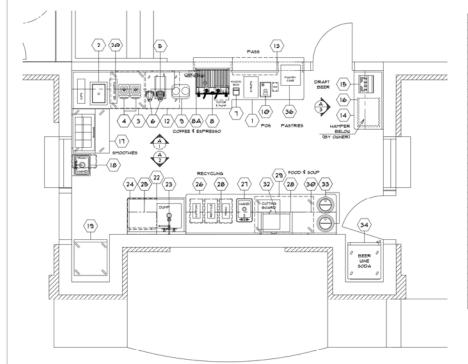

				EQUIPMENT SO	CHEDULE		
ITEM #	QTY	UNITS	CATEGORY	MFR	MODEL	EQUIPMENT REMARKS	SUPPLIED BY
	- 1	LOT	FRONT COUNTER	R\$D FABRICATING	CUSTOM 9/9		
2	- 1		DROP-IN ICE BIN	GLASTENDER	DI-IB12		
3	1		REACH-IN UNDERGOUNTER FREEZER	TRUE	TUG-21F-D-2-HG	W/ 2.25" CASTERS	
4	2		BLENDER	VITAMIX	036013		
5	1		COFFEE BREWER	BUNN	23001.0003		
6	2		AIRPOT	BUNN	32130.0000		
7	1		KNOCK BOX	F\$0	EPK665B		
8	1		ESPRESSO MACHINE	F\$0	LINEA-PB-2-AV		
8A	1		ESPRESSO WATER FILTER	EVERPURE	EV927222		
9	- 1		COFFEE GRINDER	F\$O	K3Ø TWIN		
10	1	LOT	POS \$ PRINTER	CUSTOM			BY OWNER
11			SPARE NUMBER				
12	1		UNDERCOUNTER REFRIGERATOR	TRUE	TUC-27G-LP-HC-FGDØ1		
13	1		PASS-THRU SHELF	CUSTOM MILLWORK	CUSTOM		BY MILLWORK CONT'R
14	1	LOT	BEER COUNTER	R [€] D FABRICATING	CUSTOM 9/9		
15	1		BEER TAPS	GLASTENDER	BT-4-99		BY BEVERAGE CO.
16	1		WALL SHELF	ADVANCE TABCO	W9-15-48		
17	1		SANDWICH / SALAD PREP REFRIG.	TRUE	T99U-36-Ø8-HC		
18	1		HAND SINK	ADVANCE TABCO	1-P5-60		
19	1		REACH-IN REFRIGERATOR	TRUE	T-23-HC		
20	1		WALL SHELF	R\$D FABRICATING	CUSTOM 9/9		
21			SPARE NUMBER				
22	1		DISHTABLE	ADVANCE TABCO	DTU-U6@-48L		
23	- 1		PRE-RINSE FAUCET	T\$5 BRASS	MPZ-8WLV-Ø8-CR		
24	1		UNDERCOUNTER DISHWASHER	HOBART	LXEH+BULDUP		
25	2		DISH SHELF	METRO	1824NK3		
26	1	LOT	BACK COUNTER	R [©] D FABRICATING	CUSTOM 9/9		
27	1		DROP-IN SINK	ADVANCE TABCO	DI-1-10		
28	3		WALL SHELF	R [©] D FABRICATING	CUSTOM 9/9		
29	1		UNDERCOUNTER REFRIGERATOR	TRUE	TUC-48-LP-HC		
30	1		WALL SHELF	ADVANCE TABCO	WS-18-36		
31			SPARE NUMBER				
32	1		MICROWAVE OVEN	ACP	RCSIØTS	ON SHELF	
33	2		SOUP WARMER	VOLLRATH	7411@IDW		
34	1		REACH-IN REFRIGERATOR	TRUE	T-23G-HC~FGDØI		
35			SPARE NUMBER				
36	1		COUNTERTOP PASTRY CASE	CAL-MIL	P255-13		
37-38			SPARE NUMBER				

CAFE FLOOR PLAN

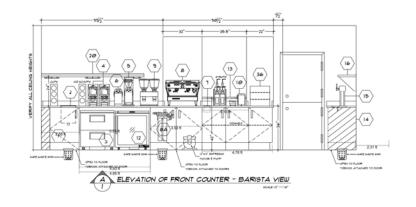


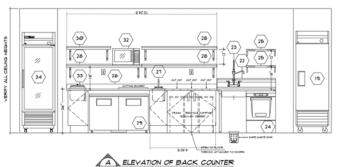



A ELEVATION OF BACK COUNTER





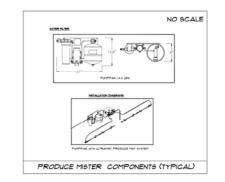

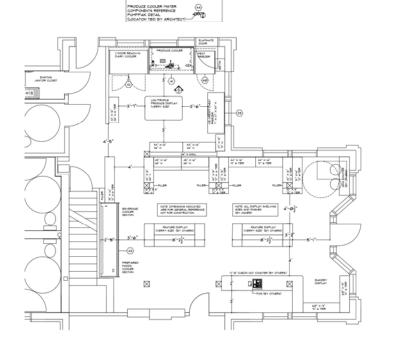


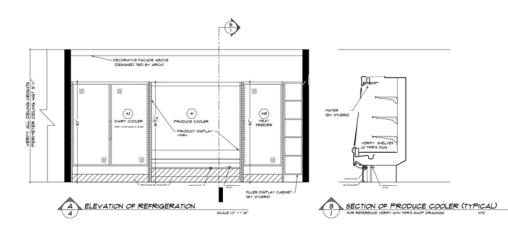


MARKET FLOOR PLAN



FSE-8 OF 14

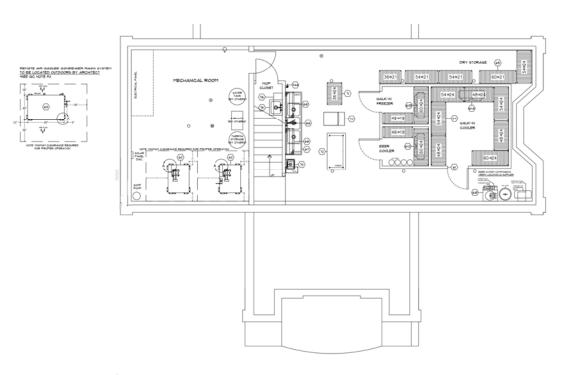

ITEM #	QTY	UNITS	CATEGORY	MER	MODEL	SUPPLIED BY
	QII	UNIIS	DRAFT BEER SYSTEM	CUSTOM	PIODEL	BY LEONARD'S SYRUPS
64	-					BT LECNARD 5 STRUPS
61	1	LOT	WALK-IN COOLER/FREEZER/BEER COOLER	KOLPAK	CUSTOM	
61A	1	LOT	WALK-IN COOLER EVAPORATOR COIL	RDT	ADT-030	
040%	1	LOT	WALK-IN FREEZER EVAPORATOR COIL	RDT	LET-065	
61C	1	LOT	WALK-IN BEER COOLER EVAPORATOR COL	RDT	ADT-040	
62	2		INDOOR REFRIGERATION SYSTEM	RDT	IRP2-02Z-C6I-AER	
63	1		OUTDOOR CONDENSER RACK	RDT	Z92-C91-ARA	
64	1	LOT	WALK-IN SHELVING	METRO	METRO SEAL III	
65	1	LOT	DRY STORAGE SHELVING	METRO	SUPER ERECTA BRITE	
66	1		PRE-RINSE W/ ADD ON FAUCET	T\$6 BRASS	B-Ø133-ADF12-BC	
61	1		THREE (3) COMPARTMENT SINK	ADVANCE TABCO	94-23-6 <i>0</i> -18RL	
68	2		DISH SHELF	METRO	1442NK3	
69			SPARE NUMBER			
10			SPARE NUMBER			
71	1	LOT	CLEAN DISH RACK	METRO	METRO SEAL III	
72	1		MOBILE WORK TABLE	ADVANCE TABCO	T99-3@5	
13	- 1		HAND SINK	ADVANCE TABCO	1-P9-60	
14	1		ICE MAKER W/ BIN	MANITOWOC	IYTØ42ØA	
14A	1		ICE MAKER WATER FILTER	EVERPURE	EV9324@I	
15	1		MOP SINK	ADVANCE TABCO	9-0P-20	BY GC
76	1		CLEANING SUPPLY SHELF	METRO	1436NK3	

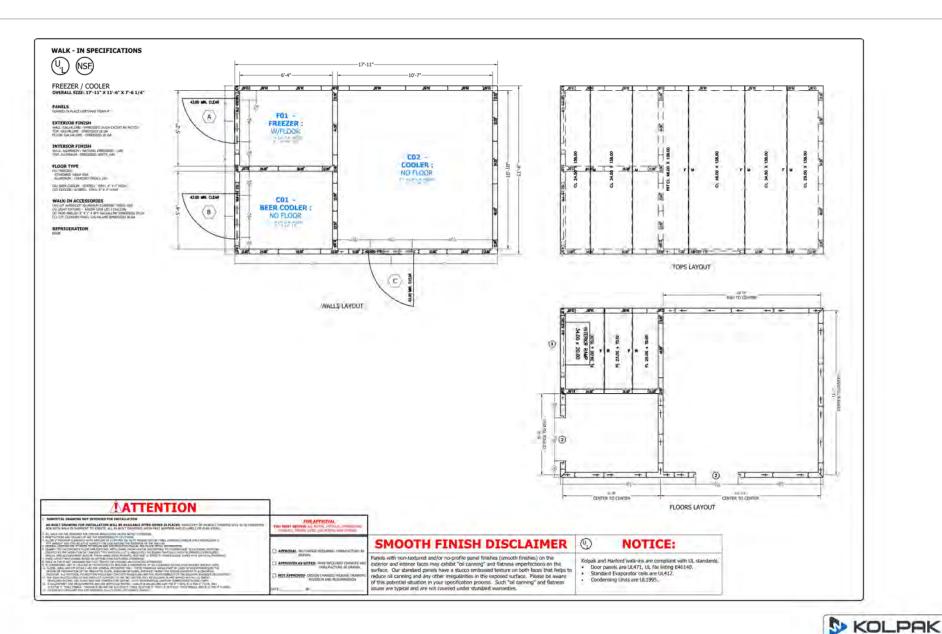

REVISED: 05.29.2020 PL/CB

> WALK-IN COOLER PANEL REQUIREMENTS

SEASONS MARKET BASEMENT DETROIT, MI

DRAWN BY CE/PL DATE 05:20:20 CHECKED BY PLL BCALE 1/16

> 15514 Farmington Rd. Livonia, Michigan 45114 pr. 734.498.4775 jr. 734.498.4778 drawings@damilits.com



| KOLPAK | JOB NOW 2680 | 2680 | DRAWING #A168581R2 | F9E-13

REVISED: 05.29.2020 PL/CB

KOLPAK

DRAWING #A168581R2


A Welbilt Brand

FRAME: RECESSED 0" WITH 0" LEVELING SAND AND 0" TILE AND GROUT EXT: GALVALUME - EMBOSSED 26 GA INT: ALUMINUM - NATURAL EMBOSSED - .040 PLUG: EXT: GALVALUME - EMBOSSED 26 GA EXT: KICKPLATE, ALUM .063 DIAMOND TREAD 36" HIGH INT: ALUMINUM - NATURAL EMBOSSED - .040 INT: KICKPLATE, ALUM .063 DIAMOND TREAD 36" HIGH

HARDWARE AND ACCESSORIES: HANDIAWAE AND ALLESSCRIES:
(1) 115/01 ELECTRICAL
(1) VENT - PRESSURE RELIEF, HEATED KASON 1825 (STD)
(1) LIGHT FORTURE - KASON 1803 LED W/BULB,
GLIDE AND NIGHTLIGHT 120V (STD)
(1) THERMOMETER - 2 INCH DIAL W/S' LEAD (STD)
(1) SWITCH - PILOT LIGHT INCLUDED U. (STD)

	(1) THRESHOLD, STAINLESS STEEL 14 GA (1) VIEWPORT - 14X14 FREEZER, HEATED FRAME AND GLASS 4IN THICK 120V 50/60HZ
OFFSET -2.38	(1) HEATER WIRE, 5 WATT / FT (1) DOOR CLOSER - KASON 1098 W/COVER AND HOOK (STD) (1) HANDLE - KASON 28 WITH LOCKING ASSEMBLY (STD)
DR 34.00" x 78.00" FR 50.25" x 82.25"	(3) HINGE - KASON 1345 ADJUSTABLE / SPRING ASSISTED (STD (1) RAMP INTERIOR 34X20
DW-1 (A)	
DOOR	ELECTRICAL INFORMATION

DOOR ELECTRICAL INFOR	NTAMS	JN.		
DESCRIPTION	QTY	VOLT	AMP -	AMP LOAD
LEDUSHT	2		0.4	0.0
I EATER WIRE	1		0.6	0.8
KASON 1967 SWITCH / DIGITAL THE RESOMETER GOMBO	0		0.80	0.0
HEATED AIR VENT	1.0		0.1	0.1
HEATED VEWFORT		115	0.9	0.6
AR SHELD	-0		1.4	0.0
N'OUT BUZZER	.0		0.1	0.0
ARCTIC FOX DELLIX DOOR IXSPLAY	. 0	1 1	0.4	0.0
ALARMS	. 0	200	1.0	0.0
115 VOLT, SINGLE PHASE, BI	O Hz. Ti	OTAL DO	OR AMPS	2.60

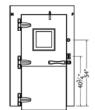

OFFSET 1.38

DR 34.00" x 78.00" FR 52.25" x 82.25"

FRAME:
RECESSED 0" WITH 0" LEVELING SAND AND 0" TILE AND GROUT
EXT: GALVALUME - EMBOSSED 26 GA
INT: ALUMINUM - NATURAL EMBOSSED - .040

PLUG: EXT: GALVALUME - EMBOSSED 26 GA EXT: KICKPLATE, ALUM. 063 DIAMOND TREAD 36" HIGH INT: ALUMINM - NATURAL EMBOSSED - .040 INT: KICKPLATE, ALUM. .063 DIAMOND TREAD 36" HIGH

HAT SUCCESSORIES.

(3) 115/07) ELECTRICAL.

(3) 115/07) ELECTRICAL.

(3) 115/07) ELECTRICAL.

(3) 115/07) ELECTRICAL.

(4) 115/07) ELECTRICAL.

(5) 115/07) ELECTRICAL.

(5) 115/07) ELECTRICAL.

(5) 115/07) ELECTRICAL.

(6) 115/07) ELECTRICAL.

(7) 115/07) ELECTRICAL.

(8) 105/07) ELECTRICAL.

(1) 115/07) ELECTRICAL.

(1) 115/07) ELECTRICAL.

(1) 115/07) ELECTRICAL.

(1) 115/07) ELECTRICAL.

(2) 115/07) ELECTRICAL.

(3) 115/07) ELECTRICAL.

(3) 115/07) ELECTRICAL.

(4) 115/07) ELECTRICAL.

(5) 115/07) ELECTRICAL.

(6) 115/07) ELECTRICAL.

(6) 115/07) ELECTRICAL.

(6) 115/07) ELECTRICAL.

(7) 115/07) ELECTRICAL.

(7

DW-2 (B)					
DESCRIPTION	OTY	VOLT	AMP	AMP LOAD	
TED LIGHT	3		64	8.0	
HEATER WIRE	- 0	1 1	0.8	0.0	
RAEON 1987 EWITCH / ENDITAL THERMOMETER COMBO	- 0	1 1	0.80	6.0	
HEATED AIR VENT	- 12	1	0.1	0.0	
HEATED VEWPORT	1	115	0.9	0.9	
AIR SHELD	- 0	1	1.4	0.0	
IN/OUT BUZIER	0	1	0.1	0.0	
ARCHE FOX DELUX DOOR DIEPLAY	- 0	1 1	0.4	6.0	
ALARMS	0	1	1.0	0.0	
115 VOLT, SINGLE PHASE, 6	Hir. T	OTAL DO	OR AMPS	1.70	




FRAME: RECESSED 0" WITH 0" LEVELING SAND AND 0" TILE AND GROUT EXT: GALVALUME - EMBOSSED 26 GA INT: ALUMINUM - NATURAL EMBOSSED - .040

PLUG: EXT: GALVALUME - EMBOSSED 26 GA EXT: NICKPLATE, ALUM .063 DIAMOND TREAD 36" HIGH BIT: ALUMINUM - NATURAL EMBOSSED - .040 BIT: KICKPLATE, ALUM .063 DIAMOND TREAD 36" HIGH HARDWARE AND ACCESSORIES:


HARDWARE AND ACCESSORIES:
(1) 115/001 ELECTROLON BIGUES ON URBLE,
GLOBE AND NIGHTLIGHT 120F (STD)
(1) THERMORETES - 2 INCH DIALW WE ELAN (STD)
(1) SWITCH-PROT LIGHT INCLUDED U, (STD)
(1) SWITCH-PROT LIGHT INCLUDED U, (STD)
(1) DONG LOSER - 4-AGOS 1008 W/ODER AND HOOK (STD)
(1) HARDWARE - ANGOS 1008 W/ODER AND HOOK (STD)
(1) HARDWARE - ANGOS 1008 W/ODER AND HOOK (STD)
(2) HIRDWARE - 4-AGOS 1008 W/ODER AND HOOK (STD)
(2) HIRDWARE - 4-AGOS 1008 W/ODER AND HOOK (STD)

DR 34.00" x 78.00" FR 46.00" x 82.25" DW-3 (c)

DESCRIPTION	QTY	VOLT	AMP	AMP LOAD
LED LIGHT	3		0.4	12
HEATER WIFE	- 0		0.8	0.0
KASON 1967 SWITCH / DIGITAL THERMOMETER COMBO	-0		0.60	8.9
PEATED AIR VENT	0		01	0.0
HEATED VIEWPORT	-1	115	0.9	0.9
AIR SHELD	- 0		1.4	8.0
NOUT BUZZER	- 0		-0.1	0.0
ARCTIC FOX BELUX DOOR DISPLAY	- 0		0.4	0.0
ALARMS	-0.		1.0	0.0
115 VOLT, SINGLE PHATE BE	He T	STAL DO	OR AMPS	2.10

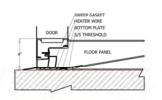


1 DETAIL - 4IN FLOOR-RAMP

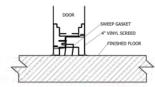

2 DETAIL - 4IN VSCD



LOCKS SPACED @23* O.C.

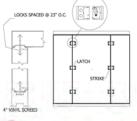

















HISTORIC DISTRICT COMMISSION PROJECT REVIEW REQUEST

DATE: 06/19/2020

CITY OF DETROIT PLANNING & DEVELOPMENT DEPARTMENT 2 WOODWARD AVENUE, ROOM 808, DETROIT, MI 48226

PROPERTY INFORM						
ADDRESS: 4125 Second	Avenue		AKA: _Sea	sons		
HISTORIC DISTRICT: Willi	s/Selden					
SCOPE OF WORK: Win Doo (Check ALL that apply)		oof/Gutters/ nimney	Porch/ Deck	Landso	cape/Fence/ Park	General Rehab
Nev	w nstruction De	emolition	Addition	X Other:	Egress stai	rs on rear
APPLICANT IDENTIF	FICATION					
Property Owner/ Homeowner	Contractor	E	enant or Business Occu	•	Consul	ect/Engineer/ tant
NAME: Joe Gallagher		_ COMPANY	NAME: The	Green Ga	rage, LLC	
ADDRESS: 4444 Second A	ve	_ CITY: Detro	it	STATE: MI	ZIP: <u>4</u> 8	3201
PHONE:	MOBILE: 24	8 345 8309	E	MAIL: jgalla	agher615@g	mail.com
PROJECT REVIEW R						
Please attach the following	_		et.			
*PLEASE KEEP FILE SIZE O		-		555		
Completed Building	Permit Applicati	on (highlight	ed portions o		OTE: ed on the scop	e of work,
ePLANS Permit Num for permits through el		ble if you've a	already applie	\ A	itional docume equired.	ntation may
Photographs of ALLs	•	uilding or site	<u>)</u>		www.detroitm be-specific req	ni.gov/hdc for juirements.
Detailed photograph (photographs to show				l)		
Description of existing conditions (including materials and design)						
Description of project replacementrather t						why
Detailed scope of wo	ork (formatted as	bulleted list)				
Brochure/cut sheets	for proposed rep	olacement ma	nterial(s) and	or product/	(s), as applic	able

Upon receipt of this documentation, staff will review and inform you of the next steps toward obtaining your building permit from the Buildings, Safety Engineering and Environmental Department (BSEED) to perform the work.

SUBMIT COMPLETED REQUESTS TO HDC@DETROITMI.GOV

P2 - BUILDING PERMIT APPLICATION

			Date: 6/24/2020
PROPERTY INFORMATION	N.		
Address: 4125 Second Ave	Flo	oor: Suite	#: Stories:
AKA:	Lot(s):	Subdiv	ision:
Parcel ID#(s):			
Current Legal Use of Property:			
Are there any existing buildings	or structures on this parcel?	Yes	No
PROJECT INFORMATION			
Permit Type: New		Demolition	Correct Violations
Foundation Only Char			
Revision to Original Permit #	t:	(Original permit has	been issued and is active)
Description of Work (Describe	in detail proposed work and use	of property, attach wor	k list)
Interior conversion to food market	t with concession area, with er	mergency exit stair a	dded to second
floor			
	MB	C use change	No MBC use change
Included Improvements (Che	ck all applicable; these trade area	s require separate per	mit applications)
HVAC/Mechanical El			
Structure Type	_		
New Building Existing	g Structure Tenant Spa	ace Garage	Accessory Building
Other: Size			
Construction involves changes			
(e.g. interior demolition or construction			
Use Group: Ty		nt MI Bldg Code Table	601)
Estimated Cost of Constructi	¢	\$	
Structure Use	By Contractor		By Department
Residential-Number of Units:	Office-Gross Floor Area	Indust	rial-Gross Floor Area
Commercial-Gross Floor Area:	Institutional-Gross Floor	Area Oth	er-Gross Floor Area
Proposed No. of Employees:	List materials to be stored in	the building:	
PLOT PLAN SHALL BE submitte (must be correct and in detail). existing and proposed distance	d on separate sheets and sha	Il show all easemen	ts and measurements lot, show all buildings,
	For Building Department		
Intake By:	Date:	Fees Due:	DngBld? N
Permit Description:			
	D.	roposed Use:	
Current Legal Land Use:		oposed ose.	
Permit#:	Date Permit Issued:	Permit Co	ost: \$
Zoning District:	Zoning		
Lots Combined?			
Revised Cost (revised permit ap	plications only) Old \$	Nev	v \$
Structural:	Date:	Notes:	
Zoning:	Date:	Notes:	

Page 1 of 2

IDENTIFICATION (All Fields Required	ed)
Property Owner/Homeowner	Property Owner/Homeowner is Permit Applicant
	Company Name: Green Garage, LLC
Address: 1901 Austin Ave	City: Ann Arbor State: MI Zip: 48104
Phone:	Mobile: 248 840 6547
Driver's License #:	Email: greengaragedetroit@gmail.com
Contractor is Permit A	Applicant
Representative Name: Joe Gallagher	Company Name: Green Garage, LLC
Address: 4444 Second Ave	City: Detroit State: MI Zip: 48201
Phone: Mobile: 248	Company Name: Green Garage, LLC City: Detroit State: MI Zip: 48201 3 345 8309 Email: jgallagher615@gmail.com
City of Detroit License #:	
TENANT OR BUSINESS OCCUPAN	Tenant is Permit Applicant
Name: Thomas Brennan Phone: 24	48 840 6547 Email: greengaragedetroit@gmail.com
	Architect/Engineer/Consultant is Permit Applicant
Name: Theodore Berlinghor State	te Registration#: 13010-25131 Expiration Date:
Address: 17400 Wildemere	City: Detroit State: MI Zip: 48221 Email: architects.int@att.net
Phone: 313 341 /930 Mobile:	Email: architects.int@att.net
HOMEOWNER AFFIDAVIT (Onl	nly required for residential permits obtained by homeowner.)
on this permit application shall be complete requirements of the City of Detroit and take inspections related to the installation/work	nd occupant of the subject property and the work described ted by me. I am familiar with the applicable codes and e full responsibility for all code compliance, fees and herein described. I shall neither hire nor sub-contract to any on of the work covered by this building permit.
Print Name:	Signature: Date:
Subscribed and sworn to before me this	day of20A.DCounty, Michigan
Signature: (Netari Public)	My Commission Expires:
	APPLICANT SIGNATURE
restrictions that may apply to this construct certify that the proposed work is authorize to make this application as the property of all applicable laws and ordinances of jurisd inspections are requested and conducte the previous inspection and that expired Print Name: Joseph Gallagher (Permit Applicant) Driver's License #: G426441792517	Signature: Date: 6/24/2020 Expiration: 6/30/2024
Subscribed and sworn to before me this 24	th day of June 20 20 A.D. Wayne County, Michigan

Section 23a of the state construction code act of 1972, 1972PA230, MCL 125.1523A, prohibits a person from conspiring to circumvent the licensing requirements of this state relating to persons who are to perform work on a residential building or a residential structure. Visitors of Section 23a are subject to civil fines.

My Commission Expires: 5/23/21

This application can also be completed online. Visit detroitmi.gov/bseed/elaps for more information.



Effective 10/11/2011

SUMMARY

This ordinance amends Chapter 25, Article II, of the 1984 Detroit City Code by adding Section 25-2-181 to establish the Willis-Selden Local Historic District, and to define the elements of design for the district.

IT IS HEREBY ORDAINED BY THE PEOPLE OF THE CITY OF DETROIT THAT:

Section 1. Chapter 25, Article II, of the 1984 Detroit City Code is amended by adding Section 25-2-181 to read as follows:

Sec. 25-2-181. Willis-Selden Local Historic District.

- (A) A historic district to be known as the Willis-Selden Local Historic District is established in accordance with the provisions of this article.
- (B) This historic district designation is certified as being consistent with the Detroit Master Plan.
- (D) The defined elements of design, as provided for in Section 25-2-2 of this code, are as follows:
- (1) Height. Single-family or small multi-unit residential structures range in height from one and one-half (1½) to two and one-half (2½) stories in height. Apartment buildings typically range in height from two (2) stories to four (4) stories, often on high basements; a majority of these buildings are three (3) stories in height with high basements. The apartment building at 70 West Alexandrine Avenue is eight stories in height. Commercial and other building types typically range from one (1) to two (2) stories in height. The building at 444 West Willis Avenue, commonly known as the Willys-Overland Building, is historically four (4) stories in height and features a modern, set back, fifth (5th) story addition. The building at 3933 Woodward Avenue, commonly known as the Garden Theater, is three (3) stories in height. The building at 3901 Cass Avenue, commonly known as Cass Avenue Methodist Church, features a sanctuary that is a tall, single story in height, a tower that is approximately one and one-half (1½) times as tall as the sanctuary, and a two (2) story addition.
- (2) Proportion of Buildings' Front Façades. Front façades of single-family or small multi-unit residential structures are typically as tall as wide or slightly taller than wide. Front façades of apartment buildings are commonly as tall as wide or slightly taller than wide, with the exception of broader buildings at 3761 Second Avenue, commonly known as the Coronado Apartments, 711 West Alexandrine Avenue, 495-497 West Willis Avenue, and 477 West Alexandrine Avenue, which are significantly wider than tall. Front façades of single-story commercial buildings are significantly wider than tall, while multi-story commercial

- buildings and other non-residential buildings tend to be slightly wider than tall. Buildings often occupy most or all of deep lots, resulting in side elevations of buildings that are often substantially wider than tall.
- (3) Proportion of Openings Within the Façades. Openings typically amount to between twenty percent (20%) and thirty-five percent (35%) of the front façade. Commercial buildings often feature expansive storefront windows on their first (1st) floors, though in many cases these windows have been covered with boards or closed in with brick or concrete block. Sash windows, taller than wide, predominate on all building types. On apartment buildings, sash windows are sometimes arranged in groupings which, together, are square or wider than tall. A significant minority of buildings feature arched, mullioned, semicircular, casement, or dormer windows appropriate to their respective architectural styles. Upper sashes and transoms are occasionally subdivided into smaller panes. Casement windows are usually subdivided into smaller panes. Door openings are typically slightly larger in scale than window openings. Primary entrance openings are usually centered on the façades of commercial and apartment buildings, but usually off-center on the façades of smaller residential buildings.
- (4) Rhythm of Solids to Voids in Front Façades. Despite a variety of building types, the overall impression is one of regular, repetitive openings arranged horizontally within façades. A repetitive flow of storefront openings, where they exist, creates a rhythm along commercial frontage. Smaller residential buildings as well as the building at 3901 Cass Avenue, commonly known as Cass Avenue Methodist Church, display more varied, often asymmetrical, arrangements of openings, but the overall impression is still one of regular, repetitive openings.
- (5) Rhythm of Spacing of Buildings on Streets. Rhythm of spacing on streets is generally determined by setbacks from side lot lines. The overall character of the district is one of densely clustered, yet visually distinct, structures separated by narrow setbacks. Commercial buildings frequently abut adjacent buildings, typically featuring no setbacks from side lot lines, especially on Woodward Avenue where evenly spaced storefronts create a regular spacing of buildings. There is a general regularity in the widths of subdivision lots from one block to another, contributing to a regular rhythm of spacing of buildings on streets.
- (6) Rhythm of Entrances and/or Porch Projections. Porches on smaller residential buildings typically project while those on other types of buildings usually do not. On residential buildings only, entrances are often located several steps above grade to accommodate high basements. Doorways on smaller residential buildings are often set beneath gable-roofed or arched openings, while doorways on other buildings are typically centered on their façades. A regular rhythm of entrances is created by a row of similar commercial buildings along Woodward Avenue.
- (7) Relationship of Materials. A majority of buildings are faced with brick and feature stone or cast stone trim. Single-family residential buildings are generally faced with brick and feature wooden brackets, bay windows, vergeboards, timbering, porch supports, dentils, entablature, or other classically inspired elements, and other details depending on style. A small number of single-family residential buildings feature wood clapboard siding. Stone or stone facing defines the foundations of buildings at 643-647 and 748 West Alexandrine Avenue, 481 Brainard Avenue, 3957 and 4107 Cass Avenue, and 500 West Willis Avenue, the lower levels of buildings at 4120 Cass Avenue, 3761 Second Avenue, 495-497 West Willis Avenue, and the entire primary façade of buildings at 624 and 627 West Alexandrine

Avenue and 3977 Cass Avenue. The buildings at 3901 Cass Avenue, commonly known as Cass Avenue Methodist Church, 3900 and 3977 Second Avenue, and 4100 Third Avenue are composed primarily of stone. Sash windows are historically wood but have, in many cases, been replaced with windows of more modern materials. Stone is used for window sills on a majority of buildings within the district. While roofs within the district are generally flat and not visible, pitched roofs typically feature visible slate or asphalt shingles. Buildings at 686 Selden and 711 West Alexandrine Avenue feature clay tile roofs. The building at 3901 Cass Avenue, commonly known as Cass Avenue Methodist Church, features a copper roof on its tower.

- (8) Relationship of Textures. On a majority of buildings within the district, the major textural effect is that of brick with mortar joints juxtaposed with cast stone or limestone trim. Patterned brickwork is used to create subtle detail on commercial and apartment buildings, such as spandrels and rectangular panels, and more pronounced textural interest where it exists on the upper stories of buildings, such as at 461 West Alexandrine Avenue, and in an arcaded cornice on the building at 711 West Alexandrine Avenue. Where they exist, detailed wooden vergeboards, gables, brackets, and dormers create considerable textural interest on all single-family residential buildings in the district. Rough-cut stone with thick mortar joints creates considerable textural interest on buildings where it exists, while other buildings feature smooth stone with thin mortar joints. In general, asphalt shingle roofs do not contribute to textural interest.
- (9) Relationship of Colors. Natural brick colors in shades of brown, red, and buff predominate on wall surfaces, while natural stone colors in shades of gray, red, and brown also exist. Although most roofs are flat and therefore not visible, sloped roofs typically feature gray asphalt, while some feature red or green clay tile or slate in contrasting colors of gray, red, or green. Wooden architectural details are frequently painted in bold colors, appropriate to the architectural style of the buildings, which contract markedly with brick facing. Brick apartment buildings are generally unpainted, with gray stone trim contrasting with brown or buff brickwork. Brick on commercial buildings is frequently painted in shades of yellow or orange. The original colors of any building, as determined by professional analysis, are always acceptable for that building and may provide guidance for similar buildings.
- (10) Relationship of Architectural Details. Buildings in the district exemplify a broad range of architectural styles, and their architectural details relate to their style. Pre-1880 residential buildings, as well as commercial buildings on Woodward Avenue, are Italianate in style. Single-family residential buildings are often Queen Anne or Stick/Eastlake in style. Romanesque Revival structures include the building at 3977 Second Avenue, commonly known as the Campbell-Symington House, and the building at 3901 Cass Avenue, commonly known as the Cass Avenue Methodist Church. Larger apartment buildings include the Spanish Medieval building at 624 West Alexandrine Avenue, commonly known as the El Moore Flats, and several buildings in Beaux Arts and Colonial Revival styles. Also represented are the Jacobethan Revival, Craftsman, Spanish Colonial, Late Gothic, and Neo-Georgian styles. Buildings range from vernacular to high style in appearance, with the level of architectural detail varying greatly from one building to the next.
- (11) Relationship of Roof Shapes. Most apartment buildings and all nonresidential buildings have flat roofs that cannot be seen from the ground, with the exception of the building at 3901 Cass Avenue, commonly known as Cass Avenue Methodist Church, with prominent cross gables defining its nave and transept and a hip roof defining a two-story addition. Single-

- family residential buildings feature multiple roof shapes, with steep, intersecting gables, dormers, towers, and tall chimneys creating dramatic silhouettes. Flat-roofed apartment buildings often feature stepped or triangular parapet walls, occasionally with crenellation or balustrades, which add interest to the building's roofline.
- (12) Walls of Continuity. Setbacks of residential buildings tend to vary slightly from one building to the next, but generally create a wall of continuity on all streets in the district, except where building demolition has created vacant lots. The continuous façades of commercial buildings, where they exist in rows, create significant walls of continuity in the district. Fencing, often modern steel units that resemble historic cast or wrought iron fencing, exists at the front lot line of many properties and suggests an additional wall of continuity. Mature trees and public lighting fixtures generally do not contribute to a wall of continuity due to their irregular placement throughout the district.
- (13) Relationship of Significant Landscape Features and Surface Treatments. The overall impression is that east-west streetscapes are abundantly planted whereas north-south streetscapes are not. Typical treatment of individual residential properties is a shallow, flat front lawn in grass turf, subdivided by a straight concrete walk leading to the front entrance. Alleys provide access to the rear of a majority of lots in the district; a small number of these lots contain garages in the rear accessed via the alley. Trees, hedges, and other landscaping features are irregularly spaced. Trees in the front yards of buildings vary in size, age, and species. Most commercial buildings, and a smaller number of apartment buildings, are built up to the front lot line. Public sidewalks run alongside all streets in the district. Curbs, while historically stone, have been replaced with concrete in a majority of the district. Public lighting is generally of the modern, steel, pole-mounted variety, though wrought iron-style light fixtures exist on Woodward Avenue.
- (14) *Relationship of Open Space to Structures*. Front and side yards range from shallow to nonexistent, while most smaller residential buildings feature rear yards. Other than public rights-of-way, large areas of open space exist only where they have been created by building demolition; sometimes these spaces serve as parking lots or are maintained as open lawns.
- (15) Scale of Façades and Façade Elements. Single-family residential buildings are moderate to large in scale relative to typical buildings from the period in which they were constructed. Apartment buildings range from small to large in scale, with a small number of buildings, such as the building at 70 West Alexandrine and the building at 3751-73 Second Avenue, commonly known as the Coronado Apartments, being significantly larger in scale than the others. The building at 444 West Willis Avenue, commonly known as the Willys-Overland building, is also large in scale. Elements within the façades are generally small to medium in scale.
- (16) Directional Expression of Front Elevations. Façades of single-family residential structures are generally vertical in directional expression due to tall window and door openings and peaked rooflines. Apartment buildings generally range from neutral to slightly vertical in directional expression, though a smaller number are horizontal in directional expression. Commercial buildings, especially single-story ones, are generally horizontal in directional expression due to broad storefront windows and, where they exist, horizontal cornices.
- (17) *Rhythm of Building Setbacks*. A degree of irregularity is introduced by varying setbacks of front façades; smaller residential buildings tend to be set several feet back from the public sidewalk, while larger apartment buildings and other buildings often occupy their entire lots. While setbacks may vary slightly from one building to the next the overall impression

- is one of a consistent rhythm of building setbacks. Where building demolition has occurred, the original rhythmic progression of buildings has been disrupted.
- (18) Relationship of Lot Coverages. Lot coverages within the district are generally high, but vary based on building type. Single-family residential buildings and smaller apartment buildings often occupy between twenty percent (20%) and forty percent (40%) of their lots, with much of the remaining space being devoted to rear yards. Other building types range from fifty percent (50%) to one hundred percent (100%) lot coverage. Large buildings may have light courts or central courtyard spaces. Commercial buildings, in particular, often occupy a large percentage of their lots.
- (19) Degree of Complexity Within the Façades. The façades within the district range from simple to complex, depending on style. Overall, front façades tend to be simple in their massing and mostly regular in their fenestration, though a variety of window and door shapes, materials, architectural elements, and details of individual buildings increase the overall level of complexity of the district.
- (20) *Orientation, Vistas, Overviews*. Buildings generally face the streets and are entered from the front façade by a single or double doorway. The tallest buildings within the district, such as the building at 70 West Alexandrine Avenue, the building at 3901 Cass Avenue, commonly known as Cass Avenue Methodist Church, the building at 3761 Second Avenue, commonly known as the Coronado Apartments, and the building at 444 West Willis Avenue, commonly known as the Willys-Overland Building, constitute landmarks that are clearly visible from several blocks away. The buildings on Woodward Avenue, visible from a considerable distance up and down the street, are a significant component of a broader streetscape.
- (21) *Symmetric or Asymmetric Appearance*. The appearance of front façades in the district is, for the most part, symmetrical. Single-family residential buildings tend to display a modest degree of asymmetry in massing and architectural detail.
- (22) *General Environmental Character*. The general character of the district is that of a medium-density, mixed-use, urban neighborhood of small to large apartment buildings interspersed with other building types. The district maintains a sense of vitality as a result of its mixture of uses and the correspondingly diverse physical appearance of its buildings.

Krystal A. Crittendon
Corporation Counsel