

# HISTORIC DISTRICT COMMISSION NOTICE OF DENIAL

City of Detroit - Planning & Development Department 2 Woodward Avenue, Suite 808 Detroit, Michigan 48226

## Notification Date: 06/18/25

## Application Number: HDC2025-00274

<b>APPLICANT &amp; PROPERTY INFORMATIO</b>	ON		
NAME: Timothy Flintoff Jr.	COMPANY	NAME: 4545 Architecture	
ADDRESS: 2761 E. Jefferson Ave, Ste 302	CITY: Detroit	STATE: MI	<b>ZIP:</b> 48207
PROJECT ADDRESS: 1760 Wabash			
HISTORIC DISTRICT: Corktown			
HISTORIC DISTRICT: Corktown SCOPE: Install aluminum-clad wood windows and wood clapboa	ard siding		

At the Regular Meeting that was held on 06/11/25 , the Detroit Historic District Commission ("DHDC") reviewed the above-referenced application. Pursuant to Section 5(1) and 9(1) of the Michigan Local Historic District Act, as amended, being MCL 399.205 (1), MCL 399.209 (9) and Sections 21-2-78 and 21-2-80 of the 2019 Detroit City Code; the DHDC hereby issues a Denial for the following work, effective on 06/17/25 , as it will be inappropriate according to the Secretary of Interior's Standards for Rehabilitation and the district's Elements of Design:

### **REASON FOR DENIAL:**

• The installed windows have exceptionally thin and minimally profiled window frames and don't match the more robust dimensions and depth of profile of a historic wood window at this property.

• The new windows have altered the features and spaces that characterize the property. '

• Recessed placement of windows is a distinctive character-defining feature. The majority of new windows were installed in plane with the exterior walls. This created a monolithic wall form and the windows frames sitting forward of the window trim. The appearance and placement of the replacement windows is not consistent with the general characteristics of a historic window of the type and period of this 19th century dwelling, nor is it consistent with the historic placement of windows at this particular property.

- Bright white windows were installed; bright white is a contemporary color and offers too high a contrast and is not compatible with exterior color palettes of Victorian-era houses.
- Regarding the unapproved removal of the historic wood siding and its replacement with the current lapped wood siding:
- o The work has altered the features and spaces that characterize the property.
- o The historic siding was intact and not beyond repair.

o The existing siding does not meet the dimensions, profile (new siding is flatter, not similarly angled so the shadow lines are reduced) and surface finish (planed surface not entirely smooth).

o As the historic wood siding was a distinctive, character-defining feature and the dominant surface feature on the dwelling, it is staff's opinion that another wood siding product should be located (new or possibly reclaimed historic wood siding) that more closely matches the siding removed without approval, and a physical sample must be submitted to staff for review.

#### FAILURE TO MEET STANDARDS:

The Standards for Rehabilitation (codified in 36 CFR 67 for use in the Federal Historic Preservation Tax Incentives program) address the most prevalent treatment. "Rehabilitation" is defined as "the process of returning a property to a state of utility, through repair or alteration, which makes possible an efficient contemporary use while preserving those portions and features of the property which are significant to its historic, architectural, and cultural values."

As stated in the definition, the treatment "rehabilitation" assumes that at least some repair or alteration of the historic building will be needed in order to provide for an efficient contemporary use; however, these repairs and alterations must not damage or destroy materials, features or finishes that are important in defining the building's historic character.

The Standards are to be applied to specific rehabilitation projects in a reasonable manner, taking into consideration economic and technical feasibility.

## Failure to meet standards: 2, 5, 6, 9

Corresponding Standard numbered below:	
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- 1. A property shall be used for its historic purpose or be placed in a new use that requires minimal change to the defining characteristics of the building and its site and environment
- 2. The historic character of a property shall be retained and preserved. The removal of historic materials or alteration of features and spaces that characterize a property shall be avoided.
- Each property shall be recognized as a physical record of its time, place, and use. Changes that create a false sense of historical development, such as adding conjectural features or architectural elements from other buildings, shall not be undertaken.
- 4. Most properties change over time; those changes that have acquired historic significance in their own right shall be retained and preserved.
- 5. Distinctive features, finishes, and construction techniques or examples of craftsmanship that characterize a property shall be preserved.
- 6. Deteriorated historic features shall be repaired rather than replaced. Where the severity of deterioration requires replacement of a distinctive feature, the new feature shall match the old in design, color, texture, and other visual qualities and, where possible, materials. Replacement of missing features shall be substantiated by documentary, physical, or pictorial evidence.
- 7. Chemical or physical treatments, such as sandblasting, that cause damage to historic materials shall not be used. The surface cleaning of structures, if appropriate, shall be undertaken using the gentlest means possible.
- 8. Significant archeological resources affected by a project shall be protected and preserved. If such resources must be disturbed, mitigation measures shall be undertaken.
- 9. New additions, exterior alterations, or related new construction shall not destroy historic materials that characterize the property. The new work shall be differentiated from the old and shall be compatible with the massing, size, scale, and architectural features to protect the historic integrity of the property and its environment.
- 10. New additions and adjacent or related new construction shall be undertaken in such a manner that if removed in the future, the essential form and integrity of the historic property and its environment would be unimpaired.

#### FAILURE TO MEET ELEMENTS OF DESIGN:

Failure to meet Elements of Design: N/A

Corresponding design element numbered below:	
1. Height.	12. Walls of continuity.
2. Proportion of building's front façades.	13. Relationship of significant landscape features and surface treatments.
3. Proportion of openings within the façade.	14. Relationship of open space to structures.
4. Rhythm of solids to voids in front façade.	15. Scale of façade and façade elements.
5. Rhythm of spacing of buildings on streets.	16. Directional expression of front elevations.
6. Rhythm of entrance and/or porch projections.	17. Rhythm of building setbacks.
7. Relationship of materials.	18. Relationship of lot coverages.
8. Relationship of textures.	19. Degree of complexity within the façade.
9. Relationship of colors.	20. Orientation, vistas, overviews.
10. Relationship of architectural details.	21. Symmetric or asymmetric appearance.
11. Relationship of roof shapes.	22. General environmental character.

If you have any questions regarding the above, please contact staff at 313-224-1762 or hdc@detroitmi.gov.

For the Commission:

an Garrick Landsberg

Director of Staff, Historic District Commission

PSR: Audra

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#### **APPEALS PROCESS**

The application may be resubmitted for the Historic District Commission's review when suggested changes have been made that address the cited reasons for denial, if applicable. Please be advised that, in accordance with MCL 399. 211 and Section 21-2-81 of the 2019 Detroit City Code, an applicant aggrieved by a decision of the DHDC may file an appeal with the State Historic Preservation Review Board. Within sixty (60) days of your receipt of this notice, an appeal may be filed with:

Jon Stuckey, Michigan Department of Attorney General 2nd Floor, G. Mennen Williams Building 525 West Ottawa Street, P.O. Box 30754, Lansing, MI 48909 Phone: 517-335-0665 E-mail: stuckeyj@michigan.gov Docusign Envelope ID: DD9F5001-56B6-4E7F-8945-404AA4C697FF



# HISTORIC DISTRICT COMMISSION APPLICATION FOR WORK APPROVAL

City of Detroit - Planning & Development Department 2 Woodward Avenue, Suite 808					ICATION ID	
	, Michigan 48226	9 000			HDC2025-0	0274
PRC	OPERTY INFO	RMATION				
	RESS(ES): 1760 V					
	ORIC DISTRICT:					
пізт		Corktown				
SCO	PE OF WORK: <mark>(C</mark> I	heck ALL that apply)				
x	Windows/ Doors	Walls/ Siding	Painting	Roof/Gutters/ Chimney	Porch/Deck/Balcony	y Other
	Demolition	Signage	New Duilding	Addition	Site Improvements (landscape, trees, fend patios, etc.)	ces,
	F PROJECT DES	CRIPTION:				
	e of Work place existing windo	ow units (Work Com	pleted)			
	windows on side an	-	,			
b. Re	place vinyl double-h	lung units with alum	inum-clad wood d	ouble-hung windows		
2. Re	place front, second	fl oor central window	vs with aluminum-	clad wood double hung	u colonial-style unit	
	/le, location, and size			•		
ÅPF	LICANT IDE	NTIFICATION	low at front gable	attic		
	E OF APPLICANT	a placeline ne engi				
4. Re NAM a. I.e.	pair/Replace painter E: Timothy Flintoff in places where sid	d wood siding as red Jr. ling bows. cracks. h	quired using in-kir as rotted. etc.	d materials COMPANY NAME:	4545 Architecture	
	RESSIZION PRISTING			CITY: Detroit	STATE: MI	<b>ZIP:</b> 48207
PHO	<b>NE:</b> +1 (248) 320-6	098		EMAIL: tim.flintoff@	4545architecture.com	
IAG	REE TO AND	O AFFIRM TH	E FOLLOW	ING:		
I understand that the failure to upload all required documentation may result in extended review times for my project and/or a denied application.						
	l understand that	the review of this	application by t	he Historic District Co	ommission does not wa	ive mv
х						
x	I hereby certify that	t the information on	this application is	true and correct. I certi	fy that the proposed work	is authorized by the
owner of record and I have been authorized to make this application as the property owner(s) authorized agent.						
	Tim	othy Flintoff Jr.		4545 Arc	chitecture	
	—DocuSigned by:	-		0.5/10/000	\-	
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SIGN	IATURE 2761 E	. Jefferson Ave, Ste	9 302	DATE	Detroit	MI 48207
	+1 (248	3) 320-6098		tim.f	lintoff@4545architecture.	com

Questions? Contact us at hdc@detroitmi.gov or (313)224-1762

NOTE: Based on the scope of work, additional documentation may be required. See <a href="http://www.detroitmi.gov/hdc">www.detroitmi.gov/hdc</a> for scope-specific requirements.

# **PROJECT DETAILS – TELL US ABOUT YOUR PROJECT**

Instructions: Add project details using the text box in each section. If your details exceed the space provided, attach the details via the attachment icon for that section.

#### **ePLANS PERMIT NUMBER:**

(only applicable if you've already applied for permits through ePLANS)

NA

#### GENERAL

1.	<b>DESCRIPTION OF EXISTING CONDITION</b> Please tell us about the current appearance and conditions of the areas you want to change. You may use a few sentences or attach a separate prepared document on the right. (For example, "existing roof on my garage is covered in gray asphalt shingles in poor condition.")		
2.	<b>PHOTOGRAPHS</b> Help us understand your project. Please attach photographs of all areas where work is proposed.	Ø	
3.	<b>DESCRIPTION OF PROJECT</b> In this box, tell us about what you want to do at the areas described above in box #1. (For example, Install new asphal roofing at garage.)	lt shingle	
		Ø	
4.	<b>DETAILED SCOPE OF WORK</b> In this box, please describe all steps necessary to complete the work described in box #3. (For example, "remove exis shingles, replace wood deck as necessary, replace wood eaves, install roof vents, replace rotted fascia boards, paint, worksite.")	ting clean	
		$\square$	
5.	BROCHURES/CUT SHEETS		

Please provide information on the products or materials you are proposing to install. For example, a brochure on the brand and color of the shingles proposed.

# ADDITIONAL DETAILS

#### 6. WINDOWS/DOORS

Detailed photographs of window(s) and/or door(s) proposed for replacement showing the condition of the interior and exterior of the window(s) and/or door(s)



May 19, 2025

1760 Wabash St., Detroit, MI 48216

RE: 1760 Wabash St. Historic District Commission Submission

#### Project Narrative

1760 Wabash is a 2.5 story wood-framed residential dwelling in the Corktown Historic District, built in the late 1800s. It is located on the east side of Wabash, between Marantette and Bagley. The front elevation features a cross gable, with centrally placed windows at the first and second floors; the first floor window is an undivided fixed picture window with a multi-colored stained glass transom above, and the second floor features two double-hung windows. All other windows throughout are double-hung white vinyl units, without a uniform spacing. The south side of the front elevation features a raised porch covered with a steeply sloped asymmetrical roof. The main gable roofs at the front and southeast side of the structure are steep, while the lower rear roofs are low pitched. The house is primarily clad in a painted wood lap siding.

The intention of this project is to seek approval for the already completed replacement of existing double-hung vinyl windows with new double-hung aluminum-clad wood windows. It also is for the approval of the installation of a new aluminum-clad wood casement window in place of the original attic window at the front elevation, which is to have similar casing and trim as the original window. The project will include the replacement of two installed double-hung windows at the front of the house with two aluminum-clad wood double-hung windows in the colonial style, whose location and size is to match the original windows which existed there. It also intends to repair/replace the recently installed wood lap siding as needed. The existing painted wood lap siding will be repaired or replaced where required, such as where there are gaps or it bows from the structure.



May 19, 2025

1760 Wabash St., Detroit, MI 48216

RE: 1760 Wabash St. Historic District Commission Submission

#### Scope of Work

- 1. Replace existing window units (Work Completed)
  - a. All windows on side and rear elevations
  - b. Replace vinyl double-hung units with aluminum-clad wood double-hung windows
- 2. Replace front, second floor central windows with aluminum-clad wood double hung colonial-style unit
  - a. Style, location, and size to match original, with wide middle mullion between
- 3. Install aluminum-clad wood casement window at front gable attic
  - a. To have same size and placement as original window
- 4. Repair/Replace painted wood siding as required using in-kind materials
  - a. I.e. in places where siding bows, cracks, has rotted, etc.
  - b. Paint to match existing

# Docusign Envelope ID: DD9F5001-56B6-4E7F-8945-404AA4C697FF DOUBLE-HUNG WINDOW

# **FEATURES**

# **DOUBLE-HUNG** WINDOWS

# **FRAME & SASH**


A Select wood components are kiln dried and treated with water/insect repellent and preservative. Interior wood surfaces are available in pine, mixed grain Douglas fir, cherry, hickory, mahogany, maple, oak, walnut, alder or vertical grain Douglas fir. Interior surfaces are available unfinished or factory primed. Optional factoryapplied finishes are available in a variety of stains and paints.

**B** Wood components are fitted with aluminum extrusions on the exterior. 50 exterior colors that meet AAMA 2604 and 2605 specifications are available, as well as custom colors. Also available is a selection of seven exterior anodized options.


Optional vinyl installation flanges are pre-applied into a kerf on the frame exterior to facilitate installation. Optional aluminum flanges or metal installation clips are available.

Compression bulb weatherstrip is applied on the bottom sash, head jamb, at the meeting rail and on side jambs for a maximum weather seal.

Jamb liners encase balancer assemblies that allow each sash to be tilted 90° inward from a bottom pivot and stay securely in place for washing.

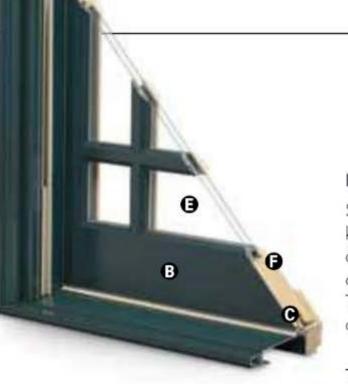

Double-hung jamb liners incorporate synthetic interior and exterior inserts or optional painted aluminum exterior and wood-veneered interior inserts.

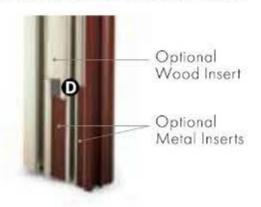

# GLASS

G High-Performance Low-E4® glass with a low-conductivity spacer. Triple-pane glass, tinted, clear dualpane, high-altitude glass and other special glazing options are available.

Glass is fixed in place from the interior with wood stops that can be removed for easy reglazing if necessary. Glass stops available in ovolo (colonial) and contemporary profiles.

**GLASS SPACERS** available in black, white and stainless steel.

# HARDWARE

Sash lock/tilt mechanisms and keepers give a slim, more traditional design and allow opening and tilting of the window in one operation. Tilting the sash from the inside for cleaning is effortless.

Optional surface mount sash lifts allow for easy operation. Units less than 3' wide use one lift. Units 3' wide and greater use two lifts.

# HARDWARE OPTIONS



Windows with VeriLock® sensors use a different sash lock. See the next page for details. Bold name denotes finish shown.

# HARDWARE FINISHES



# **EXTERIOR & INTERIOR OPTIONS**



\*Actual wood species is either Sapele or Sipo, both non-endangered species grown in Africa, with color and characteristics similar to Central American mahoganies. Printing limitations prevent exact replication of colors and finishes. Please see your Andersen supplier for actual color and finish samples.



# ACCESSORIES Sold Separately

# DOUBLE-HUNG WINDOWS

# HARDWARE

# Window Opening Control Device Kit

An optional Window Opening Control Device Kit is available, which limits opening the sash to less than 4" when the window is first opened. Available in stone and white.

# VeriLock & Open/Closed Sensors DISCONTINUED



VeriLock sensors are unique as they

# Open/Closed Sensors

Wireless open/closed sensors

# **INSECT SCREENS**

# TruScene® Insect Screens


Andersen® TruScene insect screens let in over 25% more fresh air and provide 50% greater clarity than conventional Andersen insect screens, all while keeping out unwanted small insects. Frames are available in painted aluminum or wood-veneered options.

# **Conventional Insect Screens**

# GRILLES

# **Full Divided Light**

Permanent interior and exterior grilles with grille spacer bars between two panes of glass. Available in 5/8," 7/8", 1 1/8", 1 1/2", or 2 1/4" widths and ovolo or contemporary profile. Ovolo profile shown below, not all widths are pictured.

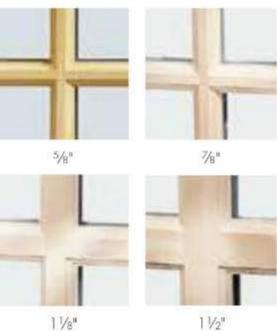

Simulated Divided Light

Permanent exterior and interior grilles without grille spacer bars. Available in 5/8", 7/8", 1 1/8", 1 1/2", or 2 1/4" widths and ovolo or contemporary profile. Ovolo profile shown below, not all widths are pictured.



# Finelight<sup>™</sup> Grilles-Between-the-Glass

Available in 5/8" flat or 1" contoured aluminum profiles. Two-tone colors of pebble tan/colony white, sierra bronze/colony white or forest green/colony white are available on the 1" profile.



# **Removable Interior Wood Grilles**

Removable interior wood grilles are available in a 7/8" width and ovolo or contemporary profiles. Optional surround for removable grille and permanent exterior grilles also available. Ovolo profile shown below.



See page 22 for more information on grilles.

E-Series Double-Hung Windows




Charcoal fiberglass screen mesh fits into an aluminum frame in all 50 exterior colors and seven anodized finishes. Available in half or full insect screens. Aluminum screen mesh is available as an option.

See page 24 for more information on our insect screens.


\*When properly configured and maintained with a professionally installed security system and/or self monitoring system compatible with Honeywell<sup>®</sup> 5800 controls. See your Andersen supplier for more information.

# Docusign Envelope ID: DD9F5001-56B6-4E7F-8945-404AA4C697FF DOUBLE-HUNG WINDOWS

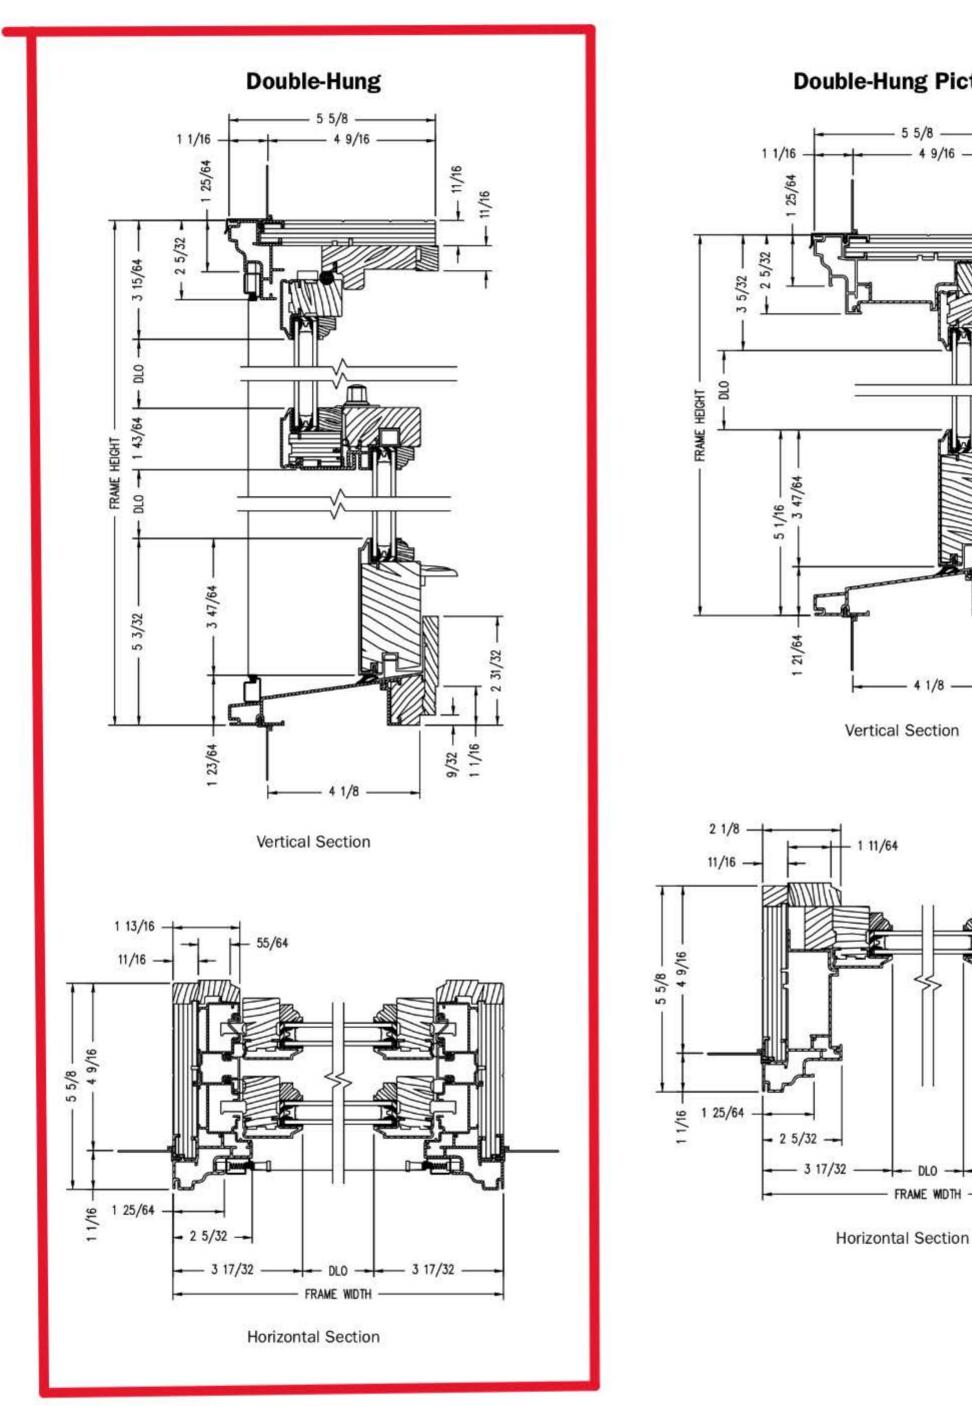

# **Double-Hung Windows**

**Double-Hung Picture** 

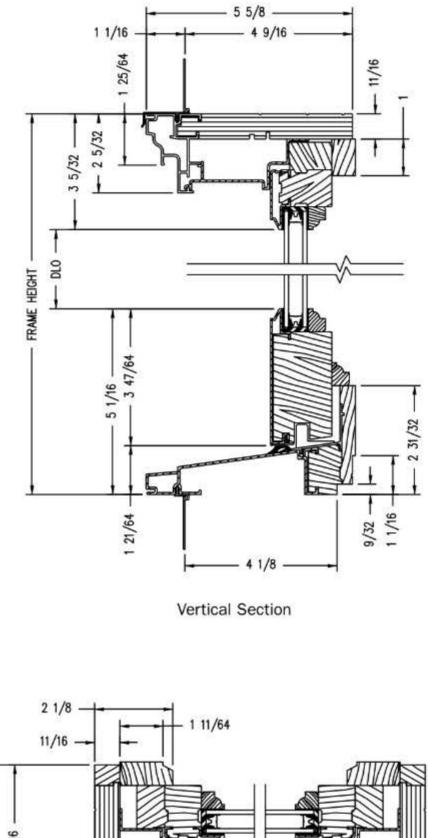

3 17/32


- DLO -

Shown with ovolo (colonial) glass stops.

PROPER INSTALLATION AND MAINTENANCE OF E-SERIES PRODUCTS IS ESSENTIAL TO ATTAIN OPTIMUM PERFORMANCE AND OPERATION. WRITTEN INSTALLATION INSTRUCTIONS THAT PROVIDE GUIDELINES FOR PROPER INSTALLATION ARE AVAILABLE BY VISITING <u>ANDERSENWINDOWS.COM</u>. CUSTOM SIZES ARE AVAILABLE. CONTACT YOUR LOCAL SUPPLIER FOR MORE INFORMATION. DRAWINGS ARE NOT TO SCALE.

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# E-Series Double-Hung Window



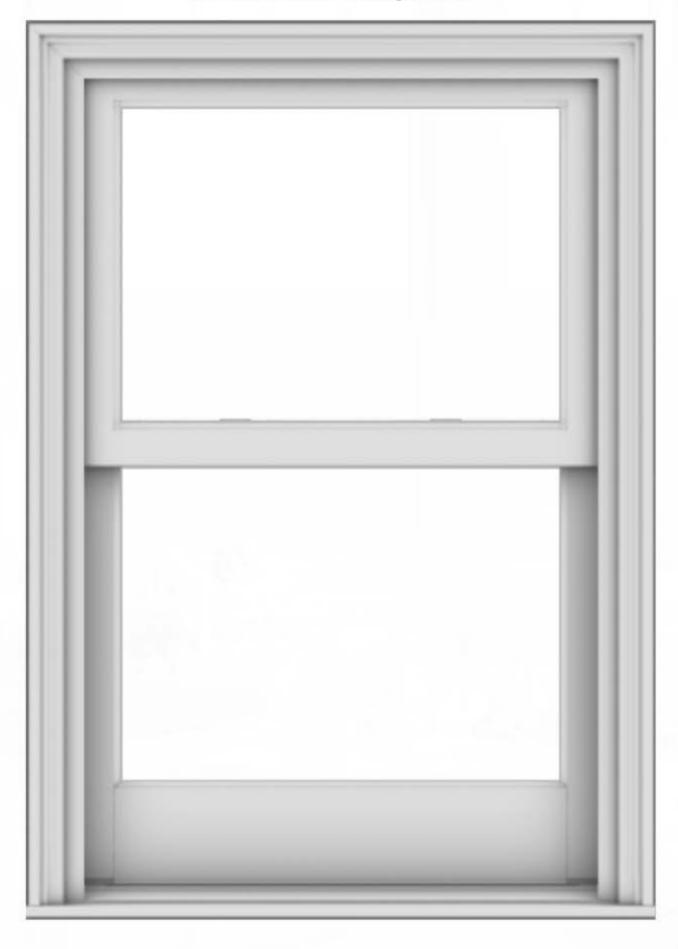





May 19, 2025

1760 Wabash St., Detroit, MI 48216

RE: 1760 Wabash St. Historic District Commission Submission

#### Existing Photos



Front Facade





Rear Facade

# 4545 architecture



South Side and Front Porch (Photo from HDC Staff Report April 2025, taken March 2025)








Existing Window Detail



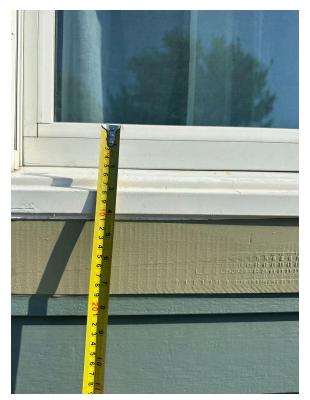



Existing Trim Detail

# 4545 architecture





Existing Window (from inside)

# 4545 architecture




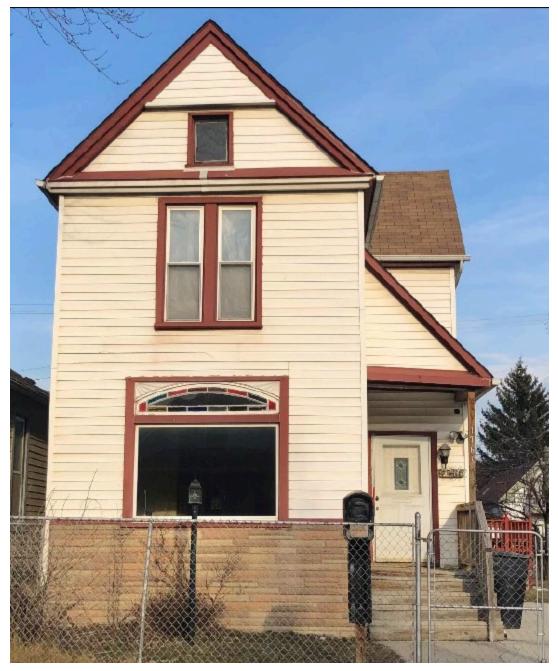


Photo shows original size and placement of double-hung colonial style windows and front attic window (Photo from HDC Staff Report April 2025, taken February 2024)



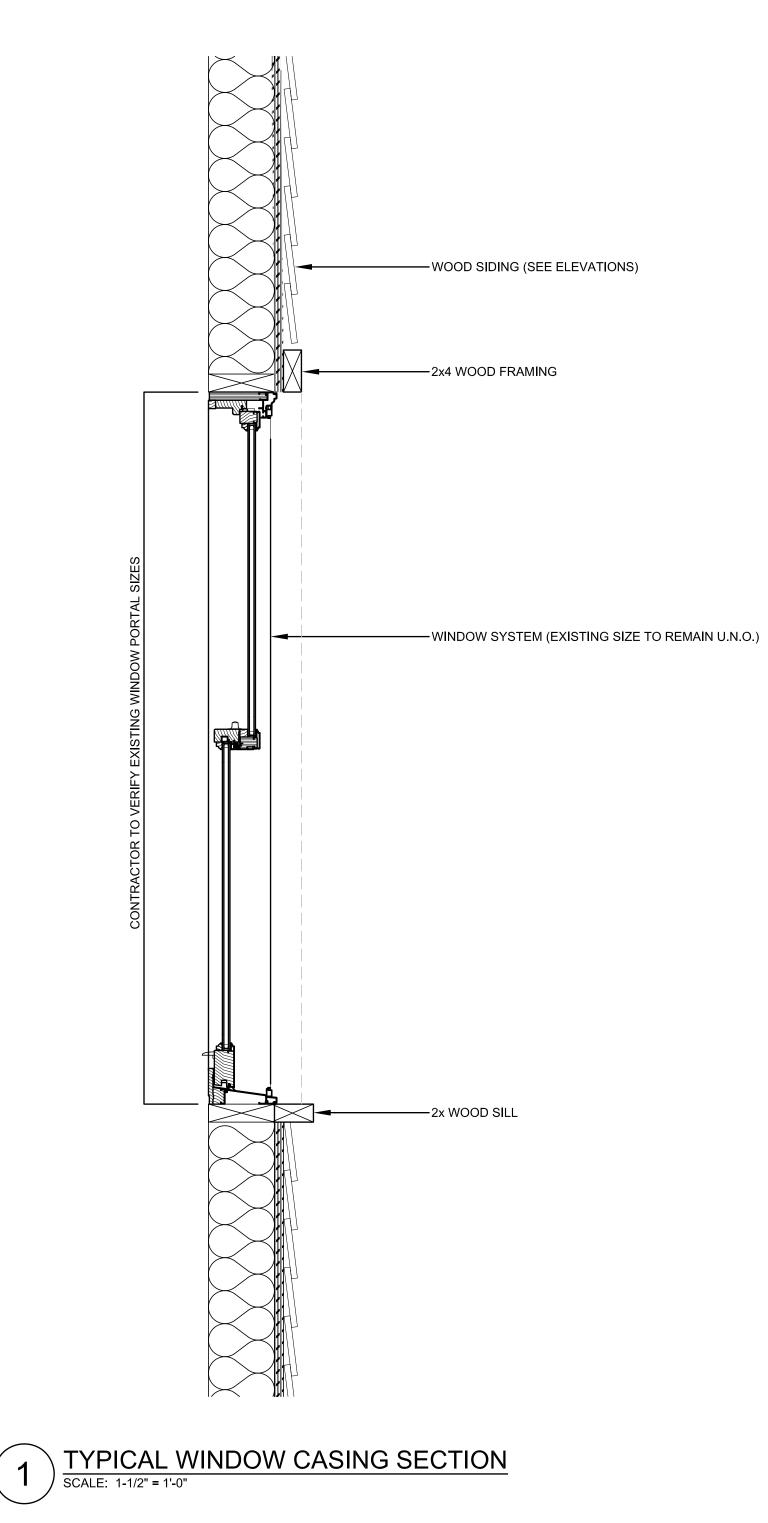

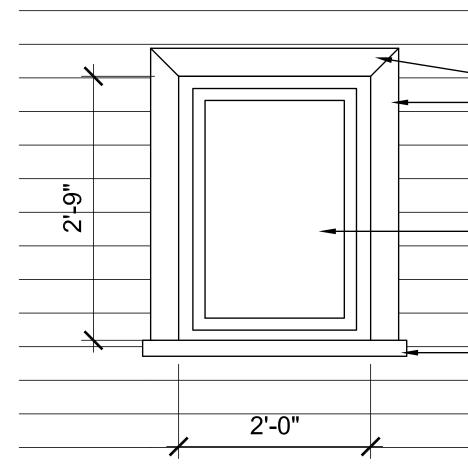

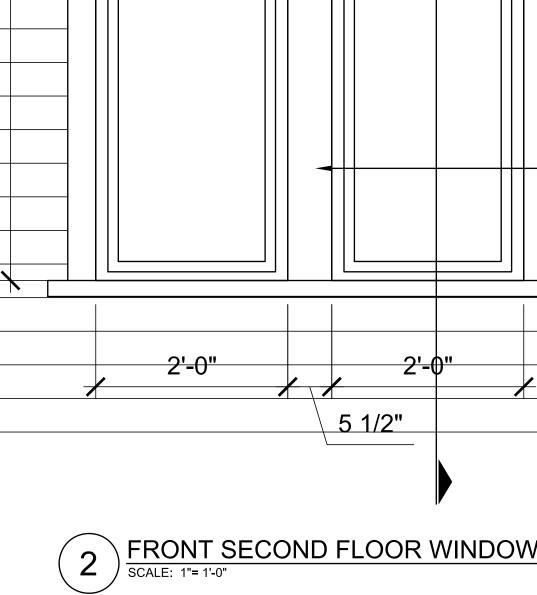

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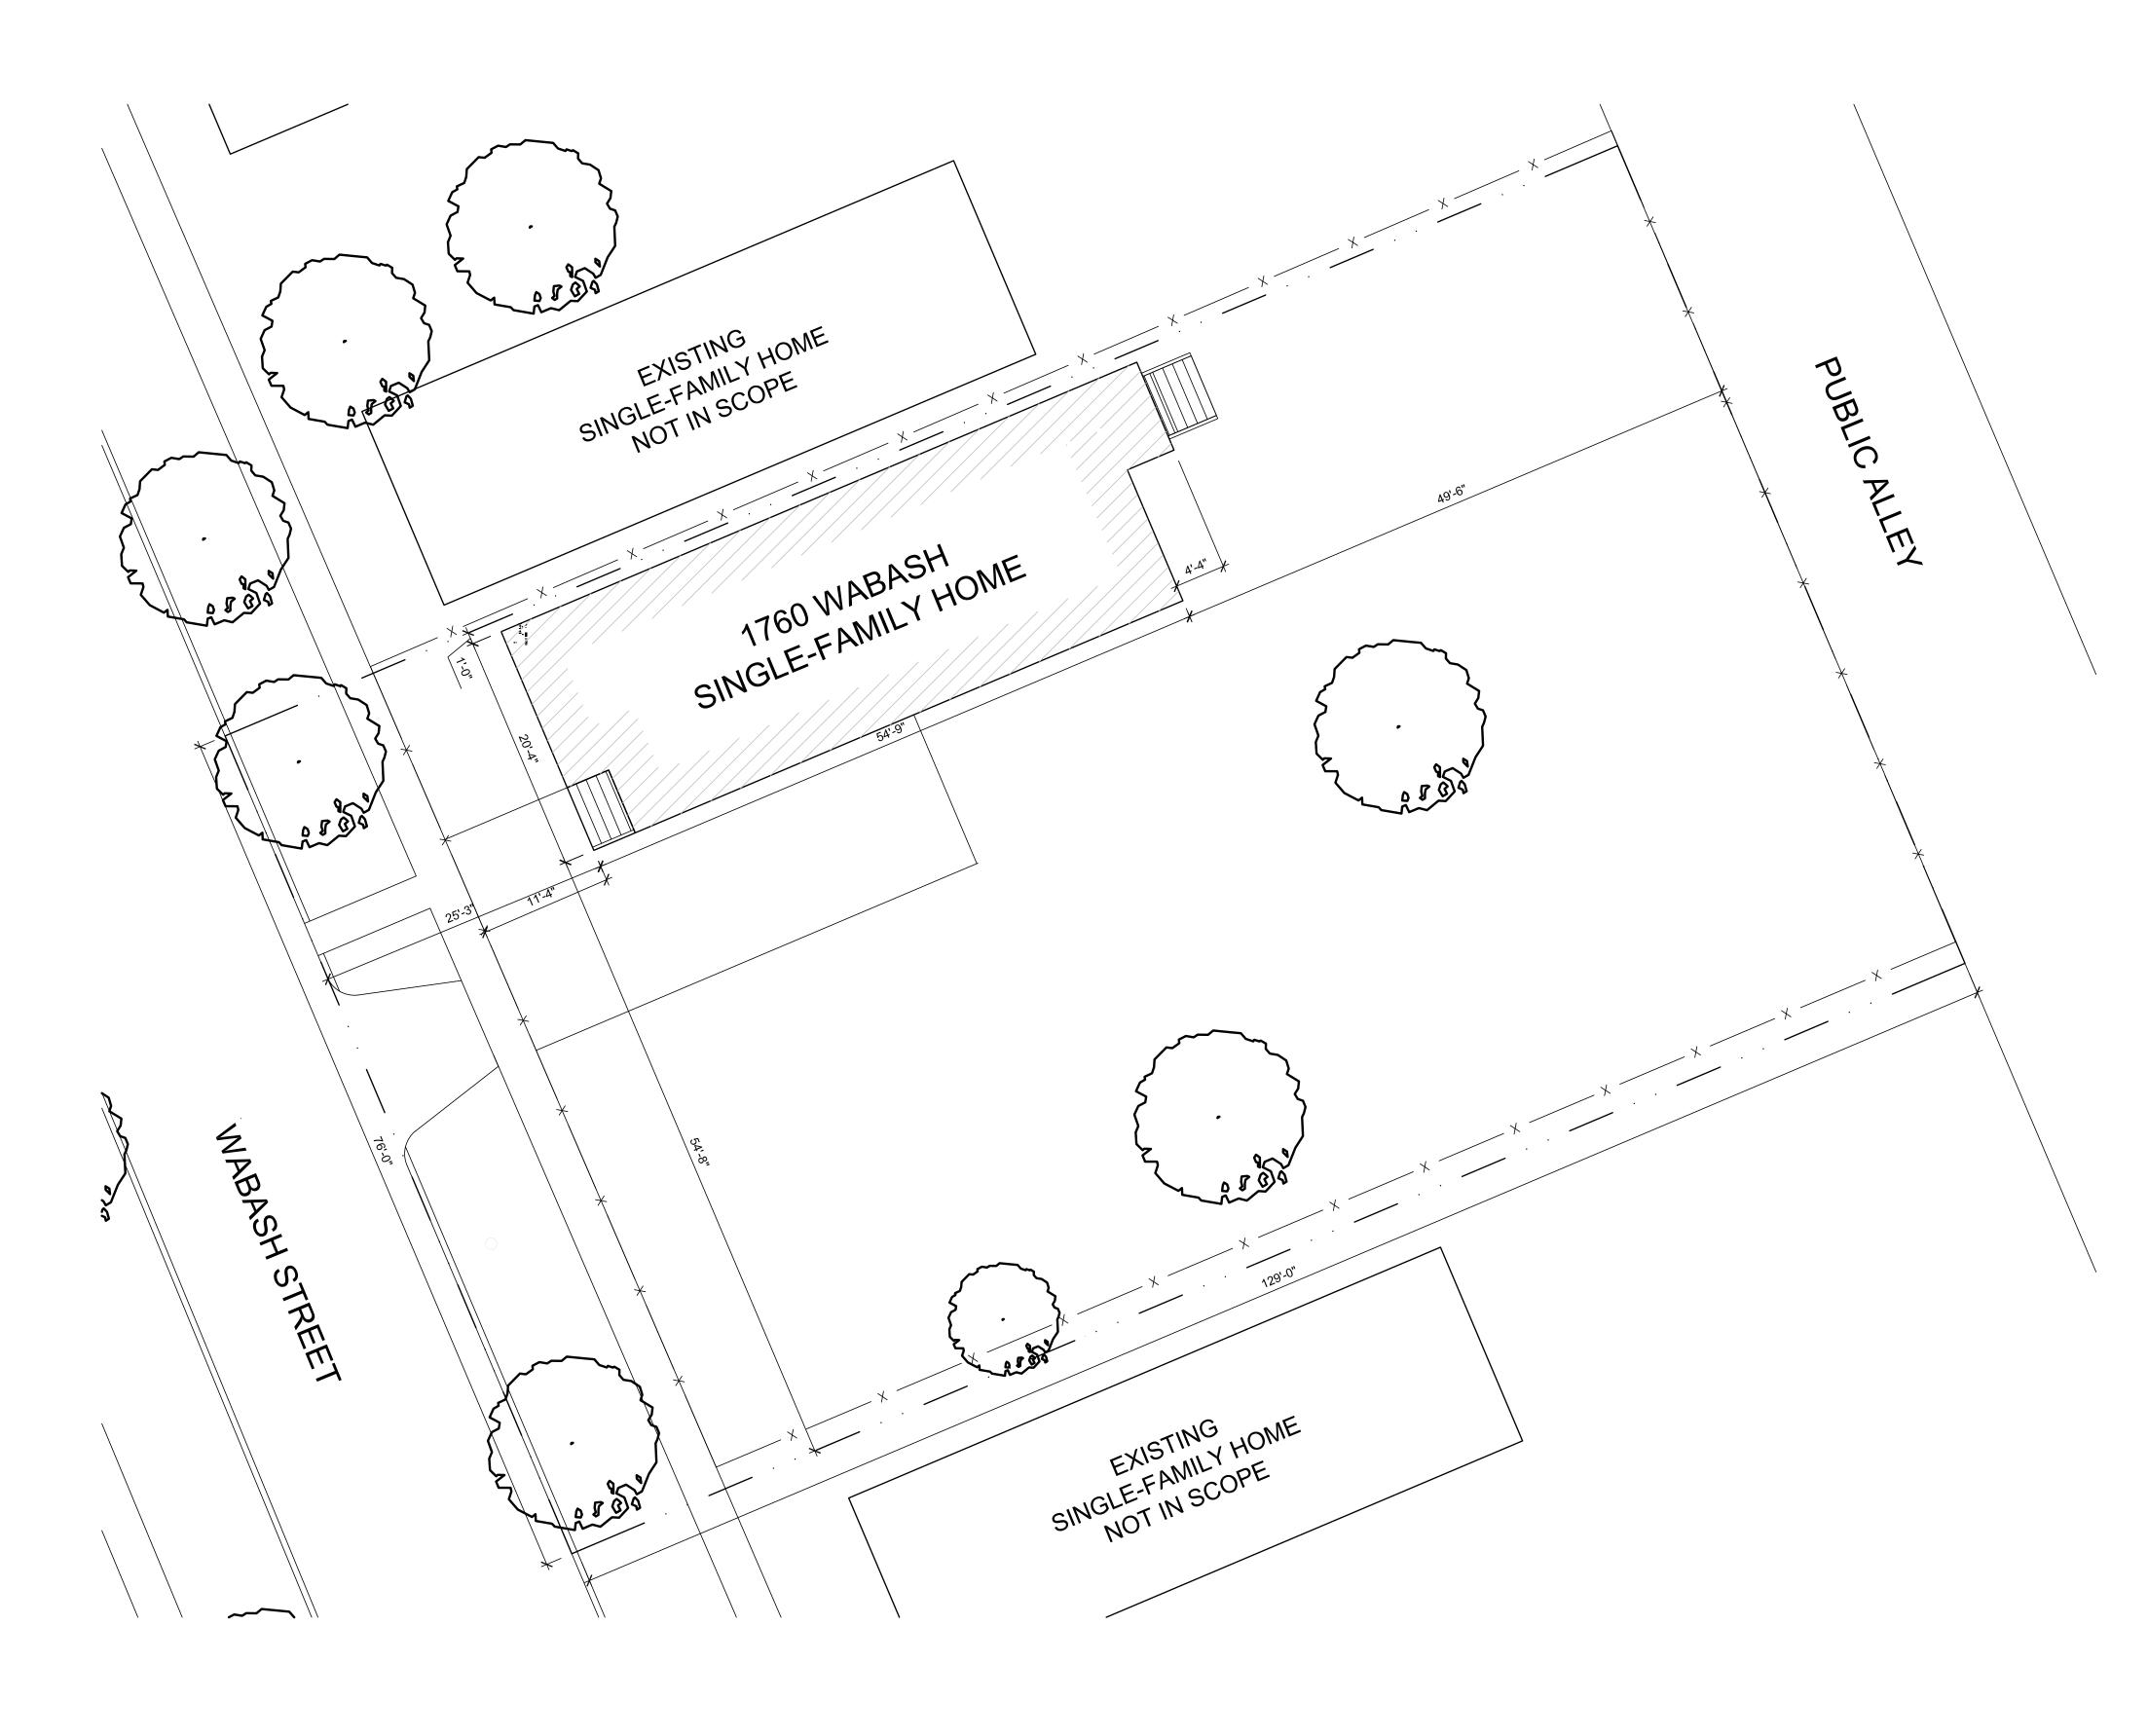
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	ARCHITECT:		
Project         Project <t< td=""><td>4545 architecture</td><td></td><td></td></t<>	4545 architecture		
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	CONSULTANT:	7	
ALUMINU-CLAD WOOD WINDOW		2x4 WOOD FRAMING	-
ALUMINU-CLAD WOOD WINDOW			
ALUMINU-CLAD WOOD WINDOW			
ALUMINU-CLAD WOOD WINDOW		ANDERSON E-SERIES DOUBLE-HUNG	
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Project No. : 2024031	Project No. : 2024031		
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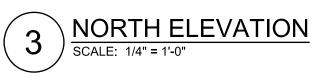
ARCHITECTURAL SITE PLAN SCALE: 1/8"=1'-0"


# GENERAL SITE PLAN NOTES:

- 1. PAVEMENT SHALL BE OF THE TYPE, THICKNESS AND CROSS SECTION AS INDICATED ON THE PLANS AND AS FOLLOWS:
- 2. CONCRETE: PORTLAND CEMENT TYPE IA (AIR-ENTRAINED) WITH A MINIMUM CEMENT CONTENT OF SIX SACKS PER CUBIC YARD, MINIMUM 28 DAY COMPRESSIVE STRENGTH OF 3,500 PSI AND A SLUMP OF 1 1/2 TO 3 INCHES.
- 3. ASPHALT: BASE COURSE MDOT BITUMINOUS MIXTURE NO. 1100L, 20AA; SURFACE COURSE - MDOT BITUMINOUS MIXTURE NO. 1100T, 20AA; ASPHALT CEMENT PENETRATION GRADE 85-100, BOND COAT - MDOT SS-1H EMULSION AT 0.10 GALLON PER SQUARE YARD; MAXIMUM 2 INCH LIFT.
- PAVEMENT BASE SHALL BE COMPACTED TO 95% OF THE MAXIMUM DENSITY (MODIFIED PROCTOR) PRIOR TO PLACEMENT OF PROPOSED PAVEMENT. EXISTING SUB-BASE SHALL BE PROOF-ROLLED IN THE PRESENCE OF THE ENGINEER TO DETERMINE STABILITY.
- 5. ALL CONCRETE PAVEMENT, DRIVEWAYS, CURB & GUTTER, ETC., SHALL BE SPRAY CURED WITH WHITE MEMBRANE CURING COMPOUND IMMEDIATELY FOLLOWING FINISHING OPERATION.
- ALL CONCRETE PAVEMENT JOINTS SHALL BE FILLED WITH HOT POURED RUBBERIZED ASPHALT JOINT SEALING COMPOUND IMMEDIATELY AFTER SAWCUT OPERATION. FEDERAL SPECIFICATION SS-S164.
- 7. ALL WORKMANSHIP AND MATERIALS SHALL BE IN ACCORDANCE WITH THE CURRENT STANDARDS AND SPECIFICATIONS OF THE MUNICIPALITY AND THE MICHIGAN DEPARTMENT OF TRANSPORTATION STANDARD SPECIFICATIONS FOR CONSTRUCTION, CURRENT EDITION.
- 8. ALL TOP OF CURB ELEVATIONS, AS SHOWN ON THE PLANS, ARE CALCULATED FOR A 6" CONCRETE CURB UNLESS OTHERWISE NOTED.
- 9. ALL SIDEWALK RAMPS, CONFORMING TO PUBLIC ACT NO. 8, 1993, SHALL BE INSTALLEI AS INDICATED ON THE PLANS.
- 10. CONSTRUCTION OF A NEW OR RECONSTRUCTED DRIVE APPROACH CONNECTING TO AN EXISTING STATE OR COUNTY ROADWAY SHALL BE ALLOWED ONLY AFTER AN APPROVED PERMIT HAS BEEN SECURED FROM THE AGENCY HAVING JURISDICTION OVER SAID ROADWAY.
- 11. FOR ANY WORK WITHIN THE PUBLIC RIGHT-OF-WAY, THE CONTRACTOR SHALL PAY FOR AND SECURE ALL NECESSARY PERMITS AND LIKEWISE ARRANGE FOR ALL INSPECTION.
- EXISTING TOPSOIL, VEGETATION AND ORGANIC MATERIALS SHALL BE STRIPPED AND REMOVED FROM PROPOSED PAVEMENT AREA PRIOR TO PLACEMENT OF BASE MATERIALS.
- 13. EXPANSION JOINTS SHOULD BE INSTALLED AT THE END OF ALL INTERSECTION RADII.
- 14. SIDEWALK RAMPS, CONFORMING TO PUBLIC ACT NO. 8, 1973, SHALL BE INSTALLED AS SHOWN AT ALL STREET INTERSECTIONS AND AT ALL BARRIER FREE PARKING AREAS AS INDICATED ON THE PLANS.
- 15. ALL PAVEMENT AREAS SHALL BE PROOF-ROLLED UNDER THE SUPERVISION OF A GEOTECHNICAL ENGINEER PRIOR TO THE PLACEMENT OF BASE MATERIALS AND PAVING MATERIALS.
- 16. FILL AREAS SHALL BE MACHINE COMPACTED IN UNIFORM LIFTS NOT EXCEEDING 9 INCHES THICK TO 98% OF THE MAXIMUM DENSITY (MODIFIED PROCTOR) PRIOR TO PLACEMENT OF PROPOSED PAVEMENT.
- 17. ALL LANDSCAPED AREAS TO BE PROVIDED W/ SPRINKLER SYSTEMS FOR 100% COVERAGE.


# SITE PLAN KEY NOTES: (TYPICAL THIS SHEET ONLY)


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025 Timothy Flintoff Architect, PLLC	Drawn by : ANJ Check by : TRF Sheet Title : ARCHITECTURAL SITE PLAN
DO NOT SCALE DRAWINGS   ©2025 Timothy Flintoff Architect, PLLC	ANJ Check by : TRF Sheet Title : ARCHITECTURAL



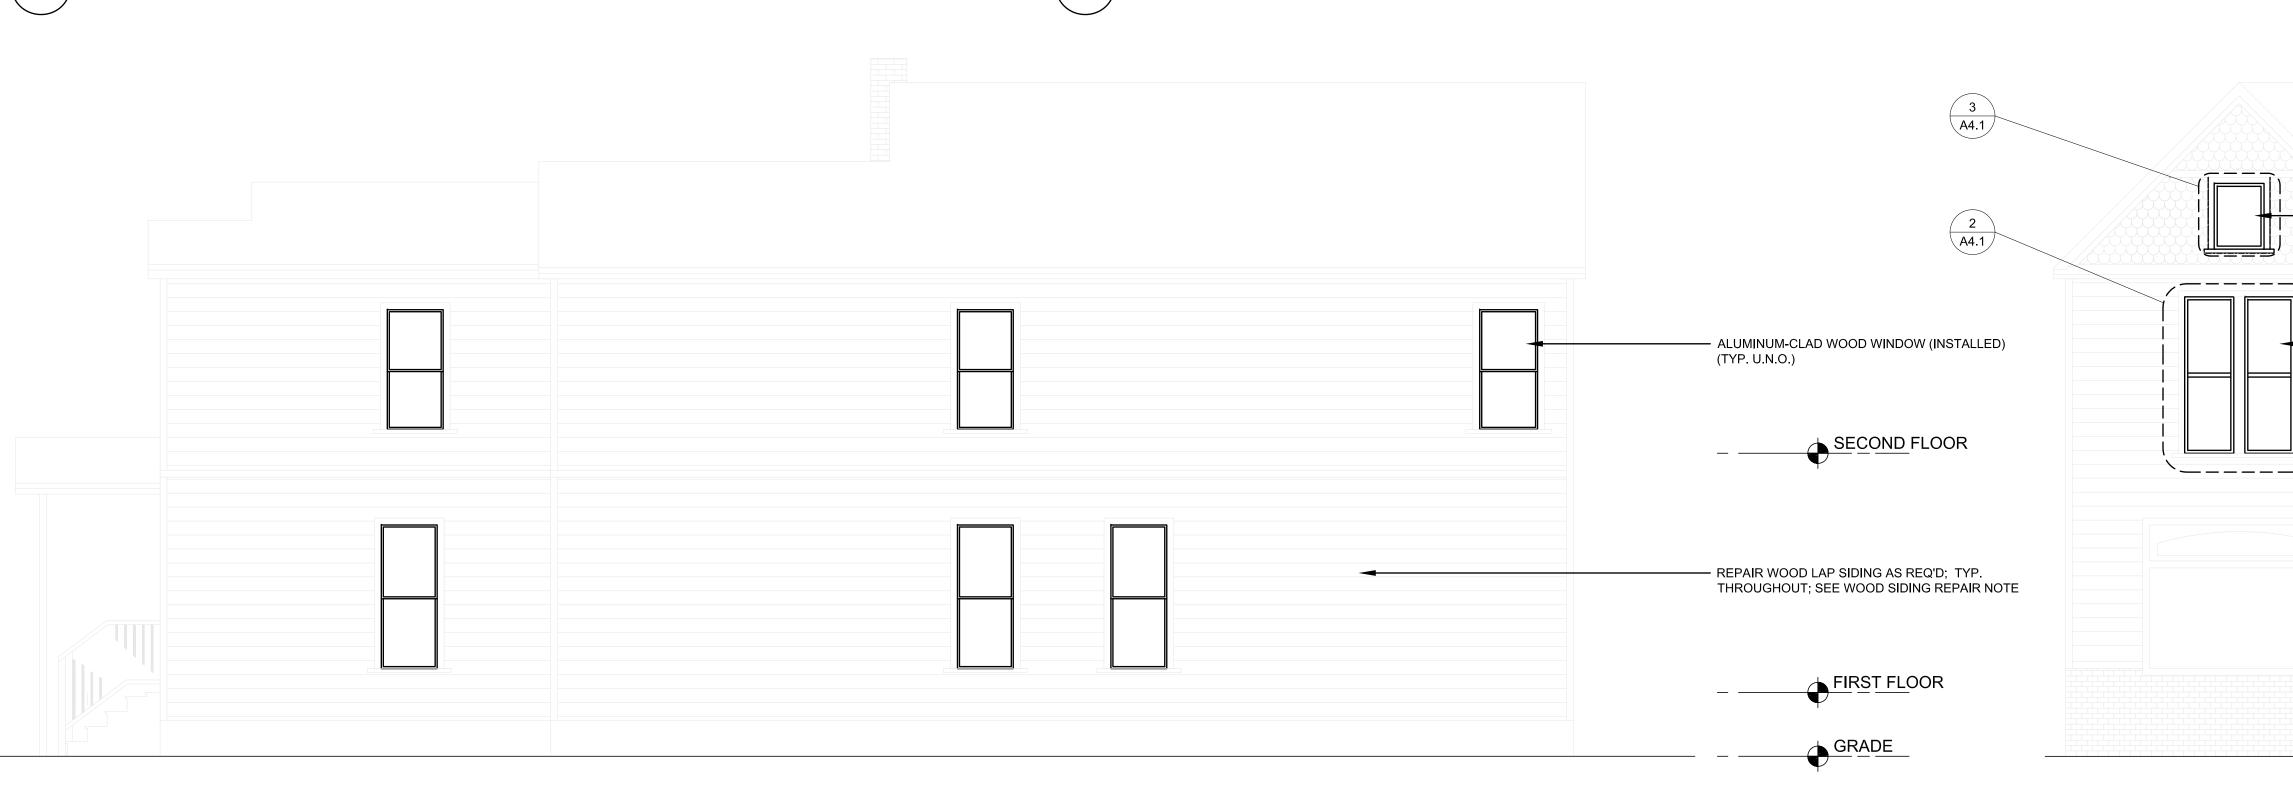



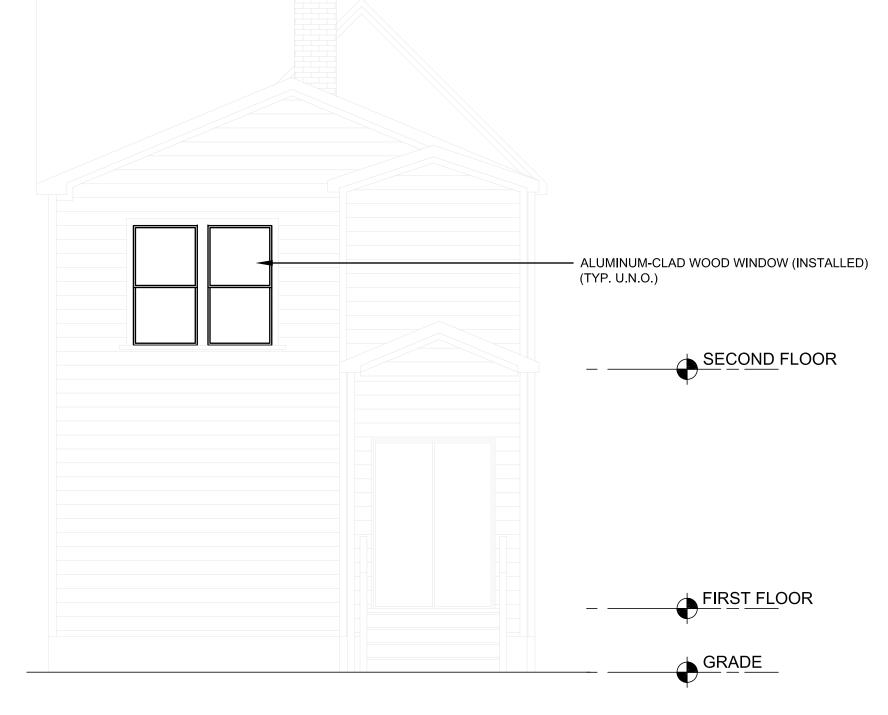

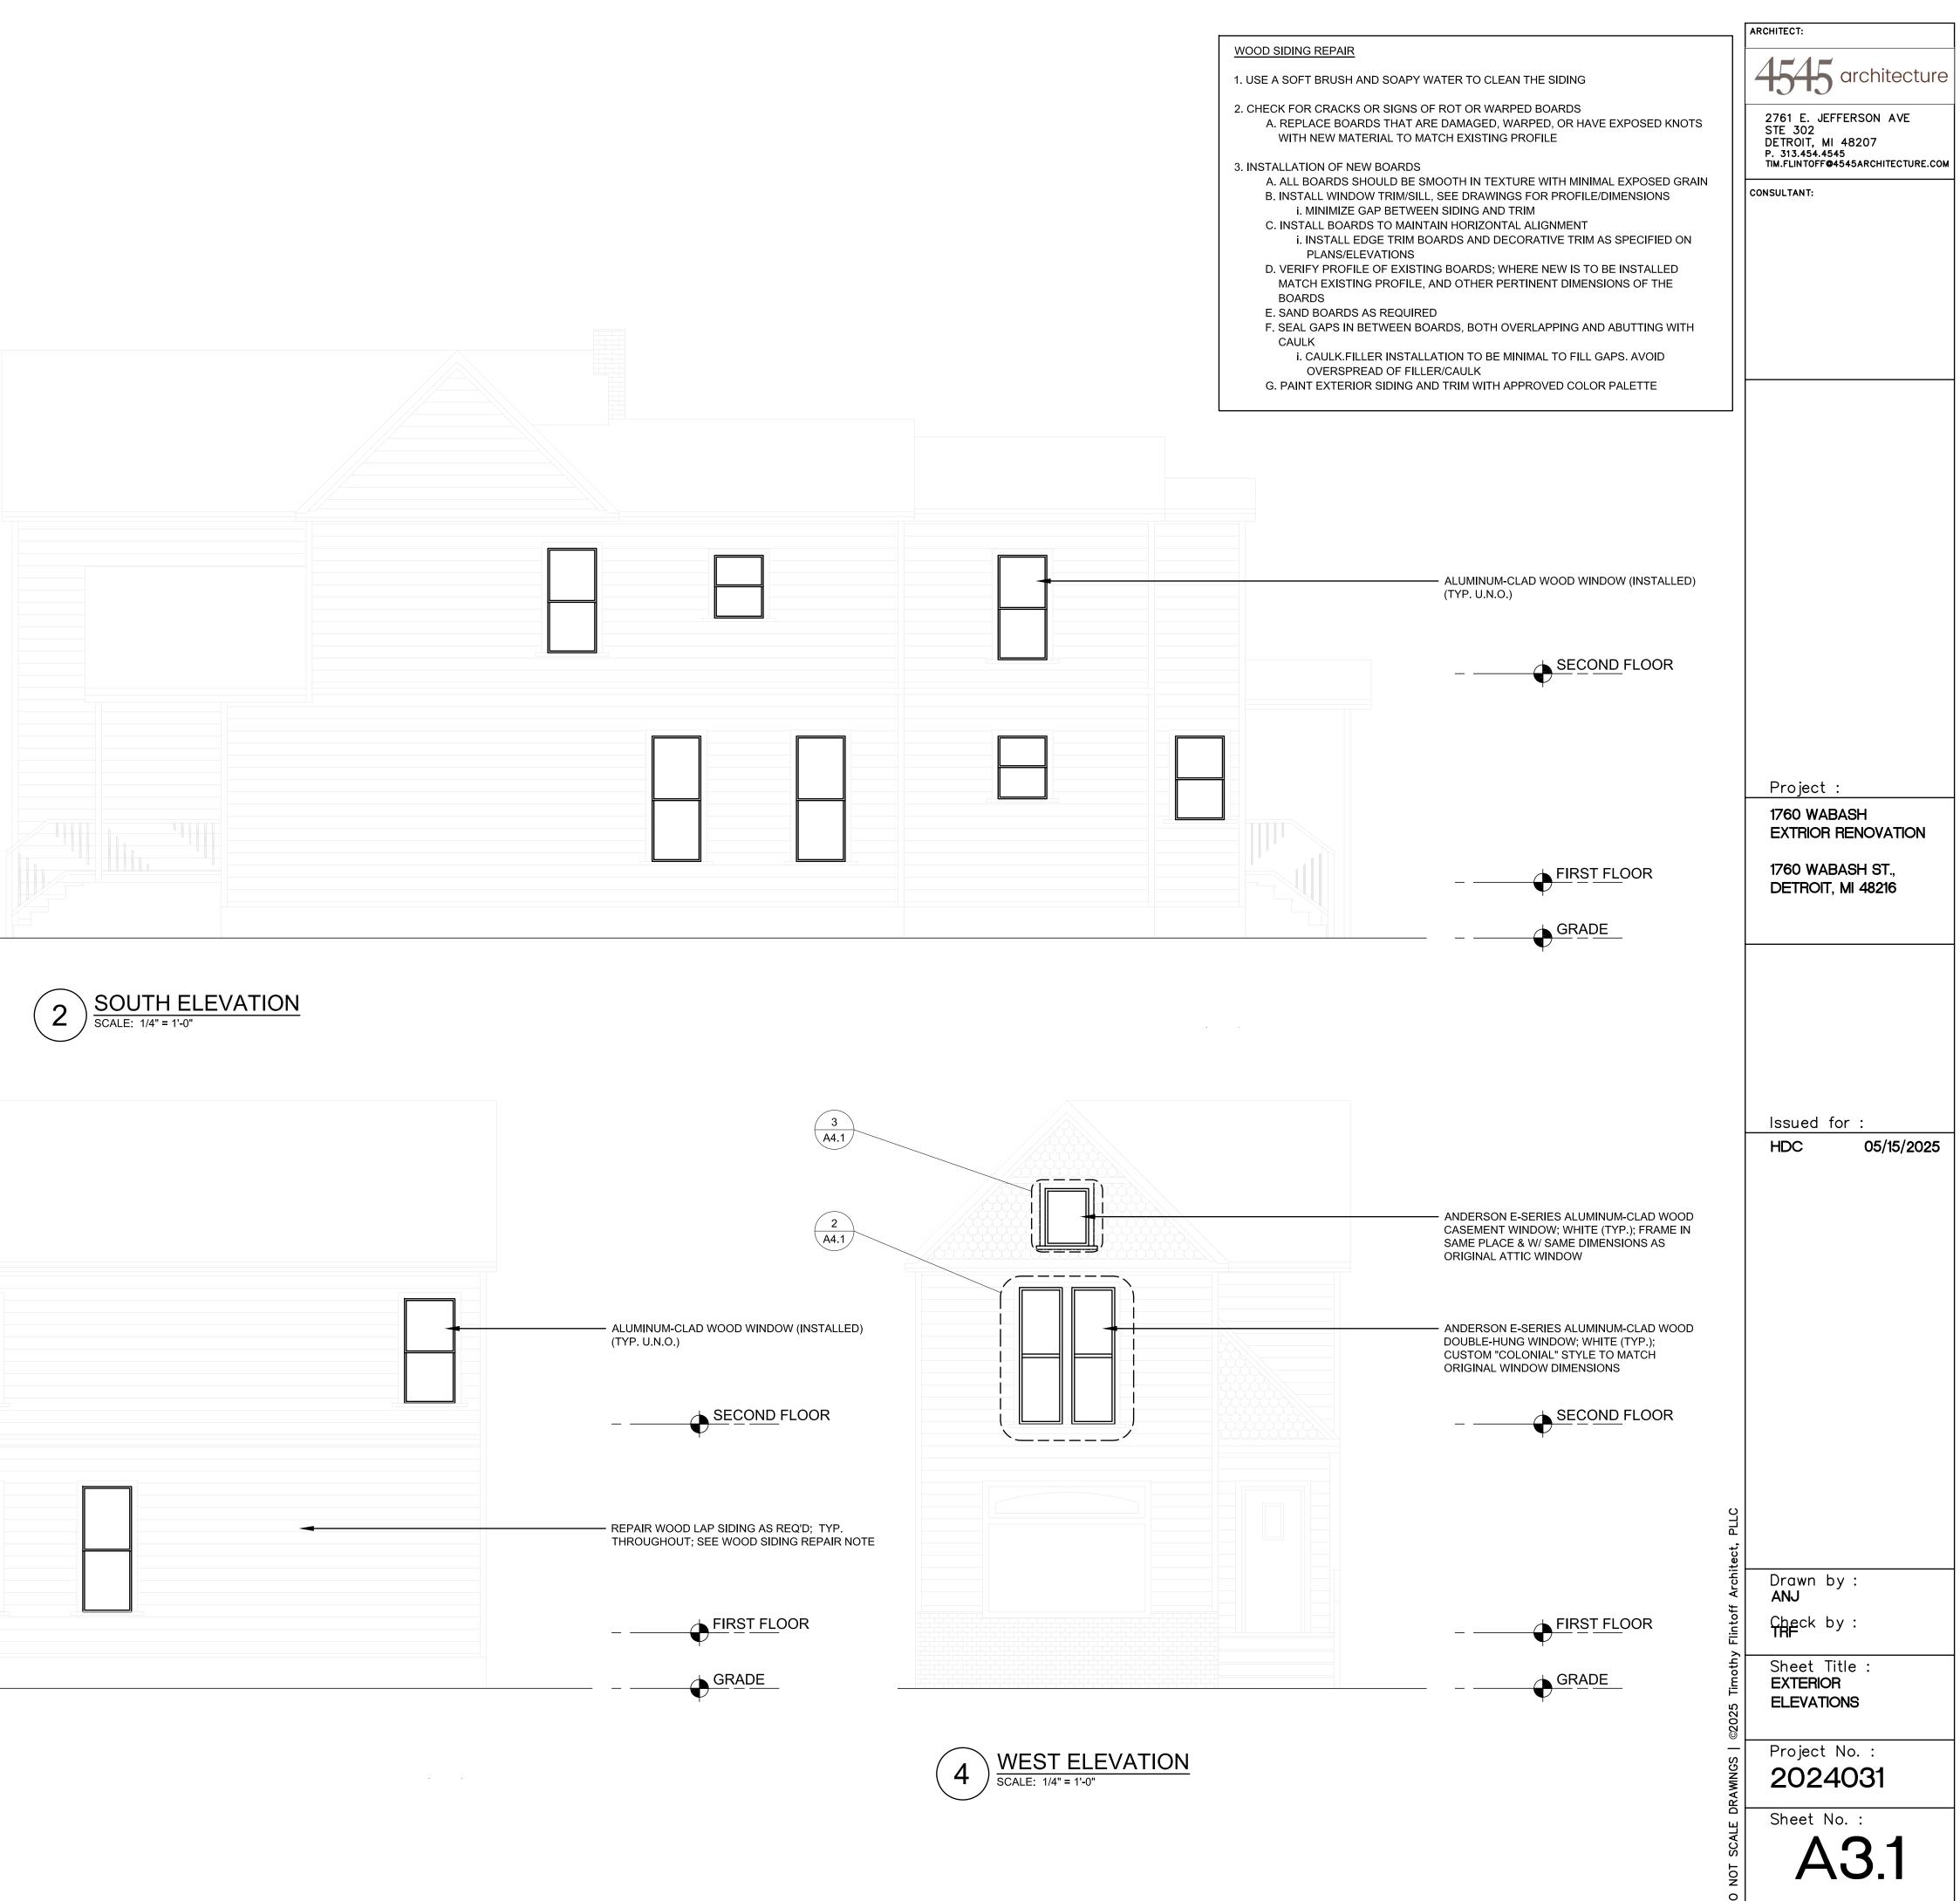



# 1760 WABASH EXTERIOR RENOVATION

1760 WABASH ST., IDETROIT, MI. 48216

ARCHITECT 4545 ARCHITECTURE | DESIGN, PLLC TIMOTHY FLINTOFF, AIA, NCARB 2761. E JEFFERSON, SUITE 302 DETROIT, MI 48207 248-320-6098

PROJECT DATA

BUILDING CODE AUTHORITY: CITY OF DETROIT, MICHIGAN

OWNER: SHARIF AFFAS, DETROIT DEVELOPING PROPERTIES, LLC APPLICABLE CODES:

BUILDING CODE ALSO KNOWN AS THE "MICHIGAN BUILDING CODE" 2021 MICHIGAN BUILDING CODE (MBC) AS AMENDED

MECHANICAL CODE ALSO KNOWN AS THE "MICHIGAN MECHANICAL CODE" 2021 MICHIGAN MECHANICAL CODE AS AMENDED

PLUMBING CODE ALSO KNOWN AS THE "MICHIGAN PLUMBING CODE" 2021 MICHIGAN PLUMBING CODE AS AMENDED

ELECTRICAL CODE ALSO KNOWN AS THE "MICHIGAN ELECTRICAL CODE" 2023 MICHIGAN ELECTRICAL CODE AS AMENDED

ENERGY CODE 2015 UNIFORM ENERGY CODE

BARRIER FREE REQUIREMENTS AMERICANS WITH DISABILITIES ACT (ADA) MBC-2015, CHAPTER 11 ICC / ANSI 117.1 - 2010, EXCEPT SECTION 611 & 707

# SHEET INDEX


TS1.1 SP1.1 A3.1 A4.1 TITLE SHEET AND SHEET INDEX ARCHITECTURAL SITE PLAN EXTERIOR ELEVATIONS SECTIONS

1760 WABASH ST.





PROJECT SITE MAP: NOT TO SCALE

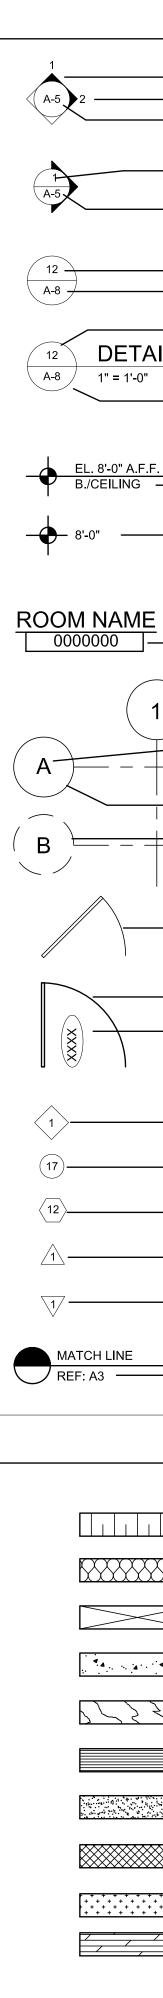

1 IVI	BOL LEGEND	AB	BREVIATION
	DARKENED ARROW INDICATES ELEVATED SECTION	@ ACOUST.	AT ACOUSTICAL
	ELEVATION NUMBER	A.C.T. ADJ.	ACOUSTIC CEILING TILE ADJACENT
	SHEET NUMBER WHERE ELEVATION IS LOCATED	A.F.F. ALUM.	ABOVE FINISH FLOOR ALUMINUM
		ANOD. BD.	ANODIZED BOARD
	ELEVATION NUMBER	BLDG. BLK.	BUILDING BLOCK
	SHEET NUMBER WHERE ELEVATION IS LOCATED	BLKG.	BLOCKING
		CEM. C.J.	CEMENT CONTROL JOINT
		ငLG. ငူ	CEILING CENTER LINE
	DETAIL REFERENCE NUMBER SHEET NUMBER WHERE DETAIL IS LOCATED	с.о. соц.	CLEAN OUT COLUMN
	Sheet Nowber where betail is located	CONC.	CONCRETE
	DETAIL NUMBER	C.G. CONST.	CORNER GUARD CONSTRUCTION
	DETAIL NAME	CONT. CORR.	CONTINUOUS CORRUGATED
	DRAWING SCALE	CPT. C.T.	CARPET CERAMIC TILE
	SHEET NUMBER WHERE DETAIL IS REFERENCED	DET.	DETAIL
		DIA. DM.	DIAMETER DIMENSION
	HEIGHT ABOVE FINISHED FLOOR	DN. D.O.	DOWN DOOR OPENING
	REFERENCE POINT OF ELEVATION	DR.	DOOR
		DWG. EA.	DRAWING EACH
	HEIGHT ABOVE FINISHED FLOOR	ELEV. E.W.	ELEVATION EACH WAY
	NOTE: DATUM SYMBOL INDICATES A SPECIFIC	EXG. EXIST.	EXISTING EXISTING
	REFERENCE HEIGHT OF MATERIAL INDICATED	EXP.	EXPANSION, EXPOSED
	ROOM NAME	EXT. F.D.	EXTERIOR FLOOR DRAIN
	ROOM NAME ROOM NUMBER	FDN.	FOUNDATION FIBER REINFORCED PANE
		FIN.	FINISH
		FLR. F.O.	FLOOR FACE OF
)		F.O.S. FR.	FACE OF STUD FRAME
/ <b>\</b>		FTG.	FOOTING
	NUMBERS DESIGNATE VERTICAL COLUMN LINES LETTERS DESIGNATE HORIZONTAL COLUMN LINES	FV. GA.	FIELD VERIFY GAUGE
		GALV. GYP.	GALVANIZED GYPSUM
	CIRCLES REPRESENT NEW COLUMN LINES	HDW.	HARDWARE
	DASHED CIRCLES REPRESENT EXISTING COLUMNS	H.M. HORIZ.	HOLLOW METAL HORIZONTAL
		HT.   I.D.	HEIGHT INSIDE DIAMETER
		INSUL.	INSULATION INTERIOR
		JT.	JOINT
	EXISTING DOOR SYMBOL	LAV. LG.	LAVATORY LONG
		L.L.O. L.L.V.	LONG LEG OUTSTANDING LONG LEG VERTICAL
		MAX.	MAXIMUM
	NEW DOOR SYMBOL	MECH. MET.	MECHANICAL METAL
	DOOR DESIGNATION	MEZZ. M.I.	MEZZANINE MISCELLANEOUS IRON
		MIN. MISC.	MINIMUM
		M.O.	MISCELLANEOUS MASONRY OPENING
		N.I.C.	NOT IN CONTRACT NOT TO SCALE
	WALL TYPE DESIGNATION NUMBER - COORDINATE WITH SCHEDULE	0.C. 0.D.	ON CENTER OUTSIDE DIAMETER
	EQUIPMENT DESIGNATION NUMBER -	OPNG.	OPENING
	COORDINATE WITH PLAN NOTES	OPP. PL.G.	OPPOSITE PLATE GLASS
	KEY NOTE DESIGNATION NUMBER -	PL.S. P.LAM	PLATE STEEL PLASTIC LAMINATE
	COORDINATE WITH PLAN NOTES	PLAS. PREFAB.	PLASTER PREFABRICATED
	ADDENDUM DESIGNATION NUMBER	PROJ.	PROJECT, PROJECTION
		P.S.F. PT.	POUNDS PER SQUARE FC PAINT, POINT
	BULLETIN DESIGNATION NUMBER	R. R.A.	RISER RETURN AIR
		R.B.	RUBBER BASE
		R.C. R.C.P.	ROOF CONDUCTOR REFLECTED CEILING PLAI
	SHEET REFERENCE FOR DRAWING CONTINUATION	R.D. R.F.	ROOF DRAIN RUBBER FLOORING
		REINF.	REINFORCED, REINFORCI REQUIRED
14-	TERIAL LEGEND	RFG.	ROOFING
		RM. R.S.	ROOM ROOF SUMP
		R.T. SAN.	RUBBER TILE SANITARY
	ACOUSTICAL CEILING	SCHED.	SCHEDULE SHEET
		SIM.	SIMILAR
		SPEC. S.S.	SPECIFICATION SERVICE SINK
X	BATT/LOOSE INSULATION	STL.	STEEL STANDARD
7		STOR.	STORAGE
_	BLOCKING/ROUGH LUMBER	STRUCT. SUSP.	STRUCTURAL SUSPENDED
	CONCRETE	SW. SYM.	SWITCH SYMMETRICAL
<u> </u>	······································	T.	TREAD TOP AND BOTTOM
コ	FINISHED WOOD	TEL.	TELEPHONE
		TERR. T&G	TERRAZZO TONGUE AND GROOVE
_	GLASS	THK.	THICK, THICKNESS THRESHOLD
		T.O.S.	TOP OF STEEL
	GYPSUM WALLBOARD	TYP. U/C	TYPICAL UNDERCUT
		U.N.O.	UNLESS NOTED OTHERW
		V.B.	
	MASONRY	V.C.T.	VINTE COMPOSITION TILE
	MASONRY	V.I.F.	VERIFY IN FIELD
	MASONRY PARTICLE BOARD	V.I.F. W. VERT.	VERIFY IN FIELD WIDE VERTICAL
		V.I.F. W.	WIDE
		V.I.F. W. VERT. WAINS.	VERIFY IN FIELD WIDE VERTICAL WAINSCOT

	ARCHITECT:
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	P. 313.454.4545 TIM.FLINTOFF@4545ARCHITECTURE.COM CONSULTANT:
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