

May 18, 2021

CERTIFICATE OF APPROPRIATENESS

Emily Peterson Nepelu LLC 1951 Chicago Boulevard Detroit, MI 48206

RE: Application Number 21-7222; 1920 Atkinson, Atkinson Avenue Historic District

Dear Ms. Peterson:

At the regularly scheduled meeting held virtually on May 12, 2021, the Detroit Historic District Commission ("Commission") reviewed the above-referenced application for building permit. Pursuant to Section 5(10) of the Michigan Local Historic District Act, as amended, being MCL 399.205, MSA 5-3407(5)(10) and Section 21-2-73 of the 2019 Detroit City Code; the Commission has reviewed the above-referenced application for building permit and hereby issues a Certificate of Appropriateness, which is effective as of May 18, 2021.

The following proposed work meets the defined elements of design for the historic district and the Secretary of the Interior's Standards for Rehabilitation and guidelines for rehabilitating historic buildings (36 CFR Part 67).

Rehabilitation and adaptive reuse of the house (first floor as restaurant, upper floors as residential apartments), the construction of a rear yard patio and pergola that will connect to the patio at the adjacent property (9321 Rosa Parks Boulevard), and the construction of three parking spaces at the alley for the use of the residential apartments.

- 01: All Windows will be either repaired to previous historic condition or rebuilt using the same materials and will be painted with historical colors per drawing set.
 - o Including trim, sash, and sills to match existing profiles.
 - o Sash to be painted B:18 Dark Reddish Brown; Trim to be painted A:8 Blackish Green
 - Window sash for window opening W22 is no longer present; a metal frame for the three-part unit remains.
- 02: Elimination of an Existing Window (DW) for New Residential Door Entrance (103) at the back of the building.
 - New door sill height.
- 03: Move the Door (103) higher and further west to accommodate the new Residential Door Entrance (103) at the back of the building.
- 04: Replace All Exterior Doors (See Drawings).
 - o Door 100, 102, 103 to be commercial grade with weatherstrip, sweep, and threshold. Paint historical colors per drawing set.
 - o Door 104 & 105. Paint historical colors per drawing set.

- O Trim to match existing profile and lite configuration to mimic adjacent windows. Paint historical colors per drawing set.
- New doors will be fiberglass. Door design flush panel with glass opening (four-over-six pattern) on upper-half of door. Doors will be built by historic window contractor and true divided lights will fill the glass area.
- 05: Front Porch to be Rebuilt and Widened in Same Materials as Existing.
 - One set of stairs to be added to the front elevation porch at the southeast corner.
 - Existing porch will not be removed. It will remain at the same height and become four feet wider.
- 06: Demolished Rear Porch will be removed. New Wood Deck for Outdoor Patio with Pergola.
- 07: New ADA Ramp Connected to Existing Ramp at 9321 Rosa Parks
- 08: Tuck Pointing and Repair of Existing Masonry as Needed.
- 09: Existing Gutters to be Repaired and Painted A:8 Blackish Green
- 10: Construct three parking spaces at rear of lot between back of enclosed deck/pergola and alley.

The COA was issued with the following conditions:

- The three windows that need to be fabricated for window opening W22 will be wood (with wood exterior), double-hung windows with true-divided, or simulated divided, light glass. Mullions, similar to the dimensions of structural historic mullions will be fabricated and installed. The existing wood window casings will remain and be repaired as needed. Finish color for this opening will match the remaining windows and trim. The window order confirming dimensions, operation, material, and finish shall be submitted for staff review.
- A catalog cut for the rear entry railing will be submitted for staff review.
- Evidence of the window and door opening proposed for removal on the rear elevation will be retained and will consist of: the double rowlock headers and the brick infill will be laid in a running bond pattern within the openings. Vertical joints will be used to separate the infill brick from the existing brick wall.
- If new brick is needed within this project, it shall match the historic brick in density, dimension, color and pattern.
- New mortar shall match the existing mortar in composition and color, the mortar joints shall match in dimension and profile.
- Lighter, contrasting color(s), sympathetic to the color palette of Color System C, will be selected for the windows and trim and will be submitted to HDC staff for review and approval.
 - o *5/11 applicant email*: Window/Building Trim: C4-Yellowish White; Window Sash, Doors, Gutters/Downspouts: B19-Black.

Please retain this COA for your files. You should now proceed to obtain a building permit from the City of Detroit Buildings, Safety, Engineering and Environmental Department. It is important to note that approval by the Detroit Historic District Commission does not waive the applicant's responsibility to comply with any other applicable ordinances or statutes.

For the Commission:

ander Dy

Audra Dye

Staff, Detroit Historic District Commission

iannuzzi studio

architecture + design

DHDC NARRATIVE

Existing Conditions

Built in 1920, 1920 Atkinson St is a 2½ story 2,305 sq ft brick building with an asphalt gable roof that has been abandoned for 30+ years. It is constructed with wood framing and features a front porch. Currently, it has been boarded and demoed to the studs by previous owners. The property has no gutters, mechanical, electrical, or plumbing. It is missing internal floors and internal stairs, rot is prevalent.

Project Description

The building at 1920 Atkinson has been abandoned for over 30 years and fallen into disrepair, creating an unwanted eyesore for the area. This project will bring new life into the property that would benefit the entire community and create the missing piece to a commercial corner at the cross section of Atkinson Street and Rosa Parks Blvd, across the street from Gordon Park. The overall goal is to increase population density and encourage more walkable areas for residents of Boston Edison, Atkinson, and Clairmont.

1920 Atkinson was acquired from the Landbank by the same owners of The Congregation Detroit (which was an abandoned church turned into a café) to offer the local community more amenities by renovating this 100-year house. Since the acquisition, the owners have received approval and converted the property's zoning from residential to SD-1 with overwhelming support of the community and community leaders.

The proposed project will be a mixed-use building with a restaurant on the first floor and two apartments on the remaining floors. With the restaurant, there will be an outdoor wood deck seating with pergola on the north side of the building (back of the property) matching the design of The Congregation Detroit, a project approved by HDC. The deck will connect to the ADA ramp from The Congregation Detroit, which will make the combined properties an even larger asset for the local community.

All windows, brickmolds, and windowsills will be repaired to previous historic condition or rebuilt using the same materials. A window on the north side (back of the building) will be bricked in as it conflicts with the new residential entrance for which the door sill will be raised to allow for enough head clearance for new internal stairs.

All exterior doors are non-historic and rotted or non-existent and will be replaced by doors that match the historic windows. Some of the door wood trims are rotted and may need to be replaced. Trims that cannot be repaired will be replaced with ones built to match existing. Because the first floor will be a commercial space, all existing doors are not to code and must swing out.

iannuzzi studio

architecture + design

DHDC NARRATIVE

Proposed Work for Approval

- 01: All Windows will be Either Repaired to Previous Historic Condition or Rebuilt Using the Same Materials and will be Painted with Historical Colors per Drawing Set.
 - A. Including trim, sash, and sills to match existing profiles.
- 02: Elimination of an Existing Window (DW) for New Residential Door Entrance (103) at the back of the building.
 - o A. New door sill height.
- 03: Move the Door (D103) higher and further west to accommodate for the New Residential Door Entrance (103) at the back of the building.
- 04: Replace All Exterior Doors (See Drawings).
 - A. Door 100, 102, 103 to be commercial grade with weatherstrip, sweep, and threshold. Paint historical colors per drawing set.
 - B. Door 104 & 105. Paint historical colors per drawing set.
 - B. Trim to match existing profile and lite configuration to mimic adjacent windows. Paint historical colors per drawing set.
- 05: Front Porch to be Rebuilt and Widened in Same Materials as Existing (See Drawings).
- 06: Demolished Rear Porch will be removed. New Wood Deck for Outdoor Patio with Pergola.
- 07: New ADA Ramp Connected to Existing Congregation Ramp.
- 08: Tuck Pointing and Repair of Existing Masonry as Needed.
- 09: Existing Gutters to be Repaired and Painted A:8 Blackish Green

• 10: Three New Parking Spots for Tenants Adjacent to the Rear Porch

THE RECTORY

1920 ATKINSON ST. Detroit, Michigan 48206

Owner:

Amy Peterson, Antonio Luck, Betsy Murdoch

Architect:

Iannuzzi Studio PLLC 1410 Service St. Suite 202 Detroit, MI 48207

Contact: David Iannuzzi, AIA T: 313.920.5688 di@iannuzzistudio.com

General Contractor: T.B.D.

Structural Engineer:

Mechanical Engineer:

M A Engineering 400 S. Old Woodward Ave., Suite 100 Birmingham, MI 48009

T: 248.258.1610

General Requirements

Provide all labor, materials, equipment, and services and provide all operations required to accomplish the work as indicated and/or implied by the drawings and these general notes and specifications.

0141 CODES AND ORDINANCES

All construction to comply with all applicable codes, ordinances, safety orders and regulations including building, Americans with Disabilities Act ADA, OSHA, plumbing, mechanical, and electrical codes, ordinances and requirements.

Plans, notes, and specifications are done to the reference code listed as of the date originally prepared. Any use in other jurisdictions will require these documents to be reviewed and/or modified by a local design professional licensed to practice in that jurisdiction.

PERMITS AND TESTS

Obtain and pay for all required permits, inspections, and tests. All re-inspection fees for work not ready or in compliance with local codes to be paid for by Contractor.

INSURANC

All Contractors shall carry broad form, comprehensive liability insurance (minimum \$1,000,000 liability) and workmen's compensation insurance and shall submit certificates of insurance to the Owner prior to execution of any work. All Contractors shall name lannuzzi Studio PLLC, Nepelu LLC, and financing organizations as additional insured on all insurance policies.

COORDINATION WITH OTHER TRADES

Coordinate all work before and during construction with all other affected trades. Where interferences develop notify architect. Relocation of conflicting installed work due to lack of coordination or poor coordination will not be considered extra work.

WORKMANSHIP

All work executed shall be performed in a first class and safe, workmanlike manner in accordance with the latest accepted standards and practice for the work involved. The workmanship shall be subject to the approval of the Owner at all times.

SCHEDULE

Within 7 days after date of Agreement, submit preliminary schedule defining planned operations for the first 60 days of Work, with a general outline for remainder of Work. Within 7 days after date of joint review, submit complete schedule. If preliminary schedule requires revision after review, submit revised schedule within 7 days. Show complete sequence of construction by activity, with dates for beginning and completion of each element of construction.

EXAMINATION OF EXISTING CONDITIONS

Before submitting proposals for the work, the Contractor shall be held to have examined the site and satisfied as to the existing conditions under which it will be obliged to operate in performance of the work. Contractor shall inform the Owner of any probable contingencies, which may influence the execution of the work with their bid. No extras will be allowed to the Contractor because of their failure to make this specified examination or neglect to include all materials and labor required in their work. Contractor to notify Architect of any hidden conditions for which an extra time or money is going to be requested prior to proceeding with the work. Failure to notify may result in denial of the extra expense.

APPROVED MANUFACTURERS

Use only materials specifically indicated in contract documents, or comparable materials by other listed acceptable or Architect-approved manufacturers. Note that "acceptable manufacturer" does not construe automatic approval of specific materials by one or all of the listed acceptable manufacturers. Architect reserves the right of final determination of acceptability of each item

SUBMISSION OF SHOP DRAWINGS AND CUT SHEETS

Submit complete shop drawings and/or manufacturer's cut-sheets for all materials, fabrication, and equipment intended for use on this project. Shop drawings shall clearly indicate all physical and performance characteristics for all materials and equipment. Submit electronic copies of all shop drawings for review by architect. No work is to be installed prior to review and return of architect-approved shop drawings.

APPROVAL OF SHOP DRAWINGS

Architect's review/approval of shop drawings is for adherence to design concept only. General and sub-contractors, suppliers, and fabricators to field verify all dimensions and site conditions for compliance with shop drawing requirements prior to release for fabrication. Architect to be given 10 days minimum to review all required shop drawings and/or selections.

DIMENSIONS

Review and verify all dimensions on the drawings before commencing with the work. If dimensional errors occur, the Contractor shall notify the Architect before proceeding with the work. DO NOT SCALE DRAWINGS. Any Contractor that scales a drawing to determine a location for any part of the work shall take full responsibility, should that portion of the work be improperly located.

ERRORS AND OMISSIONS

Any errors, omissions, or conflicts between various elements on the drawings and/or in these general notes shall be brought to the attention of the Architect before proceeding with the work. Failure to do so shall result in the Contractor taking full responsibility and liability for the work as installed.

Applicable Codes

All construction to comply with all applicable codes including local building, plumbing, mechanical, and electrical codes, ordinances and requirements.

2015 MICHIGAN REHABILITATION CODE FOR EXISTING BUILDINGS

- ALTERATION LEVEL III
 2015 MICHIGAN MECHANICAL CODE
- 2015 MICHIGAN ELECTRICAL CODE
- 2015 MICHIGAN PLUMBING CODE2015 UNIFORM ENERGY CODE

LEGAL DESCRIPTION PROPERTY EXEMPT F

PROPERTY EXEMPT FROM AD VALOREM TAXES AND ASSESSED ON THE SPECIAL ACT ROLL PURSUANT TO PA261 OF 2003 EXPIRING 12/30/2024. N ATKINSON 680 JOY ARM SUB L32 P40 PLATS, WCR $\frac{8}{128}$ 40 X 133.5 PARCEL ID: 08002810

ZONING CLASSIFICATION SD-1

BUILDING AREA

| Basement | 926 sq.ft. |
|----------------------|--------------|
| First Floor | 926 sq.ft |
| Second Floor | 909 sq. ft. |
| Third Floor | 467 sq.ft. |
| Gross Square Footage | 3,228sq. ft. |
| | |

CONSTRUCTION TYPE

FIRE RESISTANCE RATING (MBC TABLE 601)

| 0 | Wood Framing |
|---|---------------|
| | |
| 0 | Wood Framing |
| 2 | Brick Masonry |
| | • |
| 0 | Wood Framing |
| 0 | Brick Masonry |
| 0 | Wood Framing |
| | 0 0 |

OCCUPANCY AND USE Use classification

assification A-2 Assembly R-2 Residential

OCCUPANT LOAD FACTOR(TABLE NO. 1004.1.2 - MBC 2015) Type Area/Occupancy Total FIRST FLOOR

| FIRST FLOOR | | |
|---------------------|--------------|-----------|
| Interior Restaurant | sf / 15/ occ | occupants |
| Kitchen/Bar | sf /200/occ | occupants |
| Storage | sf /300/occ | occupants |
| Business | sf/100/occ | occupants |
| SECOND FLOOR | | |
| Residential | sf/200/occ | occupants |
| THIRD FLOOR | | |
| Residential | sf/200/occ | occupants |
| | | |
| BUILDING TOTAL | | OCCUPANTS |

FIRE SUPPRESSION REQUIREMENTS
Required for use over 100 occupants - OK

Required for use over 5,000 sq. ft. - OK
Required for use with fire area on a floor other than the level of exit discharge serving such

Width

| occupancies on |
|---------------------------------|
| MEANS OF EGRESS AND EXIT ACCESS |
| Egress Capacity |
| 0.2" (door) 16 nersons |

0.2" (door) 46 persons 9.2"

Exits Required Provided
1st floor 2 for occ < 501 persons x

Max Egress Travel Distance 200' for use - OK (TABLE NO. 1017.2 - MBC)

REUIRED PLUMBING FACILITIES È(TABLE NO. 403.1 - MPC 2015) Required: Provide

Required: Provided:

Water Closet: 1 per 75F, 1/75M Occ. (2) Single Occ.

Lavatory: 1/200 Occ. (2) Total

Drinking Ftn: 1 0 Drinking Fountain

Service Sink: 1 Service Sink

410.4 Substitution

Where restaurants provide drinking water in a container free of charge, drinking fountains shall not be required in those restaurants. In other occupancies where drinking fountains are required, water dispensers shall be permitted to be substituted for not more than 50 percent of the required number of drinking fountains. -OK

Scope of Work / General Notes:

RENOVATION OF EXISTING BUILDING, FIRST FLOOR RESTAURANT, SECOND AND THIRD FLOOR DWELLING.

| Sheet Index: | HDC Set | | | |
|------------------------------|------------|--|---|--|
| ISSUED SHEET | | | | |
| O ISSUED FOR REFERENCE ONLY | | | | |
| NOT INCLUDED / NOT ISSUED | | | | |
| | | | | |
| | | | | |
| | 21 | | | |
| | 5-20) | | | |
| | 04-12-2021 | | | |
| | | | | |
| | | | | |
| A0.0 COVER SHEET | • | | _ | |
| A0.1 ARCHITECTURAL SITE PLAN | • | | | |
| A0.2 LIFE SAFETY PLAN | | | | |
| ARCHITECTURAL | | | | |
| D1.0 DEMO PLANS | • | | | |
| D2.0 DEMO ELEVATIONS | • | | | |
| A1.0 FLOOR PLANS | • | | | |
| A1.1 REFLECTED CEILING PLANS | | | | |
| A2.0 EXTERIOR ELEVATIONS | | | | |
| A2.1 EXTERIOR ELEVATIONS | • | | | |
| A3.0 BUILDING SECTION | | | | |
| A3.1 WALL SECTIONS | | | | |
| A4.0 INTERIOR ELEVATIONS | | | | |
| A7.0 SCHEDULES | • | | | |

Table of Contents

| Site Plan | Page | 01 |
|-------------------------|------|----|
| Demo Plans | Page | 02 |
| Demo Elevations | Page | 03 |
| Floor Plans | Page | 04 |
| Exterior Elevations | Page | 05 |
| Exterior Elevations | Page | 06 |
| Schedule | Page | 07 |
| Exist. Site Photos | Page | 80 |
| Exist. Elevation Photos | Page | 09 |
| Exist. Elevation Photos | Page | 10 |
| Exist. Details Photos | Page | 11 |
| Exist. Details Photos | Page | 12 |
| Pergola Proposal | Page | 13 |
| Pergola Proposal | Page | 14 |
| | | |

lannuzzi Studio architecture – design

1410 Service St. Suite 202 Detroit, MI 48207

T. 313.625.9500

lann

PROJECT:

The Rectory 1920 Atkinson St. Detroit, MI 48206

1920 Atkinson St.

Site Location Map


04 - 12 - 2021

SHEET NUMBER:

AO.0

COVER SHEET

© lannuzzi Studio PLLC 2019

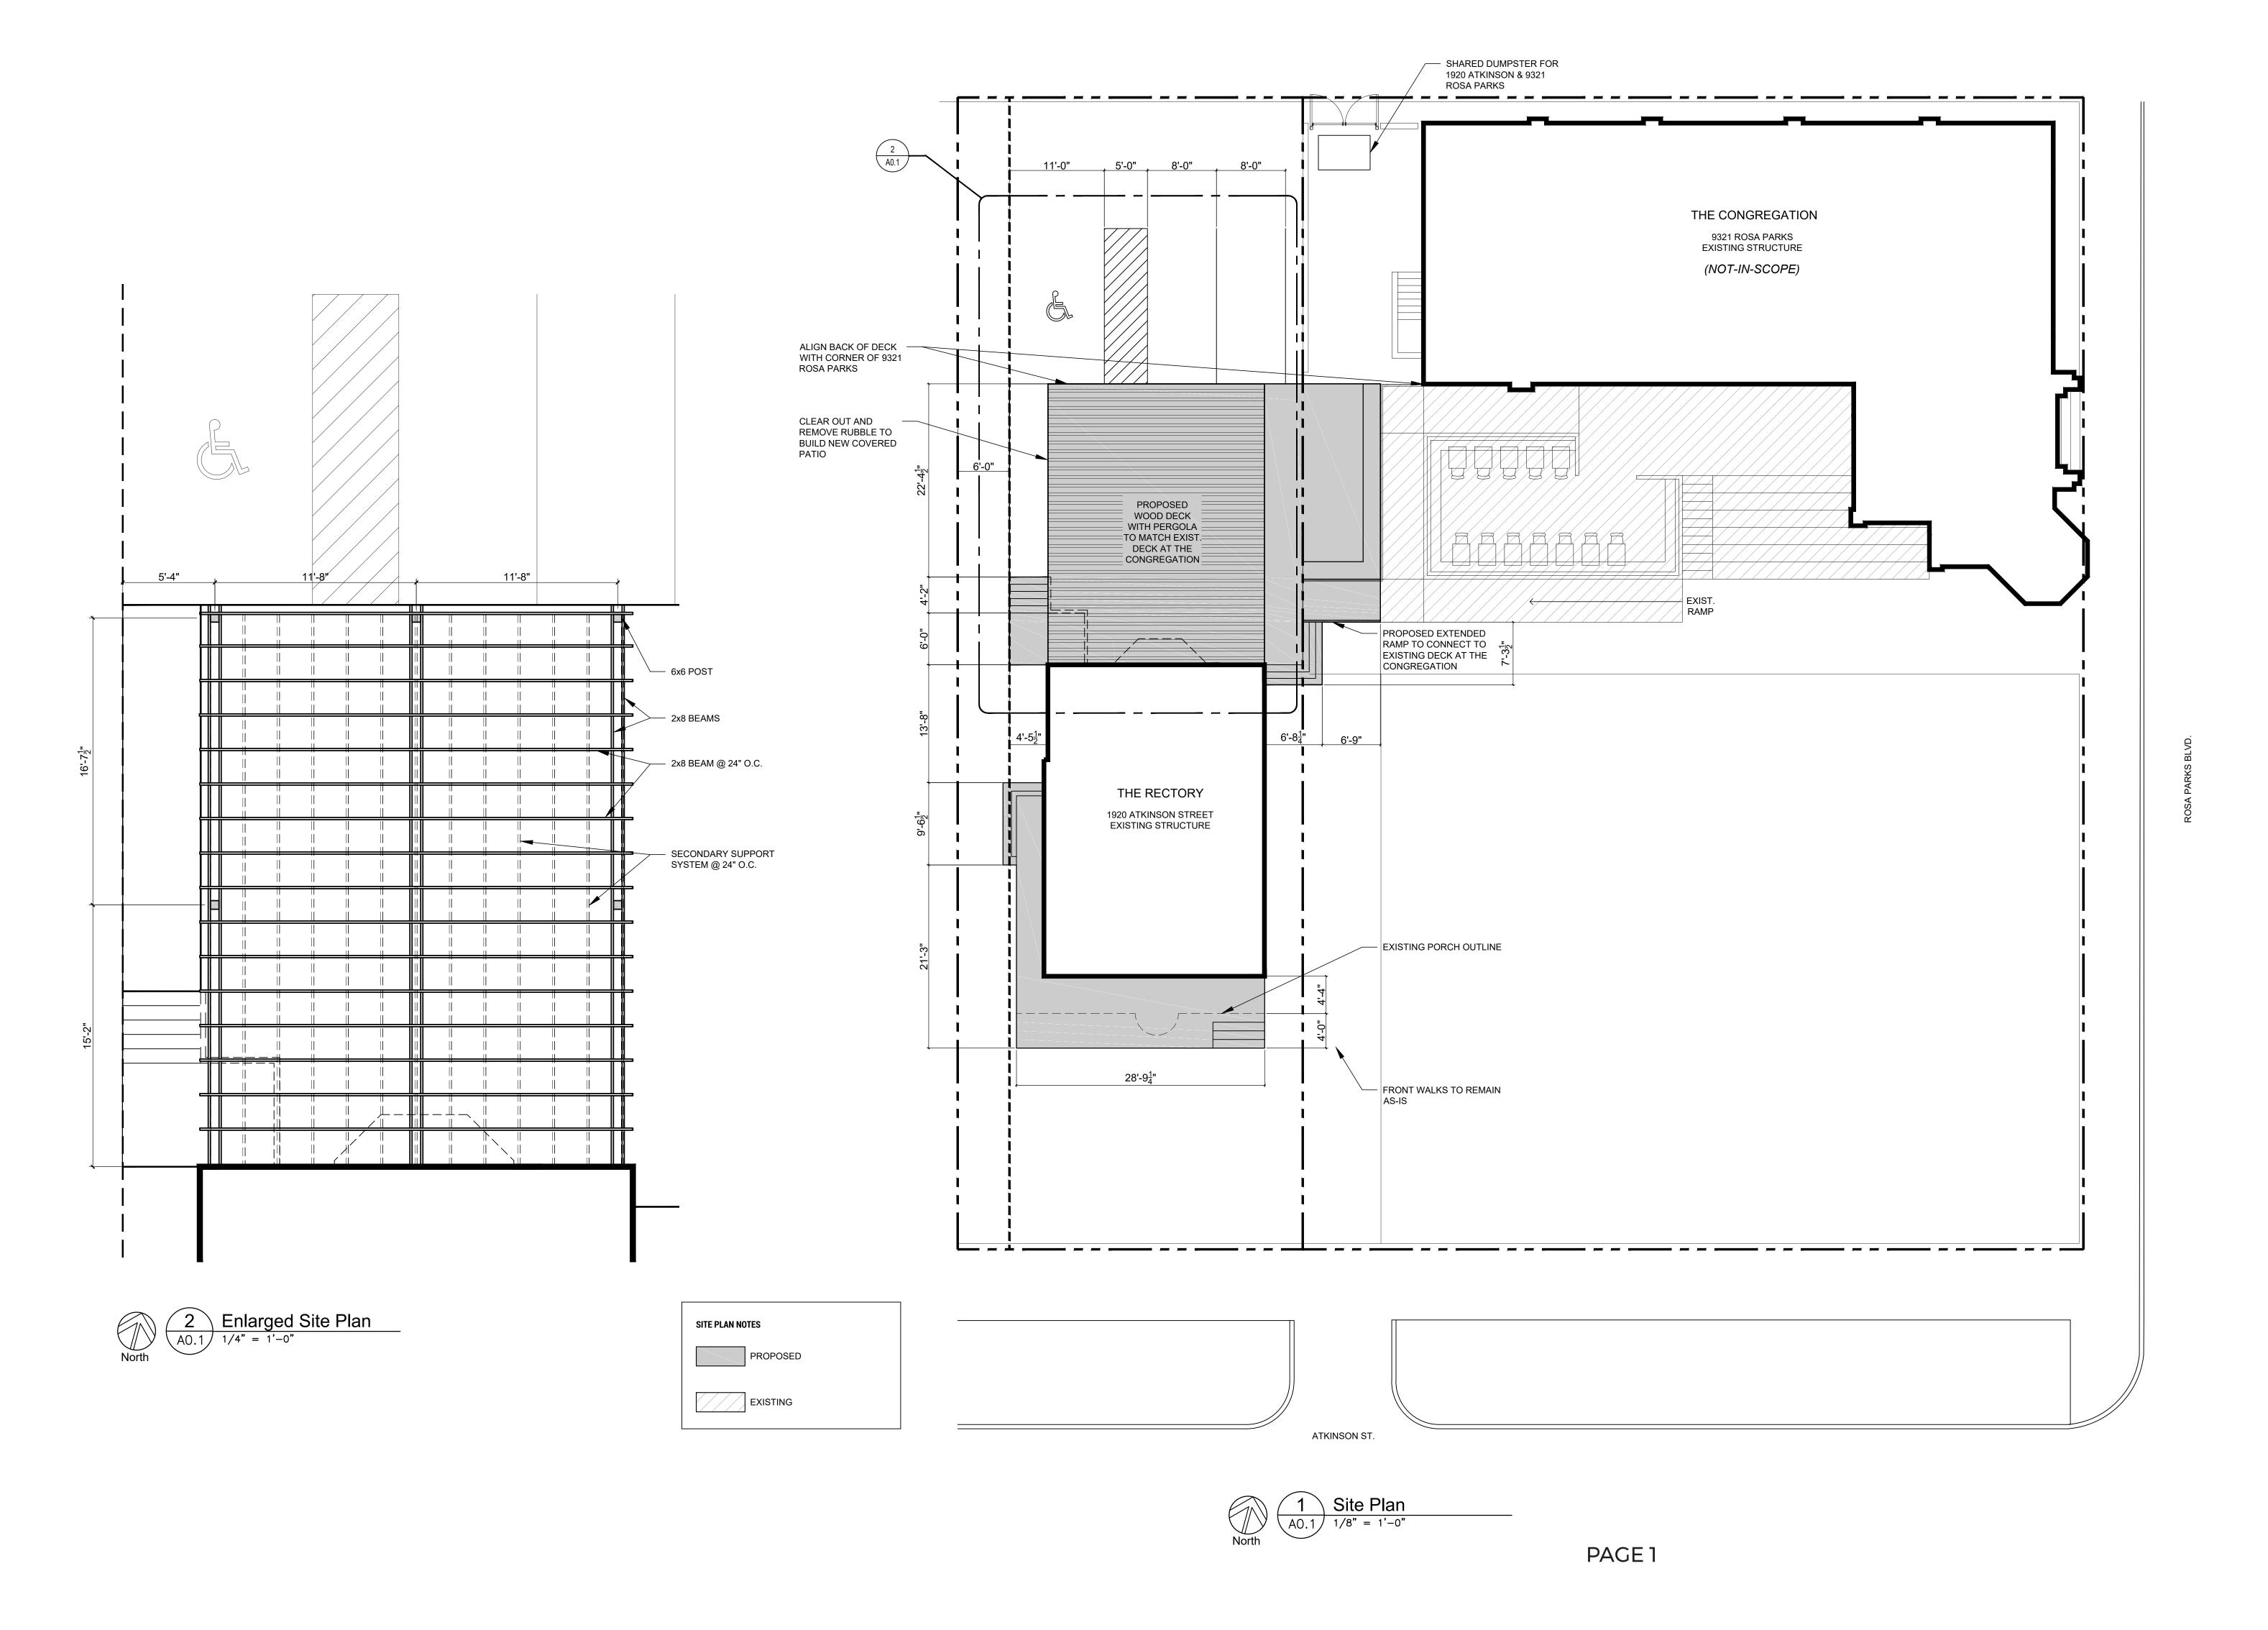

lannuzzi Studio architecture + design

> 1410 Service St. Suite 202 Detroit, Ml 48207

T. 313.625.9500 lannuzziStudio.com

PROJECT:

The Rectory 1920 Atkinson St. Detroit, MI 48206

| - 12 - 2021 | HDC Set |
|-------------|---------|
| | |
| | |
| | |
| | |

ISSUED FOR:

SHEET NUMBER:

AO.1

SHEET TITLE:
ARCHITECTURAL

SITE PLAN
© lannuzzi Studio PLLC 2019

DEMOLITION WALL KEY

Z/Z/Z/Z/Z EXISTING WALL TO BE DEMOLISHED

EXISTING WALL TO REMAIN

ARCHITECTURE KEY NOTES

D100

D101 REMOVE EXISTING INTERIOR WALLS, TYP.

D102 REMOVE STAIRS AND LANDING AND PREP FOR NEW WORK.
REMOVE FLOORING AND PREP FOR NEW WORK

D103


D104


D105 REMOVE EXISTING MASONRY WALL AND PREPARE FOR NEW


D106

GENERAL NOTES


1.: ALL WINDOWS, BRICK MODELS, AND WINDOW SILLS WILL BE RESTORED OR REBUILT TO MATCH CURRENT. COLOR IS TO BE C:4 YELLOWISH WHITE WITH B:19 BLACK FOR THE TRIM PER HDC'S DESIGN GUIDELINES

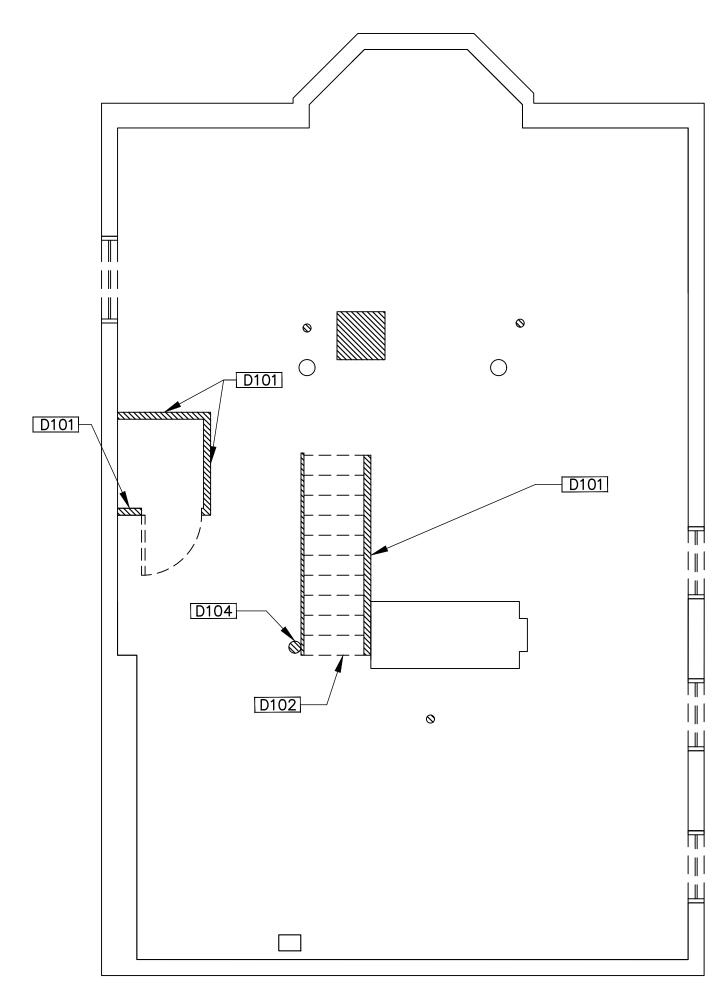

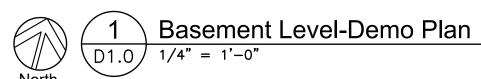

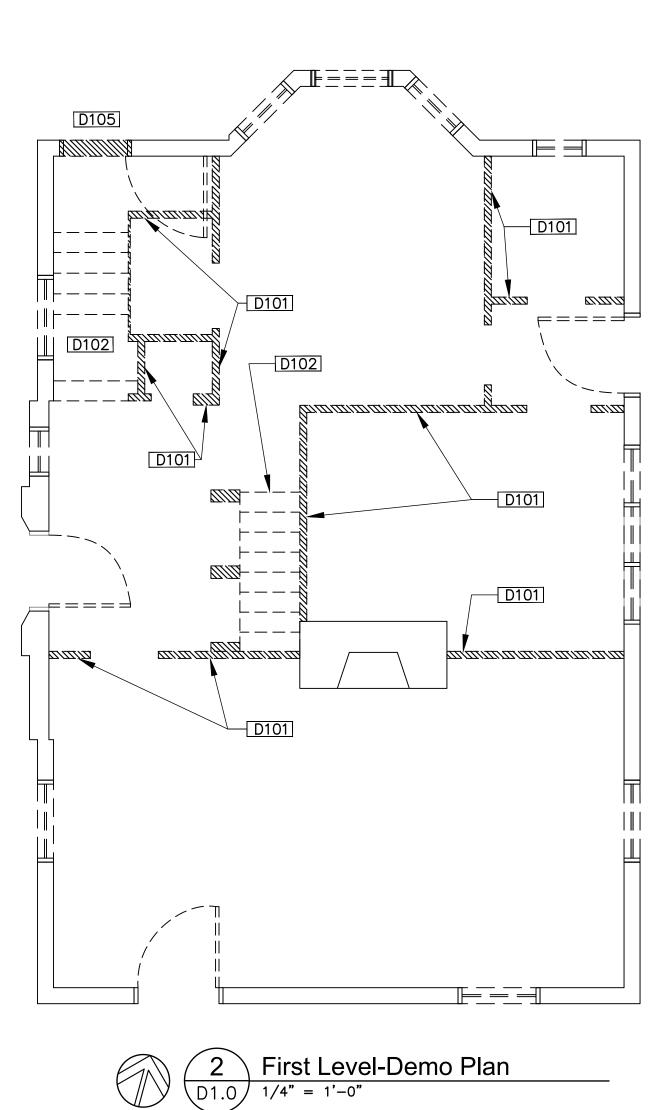




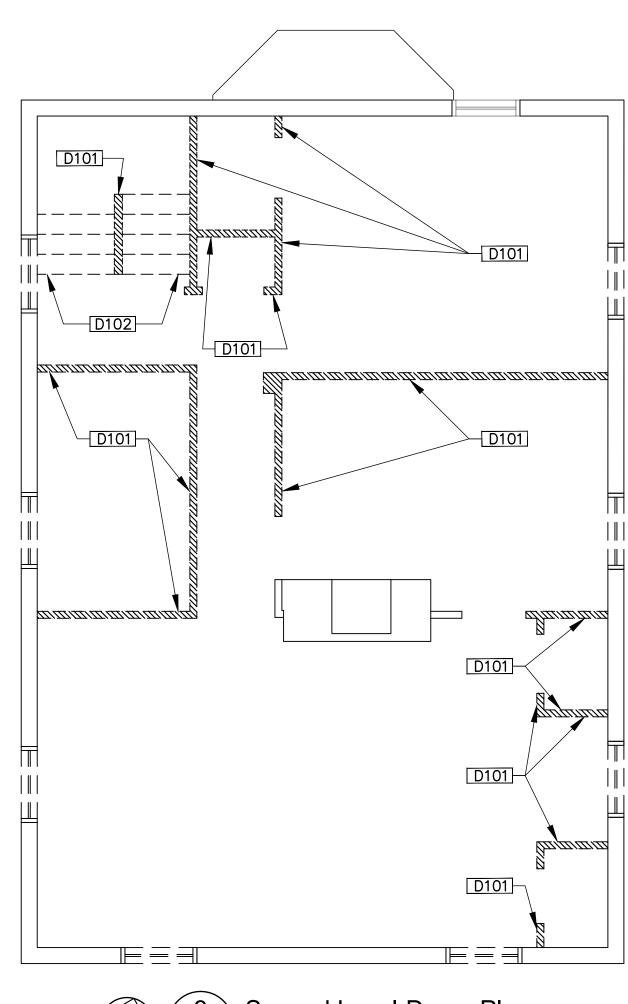

Second Level-Demo Plan

D1.0 1/4" = 1'-0"

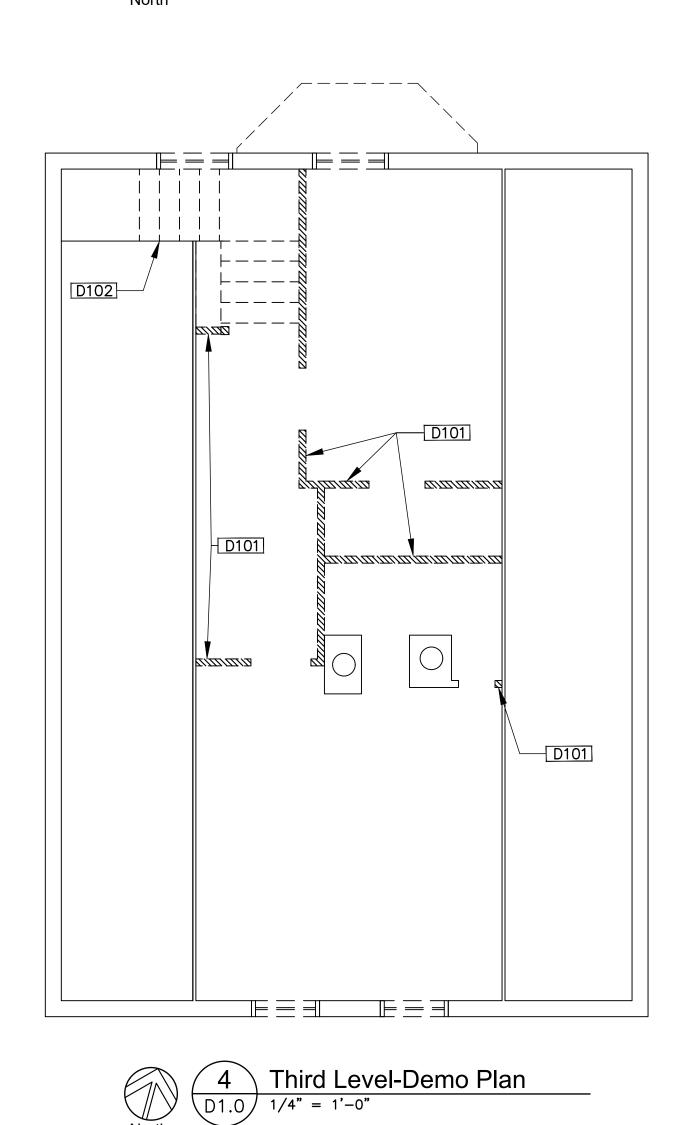

lannuzzi Studio Architecture + Design

1410 Service St. Suite 202 Detroit, MI 48207

T. 313.625.9500 lannuzziStudio.com

PROJECT:

The Rectory 1920 Atkinson St. Detroit, MI 48206


| 0.4 | 10 | 0001 | | HDC | C-1 |
|-----------|----------|------|--|-----|-----|
| <u>U4</u> | <u> </u> | 2021 | | HDC | Set |
| | | | | | |
| | | | | | |
| _ | | | | | |

ISSUED FOR:

SHEET NUMBER:

SHEET TITLE:
DEMO PLANS

© lannuzzi Studio PLLC 2019

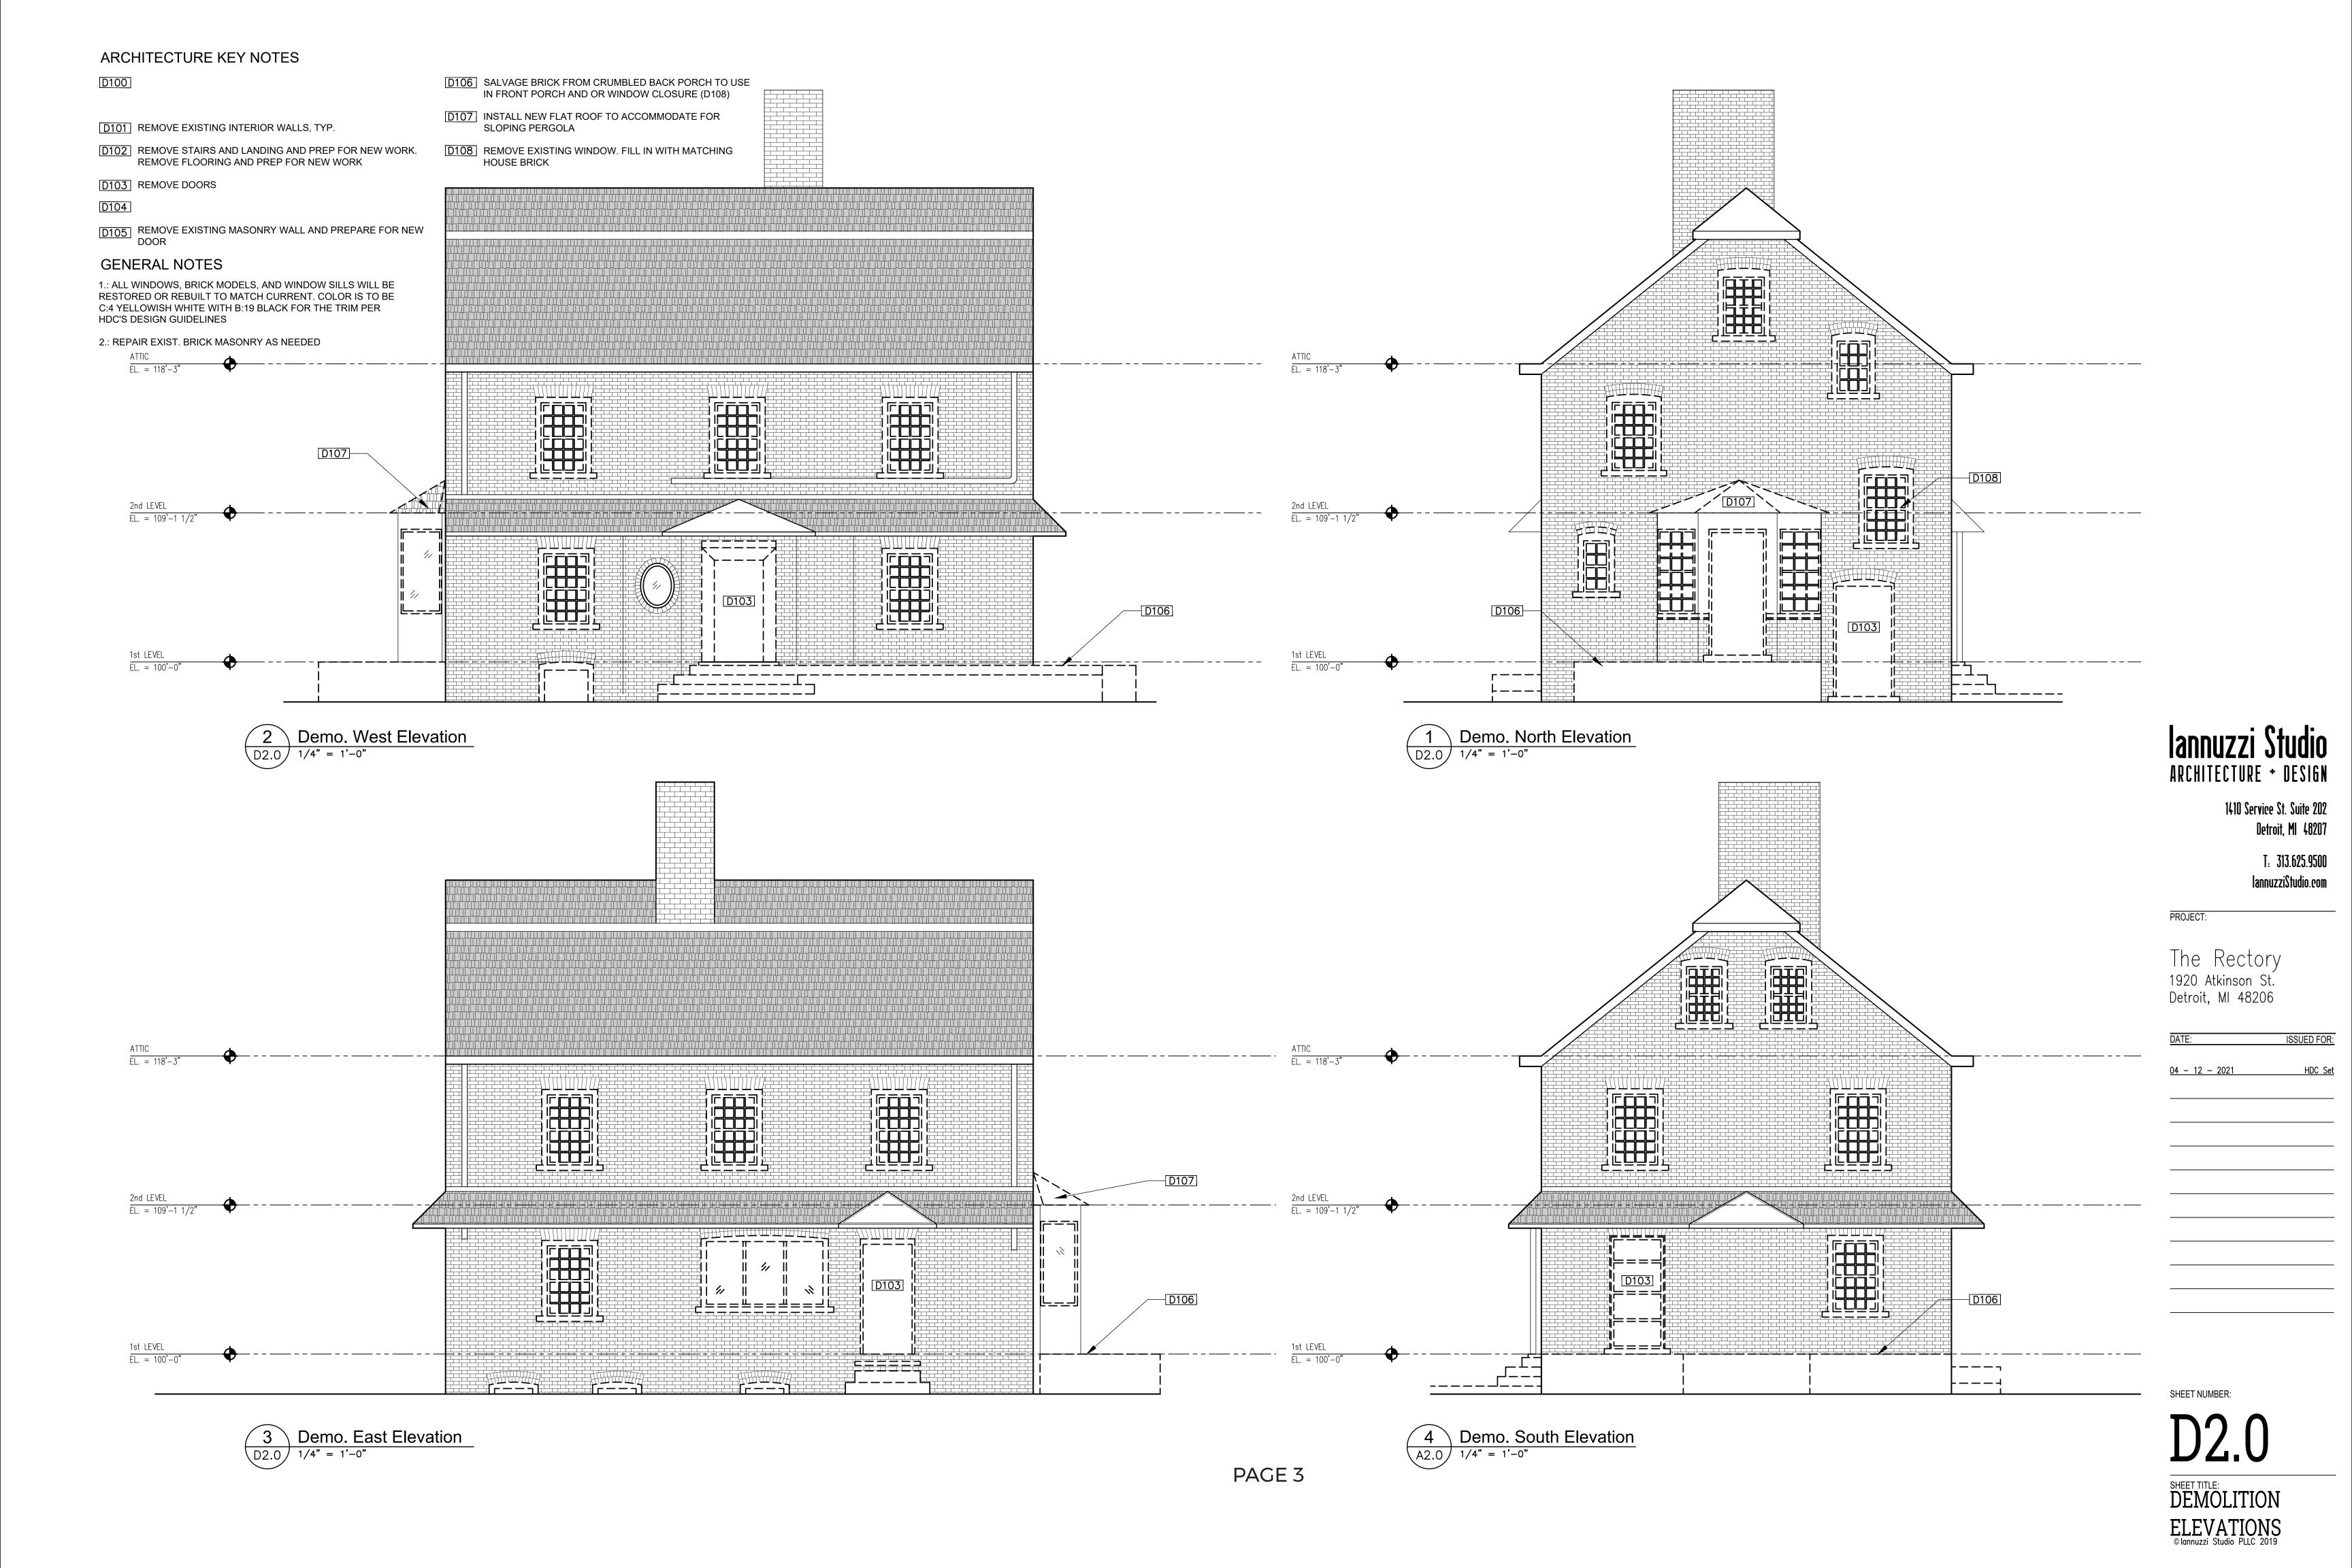

WALL KEY

EXISTING WALL TO REMAIN

NEW FULL HT WALL - SEE WALL TYPES FOR DETAILS

ARCHITECTURE KEY NOTES

A100 EXISTING MASONRY FIREPLACE & CHIMNEY

A101 FIRE-RATED WALL

A102

A103


A104 NEW DOOR


A105


A106


GENERAL NOTES


1.: ALL WINDOWS, BRICK MODELS, AND WINDOW SILLS WILL BE RESTORED OR REBUILT TO MATCH CURRENT. COLOR IS TO BE C:4 YELLOWISH WHITE WITH B:19 BLACK FOR THE TRIM PER HDC'S DESIGN GUIDELINES

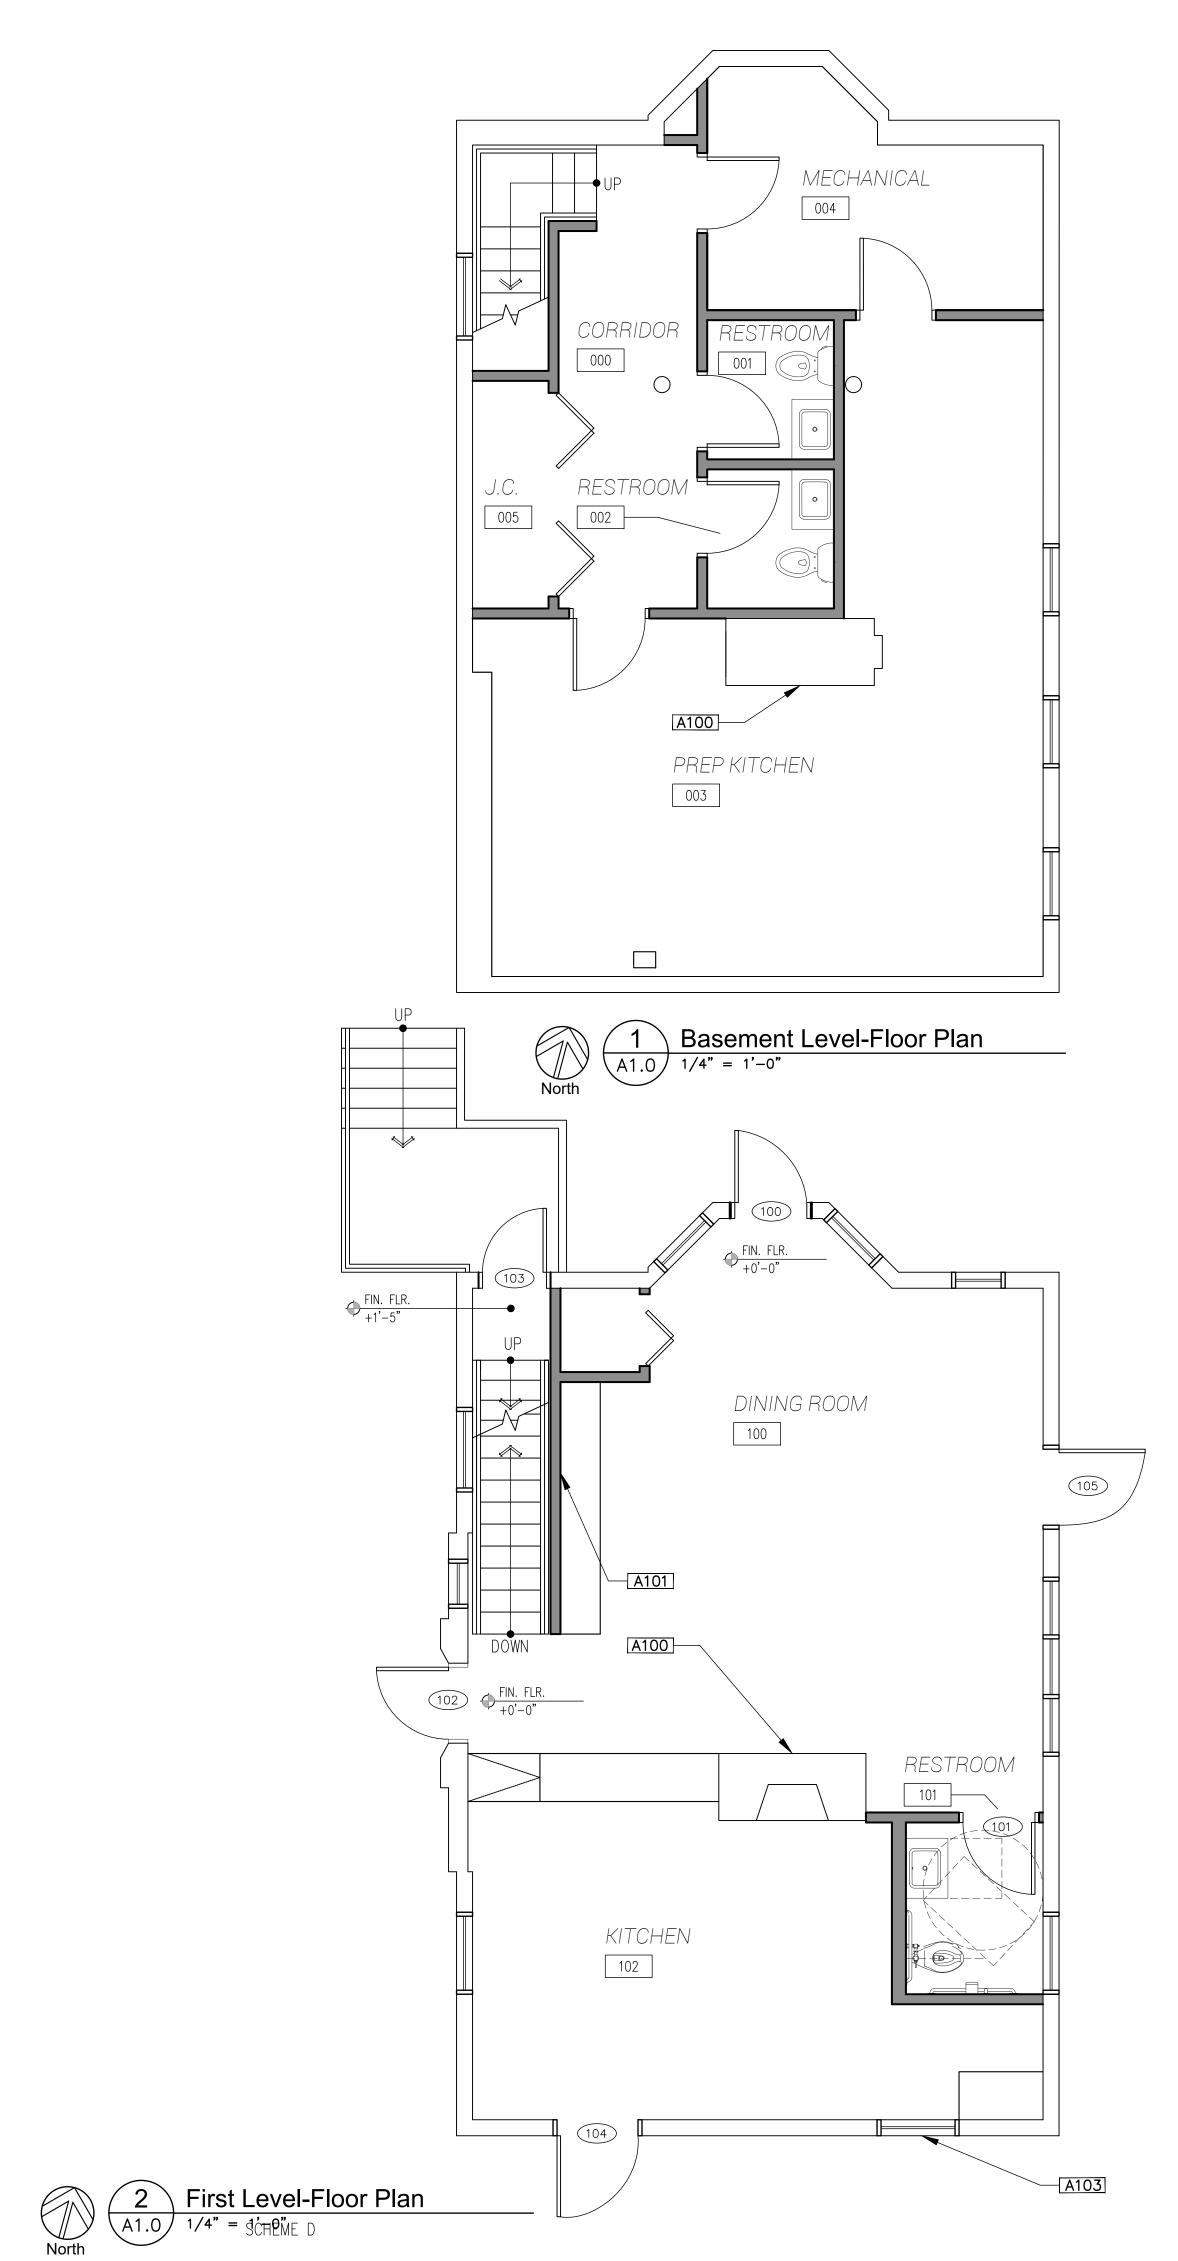

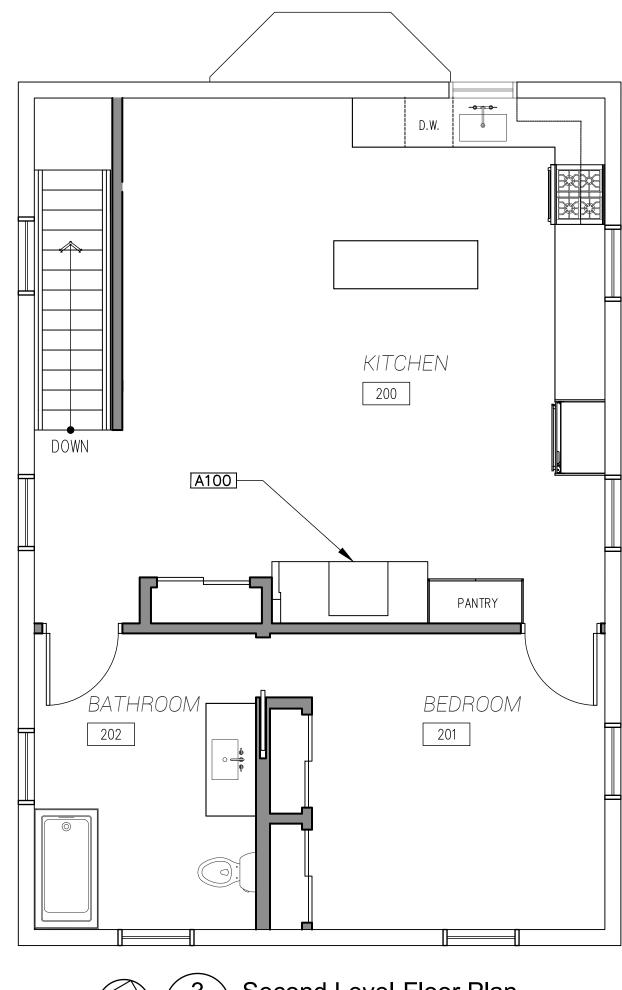

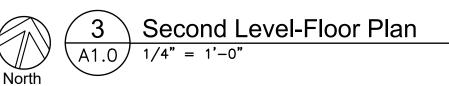

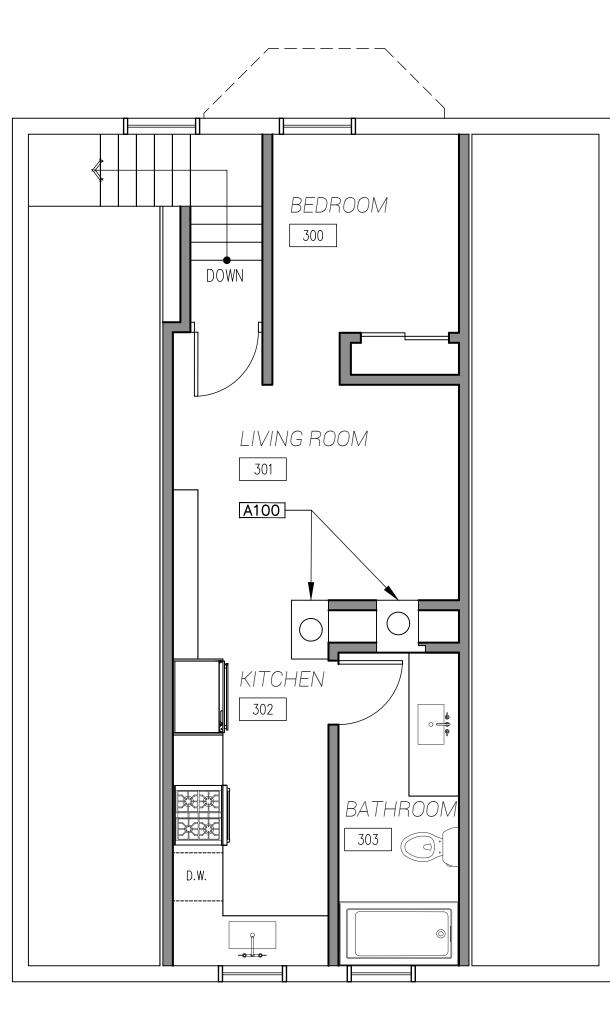

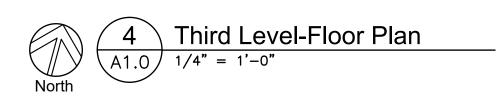

PAGE 4

lannuzzi Studio Architecture + design

1410 Service St. Suite 202 Detroit, Ml 48207

T. 313.625.9500 IannuzziStudio.com

PROJECT:

The Rectory 1920 Atkinson St. Detroit, MI 48206


| DATE: | ISSUED FOR: |
|----------------|-------------|
| | |
| 04 - 12 - 2021 | HDC Set |
| | |
| | |
SHEET NUMBER:

A1.0

SHEET TITLE:
FLOOR PLANS

© lannuzzi Studio PLLC 2019

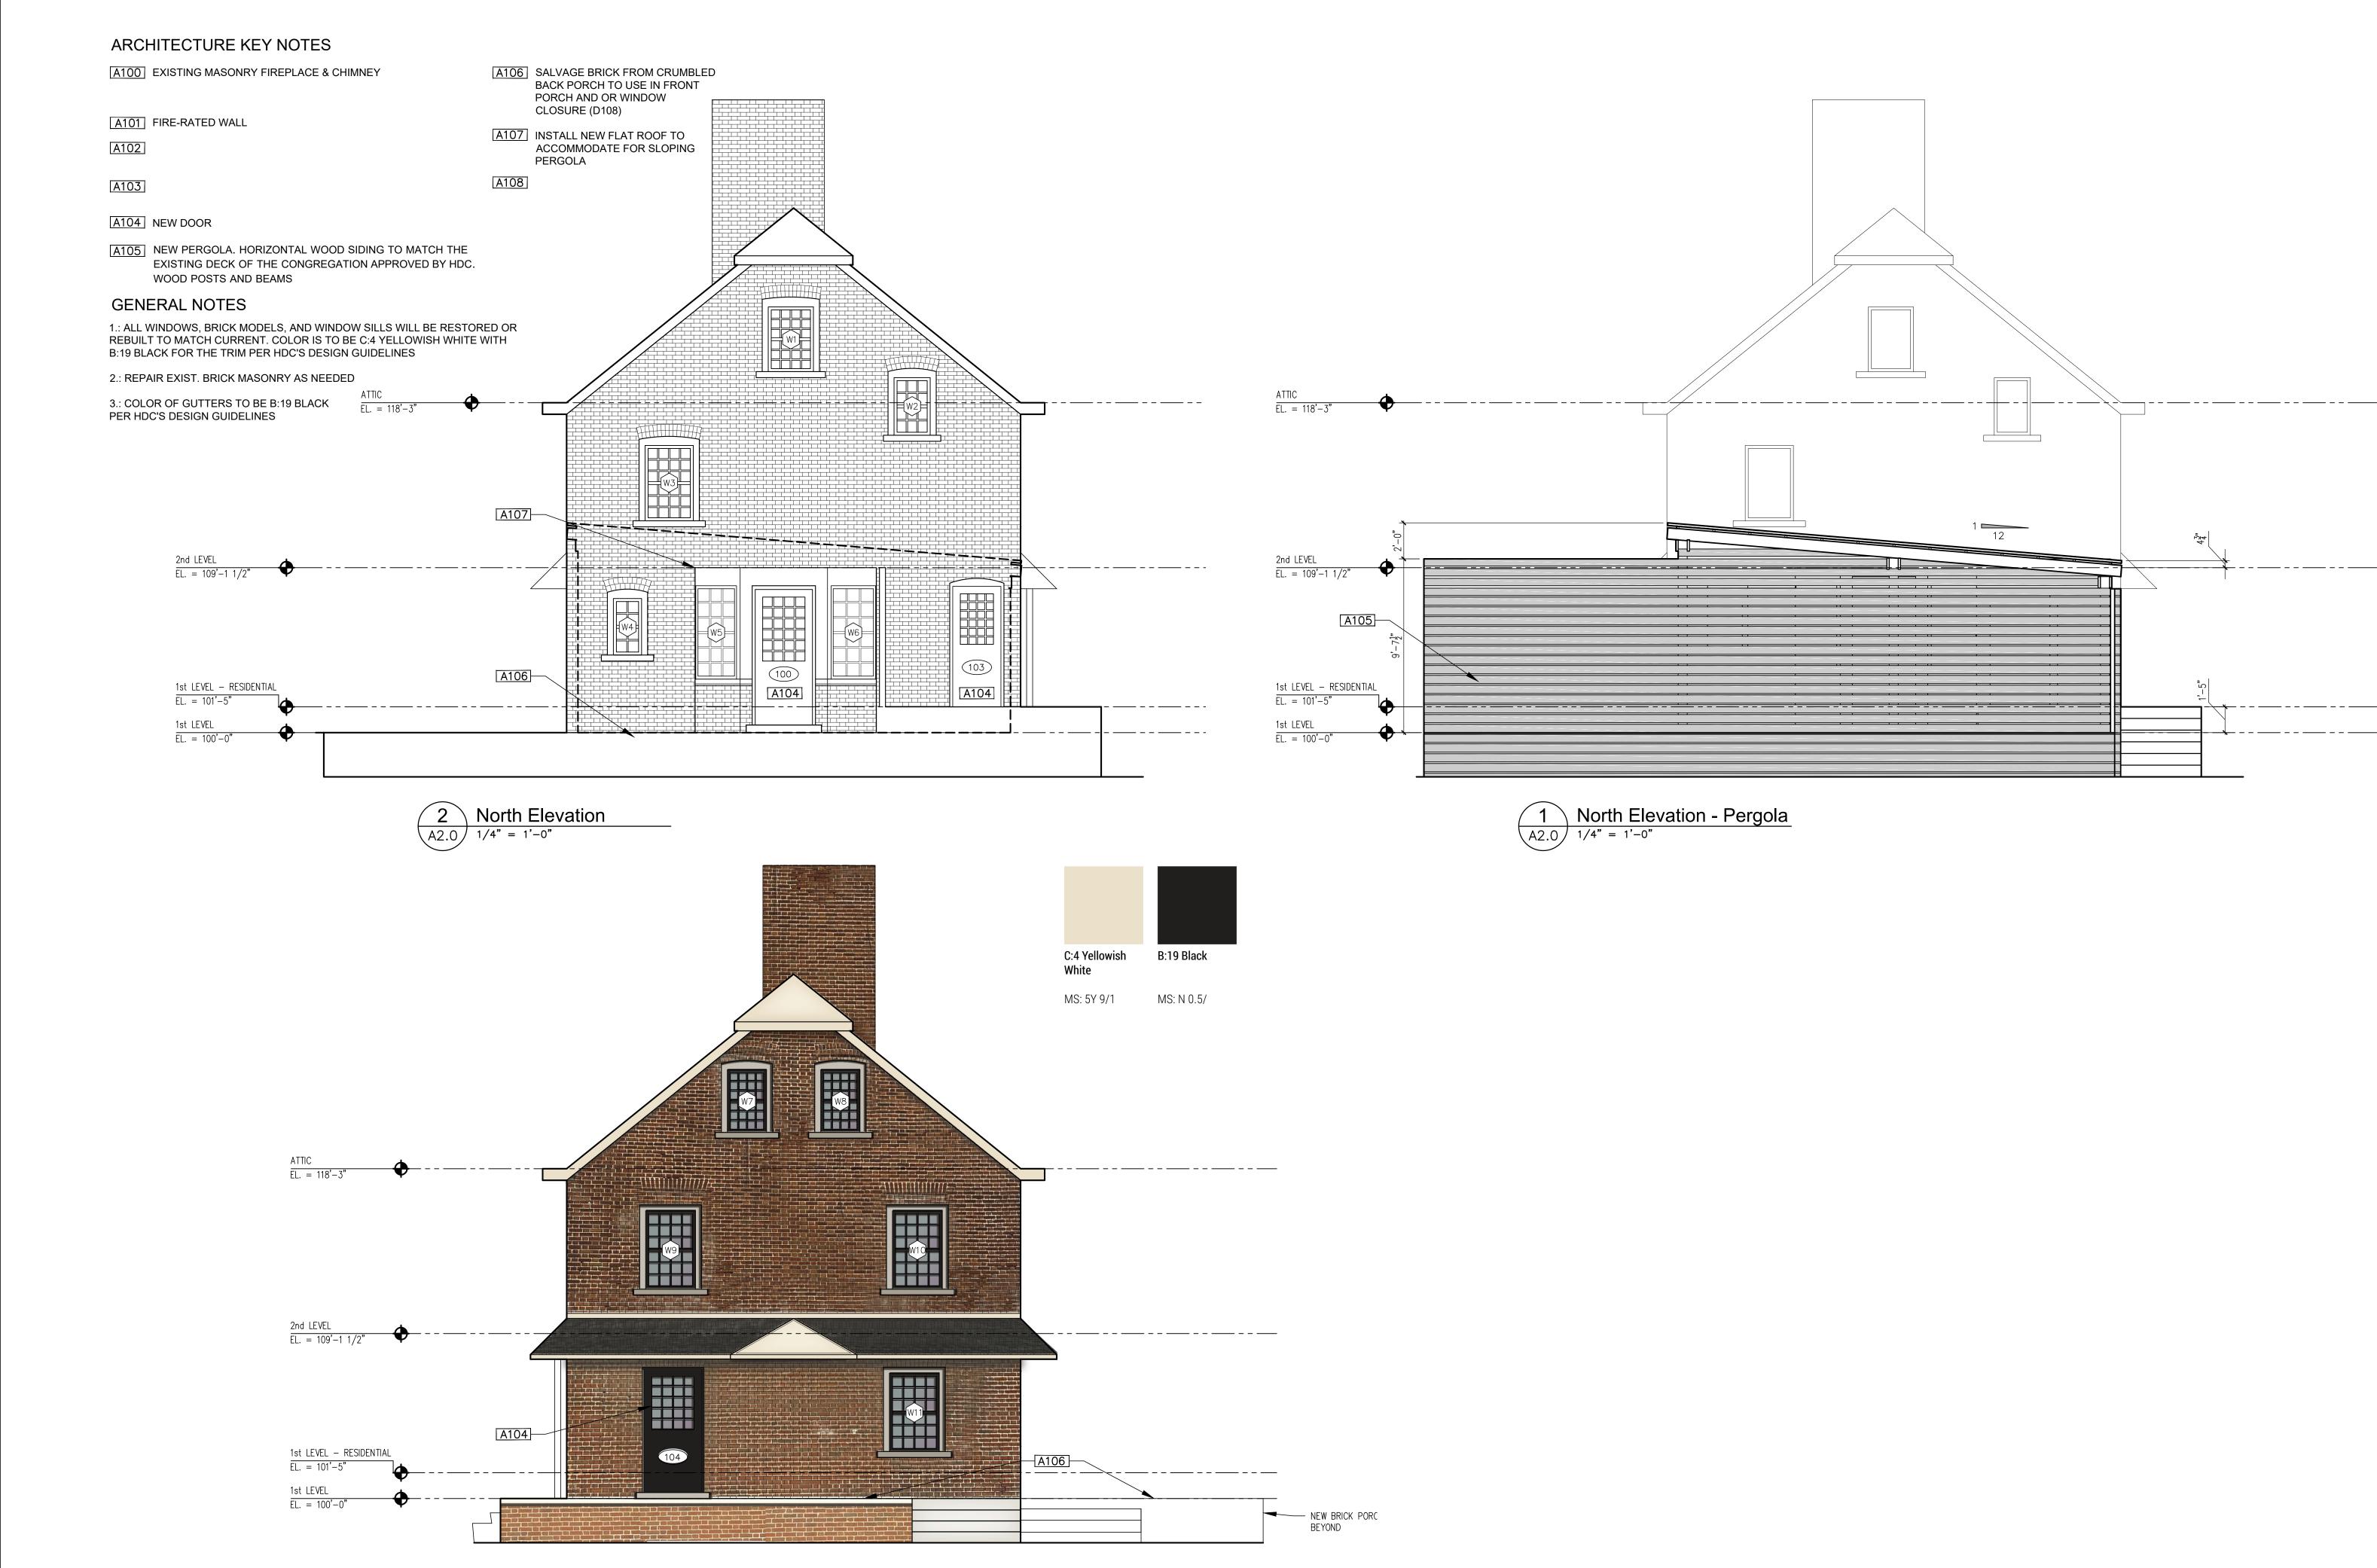

3 South Elevation
A2.0 1/4" = 1'-0"

lannuzzi Studio Architecture + design

> 1410 Service St. Suite 202 Detroit, MI 48207

> > T. 313.625.9500 lannuzziStudio.com

> > > ISSUED FOR:

PROJECT:

The Rectory 1920 Atkinson St. Detroit, MI 48206

| 04 - 12 - 2021 | HDC Set |
|----------------|---------|
| | |
| | |
| | |
| | |
| | |
| | |
| | |
| | |

SHEET NUMBER:

A2.0

SHEET TITLE: PROP. EXTERIOR

ELEVATIONS
© Iannuzzi Studio PLLC 2019

A100 EXISTING MASONRY FIREPLACE & CHIMNEY

A106 SALVAGE BRICK FROM CRUMBLED BACK PORCH TO USE IN FRONT PORCH AND OR WINDOW CLOSURE (D108)

A101 FIRE-RATED WALL

A107

A102

A103

A104 NEW DOOR


A105 NEW PERGOLA. HORIZONTAL WOOD SIDING TO MATCH THE EXISTING DECK OF THE CONGREGATION APPROVED BY HDC. WOOD POSTS AND BEAMS


GENERAL NOTES

1.: ALL WINDOWS, BRICK MODELS, AND WINDOW SILLS WILL BE RESTORED OR REBUILT TO MATCH CURRENT. COLOR IS TO BE C:4 YELLOWISH WHITE WITH B:19 BLACK FOR THE TRIM PER HDC'S DESIGN GUIDELINES

2.: REPAIR EXIST. BRICK MASONRY AS NEEDED

3.: COLOR OF GUTTERS TO BE B:19 BLACK PER HDC'S DESIGN GUIDELINES

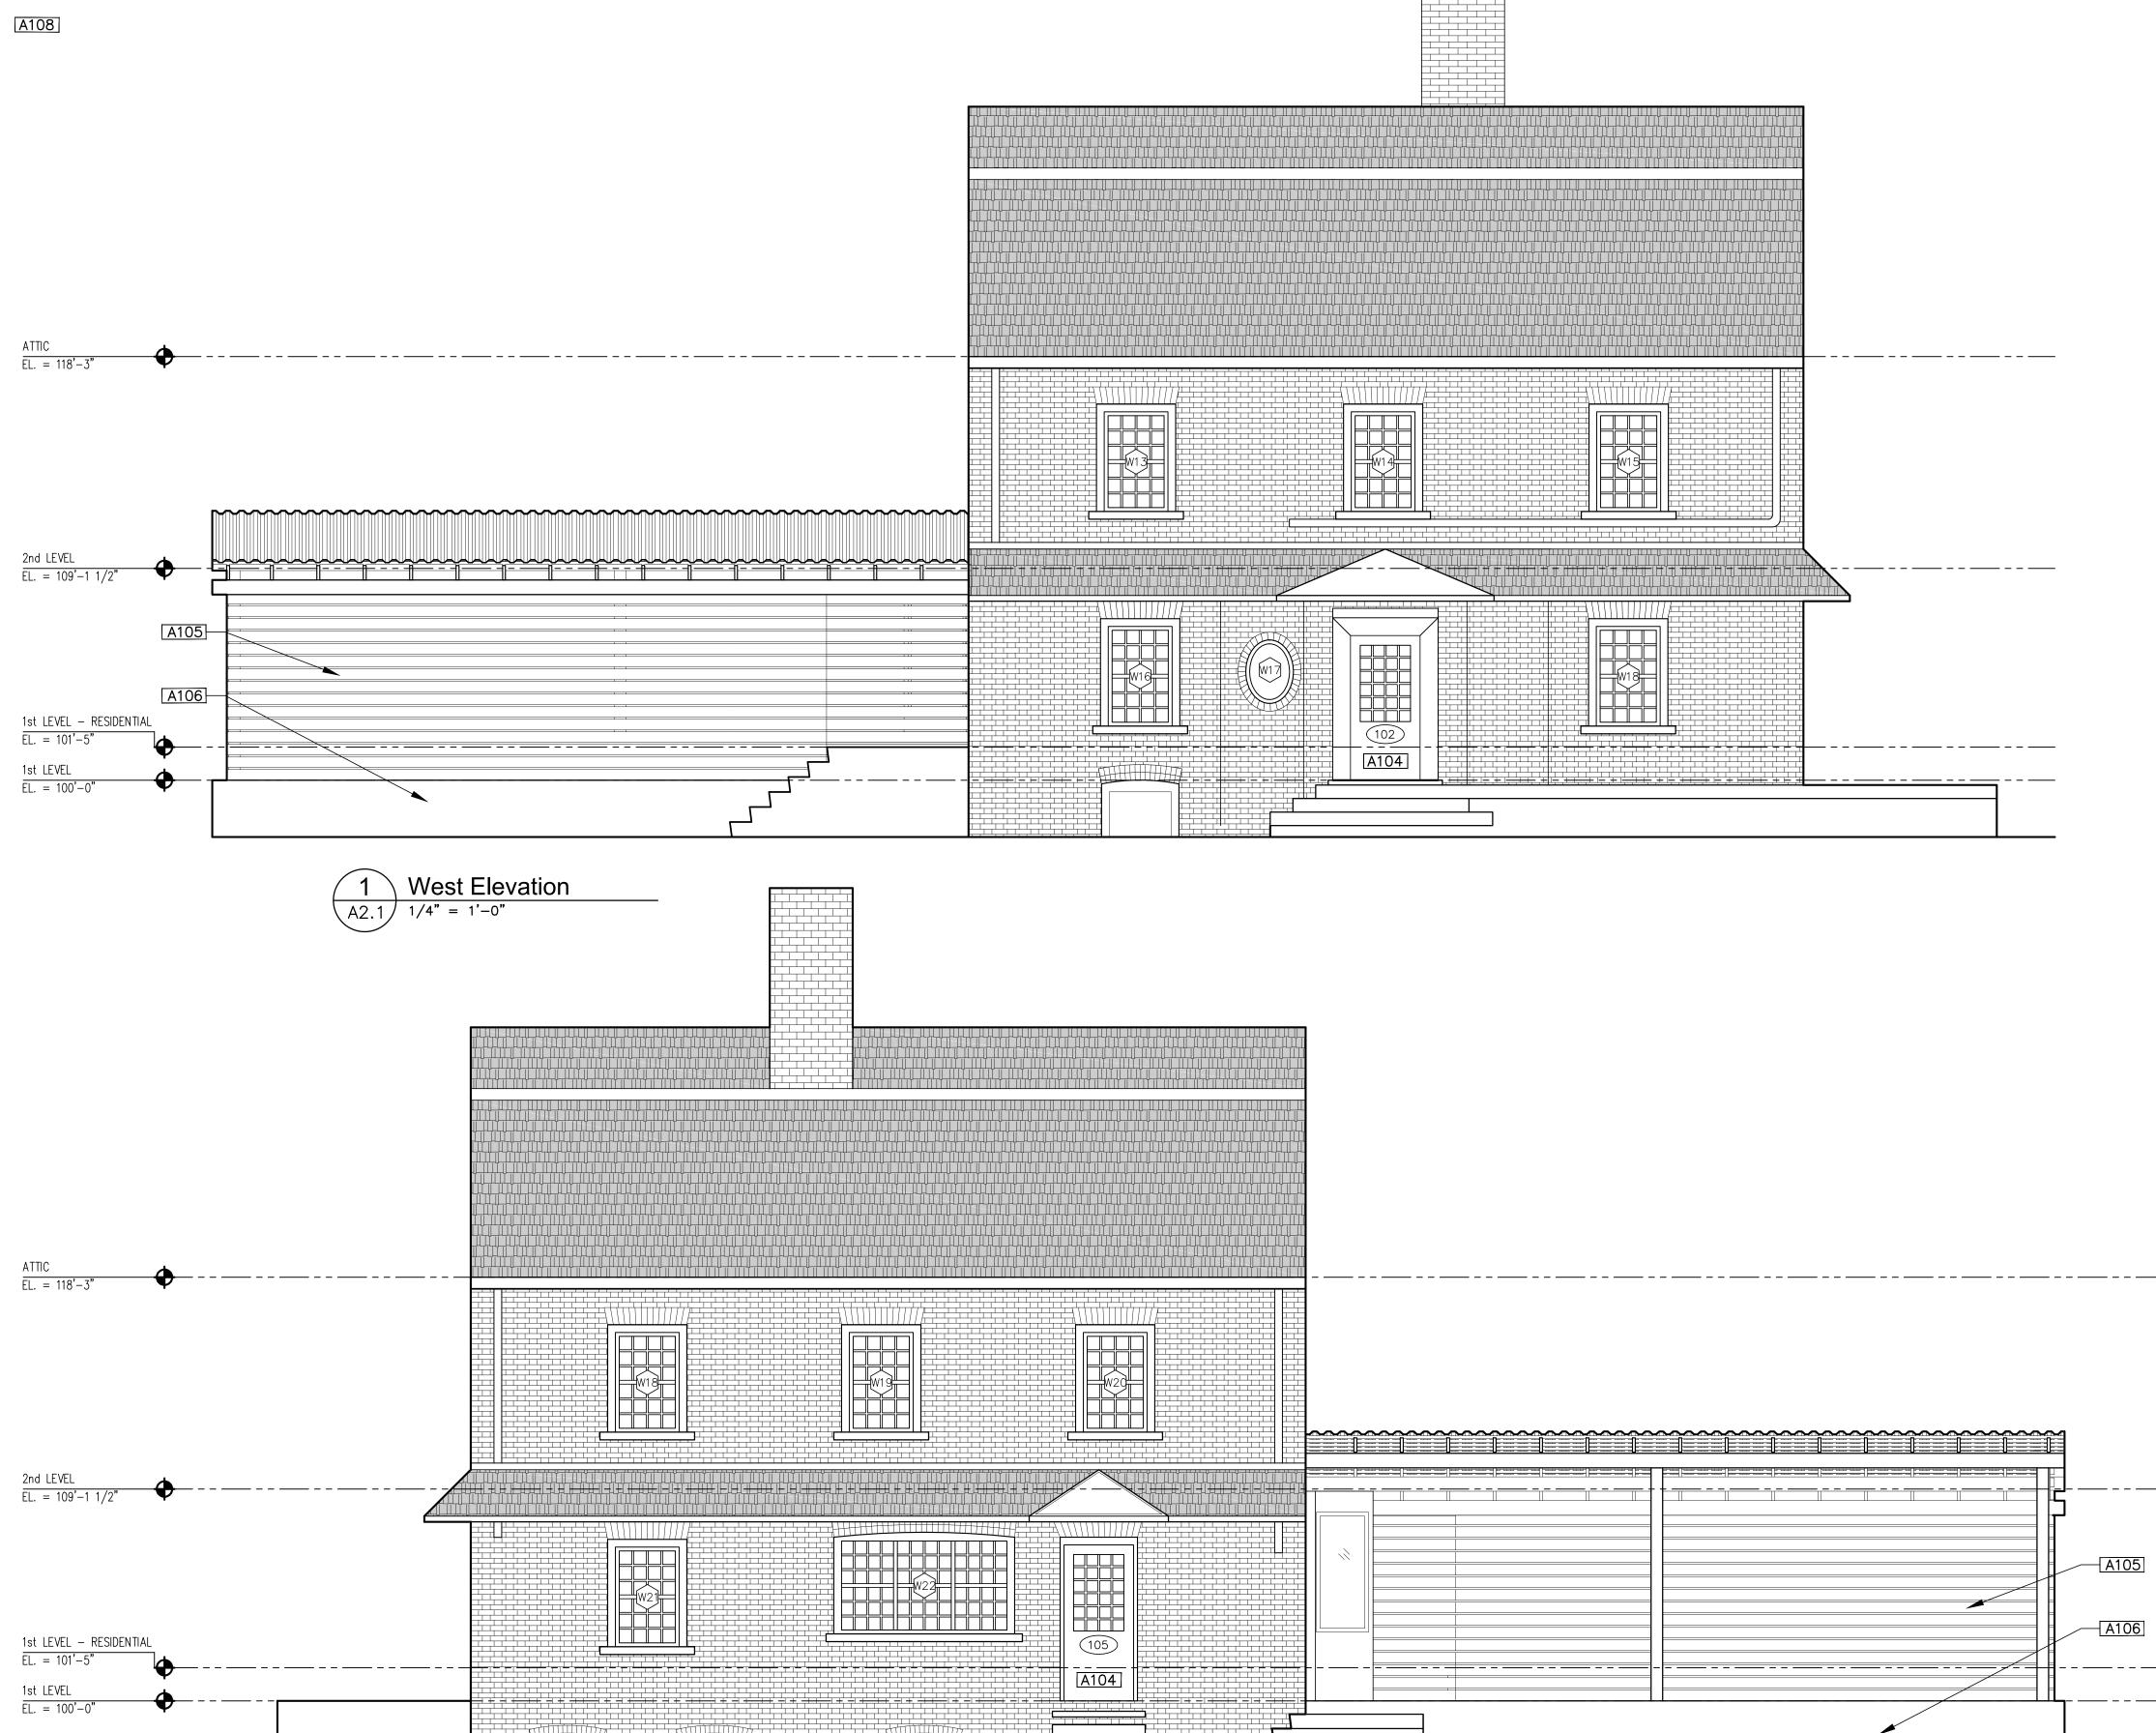

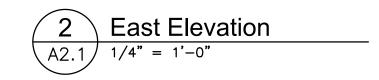

Iannuzzi Studio Architecture + design

1410 Service St. Suite 202 Detroit, MI 48207 T. 313.625.9500

lannuzziStudio.com

The Rectory 1920 Atkinson St. Detroit, MI 48206

PROJECT:

| JAIC. | 1990ED FOR. |
|-----------------------------------------------------------------|-------------|
| | |
| | |
| <u> 12 – 2021 – 2021 – </u> | HDC Set |
| | |
| | |
SHEET NUMBER:

A2.1

SHEET TITLE: PROP. EXTERIOR

ELEVATIONS
© Iannuzzi Studio PLLC 2019

| | | | WINDOW SC | HEDULE | | |
|-------|-------------------------------------------|-----------------|--------------|--------------|------------------------------------------------------------------------------------------------------------------|------------------------------------------------------------------------------------------------------------------------------------------------------------------------|
| LABEL | DIMENSIONS | LOCATION | OPERATION | MATERIAL | TRIM/SASH/SILL | COMMENTS |
| W1 | 2'-6" V.I.F. | NORTH ELEVATION | DOUBLE-HUNG | WOOD WINDOWS | REPAIRED TO MATCH EXIST. DIMENSIONS AND PROFILE; SEE ELEVATIONS FOR PROPOSED TRIM AND SASH COLORS | DETERIORATION: BROKEN GLASS PANES; ROTTED WOOD ON TRIM, SASH, AND SILL DUE TO YEARS OF NEGLECT LIGHT CONFIGURATION TO MATCH EXISTING WINDOW |
| W2 | 2'-0" V.I.F. | NORTH ELEVATION | DOUBLE-HUNG | WOOD WINDOWS | REPAIRED TO MATCH EXIST. DIMENSIONS AND PROFILE; SEE ELEVATIONS FOR PROPOSED TRIM AND SASH COLORS | DETERIORATION: OVER-CAULKED GLASS PANES; ROTTED WOOD ON TRIM, SASH, AND SILL DUE TO YEARS OF NEGLECT LIGHT CONFIGURATION TO MATCH EXISTING WINDOW |
| W3 | | NORTH ELEVATION | DOUBLE-HUNG | WOOD WINDOWS | REPAIRED TO MATCH | DETERIORATION: |
| ws | 2'-8" V.I.F. | NORTH ELEVATION | DOUBLE-HUNG | WOOD WINDOWS | EXIST. DIMENSIONS AND PROFILE; SEE ELEVATIONS FOR PROPOSED TRIM AND SASH COLORS | OVER-CAULKED GLASS PANES; ROTTED WOOD ON TRIM, SASH, AND SILL DUE TO YEARS OF NEGLECT LIGHT CONFIGURATION TO MATCH EXISTING WINDOW |
| W4 | 1'-6 ³ / ₄ " V.I.F. | NORTH ELEVATION | DOUBLE-HUNG | WOOD WINDOWS | REPAIRED TO MATCH EXIST. DIMENSIONS AND PROFILE; SEE ELEVATIONS FOR PROPOSED TRIM AND SASH COLORS | DETERIORATION: MISSING GLASS PANES; ROTTED WOOD ON TRIM, SASH, AND SILL DUE TO YEARS OF NEGLECT LIGHT CONFIGURATION TO MATCH EXISTING WINDOW |
| W5 | ,2'-10" V.I.F., | NORTH ELEVATION | DOUBLE-HUNG | WOOD WINDOWS | REPAIRED TO MATCH | DETERIORATION: MISSING |
| | 5′-2″ V.I.F. | NOINT ELEVATION | BOODEE HOIVE | Weed Windows | EXIST. DIMENSIONS AND PROFILE; SEE ELEVATIONS FOR PROPOSED TRIM AND SASH COLORS | GLASS PANES; ROTTED WOOD ON TRIM, SASH, AND SILL DUE TO YEARS OF NEGLECT LIGHT CONFIGURATION TO MATCH EXISTING WINDOW |
| W6 | 2'-10" V.I.F. | NORTH ELEVATION | DOUBLE-HUNG | WOOD WINDOWS | REPAIRED TO MATCH EXIST. DIMENSIONS AND PROFILE; SEE ELEVATIONS FOR PROPOSED TRIM AND | DETERIORATION: MISSING GLASS PANES; ROTTED WOOD ON TRIM, SASH, AND SILL DUE TO YEARS OF NEGLECT |
| W7 | 2, - 2, - | SOUTH ELEVATION | DOUBLE-HUNG | WOOD WINDOWS | SASH COLORS REPAIRED TO MATCH | LIGHT CONFIGURATION TO MATCH EXISTING WINDOW DETERIORATION: |
| | 2'-2" V.I.F. | | | | EXIST. DIMENSIONS AND PROFILE; SEE ELEVATIONS FOR PROPOSED TRIM AND SASH COLORS | OVER-CAULKED GLASS PANES; MISSING GLASS PANE; ROTTED WOOD ON TRIM, SASH, AND SILL DUE TO YEARS OF NEGLECT LIGHT CONFIGURATION TO MATCH EXISTING WINDOW |
| W8 | 2'-2" V.I.F. | SOUTH ELEVATION | DOUBLE-HUNG | WOOD WINDOWS | REPAIRED TO MATCH EXIST. DIMENSIONS AND PROFILE; SEE ELEVATIONS FOR PROPOSED TRIM AND SASH COLORS | DETERIORATION: OVER-CAULKED GLASS PANES; MISSING GLASS PANES; ROTTED WOOD ON TRIM, SASH, AND SILL DUE TO YEARS OF NEGLECT LIGHT CONFIGURATION TO MATCH EXISTING WINDOW |
| | * | | | | | |
| W9 | 76, A1. | SOUTH ELEVATION | DOUBLE-HUNG | WOOD WINDOWS | REPAIRED TO MATCH EXIST. DIMENSIONS AND PROFILE; SEE ELEVATIONS FOR PROPOSED TRIM AND SASH COLORS | DETERIORATION: MISSING GLASS PANES; ROTTED WOOD ON TRIM, SASH, AND SILL DUE TO YEARS OF NEGLECT LIGHT CONFIGURATION TO MATCH EXISTING WINDOW |
| | | | | | | |
| W10 | 2'-9" V.I.F. | SOUTH ELEVATION | DOUBLE-HUNG | WOOD WINDOWS | REPAIRED TO MATCH EXIST. DIMENSIONS AND PROFILE; SEE ELEVATIONS FOR PROPOSED TRIM AND SASH COLORS | DETERIORATION: MISSING GLASS PANES; ROTTED WOOD ON TRIM, SASH, AND SILL DUE TO YEARS OF NEGLECT LIGHT CONFIGURATION TO |
| | _4 | | | | | MATCH EXISTING WINDOW |
| W11 | 2'-9" V.I.F. | SOUTH ELEVATION | DOUBLE-HUNG | WOOD WINDOWS | REPAIRED TO MATCH EXIST. DIMENSIONS AND PROFILE; SEE ELEVATIONS FOR PROPOSED TRIM AND SASH COLORS | DETERIORATION: MISSING GLASS PANES; ROTTED WOOD ON TRIM, SASH, AND SILL DUE TO YEARS OF NEGLECT LIGHT CONFIGURATION TO MATCH EXISTING WINDOW |
| | | | | | | |
| W12 | 2'-9" V.I.F. | WEST ELEVATION | DOUBLE-HUNG | WOOD WINDOWS | REPAIRED TO MATCH EXIST. DIMENSIONS AND PROFILE; SEE ELEVATIONS FOR PROPOSED TRIM AND SASH COLORS | DETERIORATION: OVER-CAULKED GLASS PANES; ROTTED WOOD ON TRIM, SASH, AND SILL DUE TO YEARS OF NEGLECT LIGHT CONFIGURATION |
| | | | | | | TO MATCH EXISTING WINDOW |

| | I | | WINDOW SCHI | | | I |
|--------------|---------------|-------------------------|----------------------------------------------|-----------------------|-------------------------------------------------------------------------------------------------------------------|------------------------------------------------------------------------------------------------------------------------------------|
| LABEL W13 | 2'-9" V.I.F. | LOCATION WEST ELEVATION | OPERATION DOUBLE-HUNG | MATERIAL WOOD WINDOWS | TRIM/SASH/SILL REPAIRED TO MATCH EXIST. DIMENSIONS AND PROFILE; SEE ELEVATIONS FOR PROPOSED TRIM AND SASH COLORS | COMMENTS DETERIORATION: MISSING GLASS PANES OVER-CAULKED GLASS PANES; ROTTED WOOD ON TRIM, SASH, AND SILL DUE TO YEARS OF NEGLECT |
| | | | | | | LIGHT CONFIG. TO MATCH EXIST. WINDO |
| W14 | 2'-9" V.I.F. | WEST ELEVATION | DOUBLE-HUNG | WOOD WINDOWS | REPAIRED TO MATCH EXIST. DIMENSIONS AND PROFILE; SEE ELEVATIONS FOR PROPOSED TRIM AND SASH COLORS | DETERIORATION: MISSING GLASS PANE OVER-CAULKED GLAS PANES; ROTTED WOO ON TRIM, SASH, AND SILL DUE TO YEARS O NEGLECT |
| W15 | 2'-9" V.I.F. | WEST ELEVATION | DOUBLE-HUNG | WOOD WINDOWS | REPAIRED TO MATCH EXIST. DIMENSIONS AND PROFILE; SEE ELEVATIONS FOR PROPOSED TRIM AND SASH COLORS | LIGHT CONFIG. TO MATCH EXIST. WINDO' DETERIORATION: MISSING GLASS PANE ROTTED WOOD ON TRIM, SASH, AND SILL DUE TO YEARS OF NEGLECT |
| | ,4 | | | | | LIGHT CONFIG. TO MATCH EXIST. WINDO |
| W16 | 2'-0½" V.I.F. | WEST ELEVATION | FIXED | WOOD WINDOWS | REPAIRED TO MATCH EXIST. DIMENSIONS AND PROFILE; SEE ELEVATIONS FOR PROPOSED TRIM AND SASH COLORS | DETERIORATION: ROTTED WOOD ON TRIM, SASH, AND SILL DUE TO YEARS OF NEGLECT LIGHT CONFIG. TO MATCH EXIST. WINDO |
| W17 | 2'-9" V.I.F. | WEST ELEVATION | DOUBLE-HUNG | WOOD WINDOWS | REPAIRED TO MATCH EXIST. DIMENSIONS AND PROFILE; SEE ELEVATIONS FOR PROPOSED TRIM AND SASH COLORS | DETERIORATION: MISSING GLASS PANE ROTTED WOOD ON TRIM, SASH, AND SILL DUE TO YEARS OF NEGLECT LIGHT CONFIG. TO |
| | | | | | | MATCH EXIST. WINDO |
| W18 | 2,-9, A'I'E' | EAST ELEVATION | DOUBLE-HUNG | WOOD WINDOWS | REPAIRED TO MATCH EXIST. DIMENSIONS AND PROFILE; SEE ELEVATIONS FOR PROPOSED TRIM AND SASH COLORS | DETERIORATION: MISSING GLASS PANE ROTTED WOOD ON TRIM, SASH, AND SILL DUE TO YEARS OF NEGLECT LIGHT CONFIG. TO |
| | 4 | | | | | MATCH EXIST. WINDO |
| W19 | 2'-9" V.I.F. | EAST ELEVATION | DOUBLE-HUNG | WOOD WINDOWS | REPAIRED TO MATCH EXIST. DIMENSIONS AND PROFILE; SEE ELEVATIONS FOR PROPOSED TRIM AND SASH COLORS | DETERIORATION: ROTTED WOOD ON TRIM, SASH, AND SILL DUE TO YEARS OF NEGLECT LIGHT CONFIG. TO MATCH EXIST. WINDO |
| W20 | 2'-9" V.I.F. | EAST ELEVATION | DOUBLE-HUNG | WOOD WINDOWS | REPAIRED TO MATCH EXIST. DIMENSIONS AND PROFILE; SEE ELEVATIONS FOR PROPOSED TRIM AND SASH COLORS | DETERIORATION: MISSING GLASS PANE ROTTED WOOD ON TRIM, SASH, AND SILL DUE TO YEARS OF NEGLECT |
| | 4 | | | | | LIGHT CONFIG. TO MATCH EXIST. WINDO |
| W21 | 2'-9" V.I.F. | EAST ELEVATION | DOUBLE-HUNG | WOOD WINDOWS | REPAIRED TO MATCH EXIST. DIMENSIONS AND PROFILE; SEE ELEVATIONS FOR PROPOSED TRIM AND SASH COLORS | DETERIORATION: MISSING GLASS PANE ROTTED WOOD ON TRIM, SASH, AND SILL DUE TO YEARS OF NEGLECT |
| | 4 | | | | | LIGHT CONFIG. TO MATCH EXIST. WINDO |
| W22 | 7'-1½" V.I.F. | EAST ELEVATION | FIXED CENTER; LEFT AND RIGHT CRANK OUT | WOOD WINDOWS | REPAIRED TO MATCH EXIST. DIMENSIONS AND PROFILE; SEE ELEVATIONS FOR PROPOSED TRIM AND SASH COLORS | DETERIORATION: MISSING GLASS PANE ROTTED WOOD ON TRIM, SASH, AND SILL DUE TO YEARS OF NEGLECT |
| | | | | | | LIGHT CONFIG. TO MATCH EXIST. WINDO |
| | | | | | | |
| | | | | | | |

| | | EXTERIO | R DOOR SCHEDULE | | | |
|-------|---------------|-----------------|-----------------|---------------------------------------------------------------------------------------------------------|------------------------------------------------------------------------------------------------------------------------------------------------------------------------|--|
| LABEL | DIMENSIONS | LOCATION | MATERIAL | TRIM | COMMENTS | |
| 100 | 3'-2" V.I.F. | NORTH ELEVATION | FIBERGLASS | REPLACED TO MATCH EXIST. DIMENSIONS AND PROFILE; SEE ELEVATIONS FOR PROPOSED TRIM COLORS | DETERIORATION: BOARDED UP OPENING NO DOOR IN PLACE COMMERCIAL GRADE MULTI-GRADE DOOR TO MATCH WINDOW'S DESIGN MAIN ENTRANCE TO RESTAURANT | |
| 102 | 3'-0" V.I.F. | WEST ELEVATION | FIBERGLASS | REPLACED TO MATCH EXIST. DIMENSIONS AND PROFILE; SEE ELEVATIONS FOR PROPOSED TRIM COLORS | DETERIORATION: WOOD DOOR IN EXTREMELY POOR SHAPE COMMERCIAL GRADE MULTI-GRADE DOOR TO MATCH WINDOW'S DESIGN SECONDARY ENTRANCE TO RESTAURANT | |
| 103 | 2'-8" V.I.F. | NORTH ELEVATION | FIBERGLASS | REPLACED TO MATCH EXIST. DIMENSIONS AND PROFILE; SEE ELEVATIONS FOR PROPOSED TRIM COLORS | DETERIORATION: WOO DOOR IN EXTREMELY POOR SHAPE COMMERCIAL GRADE OR NEAR COMMERCIAL GRADE MULTI-GRADE DOOR TO MATCH WINDOW'S DESIGN ENTRANCE FOR RESIDENTIAL TENANT/ | |
| 104 | 3'-2½" V.I.F. | SOUTH ELEVATION | FIBERGLASS | REPLACED TO MATCH EXIST. DIMENSIONS AND PROFILE; SEE ELEVATIONS FOR PROPOSED TRIM COLORS | NON-OPERABLE; NO HARDWARE TO MATCH WINDOW'S DESIGN | |
| 105 | 3'-0" V.I.F. | EAST ELEVATION | FIBERGLASS | REPLACED TO MATCH EXIST. DIMENSIONS AND PROFILE; SEE ELEVATIONS FOR PROPOSED TRIM COLORS | NON-OPERABLE; NO HARDWARE TO MATCH WINDOW'S DESIGN | |

Iannuzzi Studio ARCHITECTURE + DESIGN 1410 Service St. Suite 202 Detroit, MI 48207 T: 313.625.9500 IannuzziStudio.com

DDO IECT:

The Rectory 1920 Atkinson St. Detroit, MI 48206


DATE: 1550ED

SHEET NUMBER:

A7.0

SHEET TITLE:
Door, Window &
Finish Schedule
© Iannuzzi Studio PLLC 2019

SITE PHOTOS

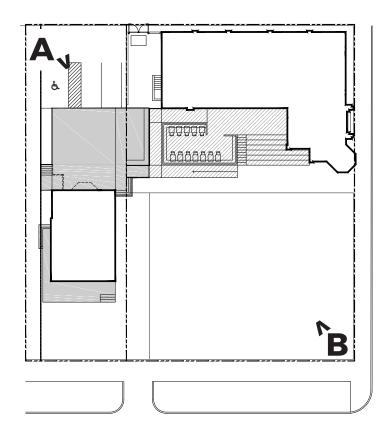







B-FRONT CORNER OF THE SITE

EXISTING ELEVATIONS







NORTH ELEVATION

REMOVING WINDOW TO
MOVE DOOR 103 UP FOR
NEW PATIO - SEE
ELEVATIONS AND PLANS



SOUTH ELEVATION



SOUTH ELEVATION

EXISTING ELEVATIONS









WEST ELEVATION EAST ELEVATION

EXISTING DETAILS







PORCHES

SALVAGE BRICK FROM CRUMBLED BACK PORCH TO USE IN FRONT PORCH AND OR WINDOW CLOSURE (D108)







WINDOWS


ALL WINDOWS, BRICK MODELS, AND WINDOW SILLS WILL BE RESTORED OR REBUILT TO MATCH CURRENT. COLOR IS TO BE C:4 YELLOWISH WHITE WITH B:19 BLACK FOR THE TRIM PER HDC'S DESIGN GUIDELINES



GUTTERS


COLOR OF GUTTERS TO BE B:19 BLACK PER HDC'S DESIGN GUIDELINES

EXISTING DETAILS

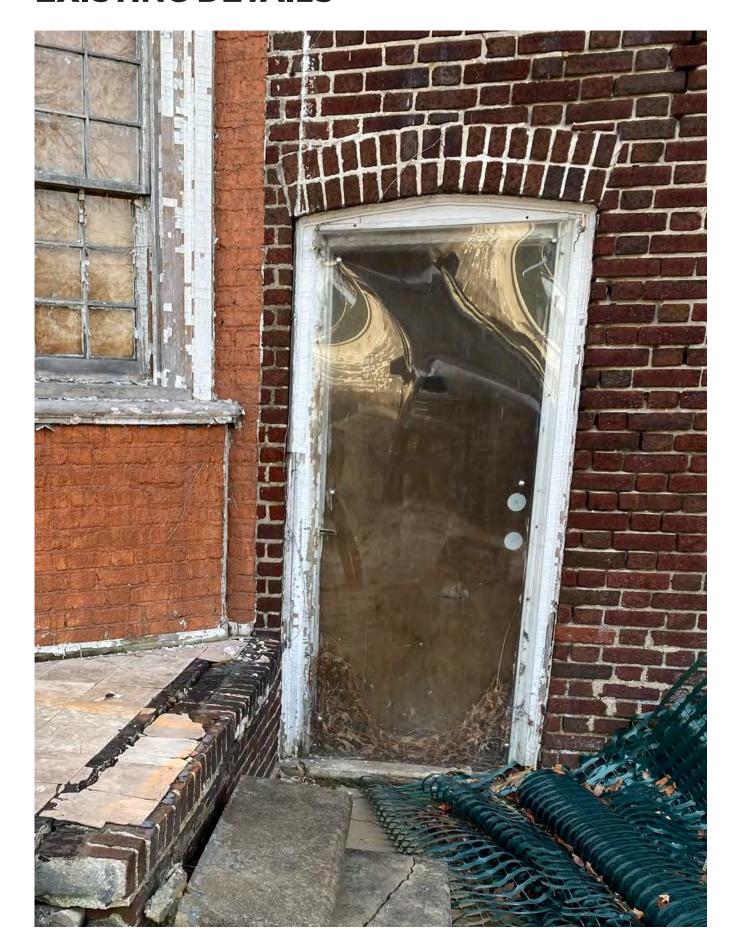


DOOR A - NEW DOOR SILL HEIGHT AND DOOR (103) FOR RESIDENTIAL TENANTS - SEE DOOR SCHEDULE FOR DETAILS

EXISTING MATERIAL: WOOD

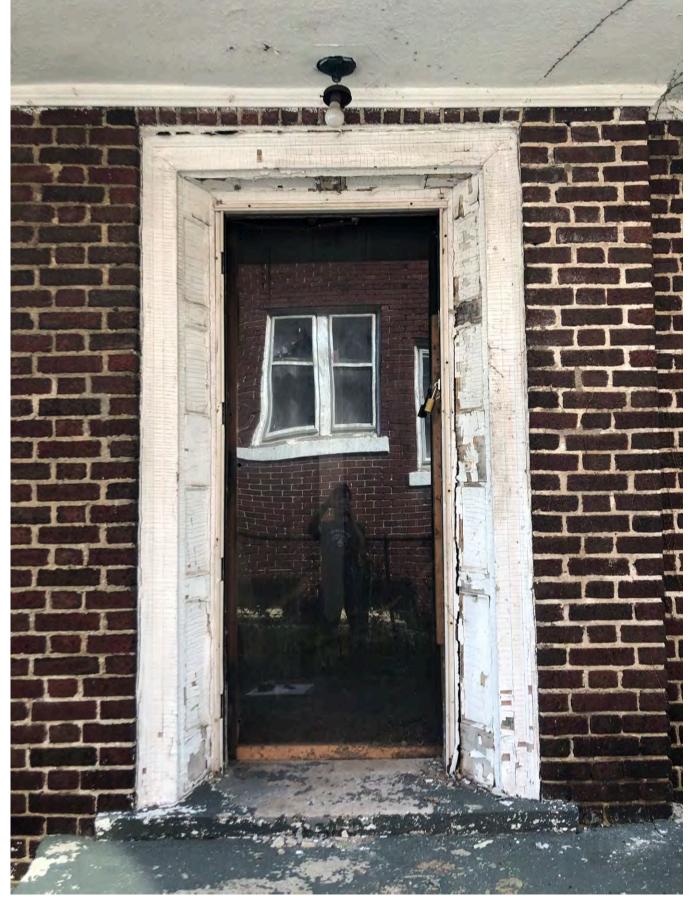


DOOR B - NEW DOOR (102) FOR SECONDARY ENTRANCE TO RESTAURANT - SEE DOOR SCHEDULE FOR DETAILS

EXISTING MATERIAL: WOOD; CURRENT DOOR IS MISSING AND IS HELD BY AN ACRYLIC PIECE

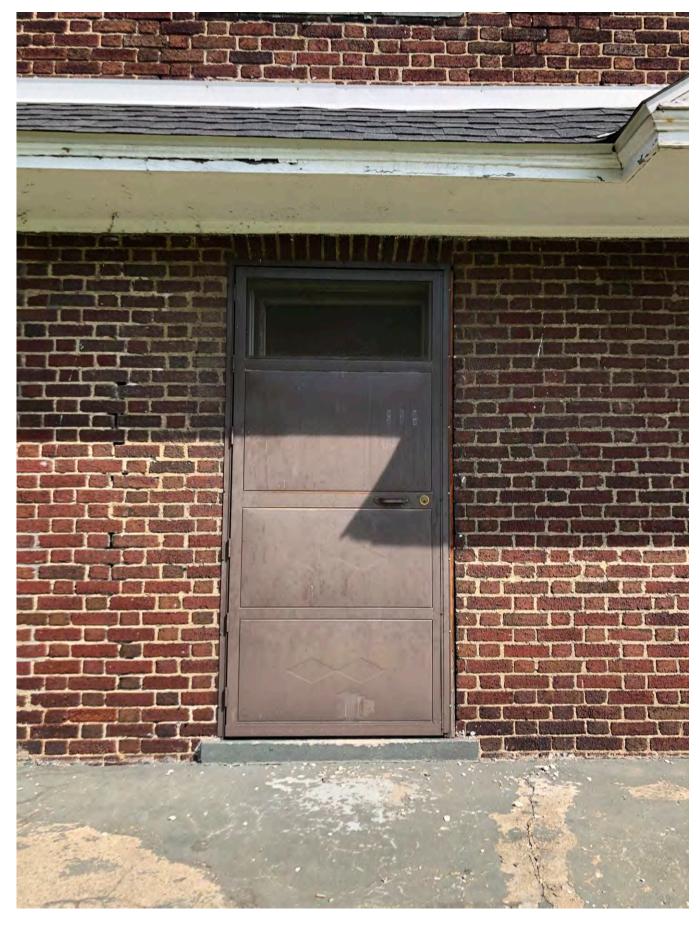

DOOR C - NEW DOOR (104) - SEE DOOR SCHEDULE FOR DETAILS

EXISTING MATERIAL: METAL

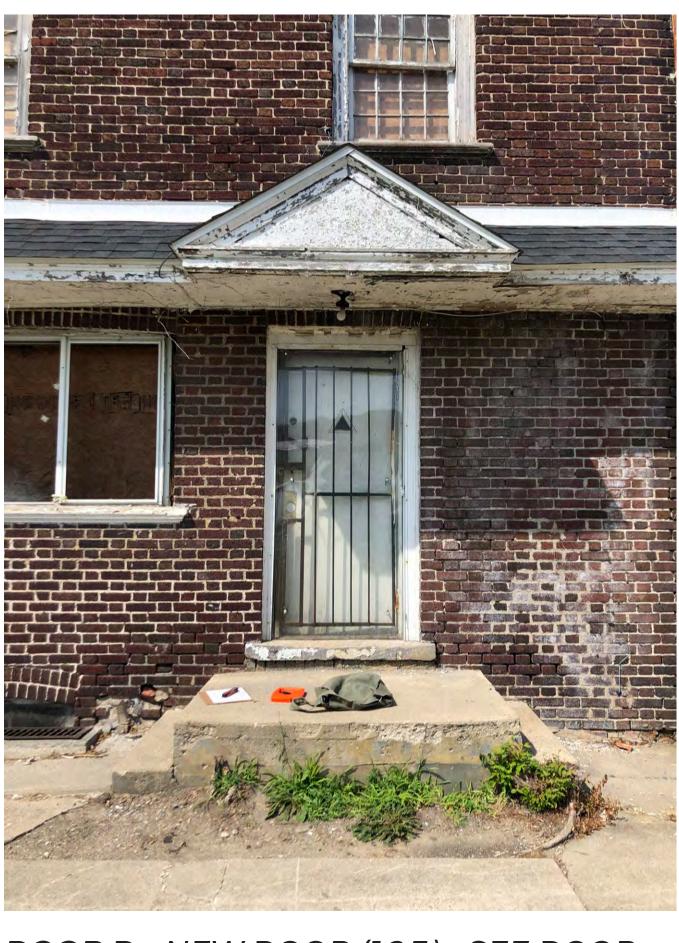

DOOR D - NEW DOOR (105) - SEE DOOR SCHEDULE FOR DETAILS

EXISTING MATERIAL: WOOD

DOORS


ALL EXTERIOR NON-HISTORIC DOORS TO BE REPLACED.

NORTH ELEVATION DOOR TO BE RELOCATED. SEE PROPOSED ELEVATIONS AND DOOR SCHEDULE.

THE DOOR WOOD TRIMS ARE ROTTED AND NEED TO BE REPLACED AS WELL. BECAUSE THE FIRST FLOOR WILL BE A COMMERCIAL SPACE, ALL EXISTING DOORS ARE NOT TO CODE AND MUST SWING OUT. NEW DOORS WILL MIMIC ADJACENT WINDOW DESIGN.

PERGOLA PROPOSAL + RAILING



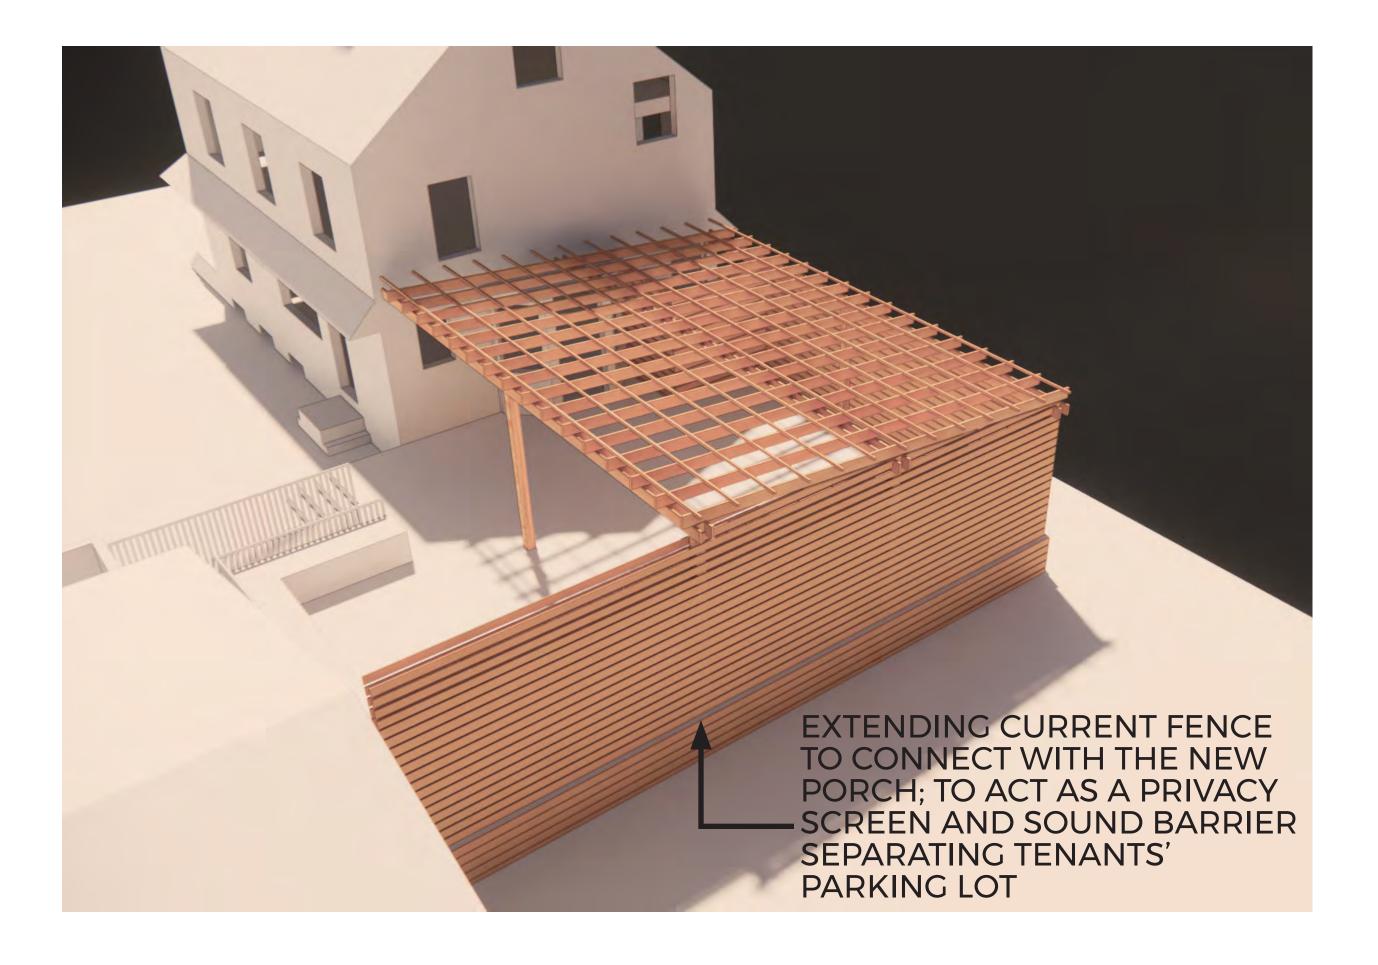





PERGOLA PROPOSAL





