

STAFF REPORT 10-9-2019 MEETING
APPLICATION NUMBER 19-6495
ADDRESS: 4440 E. CANFIELD
HISTORIC DISTRICT: SWEETEST HEART OF MARY
APPLICANT: TJ GARRETT
DATE OF COMPLETE APPLICATION: 8/30/2019
DATE OF STAFF SITE VISIT: 10/1/2019

PREPARED BY: J. ROSS

SCOPE: INSTALL NEW CELLPHONE EQUIPMENT/VENTS AT TOWER

EXISTING CONDITIONS


As per the Detroit Historic Designation Advisory Board:

Sweetest Heart of Mary is a typical cruciform plan church built of painted red brick with stone trim and a patterned slate roof. The main west facade is distinguished by a stone base topped by a quatrefoil frieze over the main portal and twin buttressed towers surmounted by octagonal spires. Sweetest Heart's 217 spires house three large bells, cast in St. Louis in 1889 to be placed in the bell tower of the school. A smaller spire marks the intersection of the nave with the transept. Several motifs unify the composition of the edifice: alternating patterns of pinnacles and decorated gables define the bases of the main spires; the gable ornamentation, consisting primarily of blind serrated lancets, is repeated on the four larger gables which mark the ends of the nave and transepts: the pointed gable shape is echoed not only on the spires and the roof, but also on the side buttressing and above all of the portals; lancet windows fenestrate the towers, the gables, and the main three-portal facade; and circles dominate the tracery of the tower windows and the smaller windows of the north and south facades. Gables, pinnacled buttresses, and angled side entrances provide the nave facades with a multiplicity of line and form. Much of this detailing derives from northern European precedents; the combination a French front and a German nave reflects the late Victorian propensity towards the use of a multiplicity of forms.

4440 E. Canfield, current conditions





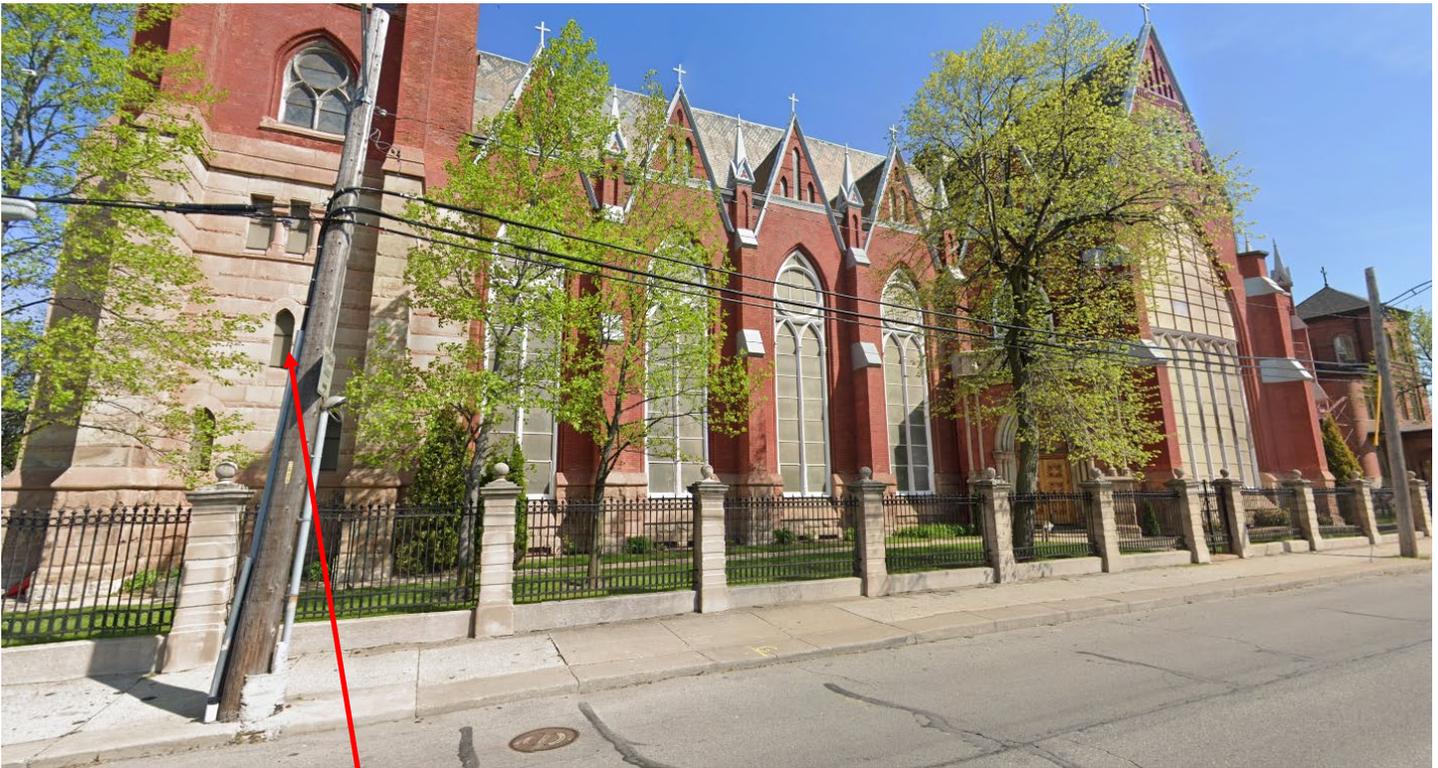

The lower pane of this window will be removed and replaced with new louvers

PROPOSAL

The project involves the installation of new cellphone equipment within the building's southwest tower. The majority of the work associated with this project will be undertaken within the building's interior space/within the portion of the building which is not covered under the building's interior designation. However, one element of the project involves the replacement of one exterior window. Specifically, the exterior work item associated with this project includes the following:

- At the north elevation, second story window at the tower, remove the lower light from the sash in install. replaced with (2) 13"x22" intake and exhaust louvers. Louver color to match beige stonework (Greenheck manufacturer, color: sierra tan/ color code: GF118)

STAFF OBSERVATIONS AND RESEARCH

- The air exhaust and intake vents are proposed for installation are necessary in order to maintain proper air flow and temperature control for the new equipment
- The window pane proposed for replacement is an opaque glass and is likely not original/historic age
- It is staff's opinion that the new louvers will be minimally visible and will not detract from the building's historic appearance

ISSUES

- None

RECOMMENDATION

As noted above, it is HDC staff's opinion that the new louvers will be minimally visible and will not detract from the building's historic appearance. HDC staff therefore recommends that the Commission issue a Certificate of Appropriateness for the work as proposed because it meets the Secretary of the Interior's Standards for Rehabilitation, standard #9) *New additions, exterior alterations, or related new construction*

shall not destroy historic materials that characterize the property. The new work shall be differentiated from the old and shall be compatible with the massing, size, scale, and architectural features to protect the historic integrity of the property and its environment.

SWEETEST HEART OF MARY CATHOLIC CHURCH

T-Mobile site DE04229B

4440 E Canfield Street, d/b/a 4440 Russell Street
Detroit, Michigan 48207
(Landtech #18323064)



Panoramic view of the church from the south side of Canfield Street.


Background

The Sweetest Heart of Mary Catholic church was built in 1893. In 2004 T-Mobile installed their equipment in the south steeple of the church. Antennas are mounted in the open window bays on the fifth floor of the south steeple. The auxiliary T-Mobile telecom equipment are housed on the third floor of the south steeple.

Over time water seeped inside both steeples. Water entered the fifth, fourth, and thirds floors of the south steeple. The water has affected T-Mobile's equipment and operations. As the parish began structural repairs to both steeples, T-Mobile and the church agreed to move the auxiliary equipment from the third to second floor of the south steeple. (The second floor of the steeple did not suffer any water damage.) The following outlines design requirements necessary to relocate T-Mobile's equipment.

Design Requirement Outline

- Structural Design – Provide structural support for new equipment on second floor.
- HVAC – Air exhaust and Intake to maintain proper air flow and temperature control for equipment
- Electric – Provide electric service to T-Mobile equipment
- Fiber Optic – Provide fiber optic service to T-Mobile equipment
- Sound Level – Install low noise AirScale equipment so not to disturb the congregation.
- Grounding – Ground new equipment.


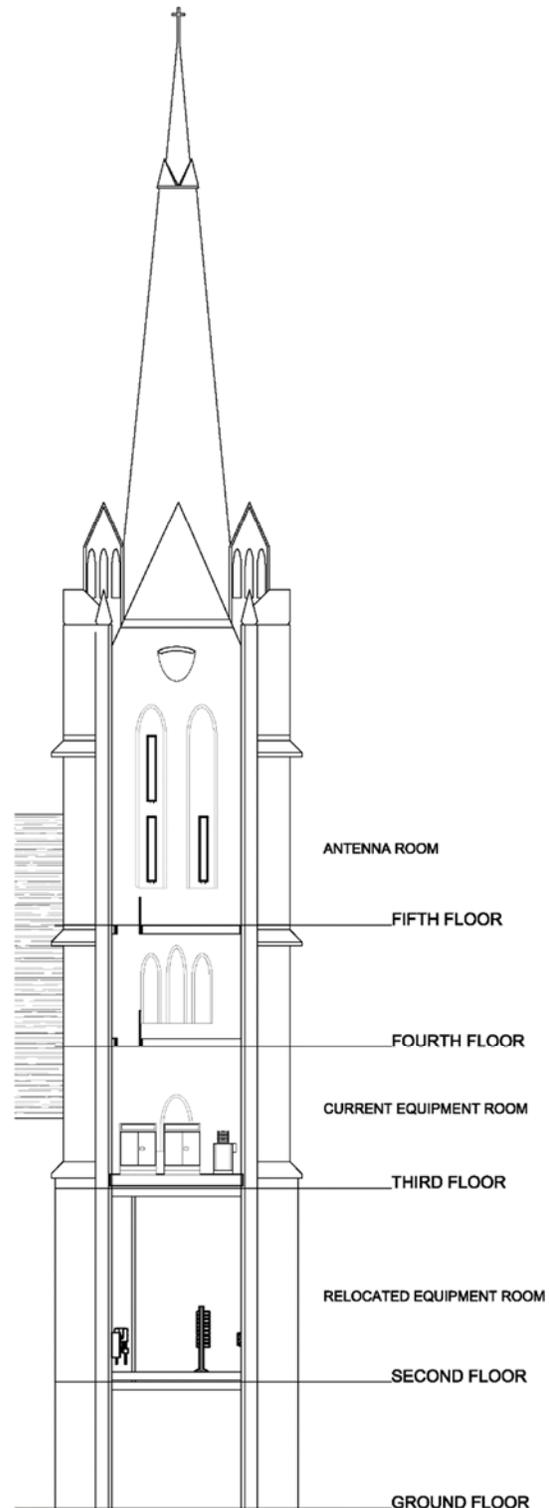


Structural Design

Provide structural support for new equipment on second floor.

- Bolt steel beams into masonry walls of steeple to suspend galvanized steel platform over wood flooring.
- Lower window on the 2nd floor steeple room to be removed temporarily.
- Beams to be hoisted into 2nd floor room through lower window on south wall of steeple (right)
- W10 beam required to penetrate non-load bearing closet wall (see “PROPOSED EQUIPMENT ROOM” sheet 2 of 2 from site sketch) to tie into structural wall.
- Organ air pump & ductwork will not be affected with installation. Platform has been designed around air pump.

Note: lower windowpane replacement to be discussed under HVAC.

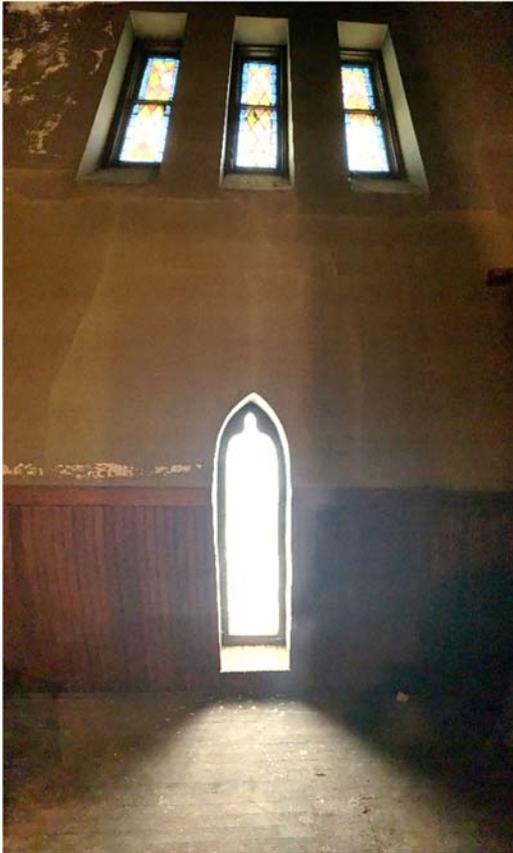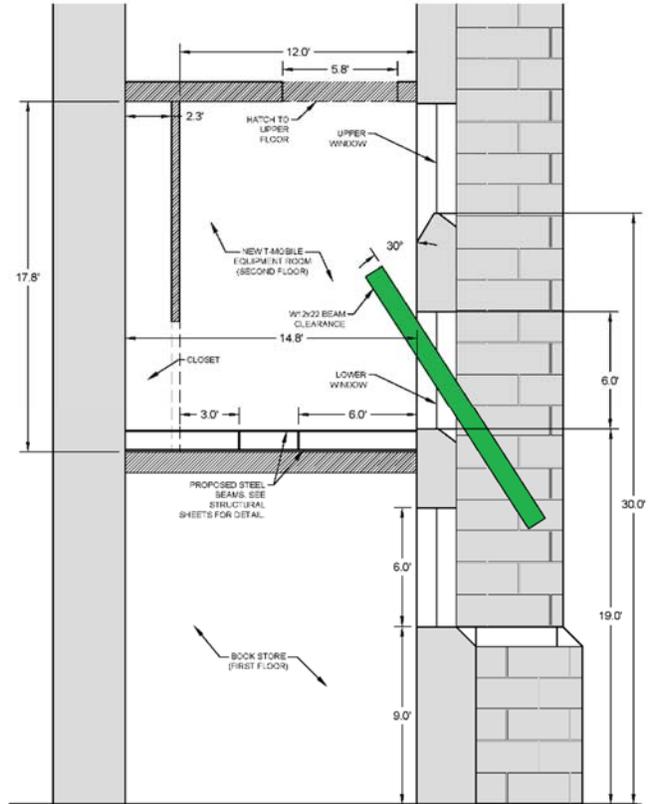

HVAC

Air exhaust and intake to maintain proper air flow and temperature control for equipment

- Replace lower windowpane with intake and exhaust louvers.
- Upper Windows are stained glass and are not to be touched or affected by the relocation. (see left)
- Lower Window (to be replaced) has opaque glass (see left).
- From the street outside the window appears milky white against a light beige stone (below)




HVAC (cont.)

- Normally there are no lights turned on in the proposed emits through the upper or lower windows outside.
- New ductwork to be installed overhead and suspended from overhead ceiling with Unistrut and hanging spring isolators.
- Lower window glass to be replaced with (2) 13"x22" intake and exhaust louvers. Louver color to match beige stonework (Greenheck manufacturer, color: sierra tan/ color code: GF118.)
- Proposed louver color match building color/style better than existing louver in the same window symmetrical to the proposed window exhaust on the north steeple (right) and above the North facing Rose Window (below).
- Exhaust fan rated at 6.4 Sones (approx. 55 dB)



Sierra Tan

GF118

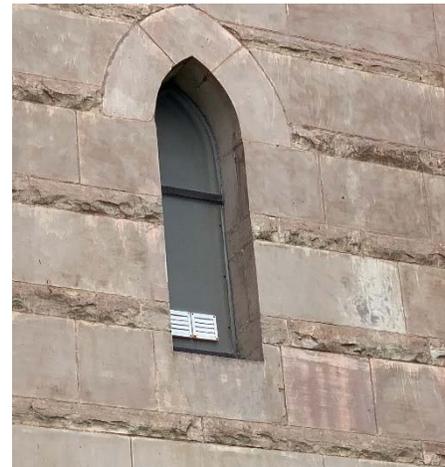

Electric

Provide electric service to T-Mobile equipment

- Existing 200A service on 3rd floor to be relocated to 2nd floor, including: 200A Tap Box & 50 KVA stepdown transformer (right). Existing disconnect and meter to remain. Existing Power from disconnect runs up access (ladder) room from 2nd to 3rd floor. Power to be rerouted through existing conduit to 2nd floor room. All utility equipment to be installed in existing closet.

Fiber Optic

Provide fiber optic service to T-Mobile equipment

- Existing Ciena Fiber demarcation box to be relocated with Electric equipment in closet of 2nd floor. Fiber to follow similar path with power conduit rerouted from 3rd floor to 2nd floor.



Sound Level

Install low noise AirScale equipment so not to disturb the congregation.

- All new T-Mobile equipment to be installed shall be 5G AirScale equipment (or newer) from Nokia. Nokia equipment to be installed on Equipment FIF racks. Due to the organ air intake located in the new equipment room, all equipment is rated at or below 65 dB.

Grounding

- All Equipment shall be grounded to a master ground bar on the 2nd floor. The master ground bar shall be grounded to the existing building ground on the 3rd floor following the conduit chase up in the 3rd floor access (ladder) room.

SITE SKETCH




INSTALL LOUVERS IN EXISTING WINDOW, INSTALL PER MANUFACTURERS SPECIFICATIONS.

EXISTING WINDOW



INSTALL LOUVERS IN EXISTING WINDOW, INSTALL PER MANUFACTURERS SPECIFICATIONS.

EXISTING WINDOW LOCATION

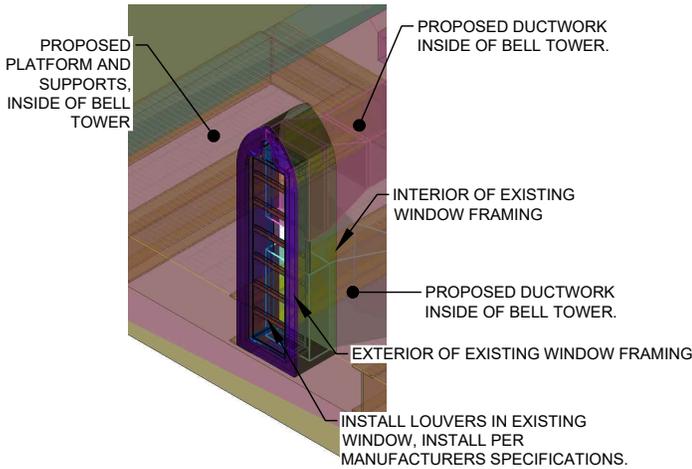

PROPOSED LOUVERS



28505 SCHOOLCRAFT RD, BLDG#6
LIVONIA, MICHIGAN 48150

SITE NAME:
SWEETEST HEART OF MARY


SITE NUMBER:
DE04229B

STREET ADDRESS:
**4440 E. CANFIELD D/B/A 4440 RUSSELL ST.
DETROIT, MICHIGAN 48207**

REV	DESCRIPTION	BY	DATE
0	PRELIMINARY	CDR	08/20/19



SITE SKETCH

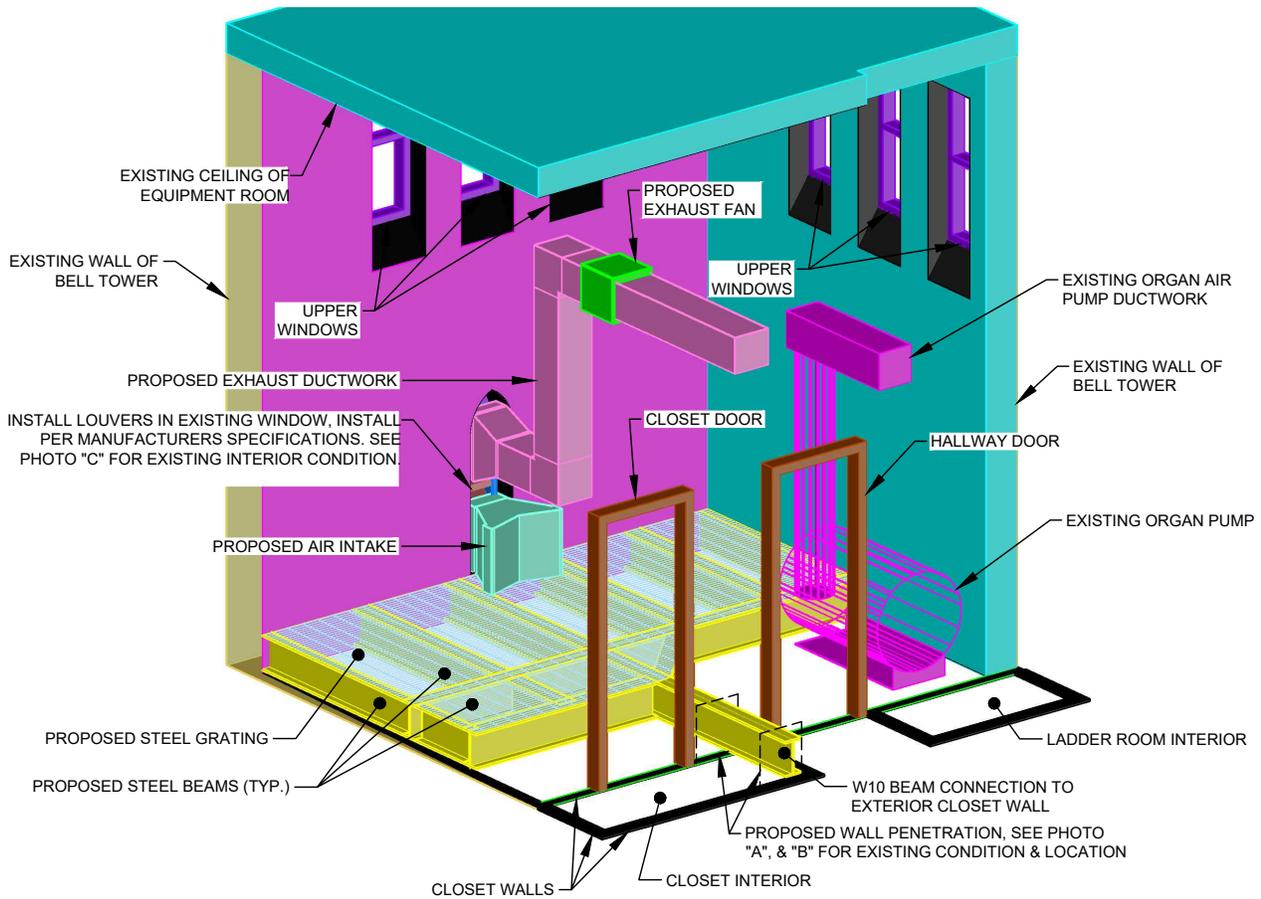

PROPOSED EQUIPMENT ROOM

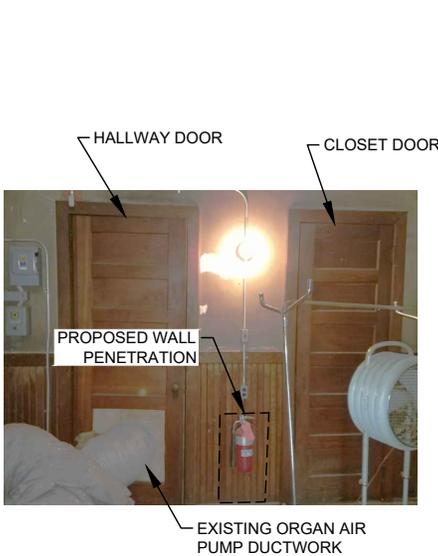


PHOTO "A"



PHOTO "B"



PHOTO "C"

REV	DESCRIPTION	BY	DATE
0	PRELIMINARY	CDR	08/20/19



2018 RELOCATION

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SWEETEST HEART OF MARY
SITE NUMBER:
DE04229B

STREET ADDRESS:
4440 E. CANFIELD D/B/A 4440 RUSSELL ST.
DETROIT, MICHIGAN 48207

T-Mobile
 28505 SCHOOLCRAFT RD, BLDG#6
 LIVONIA, MICHIGAN 48150
 Phone: 734.367.7200
 Fax: 734.367.7242
 CONTACT: KEN KALOUSEK
 (734) 444-0181

LANDTECH PROJECT NUMBER: 18323064			
REV.	DATE	DESCRIPTION	BY
A	09/18/18	PRELIMINARY RELEASE	CJL
B	11/02/18	HVAC & STRUCTURAL ADD	CDR

FROM T-MOBILE OFFICE HEAD NORTH ON MERRIMAN ROAD TO I-96; TURN EAST ON I-96 AND CONTINUE TO I-75; TURN SOUTH ON I-75 AND PROCEED TO WARREN AVENUE; TURN EAST ON WARREN AVENUE AND CONTINUE TO RUSSELL STREET; TURN SOUTH ON RUSSELL STREET AND PROCEED TO CANFIELD STREET; SITE IS LOCATED AT THE NORTHEAST CORNER OF RUSSELL STREET AND CANFIELD STREET.

DRIVING DIRECTIONS

LATITUDE: 42.35805538°
 LONGITUDE: -83.0480622°



FAA INFORMATION

THE UTILITIES SHOWN ON THESE DRAWINGS ARE FOR THE CONVENIENCE OF THE CONTRACTOR ONLY. OTHER UTILITIES THAT ARE NOT SHOWN MAY BE PRESENT AT THE SITE. LANDTECH ASSUMES NO RESPONSIBILITY FOR THE LOCATIONS OF THE UTILITIES. THE CONTRACTOR SHALL BE RESPONSIBLE FOR VERIFYING ALL UTILITIES WITHIN THE LIMITS OF THE WORK. ALL DAMAGE MADE TO EXISTING UTILITIES BY THE CONTRACTOR SHALL BE THE SOLE RESPONSIBILITY OF THE CONTRACTOR.

THIS SEAL CERTIFIES ONLY THE CIVIL ENGINEERING DESIGN AND RELATED DETAILS SHOWN ON THESE PLANS. THIS SEAL DOES NOT CERTIFY ANY ARCHITECTURAL, ELECTRICAL, MECHANICAL, STRUCTURAL DESIGN, AND RELATED DETAILS INCLUDED IN THESE PLANS.


UTILITY NOTICE

SHEET DESCRIPTION

- | | |
|-------|-------------------------------|
| T-1 | TITLE SHEET |
| C-1 | SITE PLAN |
| C-1.1 | SITE PLAN |
| C-2 | EQUIPMENT ROOM |
| C-2.1 | FLOOR PLANS |
| C-3 | EXISTING ANTENNA PLAN |
| C-4 | PROPOSED ANTENNA PLAN |
| C-5 | ELEVATION VIEW |
| C-5.1 | PICTORIAL VIEWS |
| C-5.2 | PICTORIAL VIEWS |
| C-6 | EQUIPMENT DETAILS |
| C-6.1 | EQUIPMENT DETAILS |
| C-6.2 | ANTENNA DETAILS |
| C-6.3 | MOUNTING DETAILS |
| SK-1 | PLATFORM STRUCTURAL PLAN |
| SK-2 | ANTENNA STRUCTURAL DETAIL |
| SK-3 | PLATFORM STRUCTURAL DETAIL |
| E-1 | CONDUIT CABLE SCHEMATIC |
| E-1.1 | CABLE DETAILS |
| E-1.2 | ELECTRIC DETAILS |
| E-2 | ONE-LINE DIAGRAM |
| E-3 | GROUNDING PLAN |
| E-3.1 | GROUNDING DETAILS |
| E-3.2 | GROUNDING SCHEMATIC |
| M-1 | HVAC DETAILS |
| M-1.1 | HVAC GENERAL NOTES |
| M-1.2 | EXHAUST FAN & LOUVER SCHEDULE |
| N-1 | GENERAL NOTES |
| N-2 | GENERAL NOTES |

2018 RELOCATION

NOTE: THESE DRAWINGS ARE TO SCALE WHEN PLOTTED ON 11"x17" SHEETS. REFER TO GRAPHIC SCALES ON REPRODUCTIONS.

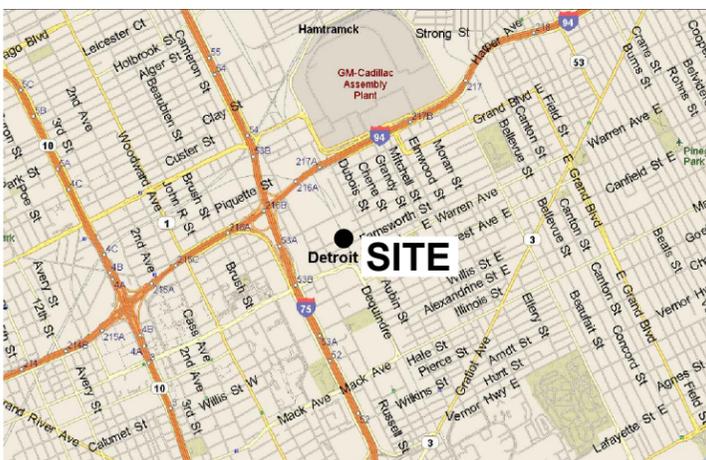

LOCATION MAP

APPLICANT/LESSEE

NAME: T-MOBILE
 ADDRESS: 28505 SCHOOLCRAFT ROAD, BLDG #6
 LIVONIA, MI 48150
 CONTACT: KEN KALOUSEK
 PHONE: (734) 444-0181

PROPERTY INFORMATION

PROPERTY OWNER: CATHOLIC ARCHDIOCESE OF DETROIT
 ADDRESS: 12 STATE STREET,
 DETROIT, MI 48226

CONTACT: PHONE:
 AREA OF CONSTRUCTION: 165 SQ. FT.
 PRESENT OCCUPANCY TYPE: ASSEMBLY
 PROPOSED OCCUPANCY TYPE: ASSEMBLY
 CURRENT ZONING:

PARCEL NUMBER: WARD 7, ITEM 001241
 HANDICAP REQUIREMENTS: FACILITY IS UNMANNED AND NOT FOR HUMAN HABITATION. HANDICAPPED ACCESS NOT REQUIRED.

CIVIL ENGINEER & SURVEYOR:

NAME: LANDTECH PROFESSIONAL SURVEYING & ENGINEERING
 ADDRESS: 1275 MCGREGOR WAY
 GRAWN, MI 49637
 CONTACT: MATTHEW MOKANYK, P.S., P.E.
 PHONE: (231) 943-0050

PROJECT SUMMARY

ATTENTION GC: THESE DRAWINGS ARE PREPARED BASED ON RFDS DATED: 3/26/18

GENERAL CONTRACTOR TO CHECK WITH CONSTRUCTION TO VERIFY THAT THE RFDS IS CORRECT.

RFDS DESIGN

TITLE	NAME	DATE
OPERATIONS		
RF ENGINEER		
ZONING ADMINISTRATOR		
CONSTRUCTION MANAGER		
POWER APPROVAL		
FIBER/AAV APPROVAL		

T-MOBILE APPROVALS

SIGNATURE _____ DATE _____

PRINTED NAME
 NO CHANGES CHANGES NEEDED SEE COMMENTS

LESSOR APPROVAL

SHEET INDEX

ALL WORK AND MATERIALS SHALL BE PERFORMED AND INSTALLED IN ACCORDANCE WITH THE CURRENT EDITIONS OF THE FOLLOWING CODES AS ADOPTED BY THE LOCAL GOVERNING AUTHORITIES. NOTHING IN THESE PLANS IS TO BE CONSTRUED TO PERMIT WORK NOT CONFORMING TO THE LATEST EDITIONS OF THE FOLLOWING CODES:

- | | |
|----------------------------------|--------------------------------------|
| 1. 2015 MICHIGAN BUILDING CODE | 7. 2015 MICHIGAN PLUMBING CODE |
| 2. 2015 MICHIGAN MECHANICAL CODE | 8. INTERNATIONAL FIRE CODE |
| 3. ANSI/TIA-222-H | 9. 2015 MICHIGAN UNIFORM ENERGY CODE |
| 4. NATIONAL ELECTRIC CODE 2017 | 10. MIOSHA RULES AND REGULATIONS |
| 5. LOCAL BUILDING CODE | 11. NFPA-101 LIFE SAFETY CODE |
| 6. CITY/COUNTY ORDINANCES | |

CITY OF DETROIT HAD ADOPTED MICHIGAN BUILDING CODE 2015 AND MICHIGAN REHABILITATION, PL FOLLOW.

USE GROUP: A-3
 CONSTRUCTION TYPE: A-1

CODE COMPLIANCE



SITE #: DE04229B
 SITE NAME: SWEETEST HEART OF MARY
 SITE ADDRESS: 4440 E. CANFIELD D/B/A 4440 RUSSELL ST.
 DETROIT, MICHIGAN 48207

Sheet Title:
TITLE SHEET

Sheet Number:
T-1

CATCH BASIN
 SQUARE CATCH BASIN
 SANITARY MANHOLE
 TELCO. MANHOLE
 ELECTRIC METER
 LIGHT POLE
 STORM MANHOLE
 WATER VALVE
 GAS METER
 GAS VALVE
 HYDRANT
 TRANSFORMER
 GAS MANHOLE
 BENCHMARK
 IRON PIPE
 CONTROL IRON L.T.
 IRON FOUND
 IRON SET
 P.K. NAIL FOUND
 P.K. NAIL SET
 NAIL LANDTECH
 MONUMENT FOUND
 RECORD
 MEASURED
 FIBER PEDESTAL
 FIBER VAULT
 POWER POLE
 GUY
 O/H TELCO
 U/G TELCO
 O/H ELEC
 U/G ELEC
 WATER
 GAS
 FIBER
 FENCE


OT
 UT
 OE
 UE
 W
 G
 F
 X

O/H TELCO
 U/G TELCO
 O/H ELEC
 U/G ELEC
 WATER
 GAS
 FIBER
 FENCE

LEGEND
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SCALE: 1"=20'

811 Know what's below. Call before you dig.

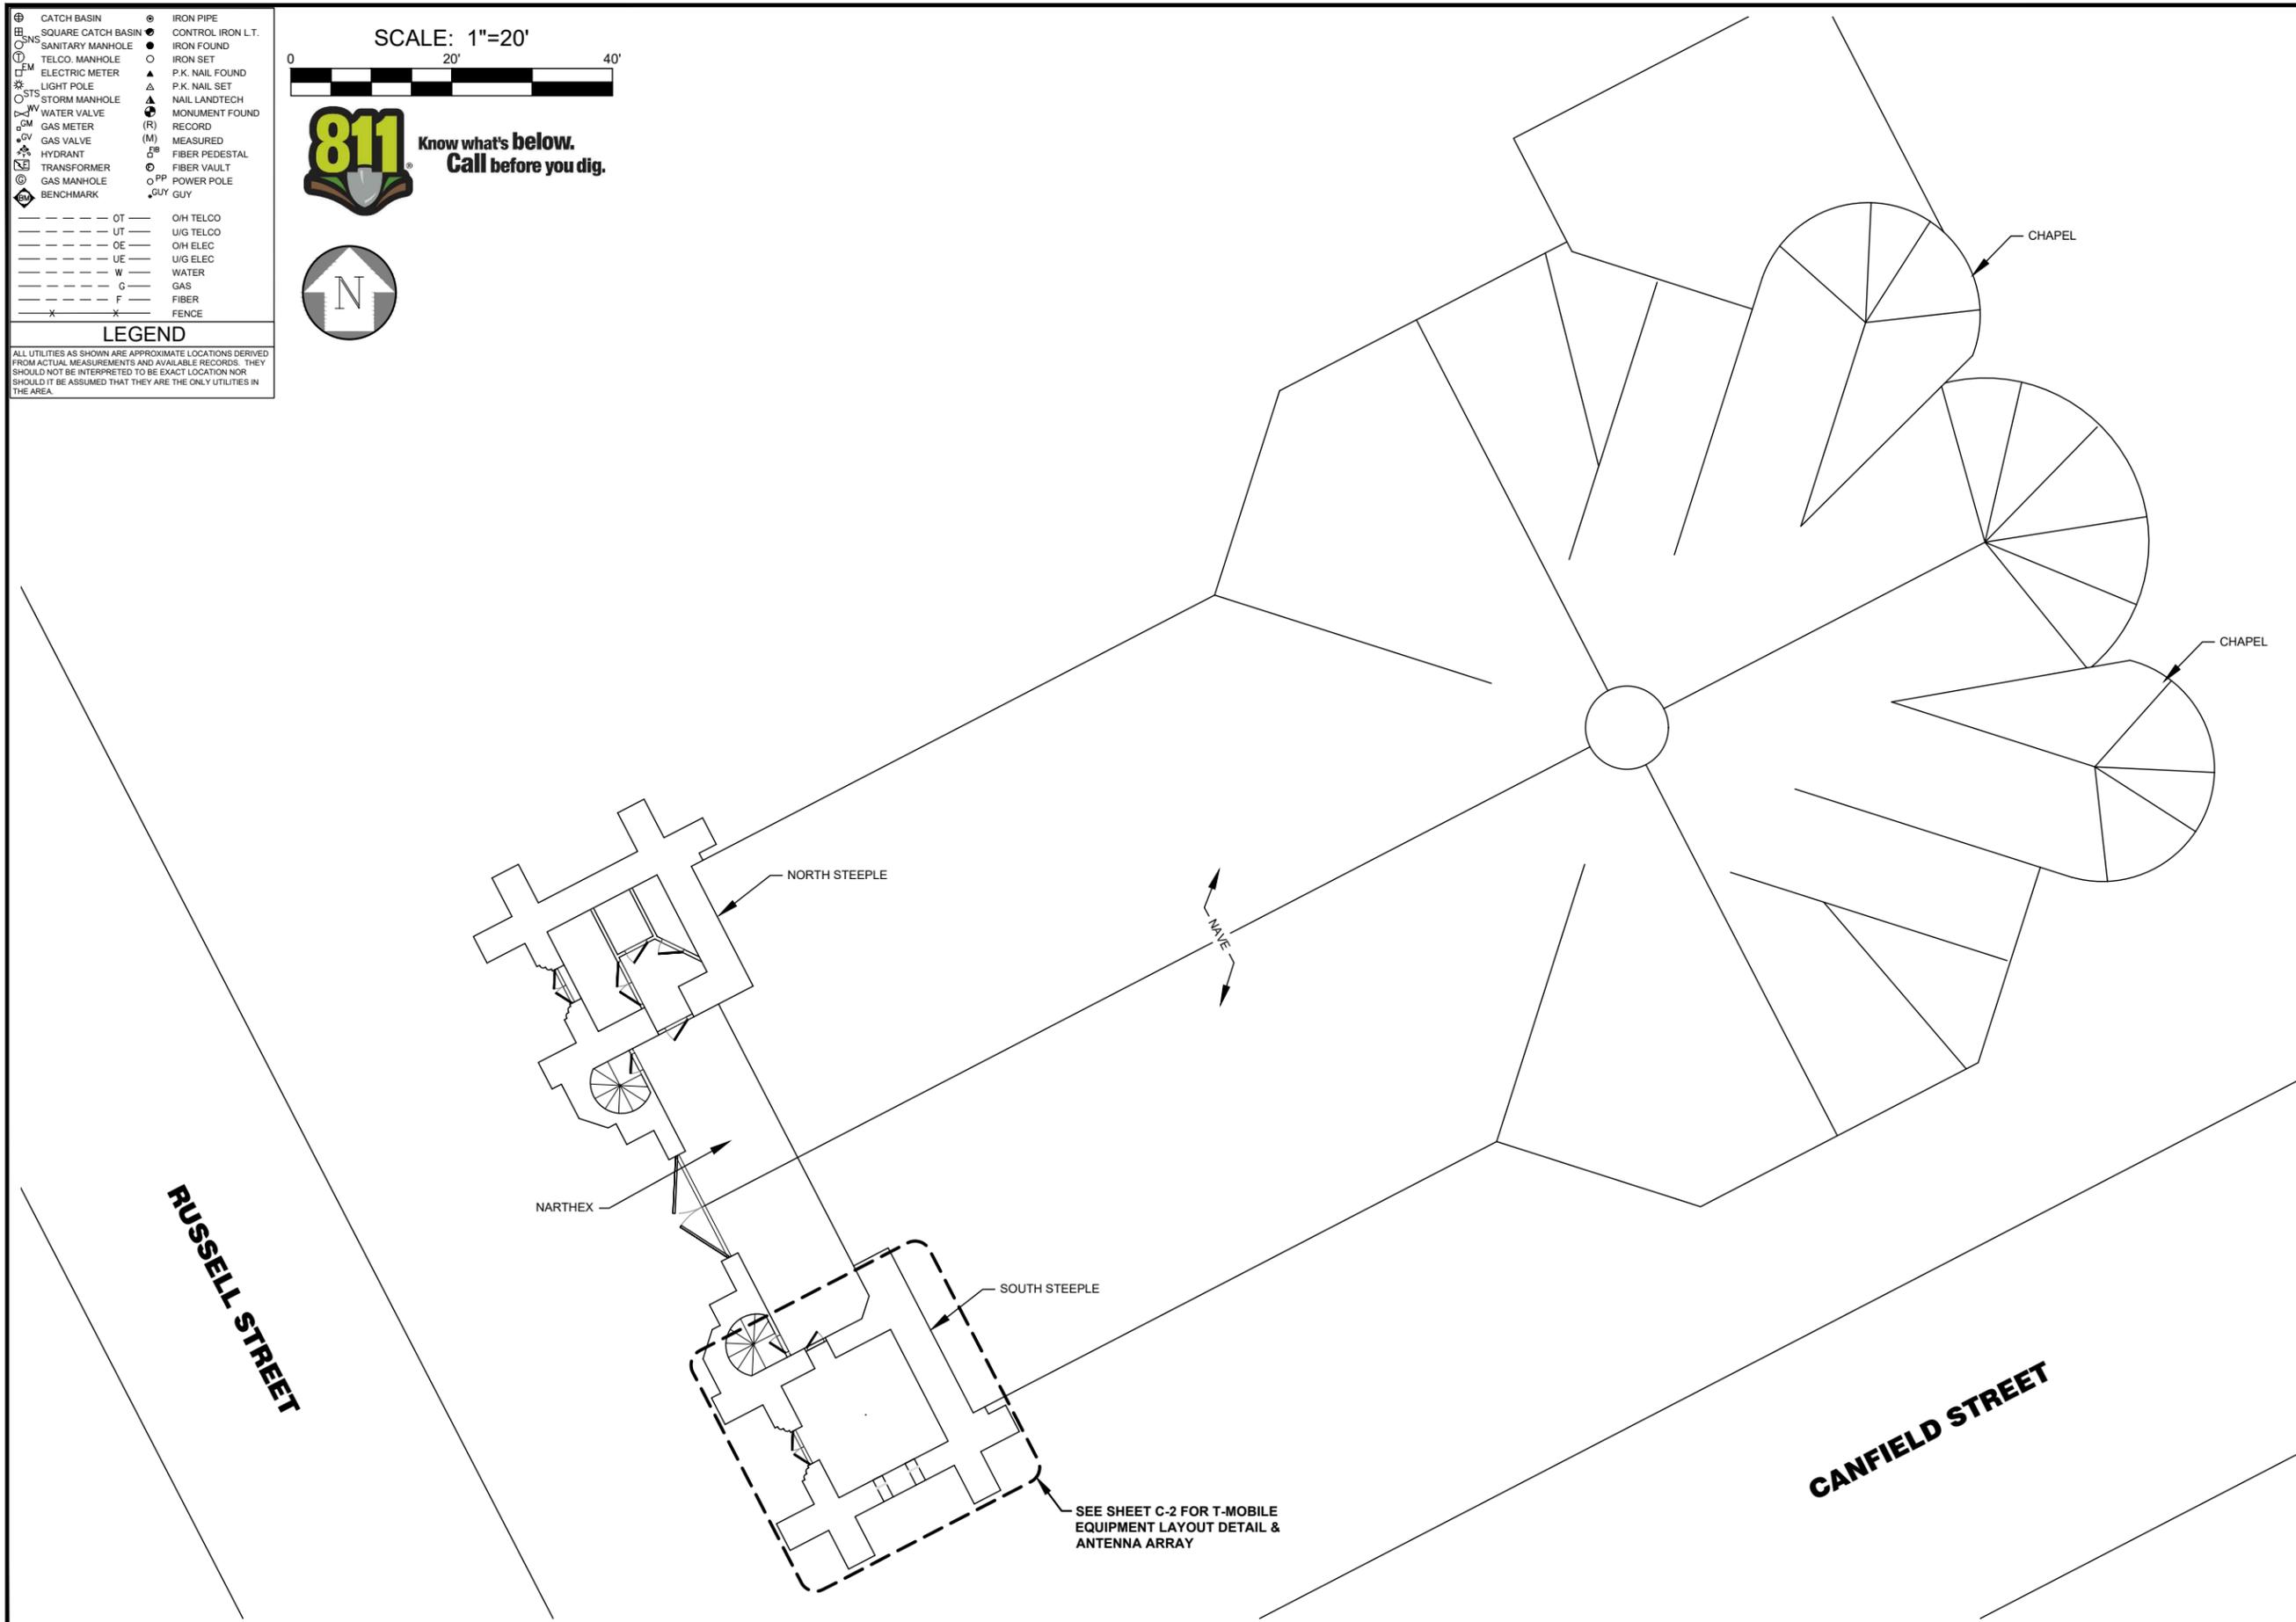

T-Mobile
 28505 SCHOOLCRAFT RD, BLDG#6
 LIVONIA, MICHIGAN 48150
 Phone: 734.367.7200
 Fax: 734.367.7242
 CONTACT: KEN KALOUSEK
 (734) 444-0181

LANDTECH PROJECT NUMBER: 18323064

REV.	DATE	DESCRIPTION	BY
A	09/18/18	PRELIMINARY RELEASE	C.JL
B	11/02/18	HVAC & STRUCTURAL ADD	CDR

2018 RELOCATION

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Sheet Title:
SITE PLAN


Sheet Number:
C-1

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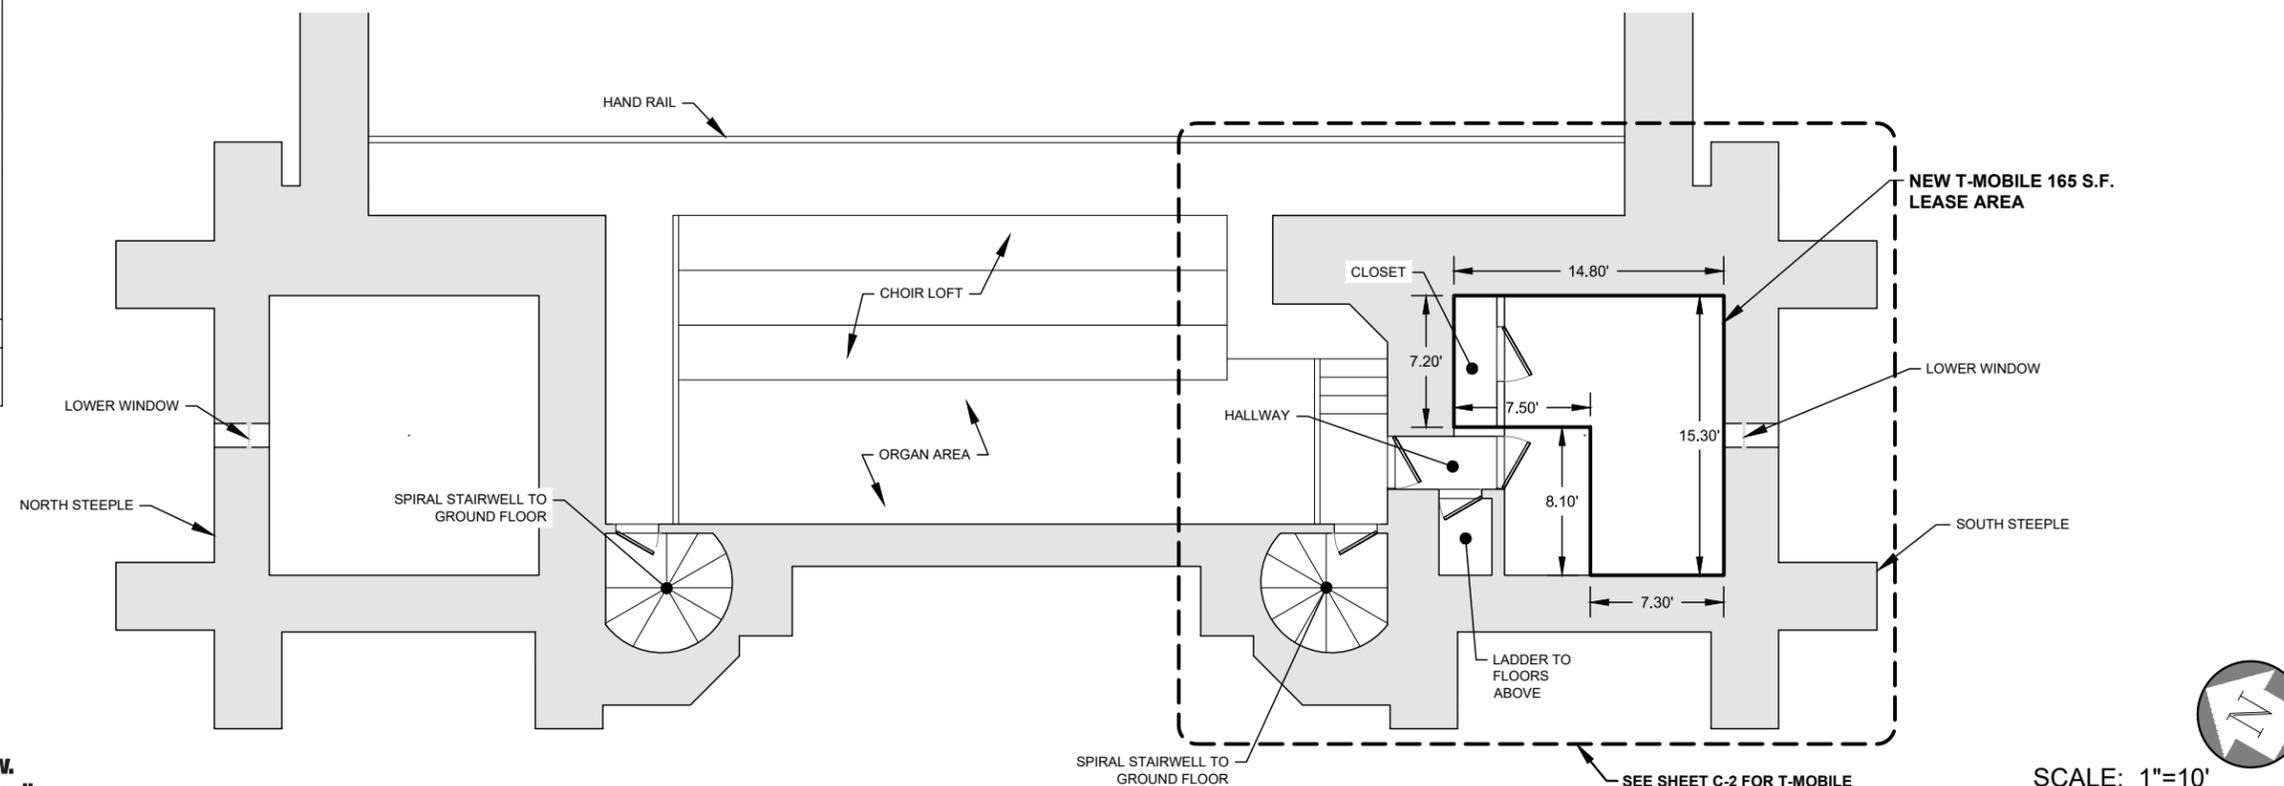
GROUND FLOOR 1"=10'

1

- ⊕ CATCH BASIN
- ⊕ SQUARE CATCH BASIN
- ⊕ SANITARY MANHOLE
- ⊕ TELCO. MANHOLE
- ⊕ ELECTRIC METER
- ⊕ LIGHT POLE
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SCALE: 1"=10'

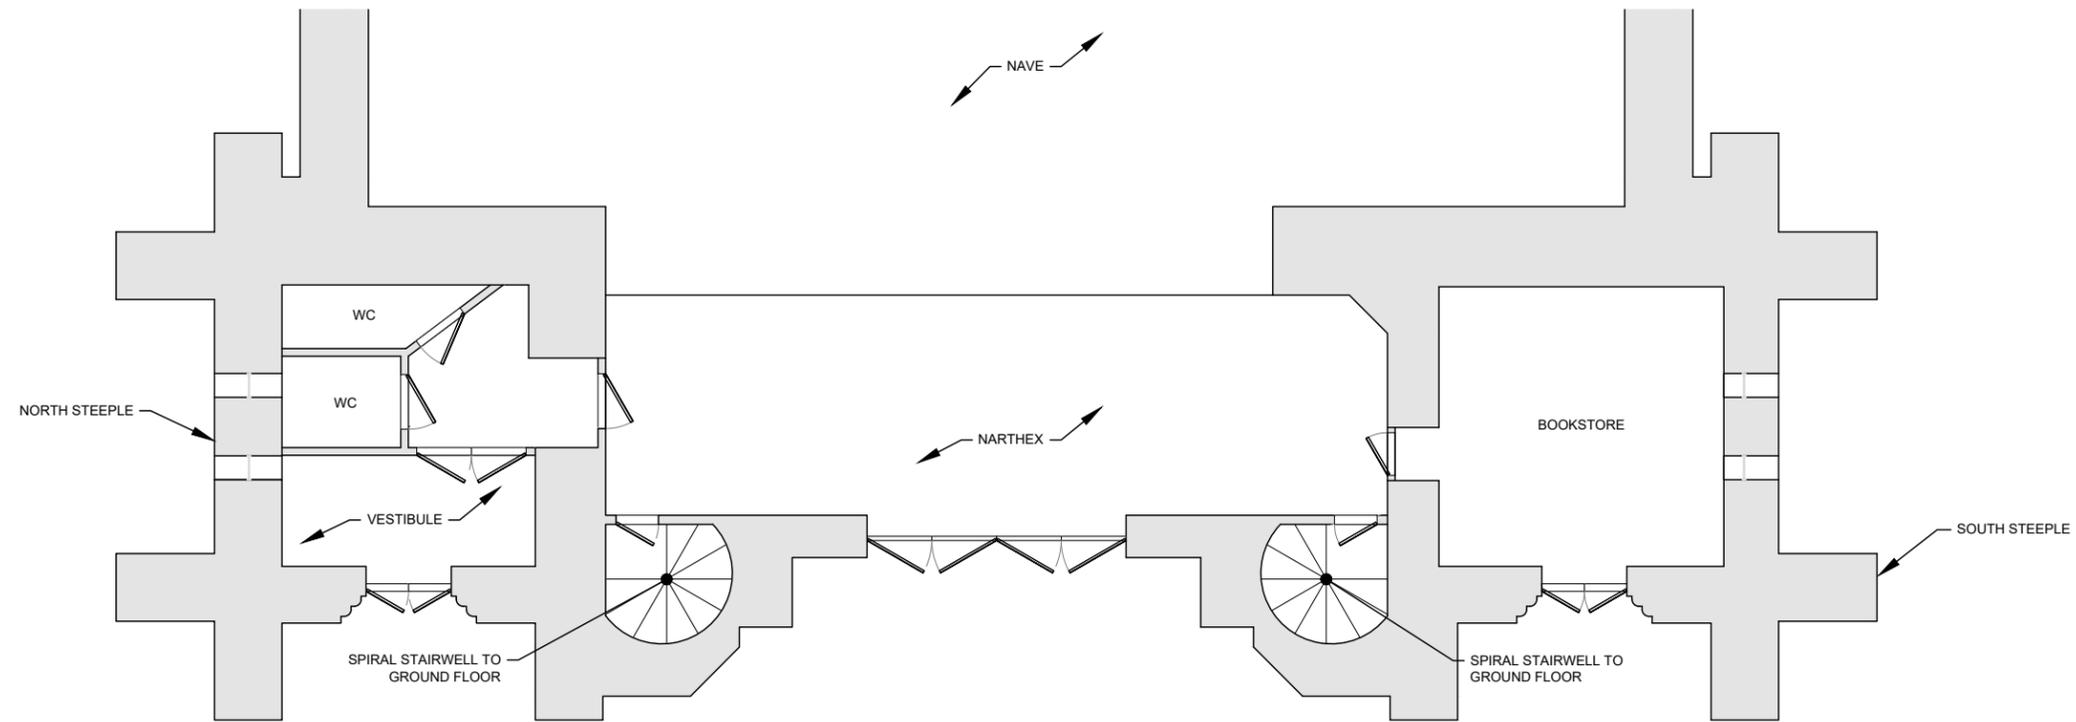

SECOND FLOOR LOFT AND STEEPLE PLAN 1"=10'

1



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Sheet Title: **SITE PLAN**

Sheet Number: **C-1.1**




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Sheet Title: **EQUIPMENT ROOM**

Sheet Number: **C-2**




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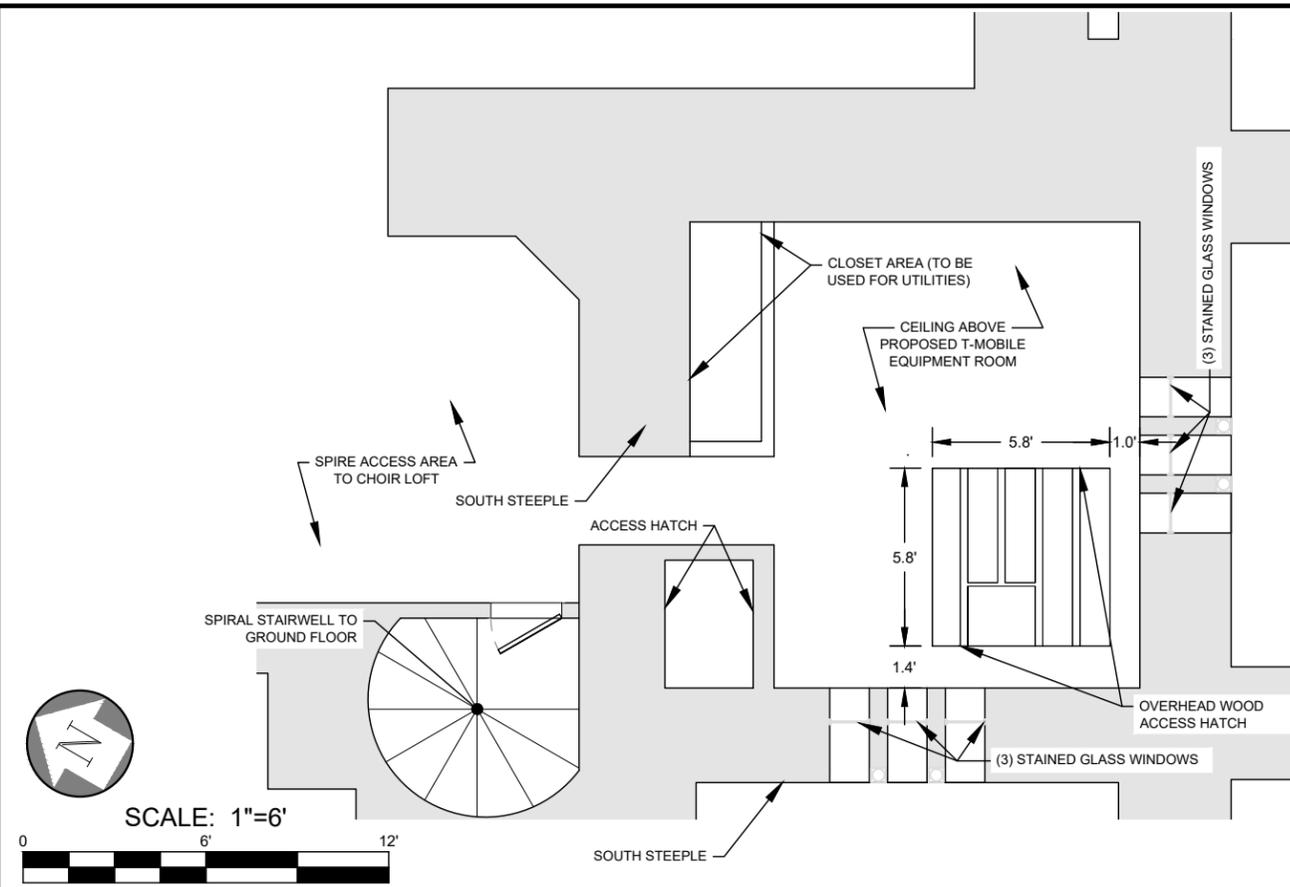
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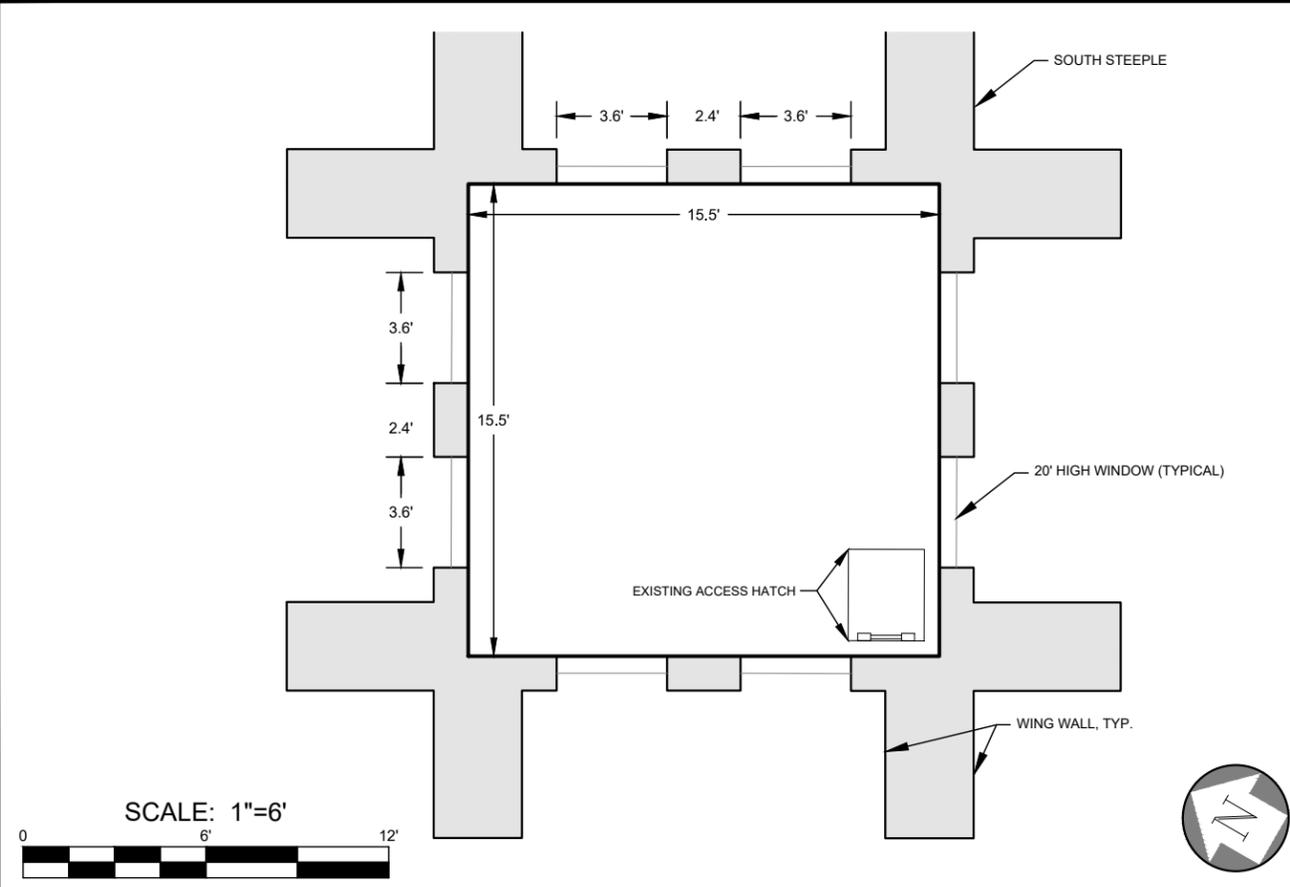
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3rd FL. SOUTH STEEPLE - OLD EQUIPMENT ROOM DEMO PLAN 1"=3' 1

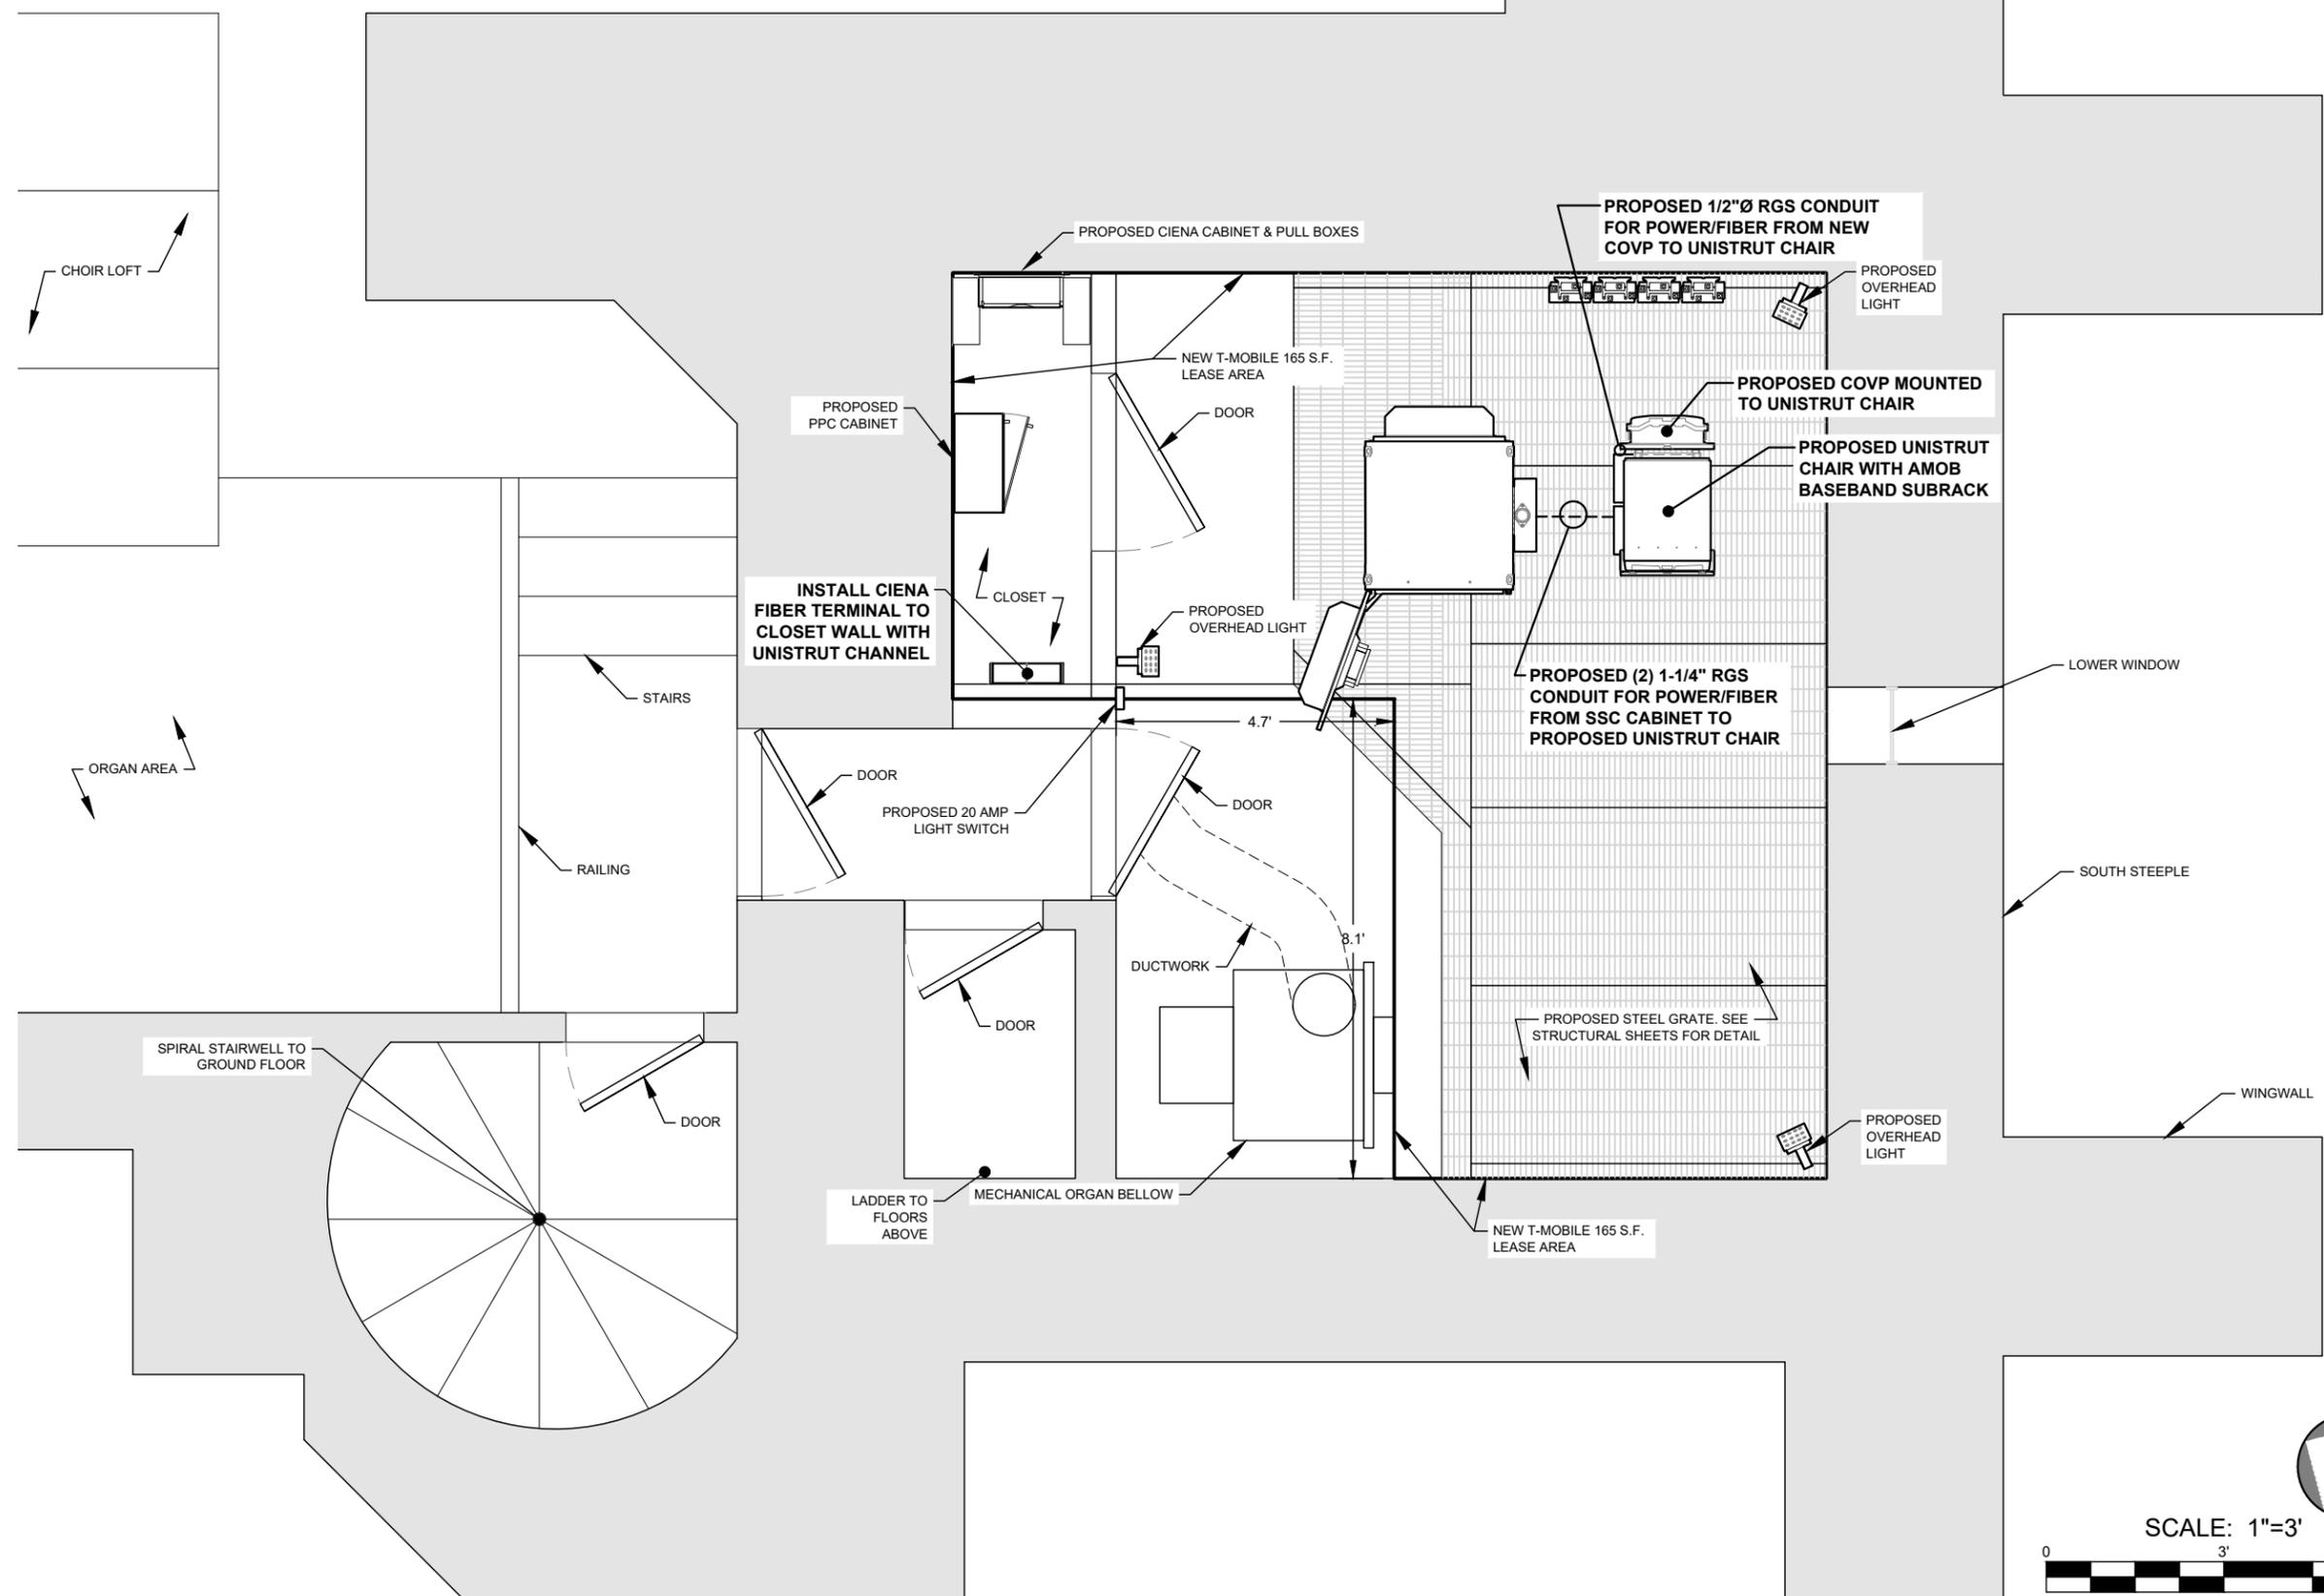

2ND FLOOR SOUTH STEEPLE CEILING VIEW 1"=6' 2

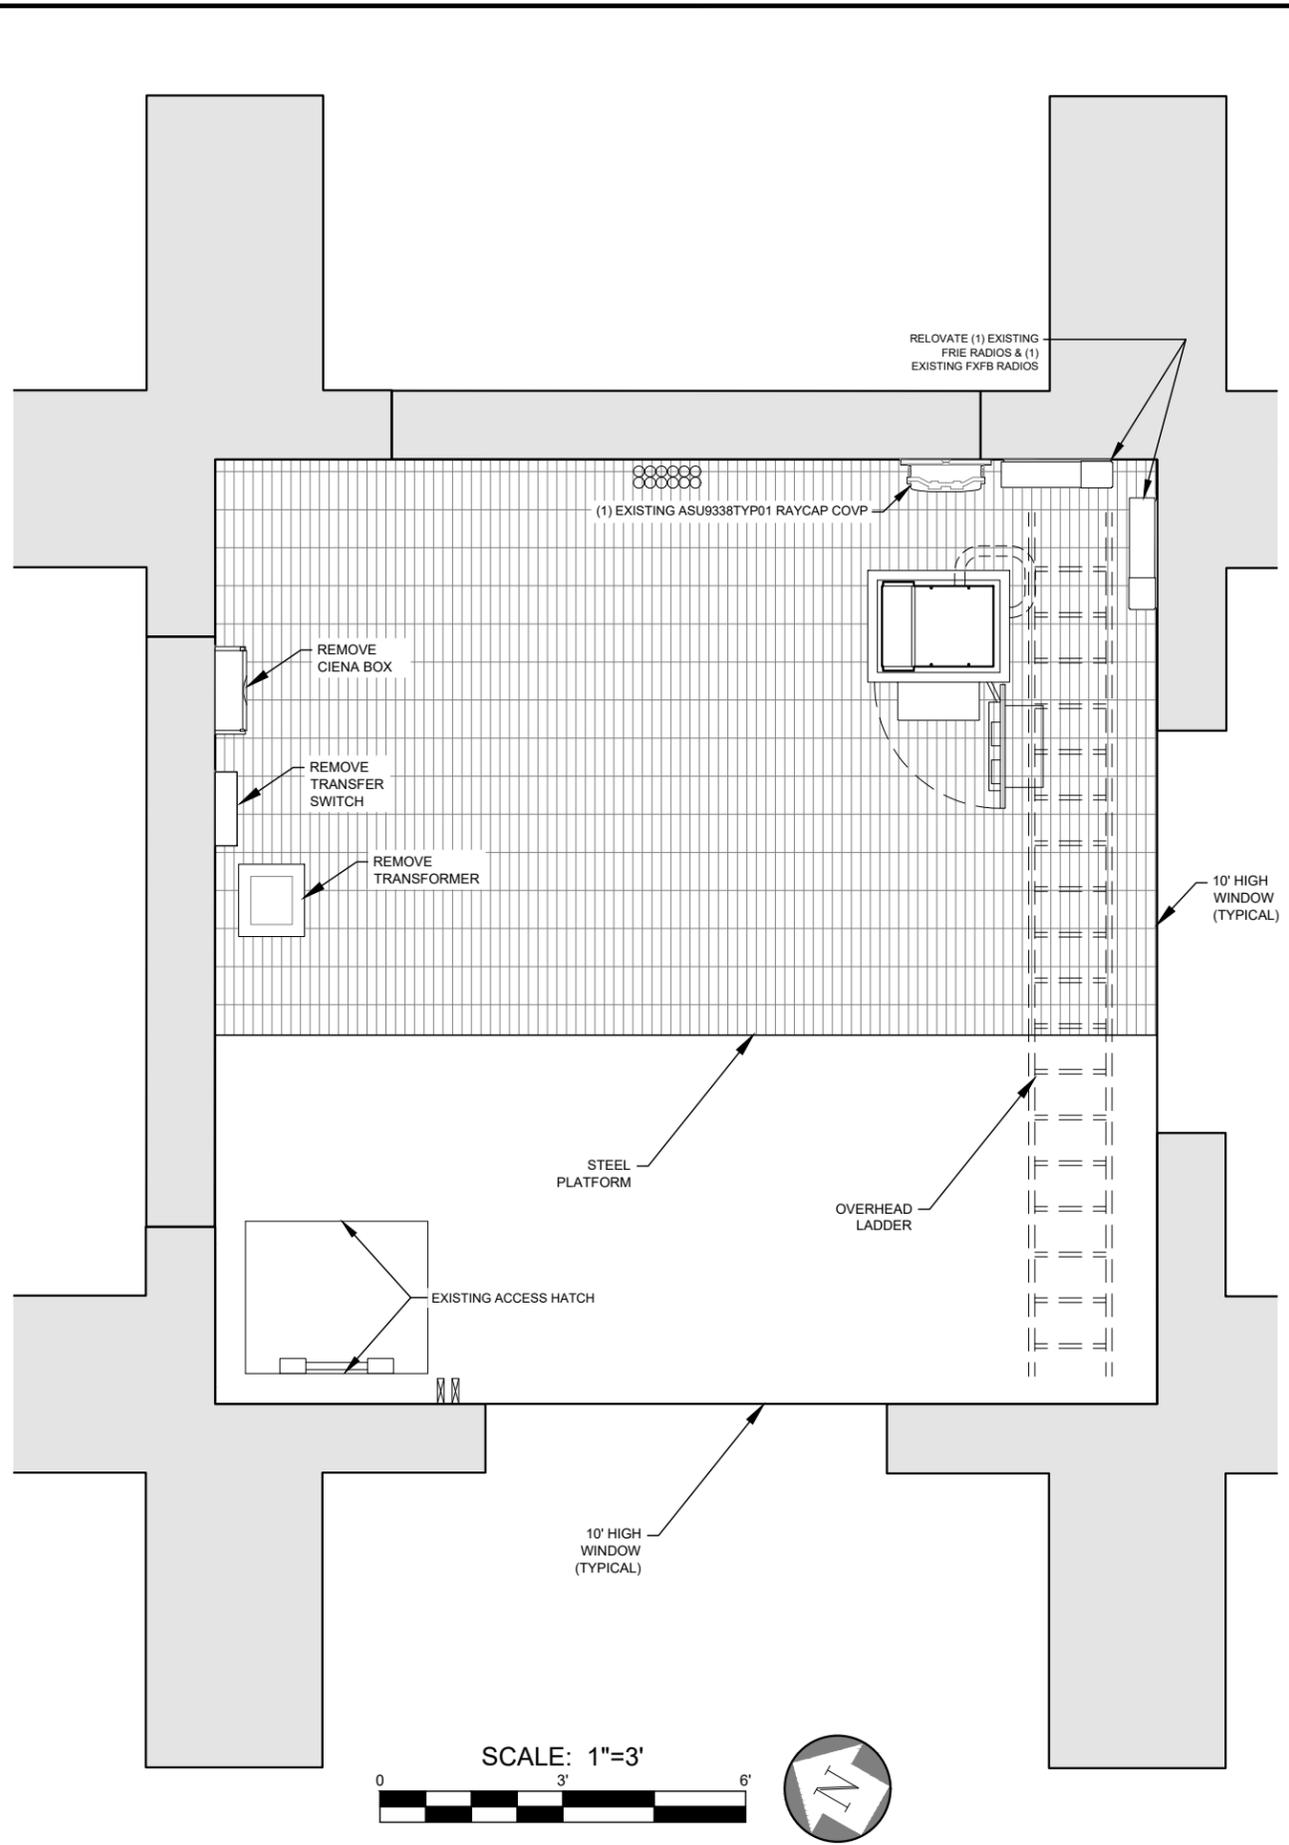

5th FLOOR SOUTH STEEPLE - ANTENNA ROOM 1"=6' 3



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Sheet Title: **FLOOR PLANS**

Sheet Number: **C-2.1**

NOTE: ANTENNA AND RADIO LAYOUT AS OBSERVED DURING SITE VISIT DOES NOT MATCH RFDS PROVIDED BY T-MOBILE. FIELD VISIT DATA SHOWN HEREON.


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Sheet Title: EXISTING ANTENNA PLAN

Sheet Number: C-3



ANTENNA SCHEDULE							
SECTOR	ALPHA		BETA		GAMMA		DELTA
ANTENNA POSITION	A-1	A-2	B-1	B-2	C-1	C-2	D-1
AZIMUTH	80°	80°	150°	150°	220°	220°	270°
RAD CENTER (AGL)	110'	110'	110'	110'	110'	110'	110'
MODEL	TMBXX-6517-R2M	FFHH-65C-R3	TMBXX-6517-R2M	FFHH-65C-R3	TMBXX-6517-R2M	FFHH-65C-R3	RVV-33B-R3
FEEDER LENGTH	15'-0"	15'-0"	15'-0"	15'-0"	15'-0"	15'-0"	15'-0"

T-Mobile
 28505 SCHOOLCRAFT RD, BLDG#6
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 Phone: 734.367.7200
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 CONTACT: KEN KALOUSEK
 (734) 444-0181

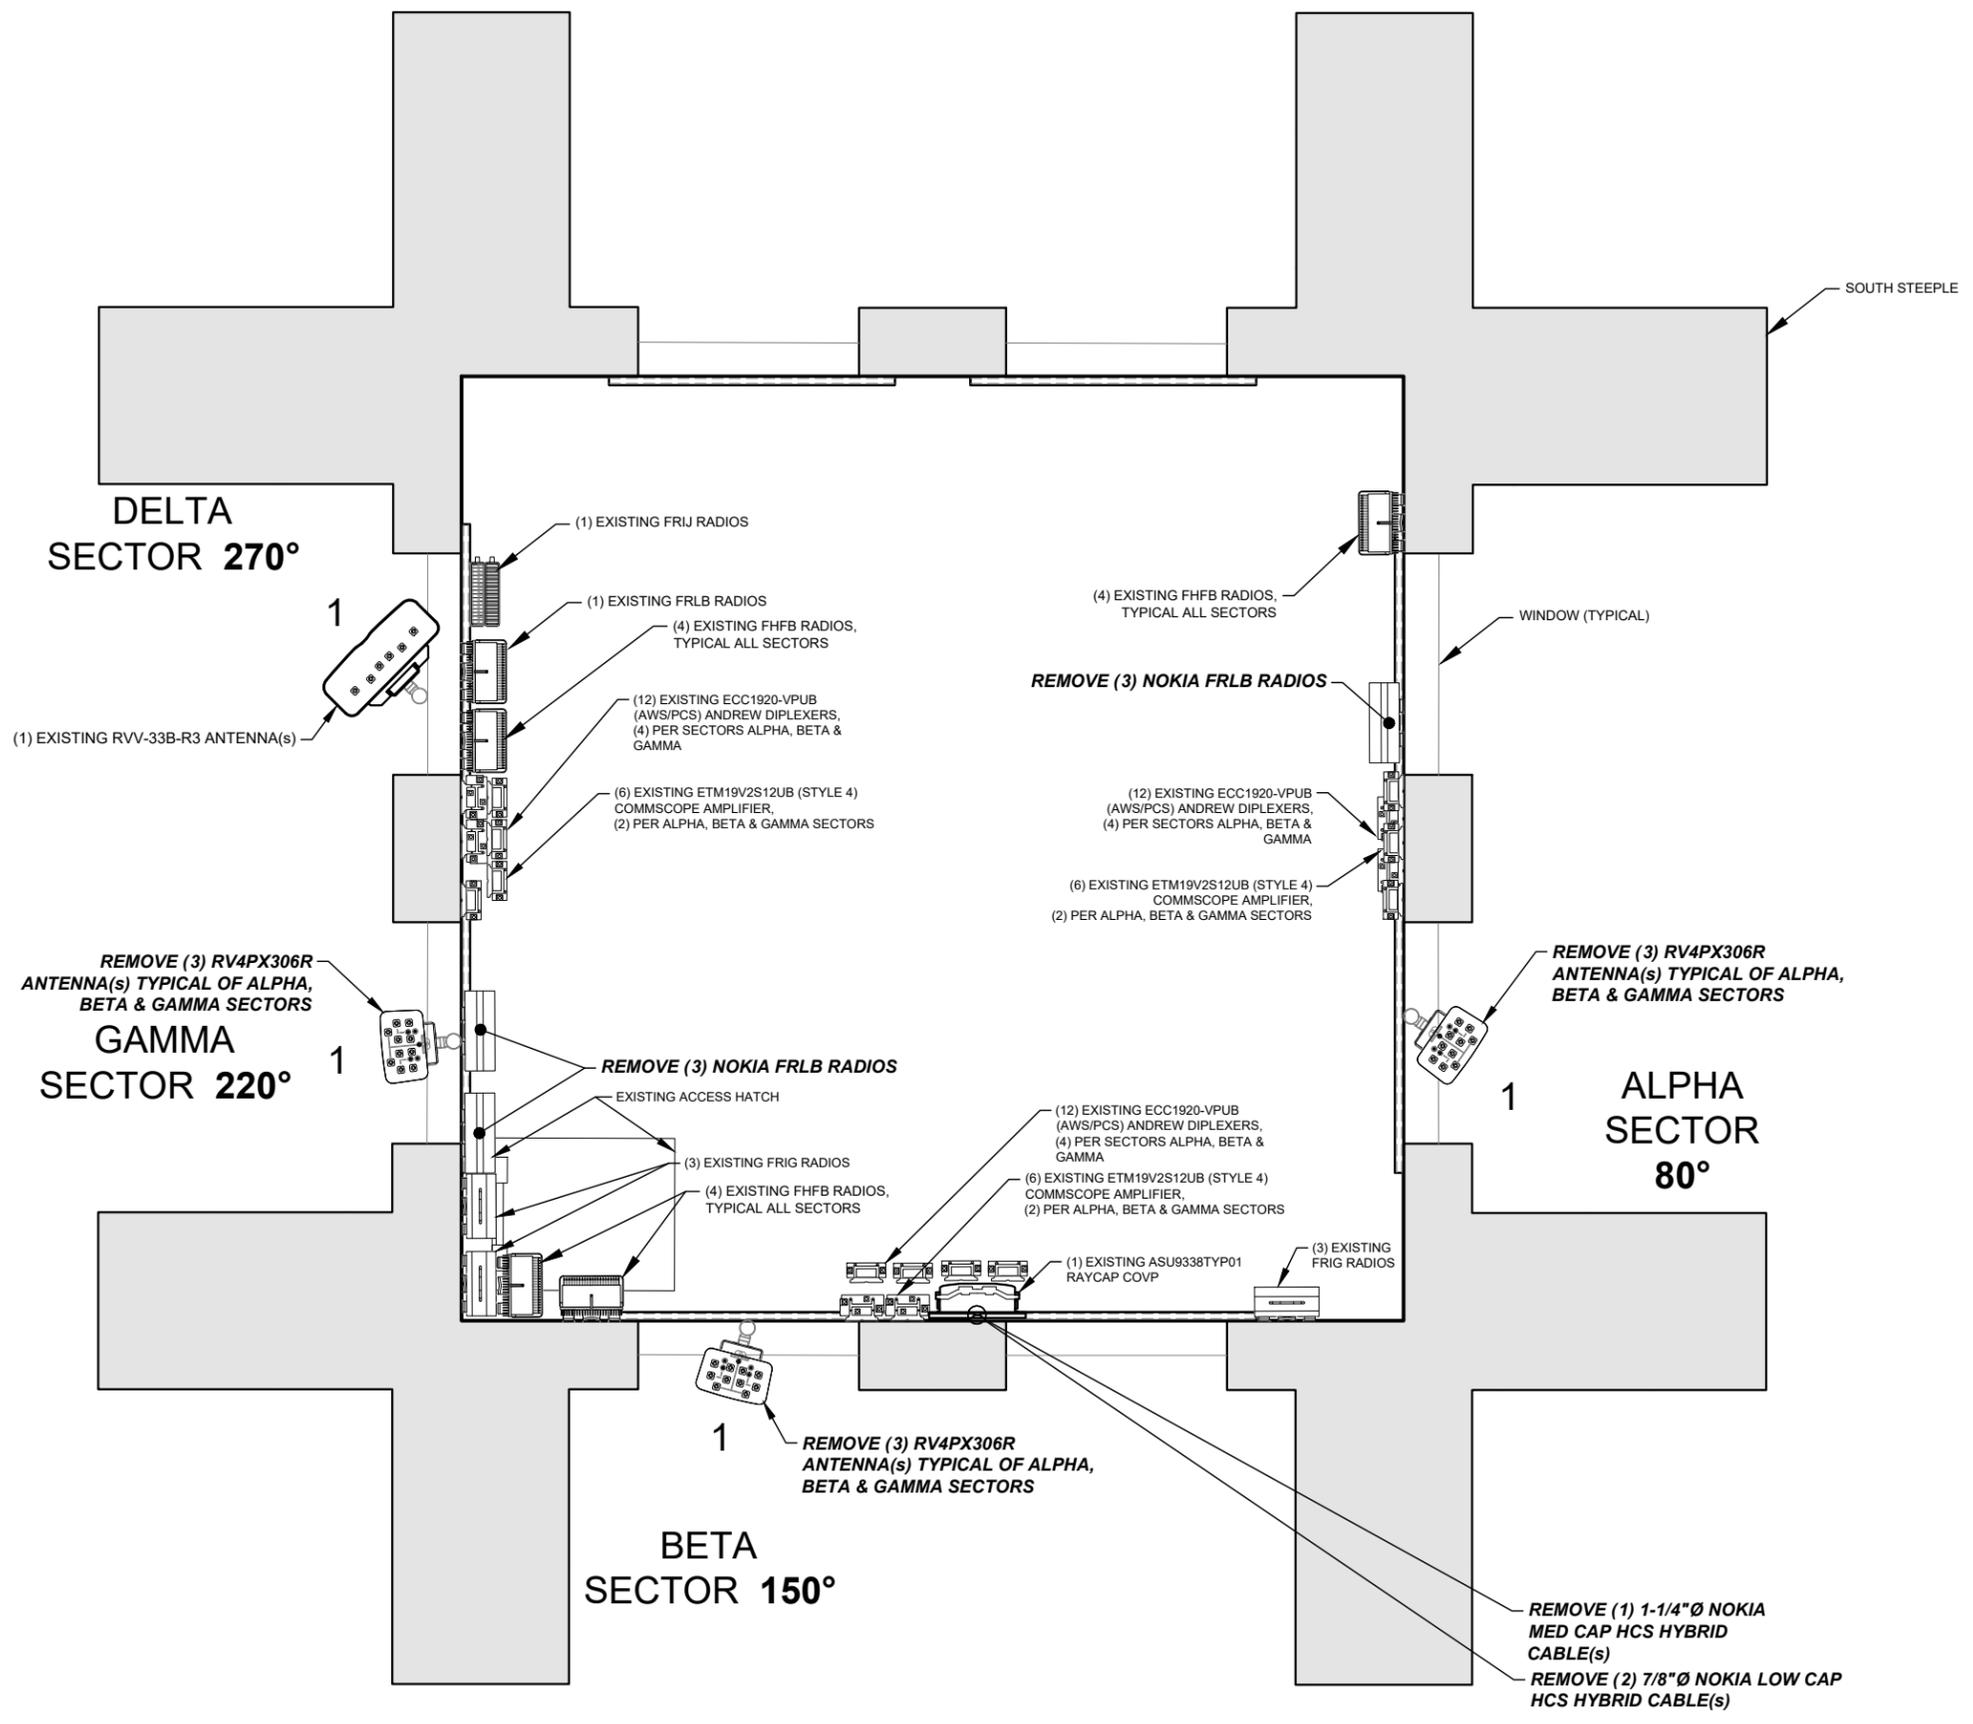
LANDTECH PROJECT NUMBER: 18323064

REV.	DATE	DESCRIPTION	BY
A	09/18/18	PRELIMINARY RELEASE	CJL
B	11/02/18	HVAC & STRUCTURAL ADD	CDR

2018 RELOCATION

NOTE: THESE DRAWINGS ARE TO SCALE WHEN PLOTTED ON 11"x17" SHEETS. REFER TO GRAPHIC SCALES ON REPRODUCTIONS.

- APPURTENANCE LIST**
EXISTING
- (1) COMMSCOPE RVV-33B-R3 ANTENNA(s) [72"l x 25.2"w x 9.3"d 94.8lb(s)]
 - (1) NOKIA FRIE RADIOS (@PLATFORM) [5.2"l x 19.3"w x 22"d 55.1lb(s)]
 - (1) NOKIA FXFB RADIOS (@PLATFORM) [5.2"l x 19.3"w x 22"d 55.1lb(s)]
 - (3) NOKIA FRIG RADIOS (@SECTOR) [18.9"l x 15.2"w x 6"d 57.32lb(s)]
 - (4) NOKIA FHFB RADIOS (@SECTOR) [34.3"l x 12.6"w x 7.8"d 52.9lb(s)]
 - (1) NOKIA FRIJ RADIOS (@) [23.1"l x 12.6"w x 5.8"d 44.1lb(s)]
 - (6) ETM19V2S12UB (STYLE 4) COMMSCOPE AMPLIFIER (@SECTOR) [10"l x 8"w x 2.2"d 11lb(s)]
 - (1) ASU9338TYP01 RAYCAP COVP (@PLATFORM) [20.38"l x 18.86"w x 5.83"d 19lb(s)]
 - (1) ASU9338TYP01 RAYCAP COVP (@SECTOR) [20.38"l x 18.86"w x 5.83"d 19lb(s)]
 - (12) ECC1920-VPUB (AWS/PCS) ANDREW DIPLEXERS (@SECTOR) [7.6"l x 7.3"w x 2.6"d 7.9lb(s)]
 - (6) ECC1920-VPUB (AWS/PCS) ANDREW DIPLEXERS (@PLATFORM) [7.6"l x 7.3"w x 2.6"d 7.9lb(s)]
 - (6) 7/8"Ø [1.03" OD] ANDREW LDF5-50A COAX CABLE(s)
- REMOVING**
- (3) COMMSCOPE RV4PX306R ANTENNA(s) [63"l x 13.9"w x 8.2"d 52.9lb(s)]
 - (3) NOKIA FRLB RADIOS (@) [15.75"l x 15.75"w x 5.9"d 59.52lb(s)]
 - (1) 1-1/4"Ø [1-1/4"OD] NOKIA MED CAP HCS HYBRID CABLE(s)
 - (2) 7/8"Ø [7/8"OD] NOKIA LOW CAP HCS HYBRID CABLE(s)
- INSTALLING**
- (3) ANDREW TMBXX-6517-R2M ANTENNA(s) [82.9"l x 11.9"w x 6.3"d 44.4lb(s)]
 - (3) COMMSCOPE FFHH-65C-R3 ANTENNA(s) [95.9"l x 25.2"w x 9.3"d 127.6lb(s)]
 - (3) NOKIA AHLOA RADIOS (@SECTOR) [22.1"l x 12.2"w x 7.5"d 83.9lb(s)]
 - (3) CBC1923T-43-2X COMMSCOPE DIPLEXERS (@SECTOR) [4.6"l x 8.3"w x 3.7"d 9.5lb(s)]
 - (2) ASU9338TYP01 RAYCAP COVP (@SECTOR) [20.38"l x 18.86"w x 5.83"d 19lb(s)]
 - (3) 1-5/8"Ø [1-5/8"OD] NOKIA HIGH CAP HCS HYBRID CABLE(s)

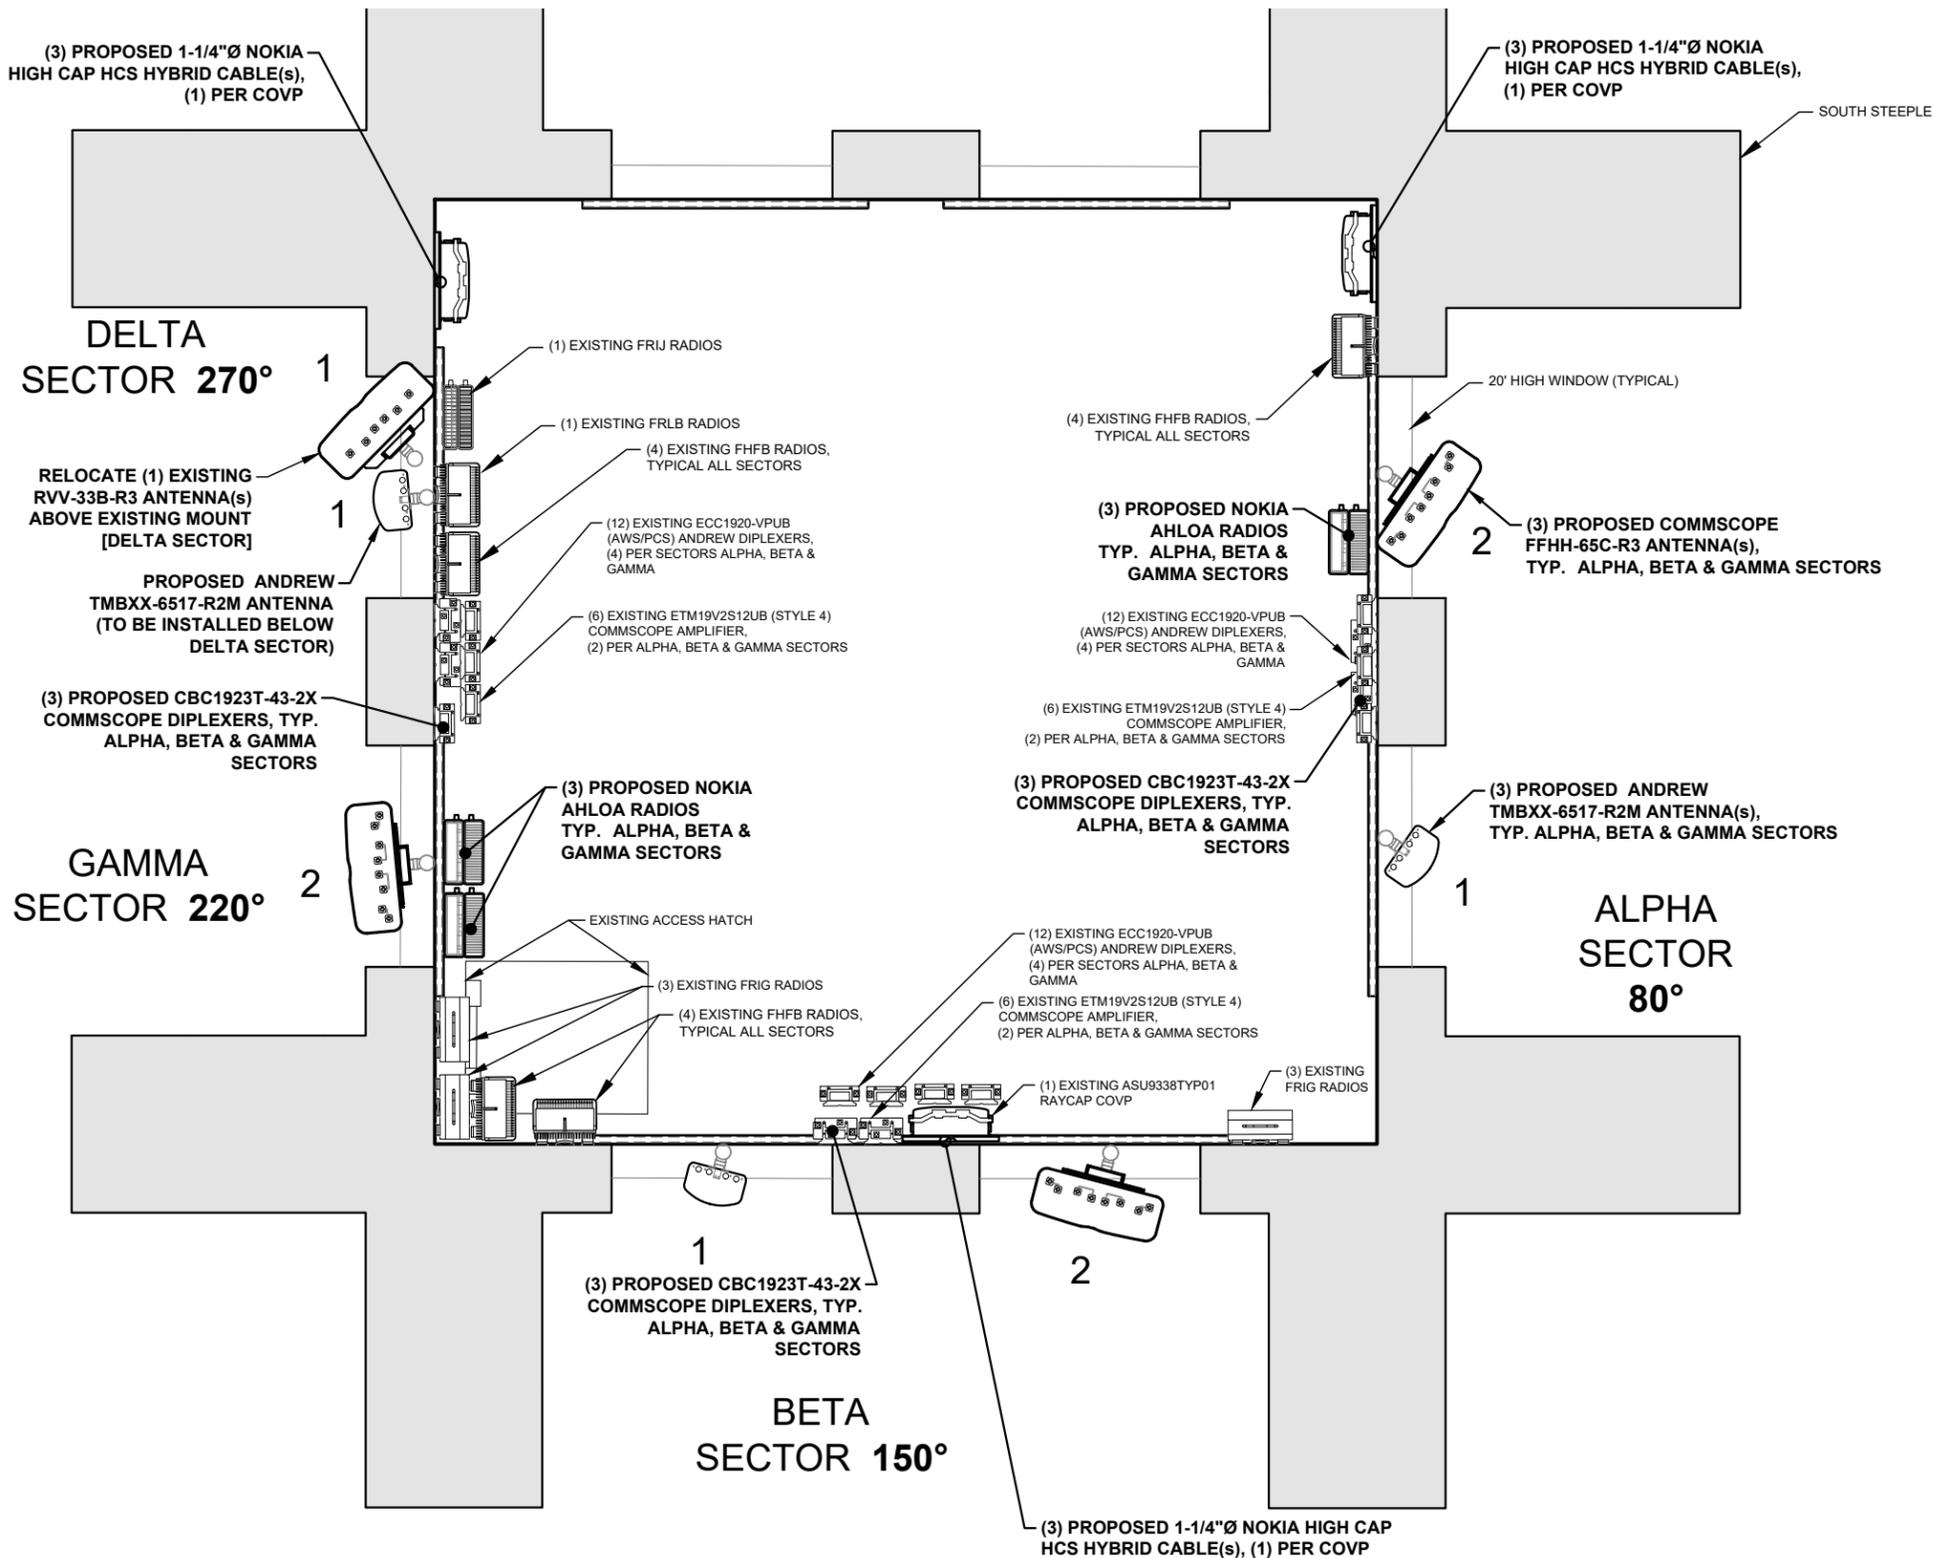

SITE #: DE04229B
 SITE NAME: SWEETEST HEART OF MARY
 SITE ADDRESS: 4440 E. CANFIELD D/B/A 4440 RUSSELL ST. DETROIT, MICHIGAN 48207

Sheet Title:
PROPOSED ANTENNA PLAN

Sheet Number:
C-4

REV.	DATE	DESCRIPTION	BY
A	09/18/18	PRELIMINARY RELEASE	CJL
B	11/02/18	HVAC & STRUCTURAL ADD	CDR

2018 RELOCATION


NOTE: THESE DRAWINGS ARE TO SCALE WHEN PLOTTED ON 11"x17" SHEETS. REFER TO GRAPHIC SCALES ON REPRODUCTIONS.




SITE #: DE04229B
SITE NAME: SWEETEST HEART OF MARY
SITE ADDRESS: 4440 E. CANFIELD D/B/A 4440 RUSSELL ST. DETROIT, MICHIGAN 48207

Sheet Title: **ELEVATION VIEW**

Sheet Number: **C-5**

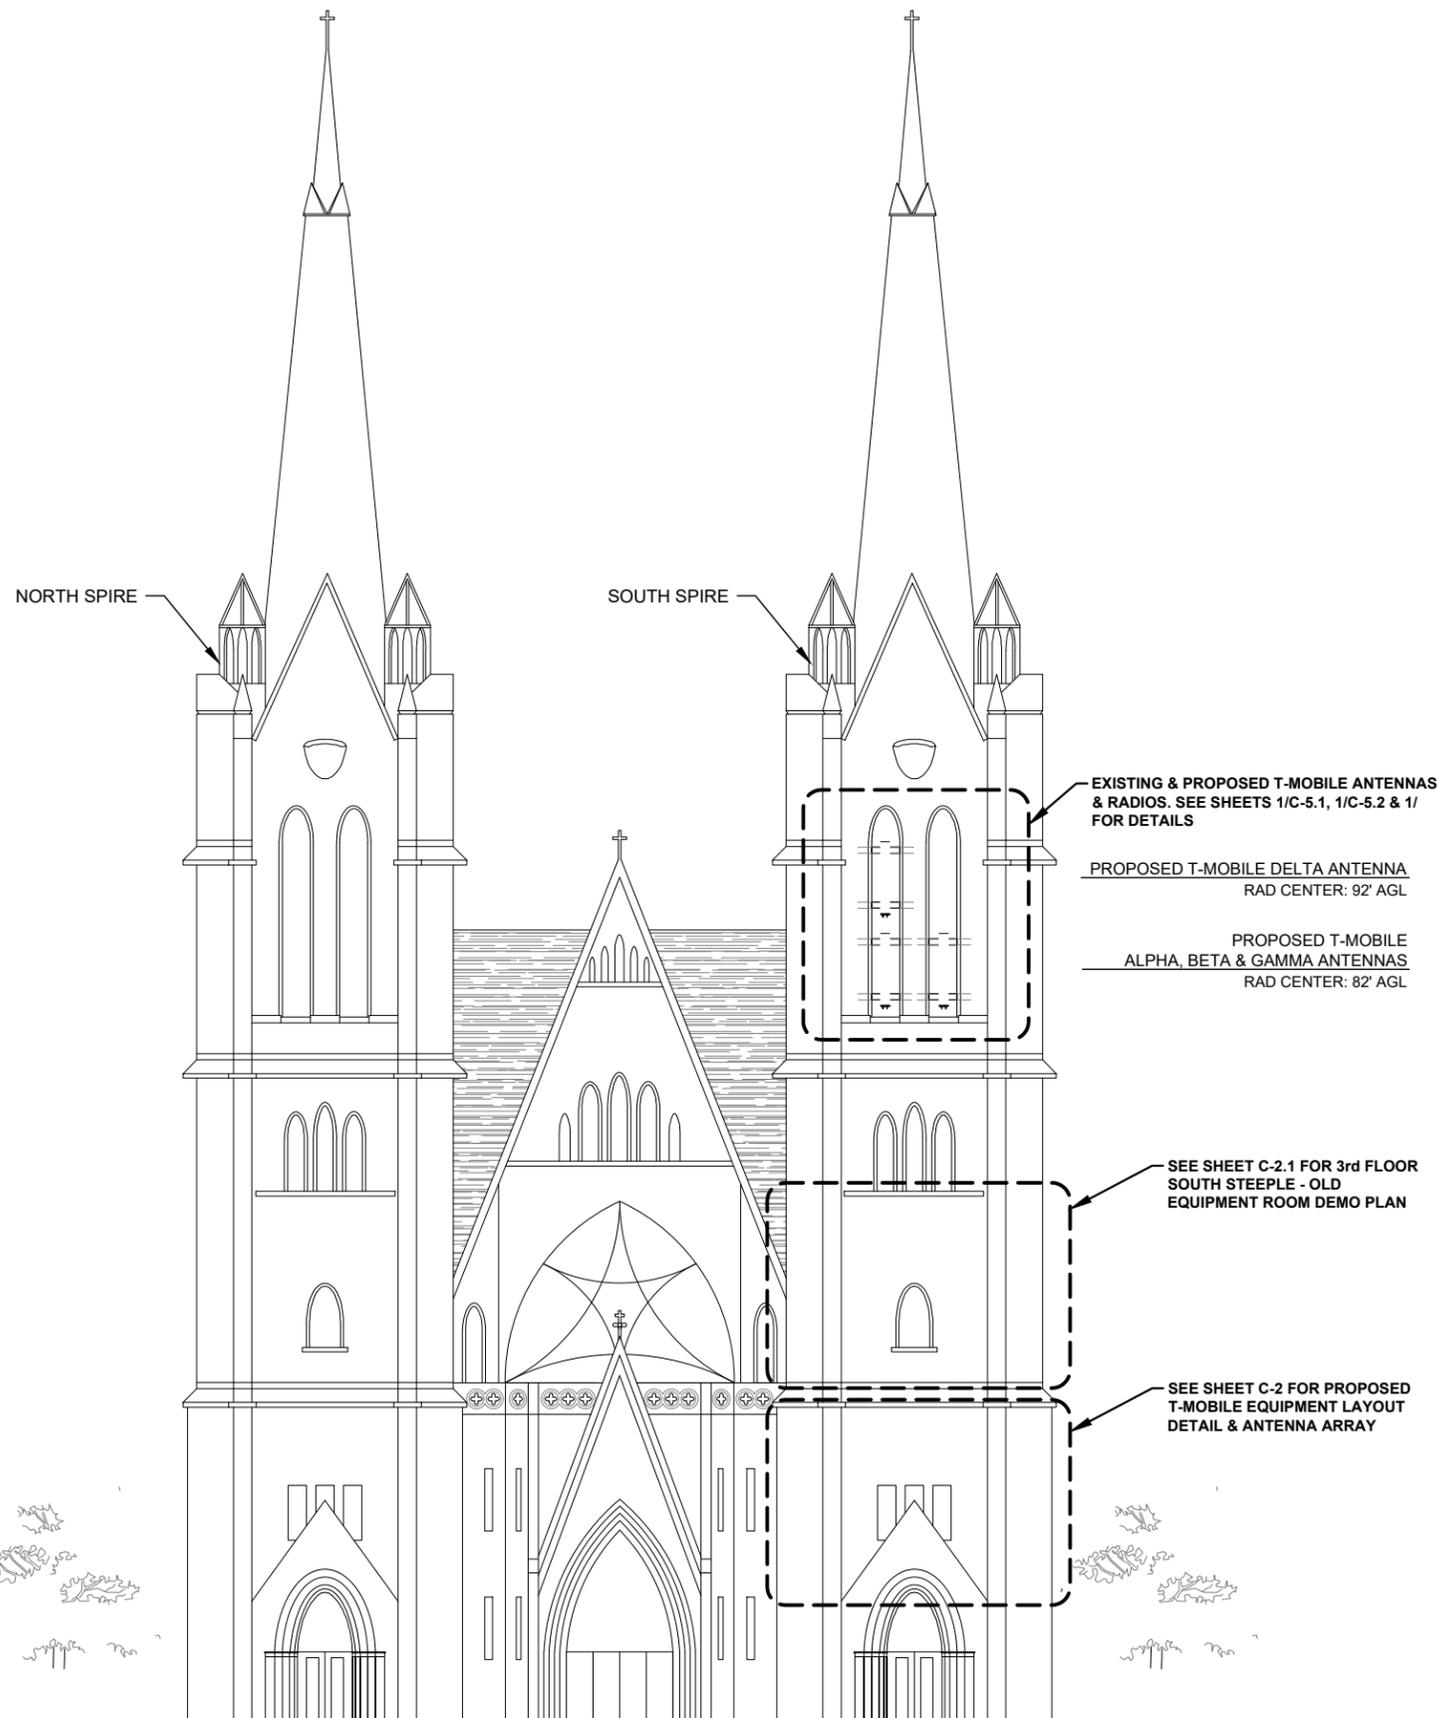

GRADE
WEST ELEVATION VIEW N.T.S. **1**

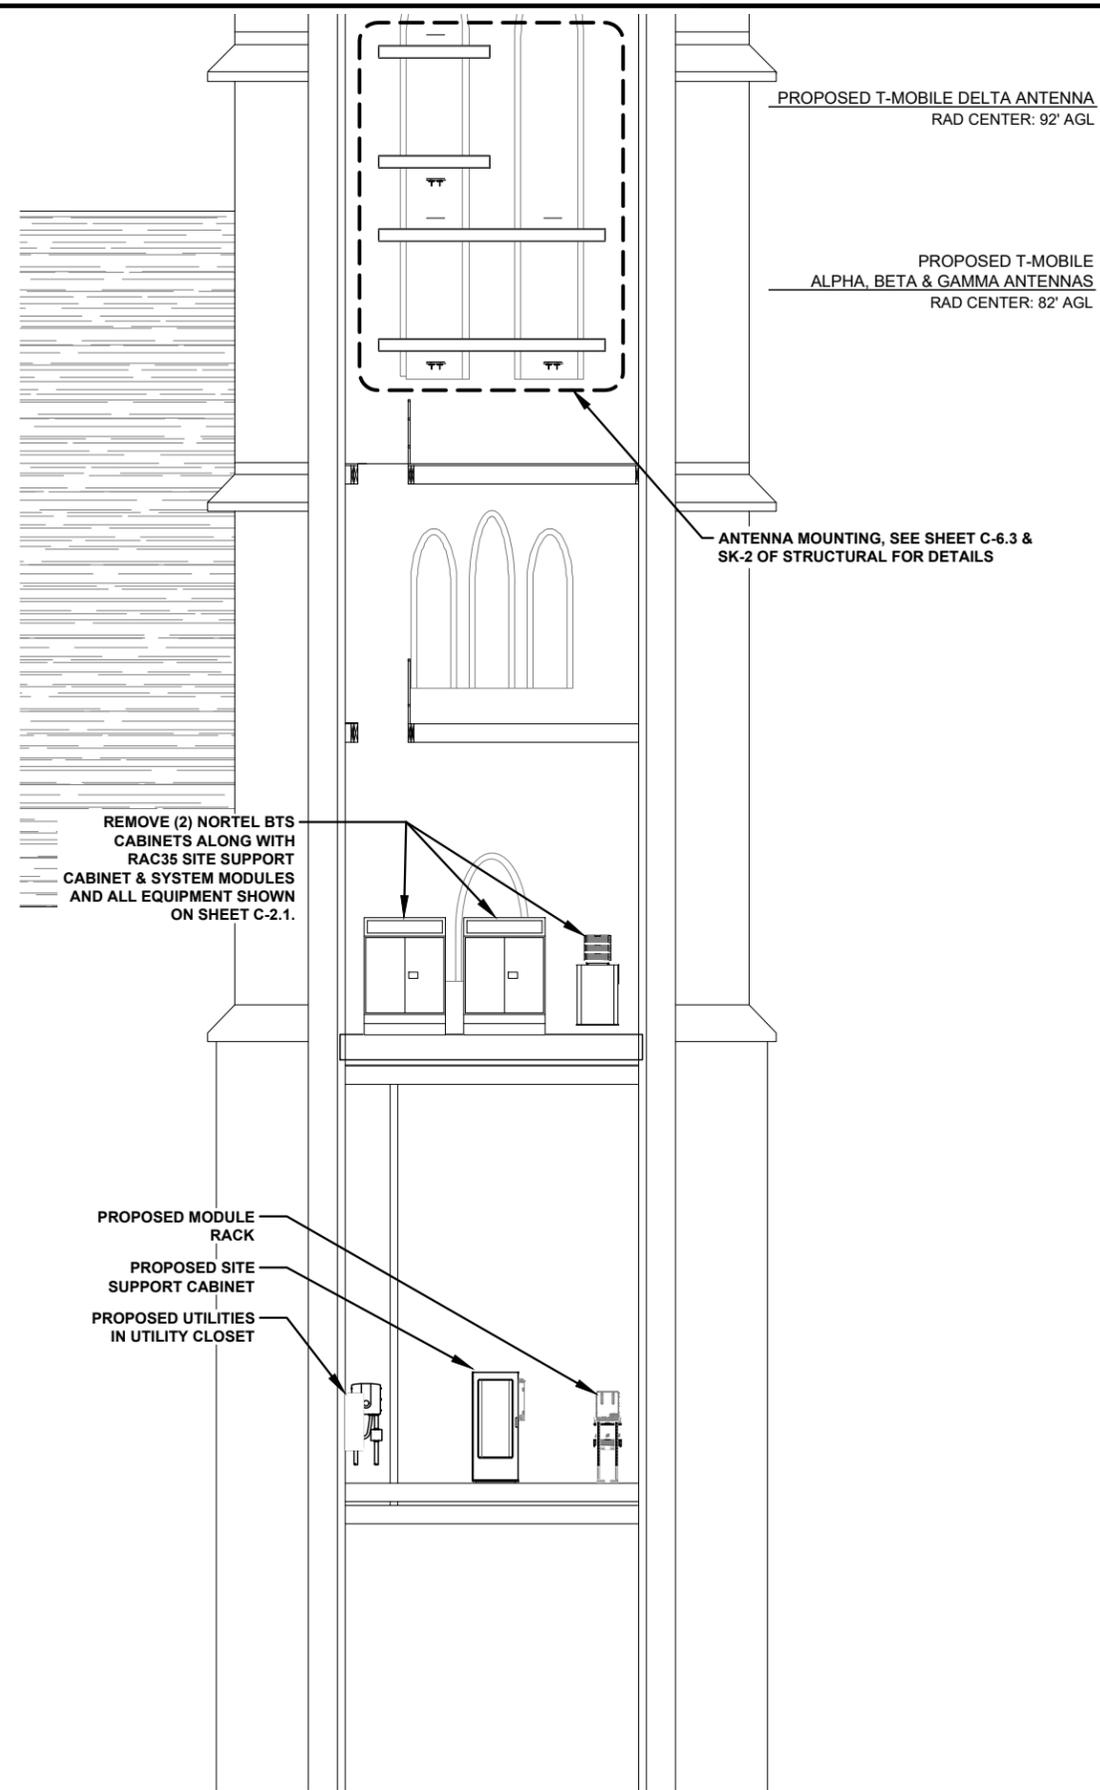

GRADE
NOTE: SOME EQUIPMENT OMITTED FROM ELEVATION VIEW FOR CLARITY
INTERIOR SOUTH SPIRE ELEVATION N.T.S. **2**

PROPOSED T-MOBILE DELTA ANTENNA
RAD CENTER: 92' AGL

PROPOSED T-MOBILE ALPHA, BETA & GAMMA ANTENNAS
RAD CENTER: 82' AGL

ANTENNA MOUNTING, SEE SHEET C-6.3 & SK-2 OF STRUCTURAL FOR DETAILS

REMOVE (2) NORTEL BTS CABINETS ALONG WITH RAC35 SITE SUPPORT CABINET & SYSTEM MODULES AND ALL EQUIPMENT SHOWN ON SHEET C-2.1.

EXISTING & PROPOSED T-MOBILE ANTENNAS & RADIOS. SEE SHEETS 1/C-5.1, 1/C-5.2 & 1/ FOR DETAILS

PROPOSED T-MOBILE DELTA ANTENNA
RAD CENTER: 92' AGL


PROPOSED T-MOBILE ALPHA, BETA & GAMMA ANTENNAS
RAD CENTER: 82' AGL

SEE SHEET C-2.1 FOR 3rd FLOOR SOUTH STEEPLE - OLD EQUIPMENT ROOM DEMO PLAN


SEE SHEET C-2 FOR PROPOSED T-MOBILE EQUIPMENT LAYOUT DETAIL & ANTENNA ARRAY

PROPOSED MODULE RACK
PROPOSED SITE SUPPORT CABINET
PROPOSED UTILITIES IN UTILITY CLOSET


NOTE: SOME EQUIPMENT OMITTED FROM ELEVATION VIEW FOR CLARITY

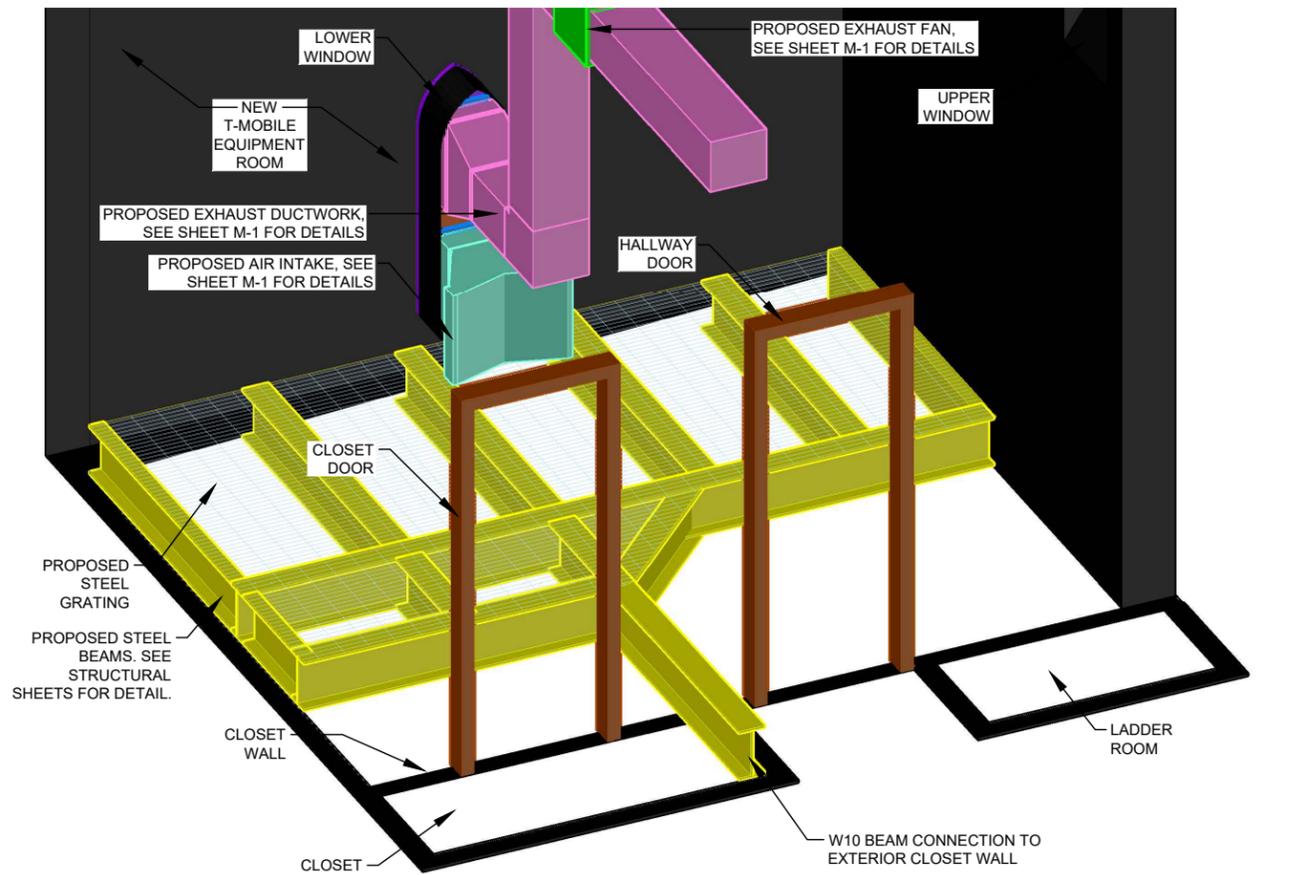

PLATFORM DETAIL N.T.S. **1**

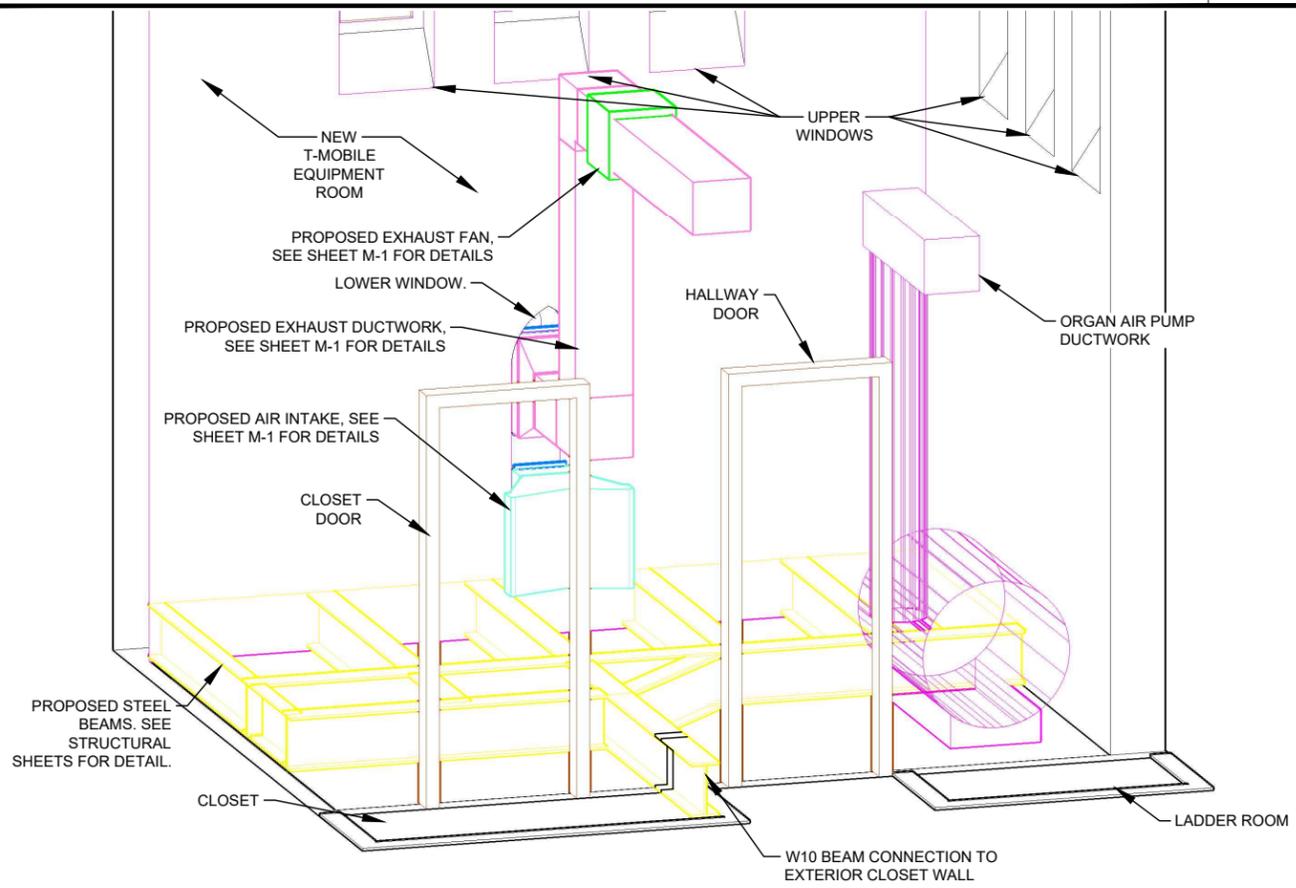

PLATFORM PICTORIAL N.T.S. **2**

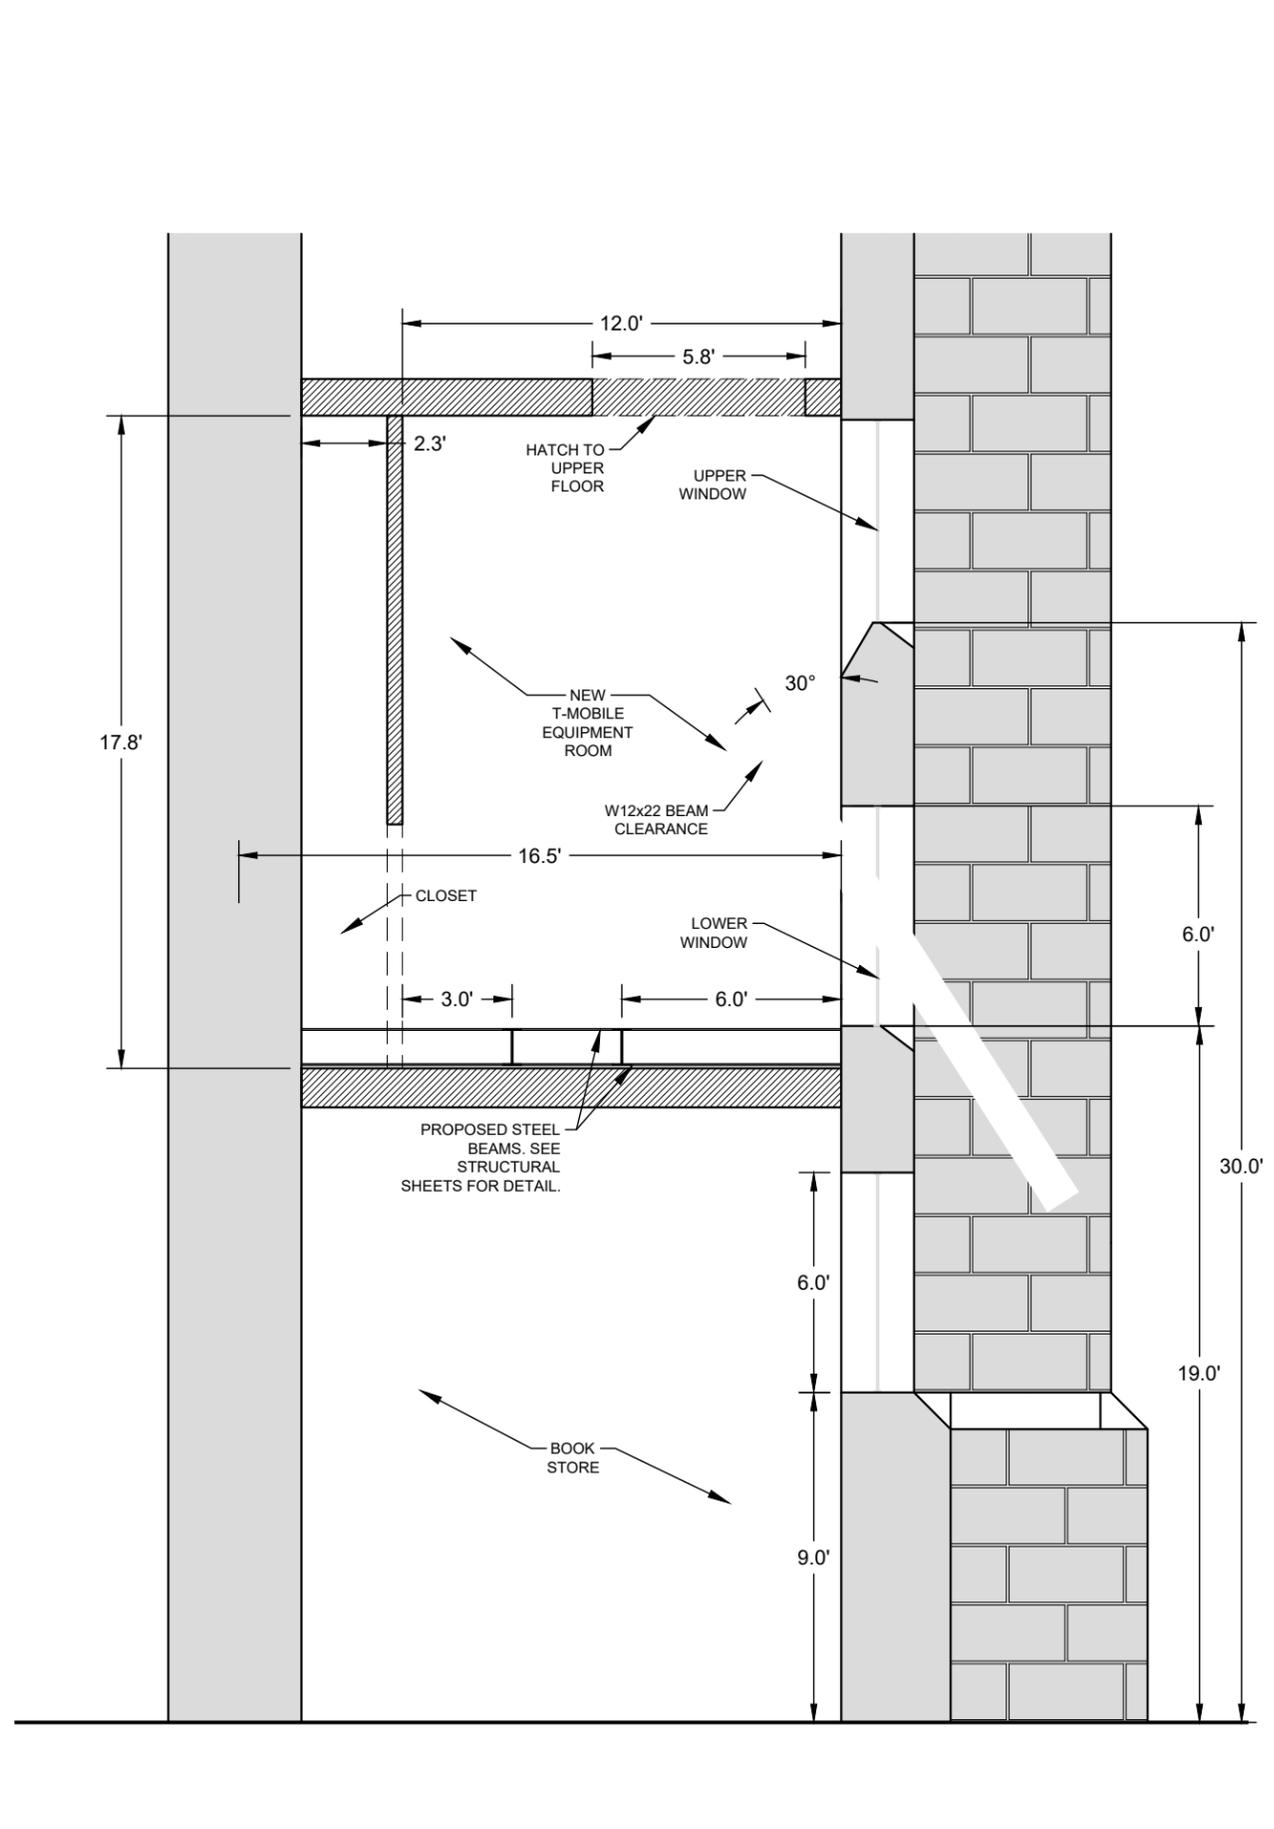

CROSS-SECTION DETAIL A-A 1"=5' **3**

T-Mobile
 28505 SCHOOLCRAFT RD, BLDG#6
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 Fax: 734.367.7242
 CONTACT: KEN KALOUSEK
 (734) 444-0181

LANDTECH PROJECT NUMBER: 18323064

REV.	DATE	DESCRIPTION	BY
B	11/02/18	HVAC & STRUCTURAL ADD	CDR

2018 RELOCATION

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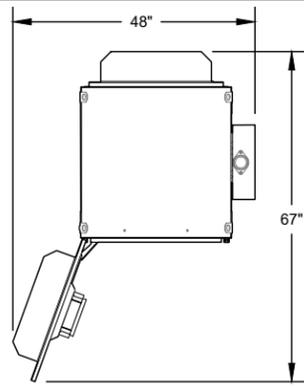


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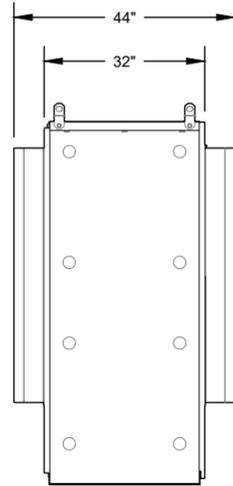
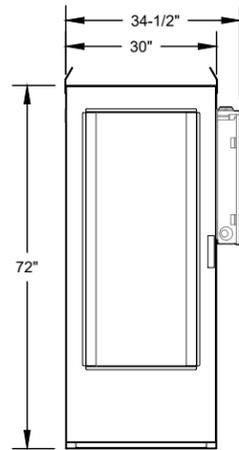
SITE #: DE04229B
 SITE NAME: SWEETEST HEART OF MARY
 SITE ADDRESS: 4440 E. CANFIELD D/B/A 4440 RUSSELL ST. DETROIT, MICHIGAN 48207

Sheet Title: **PICTORIAL VIEWS**

Sheet Number: **C-5.2**



PROPERTY	VALUE	PROPERTY
HEIGHT	72 in (876 mm)	BASIC CABINET: ENCLOSURE, DC POWER PLANT W/OUT LIFTING BRACKETS
WIDTH	30 in (762 mm)	BASIC CABINET: ENCLOSURE, DC POWER PLANT
WIDTH W/AC LOAD CENTER	34-1/2 in (835 mm)	BASIC CABINET: ENCLOSURE, DC POWER PLANT W/ AC SIDE MOUNTED LOAD CENTER
DEPTH	32 in (813 mm)	BASIC CABINET: ENCLOSURE, DC POWERPLANT
DEPTH WITH SHROUNDS	44 in (1118 mm)	BASIC CABINET: ENCLOSURE, W/ FRONT AND REAR DAC SHROUNDS



PURCELL SSC (MERV 13) N.T.S. **1**



MANUFACTURER: NOKIA
 MODEL: AMOB SUBRACK

SUBMODULE CAPACITY: (2) ASIA (6) ABIA

DIMENSIONS: 23.8"x19.1"x13.9"


WEIGHT: 23 kg ENCLOSURE 41 kg FULL CAPACITY

POWER TYPICAL MAX: 265 WATTS
 COLD START: 600 WATTS

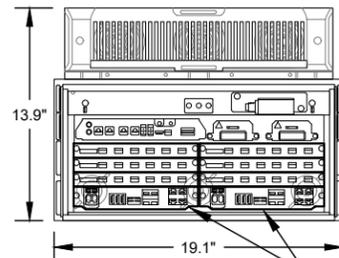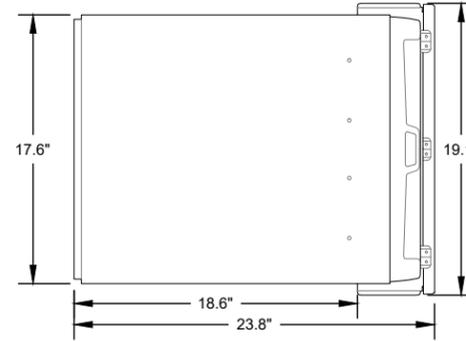


(2) ABIA; (6) ASIA SUBMODULES

AMOB AIRSCALE SUBRACK N.T.S. **2**

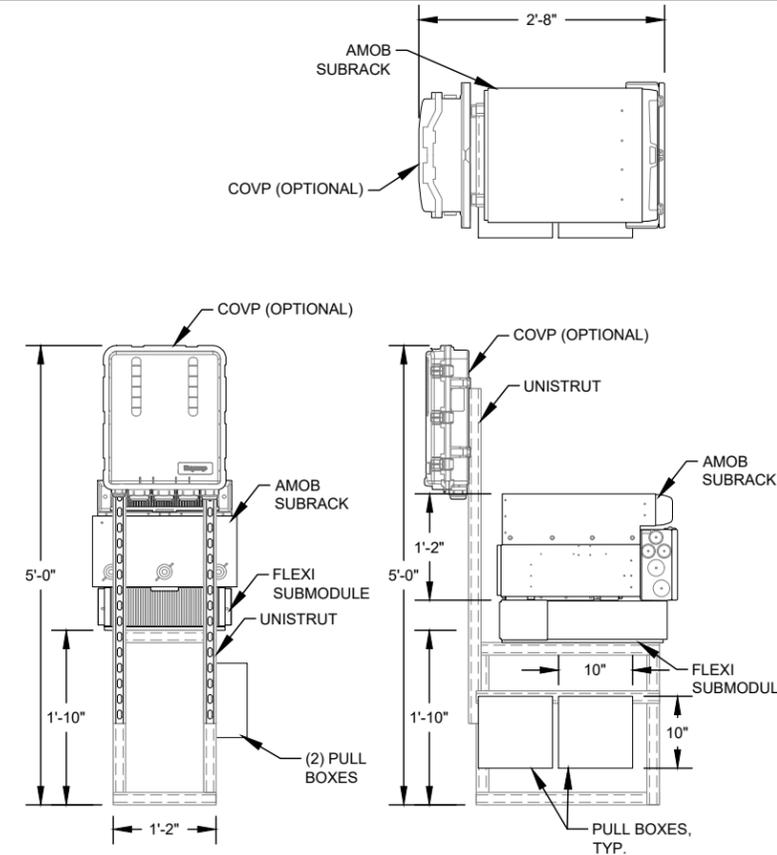

UNISTRUT CHAIR N.T.S. **3**


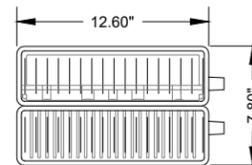


MANUFACTURER: NOKIA
 MODEL: AHLOA
 FREQUENCY: 600 MHz

DIMENSIONS w/ SOLAR SHIELD: 22.1" x 12.2" x 7.5"

WEIGHT w/ BRACKET & SOLAR SHIELD: 83.9 lbs

CONNECTORS: (2) OPTICAL (1) DIN FEMALE (DC POWER)

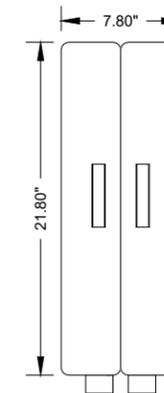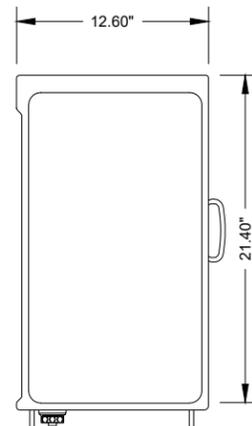

AHLOA RADIO UNIT N.T.S. **5**

INTENTIONALLY OMITTED N.T.S. **4**

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 Fax: 734.367.7242
 CONTACT: KEN KALOUSEK (734) 444-0181

LANDTECH PROJECT NUMBER: 18323064

REV.	DATE	DESCRIPTION	BY
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2018 RELOCATION


NOTE: THESE DRAWINGS ARE TO SCALE WHEN PLOTTED ON 11"x17" SHEETS. REFER TO GRAPHIC SCALES ON REPRODUCTIONS.



SITE #: DE04229B
 SITE NAME: SWEETEST HEART OF MARY
 SITE ADDRESS: 4440 E. CANFIELD D/B/A 4440 RUSSELL ST. DETROIT, MICHIGAN 48207


Sheet Title: **EQUIPMENT DETAILS**

Sheet Number: **C-6**

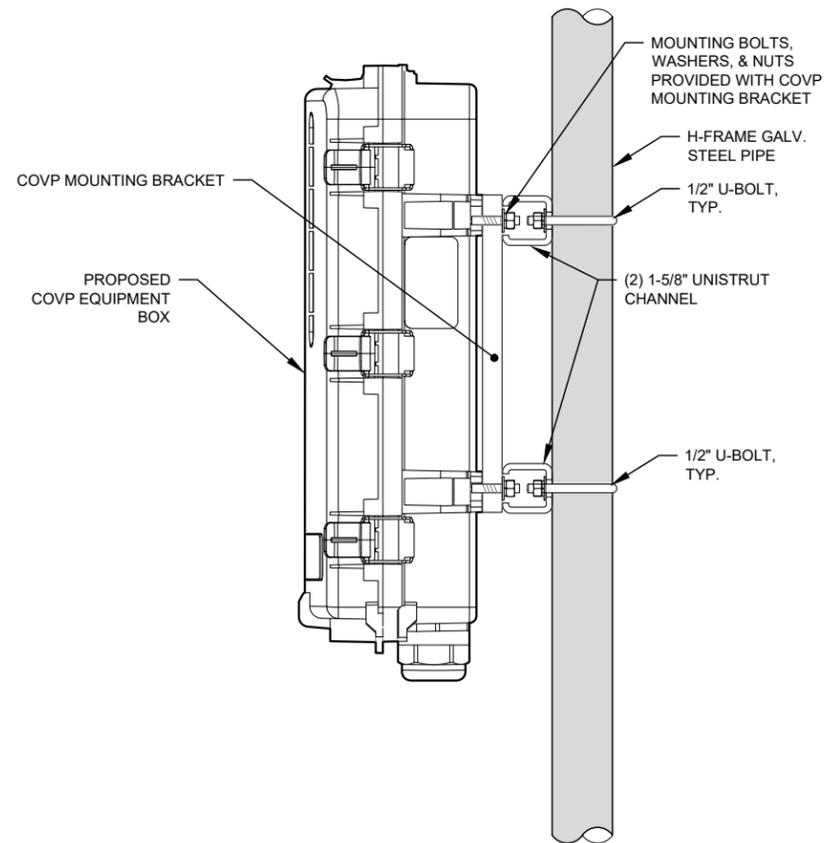


COVP MOUNTING DETAIL N.T.S.

1

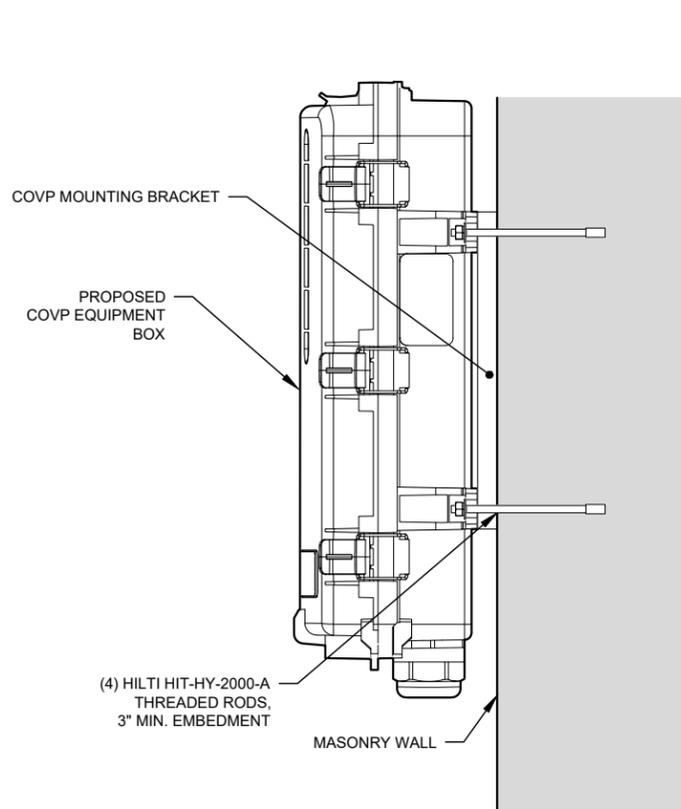


COVP MOUNTING DETAIL N.T.S.

2

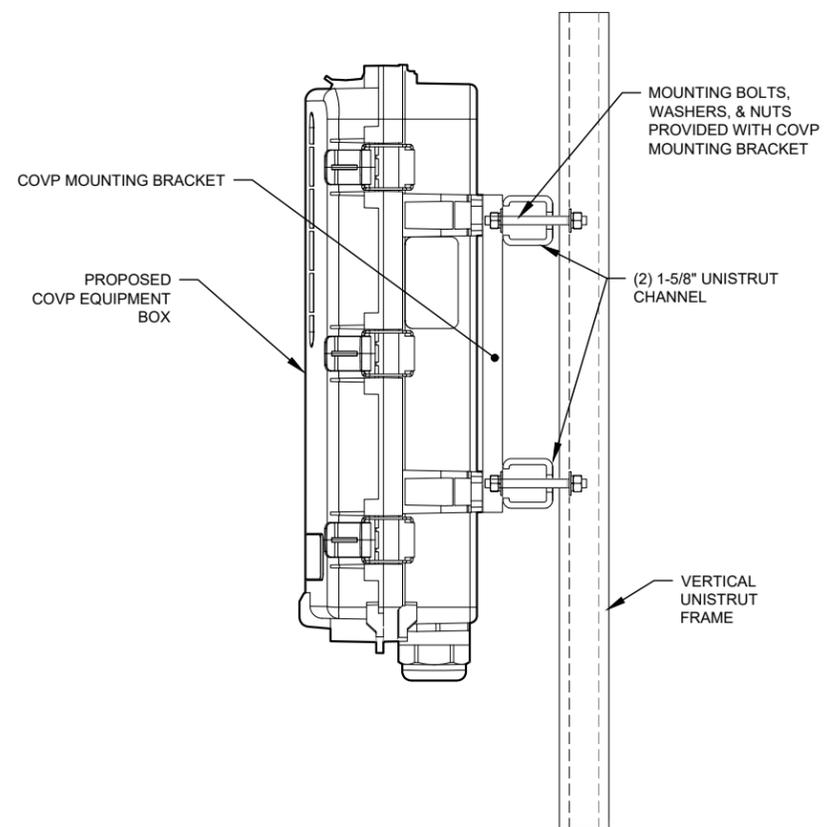


COVP MOUNTING DETAIL N.T.S.

3

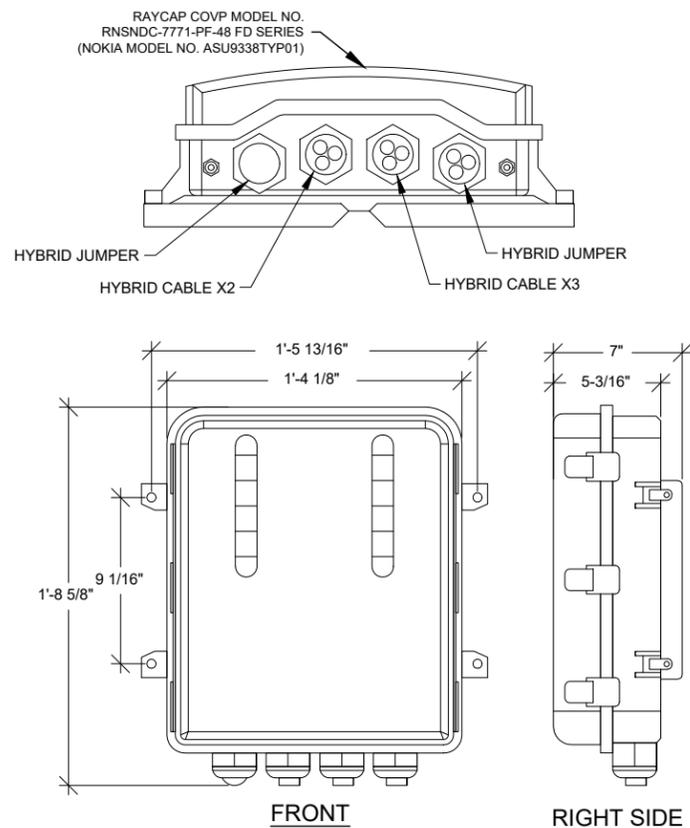


COVP DETAILS N.T.S.

4

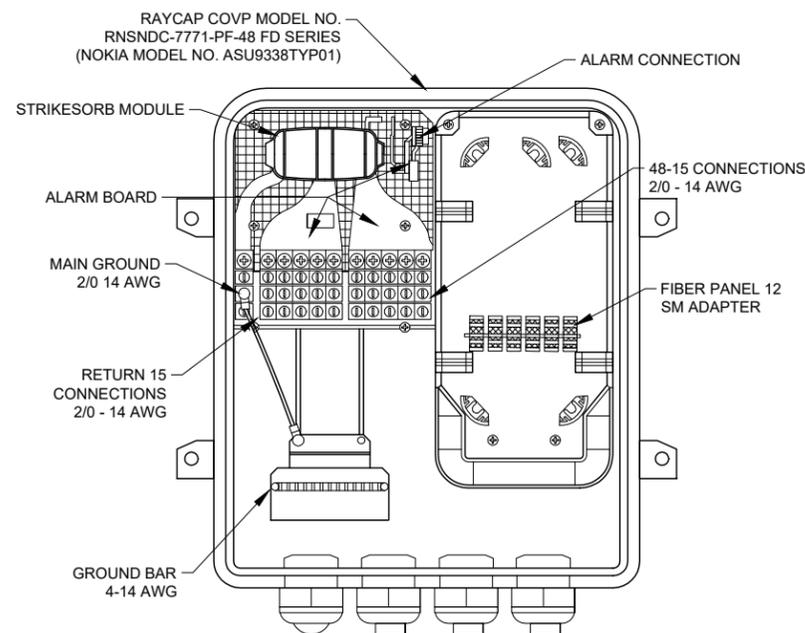

COVP WIRING DIAGRAM N.T.S.

5

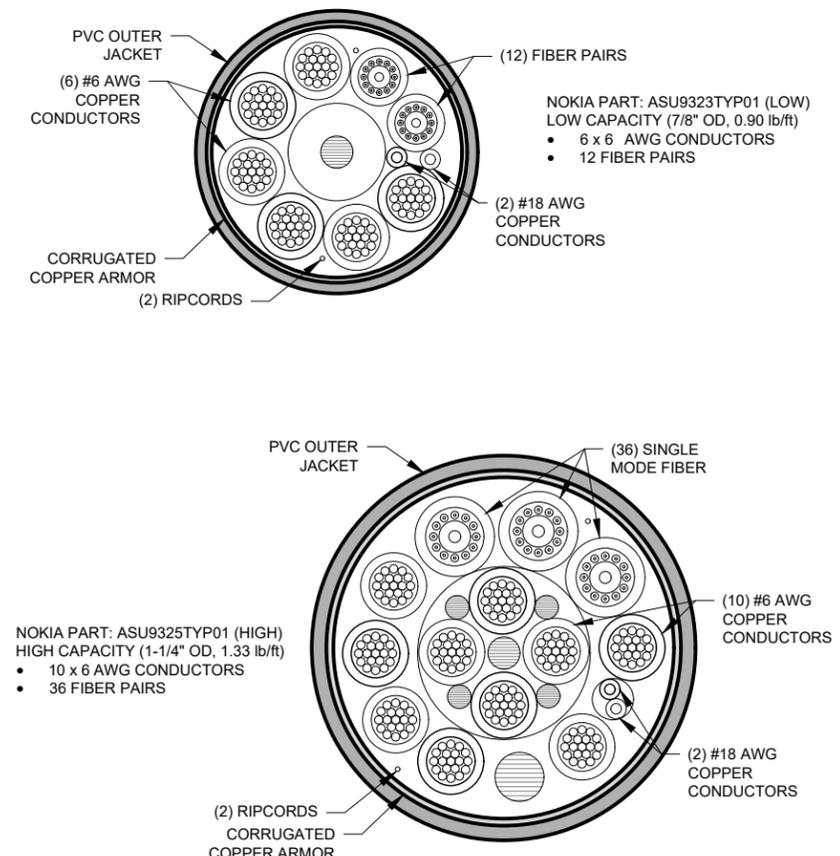

HYBRID CABLE SECTION N.T.S.

6

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LANDTECH PROJECT NUMBER: **18323064**

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2018 RELOCATION

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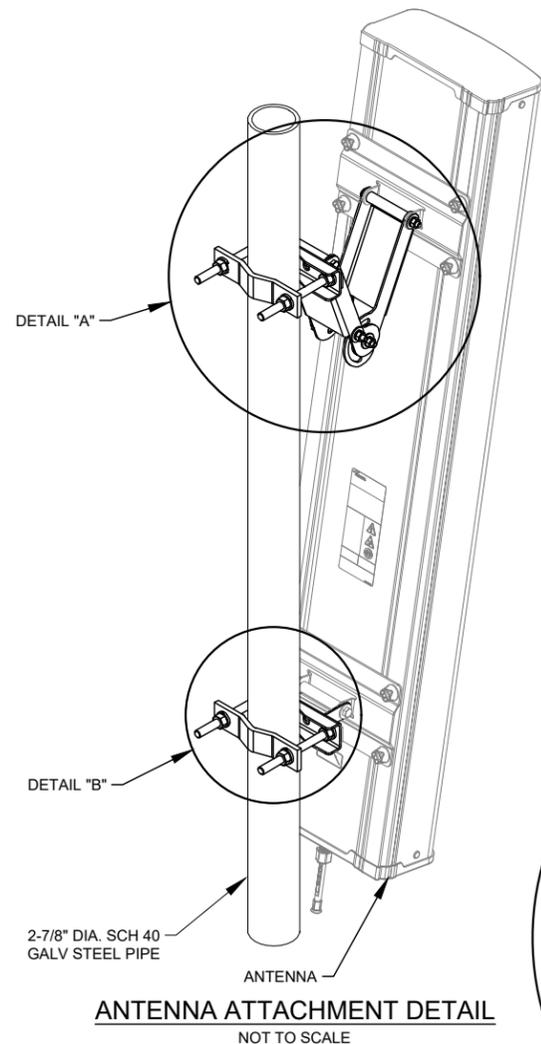
SITE #: DE04229B
 SITE NAME: SWEETEST HEART OF MARY
 SITE ADDRESS: 4440 E. CANFIELD D/B/A 4440 RUSSELL ST. DETROIT, MICHIGAN 48207

Sheet Title: **EQUIPMENT DETAILS**




Sheet Number: **C-6.1**

PARTS LIST


ITEM #	QUANTITY	PART NUMBER	DESCRIPTION
1	2	601257	ANGLE ARM
2	2	601256	MOUNTING CLAMP
3	2	601235-1	BRACKET
4	2	601235-2	BRACKET
5	1	601258	LABEL, ANGLE
6	4	600679-3	SPACER TUBE
7	14	100525-24	ME FLAT WASHER (STAINLESS STEEL)
8	2	600419-8	M8x1.25x25mm LARGE CARRIAGE BOLT (STAINLESS STEEL)
9	6	6/1/7395	M8 LOCK WASHER (STAINLESS STEEL)
10	4	600419-10	M8x1.25x110mm LARGE HEX HEAD SCREW (STAINLESS STEEL)
11	6	204001-15	M8x1.25 HEX NUT (STAINLESS STEEL)
12	2	225244	CLAMP PLATE
13	8	600419-24	LARGE LOCK WASHER (STAINLESS STEEL)
14	8	204001-21	M12x1.75 HEX NUT (STAINLESS STEEL)
15	4	600419-12	M12x1.75x150mm LARGE CARRIAGE BOLT (STAINLESS STEEL)
17	1	601584	MOLYBDENUM DISULFIDE GREASE



NOTE: TORQUE ALL HARDWARE
M8 HARDWARE: 18 Nm (160 lbf-in.)
M12 HARDWARE: 30 Nm (266 lbf-in.)

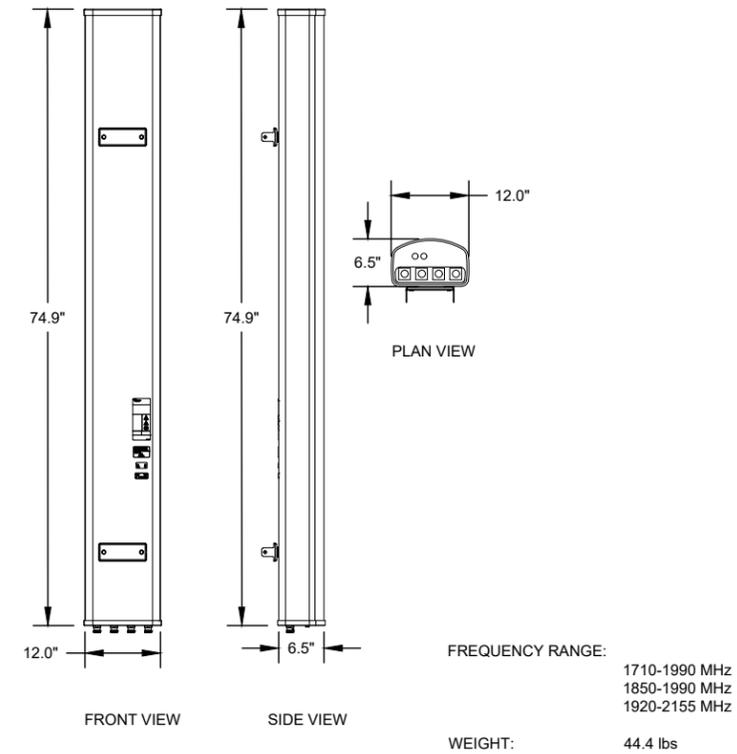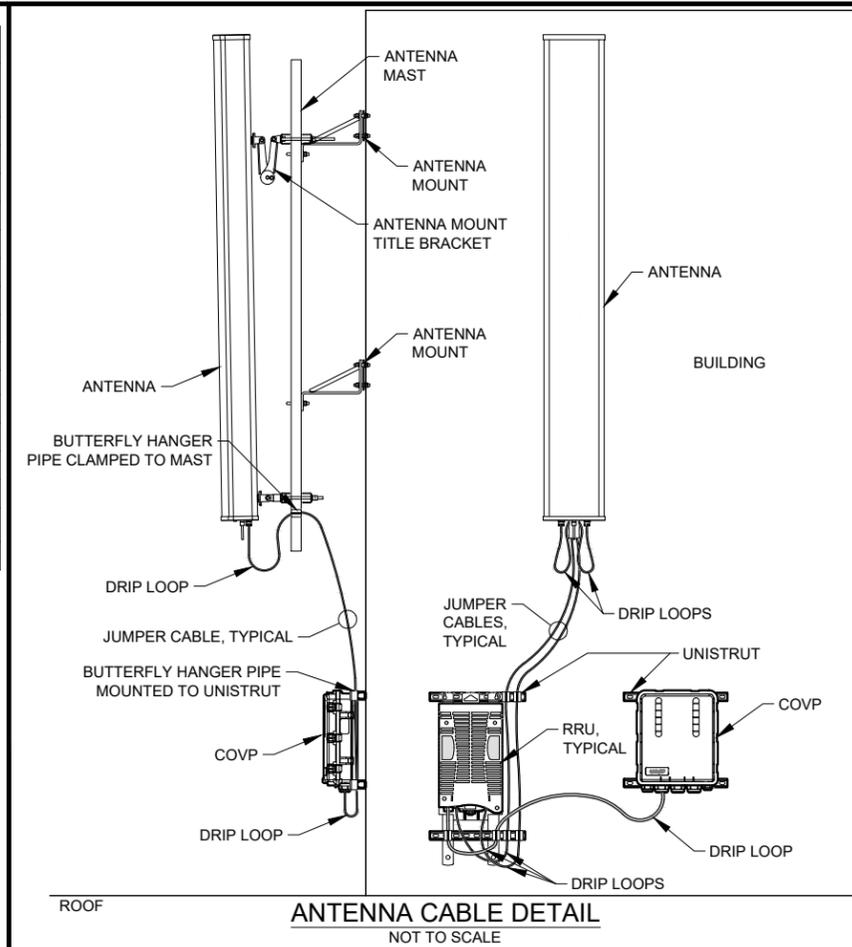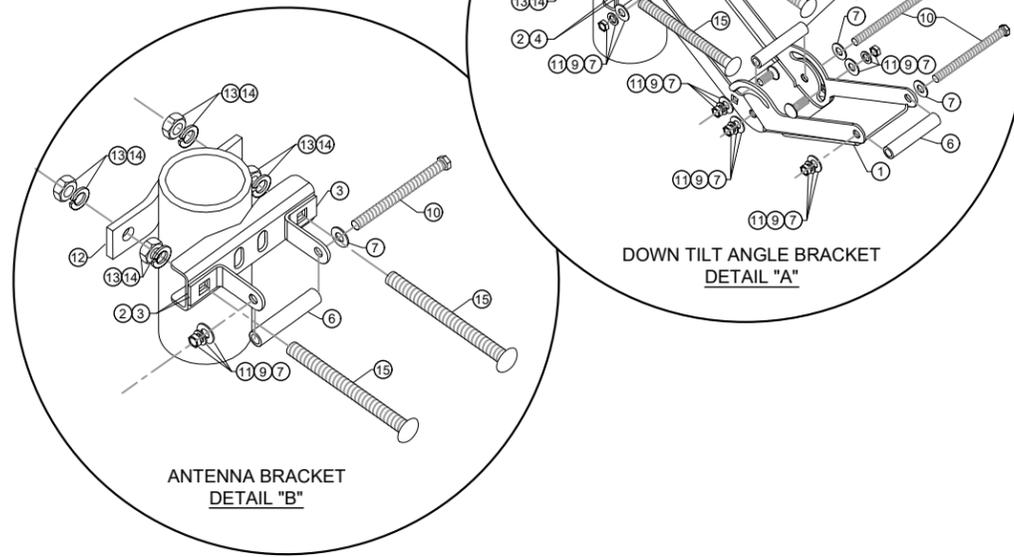

ANDREW TMBXX-6517-R2M ANTENNA
NOT TO SCALE

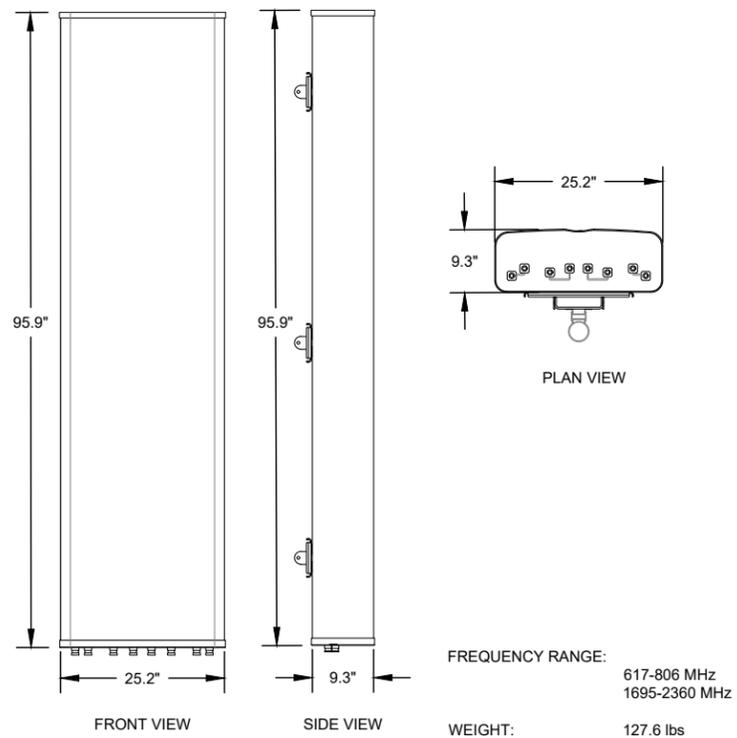

COMMSCOPE FFHH-65C-R3 ANTENNA
NOT TO SCALE

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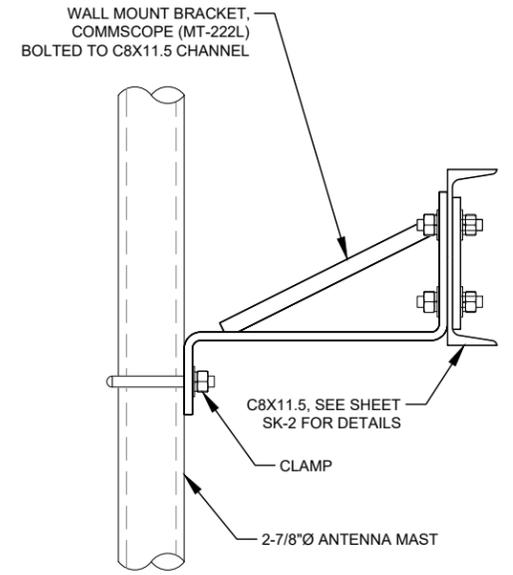


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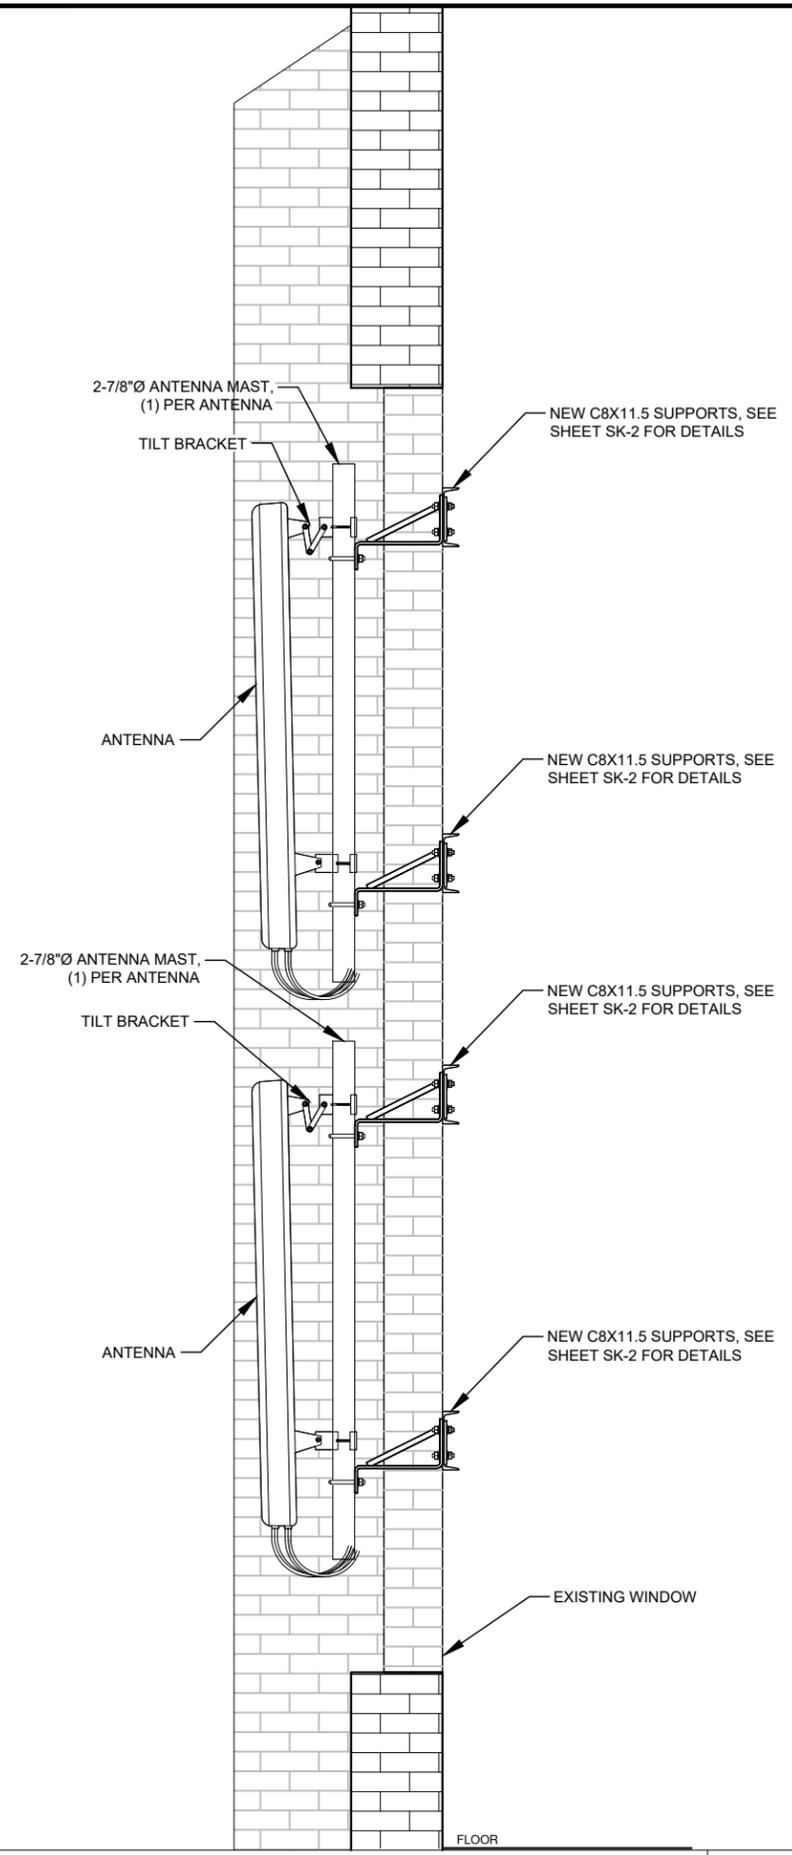
Sheet Title: **ANTENNA DETAILS**

Sheet Number: **C-6.2**


**PAIN T ALL ANTENNAS,
CABLING & HARDWARE
VISIBL E OUTSID E BLACK.**




TYP. MAST BRACKET



ANTENNA MOUNT N.T.S. 1

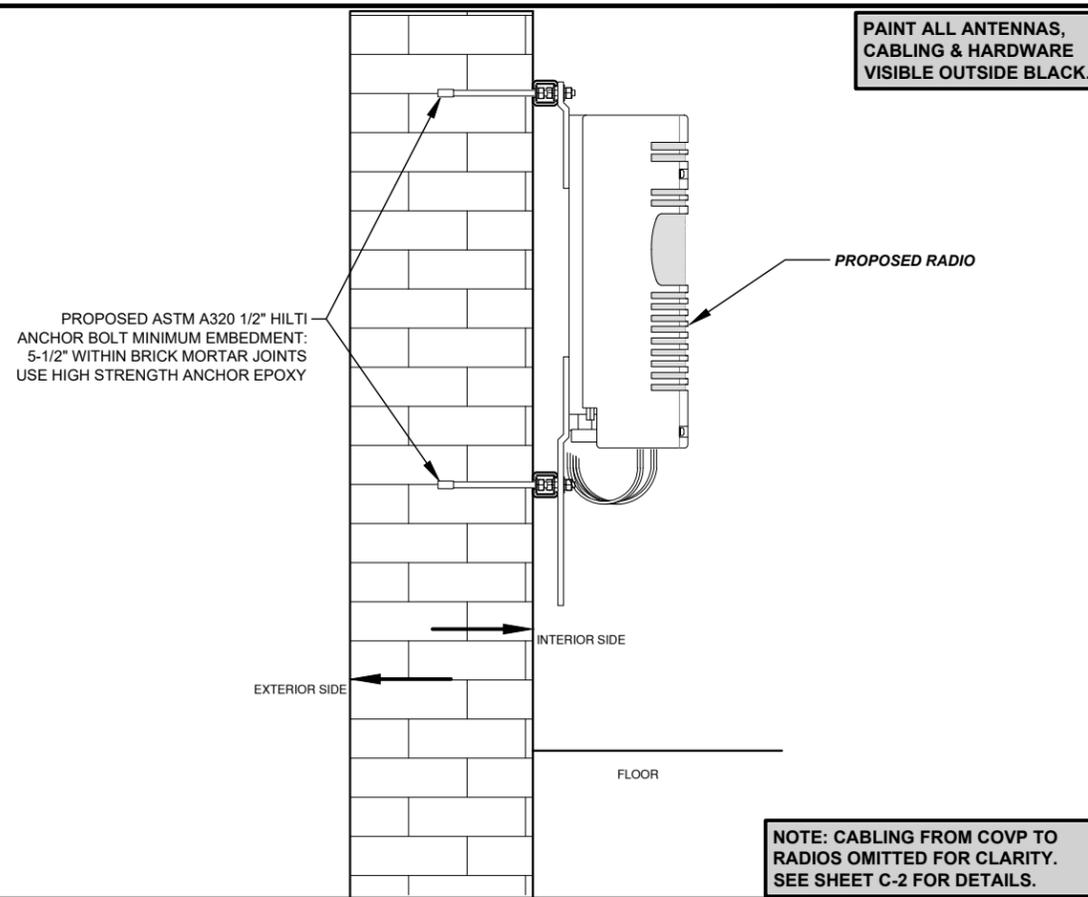

HYBRID CABLE ELEV. N.T.S. 2

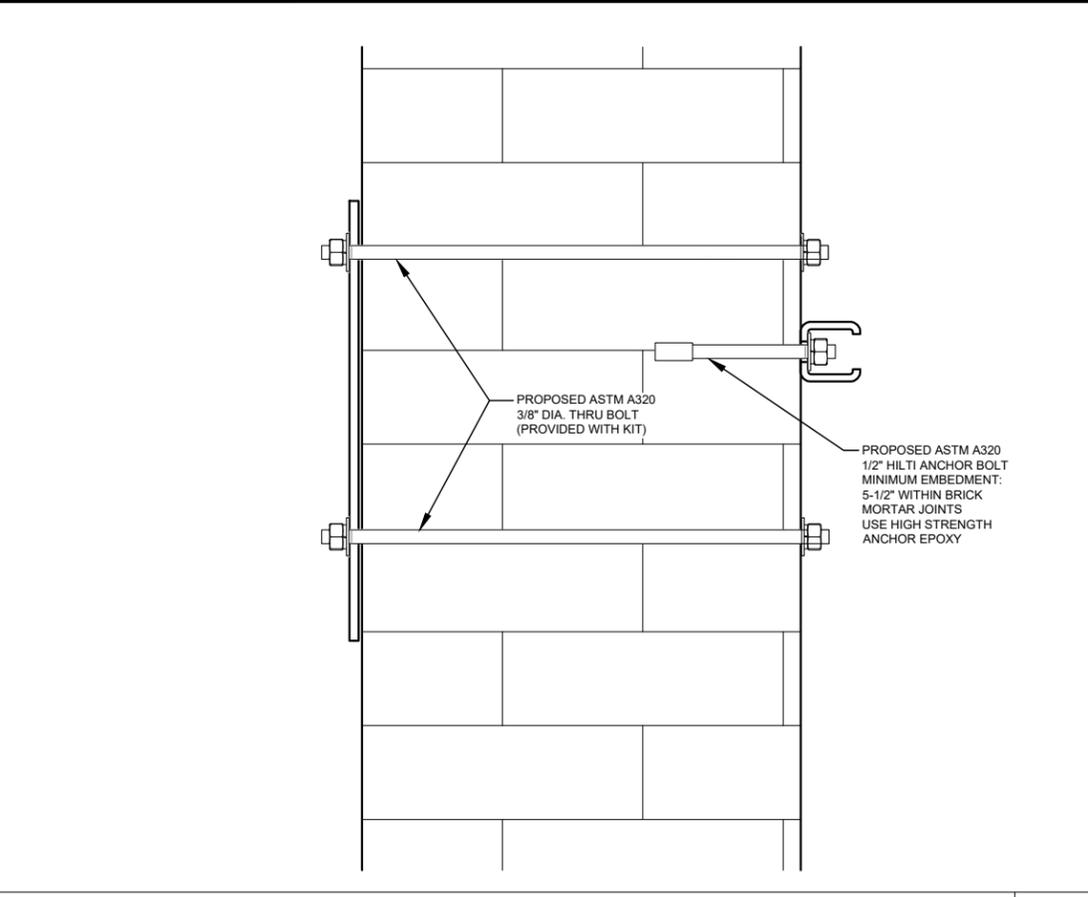

MORTOR JOINT DETAIL N.T.S. 3

T-Mobile
28505 SCHOOLCRAFT RD, BLDG#6
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SITE NAME: **SWEETEST HEART OF MARY**
SITE ADDRESS: **4440 E. CANFIELD D/B/A 4440 RUSSELL ST. DETROIT, MICHIGAN 48207**

Sheet Title: **MOUNTING DETAILS**

Sheet Number: **C-6.3**

LANDTECH PROJECT NUMBER: 18323064

REV.	DATE	DESCRIPTION	BY
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2018 RELOCATION


NOTE: THESE DRAWINGS ARE TO SCALE WHEN PLOTTED ON 11"x17" SHEETS. REFER TO GRAPHIC SCALES ON REPRODUCTIONS.



SITE #: DE04229B
 SITE NAME: SWEETEST HEART OF MARY
 SITE ADDRESS: 4440 E. CANFIELD D/B/A 4440 RUSSELL ST. DETROIT, MICHIGAN 48207

Sheet Title: PLATFORM STRUCTURAL PLAN

Sheet Number: SK-1

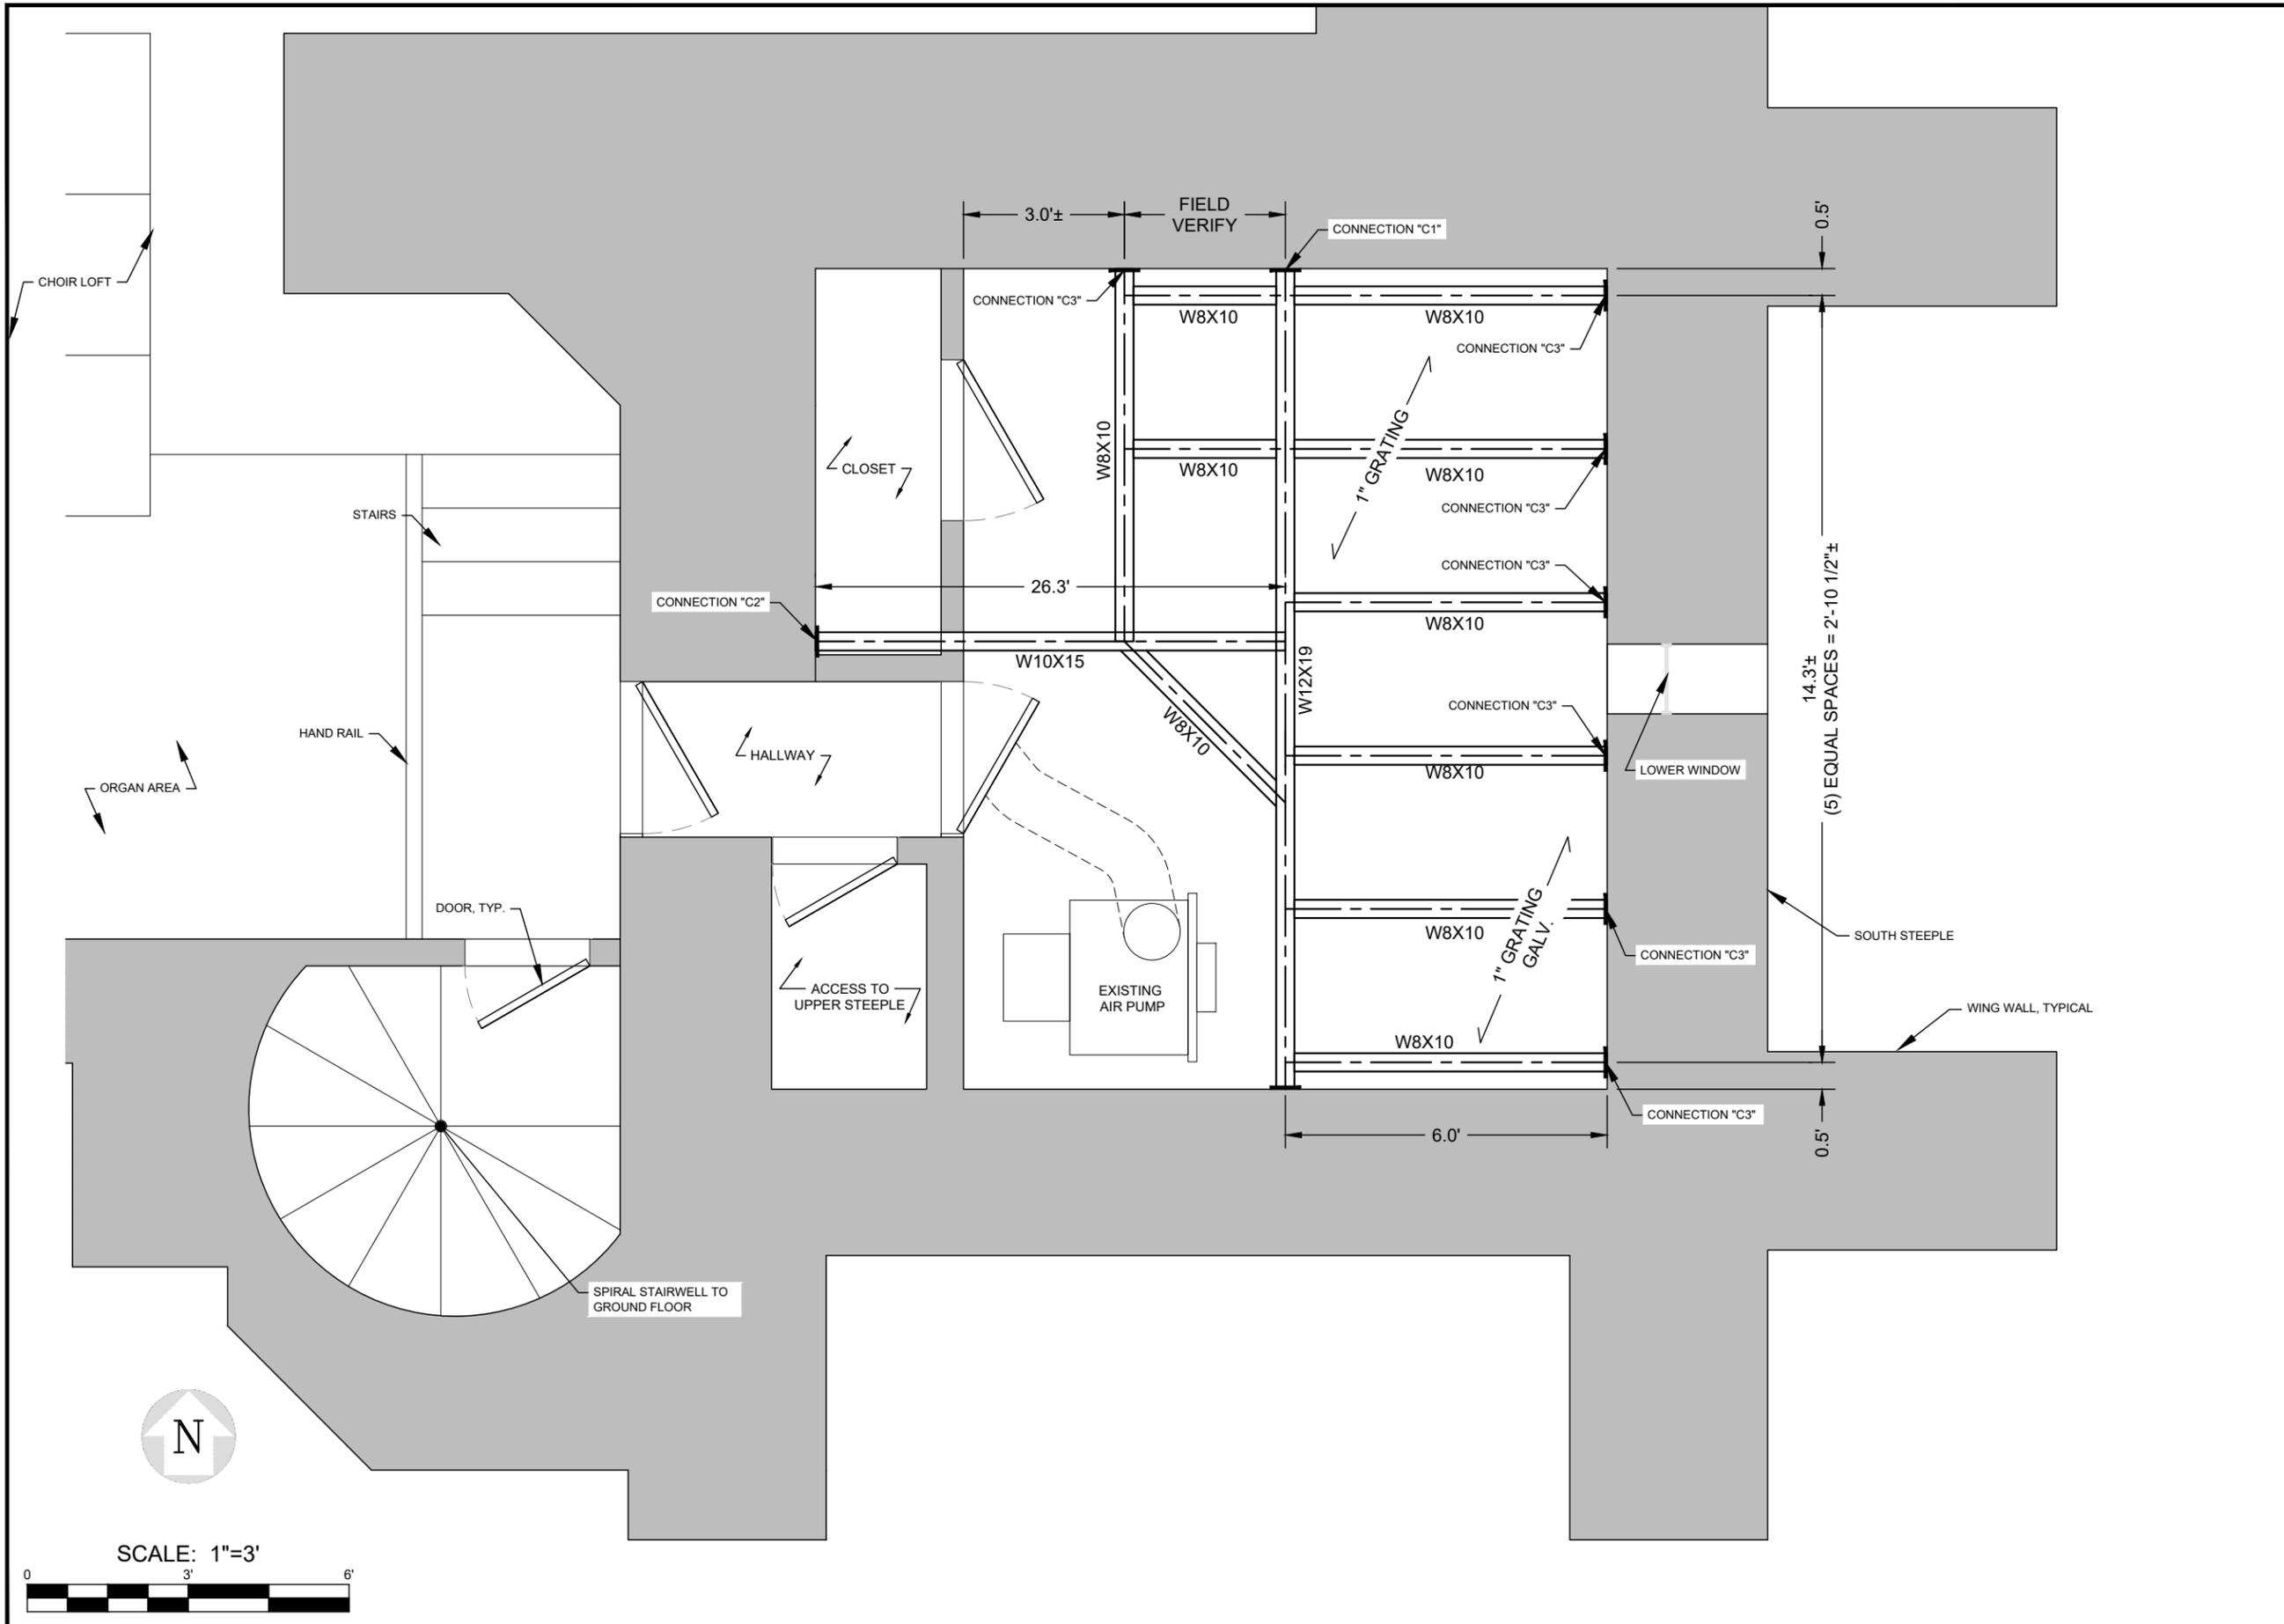


LANDTECH PROJECT NUMBER: **18323064**


REV.	DATE	DESCRIPTION	BY
A	09/18/18	PRELIMINARY RELEASE	CJL
B	11/02/18	HVAC & STRUCTURAL ADD	CDR

2018 RELOCATION


NOTE: THESE DRAWINGS ARE TO SCALE WHEN PLOTTED ON 11"x17" SHEETS. REFER TO GRAPHIC SCALES ON REPRODUCTIONS.

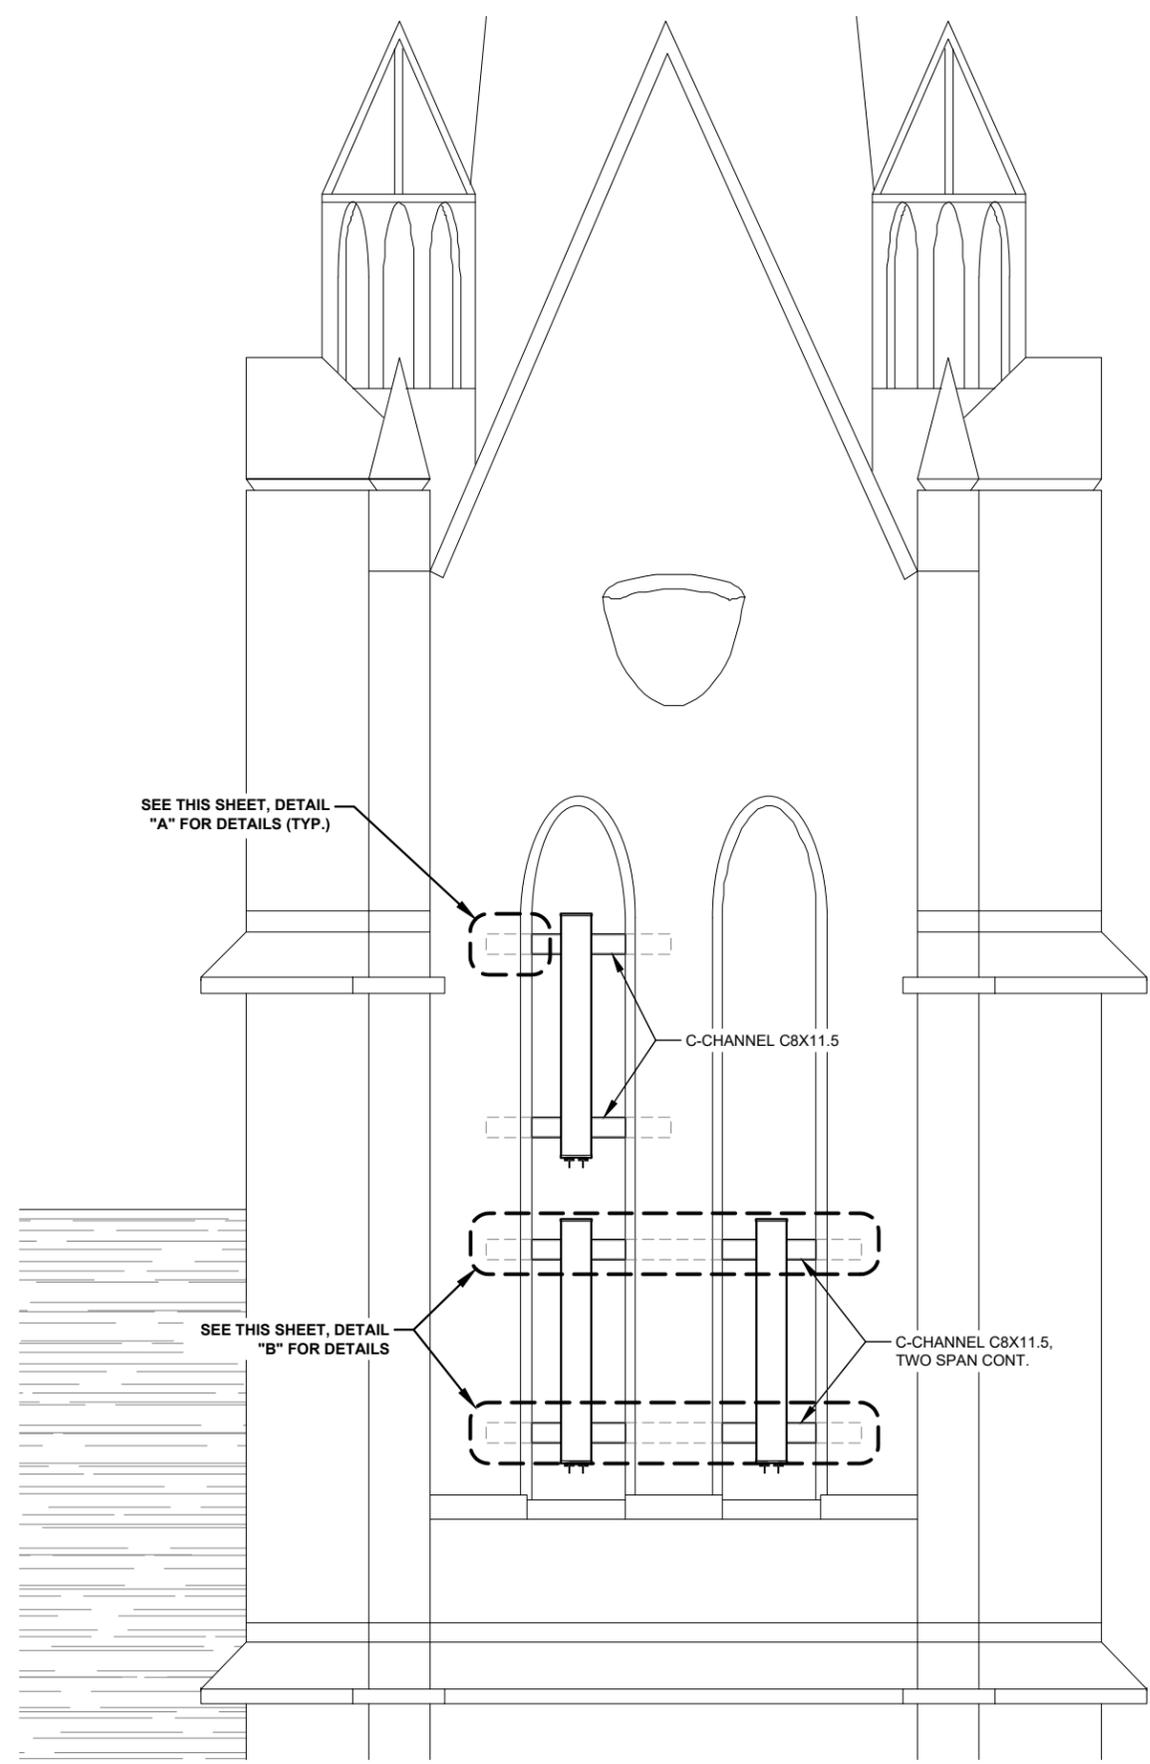

PLATFORM DETAILS N.T.S. **1**

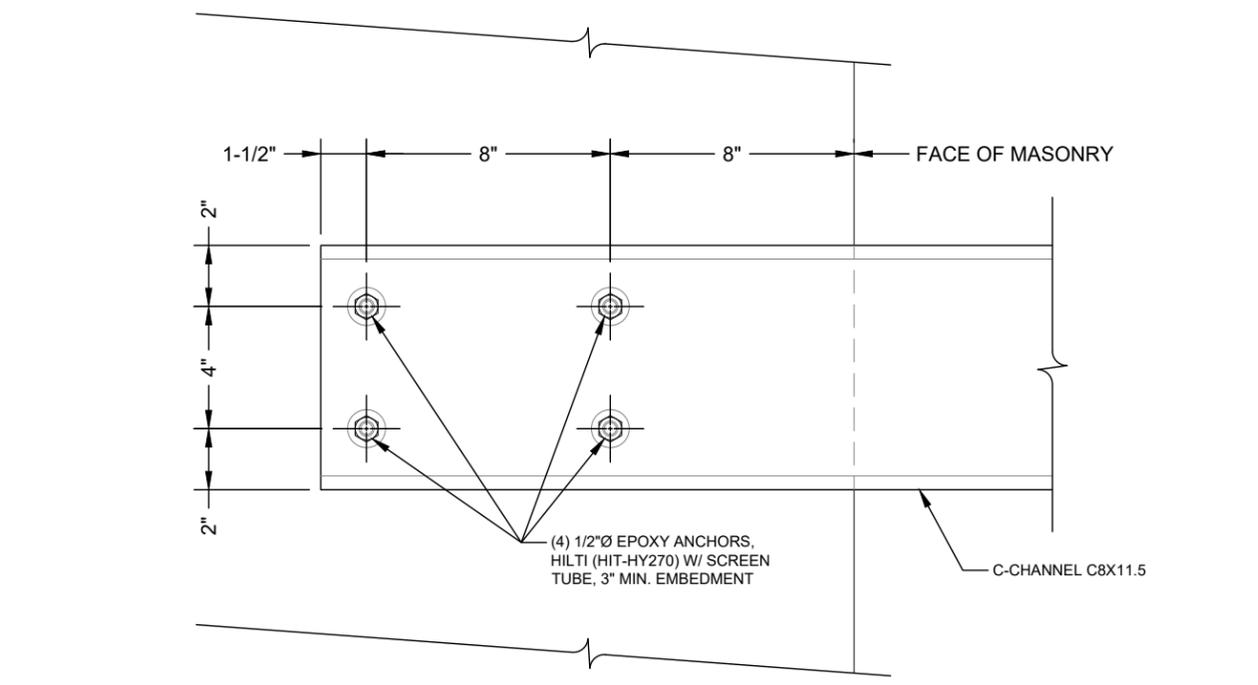

DETAIL "A" N.T.S. **2**

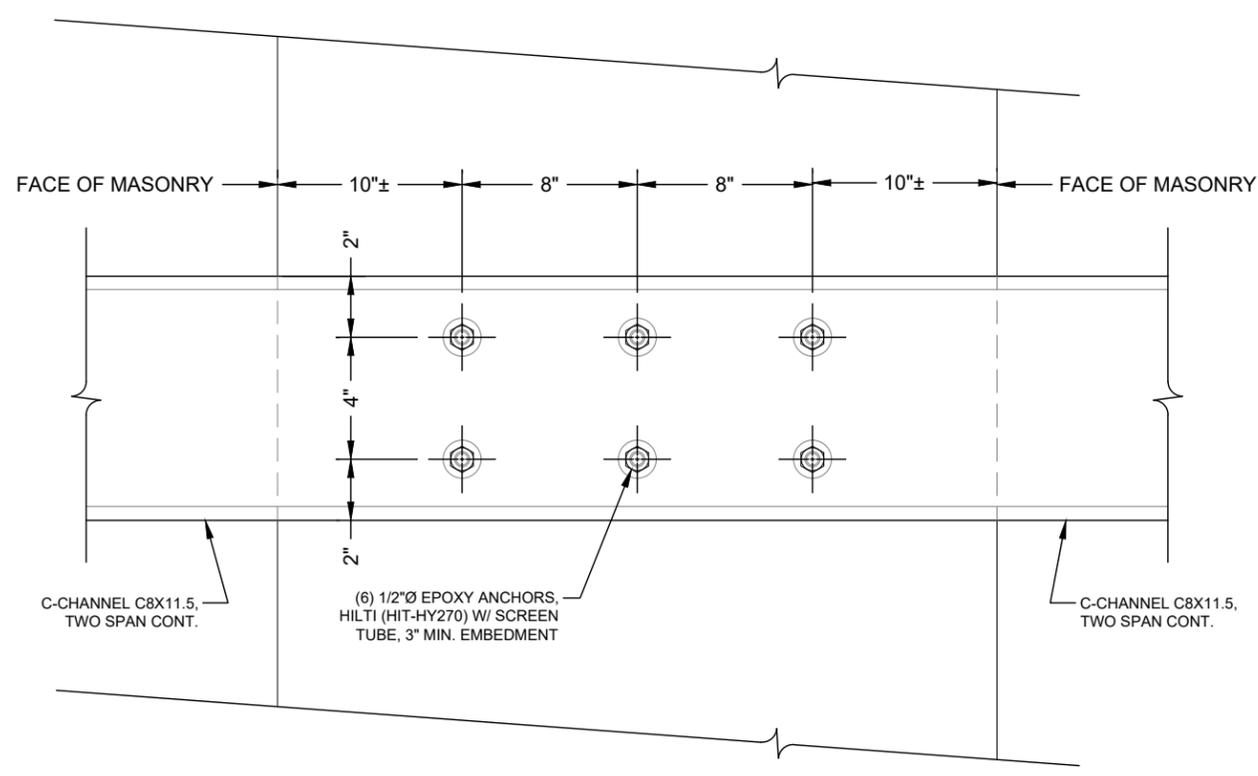

DETAIL "B" N.T.S. **3**




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Sheet Title: **ANTENNA STRUCTURAL DETAIL**

Sheet Number: **SK-2**

REV.	DATE	DESCRIPTION	BY
A	09/18/18	PRELIMINARY RELEASE	CJL
B	11/02/18	HVAC & STRUCTURAL ADD	CDR

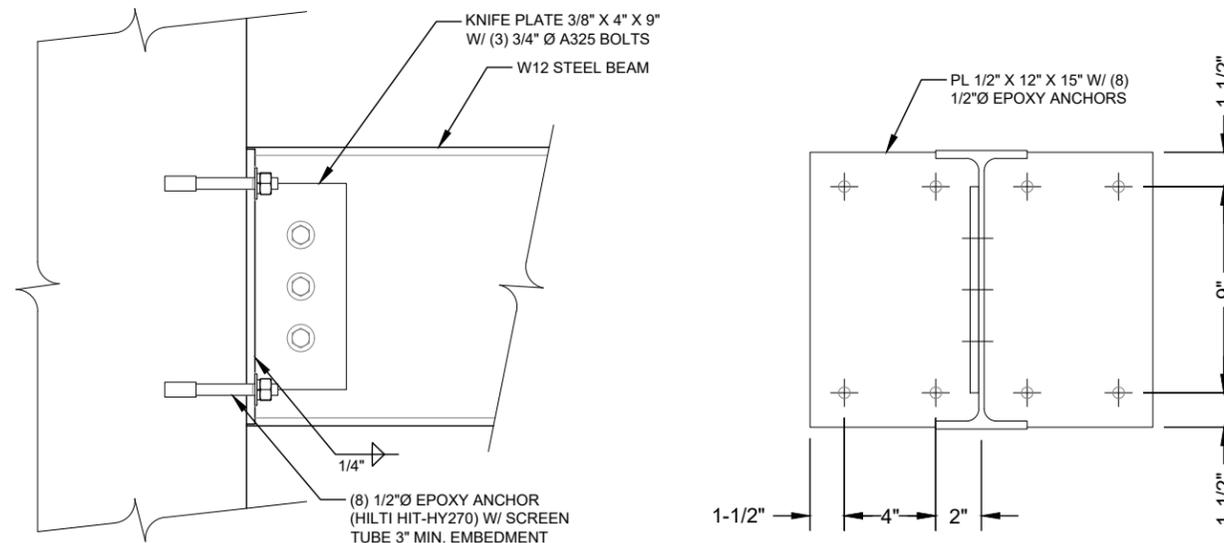


CONNECTION "C1" N.T.S

1

2018 RELOCATION

NOTE: THESE DRAWINGS ARE TO SCALE WHEN PLOTTED ON 11"x17" SHEETS. REFER TO GRAPHIC SCALES ON REPRODUCTIONS.

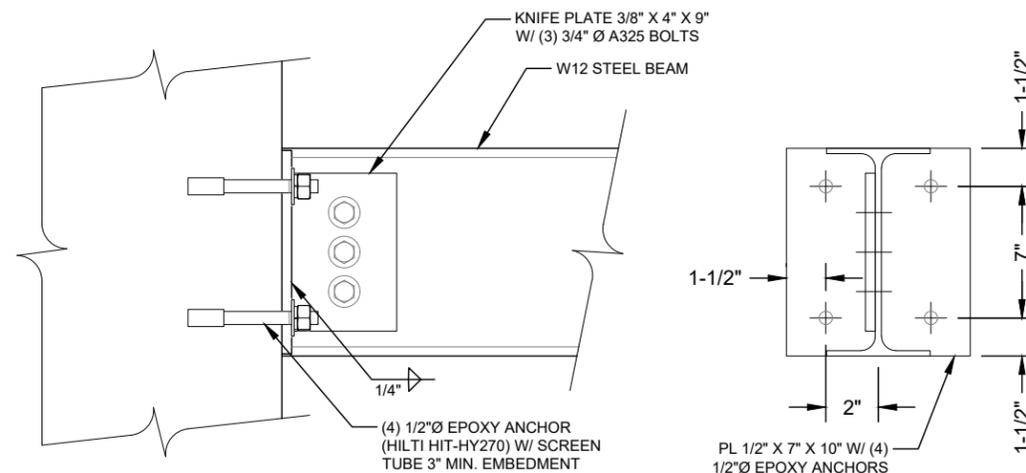

CONNECTION "C2" N.T.S


2



SITE #: DE04229B
SITE NAME: SWEETEST HEART OF MARY
SITE ADDRESS: 4440 E. CANFIELD D/B/A 4440 RUSSELL ST. DETROIT, MICHIGAN 48207

Sheet Title: PLATFORM STRUCTURAL DETAIL

Sheet Number: SK-3

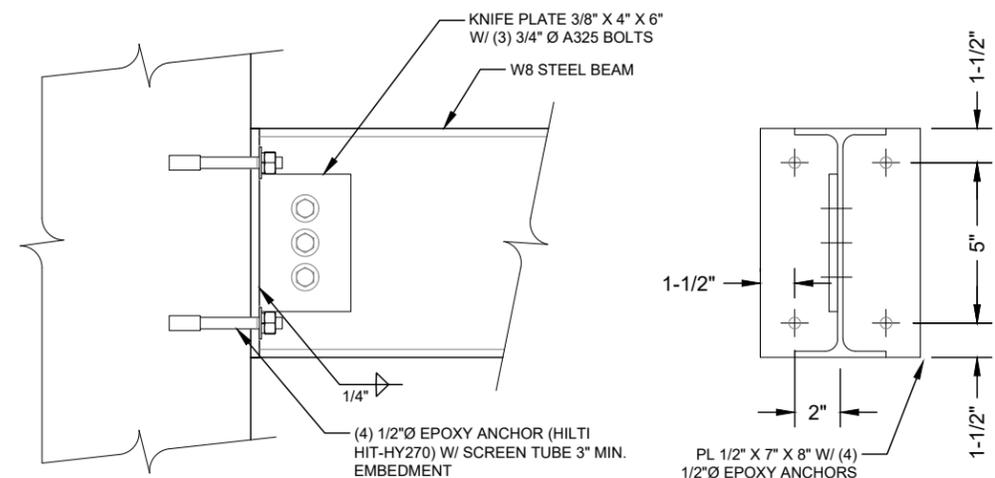

CONNECTION "C3" N.T.S

3

REV.	DATE	DESCRIPTION	BY
A	09/18/18	PRELIMINARY RELEASE	CJL
B	11/02/18	HVAC & STRUCTURAL ADD	CDR

2018 RELOCATION


NOTE: THESE DRAWINGS ARE TO SCALE WHEN PLOTTED ON 11"x17" SHEETS. REFER TO GRAPHIC SCALES ON REPRODUCTIONS.



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SITE NAME: SWEETEST HEART OF MARY
SITE ADDRESS: 4440 E. CANFIELD D/B/A 4440 RUSSELL ST. DETROIT, MICHIGAN 48207

Sheet Title: CONDUIT CABLE SCHEMATIC


Sheet Number: E-1

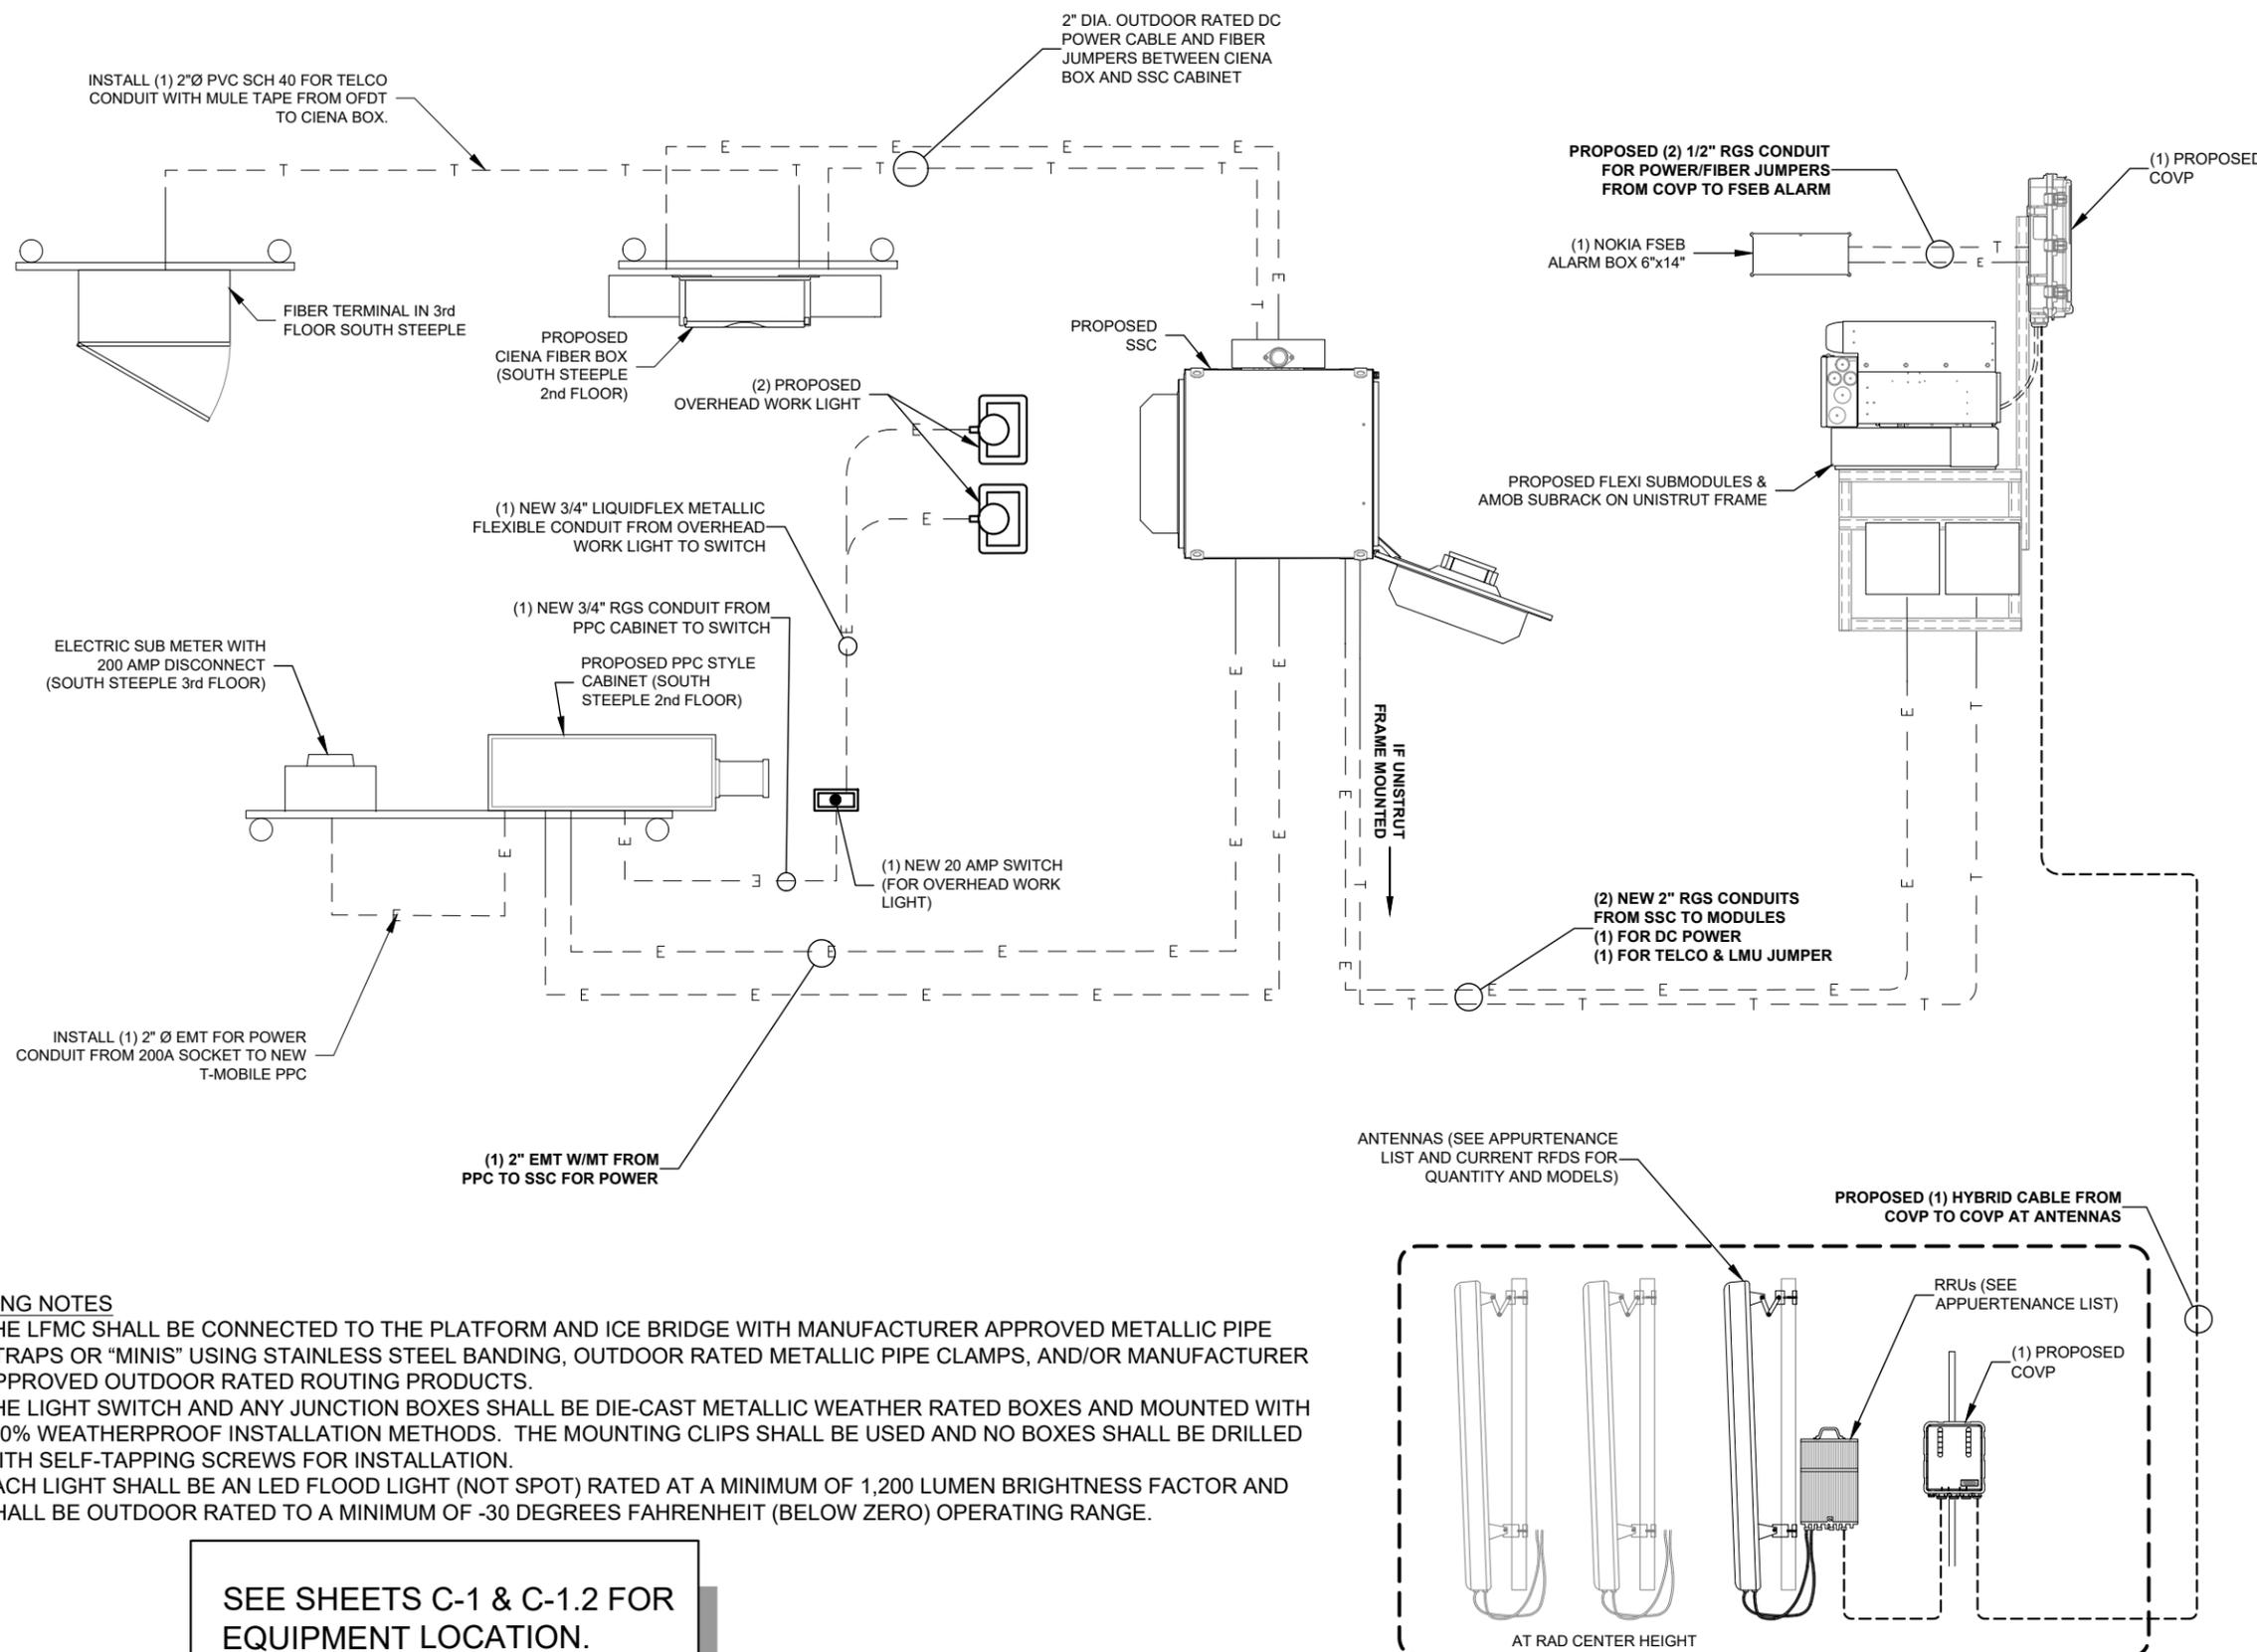

LIGHTING NOTES

- THE LFMC SHALL BE CONNECTED TO THE PLATFORM AND ICE BRIDGE WITH MANUFACTURER APPROVED METALLIC PIPE STRAPS OR "MINIS" USING STAINLESS STEEL BANDING, OUTDOOR RATED METALLIC PIPE CLAMPS, AND/OR MANUFACTURER APPROVED OUTDOOR RATED ROUTING PRODUCTS.
- THE LIGHT SWITCH AND ANY JUNCTION BOXES SHALL BE DIE-CAST METALLIC WEATHER RATED BOXES AND MOUNTED WITH 100% WEATHERPROOF INSTALLATION METHODS. THE MOUNTING CLIPS SHALL BE USED AND NO BOXES SHALL BE DRILLED WITH SELF-TAPPING SCREWS FOR INSTALLATION.
- EACH LIGHT SHALL BE AN LED FLOOD LIGHT (NOT SPOT) RATED AT A MINIMUM OF 1,200 LUMEN BRIGHTNESS FACTOR AND SHALL BE OUTDOOR RATED TO A MINIMUM OF -30 DEGREES FAHRENHEIT (BELOW ZERO) OPERATING RANGE.


SEE SHEETS C-1 & C-1.2 FOR EQUIPMENT LOCATION.

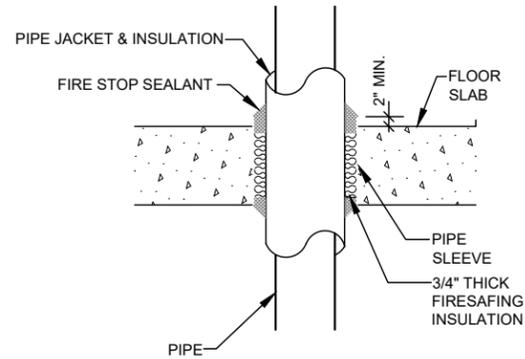


FLOOR PENETRATION DETAIL N.T.S. **1**

RIGID STEEL CLAMP SIZING SCHEDULE	
PIPE SIZE	UNISTRUT RIGID STEEL CONDUIT CLAMP P/N
3/4"	P1112
1"	P1113
1-1/4"	P1114
1-1/2"	P1115
2" AND GREATER	CONTACT ENGINEER


MASONRY WOOD FRAMED

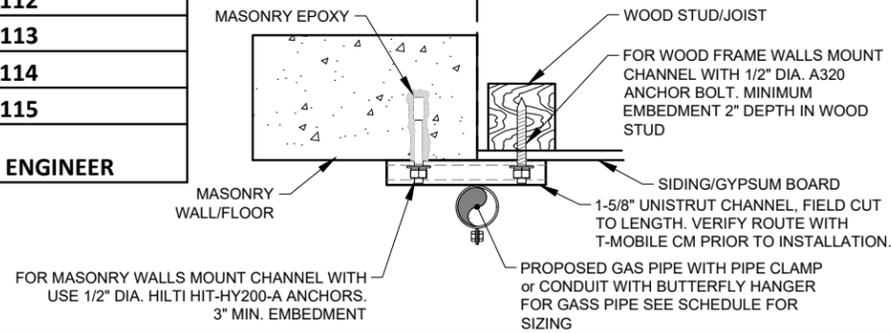


CEILING/WALL CONDUIT HANGER DETAIL N.T.S. **2**

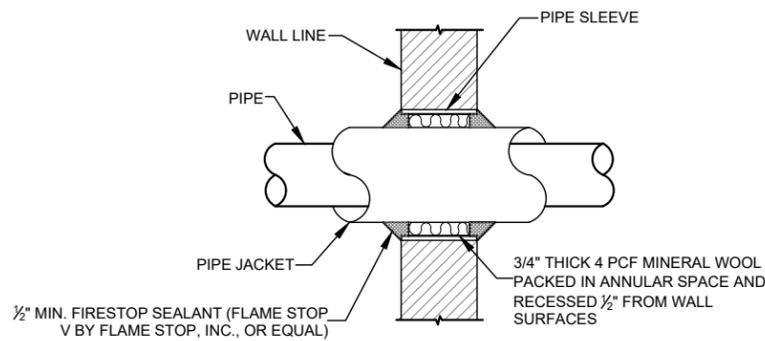


WALL PENETRATION DETAIL N.T.S. **3**

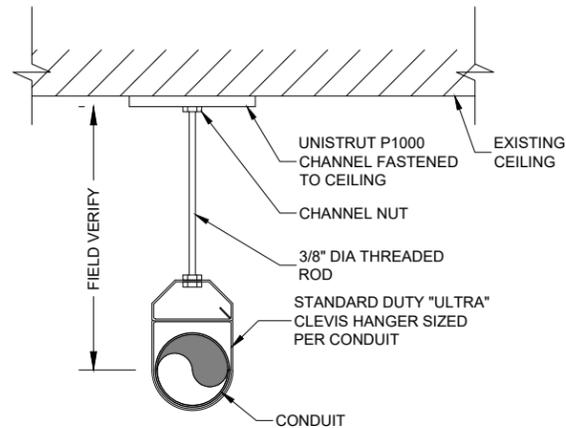

CEILING HANGER DETAIL N.T.S. **4**

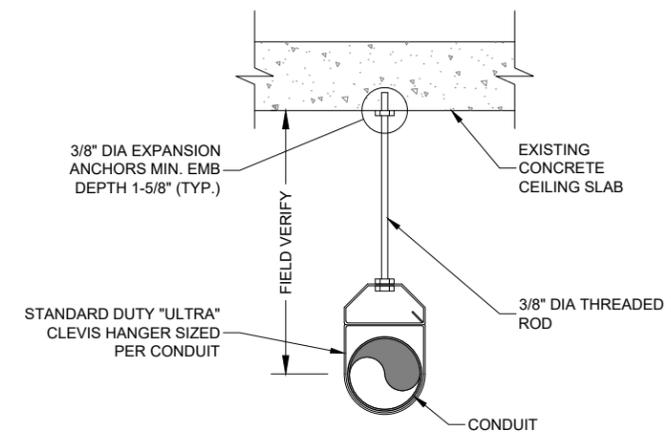


CEILING HANGER DETAIL N.T.S. **5**

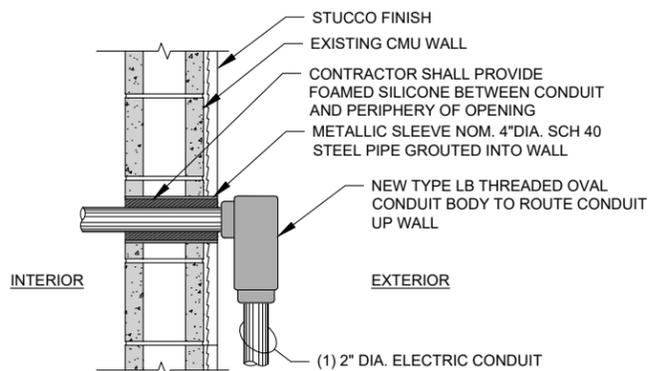

CONDUIT WALL PENETRATION DETAIL N.T.S. **6**

INTENTIONALLY OMITTED N.T.S. **7**

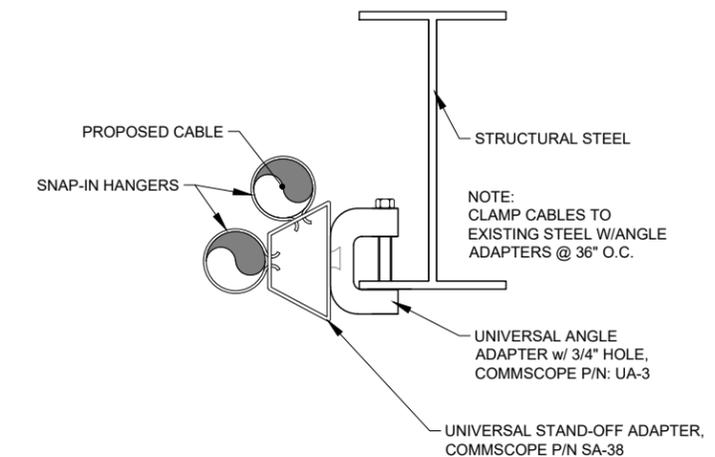

CABLE HANGER DETAIL N.T.S. **8**

T-Mobile
 28505 SCHOOLCRAFT RD, BLDG#6
 LIVONIA, MICHIGAN 48150
 Phone: 734.367.7200
 Fax: 734.367.7242
 CONTACT: KEN KALOUSEK
 (734) 444-0181

LANDTECH PROJECT NUMBER:		18323064	
REV.	DATE	DESCRIPTION	BY
A	09/18/18	PRELIMINARY RELEASE	CJL
B	11/02/18	HVAC & STRUCTURAL ADD	CDR

2018 RELOCATION


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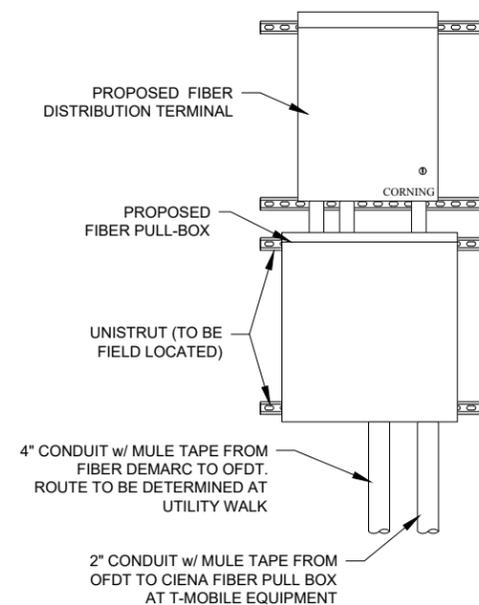
Sheet Title:
CABLE DETAILS

Sheet Number:
E-1.1



Specifications – CAC Model	
Enclosure	AC Cabinet
Cabinet Dimensions	39.00" H x 20.00" W x 10.00" D
Weight Approx.	75 lbs.
External Material	0.1" thick aluminum
Mounting	Wall or pad-mount (with optional pad-mounting base)
Cabinet Enclosure Type	One AC Power TVSS cabinet (NEMA 3R type enclosure)
Weather Protection	Rain/drip hood, rain tested per UL 891
Electrical	
Operating Voltage	120/240 VAC, single phase, 3 wire and ground
Service	100 Amp or 200 Amp. utility/standby
Disconnect	Slide bar mechanical interlock
AIC Rating	10kAIC, 22kAIC, 65kAIC
Load	Center 200 Amp, 24 position
	1-30 Amp double pole (AC TVSS)
	1-15 Amp single pole (GFI receptacles)
Bonding Jumper	Optional N-G bonding jumper
Standby Power Receptacle	Appleton AR20044RS Standard (100A or 200A), 10kAIC
TVSS with Indicator Lights	Metal Oxide Varistors (MOV) (160kA/Phase)
	Remote alarm contacts
Grounding	
Security (padlockable)	3-point door closure with 1/4 turn handle, SS hinge
Safety Compliance	UL 891, dead front switchboards
Options	10,000 or 22,000, 65,000 AIC series rated
	Pad-mounting base (8" thick)
	Various generator receptacles

POWER PEDESTAL CABINET N.T.S. **1**

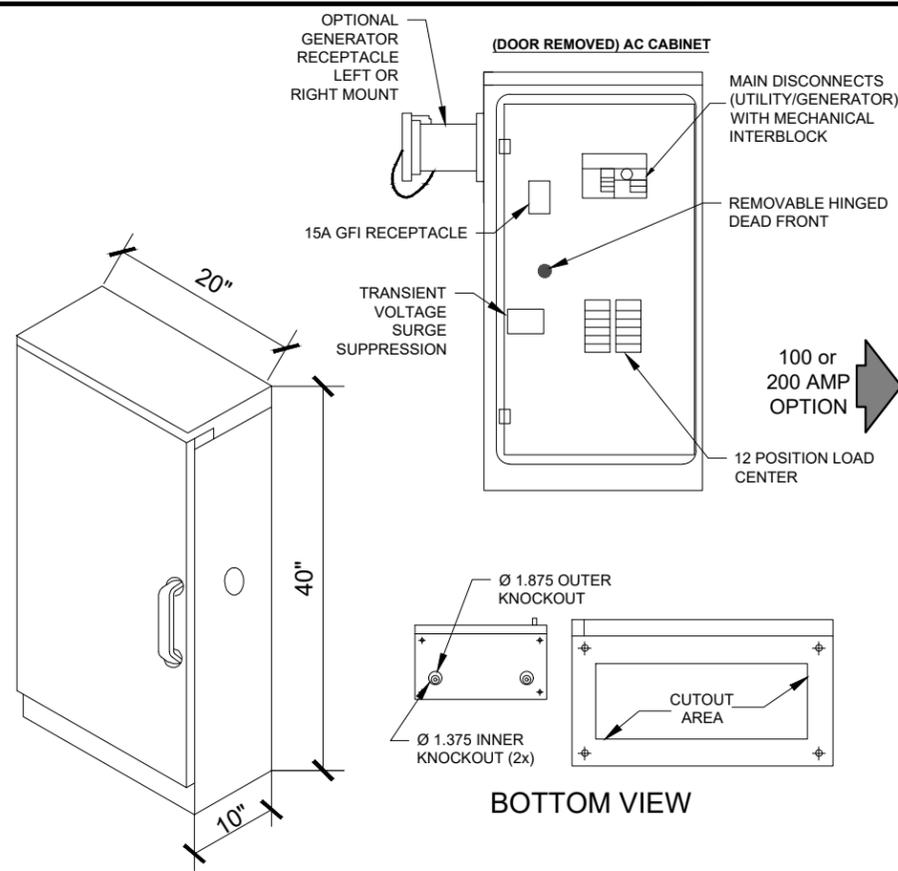

FIBER DEMARCATION DETAIL N.T.S. **2**

1. FROM TAP BOX: THE TWO (2) FOUR-INCH (4") CONDUIT WILL RETURN TO THE LOCATION DETERMINED BY "DTE" AND EXTEND OUT OF THE FINISHED GRADE 12" AND 36" RESPECTIVELY (SEE DETAIL). BOTH CONDUITS SHALL BE INSTALLED WITH PULL-STRINGS AND WATERPROOF CAPS.

2. CABINET AND CONDUCTORS FURNISHED & INSTALLED BY CUSTOMER, 350 KCMIL SERVICE CONDUCTORS FURNISHED & INSTALLED BY UTILITY.

3. EQUIPMENT ASSEMBLY DRAWINGS AND RISER DIAGRAMS MUST BE SUBMITTED TO A UTILITY PLANNER FOR ACCEPTANCE PRIOR TO INSTALLATION.

4. CABINETS AND CONDUITS SHOWN SHALL CONTAIN ONLY UNMETERED LINE CONDUCTORS. CABINET SHALL BE SEALABLE WITH ACCEPTABLE SEALING HASP.


5. TRANSMISSION TOWER SERVICES WILL UTILIZE A STANDARD 200 AMP SERVICE W/ CONTINUOUS CONDUIT TO THE SOURCE.

6. SUBSTATION CELLULAR SERVICES WILL BE A SINGLE 200-AMP SERVICE OR BUILT TO THIS SPECIFICATION. NO SERVICE SHALL BE TAKEN OUT OF THE SUBSTATION HOUSE SERVICE.


7. ALL CONDUIT AND NIPPLE ENTRIES TO CABINET AND METER BOXES WILL BE MADE WITH WEATHERPROOF HUBS, CONNECTORS OR LOCKNUTS LISTED FOR THE APPLICATIONS. NON-METALLIC BUSHINGS.

8. FOR INACCESSIBLE LOCATIONS CONSULT WITH METER ENGINEERING FOR POSSIBLE ERT METER INSTALLATION.

9. ONLY ONE SERVICE ALLOWED PER LUG. ALL GROUNDING AND BONDING MUST COMPLY WITH NEC 250 REQUIRED.

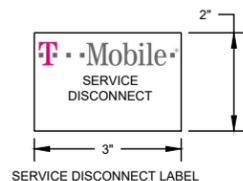

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UTILITY EQUIPMENT N.T.S. **3**
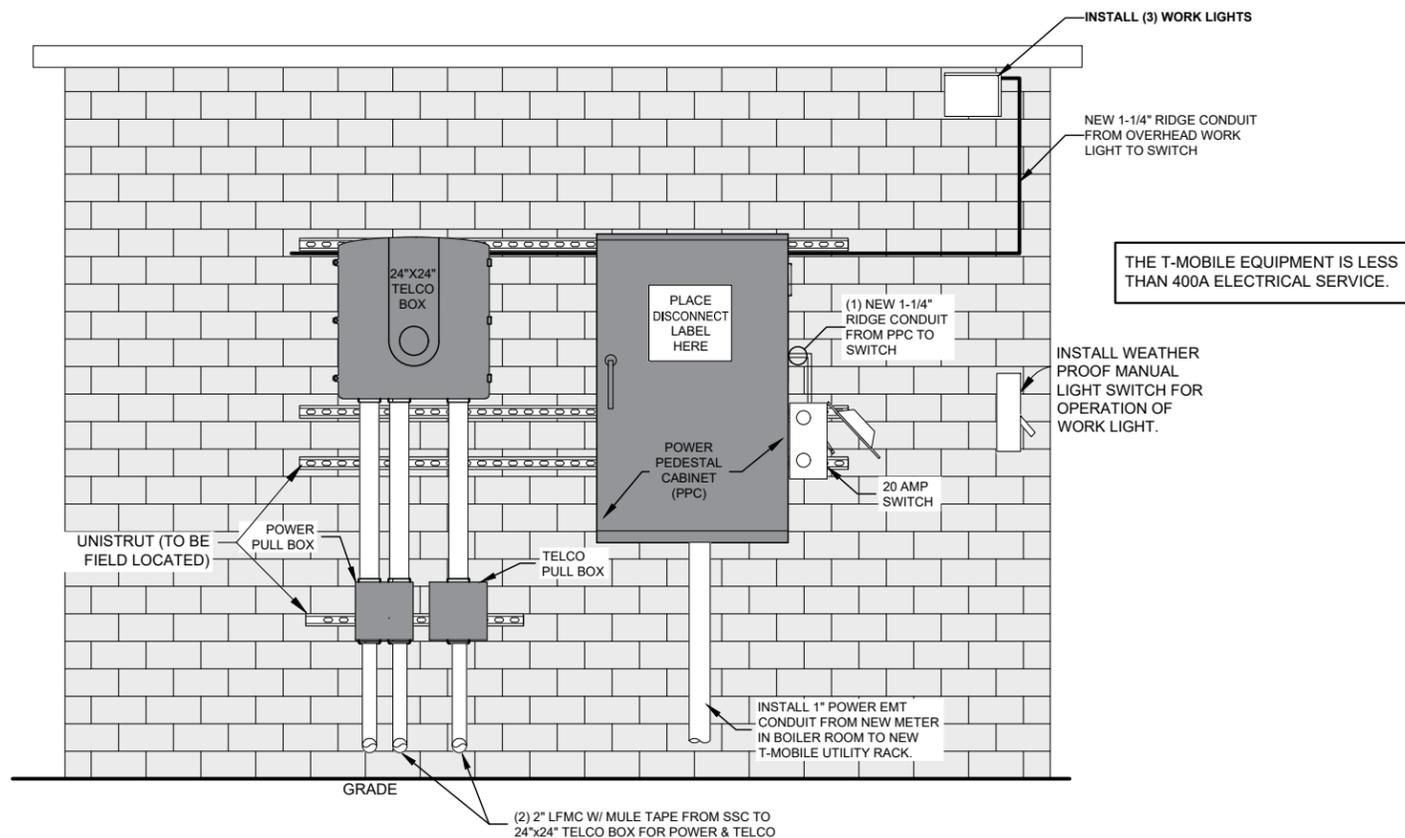
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 28505 SCHOOLCRAFT RD, BLDG#6
 LIVONIA, MICHIGAN 48150
 Phone: 734.367.7200
 Fax: 734.367.7242
 CONTACT: KEN KALOUSEK
 (734) 444-0181

LANDTECH PROJECT NUMBER: **18323064**

REV.	DATE	DESCRIPTION	BY
A	09/18/18	PRELIMINARY RELEASE	CJL
B	11/02/18	HVAC & STRUCTURAL ADD	CDR

2018 RELOCATION

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 SITE NAME: **SWEETEST HEART OF MARY**
 SITE ADDRESS: **4440 E. CANFIELD D/B/A 4440 RUSSELL ST. DETROIT, MICHIGAN 48207**

Sheet Title: **ELECTRIC DETAILS**

Sheet Number: **E-1.2**

LANDTECH PROJECT NUMBER: **18323064**

REV.	DATE	DESCRIPTION	BY
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ONE LINE DIAGRAM FORTHCOMING



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 SWEETEST HEART OF
 MARY
 SITE ADDRESS:
 4440 E. CANFIELD D/B/A 4440 RUSSELL ST.
 DETROIT, MICHIGAN 48207

Sheet Title:
 ONE-LINE DIAGRAM

Sheet Number:
 E-2

LANDTECH PROJECT NUMBER: 18323064

REV.	DATE	DESCRIPTION	BY
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B	11/02/18	HVAC & STRUCTURAL ADD	CDR

2018 RELOCATION


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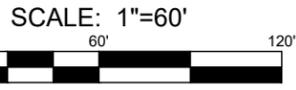
Sheet Title: **GROUNDING PLAN**

Sheet Number: **E-3**



GROUNDING LEGEND

- EXOTHERMIC WELD CONNECTION
- #2 AWG STRANDED COPPER TINNED w/ EXOTHERMIC WELD TO MASTER GROUND BAR
- MECHANICAL CONNECTION
- #6 AWG STRANDED COPPER TINNED w/ MECHANICAL CONNECTION TO MASTER GROUND BAR
- #2 AWG SOLID COPPER TINNED
- #6 AWG SOLID COPPER TINNED
- GROUND BUS BAR

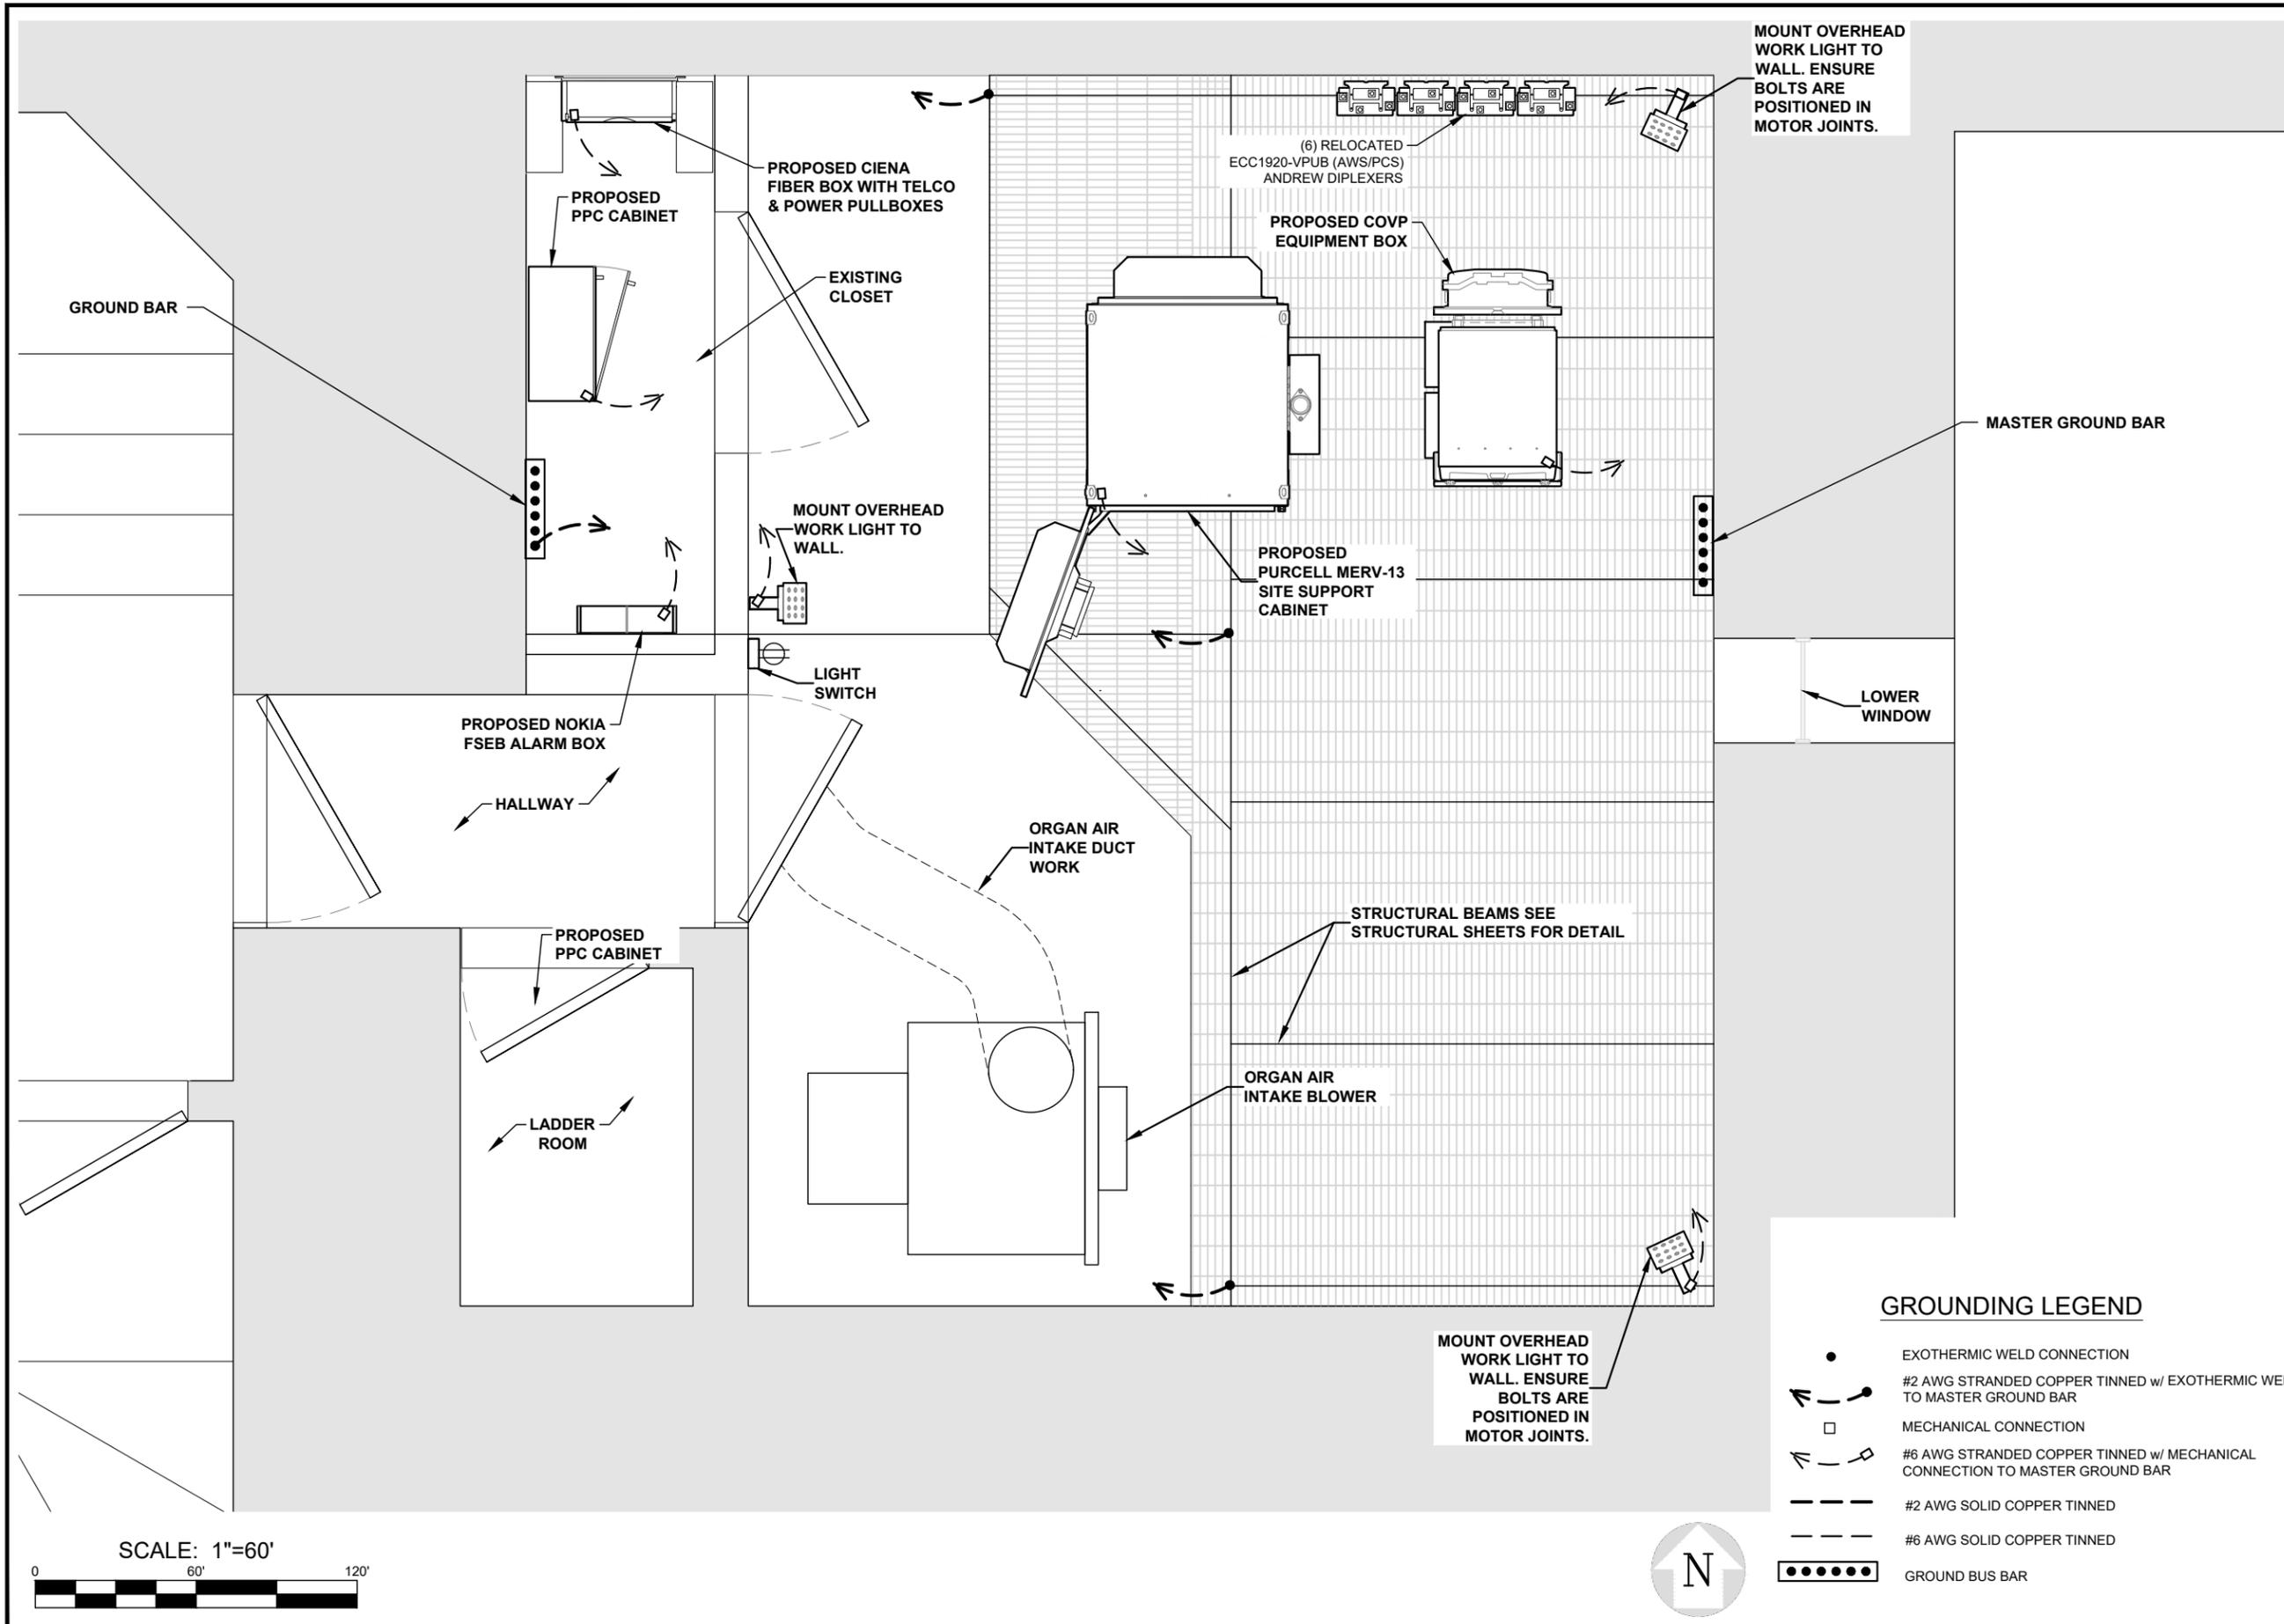

LANDTECH PROJECT NUMBER: **18323064**

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2018 RELOCATION

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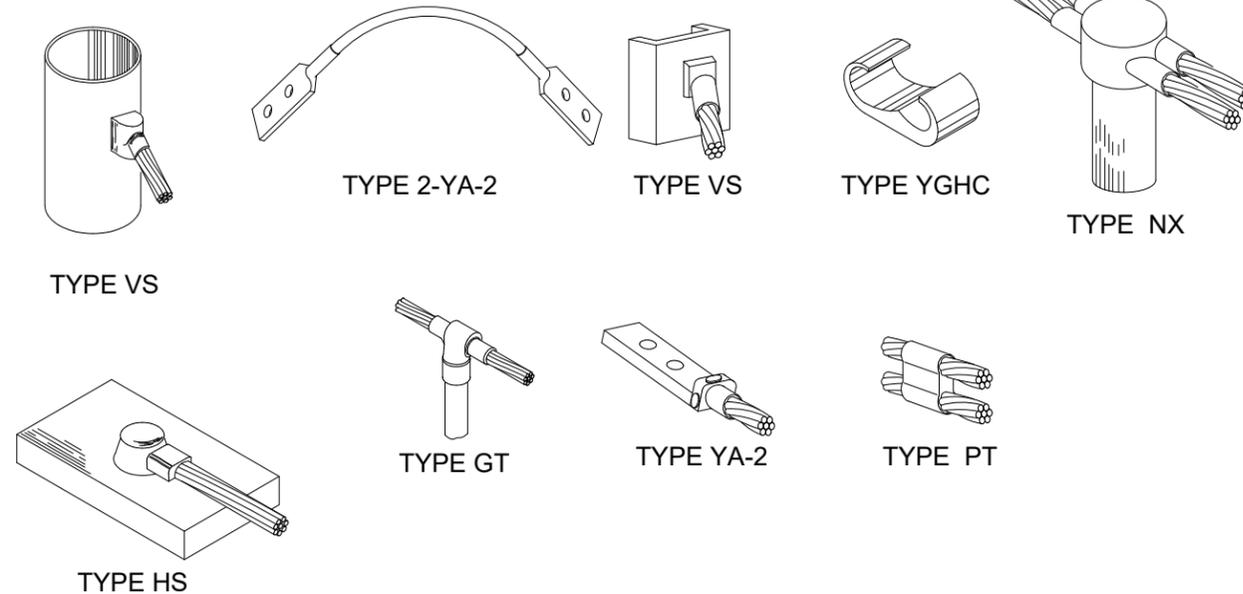
IMPORTANT GROUNDING / CABLE NOTES:

1. T-MOBILE IS ELIMINATING THE HOME RUN GROUND WIRE FROM TOP BUSS BAR AND THE BOTTOM BUSS BAR ON TOWER SITES. ROOFTOPS ARE STILL REQUIRED TO HAVE SECTORIZED GROUND AND #2 INSULATED GROUND WIRE. FROM SECTOR GROUNDS TO MAIN BUSS BARS AND BUILDING STEEL. 4 GROUND BARS, 3 ISOLATED ONE FOR EACH SECTOR, ONE AS COLLECTION POINT MOUNTED WITHOUT CHERRIES.
2. REMOVE INSULATORS (CHERRIES) FROM THE BUSS BARS AND GROUND TO TOWER, TOP AND BOTTOM ON TOWER SITES ONLY.
3. ALL EXPOSED GROUNDS TO BE DRESSED WITH SEAL TIGHT. (ONLY AT GRADE)
4. THE DISTANCE BETWEEN BUTTERFLIES AND CABLE STAND OFFS IS 36".
5. THE DISTANCE BETWEEN CONVENTIONAL AND/OR SNAP-HANGERS ON 1/2" JUMPERS SHALL BE NO MORE THAN 3 FEET AT THE TOP AND 2 FEET ON THE BOTTOM JUMPERS PER MANUFACTURER'S RECOMMENDATION.
6. NO HYBRID CABLES SHOULD TOUCH METAL OR STEEL. THE USE OF STANDOFF BRACKETS ARE REQUIRED. USE OF GROMMETS AS SUPPLIED BY T-MOBILE. (EXCEPT 1-5/8" SNAP-IN FOR CABLE MANAGEMENT)
7. HYBRID AND JUMPER LINES SHOULD BE DRESSED IN ON THE SIDE OR BOTTOM OF SECTOR FRAMES / MONOPOLES. NEVER ON TOP WERE SOMEONE WOULD WALK.
8. PARALLEL #2 TINNED PATH RUNS, WIDTH, DEPTH, BACKFILL, COMPACTION SPECS.
9. ALL MECHANICAL GROUND CONNECTIONS NEED TO BE SCRAPPED IF PAINTED TO BARE METAL AND NO-OX APPLIED ON ALL CONNECTIONS ABOVE GROUND.
10. GROUND BARS NEED TO BE COPPER.
11. GROUNDING HARDWARE NEEDS TO BE STAINLESS STEEL.

GROUNDING / CABLE NOTES

1

NOTE:
 CADWELD "TYPES" SHOWN ARE EXAMPLES. CONSULT WITH CONSTRUCTION MANAGER FOR SPECIFIC TYPES OF CADWELDS TO BE USED FOR THIS PROJECT.



CADWELD CONNECTION TYPES

N.T.S.


2

#2 AWG STRANDED JUMPER W/ LONG BARREL COMPRESSION LUGS TO GROUND BAR BY GENERAL CONTRACTOR
 NOTE: CONTRACTOR TO USE ANTI-CORROSION GREASE AT CONNECTIONS.

TO GROUND KIT
 TO WAVEGUIDE PORT

NEW 4"x24"x1/4" THICK ALUMINUM GROUND BAR, T-MOBILE CONSTRUCTION MANAGER TO VERIFY EXACT LOCATION AND INSTALLATION IN FIELD.

REFER TO GROUND RISER SCHEMATIC (SHEET C-3) FOR CONNECTIONS

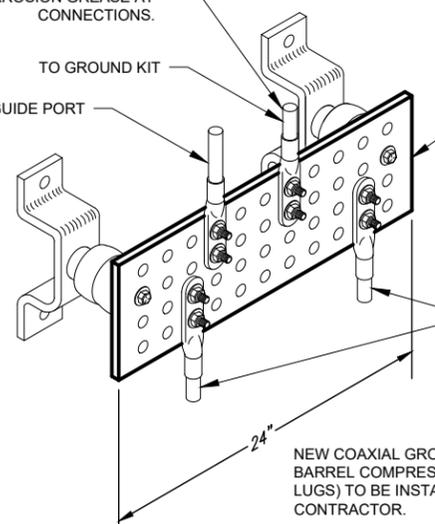

NEW COAXIAL GROUND KITS W/ LONG BARREL COMPRESSION LUGS (DOUBLE LUGS) TO BE INSTALLED BY ANTENNA CONTRACTOR.

NOTES:

1. CONTRACTOR SHALL UTILIZE LUGGED HOLES PROVIDED. NO DRILLING OF THE BAR WILL BE PERMITTED.
2. ALL HARDWARE SHALL BE 18-8 STAINLESS STEEL INCLUDING BELLEVILLES. COAT ALL SURFACES WITH KOPR-SHIELD BEFORE MATING.
3. FOR GROUND BOND TO STEEL ONLY: INSERT A DRAGON TOOTH WASHER BETWEEN LUG AND STEEL. COAT ALL SURFACES WITH KOPR-SHIELD.

GROUNDING BAR DETAIL

N.T.S.

3



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Sheet Title:
GROUNDING DETAILS

Sheet Number:
E-3.1

REV.	DATE	DESCRIPTION	BY
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B	11/02/18	HVAC & STRUCTURAL ADD	CDR





2018 RELOCATION

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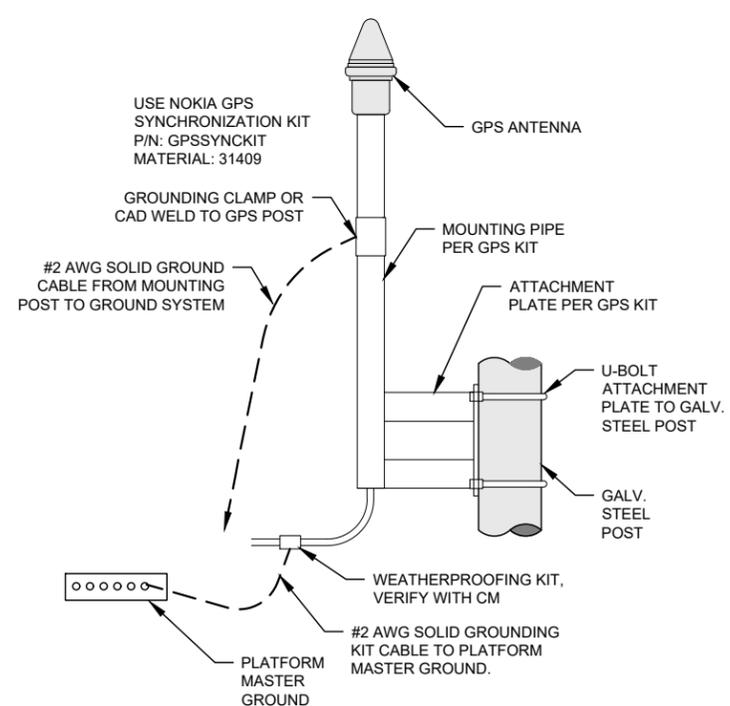
SECTOR A

SECTOR B

SECTOR C

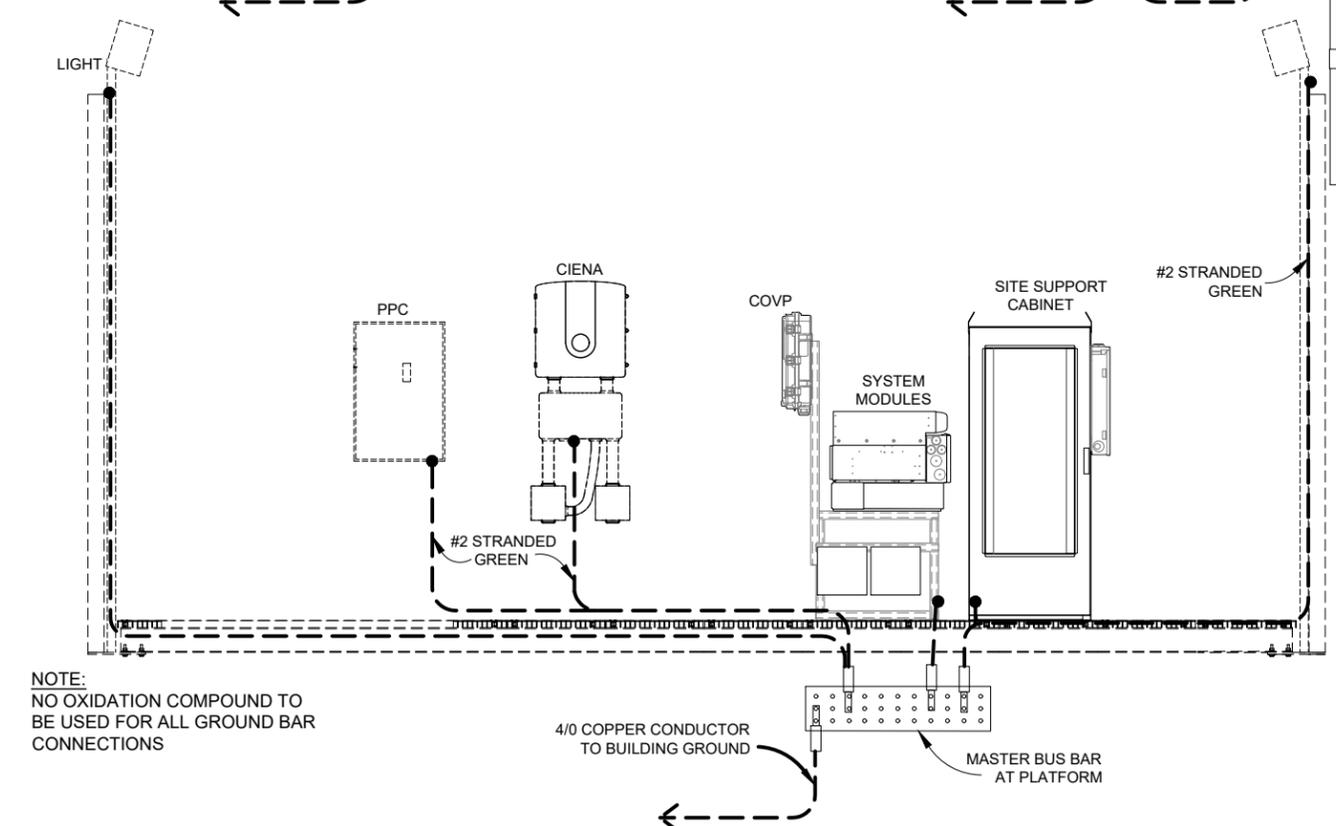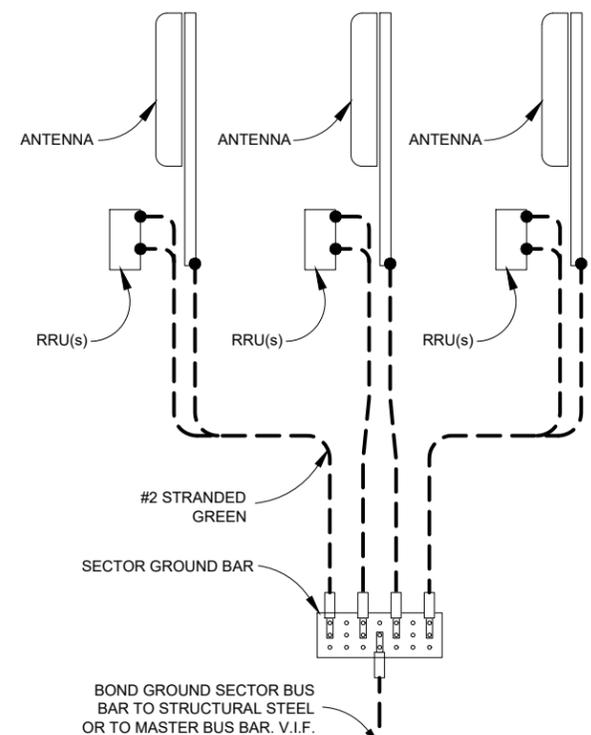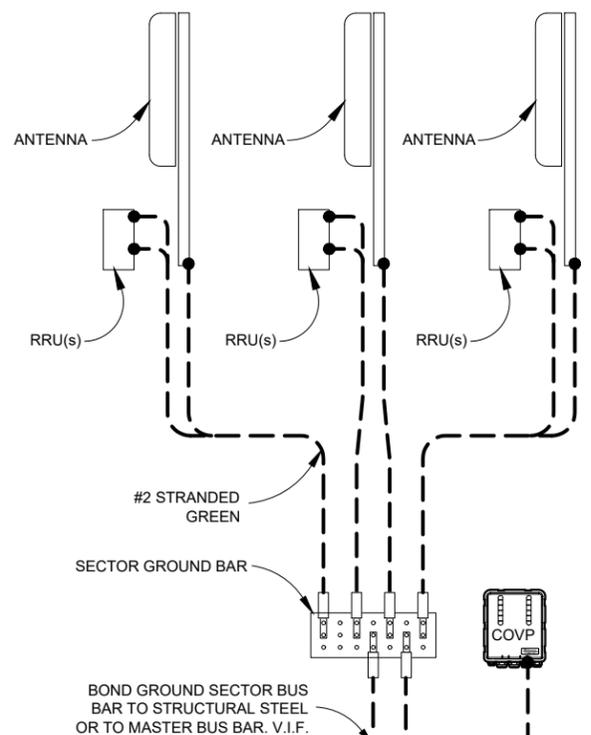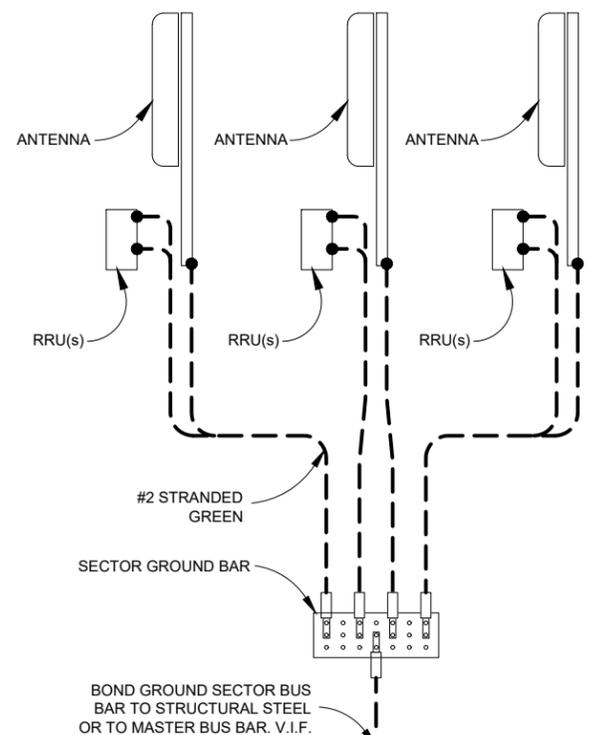

SEE GPS ANTENNA DETAIL THIS SHEET



GPS ANTENNA DETAIL


- = MECHANICAL CONNECTION
- = CAD WELD CONNECTION



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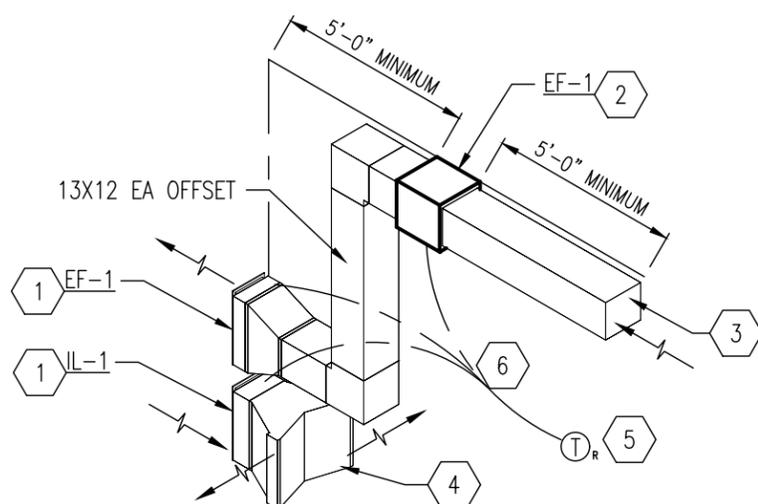
Sheet Title: **GROUNDING SCHEMATIC**

Sheet Number: **E-3.2**

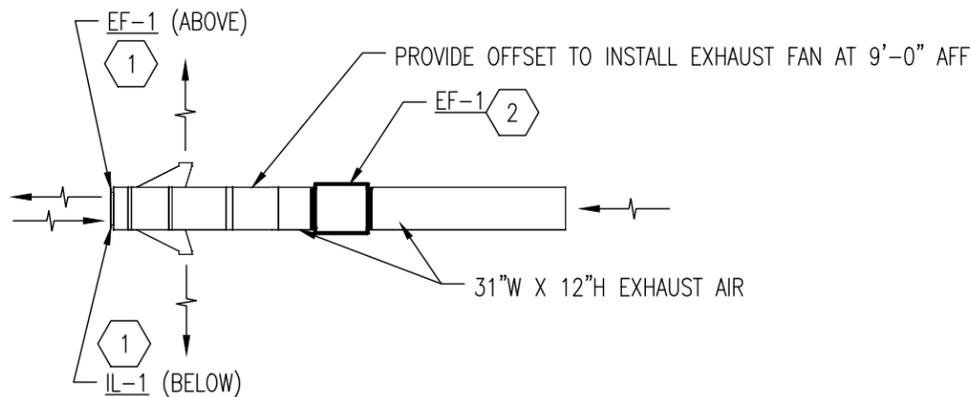


1 **FLOOR PLAN - HVAC**

M-1 SCALE: NOT TO SCALE



2 **ISOMETRIC DETAIL - HVAC**

M-1 SCALE: NOT TO SCALE

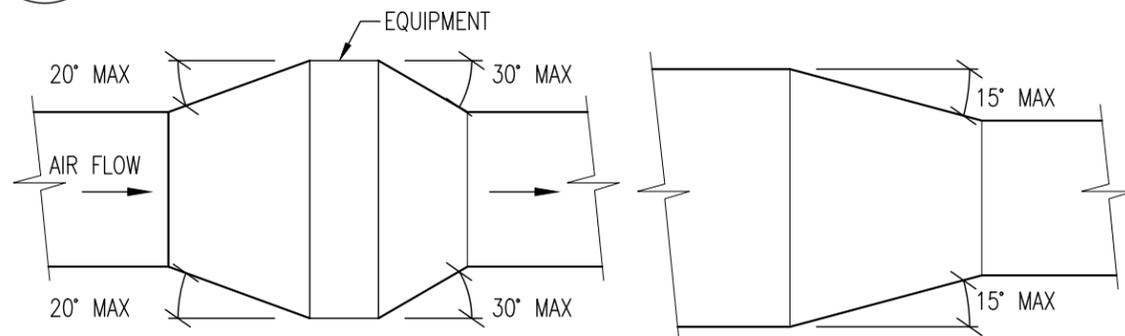

DUCT TRANSITION W/EQUIPMENT

DUCT TRANSITION

NOTES:


1. UNLESS OTHERWISE INDICATED ON PLANS, MAXIMUM ANGLES SHOWN SHALL APPLY.

3 **TYPICAL DUCT TRANSITION DETAIL**

M-1 SCALE: NOT TO SCALE

HVAC KEY NOTES

1. PROVIDE INTAKE OR EXHAUST LOUVER WITH FACTORY OPTIONS/FINISH AS SCHEDULED.
2. PROVIDE EXHAUST FAN WITH FACTORY OPTIONS AS SCHEDULED. INSTALL AT 9'-0" ABOVE FINISH FLOOR.
3. EXTEND 13" WIDE X 12" HIGH EXHAUST DUCT 10'-0" INTO THE ROOM AND TERMINATE WITH GALVANIZED 16-GAUGE 1x1 WIRE MESH GRILLE ON END.
4. PROVIDE A FIELD FABRICATED FITTING TO TRANSITION FROM THE INTAKE LOUVER TO TWO 22x4 OPENINGS TO DIRECT AIR INTO THE SPACE AT A 90° ANGLE.
5. PROVIDE A 120V REVERSE ACTING THERMOSTAT, INSTALL AT 4'-0" ABOVE FINISH FLOOR BETWEEN THE TWO DOORS.
6. INTERLOCK THE EXHAUST FAN WITH THE NORMALLY CLOSED INTAKE AND NORMALLY CLOSED EXHAUST LOUVER TO OPEN WHEN THE EXHAUST FAN IS ON.

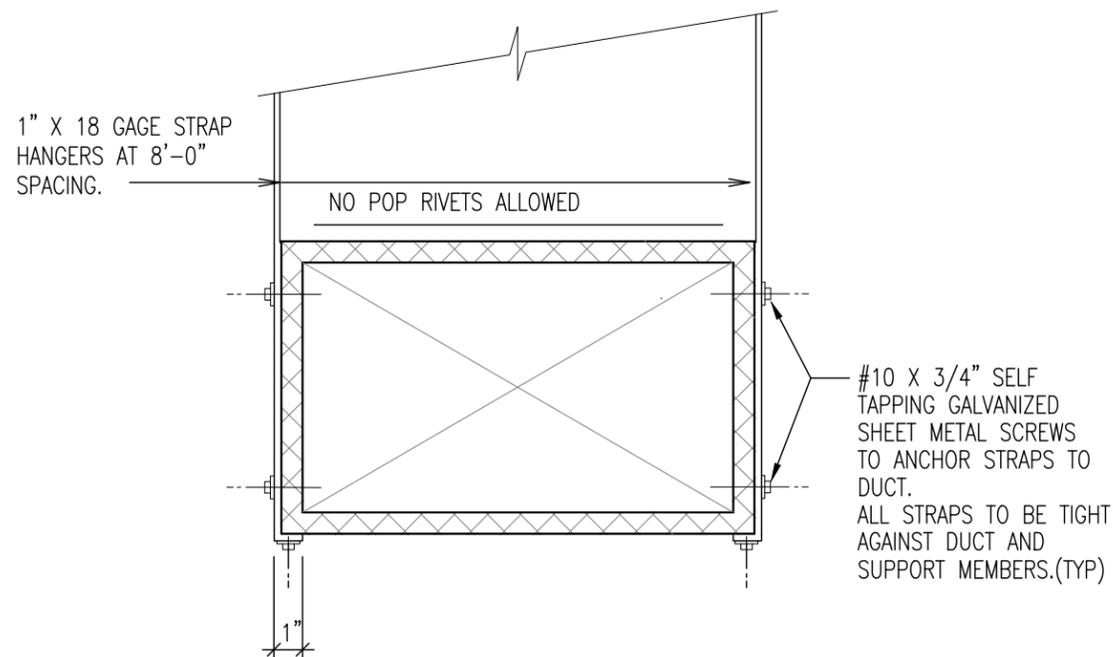

4 **TYPICAL DUCT STRAP HANGER DETAIL**

M-1 SCALE: NOT TO SCALE

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Sheet Title:
HVAC DETAILS

Sheet Number:
M-1

SECTION 23 0000 - HVAC

THE REQUIREMENTS OF THE "GENERAL CONDITIONS" AND "DIVISION 1" SECTIONS OF THE SPECIFICATIONS SHALL APPLY TO THIS SECTION OF THE SPECIFICATIONS.

PART 1 – GENERAL

1.01 SUMMARY

- A. THE CONTRACTOR SHALL PROVIDE A COMPLETE AND OPERATIONAL HVAC SYSTEM AS SHOWN ON THE DRAWINGS INCLUDING EQUIPMENT, MATERIAL, LABOR, DUCTWORK, PIPING, DIFFUSERS, GRILLES AND REQUIRED ELECTRICAL. THE CONTRACTOR SHALL PROVIDE OPERATING AND MAINTENANCE INSTRUCTIONS TO THE OWNER FOR ALL EQUIPMENT. ALL COMPRESSORS SHALL BE PROVIDED WITH A FIVE (5) YEAR EXTENDED WRITTEN WARRANTY ON PARTS AND, WHERE APPLICABLE, ALL GAS FIRED HEAT EXCHANGERS SHALL BE PROVIDED WITH AN EXTENDED TEN (10) YEAR PARTS WARRANTY. THE CONTRACTOR SHALL PROVIDE AN UNCONDITIONAL WARRANTY OF ONE YEAR FOR ALL OTHER ASSOCIATED EQUIPMENT AND DEVICES.
- B. ALL WORK SHALL BE PERFORMED IN COMPLIANCE WITH THE LOCAL BUILDING, MECHANICAL, AND ENERGY CODES ASHRAE, SMACNA, AND ALL OTHER APPLICABLE STATE AND FEDERAL CODES.
- C. THE CONTRACTOR SHALL OBTAIN AND PAY FOR ALL PERMITS AND INSPECTIONS REQUIRED FOR THE EXECUTION OF THIS WORK.
- D. ALL EQUIPMENT AND MATERIALS SHALL BE NEW AND SHALL DISPLAY A UL LABEL WHERE APPLICABLE.
- E. ALL INTERIOR INSULATION MATERIALS, JACKETS, COVERINGS, SEALS AND MASTICS SHALL HAVE A FLAME SPREAD INDEX OF 25 OR LESS AND SMOKE DEVELOPED INDEX OF 50 OR LESS PER ASTM E84 (NFPA 255).

1.02 SUBMITTALS

- A. PRODUCT DATA: INCLUDE MANUFACTURER'S TECHNICAL DATA FOR EACH MODEL INDICATED, INCLUDING RATED CAPACITIES, DIMENSIONS, REQUIRED CLEARANCES, CHARACTERISTICS, FURNISHED SPECIALTIES, ACCESSORIES, AND OPERATION AND MAINTENANCE DATA.

1.03 QUALITY ASSURANCE

- A. ELECTRICAL COMPONENTS, DEVICES, AND ACCESSORIES: LISTED AND LABELED AS DEFINED IN NFPA 70, ARTICLE 100, BY A TESTING AGENCY ACCEPTABLE TO AUTHORITIES HAVING JURISDICTION, AND MARKED FOR INTENDED USE.

PART 2 – PRODUCTS

2.01 DUCTWORK AND SPECIALTIES

- A. ALL DUCTWORK SHALL BE GALVANIZED SHEET METAL OF GAUGES AND JOINT TYPES AS SPECIFIED IN THE SMACNA MANUAL FOR THE APPLICABLE SIZES. VOLUME DAMPERS SHALL BE MANUAL LOCKING, BLADE-TYPE, TWO GAUGES HEAVIER THAN DUCT. DUCTWORK SHALL BE CONSTRUCTED IN ACCORDANCE WITH SMACNA STANDARDS FOR TWO-INCH STATIC PRESSURE. ALL DUCTWORK SHALL BE SEALED WITH MASTIC. ACCESS DOORS SHALL BE PROVIDED IN DUCTWORK AT FIRE DAMPERS OR OTHER CONTROL DEVICES AS REQUIRED FOR MAINTENANCE. DOUBLE-THICKNESS TURNING VANES SHALL BE PROVIDED AT ALL RECTANGULAR ELBOWS. FLEXIBLE CONNECTIONS TO AIR HANDLING UNITS SHALL BE PROVIDED.

2.02 INSULATION

- A. ALL DUCTWORK SHALL BE WRAPPED WITH INSULATION WITH A MINIMUM R VALUE OF R-3.5.

2.03 EXHAUST FAN

- A. EXHAUST FAN TO BE SUPPLIED AS INDICATED ON THE DRAWINGS.
- B. FAN SPEED CONTROLLER INSTALLATION LOCATION SHALL BE COORDINATED WITH ELECTRICAL CONTRACTOR AND BE INSTALLED AT OR BY THE FAN FOR ADJUSTMENT BY BALANCE CONTRACTOR.

PART 3 – EXECUTION

3.01 INSTALLATION

- A. INSTALL UNITS LEVEL AND PLUMB, MAINTAINING MANUFACTURER'S RECOMMENDED CLEARANCES. INSTALL ACCORDING TO ARI GUIDELINE B.
- B. ALL DUCTWORK AND EXHAUST FANS SHALL BE SUPPORTED PROPERLY FROM THE TOP CHORD OF ROOF JOISTS. NO DUCTWORK OR DEVICES SHALL BE ATTACHED DIRECTLY TO ROOF DECK.
- C. THE HVAC SYSTEM SHALL OPERATE WITHOUT OBJECTIONABLE VIBRATION, PULSATION, OR RATTLE. MOTORS SHALL BE MOUNTED ON RUBBER VIBRATION ISOLATORS OR THE COMPLETE UNIT SHALL BE ISOLATED FROM THE BUILDING WITH ISOLATION PADS. ALL DAMPERS, GRILLES, AND ACCESSORIES SHALL HAVE NO MOVEMENT UNDER OPERATING CONDITIONS AND SHALL OPERATE WITHOUT NOISE. ALL DUCTWORK INSTALLED EXTERNAL TO THE BUILDING SHALL BE COMPLETELY WEATHERPROOF AND INSULATED.

3.04 CONNECTIONS

- A. ELECTRICAL SYSTEM CONNECTIONS: COMPLY WITH APPLICABLE REQUIREMENTS IN DIVISION 16 SECTIONS FOR POWER WIRING, SWITCHES, AND MOTOR CONTROLS.
- B. GROUND EQUIPMENT ACCORDING TO DIVISION 16 SECTIONS "GROUNDING AND BONDING".
- C. TIGHTEN ELECTRICAL CONNECTORS AND TERMINALS ACCORDING TO MANUFACTURER'S PUBLISHED TORQUE-TIGHTENING VALUES. IF MANUFACTURER'S TORQUE VALUES ARE NOT INDICATED, USE THOSE SPECIFIED IN UL 486A AND UL 486B.

3.05 TESTING ADJUSTING AND BALANCING

- A. TEST, ADJUST, AND BALANCE THE EXHAUST AIR SYSTEMS.:
- B. MAKE ADJUSTMENTS AND RE-TEST SYSTEM TO ACHIEVE THE REQUIRED FLOW WITHIN 10% OF SPECIFIED FLOW FOR AIR SYSTEMS.
- C. WHEN DEFICIENCIES ARE IDENTIFIED, RE-TEST AND ADJUST FLOWS AFTER CORRECTIVE MEASURES ARE TAKEN.
- D. PERMANENTLY IDENTIFY POSITION OF SPEED CONTROLLER AND DAMPERS FOR FUTURE REFERENCE.

END OF SECTION 23 0000



28505 SCHOOLCRAFT RD, BLDG#6
LIVONIA, MICHIGAN 48150
Phone: 734.367.7200
Fax: 734.367.7242
CONTACT: KEN KALOUSEK
(734) 444-0181

LANDTECH PROJECT NUMBER: **18323064**

REV.	DATE	DESCRIPTION	BY
A	09/18/18	PRELIMINARY RELEASE	CJL
B	11/02/18	HVAC & STRUCTURAL ADD	CDR

2018 RELOCATION

NOTE: THESE DRAWINGS ARE TO SCALE WHEN PLOTTED ON 11"x17" SHEETS. REFER TO GRAPHIC SCALES ON REPRODUCTIONS.



SITE #: **DE04229B**
SITE NAME:
SWEETEST HEART OF MARY
SITE ADDRESS:
**4440 E. CANFIELD D/B/A 4440 RUSSELL ST.
DETROIT, MICHIGAN 48207**

Sheet Title:
HVAC GENERAL NOTES

Sheet Number:
M-1.1

REV.	DATE	DESCRIPTION	BY
A	09/18/18	PRELIMINARY RELEASE	C.JL
B	11/02/18	HVAC & STRUCTURAL ADD	CDR

2018 RELOCATION

NOTE: THESE DRAWINGS ARE TO SCALE WHEN PLOTTED ON 11"x17" SHEETS. REFER TO GRAPHIC SCALES ON REPRODUCTIONS.



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DETROIT, MICHIGAN 48207

Sheet Title:
EXHAUST FAN & LOUVER SCHEDULE

Sheet Number:
M-1.2

EXHAUST FAN SCHEDULE

TAG	BASIS OF DESIGN		FLOW RATE (CFM)	E.S.P.	FAN SPEED (RPM)	DRIVE TYPE	BLADE TYPE	WEIGHT (LBS)	SONES	ELECTRICAL DATA		DISCONNECT DATA		NOTES
	MANUFACTURER	MODEL								HP	VOLTAGE	M.T.C.	E.T.C.	
EF-1	GREENHECK	SQ-95-G	530	0.25	1,300	DIRECT	BACKWARDS INCLINED	49	6.4	1 / 15	115 / 1 / 60	√		①②③

- ① SUSPEND FROM STRUCTURE WITH UNISTRUT AND HANGING SPRING ISOLATORS
- ② PROVIDE WITH 120V REVERSE-ACTING THERMOSTAT, COORDINATE SET POINT WITH OWNER
- ③ INTERLOCK WITH LOUVERS, COORDINATE WITH LOUVER SCHEDULE AND FLOOR PLAN

LOUVER SCHEDULE

TAG	BASIS OF DESIGN		SERVICE	FLOW RATE (CFM)	LOUVER WIDTH	LOUVER HEIGHT	LOUVER DEPTH	FREE AREA (FT ²)	VELOCITY (FPM)	ELECTRIC ACUTATOR		DISCONNECT DATA		NOTES
	MANUFACTURER	MODEL								TYPE	VOLTAGE	M.T.C.	E.T.C.	
IL-1	GREENHECK	EAD-635	INTAKE LOUVER	530	13"	22"	6"	0.8	782	NORMALLY CLOSED	115 / 1 / 60	√		①②③
EL-1	GREENHECK	EAD-635	INTAKE LOUVER	530	13"	22"	6"	0.8	782	NORMALLY CLOSED	115 / 1 / 60	√		①②③

- ① PROVIDE WITH FACTORY GREENHECK 70% KYNAR 500 / HYLAR 5000 IN SIERRA TAN (COLOR CODE GF118)
- ② PROVIDE WITH FACTORY INSECT SCREEN
- ③ INTERLOCK TO OPEN WHEN THE EXHAUST FAN IS RUNNING

HISTORIC DISTRICT COMMISSION PROJECT REVIEW REQUEST

CITY OF DETROIT
PLANNING & DEVELOPMENT DEPARTMENT
2 WOODWARD AVENUE, ROOM 808, DETROIT, MI 48226

DATE: 8-27-19

PROPERTY INFORMATION

ADDRESS: 4440 E. Canfield Street AKA: 4440 Russell Street

HISTORIC DISTRICT: Sweetest Heart of Mary Roman Catholic Parish

APPLICANT IDENTIFICATION

Property Owner/
Homeowner Contractor Tenant or
Business Occupant Architect/
Engineer/
Consultant

NAME: T.J. Garrett COMPANY NAME: Haley Law Firm, PLC

ADDRESS: 10059 Bergin Road CITY: Howell STATE: MI ZIP: 48843

PHONE: 517-518-8623 MOBILE: 810-772-1275 EMAIL: tgarrett@haleyfirm.com

PROJECT REVIEW REQUEST CHECKLIST

Please attach the following documentation to your request:

Photographs of ALL sides of existing building or site

****Project only concerns one window on one side of building, shown in photos.****

Detailed photographs of location of proposed work
(photographs to show existing condition(s), design, color, & material)

Description of existing conditions
(including materials and design)

Description of project (if replacing any existing material(s), include an explanation as to why
replacement--rather than repair--of existing and/or construction of new is required)

Detailed scope of work (formatted as bulleted list)

Brochure/cut sheets for proposed replacement material(s) and/or product(s), as applicable

NOTE:


Based on the scope of work,
additional documentation may
be required.

See www.detroitmi.gov/hdc for
scope-specific requirements.

Upon receipt of this documentation, staff will review and inform you of the next steps toward obtaining your building permit from the Buildings, Safety Engineering and Environmental Department (BSEED) to perform the work.

SUBMIT COMPLETED REQUESTS TO HDC@DETROITMI.GOV

HISTORIC DISTRICT COMMISSION REVIEW & PERMIT PROCESS

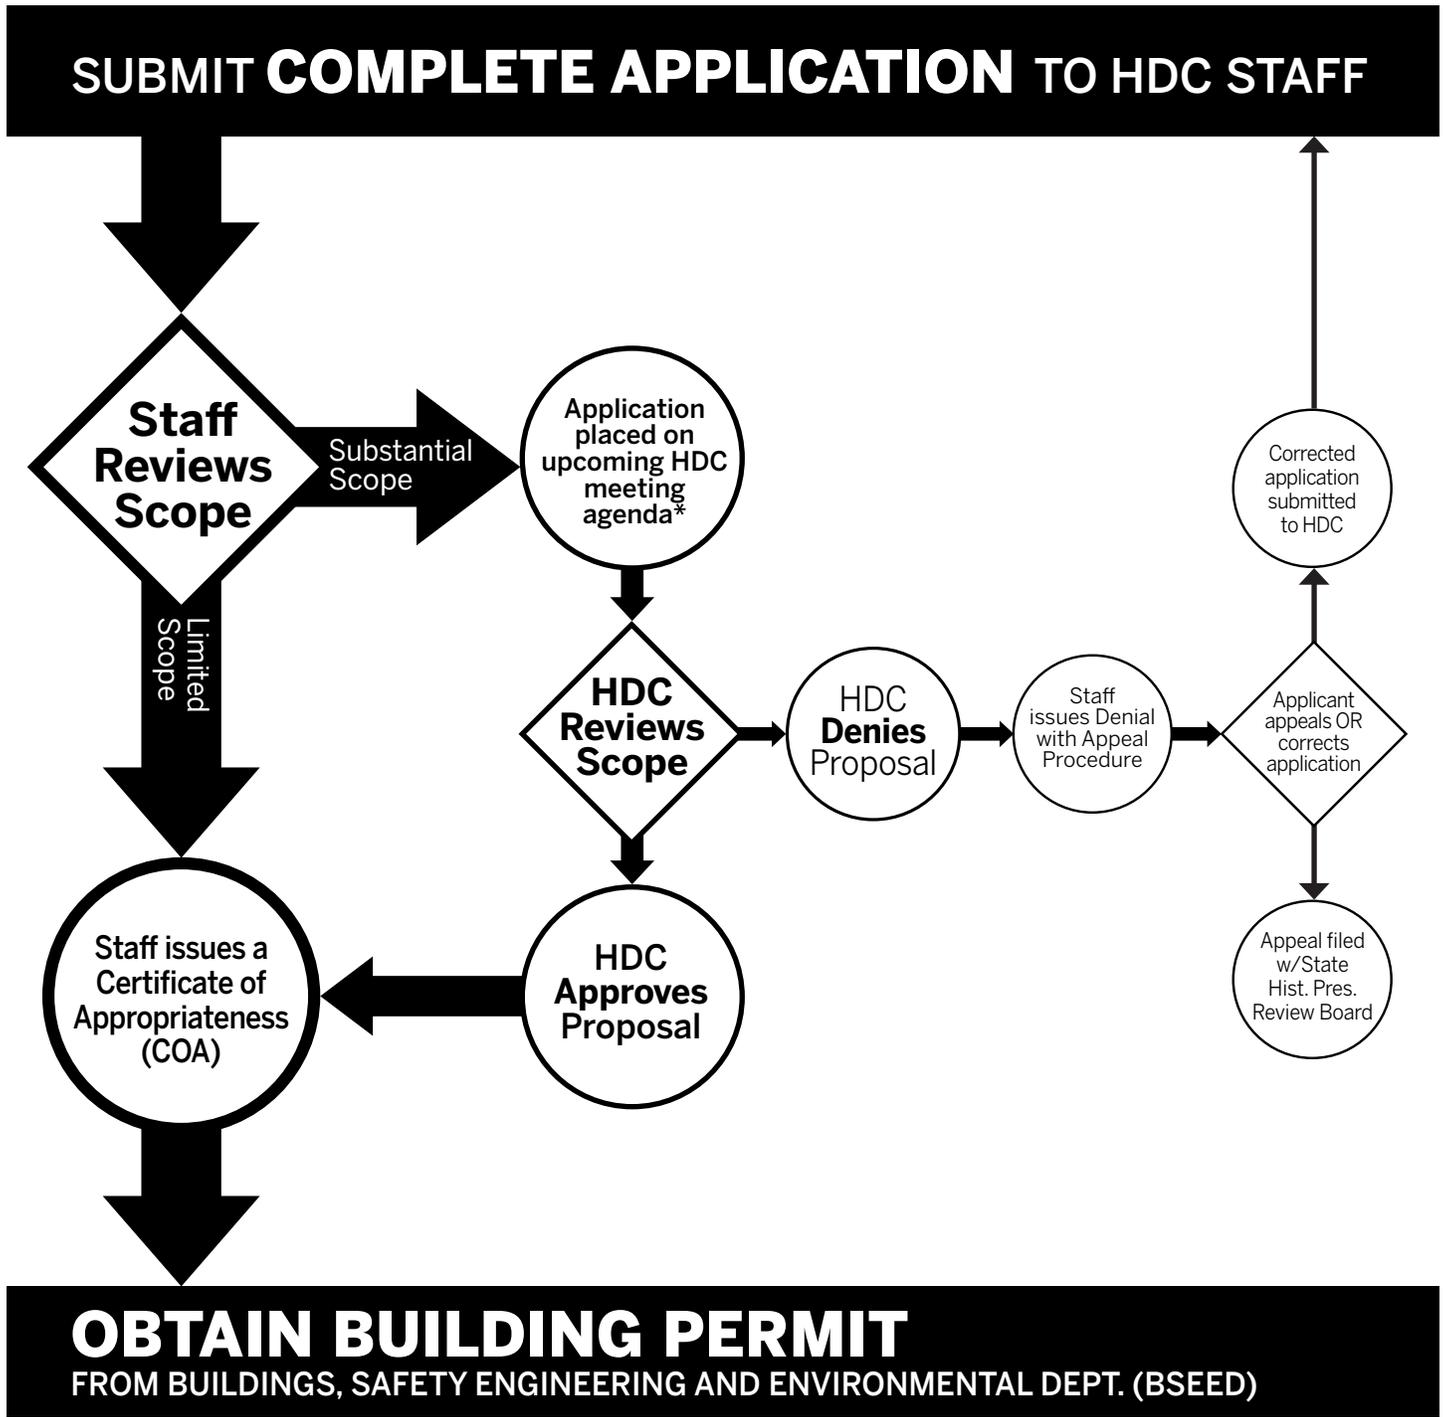

OBTAIN BUILDING PERMIT

FROM BUILDINGS, SAFETY ENGINEERING AND ENVIRONMENTAL DEPT. (BSEED)

* THE COMMISSION MEETS REGULARLY AT LEAST ONCE PER MONTH, TYPICALLY ON THE SECOND WEDNESDAY OF THE MONTH. (SEE WEBSITE FOR MEETING SCHEDULE/AGENDAS)

FIND OUT MORE AT www.detroitmi.gov/hdc

Sec. 21-2-125. - Sweetest Heart of Mary Roman Catholic Parish Historic District.

- (a) An historic district to be known as the Sweetest Heart of Mary Roman Catholic Parish Historic District is hereby established in accordance with the provisions of this article.
- (b) This historic district designation is hereby certified as being consistent with the Detroit Master Plan of Policies.
- (c) The boundaries of the Sweetest Heart of Mary Roman Catholic Parish Historic District, as shown on the map on file in the Office of the City Clerk, are as follows:

Beginning at a point of intersection of the center line of East Canfield and Russell proceeding northerly along the center line of Russell to its intersection with the north boundary (extended westward and eastward) of Lot 4 of the subdivision of Lots 12, 13, 14, and 15 of E. Robinson's Subdivision of Out Lots 15 and 16 of the Guoin Farm, (L18 P35) to its intersection with the center line of the alley running north-south between the east boundary of Lots 1, 2, and 3 of the aforementioned subdivision and the west boundary of Lot 2 of the subdivision of Lots from 1 to 11 and 16 to 22 inclusive and the private alley in re thereof of E. Robinson's Sub of Out Lots 15 and 16 of the Guoin Farm (L13 P62); from that point of intersection north along said center line of alley to its intersection with the center line of the alley running east-west between the north boundary of Lot 1 and the south boundaries of Lots 2 through 7 of the subdivision cited above as being found at L13 P62; thence westerly along the center line of said alley to its intersection with the center line of the alley running north-south between the east boundaries of Lots 1 and 7 of the subdivision cited above as being found at L13 P62 and the west boundaries of Lots 6 through 13 of Freud and Schulte's Subdivision of Lots 1 through 5 of the Riopelle Farm between Fremont and Farnsworth Streets (L7 P17); thence proceeding southerly along the center line of said alley (extended southward) to its intersection with the north boundary of Lot 1 of Freud and Schulte's Sub aforementioned; thence eastward along said north boundary of Lot 1; thence southerly along the east boundary (extended southward) of Lot 1 of Freud and Schulte's Subdivision to its intersection with the center line of East Canfield; thence westerly along the center line of West Canfield to the point of beginning. (The property included within these boundaries consists of Lot 1 of the Sub of Lots from 1 to 11 inclusive and 16 to 22 inclusive and private alley in re thereof of E. Robinson's sub of Out Lots 15 and 16 of Guoin Farm (L13 P62); Lot 4 of Sub of Lots 12, 13, 14, and 15 of E. Robinson's Subdivision of Out Lots 15 and 16 of Guoin Farm (L18 P35); and Lot 1 of Freud and Schulte's Subdivision of the Riopelle Farm lying between Fremont and Farnsworth Streets.) (L7 P17.)

- (d) The elements of design, as defined in Section 21-2-2 of this Code, shall be as follows:
 - (1) *Height.* Sweetest Heart of Mary Roman Catholic Church is a tall single-story space; its two spires are 217 feet high. The old school, facing East Canfield, is two stories tall on a high basement, with a three-story central tower (originally four stories). The sisters' house, three stories tall, is 38 feet in height. The rectory facing Russell is 26 feet high and is 2½ stories tall.
 - (2) *Proportion of buildings' front façade.* The church façade is approximately as wide from side to side as it is to the gable, although the two spires dramatically emphasize the vertical. The front façade of the old school is slightly wider than it is tall to the eaves. The façade of the sisters' house is approximately twice as wide as it is tall to the gables. The façade of the rectory is approximately as wide from gable to gable as it is tall to the peak of the gabled dormer. The church is the predominant building in the parish complex; the other buildings range from two to three stories and are compatible with one another in the proportions of the front elevations.
 - (3) *Proportion of openings within the façades.* Openings in the main façade of the church constitute approximately ten percent. The secondary façade, along East Canfield, is heavily fenestrated with large pointed-arched window openings. All window and door openings are emphatically taller than wide; the entrance openings are composed of recessed arches; windows are divided by tracery. The old school fronting on East Canfield contains approximately 25 percent openings. The sisters' house front façade is

composed of approximately 15 to 20 percent window and door openings; the front façade of the rectory facing Russell consists of 20 percent openings. The openings in all of the buildings' front façades are symmetrically arranged.

- (4) *Rhythm of solids to voids in front façade.* The main façade of the church is divided horizontally into two distinct sections. The bottom section is distinguished by its light gray limestone and the top by the red painted brick. The church façade is divided vertically into the central portion and its two flanking bays with towers and spires above. Voids are arranged symmetrically, with the most prominent voids—the central arched entrance, the pointed arched window with six-pointed star motif, and the three lancet windows above in the gable end—located in the central section. Voids in the old schoolhouse are also placed symmetrically within the façade. To each side of the slightly projecting tower pavilion is a pair of narrow sash windows with transoms above. The central bay has an arched opening leading onto a porch; above are two double-hung sash windows with transoms. In the tower are two round-arched sash windows. The sisters' house is composed of symmetrically arranged six-over-six double-hung sash windows, two per bay, with three on the two end bays of the first floor. The window openings are two times taller than they are wide. The fenestration of the rectory includes paired double-hung sash with shared sills on the outer bays and a single double-hung sash window above the entrance on the central bay. The arrangement of openings is symmetrical; a palladian window motif is in the dormer.
- (5) *Rhythm of spacing of buildings on street.* Inapplicable due to single-complex district.
- (6) *Rhythm of entrance and/or porch projections.* Inapplicable due to single-complex district.
- (7) *Relationship of materials.* The light gray limestone base of the church contrasts with the painted red brick of the central gable and bell towers. The roofs are covered in patterned slate. Tracery, crocketts, pinnacles, and trim are wood. The old school facing East Canfield is a brick building with a high limestone basement and stone details. The sisters' home is brick with stone cresting, sills, steps, door hood and spandrels, and window hoods; its roof is slate and the downspouts are copper. The rectory is painted brick with stone keystones and sills and wooden window frames, porch and dormer.
- (8) *Relationship of textures.* The regular pattern of coursed ashlar, in which wide smooth-faced courses alternate with narrow rock-faced courses, comprising the foundations of the church façade contrasts with the smoother painted surface of the brick with plain-cut mortar joints, the slate roofs and the wood elements above. The same can be said of the old school, with its rough stone base and brick façade. The sisters' house has a more rustic appearance due to the color and texture of the brick, thus providing a contrast with other buildings seen from the courtyard. The pressed brick and wood of the rectory provide a smooth texture.
- (9) *Relationship of color.* The base of the church and the old school are of light gray stone, which contrasts with the brick, now painted red, of the church and the red brick of the school. Architectural elements and details are in stone and/or of light gray painted wood, and contrast with the gray patterned roofs. Copper flashing on the church and old school provides a bright contrast. The ribs of the church spires are painted a cream color. The ionic portico still remaining of the brick school addition is of light gray masonry. The sisters' house is the only building that departs from the red brick precedent set by the other buildings in its use of orange/brown brick and a light-to-medium gray slate roof with green copper downspouts. The rectory consists of red painted brick and light gray wood trim.
- (10) *Relationship of architectural details.* Victorian Gothic ecclesiastical architectural details accentuate the church structure. The stone base is topped by a quatrefoil frieze over the main portal and twin buttressed towers surmounted by octagonal spires. Alternating patterns of pinnacles and decorated gables define the bases of the main spires. The gable ornamentation, consisting primarily of serrated

lancets, is repeated on the four larger gables, which make the ends of the nave and transepts; the pointed gable shape is echoed not only on the spires and the roof but also on the side buttressing and above all the portals. Lancet windows fenestrate the towers, gables, and the main three-portal façade, and circles dominate the tracery of the tower windows and the pointed-arch windows of the north and south elevations. The six-pointed star motif of the stained glass window above the central portal on the west façade is discernible from the exterior. Architectural detail of the old school is limited to architectural elements, which were present at the time of designation, and consists of the stone quoins at the two corners and foliated pillaster capitals, brick banding, and corbelling. The original detailing of the north elevation of the old school is no longer present; at the time of designation this wall was exposed by the demolition of the circa 1902 addition and indicates evidence of plaster walls, paneling, paint, stairs, doors and trim. Detailing on the sisters' house is restrained and confined to the surrounds and spandrels of the central entranceway and the window hoods. The conductor boxes on the copper downspouts contain reliefs. The rectory has the Neo-Georgian-style window keystones, porch details, stone sills, denticulation, and a palladian window dormer.

- (11) *Relationship of roof shapes.* The church has a pitched roof with gabled ends; the transept arms from a cross gable. Angled side entrances have gabled ends and gables project between buttresses. The towers are crowned with octagonal spires. The spire over the crossing has been dismantled except for the base. Hipped roofs predominate on the other parish buildings; the old school is covered with a hipped roof, as is its central tower. The sisters' house has a truncated hipped roof over the central block with eyebrow dormers while the end bays have transverse gables. The rectory is covered with a hipped roof with traverse gable roof and a gabled dormer.
- (12) *Walls of continuity.* Originally, the arrangement of the five-building elevations comprising the parish complex formed an interior courtyard. At the time of designation, the east end of the courtyard was open.
- (13) *Relationship of significant landscape features and surface treatments.* The wrought iron fence with concrete pillars sets apart the church complex from the streets. Low bushes are sparsely planted in front of the church and the school. The grass turf lawn of the courtyard is divided by concrete sidewalks and is planted primarily with evergreens. Evergreens are also planted on the landscaped lawn in front of the rectory. Of the schoolhouse addition, only the ionic portico, which was the dominant feature of the west façade of this Classically-inspired building, remains.
- (14) *Relationship of open space to structure.* Open space to the sidewalk exists in front of the church and the rectory on Russell, and to the south of the church and old school on East Canfield. To the east of the school is an open field, created by urban renewal clearance, as was the area to the north of the complex and rectory. An internal courtyard space open to Russell Street and now open to the east is created by the siting of the four freestanding buildings, which have grass turf and/or concrete walks between them.
- (15) *Scale of façade and façade elements.* The scale of Sweetest Heart of Mary Church is monumental. Its tripartite compound pointed-arched portal, spires, and tall elongated windows contribute to this overall effect, as do the more moderately sized details within the composition. The modest scale of the façade of the old school facing East Canfield is articulated with large forceful elements, such as the central projecting tower, the projecting front façade with curved sides, and the entrance porch. Ornamentation is on a small scale. The scale of the façade of the sisters' house is substantial, with restrained and small elements within. The rectory is on the scale of a residence of moderate size. Elements within are small and refined in detail.
- (16) *Directional expression of front elevation.* The directional expression of the church is emphatically vertical,

and emphasized by the twin spires. Likewise, the vertical aspect of the old school is emphasized by its central projecting tower. The sisters' home is emphatically horizontal, with two vertical elements, the transverse gables, at either end. The rectory presents a directionally balanced composition.

- (17) *Rhythm of building setbacks.* The setbacks of buildings from the street do not relate to each other. See site plan on file in the Office of the City Clerk.
 - (18) *Relationship of lot coverages.* The buildings occupy the perimeter of the site; a central courtyard was created by this arrangement of buildings.
 - (19) *Degree of complexity within the façade.* The façade of the church is symmetrical yet complex in its use of an extensive Gothic vocabulary. The façade of the old school is complex, due to its massing and projections, although ornamentation is minimal. The sisters' house is symmetrical and straightforward in its arrangement of windows, dormers and end gables, as is the rectory.
 - (20) *Orientation, vistas, overviews.* The complex of buildings is oriented toward the west, or Russell. The church and the rectory front on Russell; the courtyard is entered into between these buildings. The secondary orientation is towards East Canfield (the south), to which the old school faces. The sisters' house is entered through the courtyard. The church, and its spires in particular, provide a landmark from all directions at a distance.
 - (21) *Symmetrical or asymmetrical appearance.* All buildings in the parish complex are intended to appear symmetrical, although the façade of the rectory is slightly asymmetrical.
 - (22) *General environmental character.* The Sweetest Heart of Mary Roman Catholic Parish is a very visible special use element in a primarily residential redevelopment area. As one of the major focal points in the Forest Park Community, it is a visible reminder of the historic ethnic community ties. It remains one of the City's most striking examples of Late Gothic revival church architecture in an ethnic urban neighborhood.
- (e) In accordance with Section 21-2-76 of this Code, the Historic District Commission is hereby authorized to consider interior features in certain portions of Sweetest Heart of Mary Roman Catholic Church, located within the Sweetest Heart of Mary Roman Catholic Parish Historic District, and permits shall be required for such interior work in those portions of Sweetest Heart of Mary Roman Catholic Church as provided for in Sections 21-2-71 through 21-2-81 of this Code, as if such interior work were exterior work:
- (1) The interior spaces of Sweetest Heart of Mary Roman Catholic Church, which are hereby made subject to the Historic District Commission's consideration, are those spaces normally open to or seen by the public, including the narthex, nave, choir loft, chancel and side altars. Areas not open to and not ordinarily seen by the public, including sacristies, vesting rooms, basement and attic areas, closets, service areas, and the entire interior of the rectory, schoolhouse, and sisters' house, are not hereby made subject to the Historic District Commission's consideration.
 - (2) In considering proposals for the alteration, demolition, partial demolition, removal, or addition to any or all of the architectural features and permanent furniture within the designated areas of Sweetest Heart of Mary Roman Catholic Church, the Historic District Commission shall use the following criteria:
 - a. Subsections (d)(1) through (22) of this section, as applicable;
 - b. The architectural or historical significance of the existing or proposed structure, feature, permanent furniture, or furnishings traditionally associated with the building, and its relationship to the architectural and historical value of the Sweetest Heart of Mary Roman Catholic Parish Historic District;
 - c. The purpose of the designated spaces within Sweetest Heart of Mary Roman Catholic Church and

the needs of its owners, provided, that such considerations shall not bind the Historic District Commission's to permit any alteration solely on the basis of use;

- d. The provisions of Section 21-2-76 of this Code; and
 - e. Any other factor, including aesthetic, which the Historic District Commission deems to be pertinent.
- (3) As a guide in considering proposals affecting the interior of Sweetest Heart of Mary Roman Catholic Church, the Historic District Commission shall make use of a set of 37 35-millimeter color slides, which were taken by the staff of the Historic Designation Advisory Board on July 10, 1981 and represent the state of the interior as of that date. Copies of this set of slides, together with a list describing each slide and a diagram showing the designated interior areas, are on file in the Office of the City Clerk, the Historic District Commission, the Historic Designation Advisory Board, and the Burton Historical Collection of the Detroit Public Library.

(Code 1964, § 28A-1-31; Code 1984, § 25-2-84; Ord. No. 473-H, § 1(28A-1-31), eff. 10-23-1981)